

CITY OF ANN ARBOR ENGINEERING


STREET RESURFACING/RESTORATION PROJECT - 2019

ITB No. 4570 FILE No. 2019004

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PREPARED UNDER THE SUPERVISION OF

DAVID ARTHUR DYKMAN, P.E. - MI LICENSE No. 52912

03/13/2019

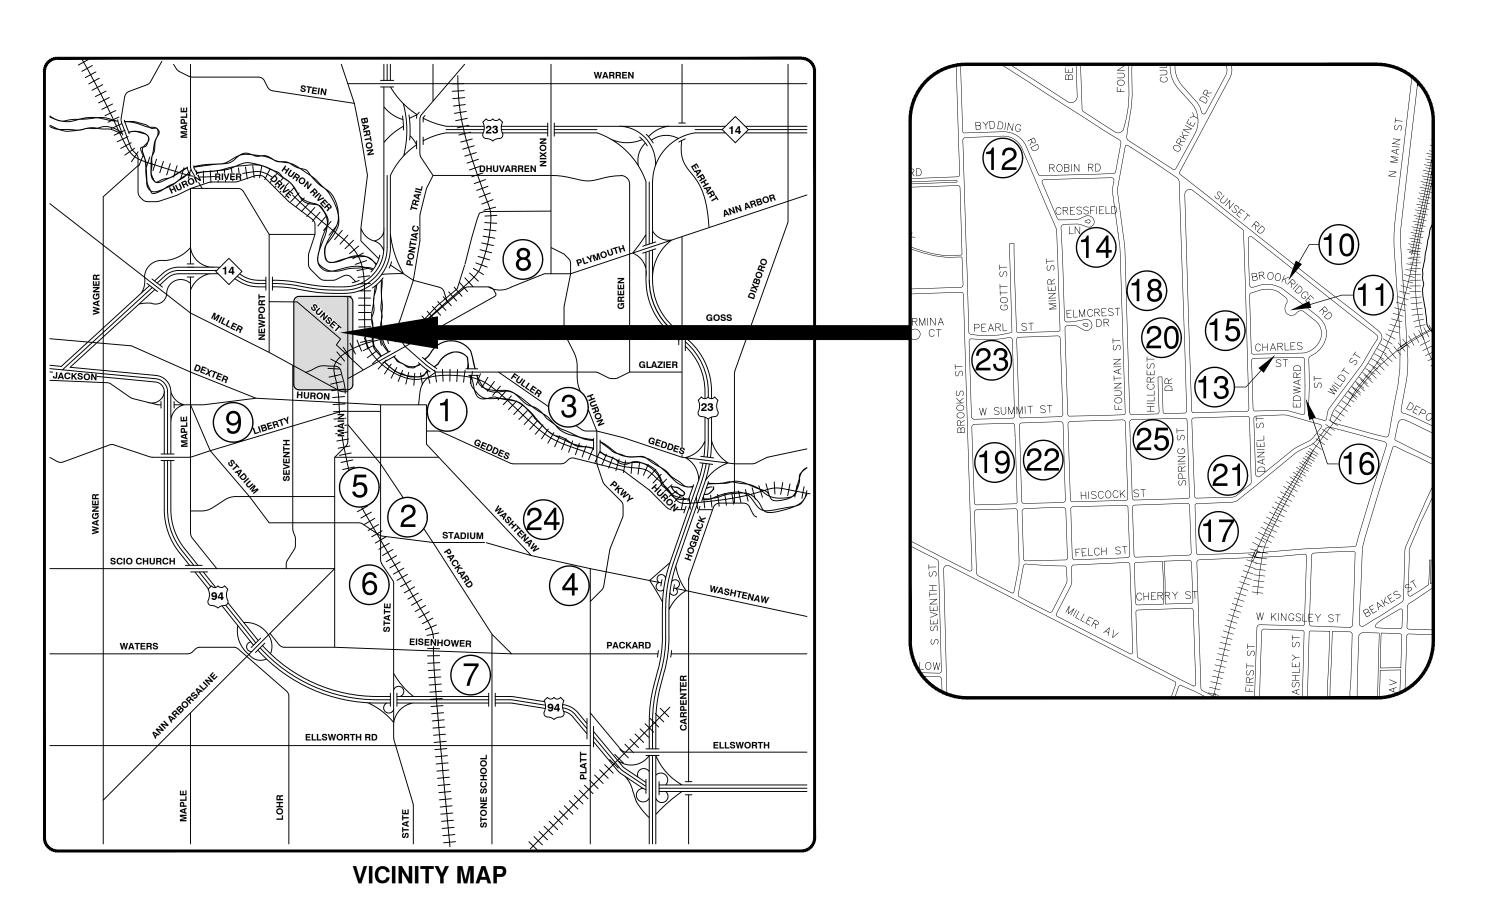

GENERAL NOTES:

- 1. Driveways and entrances to buildings, real property, and the like shall not be blocked except for short durations and only when approved by the Engineer. Vehicular and pedestrian access shall be maintained at all times. It shall be the Contractor's responsibility to coordinate all necessary driveway closures with the property owner(s) and resident(s) in the areas of construction.
- 2. The location and depth of all existing utilities and service leads are to be field verified by the Contractor prior to construction.
- 3. During non-working hours no more than ten (10) feet of trench shall remain open; any open trench shall be properly secured with protective fencing. This work shall be included in the items of work being undertaken and will not be paid for separately.
- 4. The location of material stock piles and on—site staging areas shall be approved by the Engineer.
- 5. For mainline HMA Paving, the width of the mat for each pass of the paver shall be not less than 10.5', nor greater than 16', except as noted in the plans and as directed by the Engineer. The Engineer will direct the layout of all HMA Longitudinal Joints during construction.
- 6. All excavation required to construct sidewalk and sidewalk ramps shall be included in the contract pay item "Grading, Sidewalk and Sidewalk Ramps".
- 7. Some storm sewer may unavoidably become damaged during construction, or it may be determined by the Engineer that existing storm sewer needs to be replaced. In either case the Engineer may direct the sewer to be removed and replaced. The removal of existing sewer and drainage structures, as required, shall be included in the respective contract pay items "Sewer, Rem, Less than 24 inch" and Dr Structure, Rem". The replacement sewer shall be installed and paid for at the corresponding contract unit price, if contained within the contract, for the various types and sizes of sewer to be replaced.
- 8. Where existing drainage or utility structures, whether shown or not on the plans, are designated or directed by the Engineer to receive new castings (cover and frame) the existing castings shall be neatly stacked on-site in a single location so that City of Ann Arbor forces can retrieve them at a later date. The Contractor shall assist City forces by loading them into City trucks. All costs associated with storing, stockpiling, and loading castings into City vehicles shall be included in the contract pay item "Dr Structure Cover, Type_, Modified".
- 9. Payment for drainage structure sumps where specified shall be included in the payment for the various drainage structures sizes and/or types.
- 10. Where pipes of different sizes or materials are joined, Fernco Flexible Couplings with stainless steel shear rings shall be used. The Contractor's purchase price for these devices, including shipping, shall be paid as an extra. Prior to payment for this item, the Contractor shall submit receipts for the Engineer's review and approval. All other costs associated with the installation of these devices shall be included in the payment for the sewer.

- 11. Where storm sewer is to be removed and replaced or added, all pipe shall be installed using the utility trench details shown elsewhere in the plan sheets and/or detailed in the specifications. Trench Details I and V require the use of MDOT Class II Granular Material.
- 12.If the Contractor encounters existing edge drain(s) during construction of the proposed edge drains, inlet leads, or catch basins, it shall be capped at each end to prevent material from entering the pipe. The cost of this work will not be paid for separately, but shall be included in the particular item of work being performed when existing edge drain(s) are encountered.
- 13.In areas where edge drain cannot be installed in accordance with the details, the edge drain shall be installed at the depth as indicated on the plans, or as directed by the Engineer. In no case shall the edge drain be installed at a grade less than 0.50% or at a depth less than 3.25' below the top of pavement.
- 14. Existing street name signs, guide, bus stop, and regulatory signs which conflict with the proposed construction shall be removed prior to construction, stored in a manner which will prevent damage, and re—set in locations as directed by the Engineer. This work will not be paid for separately, but shall be included in the contract pay item "Minor Traf Devices."
- 15. All curb, sidewalk, driveway approach removals shall be approved by the Engineer before the work is performed.
- 16. Place 4" (minimum) thickness Granular Material Class II compacted to 95% of its max. dry density under concrete sidewalk as shown on the details. This work shall be included in the contract item "Subbase, CIP."
- 17. Place 6" (minimum) Granular Material Class II compacted to 95% of its max. dry density under concrete driveway approaches, and 6" (minimum) Dense-Graded Aggregate 21AA compacted to 98% of its max. dry density under HMA driveway approaches. This work shall be included in the respective contract pay items "Subbase, CIP" and "Aggregate Base, 6 inch, Modified".
- 18. A uniform coat(s) of curing compound shall be applied according to the Standard Specifications and Special Provisions regardless of the difficulty involved. The Contractor shall take care to prevent overspray when applying curing compound. Several different methods may need to be developed to protect various situations, but all methods used to prevent overspray of the curing compound shall be completely effective. Methods used shall be approved by the Engineer prior to use, however approval of a method does not guarantee success or acceptability. No additional compensation shall be made for complying with these requirements.

PERMITS REQUIRED TO BE OBTAINED BY THE CONTRACTOR IPRIOR TO THE REGINNING OF CONSTRUCTION.

PERMIT	ISSUING AUTHORITY
LANE CLOSURE PERMIT	CITY OF ANN ARBOR ENGINEERING
GRADING/SOIL EROSION & SEDIMENTATION CONTROL PERMIT	CITY OF ANN ARBOR CUSTOMER SERVICE
RIGHT-OF-WAY PERMIT	CITY OF ANN ARBOR CUSTOMER SERVICE

* NO COST TO CONTRACTOR

					03-13-	DAT
CONTACT INFORMA	TION					
PUBLIC UTILITIES	OWNER	CONTACT				
WATER SANITARY STORM	CITY OF ANN ARBOR PUBLIC WORKS W.R. WHEELER SERVICE CENTER 4251 STONE SCHOOL ROAD ANN ARBOR, MI 48108	(734) 794–6350				DESCRIPTION
FORESTRY SIGNS SIGNALS STREET LIGHTS	ANN ARBOR, WIL FOTOG	(734) 794–6361			00 BID SET	REV.
PRIVATE UTILITIES	OWNER	CONTACT				
GAS	DTE ENERGY 3150 E. MICHIGAN AVE,	ROBERT CZAPIEWSKI (734) 544-7818	BOR	ES REET	7-8647	

GAS	DTE ENERGY 3150 E. MICHIGAN AVE, YPSILANTI TOWNSHIP, MI 48198	ROBERT CZAPIEWSI (734) 544-7818
ELECTRIC	DTE ENERGY WESTERN WAYNE SERVICE CENTER 8001 HAGGERTY ROAD BELLEVILLE, MI 48111	ANTHONY IGNASIAK (734) 397-4447
STREET LIGHTING	DTE ENERGY WESTERN WAYNE SERVICE CENTER 8001 HAGGERTY ROAD BELLEVILLE, MI 48111	BRANDON FARON (734) 397-4017
CABLE	COMCAST 27800 FRANKLIN ROAD SOUTHFIELD, MI 48034	RON SUTHERLAND (313) 999-8300
PHONE	AT&T 550 S. MAPLE ROAD ANN ARBOR, MI 48103	(734) 996–2135
TIBER OPTIC	MCI 2800 N. GLENFILLE ROAD	DEAN BOYERS (972) 729-6016

RICHARDSON, TX 75082





ESURFACING/REST PROJECT - 2019

CITY OF ANN ARBOR

SHEET No. 2 OF 121

NOTIFY THE CITY OF ANN ARBOR SOIL EROSION CONTROL OFFICE 48 HOURS PRIOR TO BEGINNING WORK ON THE PROJECT. PHONE: 734-794-6265.

- 1. THE CONTRACTOR SHALL IMPLEMENT AND MAINTAIN THE SOIL EROSION CONTROL MEASURES AS SHOWN ON THE PLANS AND AS DIRECTED BY THE ENGINEER AT ALL TIMES DURING CONSTRUCTION. ANY MODIFICATIONS OR ADDITIONS TO THE SOIL EROSION CONTROL MEASURES DUE TO CONSTRUCTION OR CHANGED CONDITIONS SHALL BE AS DIRECTED AND APPROVED BY THE ENGINEER.
- 2. ALL SOIL EROSION AND SEDIMENTATION CONTROL WORK SHALL CONFORM TO THE PERMIT REQUIREMENTS OF THE CITY OF ANN ARBOR. CITY ORDINANCE CHAPTER 63, CITY OF ANN ARBOR STANDARDS DIVISION VII, THE LAWS OF THE STATE OF MICHIGAN, AND THE REQUIREMENTS OF THE CONTRACT DOCUMENTS.
- 3. DAILY, OR AFTER ANY STORM EVENT, INSPECTIONS OF EROSION CONTROL MEASURES SHALL BE MADE BY THE CONTRACTOR. PERIODIC INSPECTIONS MAY BE MADE BY THE ENGINEER TO DETERMINE THE EFFECTIVENESS OF EROSION AND SEDIMENTATION CONTROL MEASURES. ANY NECESSARY CORRECTIONS SHALL BE MADE WITHOUT DELAY, AND WITHOUT ADDITIONAL COST TO THE CITY OF ANN
- 4. EROSION AND SEDIMENTATION FROM WORK ON THE SITE SHALL BE CONTAINED ON THE SITE AND NOT BE ALLOWED TO COLLECT ON ANY OFF-SITE AREAS, ROADWAYS OR WATERWAYS.
- 5. ALL MUD/SOIL TRACKED ONTO ROADWAYS FROM THE SITE DUE TO CONSTRUCTION, SHALL BE PROMPTLY REMOVED BY THE CONTRACTOR. IF SO ORDERED, THE CONTRACTOR SHALL PROVIDE AND OPERATE A VACUUM-TYPE STREET SWEEPER. AT NO ADDITIONAL COST TO THE CITY OF ANN ARBOR, WITHIN FOUR (4) HOURS OF BEING SO ORDERED.
- 6. RESTORATION OF ALL DISTURBED AREAS, INCLUDING PLACEMENT OF TOPSOIL, SEED, FERTILIZER AND MULCH AND/OR SOD SHALL BE PERFORMED WITHIN FIVE (5) DAYS OF THE COMPLETION OF FINAL GRADE.
- 7. CONSTRUCTION OPERATIONS SHALL BE SCHEDULED AND PERFORMED SO THAT PREVENTATIVE SOIL EROSION CONTROL MEASURES ARE IN PLACE PRIOR TO EXCAVATION IN CRITICAL AREAS AND TEMPORARY STABILIZATION MEASURES ARE IN PLACE IMMEDIATELY FOLLOWING BACKFILLING OPERATIONS.

- 8. SPECIAL PRECAUTIONS WILL BE TAKEN IN THE USE OF CONSTRUCTION EQUIPMENT TO PREVENT SITUATIONS THAT PROMOTE EROSION.
- 9. PROPER DUST CONTROL SHALL BE MAINTAINED DURING CONSTRUCTION BY USE OF WATER TRUCKS AND/OR DUST PALLATIVE AS REQUIRED.
- 10. THE CONTRACTOR SHALL BE RESPONSIBLE FOR MAINTAINING ALL TEMPORARY SOIL EROSION CONTROL MEASURES AND REMOVAL OF SOME MEASURES UPON AUTHORIZED COMPLETION OF THE PROJECT. FINAL COMPLETION OF PROJECT WILL NOT BE AUTHORIZED UNTIL ALL SITE WORK AND UTILITY CONSTRUCTION IS COMPLETE AND ALL SOILS ARE STABILIZED.
- 11. THE CONTRACTOR SHALL NOT GRADE INTO ADJACENT PROPERTIES. SILT AND PROTECTIVE FENCE SHALL BE INSTALLED AND MAINTAINED TO PREVENT GRADING, EROSION AND SEDIMENTATION INTO THE ADJACENT PROPERTIES.
- 12. TREE PROTECTION FENCING MUST REMAIN INTACT UNTIL RESTORATION OF THE SITE IS COMPLETE.

SEQUENCE OF EROSION CONTROL MEASURES:

THE CONTRACTOR IS TO SUBMIT TO THE ENGINEER, A SEQUENCE OF CONSTRUCTION WITH RESPECT TO THE SOIL EROSION CONTROL MEASURES FOR REVIEW, COMMENT AND APPROVAL. THIS SCHEDULE IS TO INCLUDE INSPECTION AND REPAIR OF ALL TEMPORARY EROSION CONTROL MEASURES DAILY AND WITHIN 24 HOURS OF A STORM EVENT.

SAMPLE SOIL EROSION AND SEDIMENTATION CONTROL INSTALLATION MINIMUM **REQUIREMENTS:**


- 1.1. INSTALL SILT FENCE, TREE PROTECTION FENCING, MUD MATS, INLET FILTERS ON EXISTING DRAINAGE FEATURES, AND ALL OTHER TEMPORARY SOIL EROSION CONTROLS, PRIOR TO ANY CLEARING OR EARTH MOVING OPERATION.
- 1.2. STRIP AND STOCKPILE TOPSOIL. STABILIZE STOCKPILE AS REQUIRED.
- 1.3. INSTALL WATER MAINS, STORM AND SANITARY SEWERS, AND OTHER ENCLOSED DRAINAGE FEATURES. NEW INLET FILTERS SHALL BE INSTALLED IMMEDIATELY FOLLOWING INSTALLATION OF NEW DRAINAGE INLETS.

- 1.4. PERFORM MACHINE GRADING OPERATIONS AND CONSTRUCT PAVEMENTS (MAINLINE, SIDEWALKS, DRIVES, ETC.).
- 1.5. CONTINUALLY MAINTAIN EROSION AND SEDIMENTATION CONTROL MEASURES, AS REQUIRED TO ALLOW DRAINAGE AND SEDIMENT REMOVAL. REMOVE ANY ACCUMULATED SEDIMENT IMMEDIATELY.
- 1.6. COMPLETE ALL BIORETENTION GRADING AND FINE GRADING.
- 1.7. TEMPORARY SEED AND INSTALL EROSION CONTROL BLANKET IN ALL DISTURBED AREAS.
- 1.8. REFER TO LANDSCAPE PLANTING PLANS FOR PERMANENT SITE STABILIZATION.
- 1.9. CLEAN OUT STORM SEWER SYSTEMS.
- 1.10. REMEDY ANY NOTED DEFECTS TO THE SATISFACTION OF THE CITY OF ANN ARBOR'S SOIL EROSION AND SEDIMENTATION CONTROL OFFICIAL.
- 1.11. ALL TEMP. SOIL EROSION CONTROL MEASURES MUST BE REMOVED, WITH ENGINEERS APPROVAL, PRIOR TO FINAL INSPECTION


NOTE: THIS SEQUENCE IS FOR INFORMATION ONLY. IT IS INTENDED TO SHOW THE SEQUENCE OF CONSTRUCTION WITH RESPECT TO THE SOIL EROSION AND SEDIMENTATION CONTROL MEASURES. THE CONTRACTOR IS RESPONSIBLE FOR SUBMITTING THEIR OWN DETAILED CONSTRUCTION SEQUENCE AND SCHEDULE TO THE ENGINEER FOR REVIEW, COMMENT, AND APPROVAL.

TEMPORARY SEEDING:

- 1. SEED IN ACCORDANCE WITH PROJECT DRAWINGS AND SPECIFICATIONS.
- 2. ANY DISTURBED AREA NOT PAVED, SEEDED, MULCHED, SODDED OR BUILT UPON BY NOVEMBER 15TH OR JUNE 30TH IS TO BE TEMPORARILY STABILIZED PER SPECIFICATIONS.

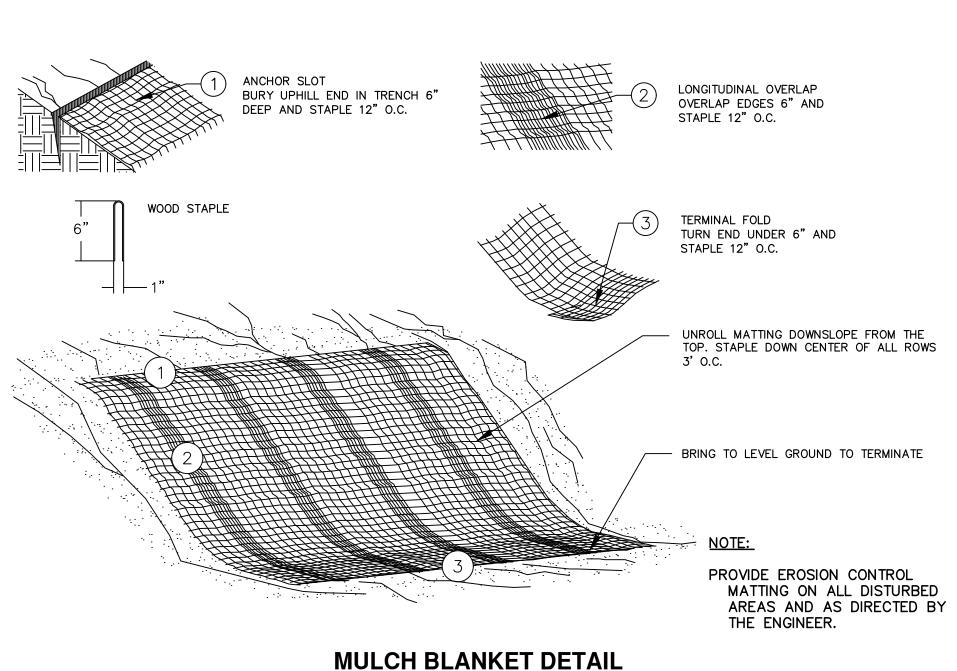

APPLIES TO ALL AREAS TO BE PERMANENTLY RESTORED WITH GRASS. SEE LANDSCAPE PLANS FOR MORE DETAILS.

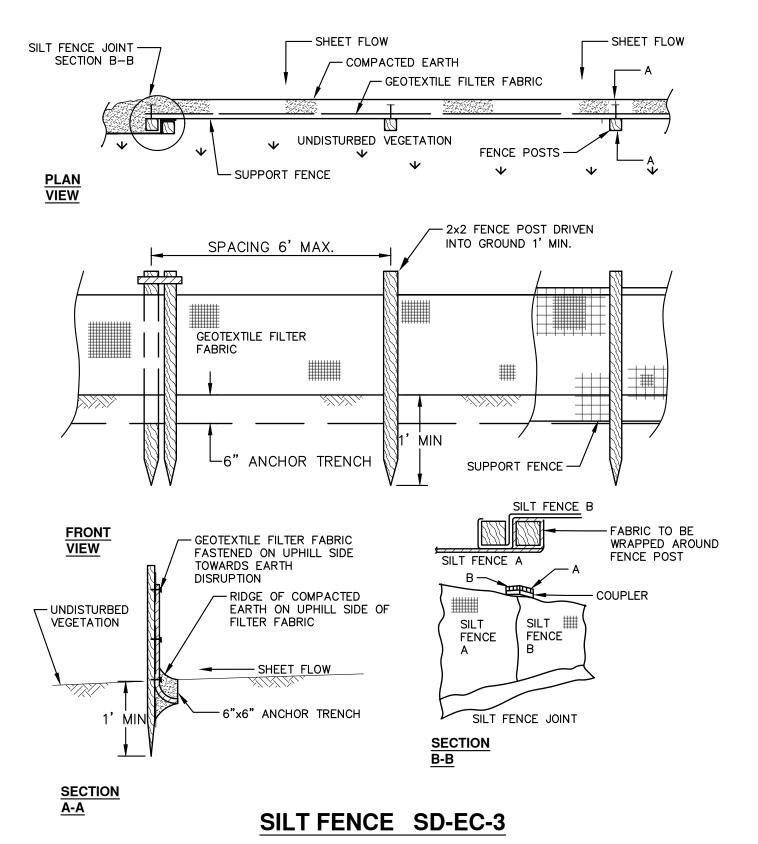





F RESURFACING/RESTC PROJECT - 2019
SESC NOTES & DETAILS


OF ANN ARBOR

SHEET No.

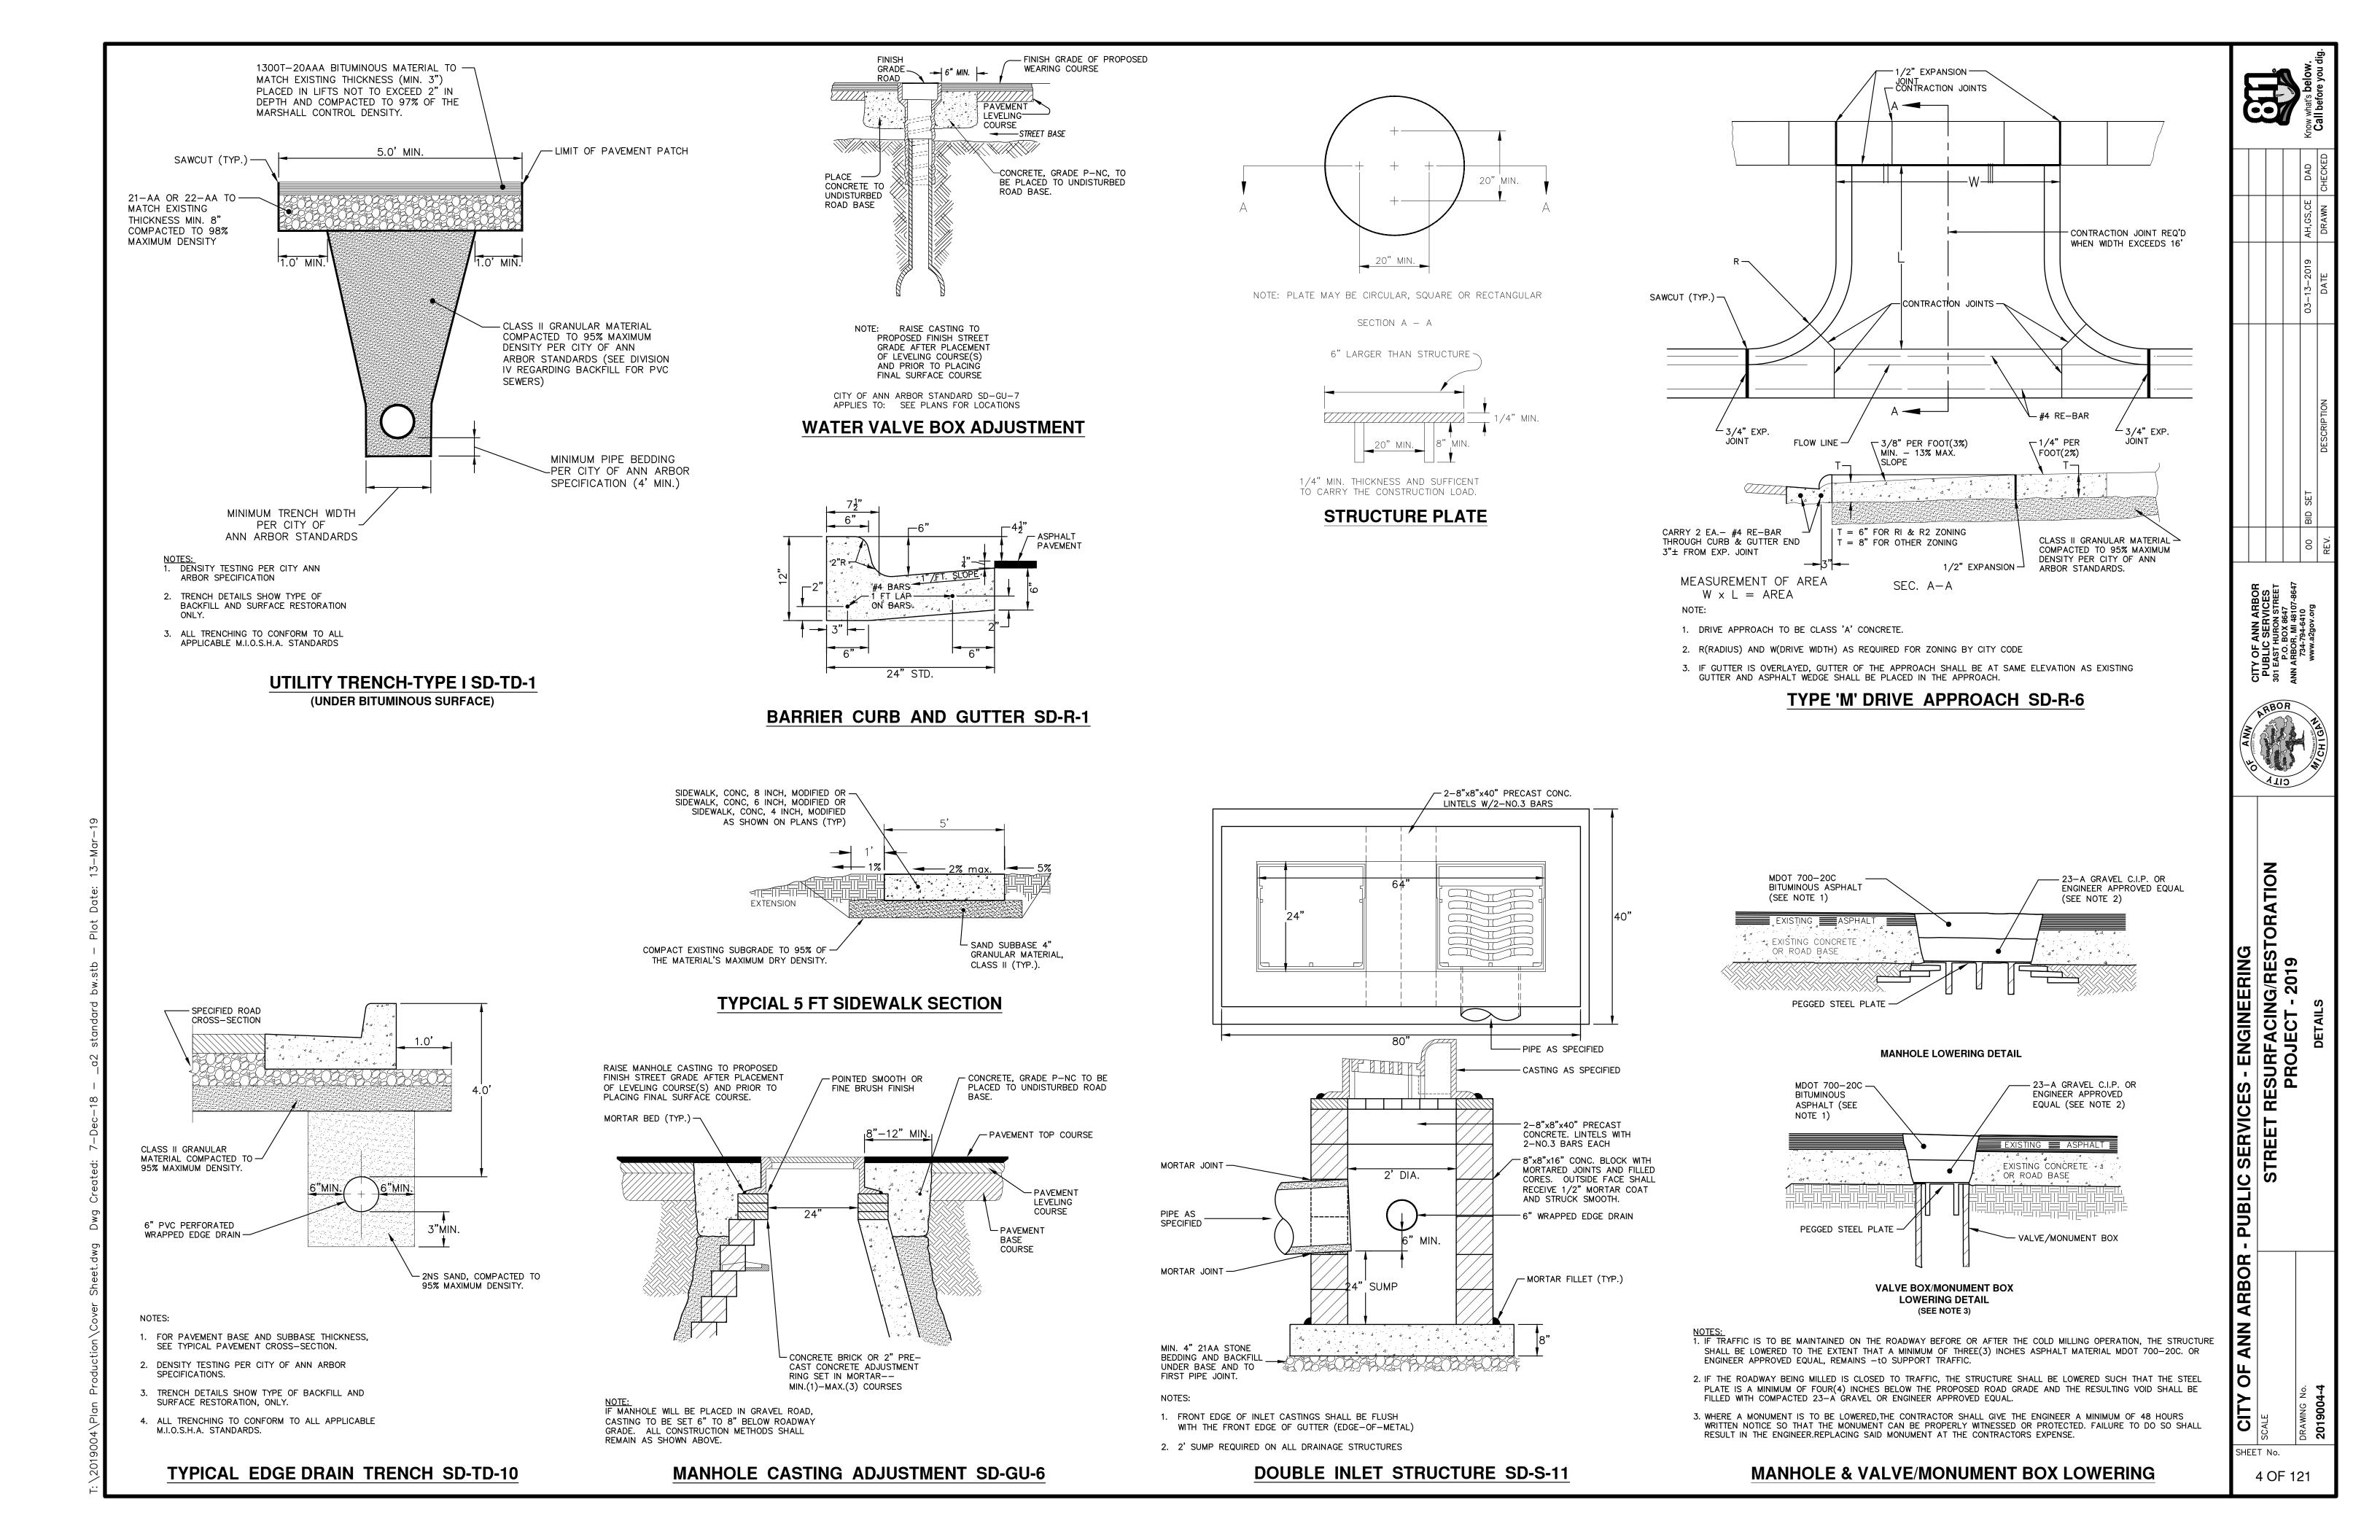


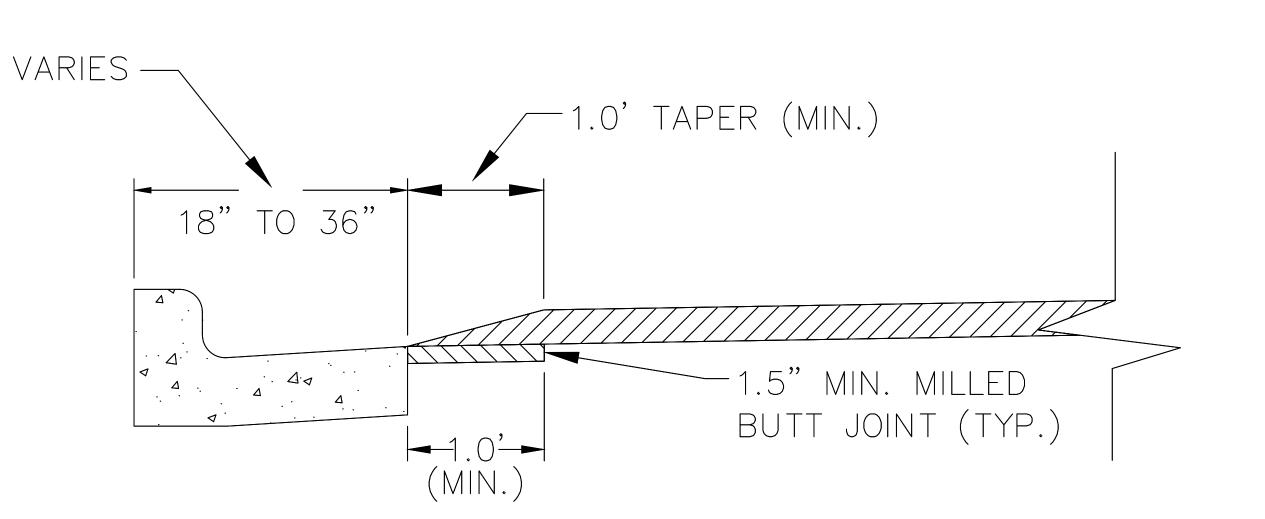

SPEED HUMP CROSS SECTION SECTION B-B

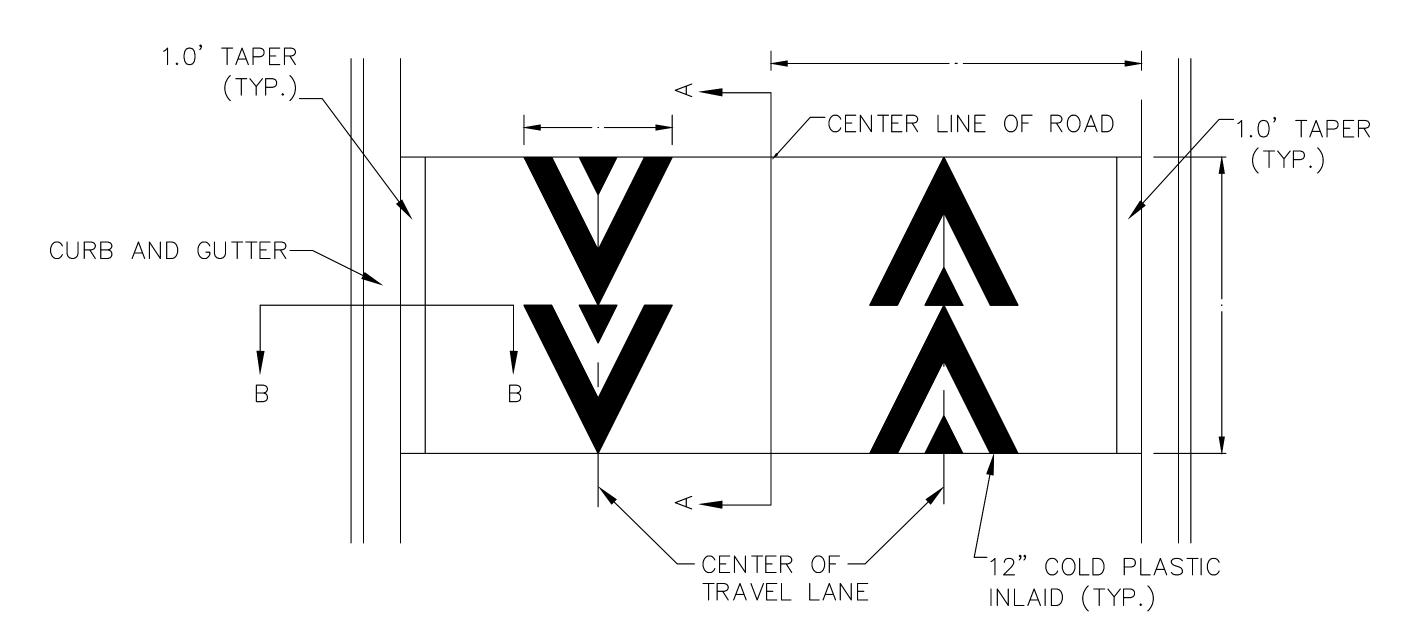

PAVEMENT MARKING DETAIL

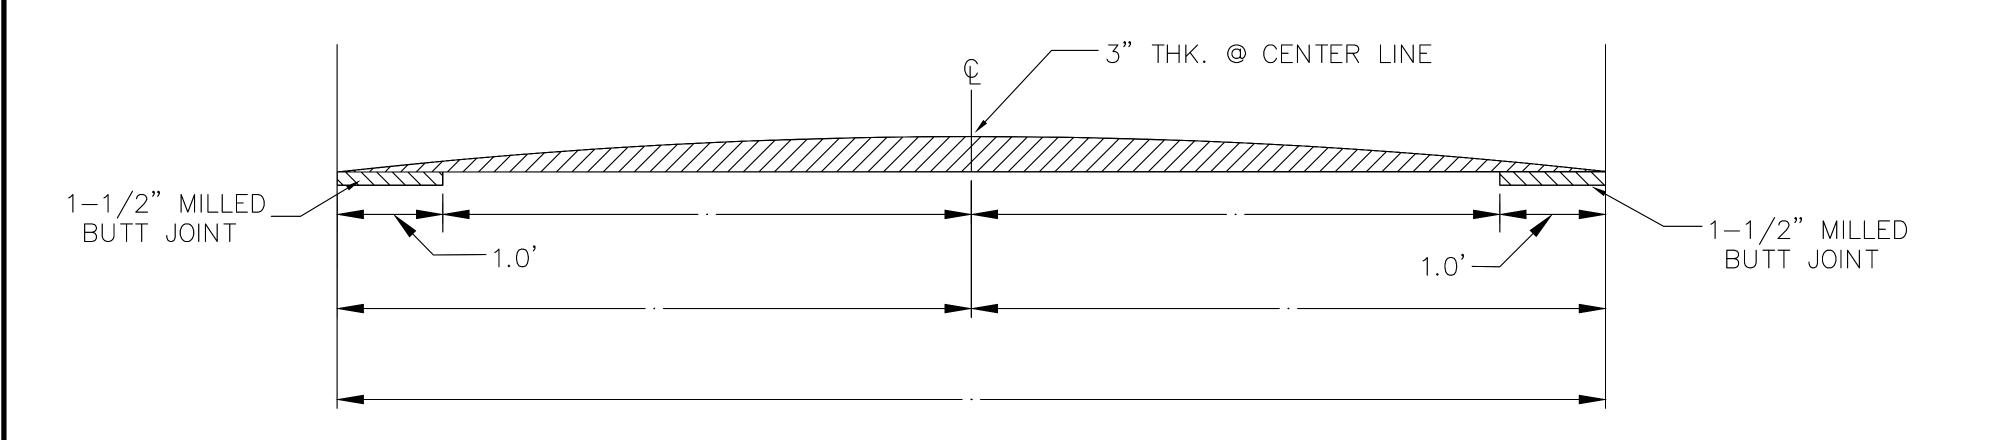

SPEED HUMP CROSS SECTION SECTION A-A


GENERAL NOTES

- 1. RAISED INTERSECTIONS SHALL FOLLOW THE SAME TAPER REQUIREMENT AS THE SPEED HUMPS DETAILED HEREIN.
- 2. PAYMENT FOR PAVEMENT MARKINGS FOR SPEED HUMPS AND RAISED INTERSECTIONS SHALL BE INCLUDED IN THE RESPECTIVE BID ITEMS AND SHALL NOT BE PAID FOR SEPARATELY.



ENGINEERING


CITY OF ANN ARBOR PUBLIC SERVICES 301 EAST HURON STREET, P.O. BOX 8647 ANN ARBOR, MICHIGAN 48107-8647 734-794-6410 www.a2gov.org

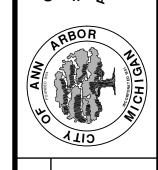

PROJECT MANAGEMENT - PUBLIC SERVICES - CITY OF ANN ARBOR

SCALE PLAN: NONE

STREET RESURFACING/RESTORATION
PROJECT - 2019
PROJECT - 2019

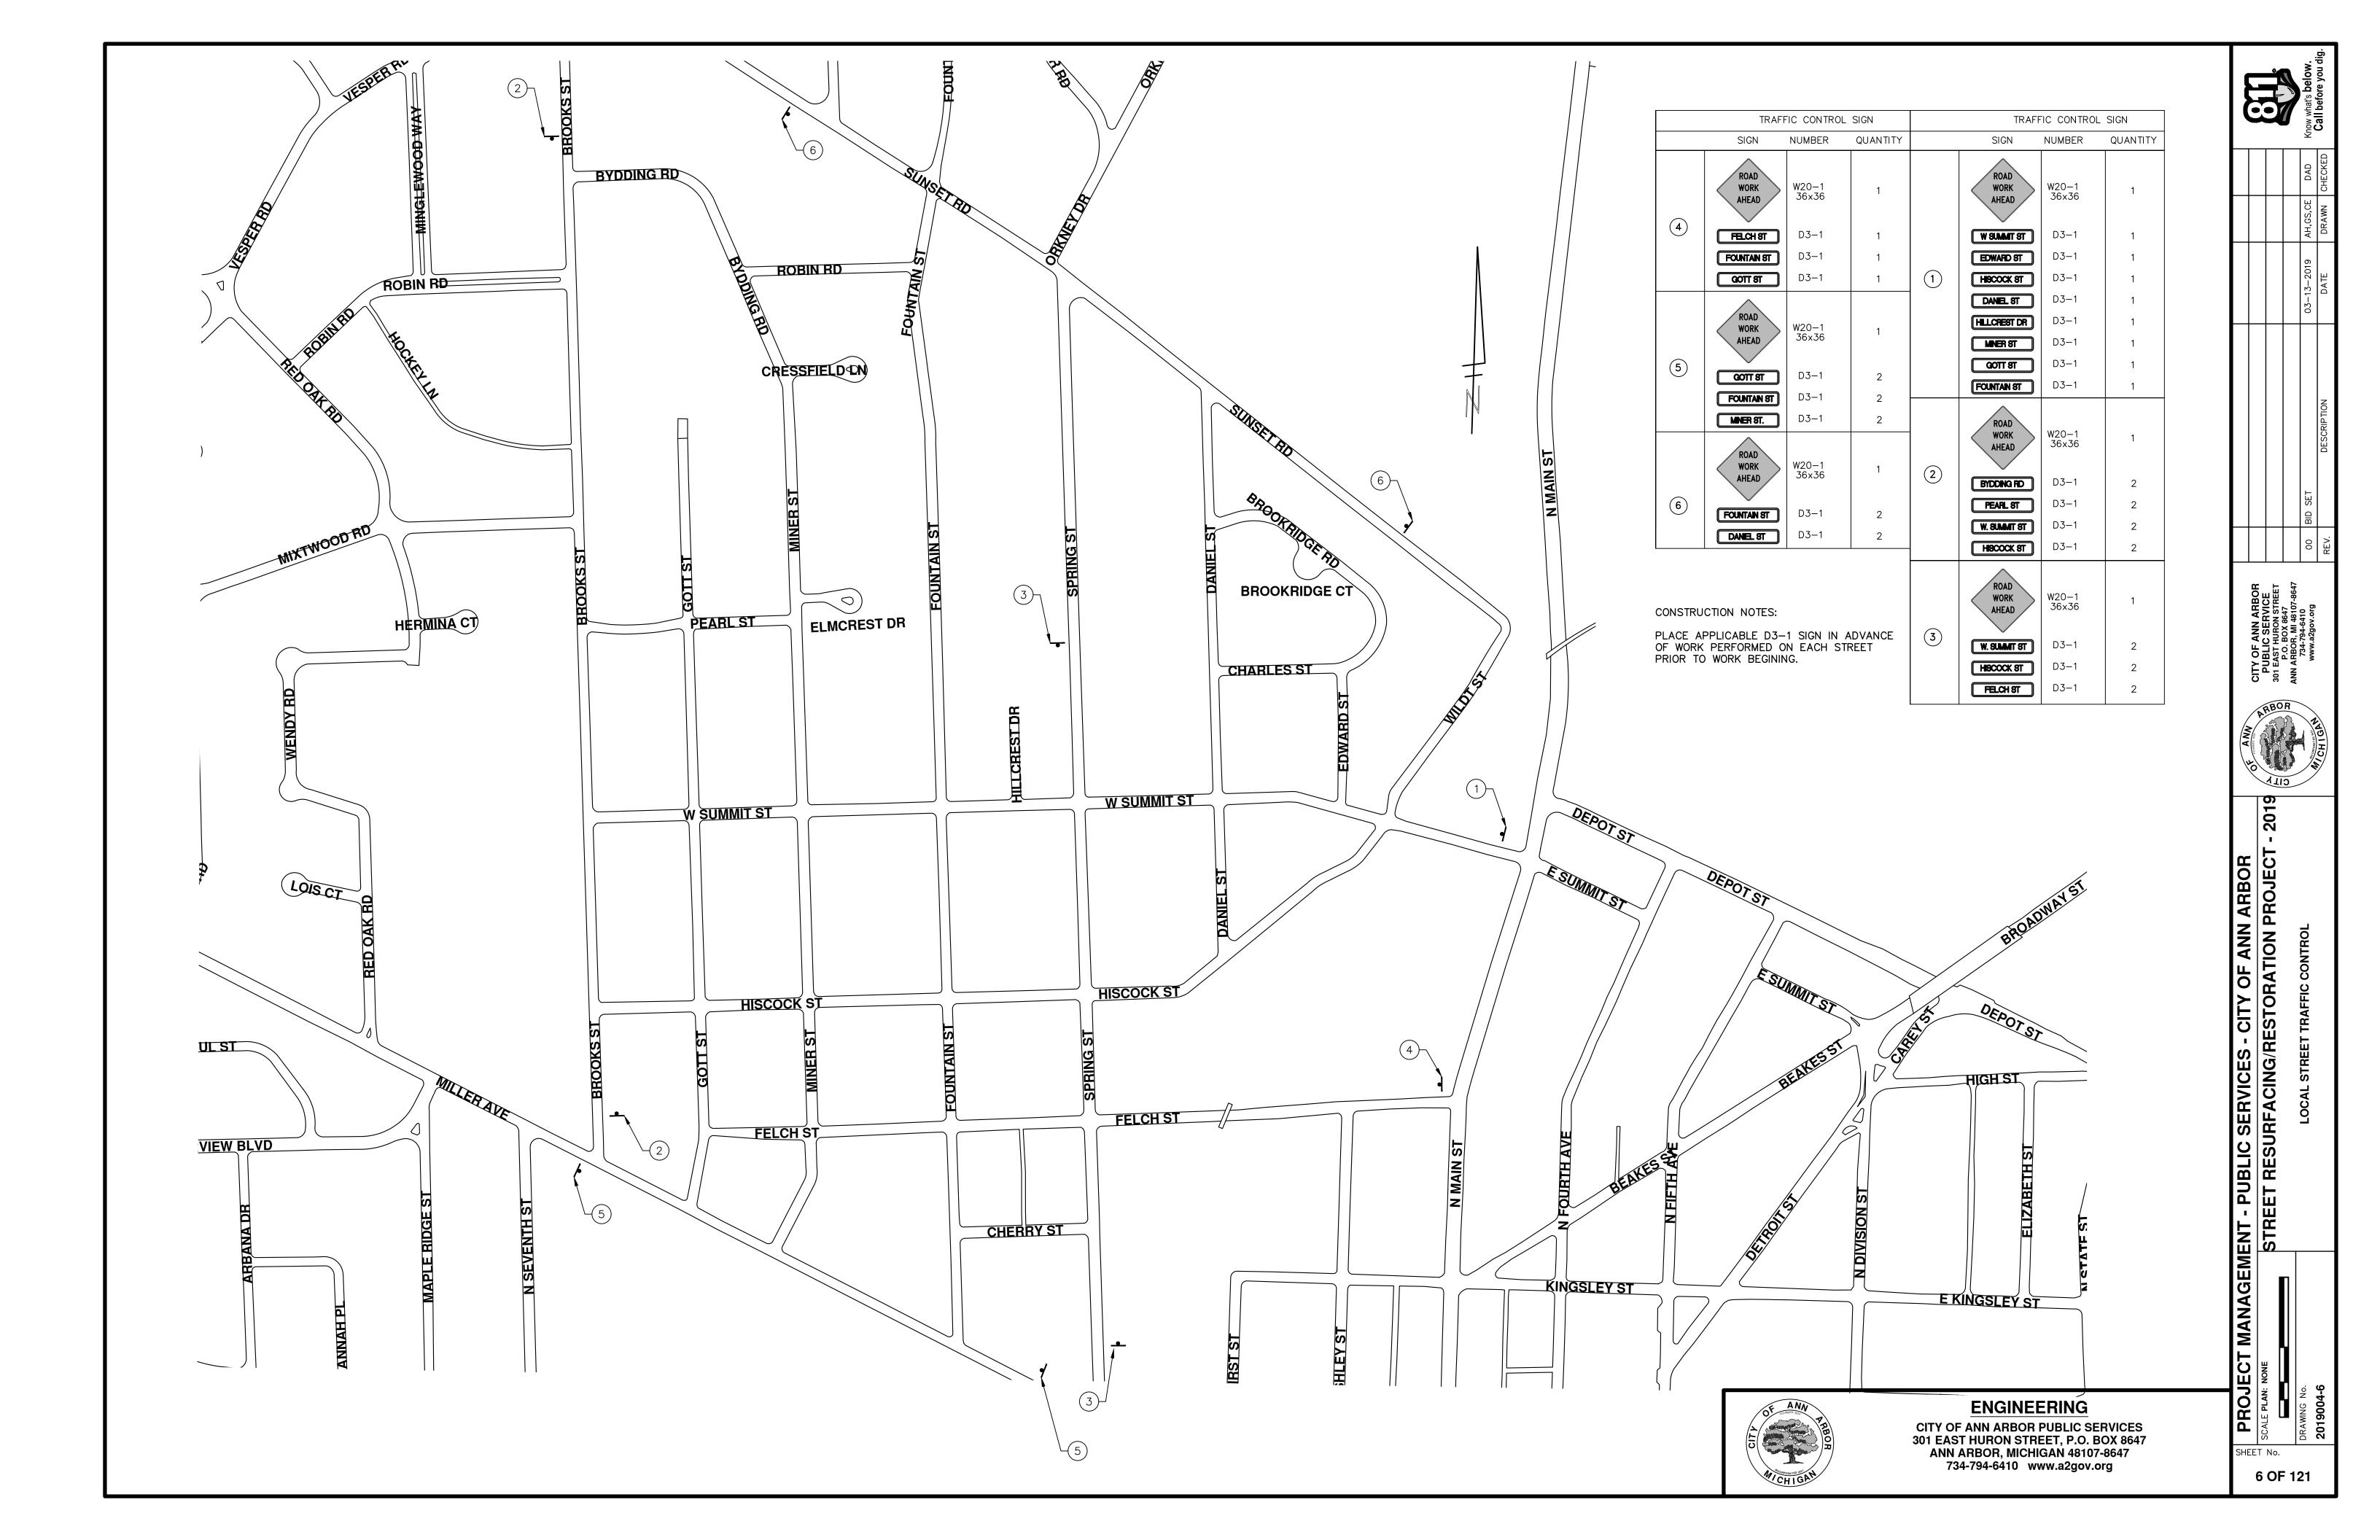



CITY OF ANN ARBOR ENGINEERING PROJECT LOCATION: BROOKRIDGE COURT

ITB No. 4570 FILE No. 2019004

	CONSTRUCTION KEY
KEY	ASSOCIATED PAY ITEM(S)
	• _Dr Structure, Adj, Case 1, Modified
AA	• _Dr Structure, Adj, Case 2, Modified
	_Dr Structure, Temp Lowering, Modified
	• _Dr Structure, Temp Lowering, Modified
AB	• _Gate Box, Adj, Case 1
AD	• _Gate Box, Adj, Case 2
	_Monument Box Adjust
ADST	Dr Structure, Adj, Add Depth, Modified
AK	Dr Structure, Adj, Case 1, Modified
	• _Sidewalk, Sidewalk Ramp, and Driveway Approach, Any Thickness, Rem
C4	Grading, Sidewalk
	Sidewalk, Conc, 4 inch, Modified
	• _Sidewalk, Sidewalk Ramp, and Driveway Approach, Any Thickness, Rem
	Grading, Sidewalk
C4HE	• Cement
	• _Sidewalk, Conc, 4 inch, Modified
	• _Sidewalk, Sidewalk Ramp, and Driveway Approach, Any Thickness, Rem
	• _Grading, Sidewalk
C6	• _Grading, Sidewalk Ramp
	• _Detectable Warning Surface, Modified
	• _Sidewalk Ramp, Conc, 6 inch, Modified
	• _Sidewalk, Conc, 6 inch, Modified
C8	• _Grading, Driveway Approach
	• _Driveway, Nonreinf Conc, 8 inch, Modified
	• _Sidewalk, Sidewalk Ramp, and Driveway Approach, Any Thickness, Rem
	Grading, Driveway Approach
	• _Grading, Sidewalk
	Grading, Sidewalk Ramp
0.115	• Cement
C HE	Driveway, Nonreinf Conc, 6 inch, Modified
	Driveway, Nonreinf Conc, 8 inch, Modified
	Detectable Warning Surface, Modified
	Sidewalk Ramp, Conc, 6 inch, Modified
	• _Sidewalk, Conc, 6 inch, Modified
	Curb, Gutter, and Curb and Gutter, Any Type, Rem
C/G	Curb and Gutter, Conc
CICLIE	• _Curb, Gutter, and Curb and Gutter, Any Type, Rem
C/GHE	• Cement
	• _Driveway Opening, Conc, Det M, Modified
CP	• _Grading, Sidewalk
	• _Sidewalk, Conc, 4 inch, Modified
CR	 _Sidewalk, Sidewalk Ramp, and Driveway Approach, Any Thickness, Rem
	Dr Structure, Rem
DS	Sewer, Rem, Less than 24 inch
	Dr Structure, 24 inch dia
	Dr Structure, Rem
DSDI	Sewer, Rem, Less than 24 inch
	• _Dr Structure, Double Inlet
PT	Dr Structure, Point
	Dr Structure Cover, Type B
	Dr Structure Cover, Type B, Special
RRA	• _Dr Structure, Adj, Case 1, Modified
	• _Dr Structure, Temp Lowering, Modified
RRK	Dr Structure Cover, Type K Dr Structure Adi Cocc 1 Medifod
RRK	• _Dr Structure, Adj, Case 1, Modified
	_Dr Structure, Adj, Case 1, Modified _Dr Structure, Reconstruct
RRK RS	 _Dr Structure, Adj, Case 1, Modified _Dr Structure, Reconstruct Plastic Drum, High Intensity, Lighted, Furn
RRK	_Dr Structure, Adj, Case 1, Modified _Dr Structure, Reconstruct

NOTES:

FOR PROTECTION OF UNDERGROUND UTILITIES AND IN CONFORMANCE WITH PUBLIC ACT 174 OF 2013, THE CONTRACTOR SHALL CALL 811 OR 1-800-482-7171 A MINIMUM OF THREE FULL WORKING DAYS, EXCLUDING SATURDAYS, SUNDAYS, AND HOLIDAYS, PRIOR TO BEGINNING EACH EXCAVATION IN AREAS WHERE PUBLIC UTILITIES HAVE NOT BEEN PREVIOUSLY LOCATED. MEMBERS WILL THUS BE ROUTINELY NOTIFIED. THIS DOES NOT RELIEVE THE CONTRACTOR OF THE RESPONSIBILITY OF NOTIFYING UTILITY OWNERS WHO MAY NOT BE A PART OF THE "MISS DIG" ALERT SYSTEM.

THE UNDERGROUND LOCATIONS SHOWN FOR NATURAL GAS, TELEPHONE, ELECTRICAL POWER, CABLE TV AND FIBER OPTIC LINES ARE APPROXIMATE. THE CITY OF ANN ARBOR ASSUMES NO RESPONSIBILITY FOR THEIR ACCURATE REPRESENTATION IN THIS DRAWING. MISS DIG MUST BE CONTACTED PRIOR TO CONSTRUCTION TO LOCATE THESE UTILITIES.

THE IMPROVEMENTS COVERED BY THESE PLANS SHALL BE PERFORMED IN ACCORDANCE WITH MICHIGAN DEPARTMENT OF TRANSPORTATION (MDOT) 2012 STANDARD SPECIFICATIONS FOR CONSTRUCTION, INCLUDING REFERENCED MDOT PUBLICATIONS, AND THE PROJECT CONTRACT DOCUMENTS.



ENGINEERING

CITY OF ANN ARBOR PUBLIC SERVICES 301 EAST HURON STREET, P.O. BOX 8647 ANN ARBOR, MICHIGAN 48107-8647 734-794-6410 www.a2gov.org


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		DAD	DRAWN CHECKED	
		AH,GS,CE	DRAWN	
		03-13-2019	DATE	
) SET	DESCRIPTION	



F RESURFACING/RESTC PROJECT - 2019
SUBSET COVER SHEET

SHEET No.

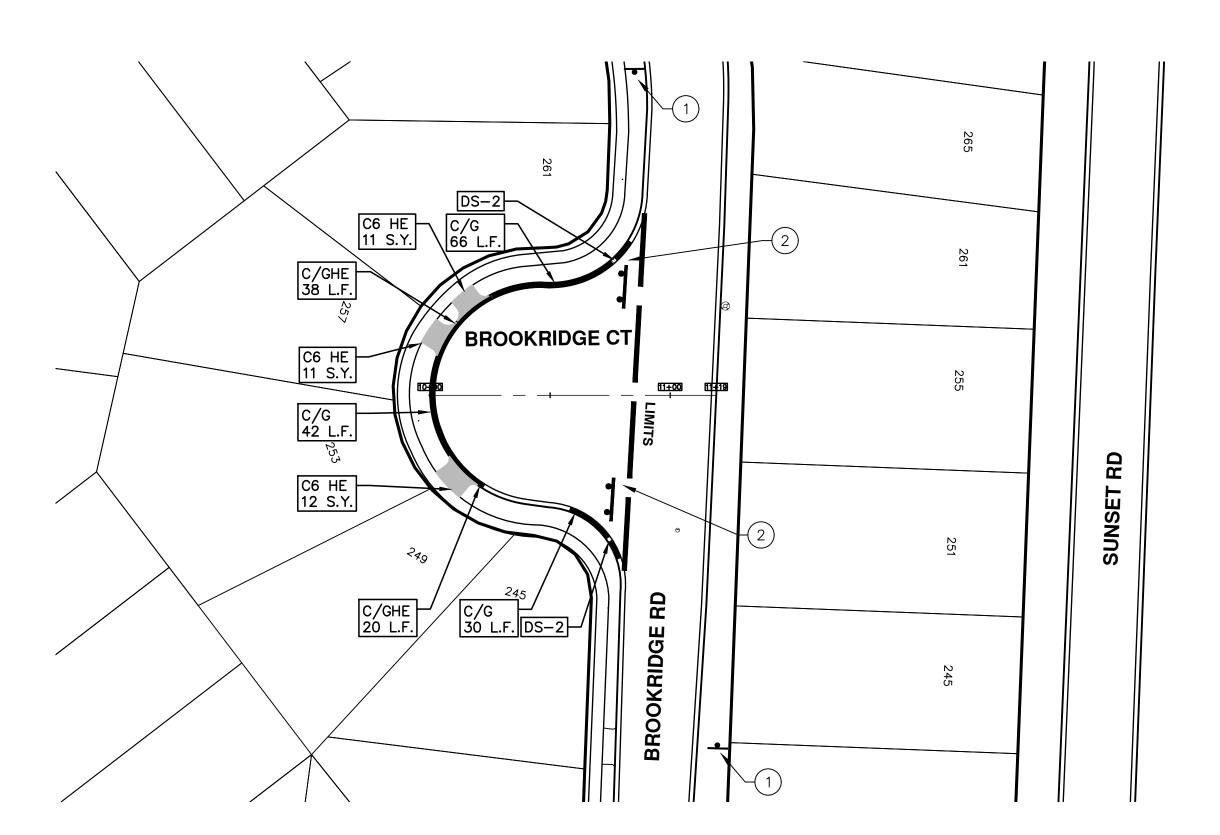

TRAFFIC CONTROL SIGN						
	SIGN	NUMBER	QUANTITY			
1	ROAD CLOSED AHEAD BROOKRIDGE CT.	W20-3 36x36 D3-1	2			
2		BARRICADE TYPE III HIGH INTENSITY LIGHTED	2			



CITY OF ANN ARBOR PUBLIC SERVICES 301 EAST HURON STREET, P.O. BOX 8647 ANN ARBOR, MICHIGAN 48107-8647 734-794-6410 www.a2gov.org

ENGINEERING

CITY OF ANN ARBOR - PUBLIC SERVICES - ENGINEERING

SCALE PLAN: 1:40

DRAWING No.

DRAWING No.

2019004-8

CITY OF ANN ARBOR - PUBLIC SERVICES - ENGINEERING

STA: 10+00 - STA: 11+19



CITY OF ANN ARBOR ENGINEERING PROJECT LOCATION: BYDDING ROAD

ITB No. 4570 FILE No. 2019004

1991 1001	CONSTRUCTION KEY
KEY	ASSOCIATED PAY ITEM(S)
	• _Dr Structure, Adj, Case 1, Modified
AA	• _Dr Structure, Adj, Case 2, Modified
	• _Dr Structure, Temp Lowering, Modified
	• _Dr Structure, Temp Lowering, Modified
AB	• _Gate Box, Adj, Case 1
ΛD	• _Gate Box, Adj, Case 2
	• _Monument Box Adjust
ADST	• _Dr Structure, Adj, Add Depth, Modified
AK	• _Dr Structure, Adj, Case 1, Modified
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C4	• _Grading, Sidewalk
	• _Sidewalk, Conc, 4 inch, Modified
	• _Sidewalk, Sidewalk Ramp, and Driveway Approach, Any Thickness, Rem
OALIE	• _Grading, Sidewalk
C4HE	• Cement
	• _Sidewalk, Conc, 4 inch, Modified
	• _Sidewalk, Sidewalk Ramp, and Driveway Approach, Any Thickness, Rem
	• _Grading, Sidewalk
	Grading, Sidewalk Ramp
C6	Detectable Warning Surface, Modified
	• _Sidewalk Ramp, Conc, 6 inch, Modified
	• _Sidewalk, Conc, 6 inch, Modified
	• _Grading, Driveway Approach
C8	Driveway, Nonreinf Conc, 8 inch, Modified
	- **
	• _Sidewalk, Sidewalk Ramp, and Driveway Approach, Any Thickness, Rem
	• _Grading, Driveway Approach
	• _Grading, Sidewalk
	• _Grading, Sidewalk Ramp
C HE	• Cement
	• _Driveway, Nonreinf Conc, 6 inch, Modified
	• _Driveway, Nonreinf Conc, 8 inch, Modified
	• _Detectable Warning Surface, Modified
	• _Sidewalk Ramp, Conc, 6 inch, Modified
	• _Sidewalk, Conc, 6 inch, Modified
C/G	• _Curb, Gutter, and Curb and Gutter, Any Type, Rem
0,0	• _Curb and Gutter, Conc
	• _Curb, Gutter, and Curb and Gutter, Any Type, Rem
C/GHE	Cement
	• _Driveway Opening, Conc, Det M, Modified
CD.	• _Grading, Sidewalk
CP	Sidewalk, Conc, 4 inch, Modified
CR	 Sidewalk, Sidewalk Ramp, and Driveway Approach, Any Thickness, Rem
	• Dr Structure, Rem
DS	Sewer, Rem, Less than 24 inch
	Dr Structure, 24 inch dia
	• Dr Structure, Rem
DSDI	• Sewer, Rem, Less than 24 inch
505.	• Dr Structure, Double Inlet
PT	Dr Structure, Point
- 1	Dr Structure Cover, Type B
RRA	• _Dr Structure Cover, Type B, Special
	• _Dr Structure, Adj, Case 1, Modified
	• _Dr Structure, Temp Lowering, Modified
RRK	Dr Structure Cover, Type K
	• _Dr Structure, Adj, Case 1, Modified
RS	• _Dr Structure, Reconstruct
TYPE II	Plastic Drum, High Intensity, Lighted, Furn
— 11	Plastic Drum, High Intensity, Lighted, Oper
TYPE III	Barricade, Type III, High Intensity, Double Sided, Lighted, Furn
🛏 1111	Barricade, Type III, High Intensity, Double Sided, Lighted, Oper



- CITY OF ANN ARBO

NOTES:


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ENGINEERING





CITY OF ANN ARBOR ENGINEERING PROJECT LOCATION: CHARLES STREET

-

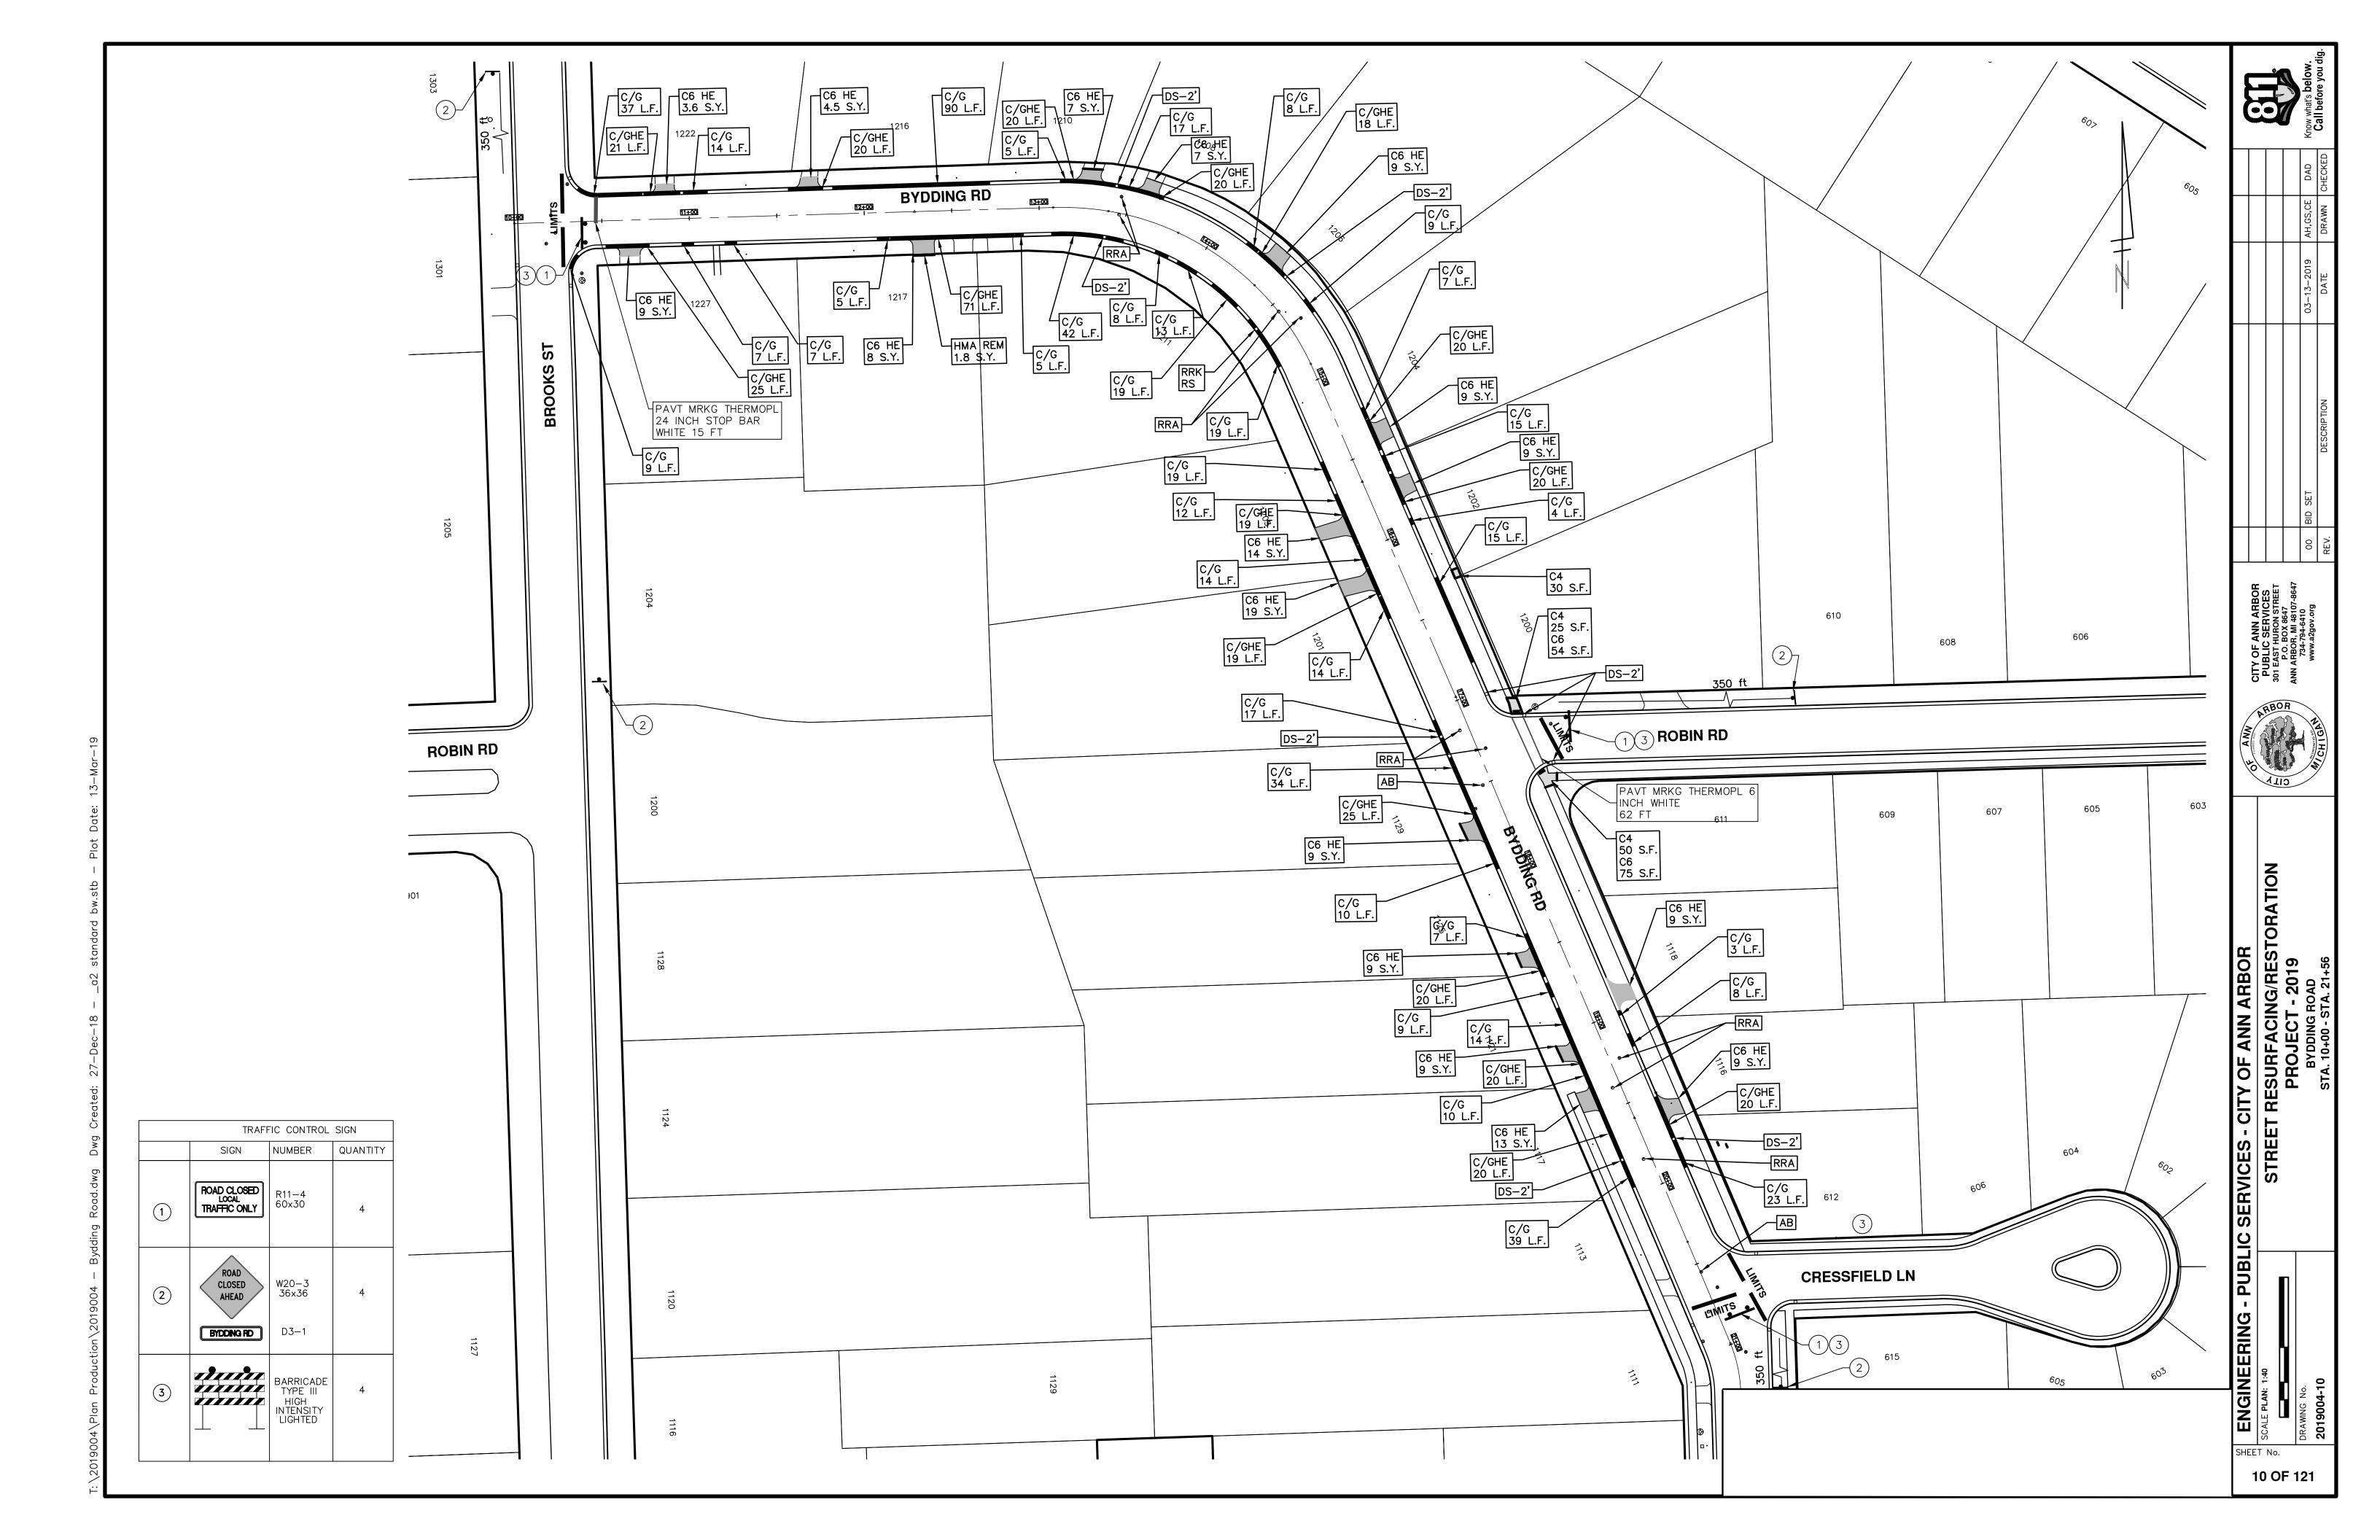ITB No. 4570 FILE No. 2019004

	CONSTRUCTION KEY
KEY	ASSOCIATED PAY ITEM(S)
	• _Dr Structure, Adj, Case 1, Modified
AA	• _Dr Structure, Adj, Case 2, Modified
	• _Dr Structure, Temp Lowering, Modified
	• _Dr Structure, Temp Lowering, Modified
AB	• _Gate Box, Adj, Case 1
, , ,	• _Gate Box, Adj, Case 2
	• _Monument Box Adjust
ADST	• _Dr Structure, Adj, Add Depth, Modified
AK	• _Dr Structure, Adj, Case 1, Modified
	• _Sidewalk, Sidewalk Ramp, and Driveway Approach, Any Thickness, Rem
C4	• _Grading, Sidewalk
	• _Sidewalk, Conc, 4 inch, Modified
	• _Sidewalk, Sidewalk Ramp, and Driveway Approach, Any Thickness, Rem
C4HE	• _Grading, Sidewalk
01112	Cement
	• _Sidewalk, Conc, 4 inch, Modified
	• _Sidewalk, Sidewalk Ramp, and Driveway Approach, Any Thickness, Rem
	• _Grading, Sidewalk
C6	• _Grading, Sidewalk Ramp
	_Detectable Warning Surface, Modified
	• _Sidewalk Ramp, Conc, 6 inch, Modified
	• _Sidewalk, Conc, 6 inch, Modified
C8	• _Grading, Driveway Approach
	• _Driveway, Nonreinf Conc, 8 inch, Modified
	• _Sidewalk, Sidewalk Ramp, and Driveway Approach, Any Thickness, Rem
	• _Grading, Driveway Approach
	• _Grading, Sidewalk
	• _Grading, Sidewalk Ramp
C HE	Cement
OTIL	• _Driveway, Nonreinf Conc, 6 inch, Modified
	• _Driveway, Nonreinf Conc, 8 inch, Modified
	• _Detectable Warning Surface, Modified
	• _Sidewalk Ramp, Conc, 6 inch, Modified
	• _Sidewalk, Conc, 6 inch, Modified
C/G	• _Curb, Gutter, and Curb and Gutter, Any Type, Rem
<i></i>	• _Curb and Gutter, Conc
	• _Curb, Gutter, and Curb and Gutter, Any Type, Rem
C/GHE	Cement
	• _Driveway Opening, Conc, Det M, Modified
CP	• _Grading, Sidewalk
	• _Sidewalk, Conc, 4 inch, Modified
CR	• _Sidewalk, Sidewalk Ramp, and Driveway Approach, Any Thickness, Rem
	• Dr Structure, Rem
DS	• Sewer, Rem, Less than 24 inch
	Dr Structure, 24 inch dia
	Dr Structure, Rem
D05:	
DSDI	Sewer, Rem, Less than 24 inch
	Sewer, Rem, Less than 24 inch _Dr Structure, Double Inlet
DSDI PT	Sewer, Rem, Less than 24 inch _Dr Structure, Double Inlet _Dr Structure, Point
	 Sewer, Rem, Less than 24 inch _Dr Structure, Double Inlet _Dr Structure, Point Dr Structure Cover, Type B
	 Sewer, Rem, Less than 24 inch _Dr Structure, Double Inlet _Dr Structure, Point Dr Structure Cover, Type B _Dr Structure Cover, Type B, Special
PT	 Sewer, Rem, Less than 24 inch _Dr Structure, Double Inlet _Dr Structure, Point Dr Structure Cover, Type B _Dr Structure Cover, Type B, Special _Dr Structure, Adj, Case 1, Modified
PT	 Sewer, Rem, Less than 24 inch _Dr Structure, Double Inlet _Dr Structure, Point Dr Structure Cover, Type B _Dr Structure Cover, Type B, Special _Dr Structure, Adj, Case 1, Modified _Dr Structure, Temp Lowering, Modified
PT RRA	 Sewer, Rem, Less than 24 inch _Dr Structure, Double Inlet _Dr Structure, Point Dr Structure Cover, Type B _Dr Structure Cover, Type B, Special _Dr Structure, Adj, Case 1, Modified _Dr Structure, Temp Lowering, Modified Dr Structure Cover, Type K
PT RRA RRK	 Sewer, Rem, Less than 24 inch _Dr Structure, Double Inlet _Dr Structure, Point Dr Structure Cover, Type B _Dr Structure Cover, Type B, Special _Dr Structure, Adj, Case 1, Modified _Dr Structure, Temp Lowering, Modified Dr Structure Cover, Type K _Dr Structure, Adj, Case 1, Modified
PT RRA	 Sewer, Rem, Less than 24 inch _Dr Structure, Double Inlet _Dr Structure, Point Dr Structure Cover, Type B _Dr Structure Cover, Type B, Special _Dr Structure, Adj, Case 1, Modified _Dr Structure, Temp Lowering, Modified Dr Structure Cover, Type K _Dr Structure, Adj, Case 1, Modified _Dr Structure, Adj, Case 1, Modified _Dr Structure, Reconstruct
PT RRA RRK RS	 Sewer, Rem, Less than 24 inch _Dr Structure, Double Inlet _Dr Structure, Point Dr Structure Cover, Type B _Dr Structure Cover, Type B, Special _Dr Structure, Adj, Case 1, Modified _Dr Structure, Temp Lowering, Modified Dr Structure Cover, Type K _Dr Structure, Adj, Case 1, Modified _Dr Structure, Adj, Case 1, Modified _Dr Structure, Reconstruct Plastic Drum, High Intensity, Lighted, Furm
PT RRA RRK	 Sewer, Rem, Less than 24 inch _Dr Structure, Double Inlet _Dr Structure, Point Dr Structure Cover, Type B _Dr Structure Cover, Type B, Special _Dr Structure, Adj, Case 1, Modified _Dr Structure, Temp Lowering, Modified Dr Structure Cover, Type K _Dr Structure, Adj, Case 1, Modified _Dr Structure, Adj, Case 1, Modified _Dr Structure, Reconstruct

NOTES:

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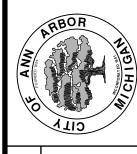


ENGINEERING

CITY OF ANN ARBOR PUBLIC SERVICES 301 EAST HURON STREET, P.O. BOX 8647 ANN ARBOR, MICHIGAN 48107-8647 734-794-6410 www.a2gov.org

		DAD	снескер	
		AH,GS,CE	DRAWN	
		03-13-2019	DATE	
			DESCRIPTION	

TY OF ANN ARBOR DUBLIC SERVICES 1 EAST HURON STREET P.O. BOX 8647 N ARBOR, MI 48107-8647 734-794-6410 www.a2gov.org




ARBOR
NG/RESTORATION
- 2019

CES - CITY OF ANN ARBOR
TREET RESURFACING/RESTC
PROJECT - 2019
SUBSET COVER SHEET

RING - PUBLIC SERVICE
STI

AWING No. **019004-11**

SCALE SCALE
DRAWING

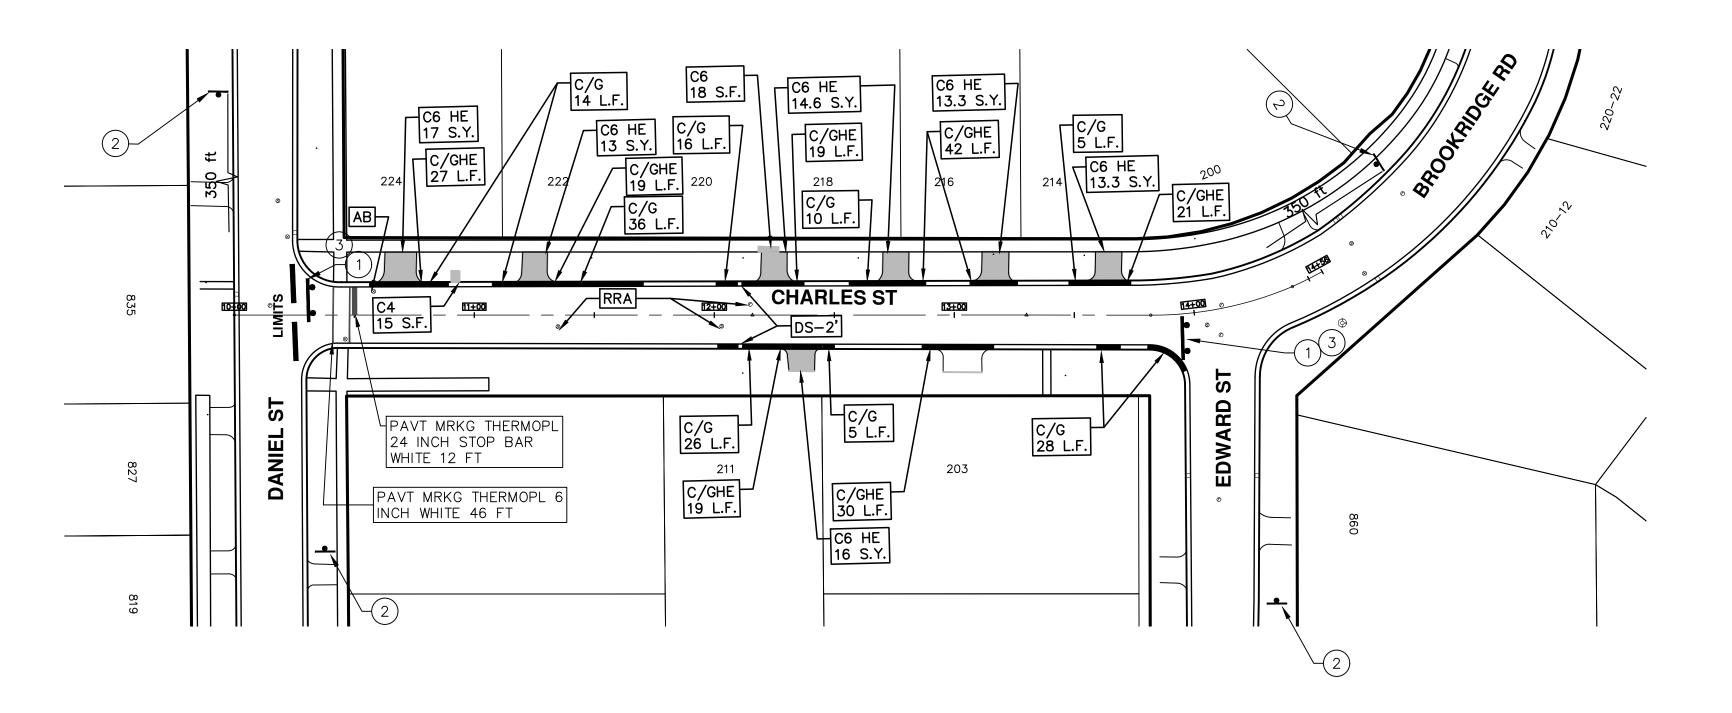

	TRAFFIC CONTROL SIGN						
	SIGN	NUMBER	QUANTITY				
1	ROAD CLOSED LOCAL TRAFFIC ONLY	R11-4 60x30	2				
2	ROAD CLOSED AHEAD	W20-3 36x36 D3-1	4				
3		BARRICADE TYPE III HIGH INTENSITY LIGHTED	2				

ENGINEERING - PUBLIC SERVICES - CITY OF ANN ARBOR

SCALE PLAN: 1:40

DRAWING No.

DRAWING No.

2019004-12

SCALE PLAN 1:40

STREET RESURFACING/RESTORATION
CHARLES STREET
STA. 10+00 - STA. 14+56

12 OF 121

ENGINEERING

CITY OF ANN ARBOR PUBLIC SERVICES 301 EAST HURON STREET, P.O. BOX 8647 ANN ARBOR, MICHIGAN 48107-8647 734-794-6410 www.a2gov.org


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CITY OF ANN ARBOR ENGINEERING PROJECT LOCATION: CRESSFIELD LANE

ITB No. 4570 FILE No. 2019004

	CONSTRUCTION KEY
KEY	ASSOCIATED PAY ITEM(S)
	• _Dr Structure, Adj, Case 1, Modified
AA	• _Dr Structure, Adj, Case 2, Modified
	Dr Structure, Temp Lowering, Modified
	Dr Structure, Temp Lowering, Modified
	• _Gate Box, Adj, Case 1
AB	• _Gate Box, Adj, Case 2
	Monument Box Adjust
ADST	-
	• _Dr Structure, Adj, Add Depth, Modified
AK	• _Dr Structure, Adj, Case 1, Modified
0.4	• _Sidewalk, Sidewalk Ramp, and Driveway Approach, Any Thickness, Rem
C4	• _Grading, Sidewalk
	• _Sidewalk, Conc, 4 inch, Modified
	• _Sidewalk, Sidewalk Ramp, and Driveway Approach, Any Thickness, Rem
C4HE	• _Grading, Sidewalk
OTIL	Cement
	• _Sidewalk, Conc, 4 inch, Modified
	• _Sidewalk, Sidewalk Ramp, and Driveway Approach, Any Thickness, Rem
	• _Grading, Sidewalk
00	• _Grading, Sidewalk Ramp
C6	Detectable Warning Surface, Modified
	- Sidewalk Ramp, Conc, 6 inch, Modified
	• _Sidewalk, Conc, 6 inch, Modified
	Grading, Driveway Approach
C8	Driveway, Nonreinf Conc, 8 inch, Modified
	• _Sidewalk, Sidewalk Ramp, and Driveway Approach, Any Thickness, Rem
	Grading, Driveway Approach
	• _Grading, Sidewalk
	• _Grading, Sidewalk Ramp
C HE	• Cement
	• _Driveway, Nonreinf Conc, 6 inch, Modified
	• _Driveway, Nonreinf Conc, 8 inch, Modified
	• _Detectable Warning Surface, Modified
	• _Sidewalk Ramp, Conc, 6 inch, Modified
	• _Sidewalk, Conc, 6 inch, Modified
0/0	Curb, Gutter, and Curb and Gutter, Any Type, Rem
C/G	Curb and Gutter, Conc
	• _Curb, Gutter, and Curb and Gutter, Any Type, Rem
C/GHE	• Cement
0, 0, 1,	Driveway Opening, Conc, Det M, Modified
	Grading, Sidewalk
CP	
<u> </u>	• _Sidewalk, Conc, 4 inch, Modified
CR	• _Sidewalk, Sidewalk Ramp, and Driveway Approach, Any Thickness, Rem
50	• Dr Structure, Rem
DS	• Sewer, Rem, Less than 24 inch
	Dr Structure, 24 inch dia
	Dr Structure, Rem
DSDI	Sewer, Rem, Less than 24 inch
	• _Dr Structure, Double Inlet
PT	• _Dr Structure, Point
	Dr Structure Cover, Type B
	Dr Structure Cover, Type B, Special
RRA	• _Dr Structure, Adj, Case 1, Modified
	• _Dr Structure, Temp Lowering, Modified
RRK	• Dr Structure Cover, Type K
	• _Dr Structure, Adj, Case 1, Modified
RS	• _Dr Structure, Reconstruct
TYPE II	Plastic Drum, High Intensity, Lighted, Furn
rrf⊆ II	Plastic Drum, High Intensity, Lighted, Oper
	Barricade Type III High Intensity Double Sided Lighted Furn
TYPE III	



F RESURFACING/RESTC PROJECT - 2019

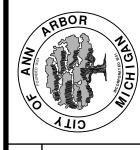CRESSFIELD LANE

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SHEET No.

13 OF 121

NOTES:


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ENGINEERING



	TRAFF	FIC CONTROL	SIGN
	SIGN	NUMBER	QUANTITY
1	ROAD CLOSED LOCAL TRAFFIC ONLY	R11-4 60x30	1
2	ROAD CLOSED AHEAD	W20-3 36x36 D3-1	2
3		BARRICADE TYPE III HIGH INTENSITY LIGHTED	1

ENGINEERING

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ENGINEERING - PUBLIC SERVICES - CITY OF ANN ARBOR

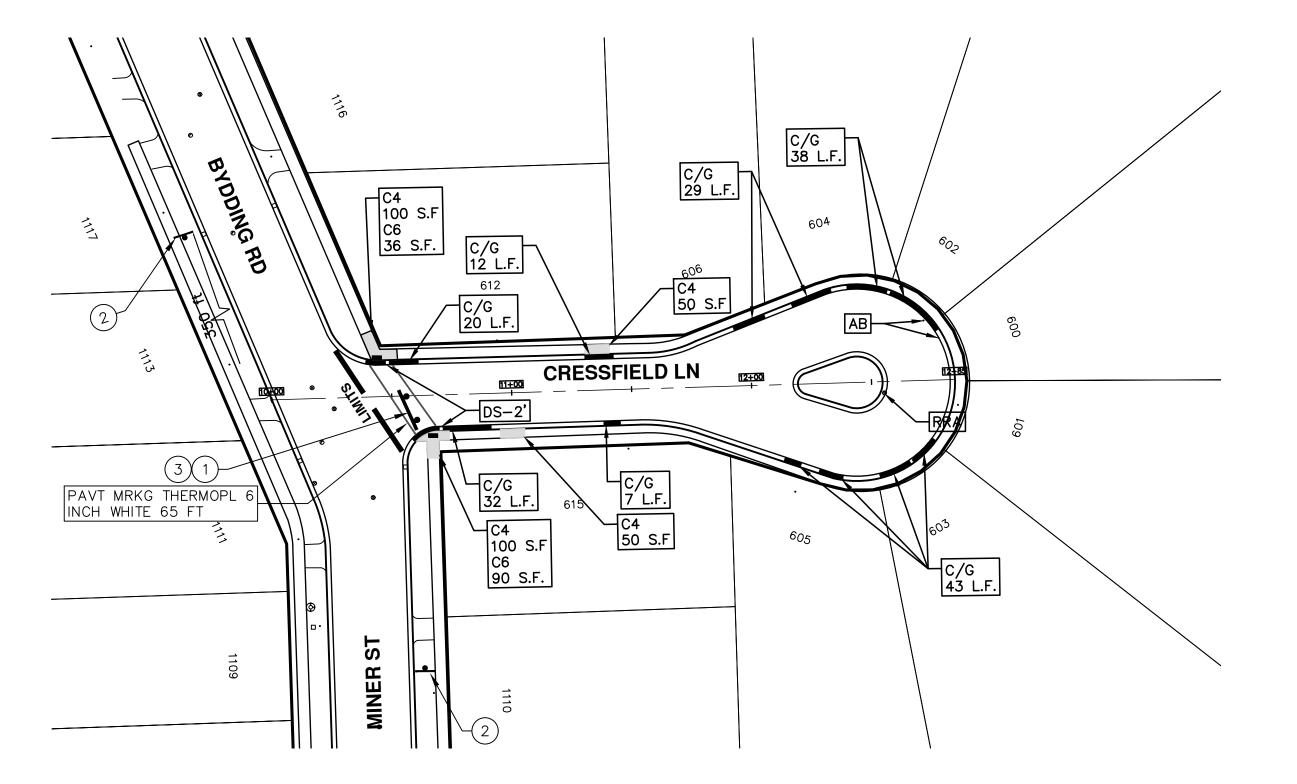SCALE PLAN: 1:40

DRAWING No.

CRESSFIELD LANE
STA. 10+00 - STA. 12+85



CITY OF ANN ARBOR ENGINEERING PROJECT LOCATION: DANIEL STREET

ITB No. 4570 FILE No. 2019004

	CONSTRUCTION KEY
KEY	ASSOCIATED PAY ITEM(S)
	• _Dr Structure, Adj, Case 1, Modified
AA	• _Dr Structure, Adj, Case 2, Modified
	• _Dr Structure, Temp Lowering, Modified
	Dr Structure, Temp Lowering, Modified
AB	• _Gate Box, Adj, Case 1
AD	• _Gate Box, Adj, Case 2
	• _Monument Box Adjust
ADST	• _Dr Structure, Adj, Add Depth, Modified
AK	• _Dr Structure, Adj, Case 1, Modified
	• _Sidewalk, Sidewalk Ramp, and Driveway Approach, Any Thickness, Rem
C4	• _Grading, Sidewalk
	• _Sidewalk, Conc, 4 inch, Modified
	• _Sidewalk, Sidewalk Ramp, and Driveway Approach, Any Thickness, Rem
C4HE	• _Grading, Sidewalk
	• Cement
	• _Sidewalk, Conc, 4 inch, Modified
	• _Sidewalk, Sidewalk Ramp, and Driveway Approach, Any Thickness, Rem
	• _Grading, Sidewalk
C6	• _Grading, Sidewalk Ramp
	• _Detectable Warning Surface, Modified
	• _Sidewalk Ramp, Conc, 6 inch, Modified
	• _Sidewalk, Conc, 6 inch, Modified
C8	• _Grading, Driveway Approach
	 _Driveway, Nonreinf Conc, 8 inch, Modified _Sidewalk, Sidewalk Ramp, and Driveway Approach, Any Thickness, Rem
	Grading, Driveway ApproachGrading, Sidewalk
	Grading, Sidewalk RampCement
C HE	Driveway, Nonreinf Conc, 6 inch, Modified
	Driveway, Nonreinf Conc, 8 inch, Modified Driveway, Nonreinf Conc, 8 inch, Modified
	Detectable Warning Surface, Modified
	Sidewalk Ramp, Conc, 6 inch, Modified
	• Sidewalk, Conc, 6 inch, Modified
	• _Curb, Gutter, and Curb and Gutter, Any Type, Rem
C/G	Curb and Gutter, Conc
	Curb, Gutter, and Curb and Gutter, Any Type, Rem
C/GHE	• Cement
0, 01.12	• _Driveway Opening, Conc, Det M, Modified
	• _Grading, Sidewalk
CP	Sidewalk, Conc, 4 inch, Modified
CR	• _Sidewalk, Sidewalk Ramp, and Driveway Approach, Any Thickness, Rem
	• Dr Structure, Rem
DS	• Sewer, Rem, Less than 24 inch
	Dr Structure, 24 inch dia
	• Dr Structure, Rem
DSDI	• Sewer, Rem, Less than 24 inch
	• _Dr Structure, Double Inlet
PT	• _Dr Structure, Point
	Dr Structure Cover, Type B
DDA	• _Dr Structure Cover, Type B, Special
RRA	Dr Structure, Adj, Case 1, Modified
	Dr Structure, Temp Lowering, Modified
	Dr Structure Cover, Type K
RRK	• _Dr Structure, Adj, Case 1, Modified
RS	• _Dr Structure, Reconstruct
T/DC "	Plastic Drum, High Intensity, Lighted, Furn
TYPE II	Plastic Drum, High Intensity, Lighted, Oper
TYPE II	Plastic Drum, High Intensity, Lighted, Oper Barricade, Type III, High Intensity, Double Sided, Lighted, Furn

Y OF ANN ARBOR
ESURFACING/REST
PROJECT - 2019
DANIEL STREET
SUBSET COVER SHEET

SHEET No.

15 OF 121

ENGINEERING

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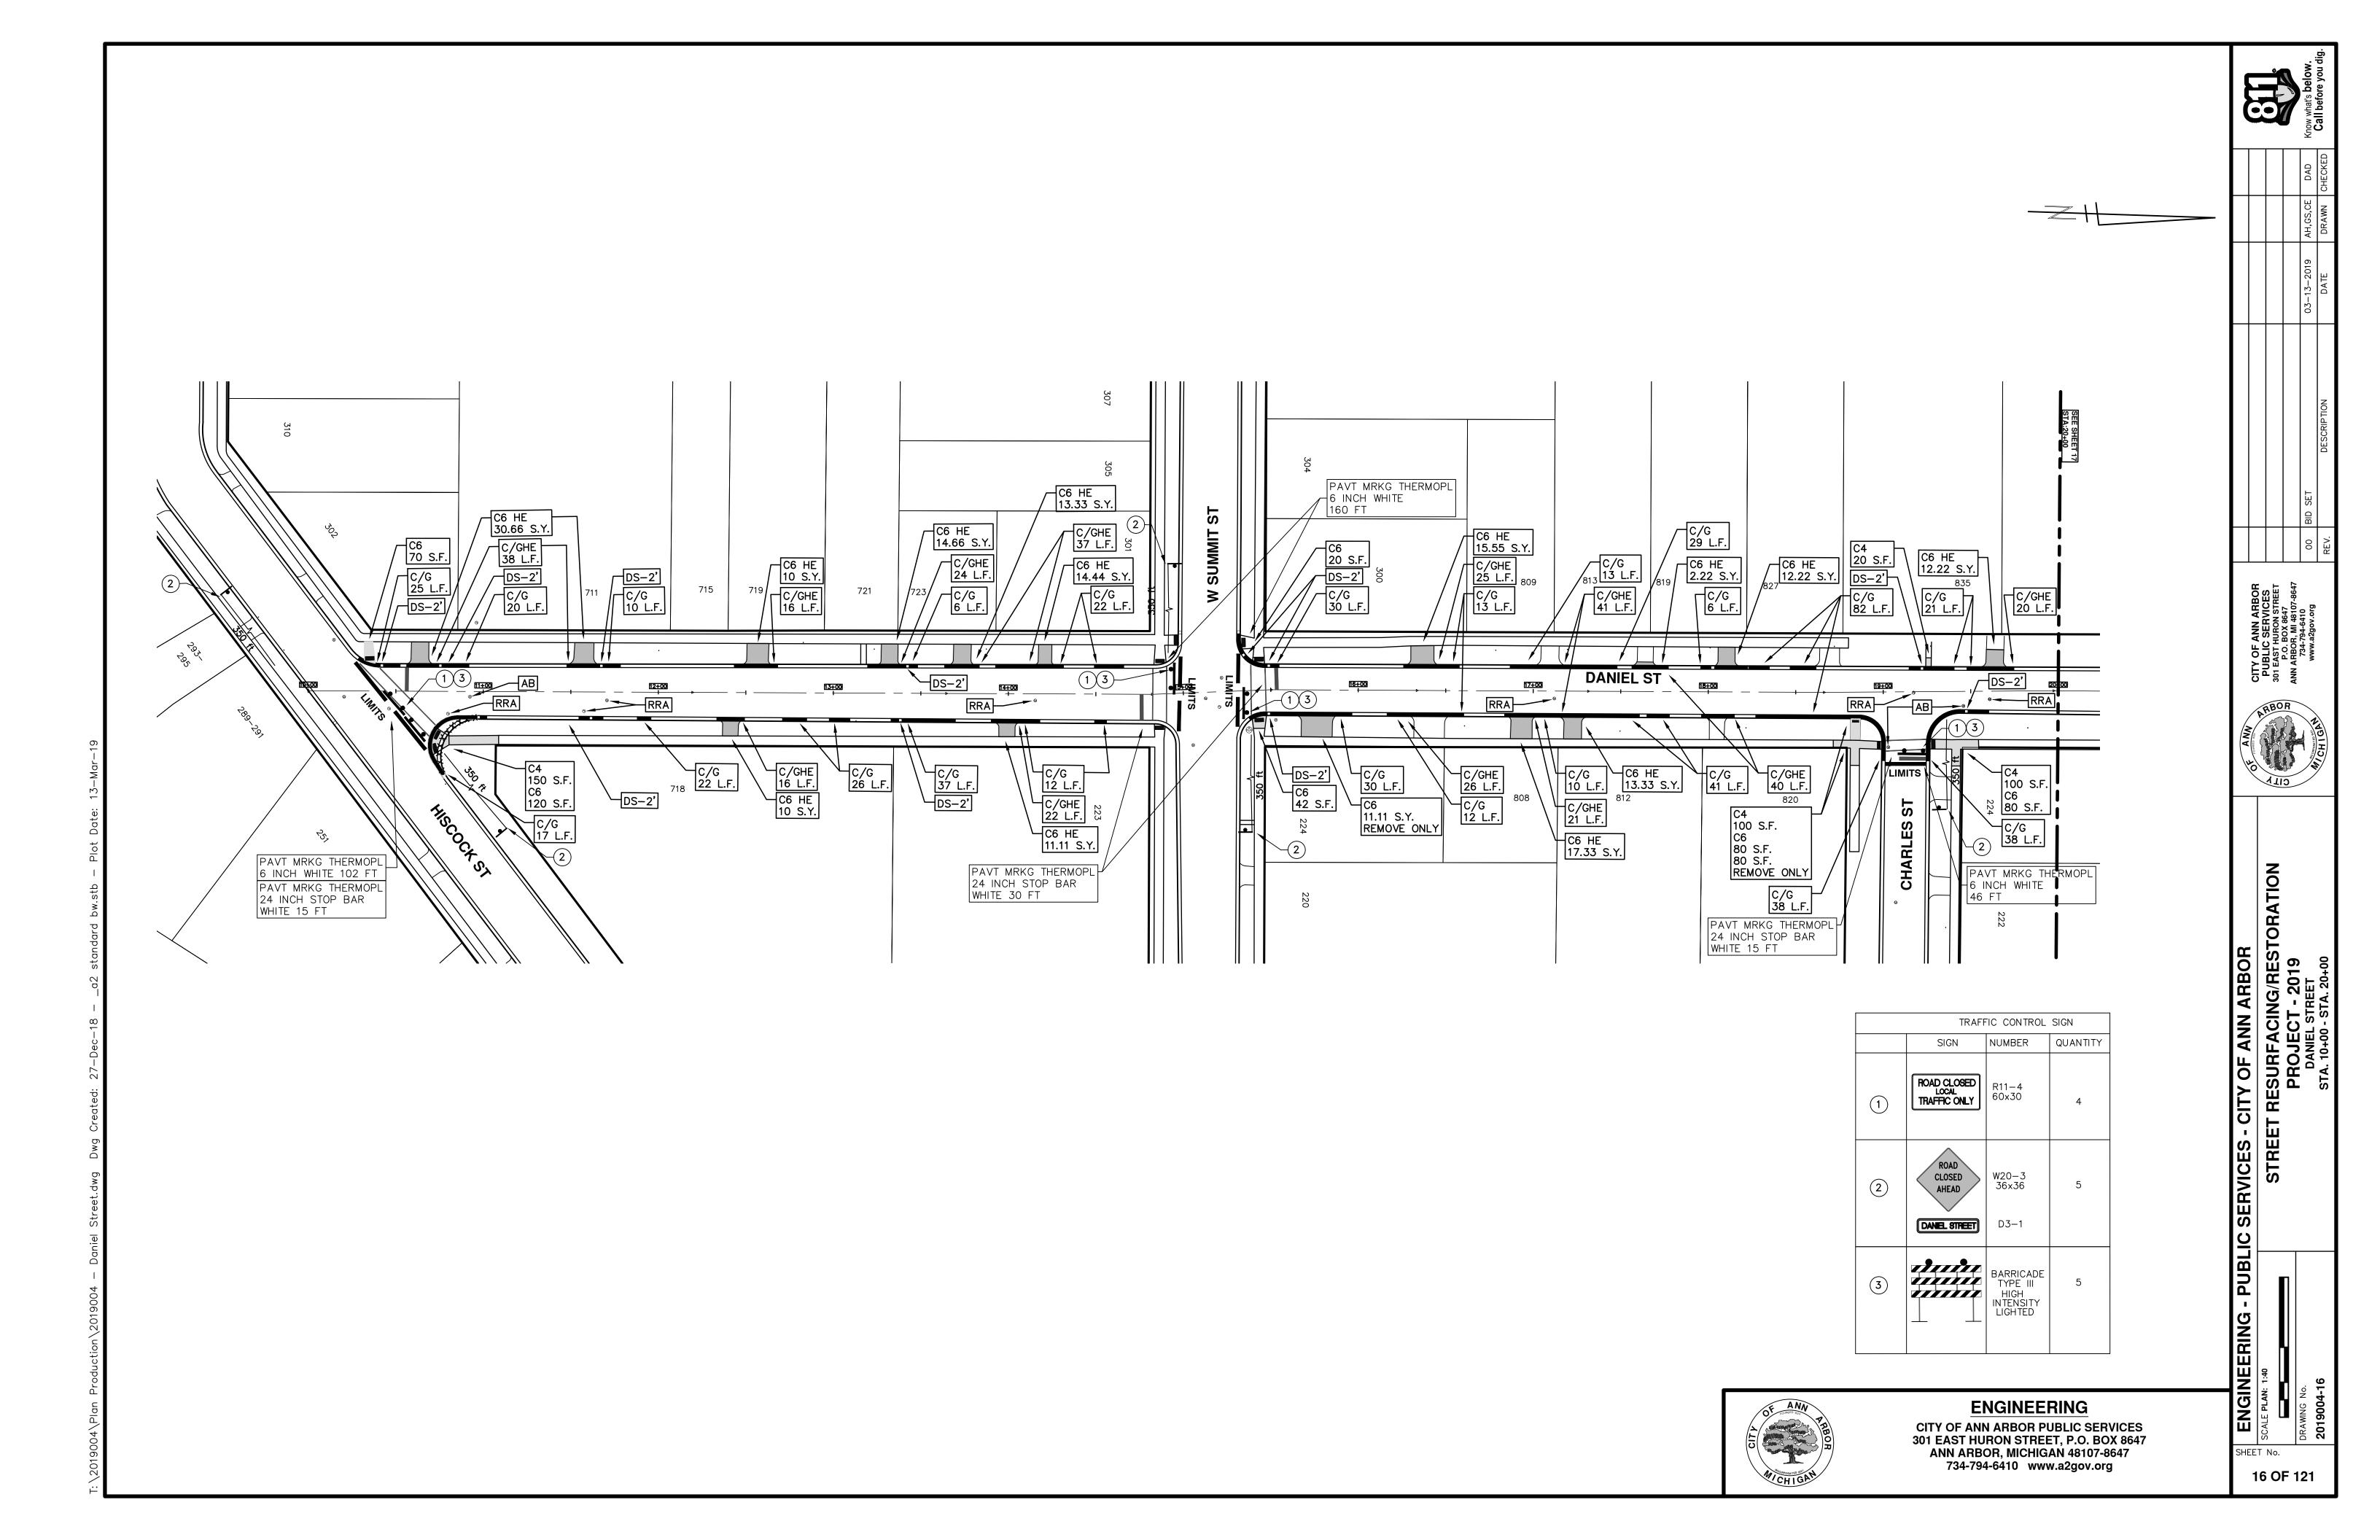
WHO MAY NOT BE A PART OF THE "MISS DIG" ALERT SYSTEM.




THE PROJECT CONTRACT DOCUMENTS.

NOTES:

UTILITIES.



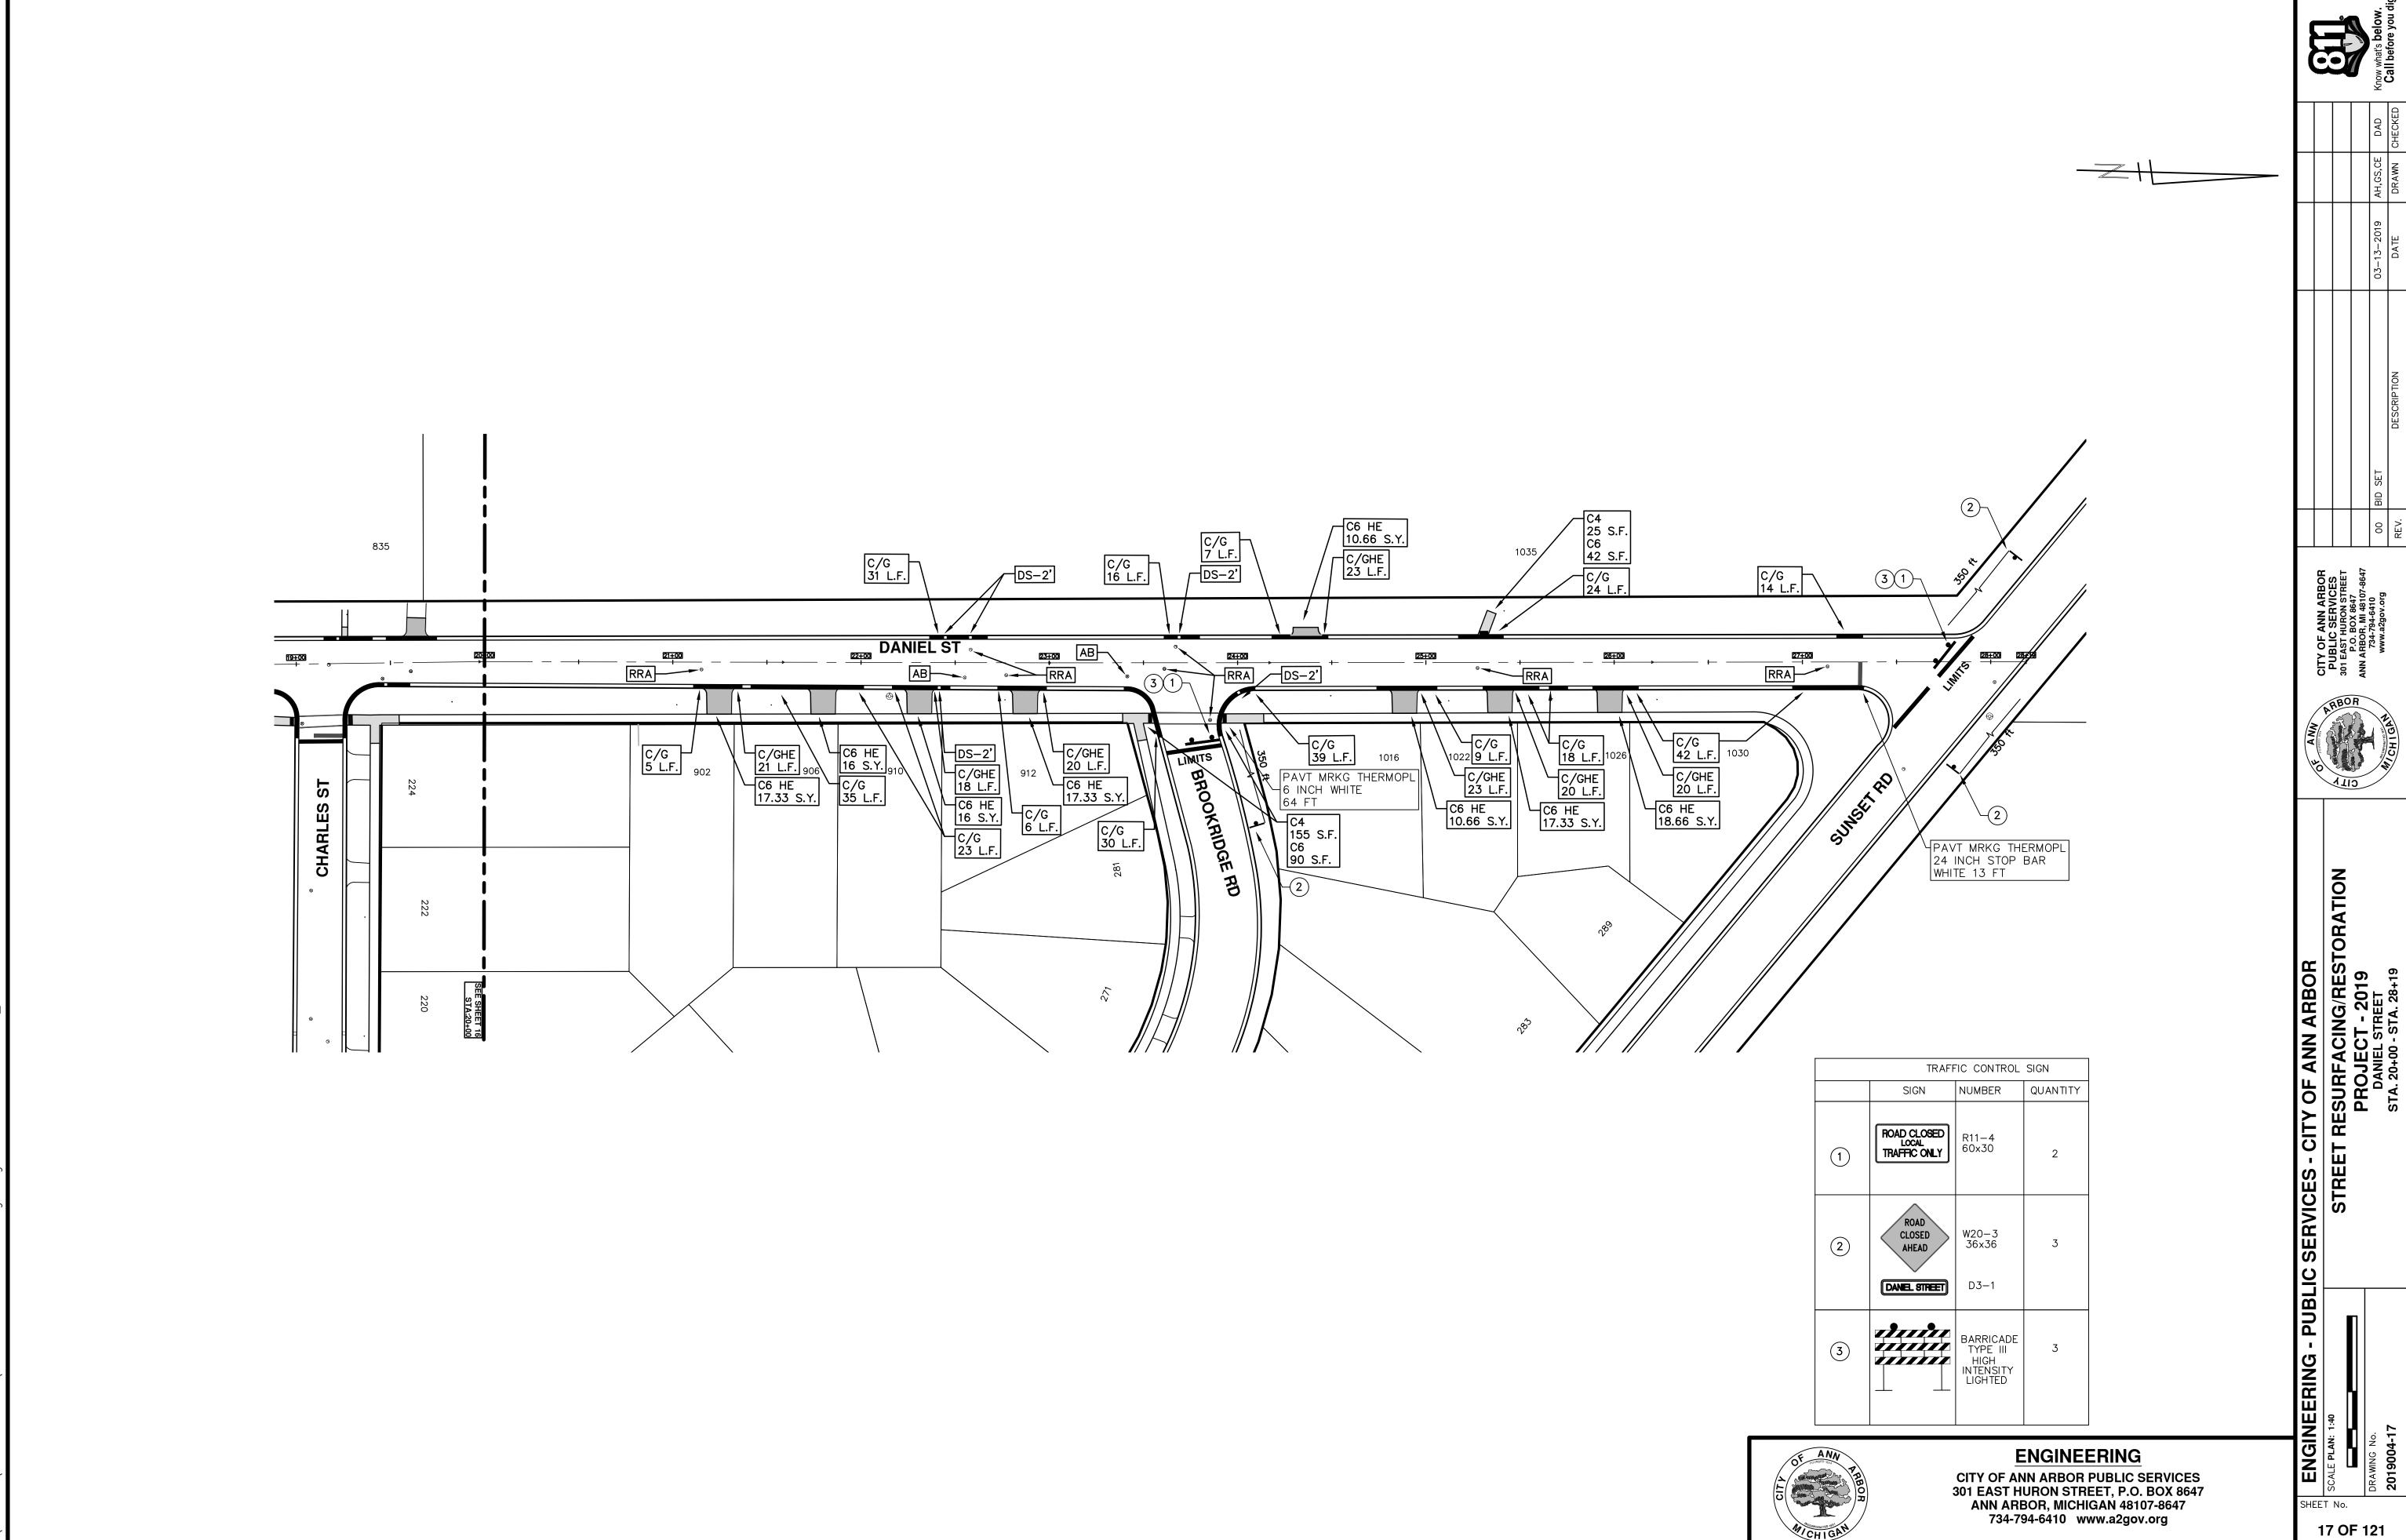


)4\Plan Production\2019004 — Daniel Street.dwg Dwg Created: 27—Dec—18 — _a2 standard bw.stb — Plot Date: 13—Mar



CITY OF ANN ARBOR ENGINEERING PROJECT LOCATION: EDWARD STREET

ITB No. 4570 FILE No. 2019004

AK • _Dr Structure, Adj, Case 1, Modified • _Sidewalk, Sidewalk Ramp, and Driveway Approach, Any Thickness, Rem • _Grading, Sidewalk • _Sidewalk, Conc, 4 inch, Modified • _Sidewalk, Sidewalk Ramp, and Driveway Approach, Any Thickness, Rem • _Grading, Sidewalk • Cement • _Sidewalk, Conc, 4 inch, Modified • _Sidewalk, Sidewalk Ramp, and Driveway Approach, Any Thickness, Rem • _Grading, Sidewalk Ramp • _Grading, Sidewalk Ramp • _Detectable Warning Surface, Modified • _Sidewalk, Conc, 6 inch, Modified • _Sidewalk, Conc, 6 inch, Modified • _Sidewalk, Conc, 6 inch, Modified • _Sidewalk, Sidewalk Ramp, and Driveway Approach, Any Thickness, Rem • _Grading, Driveway Approach • _Driveway, Nonreinf Conc, 8 inch, Modified • _Sidewalk, Sidewalk Ramp • _Grading, Sidewalk Ramp • _Grading, Sidewalk Ramp • _Cement • _Driveway, Nonreinf Conc, 6 inch, Modified • _Driveway, Nonreinf Conc, 8 inch, Modified • _Driveway, Nonreinf Conc, 8 inch, Modified • _Driveway, Nonreinf Conc, 6 inch, Modified • _Driveway, Nonreinf Conc, 6 inch, Modified • _Sidewalk Ramp, Conc, 6 inch, Modified • _Driveway, Nonreinf Conc, 8 inch, Modified • _Cement • _Driveway, Ronreinf Conc, 8 inch, Modified • _Sidewalk, Conc, 6 inch, Modified • _Curb, Gutter, and Curb and Gutter, Any Type, Rem • _Curb and Gutter, Conc • _Curb, Gutter, and Curb and Gutter, Any Type, Rem • _Curb and Gutter, Conc • _Curb, Gutter, and Curb and Gutter, Any Type, Rem • _Curb and Gutter, Conc • _Curb, Gutter, and Curb and Gutter, Any Type, Rem • _Curb and Gutter, Conc • _Curb, Gutter, and Curb and Gutter, Any Type, Rem • _Curb and Gutter, Conc, Onc, Det M, Modified • _Grading, Sidewalk • _Sidewalk, Conc, 4 inch, Modified • _Grading, Sidewalk • _Sidewalk, Conc, 4 inch, Modified		CONSTRUCTION KEY
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PRESTRICTION OF Structure Cover, Type K	I M M A	
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Plastic Drum, High Intensity, Lighted, Furn Plastic Drum, High Intensity, Lighted, Oper Barricade, Type III, High Intensity, Double Sided, Lighted, Furn	IMMX	• _Dr Structure, Adj, Case 1, Modified
Plastic Drum, High Intensity, Lighted, Oper Barricade, Type III, High Intensity, Double Sided, Lighted, Furn	RS	• _Dr Structure, Reconstruct
Plastic Drum, High Intensity, Lighted, Oper Barricade, Type III, High Intensity, Double Sided, Lighted, Furn	TYPE II	Plastic Drum, High Intensity, Lighted, Furn
• Barricade, Type III, High Intensity, Double Sided, Lighted, Furn		Plastic Drum, High Intensity, Lighted, Oper
record	VDE III	Barricade, Type III, High Intensity, Double Sided, Lighted, Furn

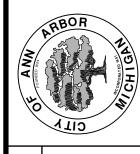

Y OF ANN ARBOR
ESURFACING/REST
PROJECT - 2019
EDWARD STREET
SUBSET COVER SHEET

SHEET No.

18 OF 121

ENGINEERING

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WHO MAY NOT BE A PART OF THE "MISS DIG" ALERT SYSTEM.


NOTES:

UTILITIES.

THE PROJECT CONTRACT DOCUMENTS.

CITY OF ANN ARBOR PUBLIC SERVICES 301 EAST HURON STREET, P.O. BOX 8647 ANN ARBOR, MICHIGAN 48107-8647

734-794-6410 www.a2gov.org

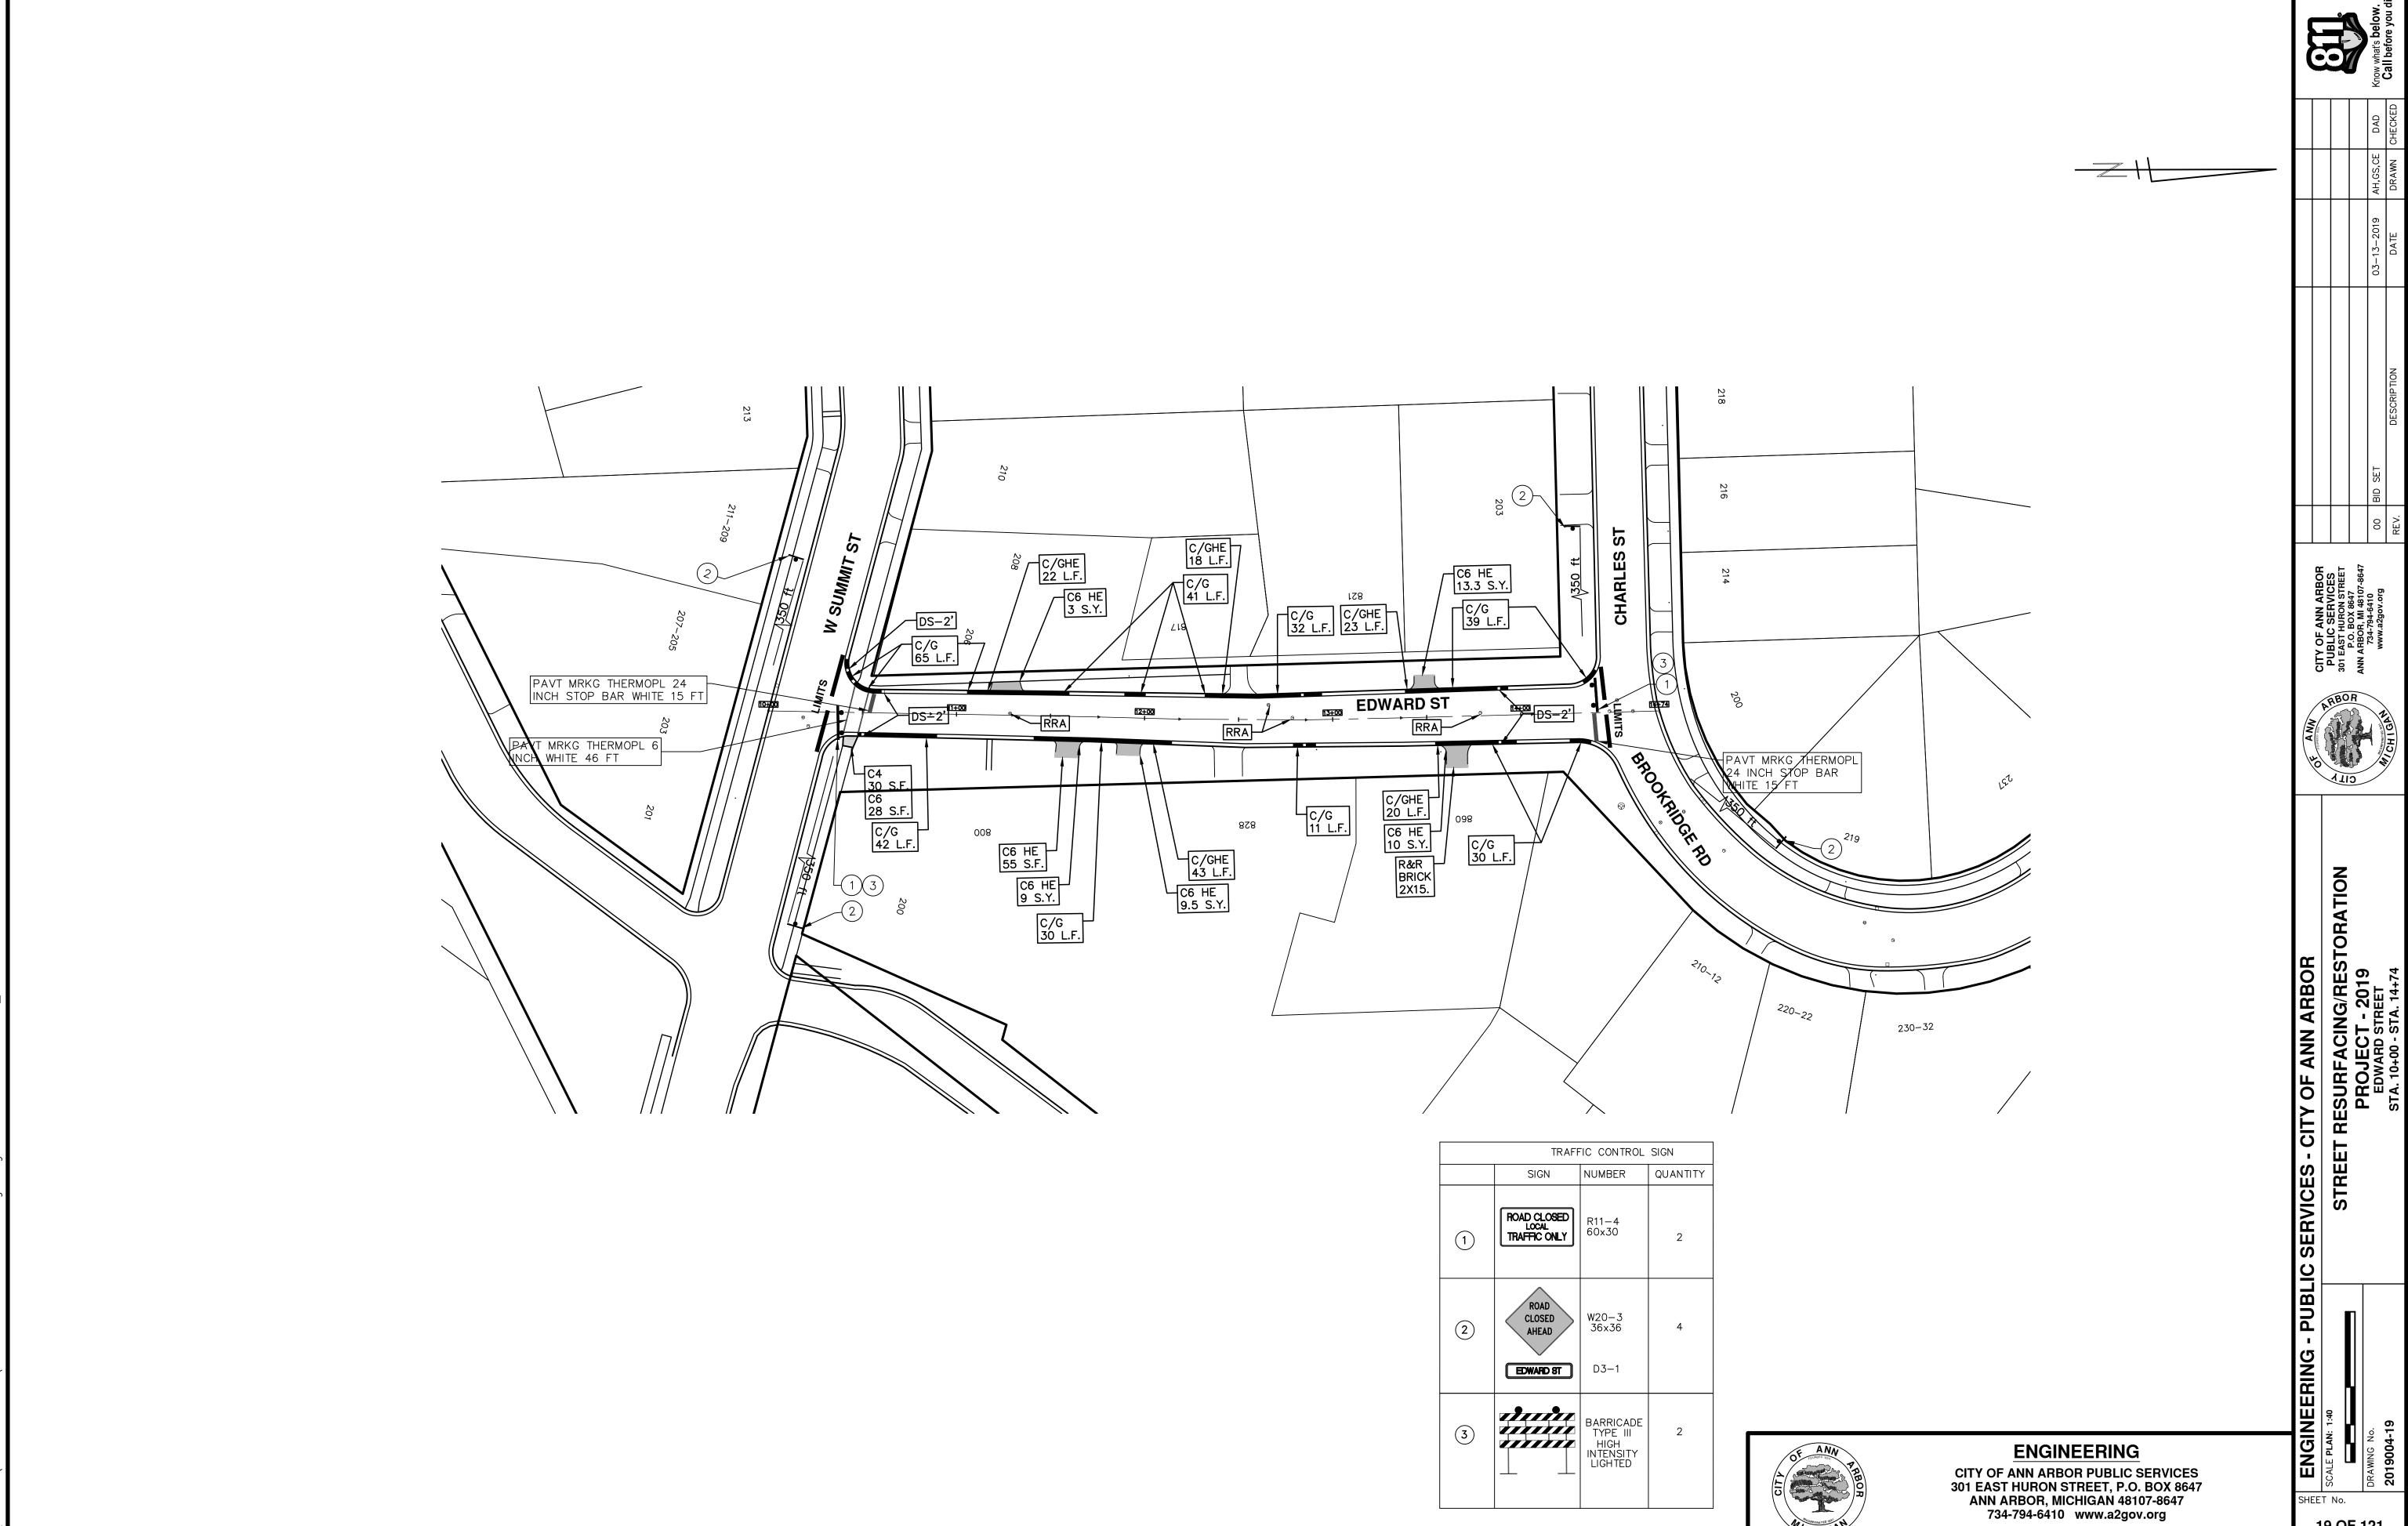



CITY OF ANN ARBOR ENGINEERING PROJECT LOCATION: FELCH STREET

ITB No. 4570 FILE No. 2019004

KEY	ASSOCIATED PAY ITEM(S)
KLI	. ,
AA	_Dr Structure, Adj, Case 1, Modified_Dr Structure, Adj, Case 2, Modified
AA	1 -
	• _Dr Structure, Temp Lowering, Modified
	_Dr Structure, Temp Lowering, Modified_Gate Box, Adj, Case 1
AB	
	 _Gate Box, Adj, Case 2 _Monument Box Adjust
ADST	Dr Structure, Adj, Add Depth, Modified
AK	• _Dr Structure, Adj, Add Deptil, Modified
AIX	• _Sidewalk, Sidewalk Ramp, and Driveway Approach, Any Thickness, Rem
C4	Grading, Sidewalk
04	Sidewalk, Conc, 4 inch, Modified
	• _Sidewalk, Sidewalk Ramp, and Driveway Approach, Any Thickness, Rem
	Grading, Sidewalk
C4HE	• Cement
	Sidewalk, Conc, 4 inch, Modified
	Sidewalk, Sidewalk Ramp, and Driveway Approach, Any Thickness, Rem
	Grading, Sidewalk
	• _Grading, Sidewalk Ramp
C6	Detectable Warning Surface, Modified
	Sidewalk Ramp, Conc, 6 inch, Modified
	• _Sidewalk, Conc, 6 inch, Modified
	Grading, Driveway Approach
C8	• _Driveway, Nonreinf Conc, 8 inch, Modified
	 _Sidewalk, Sidewalk Ramp, and Driveway Approach, Any Thickness, Rem
	• _Grading, Driveway Approach
	• _Grading, Sidewalk
	Grading, Sidewalk Ramp
	• Cement
C HE	• _Driveway, Nonreinf Conc, 6 inch, Modified
	Driveway, Nonreinf Conc, 8 inch, Modified
	Detectable Warning Surface, Modified
	• _Sidewalk Ramp, Conc, 6 inch, Modified
	Sidewalk, Conc, 6 inch, Modified
0/0	Curb, Gutter, and Curb and Gutter, Any Type, Rem
C/G	Curb and Gutter, Conc
	• _Curb, Gutter, and Curb and Gutter, Any Type, Rem
C/GHE	• Cement
	• _Driveway Opening, Conc, Det M, Modified
OD	• _Grading, Sidewalk
CP	Sidewalk, Conc, 4 inch, Modified
CR	• _Sidewalk, Sidewalk Ramp, and Driveway Approach, Any Thickness, Rem
	Dr Structure, Rem
DS	Sewer, Rem, Less than 24 inch
	Dr Structure, 24 inch dia
	Dr Structure, Rem
DSDI	Sewer, Rem, Less than 24 inch
	• _Dr Structure, Double Inlet
PT	• _Dr Structure, Point
	Dr Structure Cover, Type B
	• _Dr Structure Cover, Type B, Special
RRA	• _Dr Structure, Adj, Case 1, Modified
	• _Dr Structure, Temp Lowering, Modified
DDI	Dr Structure Cover, Type K
RRK	• _Dr Structure, Adj, Case 1, Modified
RS	• _Dr Structure, Reconstruct
_	Plastic Drum, High Intensity, Lighted, Fum
- /	p Flastic Dium, fligh intensity, Lighted. Fum
TYPE II	Plastic Drum, High Intensity, Lighted, Oper



F RESURFACING/RESTC PROJECT - 2019
FELCH STREET SUBSET COVER SHEET

SHEET No.

20 OF 121

ENGINEERING




CITY OF ANN ARBOR PUBLIC SERVICES 301 EAST HURON STREET, P.O. BOX 8647 ANN ARBOR, MICHIGAN 48107-8647 734-794-6410 www.a2gov.org


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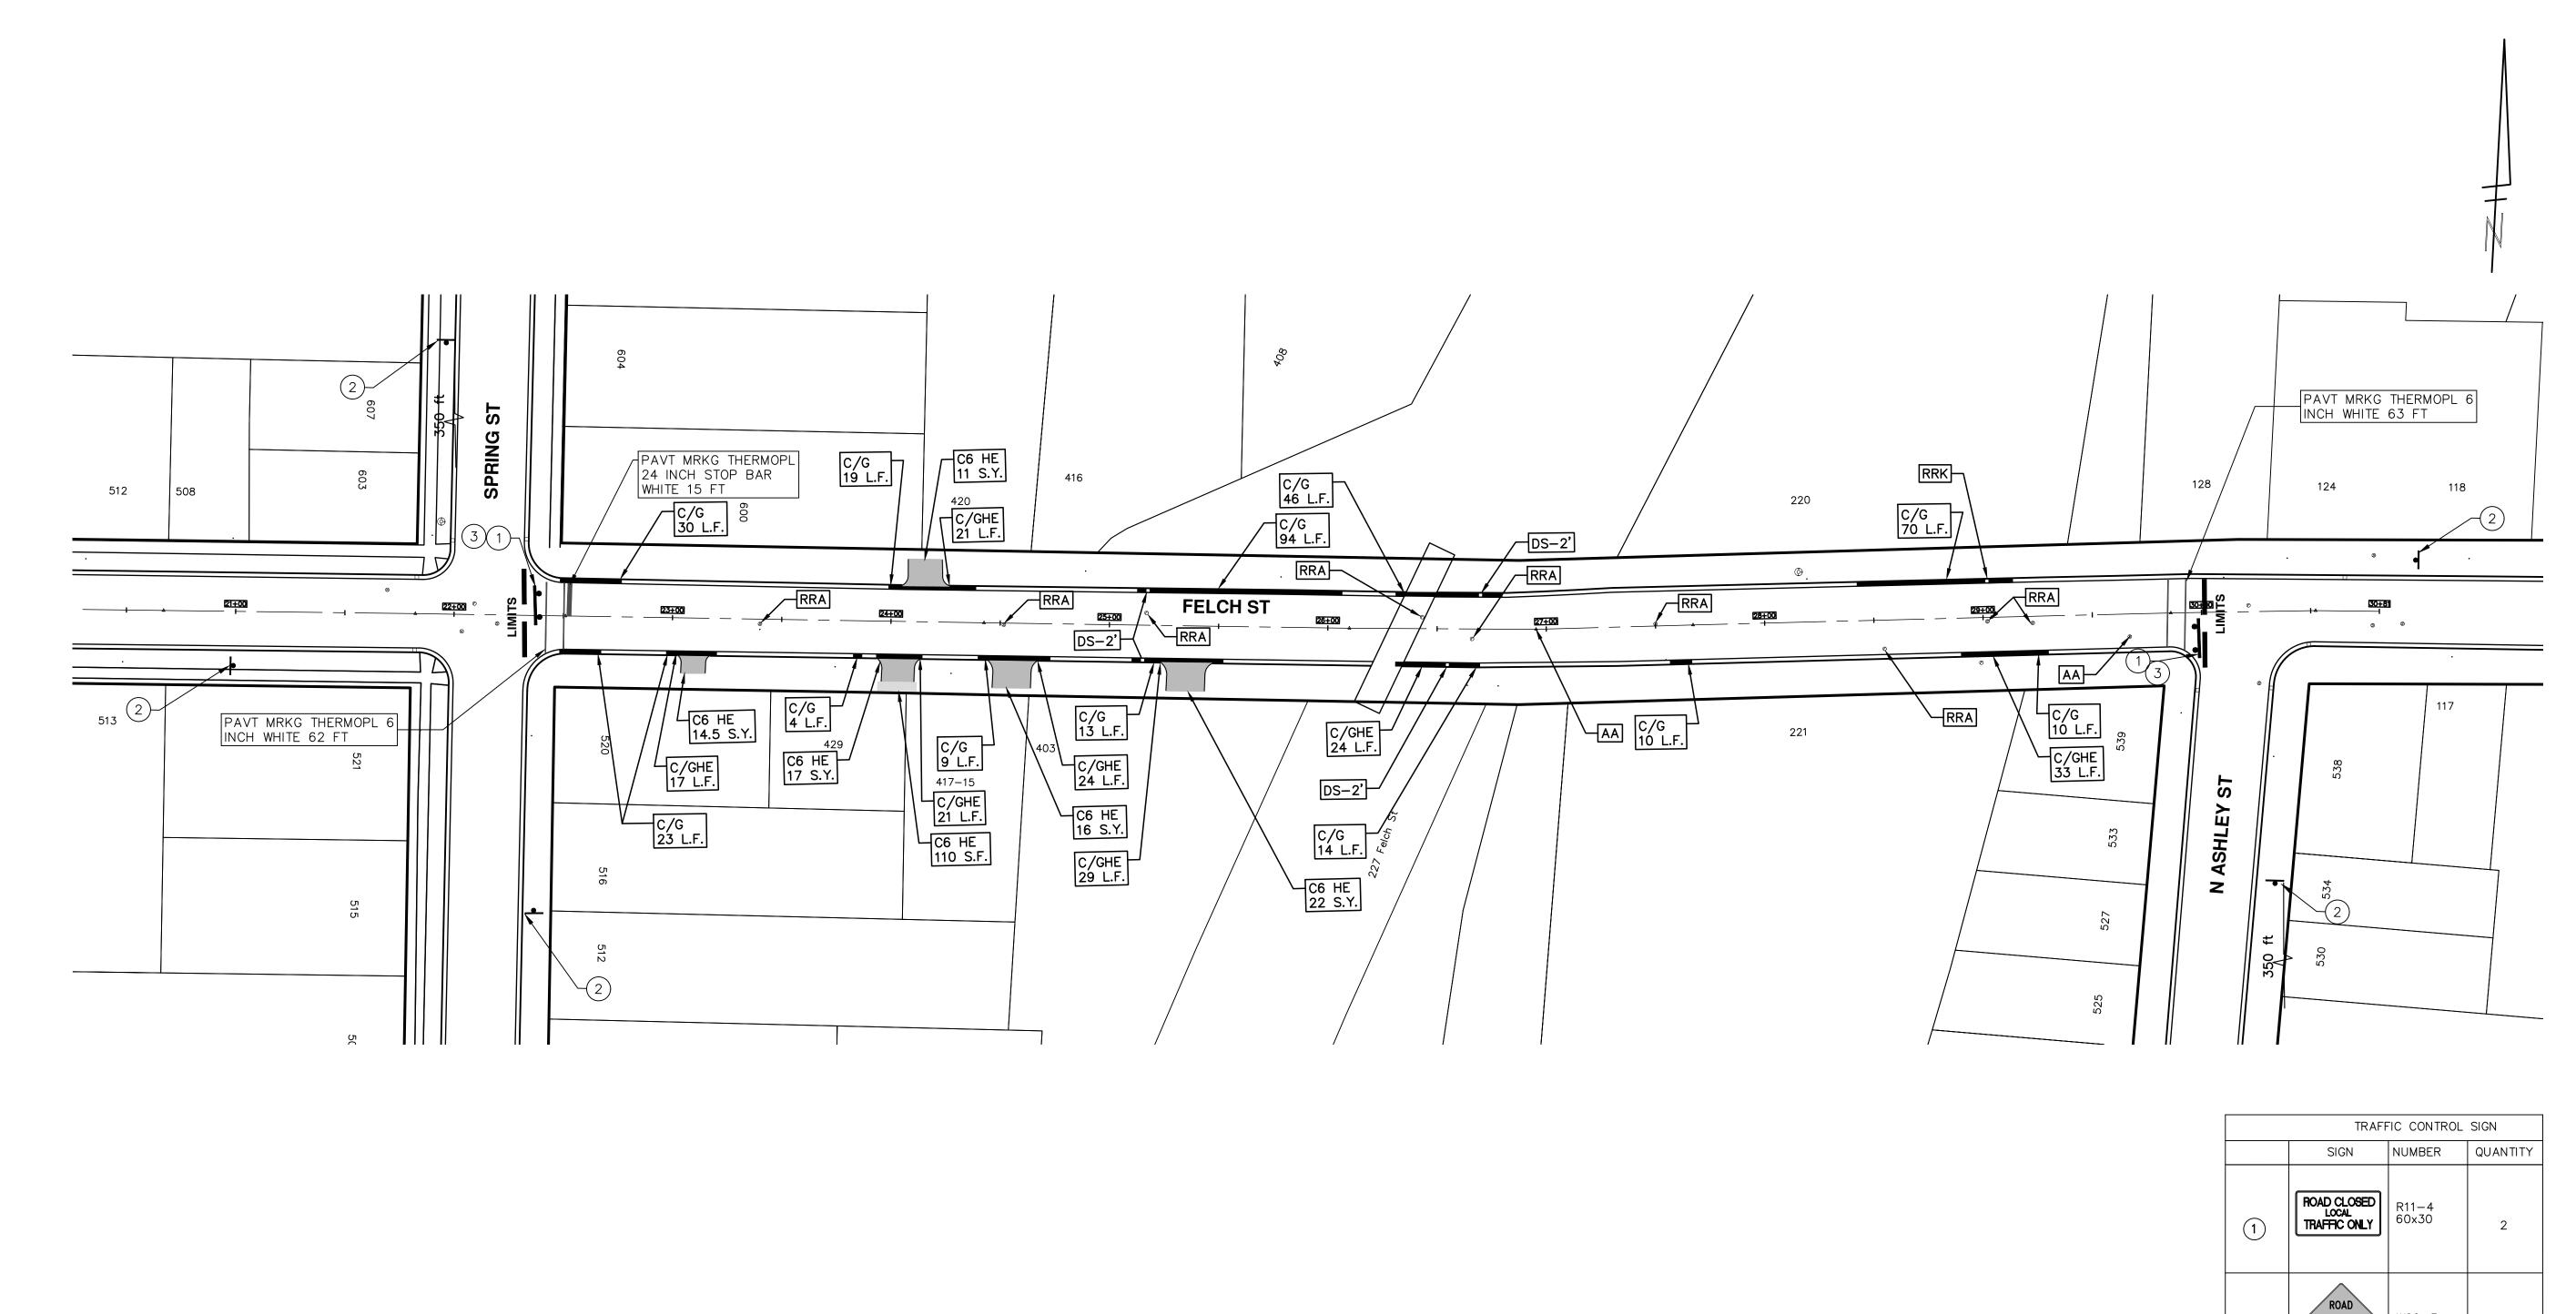







ENGINEERING
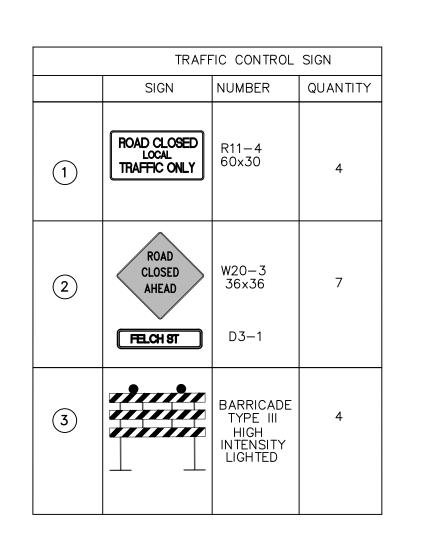
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ENGINEERING

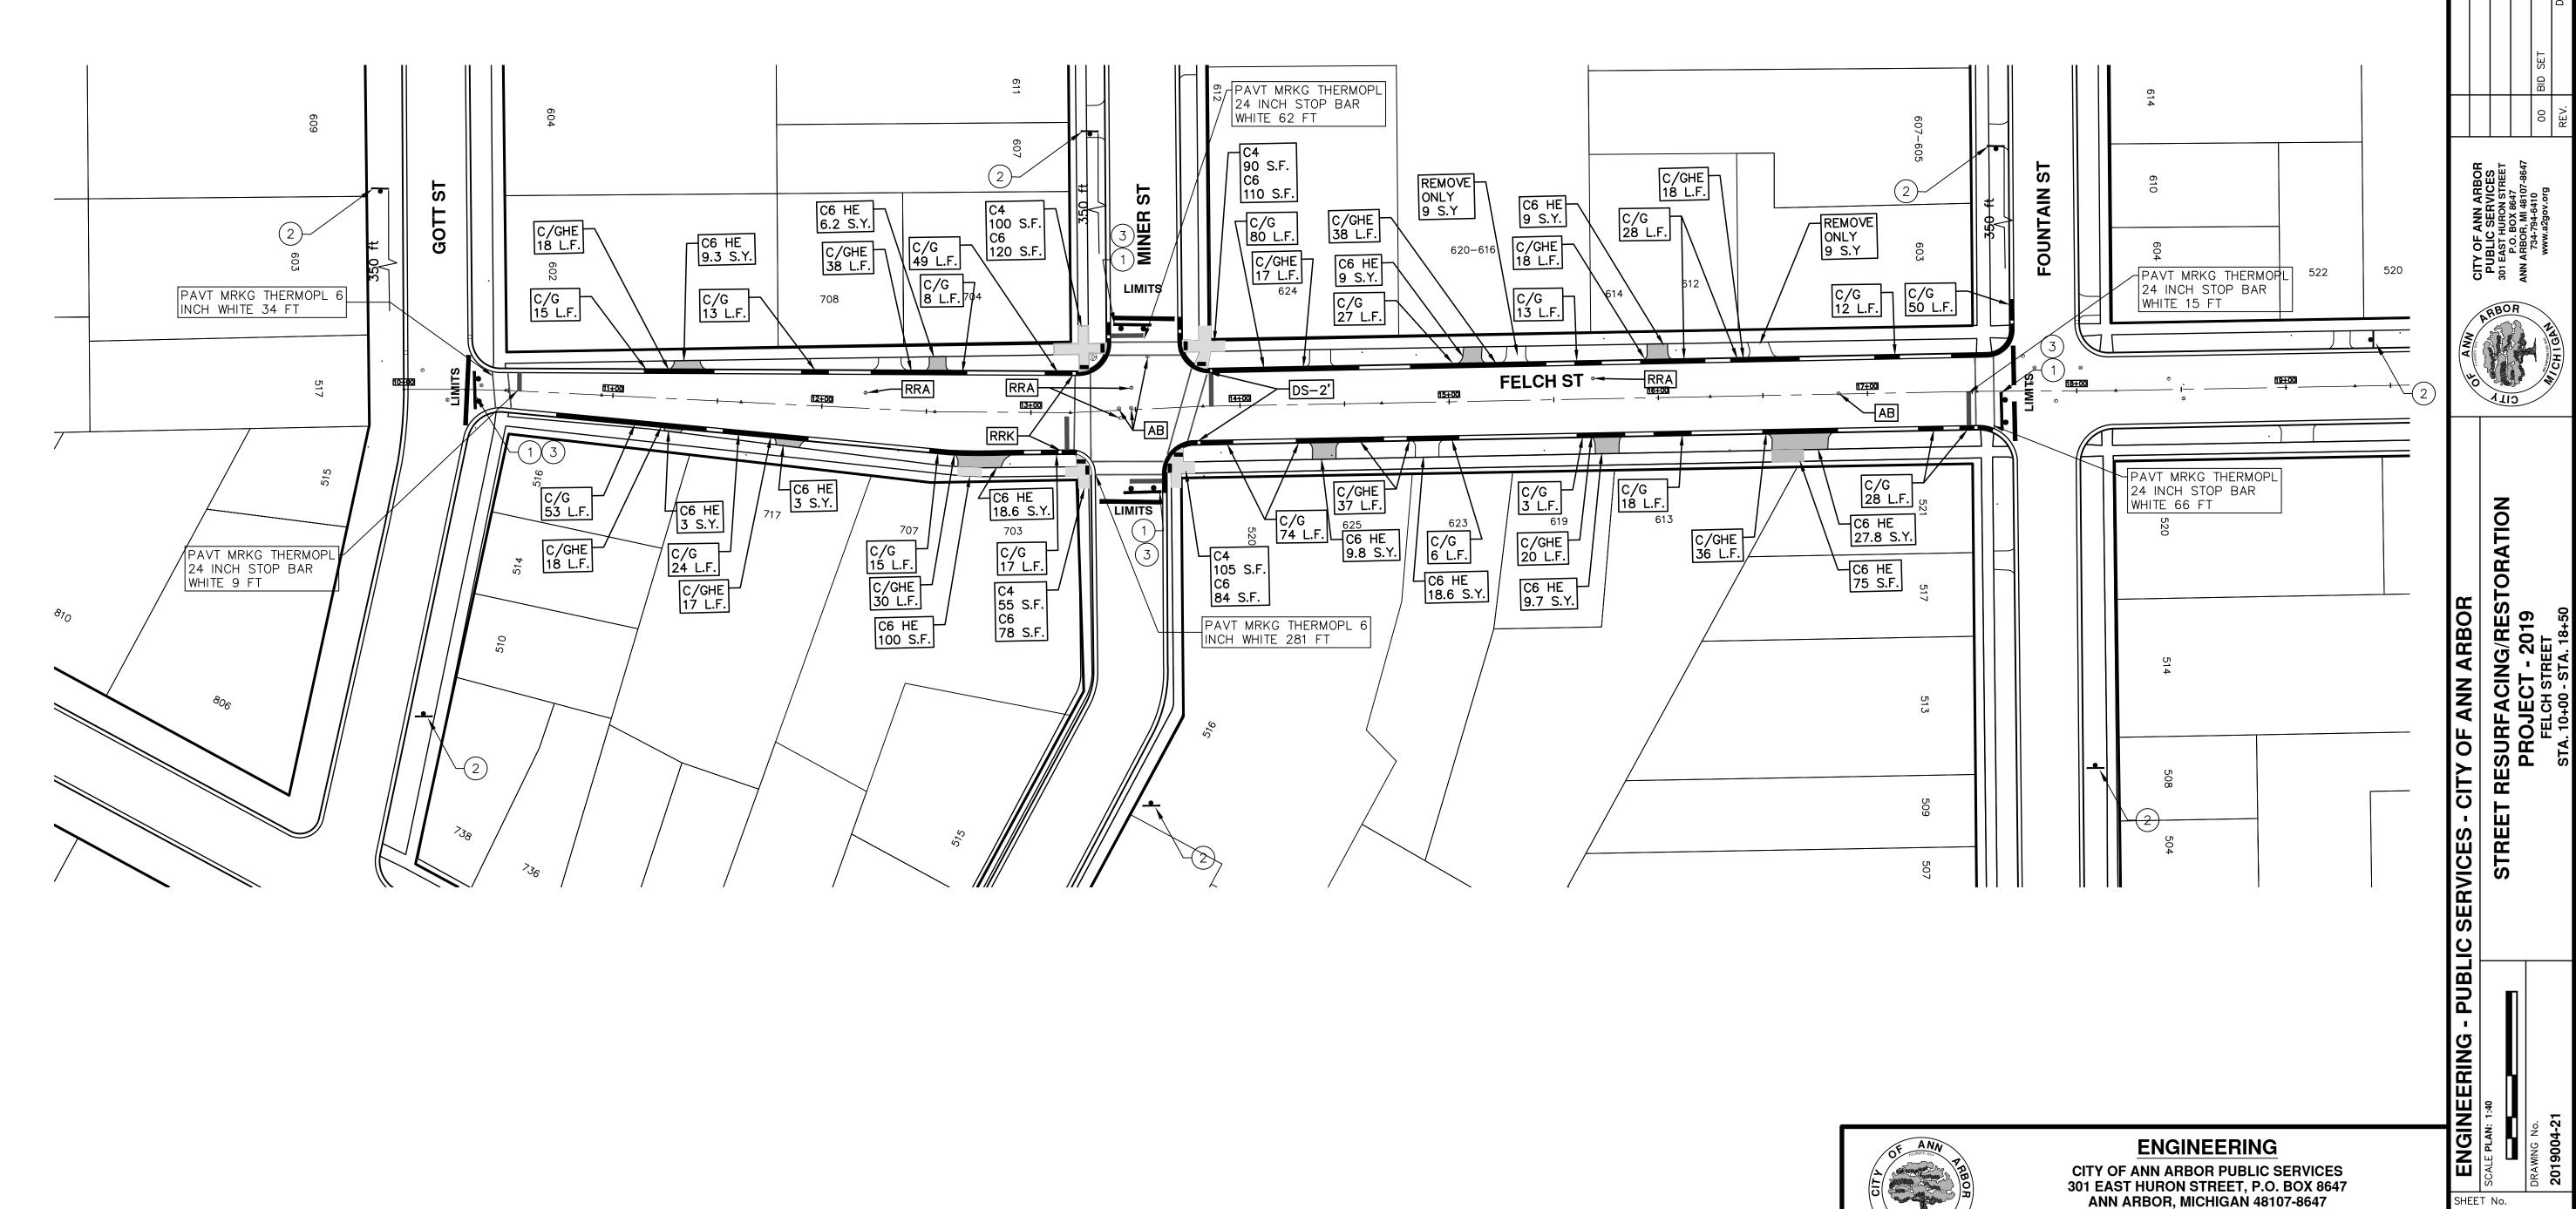CITY OF ANN ARBOR PUBLIC SERVICES 301 EAST HURON STREET, P.O. BOX 8647 ANN ARBOR, MICHIGAN 48107-8647 734-794-6410 www.a2gov.org DAD
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ENGINEERING - PUBLIC SERVICES - CITY OF ANN ARBOR

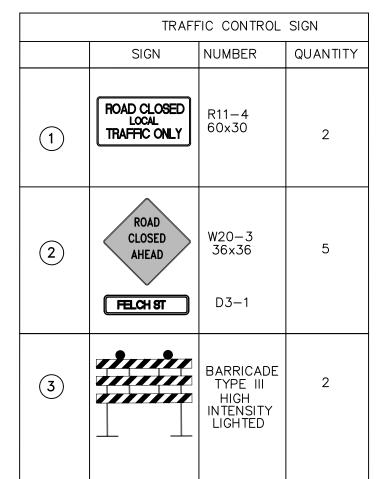SCALE PLAN: 1:40

SCALE PLAN: 1:40

DRAWING NO.

PROJECT - 2019

FELCH STREET


STA. 21+50 - STA. 30+81



CITY OF ANN ARBOR ENGINEERING PROJECT LOCATION: FOUNTAIN STREET

ITB No. 4570 FILE No. 2019004

	CONSTRUCTION KEY
KEY	ASSOCIATED PAY ITEM(S)
	• _Dr Structure, Adj, Case 1, Modified
AA	• _Dr Structure, Adj, Case 2, Modified
	• _Dr Structure, Temp Lowering, Modified
	• _Dr Structure, Temp Lowering, Modified
AB	• _Gate Box, Adj, Case 1
710	• _Gate Box, Adj, Case 2
	• _Monument Box Adjust
ADST	 _Dr Structure, Adj, Add Depth, Modified
AK	• _Dr Structure, Adj, Case 1, Modified
	• _Sidewalk, Sidewalk Ramp, and Driveway Approach, Any Thickness, Rem
C4	• _Grading, Sidewalk
	• _Sidewalk, Conc, 4 inch, Modified
	• _Sidewalk, Sidewalk Ramp, and Driveway Approach, Any Thickness, Rem
C4HE	• _Grading, Sidewalk
OTIL	• Cement
	• _Sidewalk, Conc, 4 inch, Modified
	• _Sidewalk, Sidewalk Ramp, and Driveway Approach, Any Thickness, Rem
	• _Grading, Sidewalk
C6	• _Grading, Sidewalk Ramp
00	• _Detectable Warning Surface, Modified
	• _Sidewalk Ramp, Conc, 6 inch, Modified
	• _Sidewalk, Conc, 6 inch, Modified
C8	• _Grading, Driveway Approach
Co	• _Driveway, Nonreinf Conc, 8 inch, Modified
	• _Sidewalk, Sidewalk Ramp, and Driveway Approach, Any Thickness, Rem
	• _Grading, Driveway Approach
	• _Grading, Sidewalk
	• _Grading, Sidewalk Ramp
C HE	• Cement
CHE	• _Driveway, Nonreinf Conc, 6 inch, Modified
	• _Driveway, Nonreinf Conc, 8 inch, Modified
	• _Detectable Warning Surface, Modified
	• _Sidewalk Ramp, Conc, 6 inch, Modified
	• _Sidewalk, Conc, 6 inch, Modified
C/G	• _Curb, Gutter, and Curb and Gutter, Any Type, Rem
C/G	• _Curb and Gutter, Conc
	• _Curb, Gutter, and Curb and Gutter, Any Type, Rem
C/GHE	• Cement
	• _Driveway Opening, Conc, Det M, Modified
СР	• _Grading, Sidewalk
<u> </u>	• _Sidewalk, Conc, 4 inch, Modified
CR	• _Sidewalk, Sidewalk Ramp, and Driveway Approach, Any Thickness, Rem
	Dr Structure, Rem
DS	Sewer, Rem, Less than 24 inch
	Dr Structure, 24 inch dia
	Dr Structure, Rem
DSDI	Sewer, Rem, Less than 24 inch
	• _Dr Structure, Double Inlet
PT	• _Dr Structure, Point
	Dr Structure Cover, Type B
RRA	• _Dr Structure Cover, Type B, Special
INIV	• _Dr Structure, Adj, Case 1, Modified
	• _Dr Structure, Temp Lowering, Modified
RRK	Dr Structure Cover, Type K
IMM	• _Dr Structure, Adj, Case 1, Modified
RS	• _Dr Structure, Reconstruct
TYPE II	Plastic Drum, High Intensity, Lighted, Fum
	Plastic Drum, High Intensity, Lighted, Oper
TYPE III	Barricade, Type III, High Intensity, Double Sided, Lighted, Furn

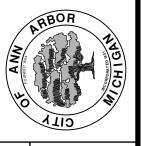

Y OF ANN ARBOR
ESURFACING/REST
PROJECT - 2019
FOUNTAIN STREET
SUBSET COVER SHEET

SHEET No.

23 OF 121

NOTES:


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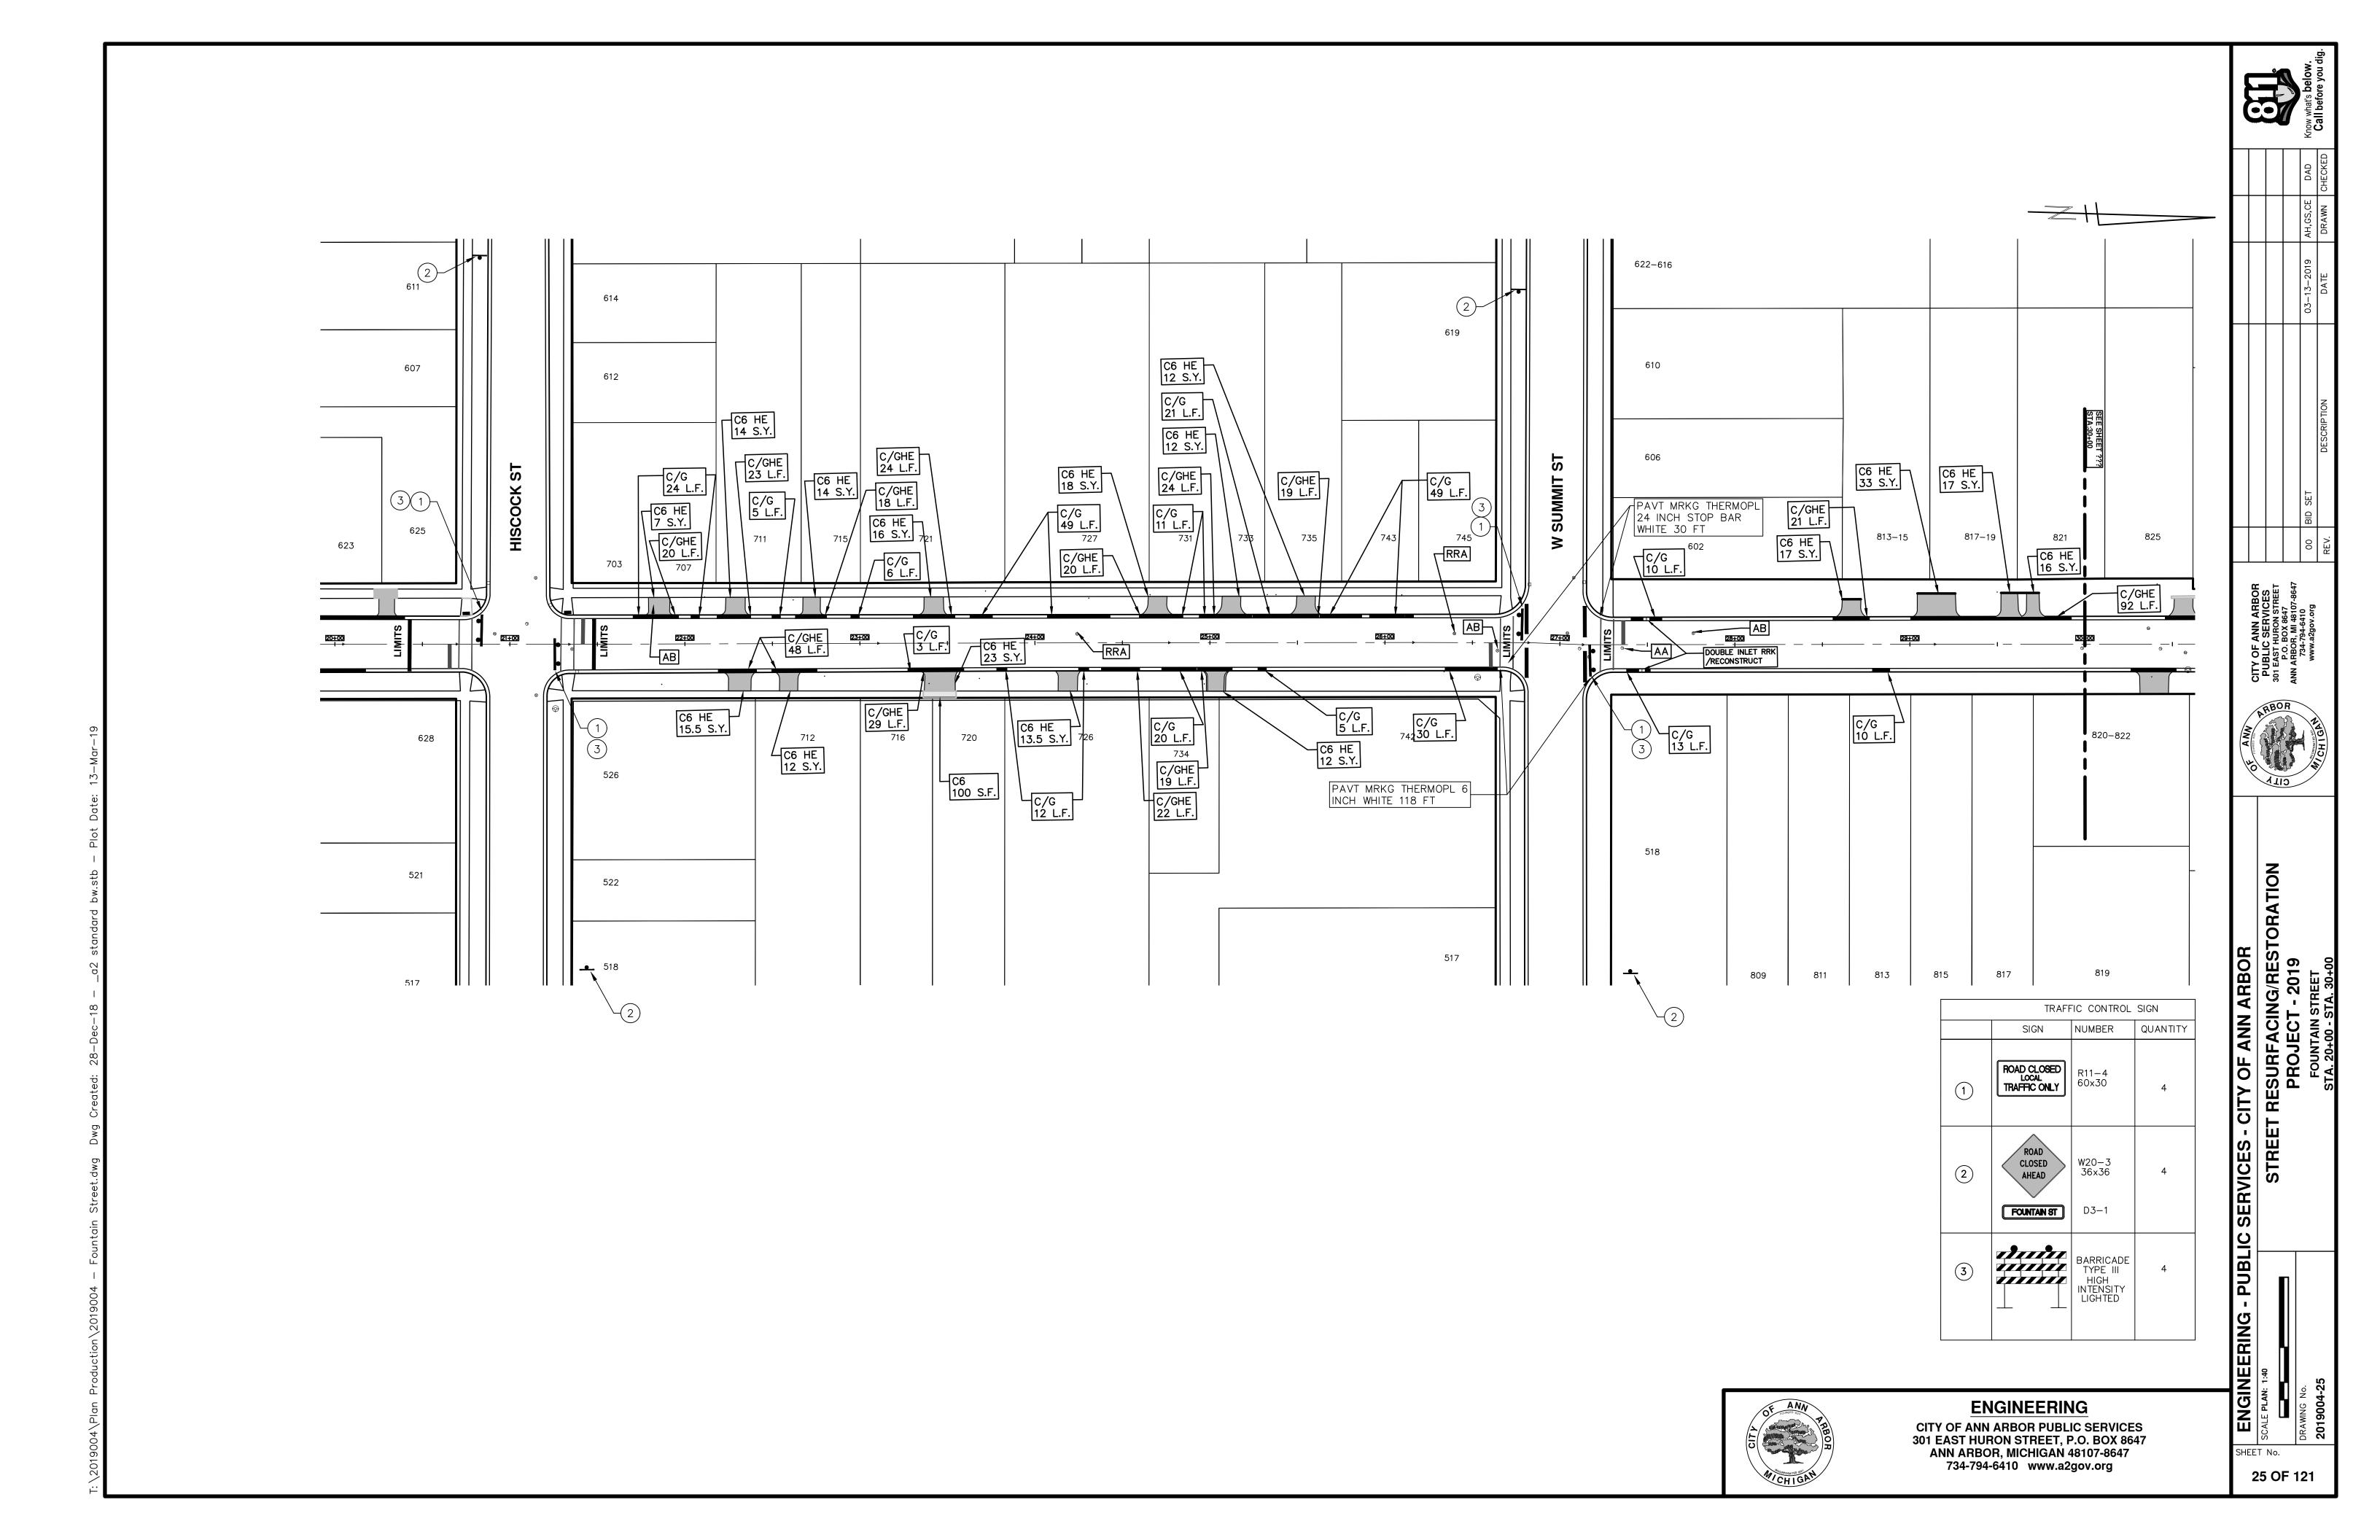
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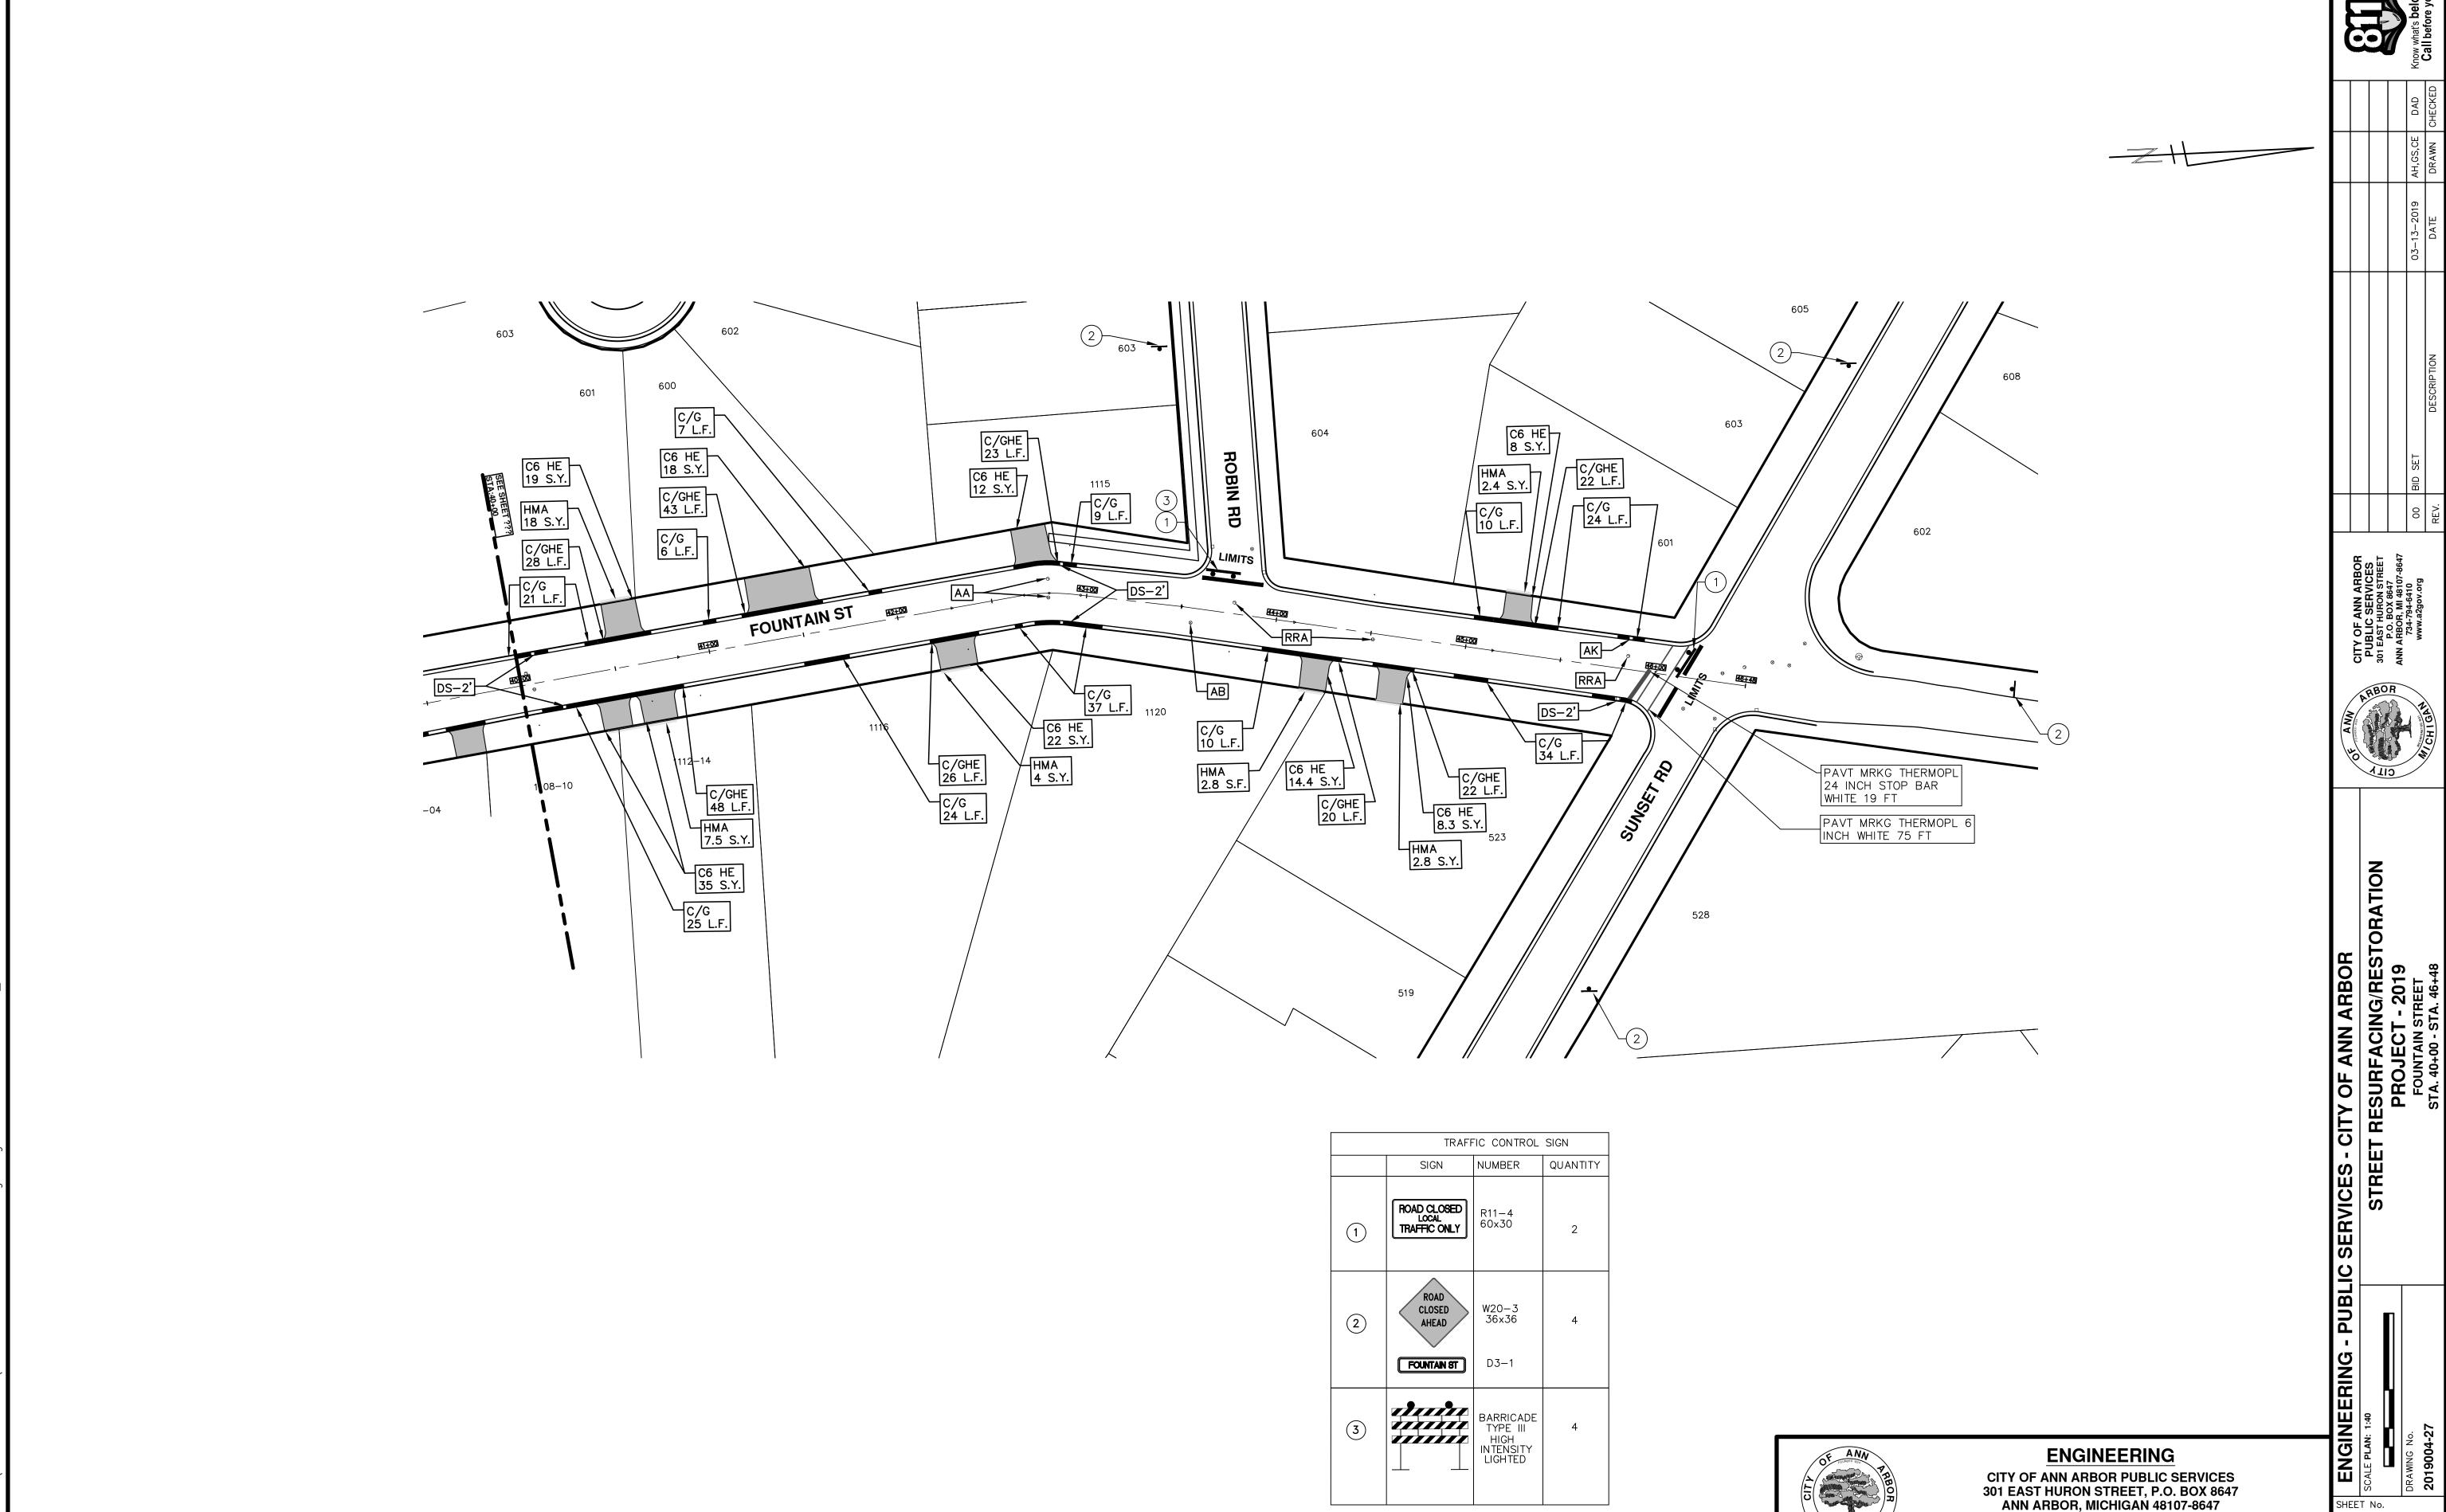
ENGINEERING







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27 OF 121

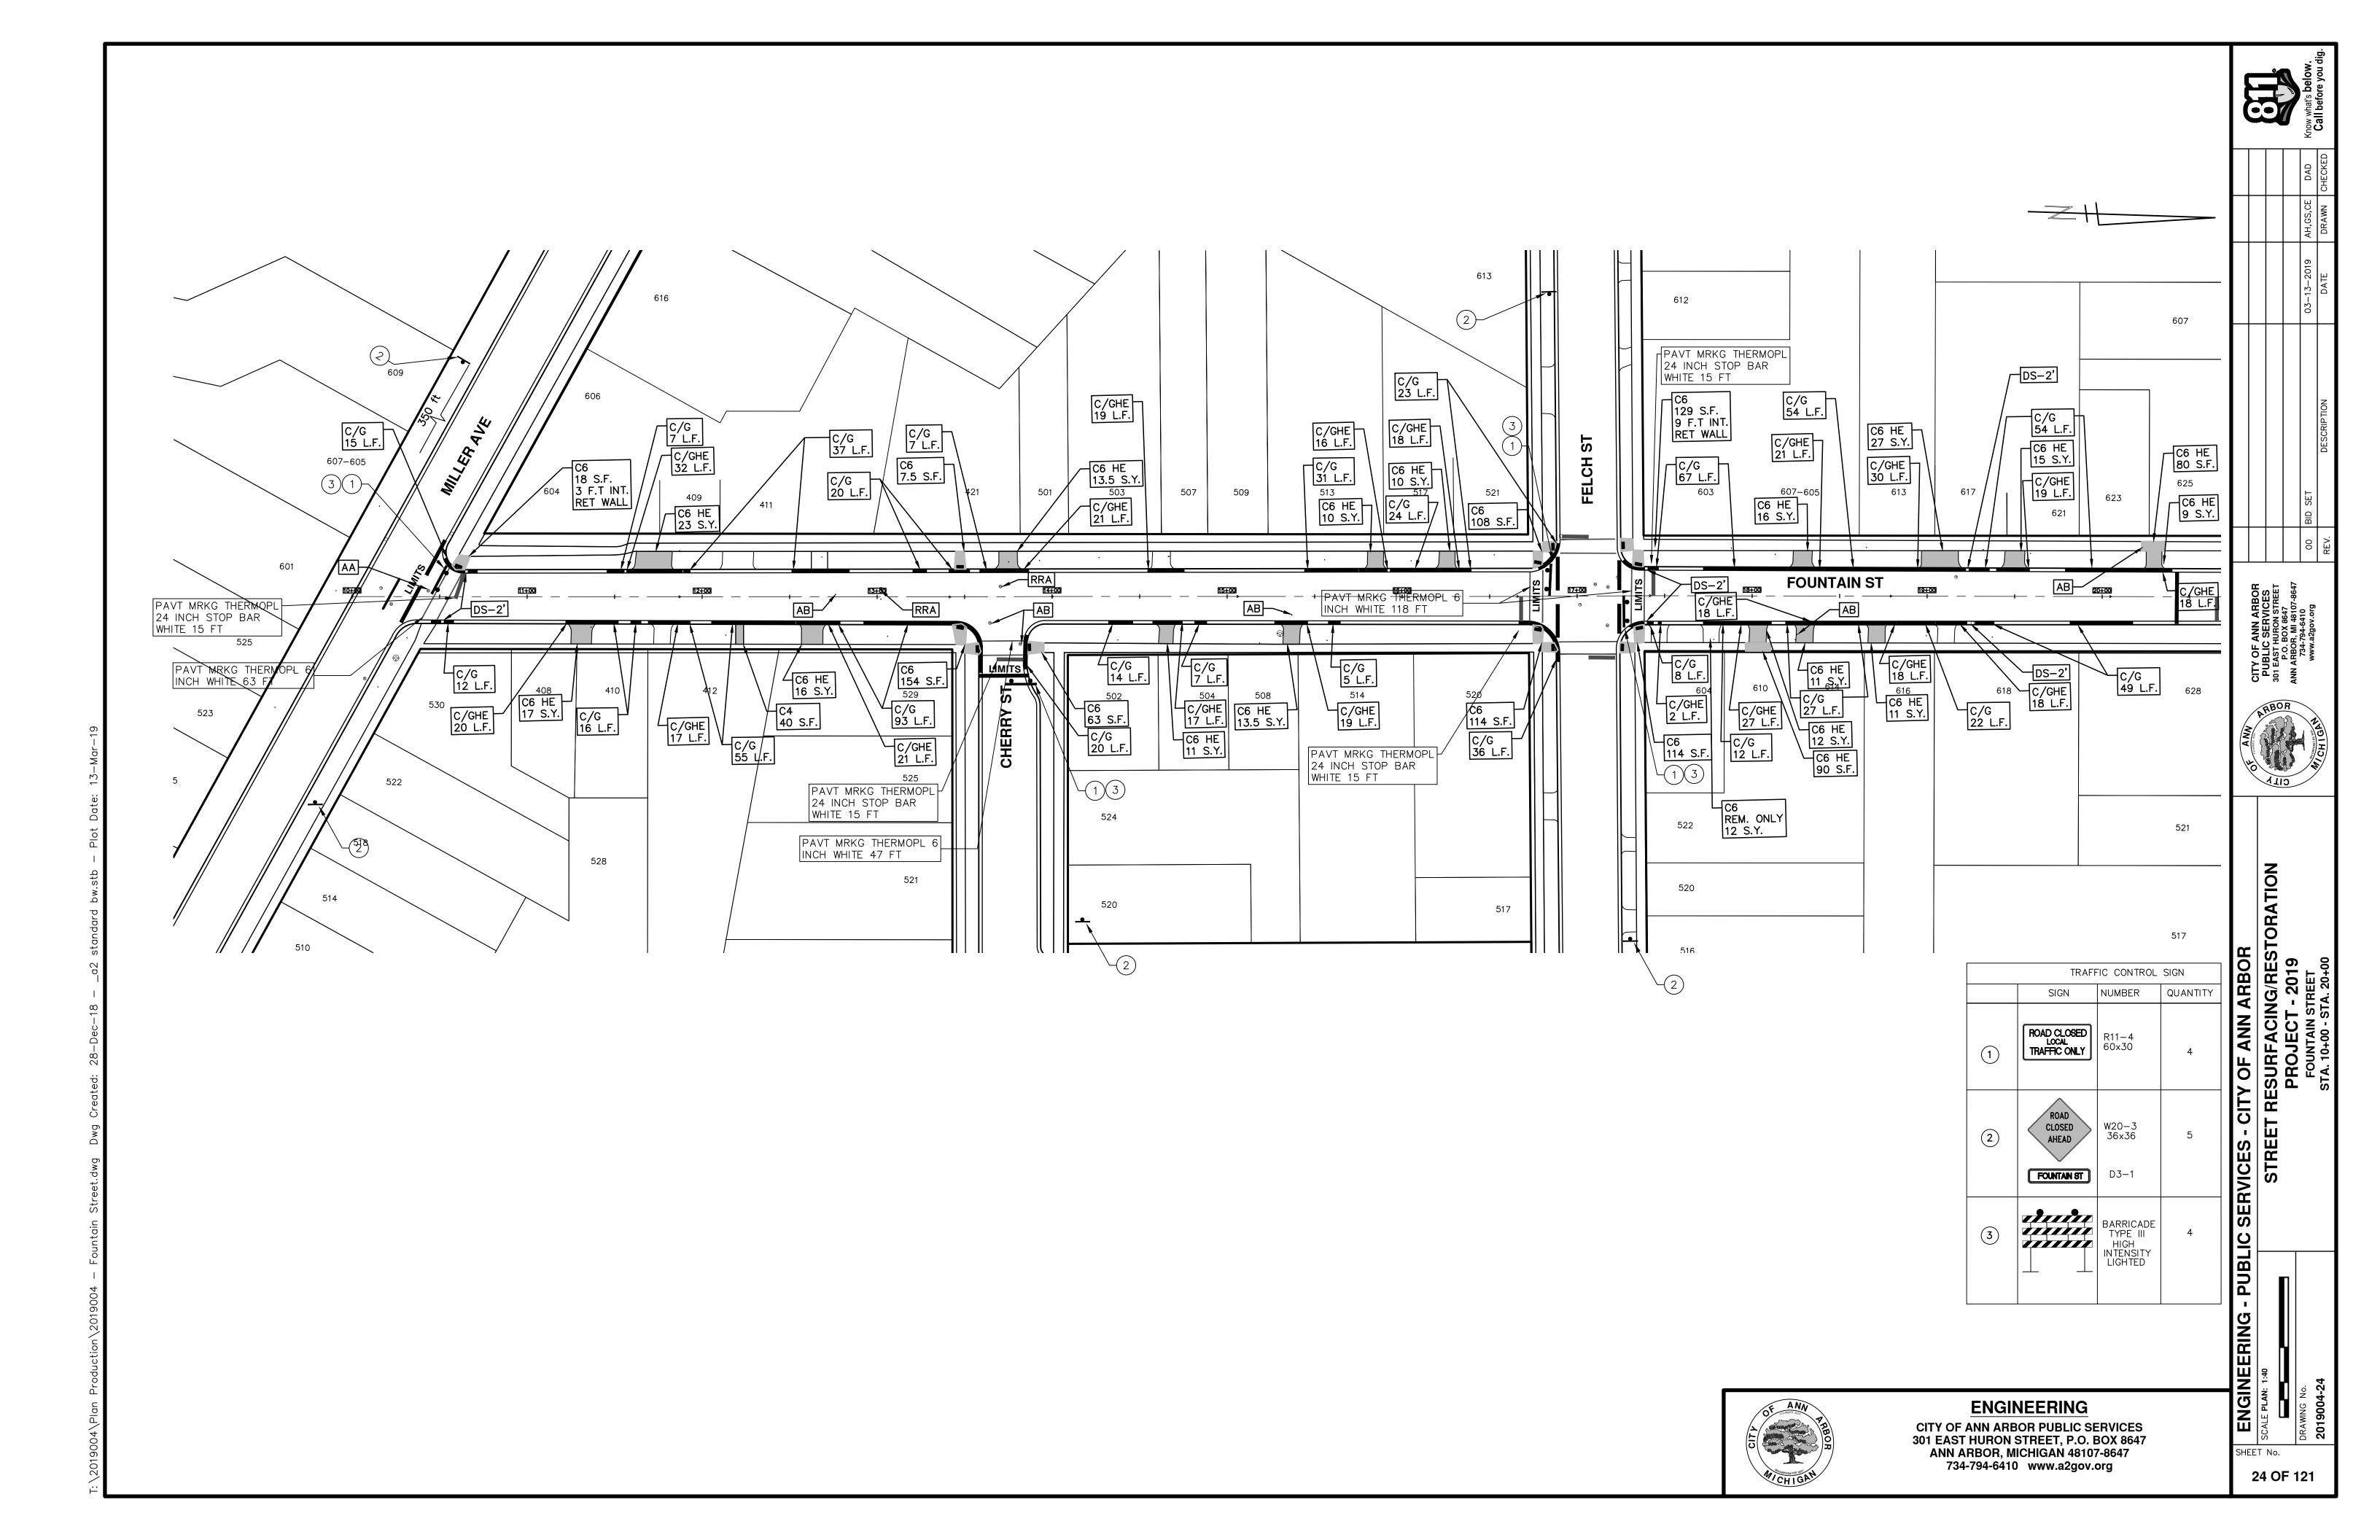

CITY OF ANN ARBOR ENGINEERING PROJECT LOCATION: GOTT STREET

ITB No. 4570 FILE No. 2019004

	CONSTRUCTION KEY
KEY	ASSOCIATED PAY ITEM(S)
	• _Dr Structure, Adj, Case 1, Modified
AA	• _Dr Structure, Adj, Case 2, Modified
	• _Dr Structure, Temp Lowering, Modified
	• _Dr Structure, Temp Lowering, Modified
AB	• _Gate Box, Adj, Case 1
	• _Gate Box, Adj, Case 2
ADOT	• _Monument Box Adjust
ADST	• _Dr Structure, Adj, Add Depth, Modified
AK	 _Dr Structure, Adj, Case 1, Modified _Sidewalk, Sidewalk Ramp, and Driveway Approach, Any Thickness, Rem
C4	• _Grading, Sidewalk
04	Sidewalk, Conc, 4 inch, Modified
	• _Sidewalk, Sidewalk Ramp, and Driveway Approach, Any Thickness, Rem
	• _Grading, Sidewalk
C4HE	• Cement
	• _Sidewalk, Conc, 4 inch, Modified
	• _Sidewalk, Sidewalk Ramp, and Driveway Approach, Any Thickness, Rem
	• _Grading, Sidewalk
00	Grading, Sidewalk Ramp
C6	Detectable Warning Surface, Modified
	Sidewalk Ramp, Conc, 6 inch, Modified
	Sidewalk, Conc, 6 inch, Modified
<u> </u>	• _Grading, Driveway Approach
C8	• _Driveway, Nonreinf Conc, 8 inch, Modified
	• _Sidewalk, Sidewalk Ramp, and Driveway Approach, Any Thickness, Rem
	• _Grading, Driveway Approach
	• _Grading, Sidewalk
	• _Grading, Sidewalk Ramp
C HE	• Cement
OTIL	• _Driveway, Nonreinf Conc, 6 inch, Modified
	• _Driveway, Nonreinf Conc, 8 inch, Modified
	• _Detectable Warning Surface, Modified
	• _Sidewalk Ramp, Conc, 6 inch, Modified
	• _Sidewalk, Conc, 6 inch, Modified
C/G	• _Curb, Gutter, and Curb and Gutter, Any Type, Rem
	• _Curb and Gutter, Conc
0/0/15	• _Curb, Gutter, and Curb and Gutter, Any Type, Rem
C/GHE	• Cement
	• _Driveway Opening, Conc, Det M, Modified
CP	• _Grading, Sidewalk
CR	• _Sidewalk, Conc, 4 inch, Modified
UK	 _Sidewalk, Sidewalk Ramp, and Driveway Approach, Any Thickness, Rem Dr Structure, Rem
DS	Sewer, Rem, Less than 24 inch
DS	• Dr Structure, 24 inch dia
	• Dr Structure, Rem
DSDI	• Sewer, Rem, Less than 24 inch
2001	• Dr Structure, Double Inlet
PT	Dr Structure, Point
	Dr Structure Cover, Type B
	• _Dr Structure Cover, Type B, Special
RRA	Dr Structure, Adj, Case 1, Modified
	• _Dr Structure, Temp Lowering, Modified
DDI	Dr Structure Cover, Type K
RRK	• _Dr Structure, Adj, Case 1, Modified
RS	• _Dr Structure, Reconstruct
	Plastic Drum, High Intensity, Lighted, Furn
TYPE II	Plastic Drum, High Intensity, Lighted, Oper
YPE III	Barricade Type III High Intensity Double Sided Lighted Furn
	Barricade, Type III, High Intensity, Double Sided, Lighted, Oper



Y OF ANN ARBOR
ESURFACING/REST
PROJECT - 2019
GOTT STREET
SUBSET COVED CHILL

SHEET No.

28 OF 121

ENGINEERING

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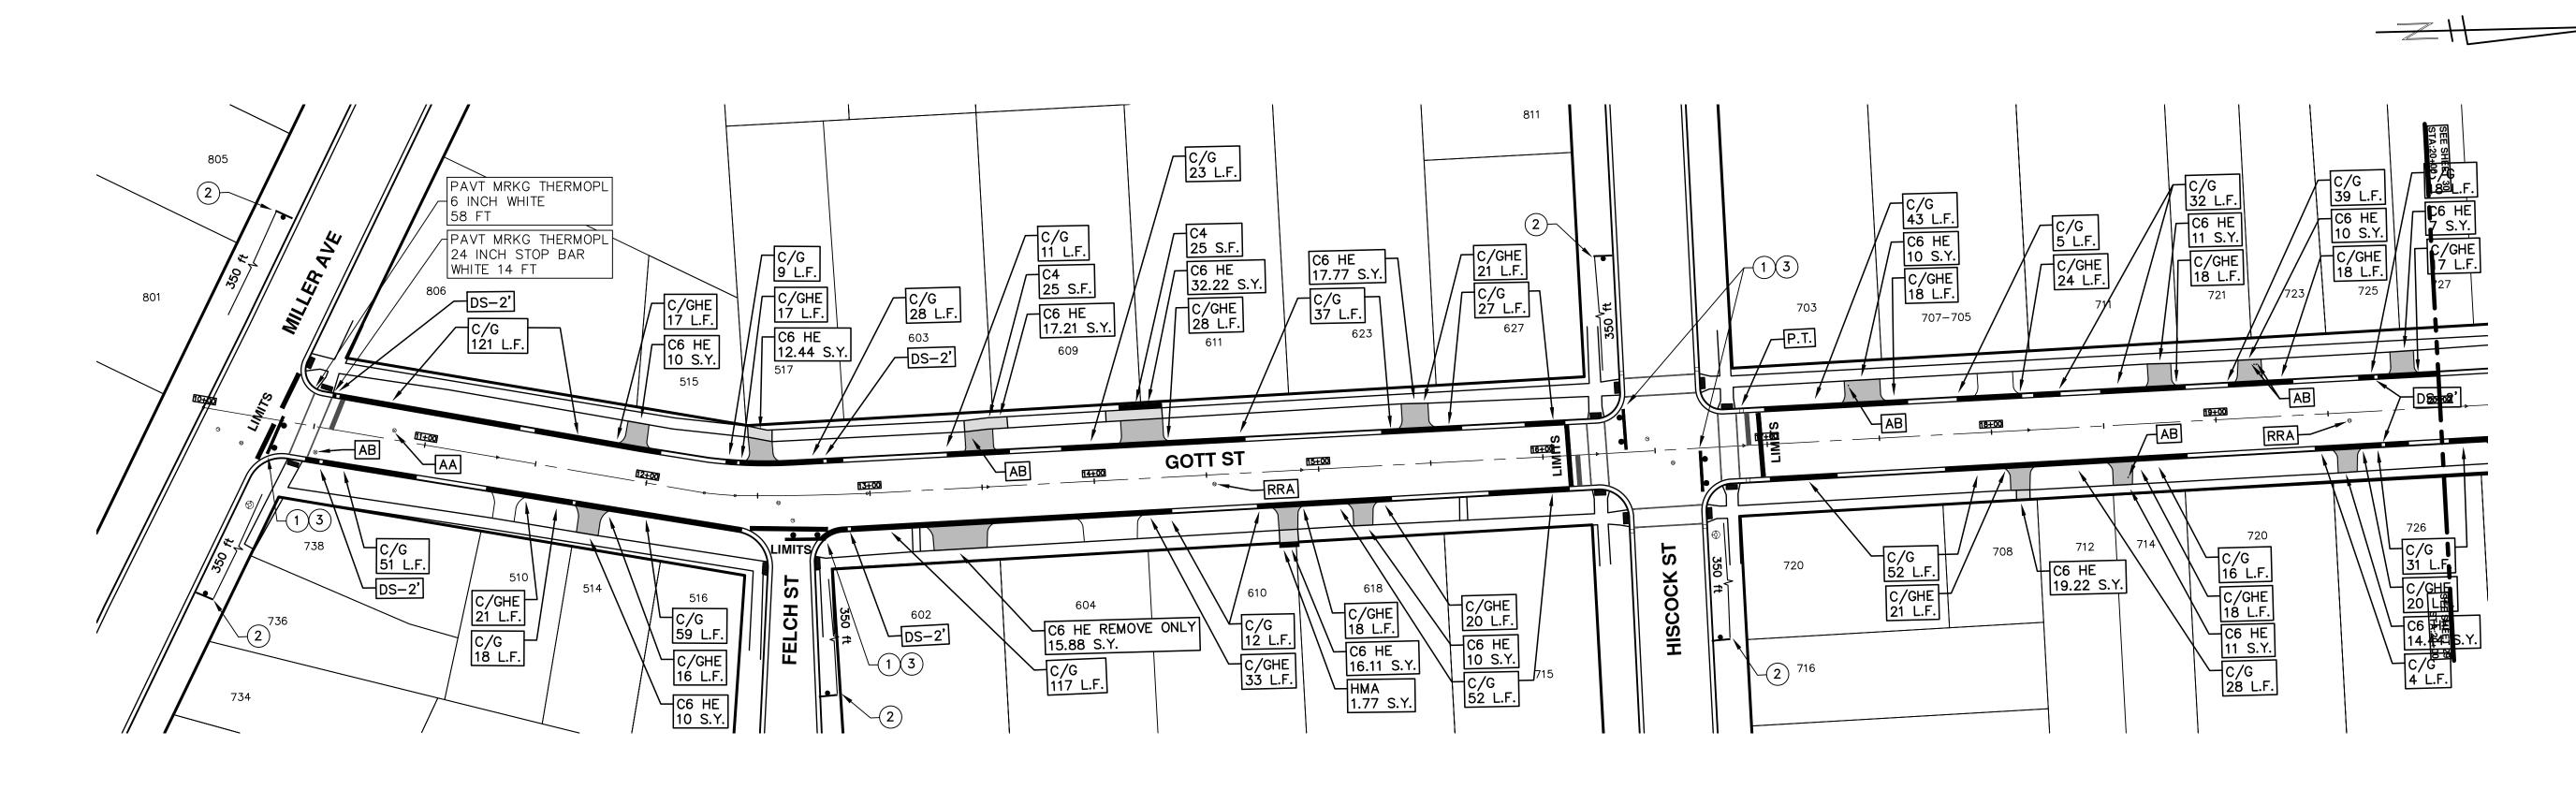
WHO MAY NOT BE A PART OF THE "MISS DIG" ALERT SYSTEM.



THE PROJECT CONTRACT DOCUMENTS.

NOTES:

UTILITIES.



TRAFFIC CONTROL SIGN					
	SIGN	NUMBER	QUANTITY		
1)	ROAD CLOSED LOCAL TRAFFFIC ONLY	R11-4 60×30	4		
2	ROAD CLOSED AHEAD	W20-3 36x36 D3-1	5		
3		BARRICADE TYPE III HIGH INTENSITY LIGHTED	4		

ENGINEERING


CITY OF ANN ARBOR PUBLIC SERVICES 301 EAST HURON STREET, P.O. BOX 8647 ANN ARBOR, MICHIGAN 48107-8647 734-794-6410 www.a2gov.org


CITY OF ANN ARBOR PUBLIC SERVICES 301 EAST HURON STREET P.O. BOX 8647 ANN ARBOR, MI 48107-8647 734-794-6410 www.a2gov.org

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STREET RESURFACING/RESTORATIO
PROJECT - 2019
GOTT STREET
STA. 10+00 - STA. 20+00

ENGINEERING - PUBLIC SERVICES - CITY OF ANN ARBOR



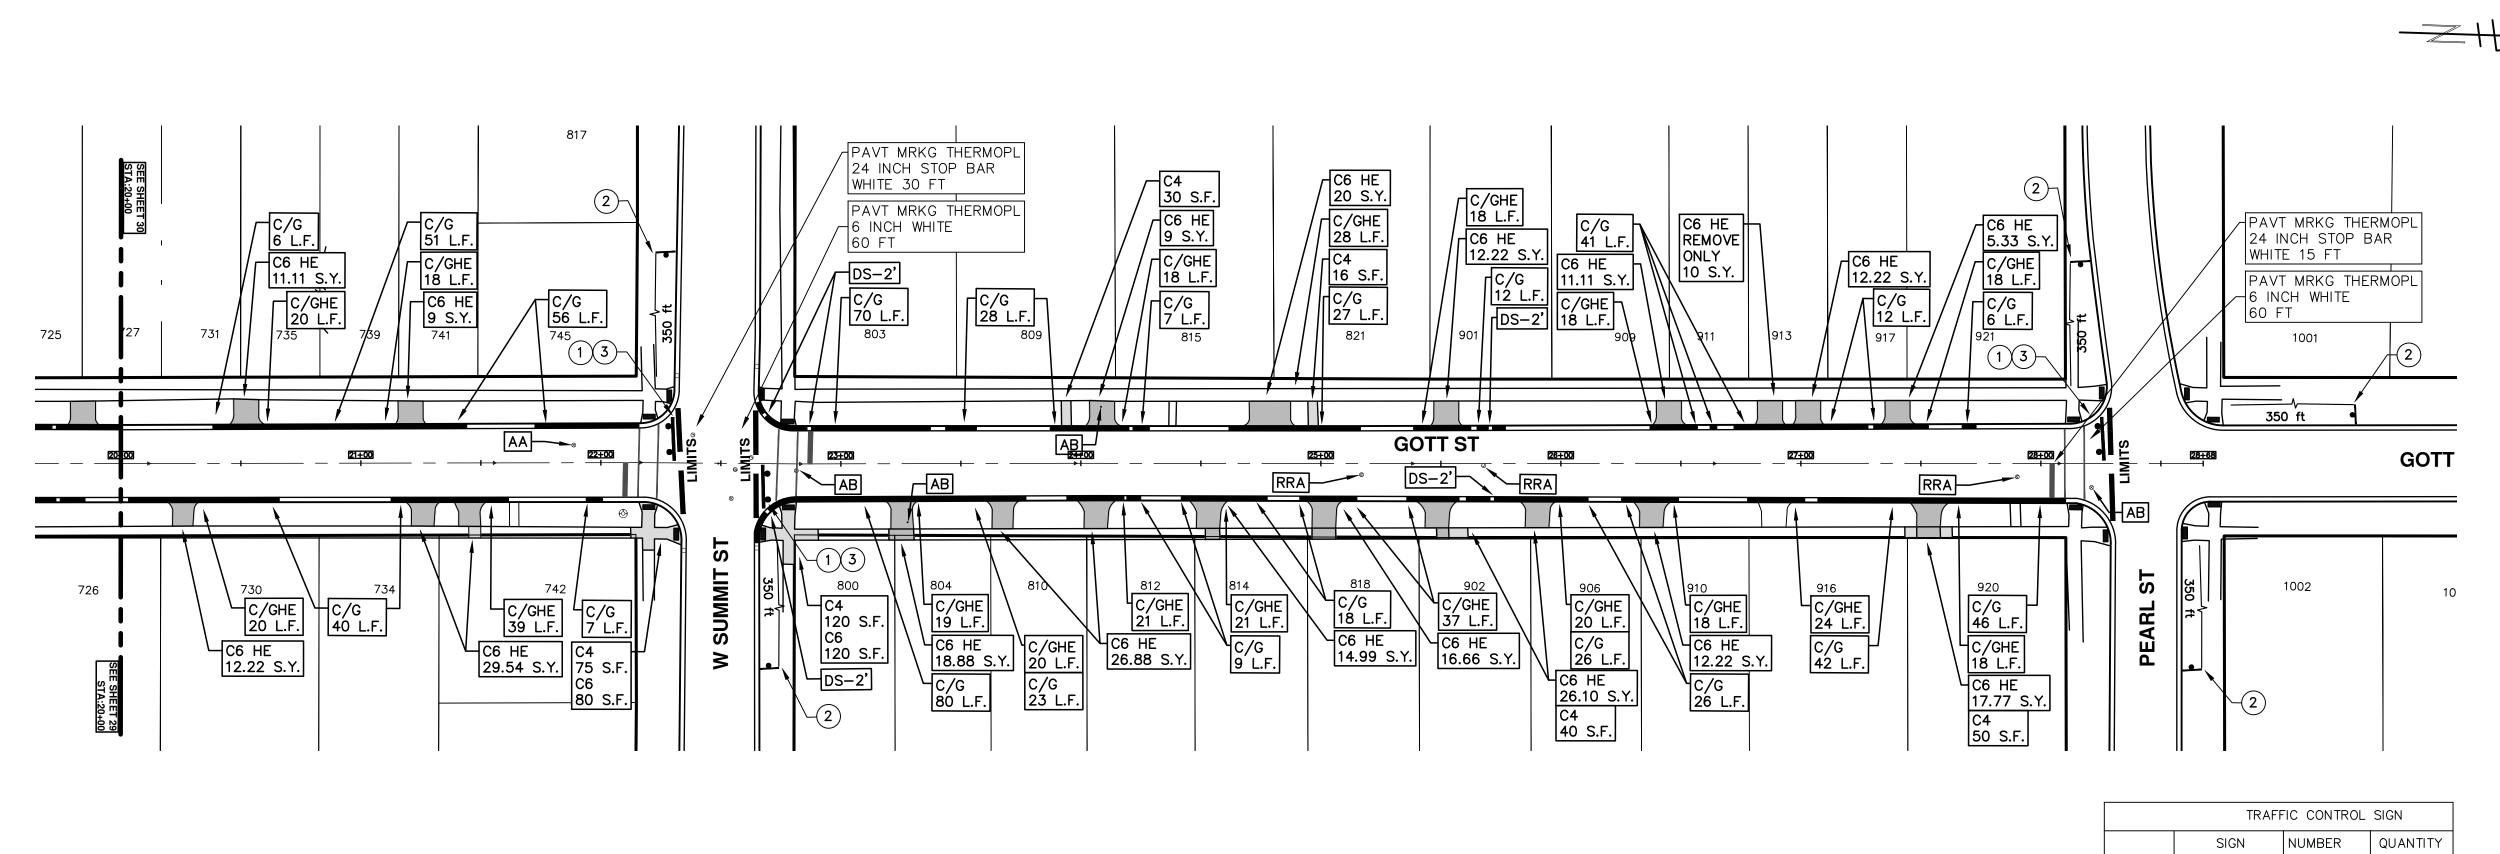

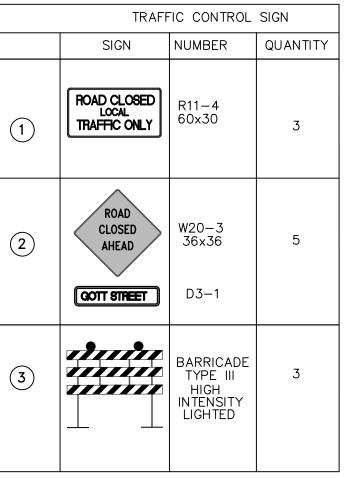ENGINEERING

CITY OF ANN ARBOR PUBLIC SERVICES 301 EAST HURON STREET, P.O. BOX 8647 ANN ARBOR, MICHIGAN 48107-8647 734-794-6410 www.a2gov.org

CITY OF ANN ARBOR PUBLIC SERVICES 301 EAST HURON STREET P.O. BOX 8647 ANN ARBOR, MI 48107-8647 734-794-6410 www.a2gov.org ENGINEERING - PUBLIC SERVICES - CITY OF ANN ARBOR

SCALE PLAN: 1:40

SCALE PLAN: 1:40

SCALE PLAN: 1:40

DRAWING No.

GOTT STREET

GOTT STREET

SCALE RESURFACING/REST

AGOTT STREET

SCALE PLAN: 1:40

STA. 20+00 - STA. 28+68



CITY OF ANN ARBOR ENGINEERING PROJECT LOCATION: HILLCREST DRIVE

ITB No. 4570 FILE No. 2019004

	CONSTRUCTION KEY
KEY	ASSOCIATED PAY ITEM(S)
	• _Dr Structure, Adj, Case 1, Modified
AA	• _Dr Structure, Adj, Case 2, Modified
	• _Dr Structure, Temp Lowering, Modified
	• _Dr Structure, Temp Lowering, Modified
AB	• _Gate Box, Adj, Case 1
AD	• _Gate Box, Adj, Case 2
	Monument Box Adjust
ADST	Dr Structure, Adj, Add Depth, Modified
AK	• _Dr Structure, Adj, Case 1, Modified
	• _Sidewalk, Sidewalk Ramp, and Driveway Approach, Any Thickness, Rem
C4	• Grading, Sidewalk
•	• Sidewalk, Conc, 4 inch, Modified
	• _Sidewalk, Sidewalk Ramp, and Driveway Approach, Any Thickness, Rem
	• Grading, Sidewalk
C4HE	
	• Cement
	• _Sidewalk, Conc, 4 inch, Modified
	• _Sidewalk, Sidewalk Ramp, and Driveway Approach, Any Thickness, Rem
	• _Grading, Sidewalk
C6	Grading, Sidewalk Ramp
	Detectable Warning Surface, Modified
	_Sidewalk Ramp, Conc, 6 inch, Modified
	• _Sidewalk, Conc, 6 inch, Modified
C8	• _Grading, Driveway Approach
Co	• _Driveway, Nonreinf Conc, 8 inch, Modified
	• _Sidewalk, Sidewalk Ramp, and Driveway Approach, Any Thickness, Rem
	• _Grading, Driveway Approach
	• _Grading, Sidewalk
	- Grading, Sidewalk Ramp
	• Cement
C HE	Driveway, Nonreinf Conc, 6 inch, Modified
	• _Driveway, Nonreinf Conc, 8 inch, Modified
	1
	• _Detectable Warning Surface, Modified
	• _Sidewalk Ramp, Conc, 6 inch, Modified
	• _Sidewalk, Conc, 6 inch, Modified
C/G	• _Curb, Gutter, and Curb and Gutter, Any Type, Rem
	• _Curb and Gutter, Conc
	 Curb, Gutter, and Curb and Gutter, Any Type, Rem
C/GHE	Cement
	 _Driveway Opening, Conc, Det M, Modified
CP	• _Grading, Sidewalk
CF	• _Sidewalk, Conc, 4 inch, Modified
CR	• _Sidewalk, Sidewalk Ramp, and Driveway Approach, Any Thickness, Rem
	Dr Structure, Rem
DS	Sewer, Rem, Less than 24 inch
	Dr Structure, 24 inch dia
	• Dr Structure, Rem
DSDI	• Sewer, Rem, Less than 24 inch
БОБІ	Dr Structure, Double Inlet
	-
PT	• _Dr Structure, Point
	• Dr Structure Cover, Type B
RRA	• _Dr Structure Cover, Type B, Special
. 31 34 3	• _Dr Structure, Adj, Case 1, Modified
	• _Dr Structure, Temp Lowering, Modified
	Dr Structure Cover, Type K
RRK	Dr Structure Cover, Type K_Dr Structure, Adj, Case 1, Modified
RRK	• _Dr Structure, Adj, Case 1, Modified
RRK RS	_Dr Structure, Adj, Case 1, Modified _Dr Structure, Reconstruct
RRK	 _Dr Structure, Adj, Case 1, Modified _Dr Structure, Reconstruct Plastic Drum, High Intensity, Lighted, Furn
RRK RS	_Dr Structure, Adj, Case 1, Modified _Dr Structure, Reconstruct

NOTES:

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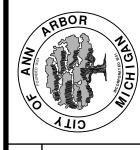


ENGINEERING

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		AH,GS,CE	DRAWN	
		03-13-2019	DATE	
			ON	

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Y OF ANN ARBOR
ESURFACING/RESTORATION
PROJECT - 2019
HILLCREST DRIVE
SUBSET COVER SHEET

STREET RESURFACT


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31 OF 121

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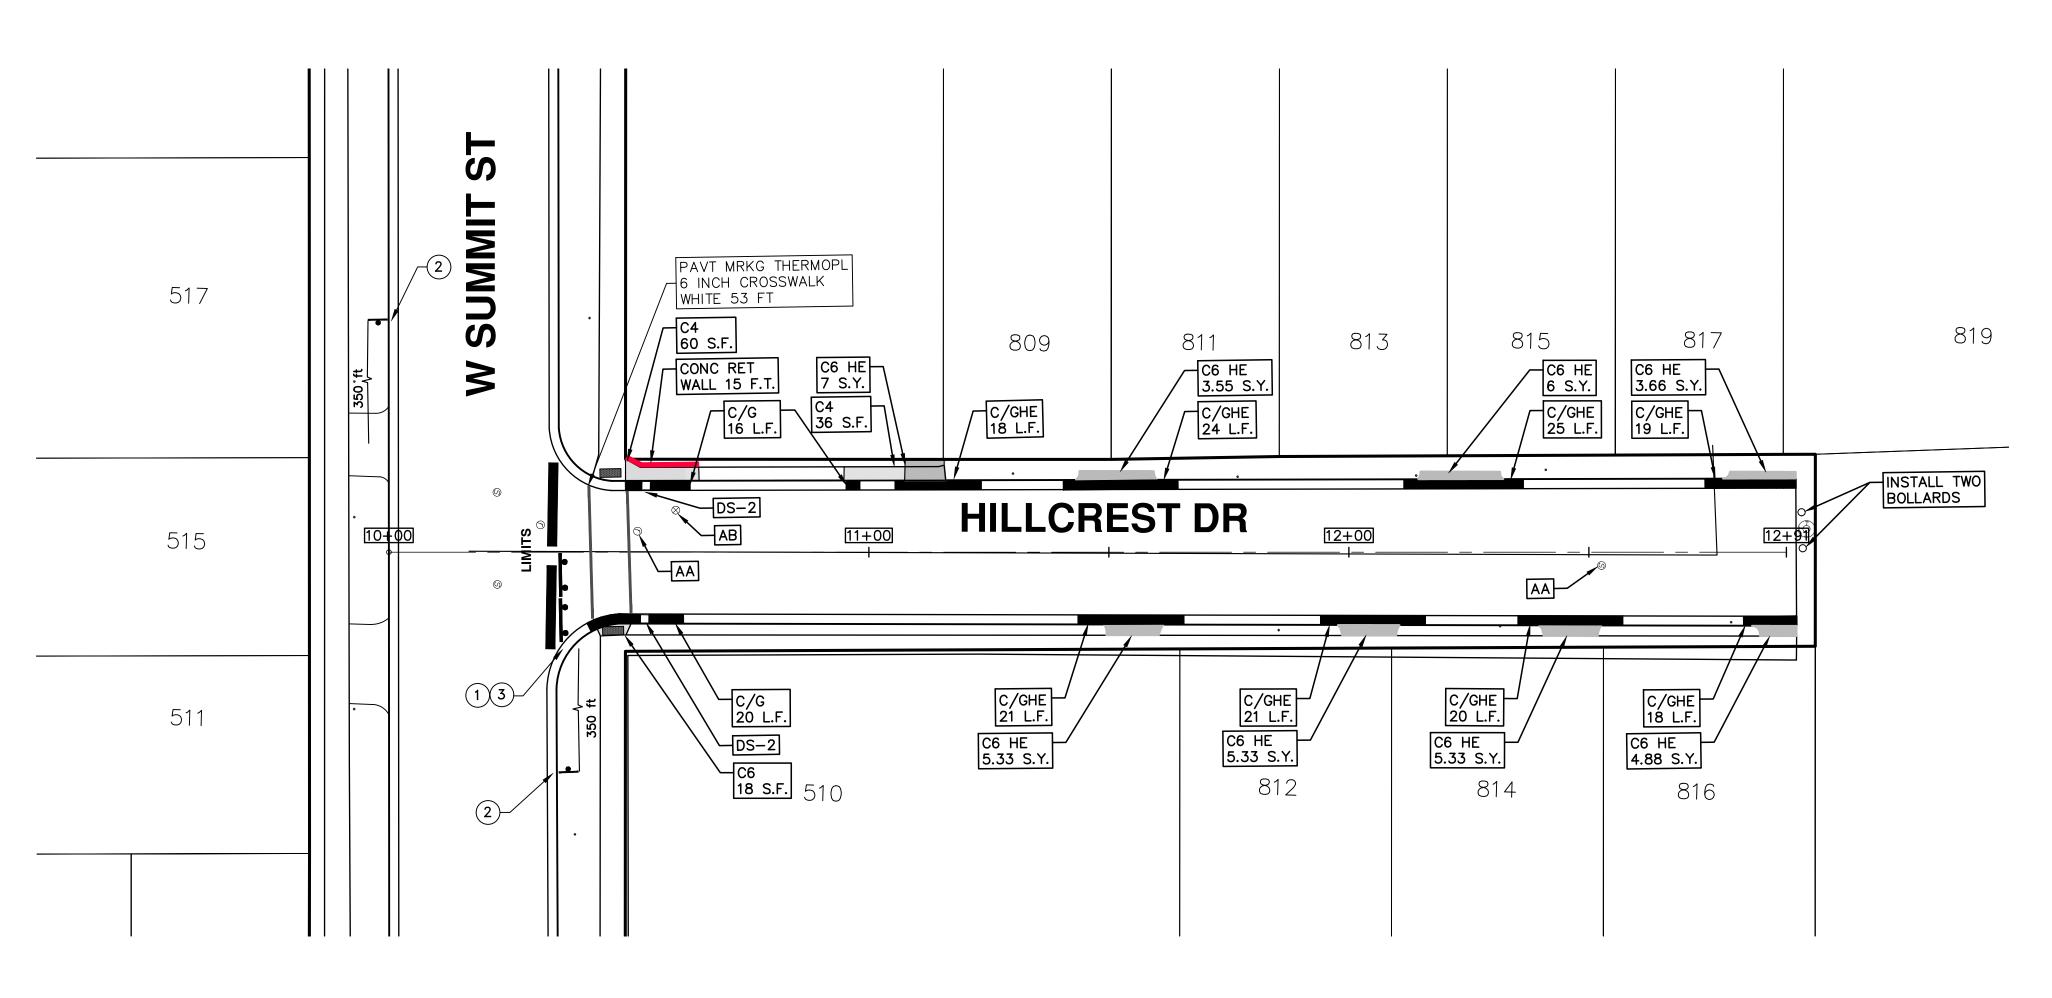


ENGINEERING - PUBLIC SERVICES - CITY OF ANN ARBOR

SCALE PLAN: 1" = 20

DRAWING No.

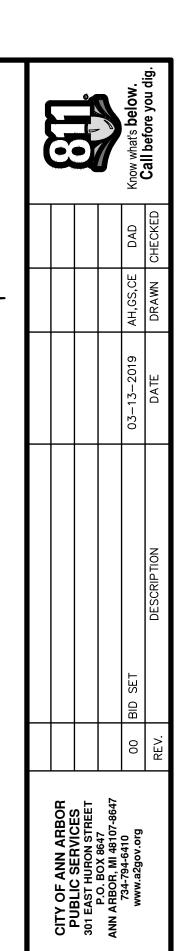PROJECT - 2019
STA. 10+00 - STA. 12+91



	TRAFF	TIC CONTROL	SIGN
	SIGN	NUMBER	QUANTITY
1)	ROAD CLOSED LOCAL TRAFFIC ONLY	R11-4 60x30	1
2	ROAD CLOSED AHEAD	W20-3 36×36 D3-1	2
3		BARRICADE TYPE III HIGH INTENSITY LIGHTED	2



CITY OF ANN ARBOR ENGINEERING PROJECT LOCATION: HISCOCK STREET

ITB No. 4570 FILE No. 2019004

KEY	ASSOCIATED PAY ITEM(S)
- X I	Dr Structure, Adj, Case 1, Modified
AA	• _Dr Structure, Adj, Case 1, Modified
	1 -
	Dr Structure, Temp Lowering, Modified Dr Structure, Temp Lowering, Modified
	• _Dr Structure, Temp Lowering, Modified
AB	• _Gate Box, Adj, Case 1
	• _Gate Box, Adj, Case 2
ADOT	• _Monument Box Adjust
ADST	• _Dr Structure, Adj, Add Depth, Modified
AK	• _Dr Structure, Adj, Case 1, Modified
	• _Sidewalk, Sidewalk Ramp, and Driveway Approach, Any Thickness, Rem
C4	• _Grading, Sidewalk
	• _Sidewalk, Conc, 4 inch, Modified
	• _Sidewalk, Sidewalk Ramp, and Driveway Approach, Any Thickness, Rem
C4HE	• _Grading, Sidewalk
OTIL	Cement
	• _Sidewalk, Conc, 4 inch, Modified
	• _Sidewalk, Sidewalk Ramp, and Driveway Approach, Any Thickness, Rem
	• _Grading, Sidewalk
CG	• _Grading, Sidewalk Ramp
C6	Detectable Warning Surface, Modified
	- Sidewalk Ramp, Conc, 6 inch, Modified
	• _Sidewalk, Conc, 6 inch, Modified
	Grading, Driveway Approach
C8	• _Driveway, Nonreinf Conc, 8 inch, Modified
	Sidewalk, Sidewalk Ramp, and Driveway Approach, Any Thickness, Rem
	Grading, Driveway Approach
	• _Grading, Sidewalk
	Grading, Sidewalk RampCement
C HE	
	• _Driveway, Nonreinf Conc, 6 inch, Modified
	• _Driveway, Nonreinf Conc, 8 inch, Modified
	• _Detectable Warning Surface, Modified
	• _Sidewalk Ramp, Conc, 6 inch, Modified
	• _Sidewalk, Conc, 6 inch, Modified
C/G	• _Curb, Gutter, and Curb and Gutter, Any Type, Rem
	_Curb and Gutter, Conc
	• _Curb, Gutter, and Curb and Gutter, Any Type, Rem
C/GHE	Cement
	• _Driveway Opening, Conc, Det M, Modified
СР	• _Grading, Sidewalk
OP.	• _Sidewalk, Conc, 4 inch, Modified
CR	• _Sidewalk, Sidewalk Ramp, and Driveway Approach, Any Thickness, Rem
	• Dr Structure, Rem
DS	• Sewer, Rem, Less than 24 inch
-	• Dr Structure, 24 inch dia
	• Dr Structure, Rem
DSDI	• Sewer, Rem, Less than 24 inch
_ 551	Dr Structure, Double Inlet
PT	Dr Structure, Point
r I	_
	Dr Structure Cover, Type B Dr Structure Cover, Type B. Special
RRA	Dr Structure Cover, Type B, Special Dr Structure Adi Coop 1 Medifod
	• _Dr Structure, Adj, Case 1, Modified
	• _Dr Structure, Temp Lowering, Modified
RRK	Dr Structure Cover, Type K
	• _Dr Structure, Adj, Case 1, Modified
RS	• _Dr Structure, Reconstruct
YPE II	Plastic Drum, High Intensity, Lighted, Fum
	Plastic Drum, High Intensity, Lighted, Oper
YPE III	Barricade, Type III, High Intensity, Double Sided, Lighted, Furn
	Barricade, Type III, High Intensity, Double Sided, Lighted, Oper



TY OF ANN ARBOR
ESURFACING/RESTC
PROJECT - 2019
HISCOCK STREET
SUBSET COVER SHEET

SHEET No.


33 OF 121

NOTES:


FOR PROTECTION OF UNDERGROUND UTILITIES AND IN CONFORMANCE WITH PUBLIC ACT 174 OF 2013, THE CONTRACTOR SHALL CALL 811 OR 1-800-482-7171 A MINIMUM OF THREE FULL WORKING DAYS, EXCLUDING SATURDAYS, SUNDAYS, AND HOLIDAYS, PRIOR TO BEGINNING EACH EXCAVATION IN AREAS WHERE PUBLIC UTILITIES HAVE NOT BEEN PREVIOUSLY LOCATED. MEMBERS WILL THUS BE ROUTINELY NOTIFIED. THIS DOES NOT RELIEVE THE CONTRACTOR OF THE RESPONSIBILITY OF NOTIFYING UTILITY OWNERS WHO MAY NOT BE A PART OF THE "MISS DIG" ALERT SYSTEM.

THE UNDERGROUND LOCATIONS SHOWN FOR NATURAL GAS, TELEPHONE, ELECTRICAL POWER, CABLE TV AND FIBER OPTIC LINES ARE APPROXIMATE. THE CITY OF ANN ARBOR ASSUMES NO RESPONSIBILITY FOR THEIR ACCURATE REPRESENTATION IN THIS DRAWING. MISS DIG MUST BE CONTACTED PRIOR TO CONSTRUCTION TO LOCATE THESE UTILITIES.

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ENGINEERING

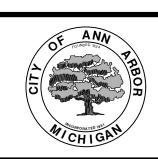

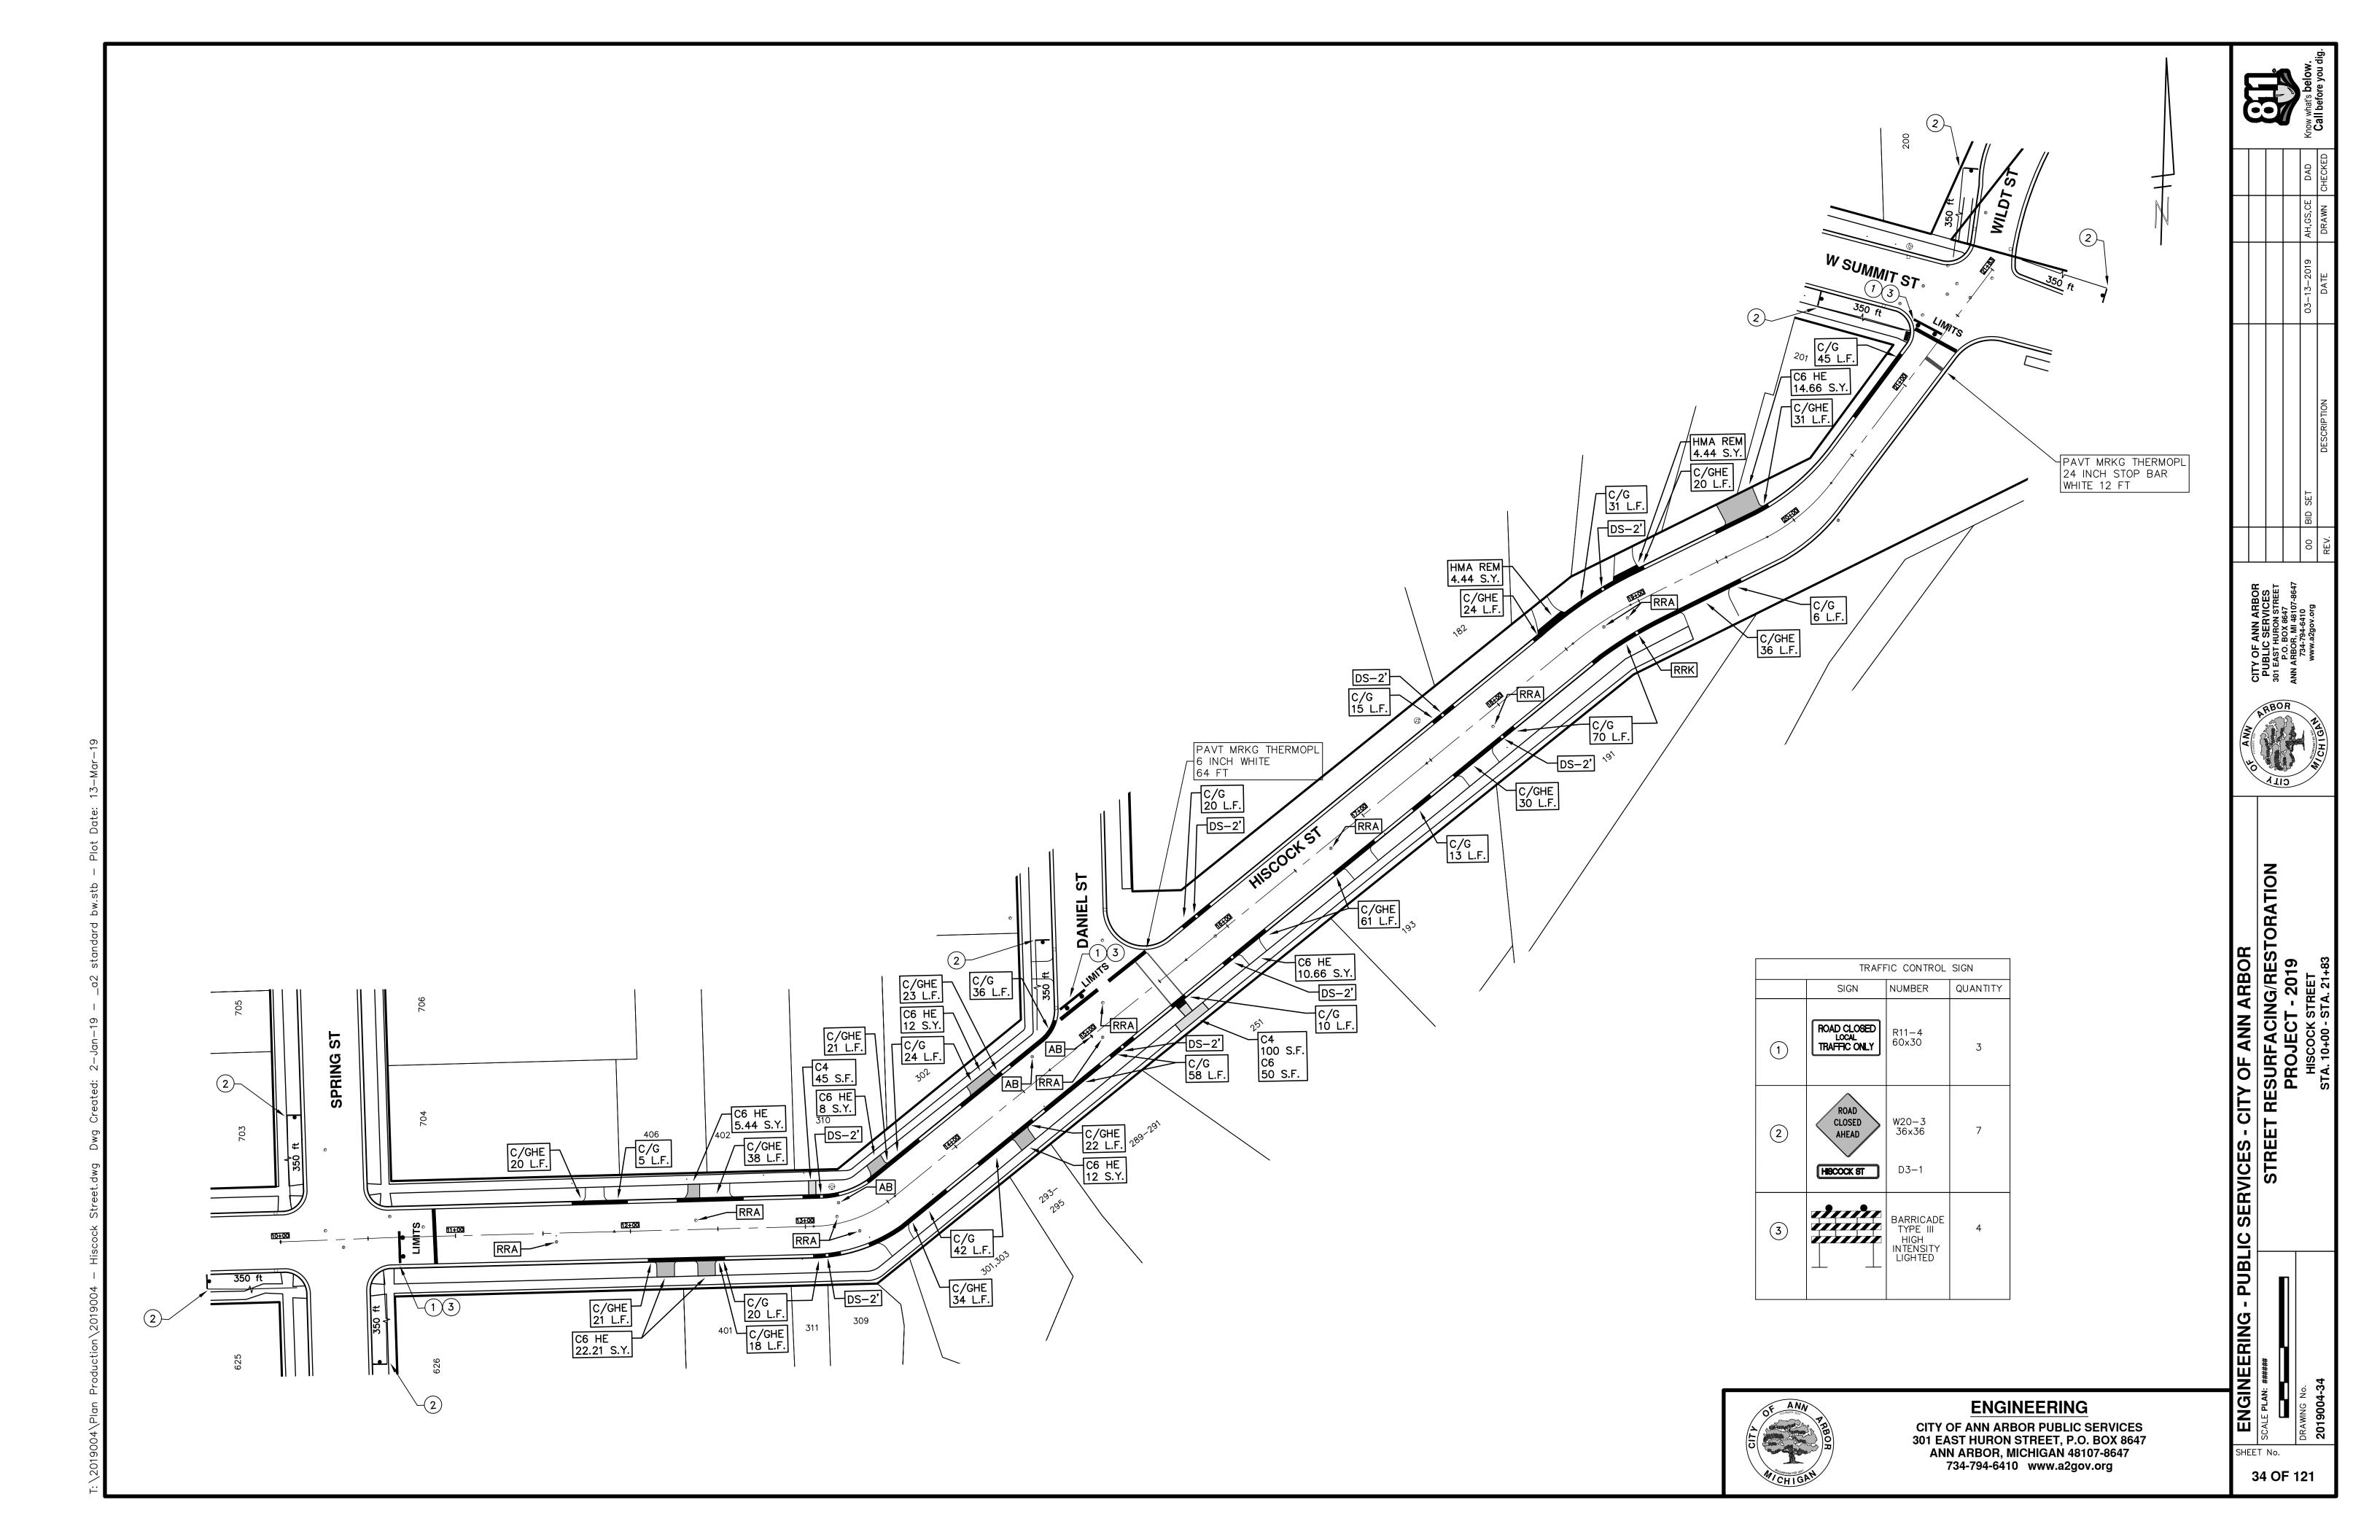

CITY OF ANN ARBOR ENGINEERING PROJECT LOCATION: MINER STREET

ITB No. 4570 FILE No. 2019004

	CONSTRUCTION KEY
KEY	ASSOCIATED PAY ITEM(S)
AA	• _Dr Structure, Adj, Case 1, Modified
	• _Dr Structure, Adj, Case 2, Modified
	_Dr Structure, Temp Lowering, Modified
АВ	• _Dr Structure, Temp Lowering, Modified
	• _Gate Box, Adj, Case 1
	• _Gate Box, Adj, Case 2
	Monument Box Adjust
ADST	Dr Structure, Adj, Add Depth, Modified
AK	Dr Structure, Adj, Case 1, Modified
	• _Sidewalk, Sidewalk Ramp, and Driveway Approach, Any Thickness, Rem
C4	Grading, Sidewalk
	Sidewalk, Conc, 4 inch, Modified
C4HE	• _Sidewalk, Sidewalk Ramp, and Driveway Approach, Any Thickness, Rem
	Grading, Sidewalk
	• Cement
	• _Sidewalk, Conc, 4 inch, Modified
	Sidewalk, Sidewalk Ramp, and Driveway Approach, Any Thickness, Rem
C6	• _Grading, Sidewalk
	• _Grading, Sidewalk Ramp
	Detectable Warning Surface, Modified
	Sidewalk Ramp, Conc, 6 inch, Modified
	Sidewalk, Conc, 6 inch, Modified
	Grading, Driveway Approach
C8	Driveway, Nonreinf Conc, 8 inch, Modified
	Sidewalk, Sidewalk Ramp, and Driveway Approach, Any Thickness, Rem
C HE	
	Grading, Driveway Approach Grading, Sidowelle
	• _Grading, Sidewalk
	• _Grading, Sidewalk Ramp
	• Cement
	• _Driveway, Nonreinf Conc, 6 inch, Modified
	• _Driveway, Nonreinf Conc, 8 inch, Modified
	• _Detectable Warning Surface, Modified
	• _Sidewalk Ramp, Conc, 6 inch, Modified
	• _Sidewalk, Conc, 6 inch, Modified
C/G	• _Curb, Gutter, and Curb and Gutter, Any Type, Rem
	• _Curb and Gutter, Conc
0/0/ !=	• _Curb, Gutter, and Curb and Gutter, Any Type, Rem
C/GHE	• Cement
	• _Driveway Opening, Conc, Det M, Modified
CP	• _Grading, Sidewalk
	• _Sidewalk, Conc, 4 inch, Modified
CR	• _Sidewalk, Sidewalk Ramp, and Driveway Approach, Any Thickness, Rem
DS	• Dr Structure, Rem
	• Sewer, Rem, Less than 24 inch
	Dr Structure, 24 inch dia
	• Dr Structure, Rem
DSDI	Sewer, Rem, Less than 24 inch
	• _Dr Structure, Double Inlet
PT	• _Dr Structure, Point
RRA	Dr Structure Cover, Type B
	• _Dr Structure Cover, Type B, Special
	• _Dr Structure, Adj, Case 1, Modified
	• _Dr Structure, Temp Lowering, Modified
RRK	Dr Structure Cover, Type K
	• _Dr Structure, Adj, Case 1, Modified
RS	• _Dr Structure, Reconstruct
	Plastic Drum, High Intensity, Lighted, Furn
T/DE "	
TYPE II	Plastic Drum, High Intensity, Lighted, Oper
TYPE II	Plastic Drum, High Intensity, Lighted, Oper Barricade, Type III, High Intensity, Double Sided, Lighted, Furn

00 BID SET 03–13–2019 AH,GS,CE DAD REV. DESCRIPTION DATE DRAWN CHECKED

CITY OF ANN ARB
PUBLIC SERVICE
301 EAST HURON STRE
P.O. BOX 8647
ANN ARBOR, MI 48107-8
734-794-6410
www.a2gov.org



RBOR 3/RESTORATION 2019

T RESURFACING/REST
PROJECT - 2019
MINER STREET

NOTES:

FOR PROTECTION OF UNDERGROUND UTILITIES AND IN CONFORMANCE WITH PUBLIC ACT 174 OF 2013, THE CONTRACTOR SHALL CALL 811 OR 1-800-482-7171 A MINIMUM OF THREE FULL WORKING DAYS, EXCLUDING SATURDAYS, SUNDAYS, AND HOLIDAYS, PRIOR TO BEGINNING EACH EXCAVATION IN AREAS WHERE PUBLIC UTILITIES HAVE NOT BEEN PREVIOUSLY LOCATED. MEMBERS WILL THUS BE ROUTINELY NOTIFIED. THIS DOES NOT RELIEVE THE CONTRACTOR OF THE RESPONSIBILITY OF NOTIFYING UTILITY OWNERS WHO MAY NOT BE A PART OF THE "MISS DIG" ALERT SYSTEM.

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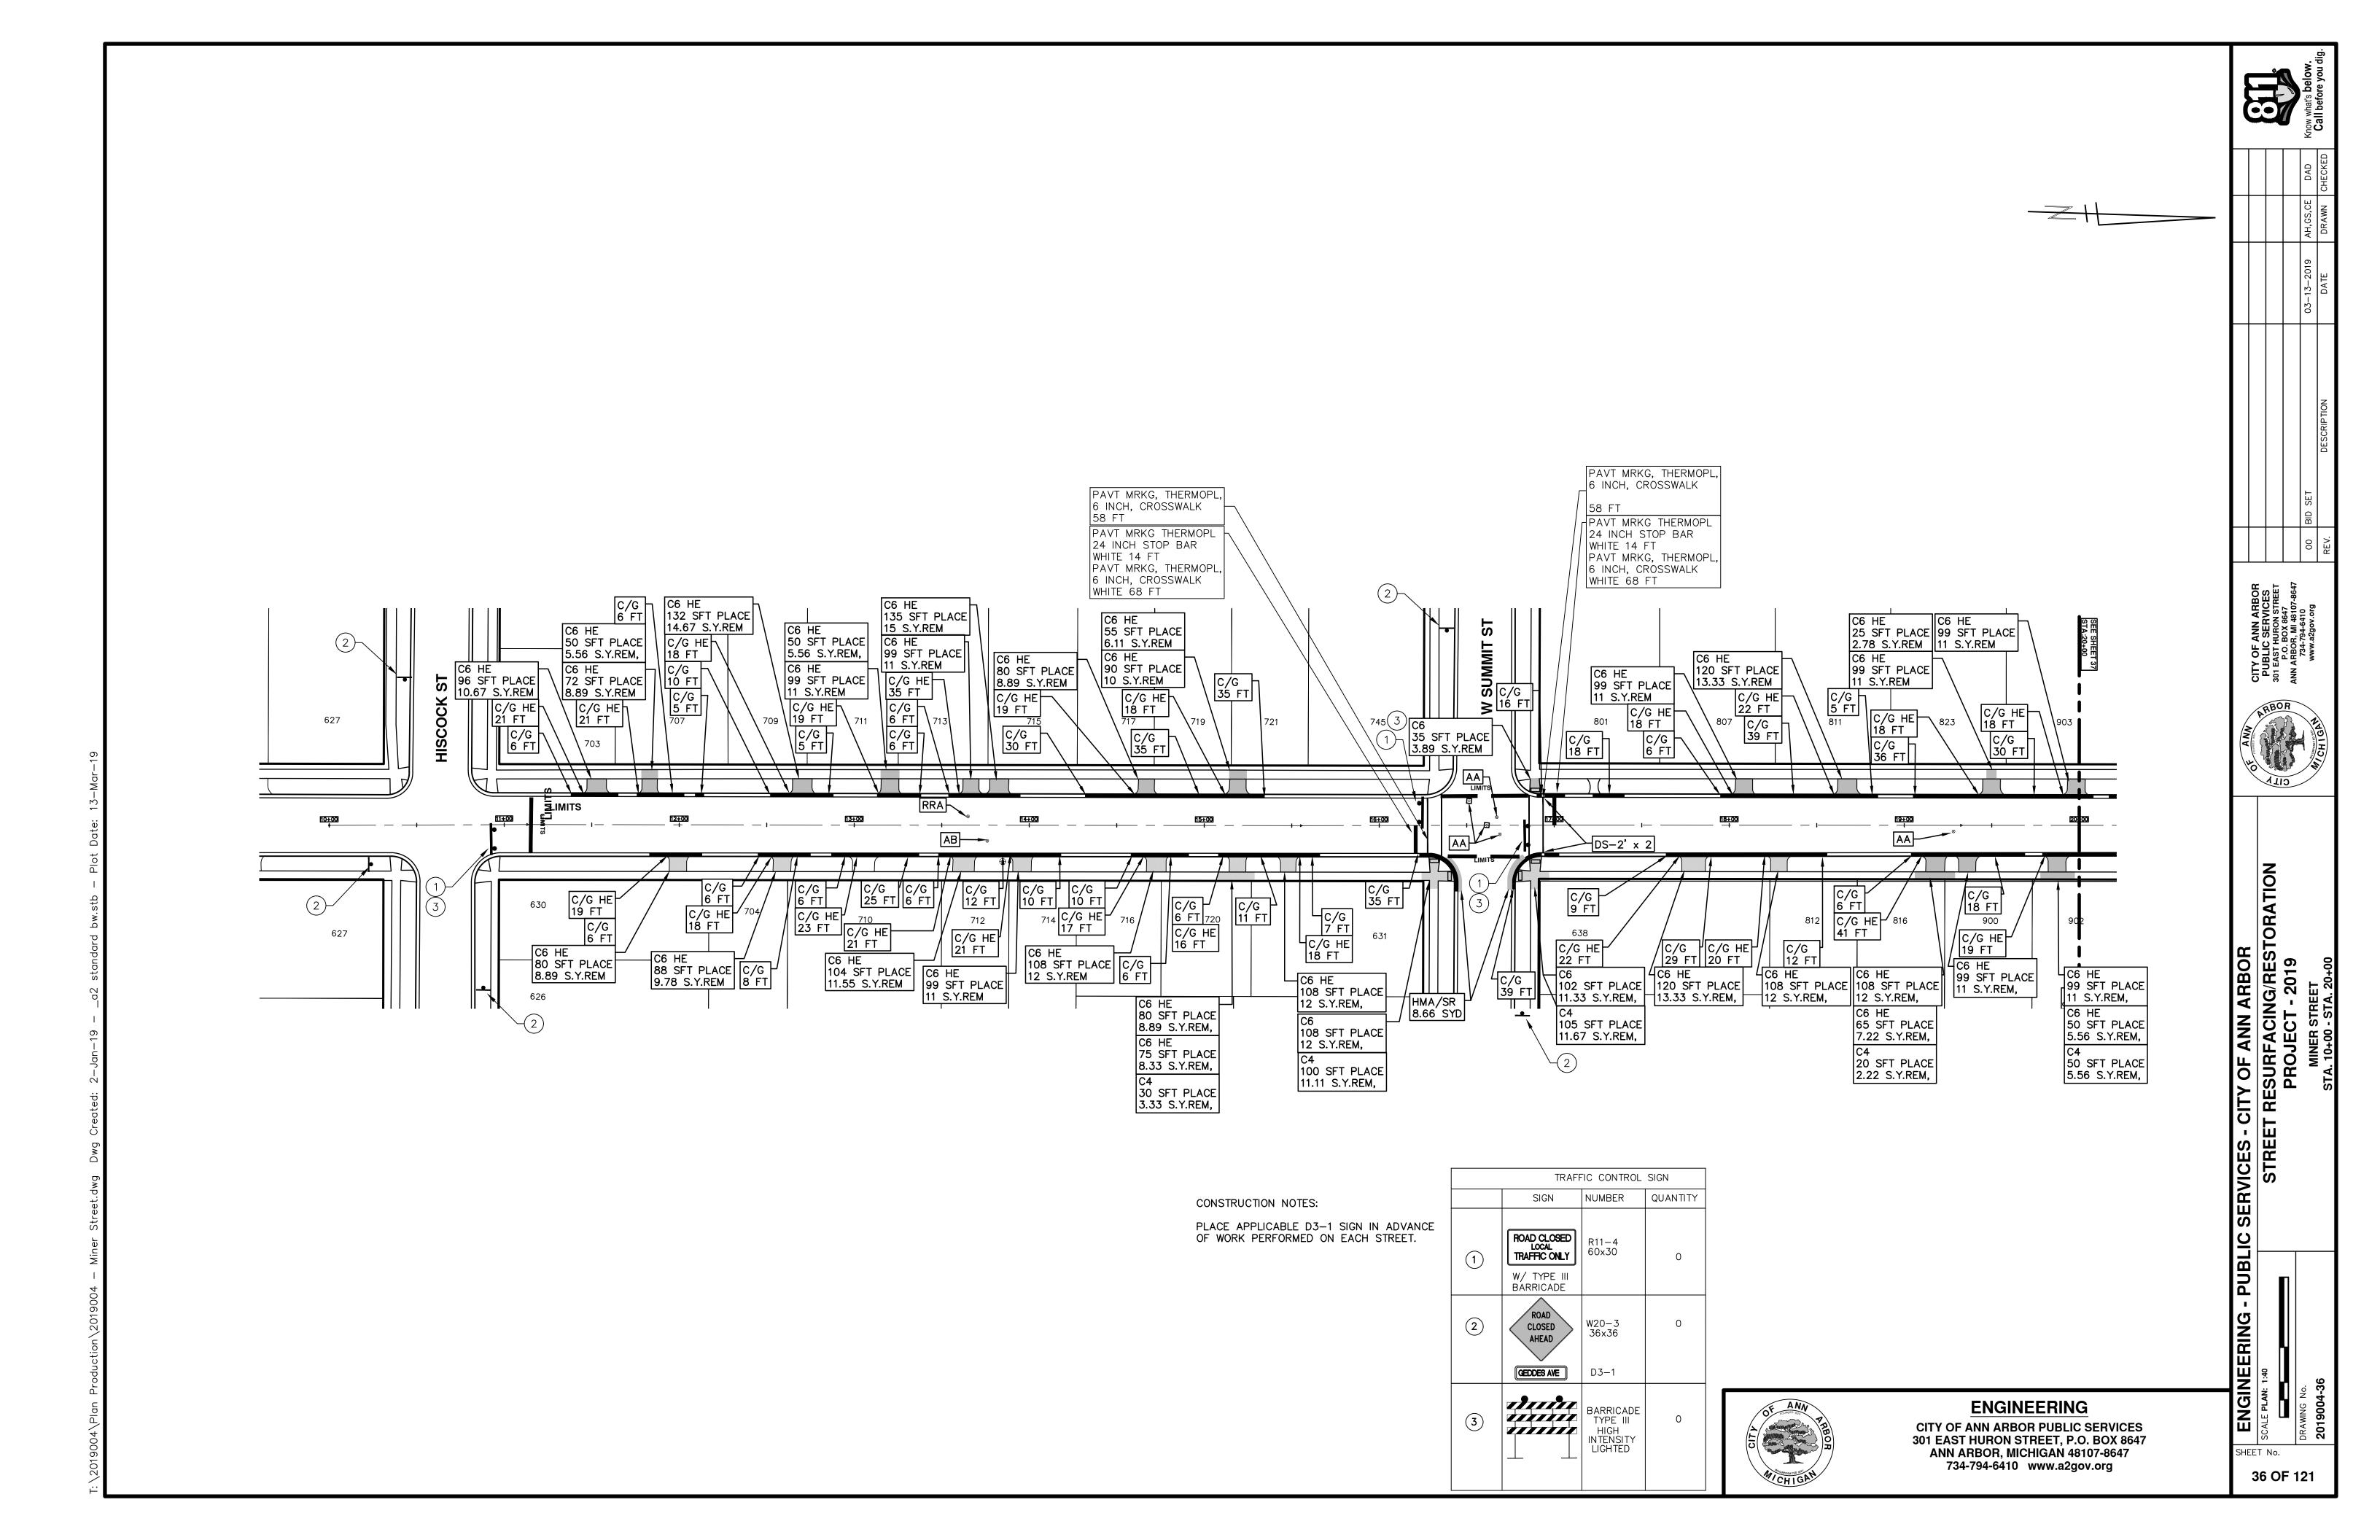
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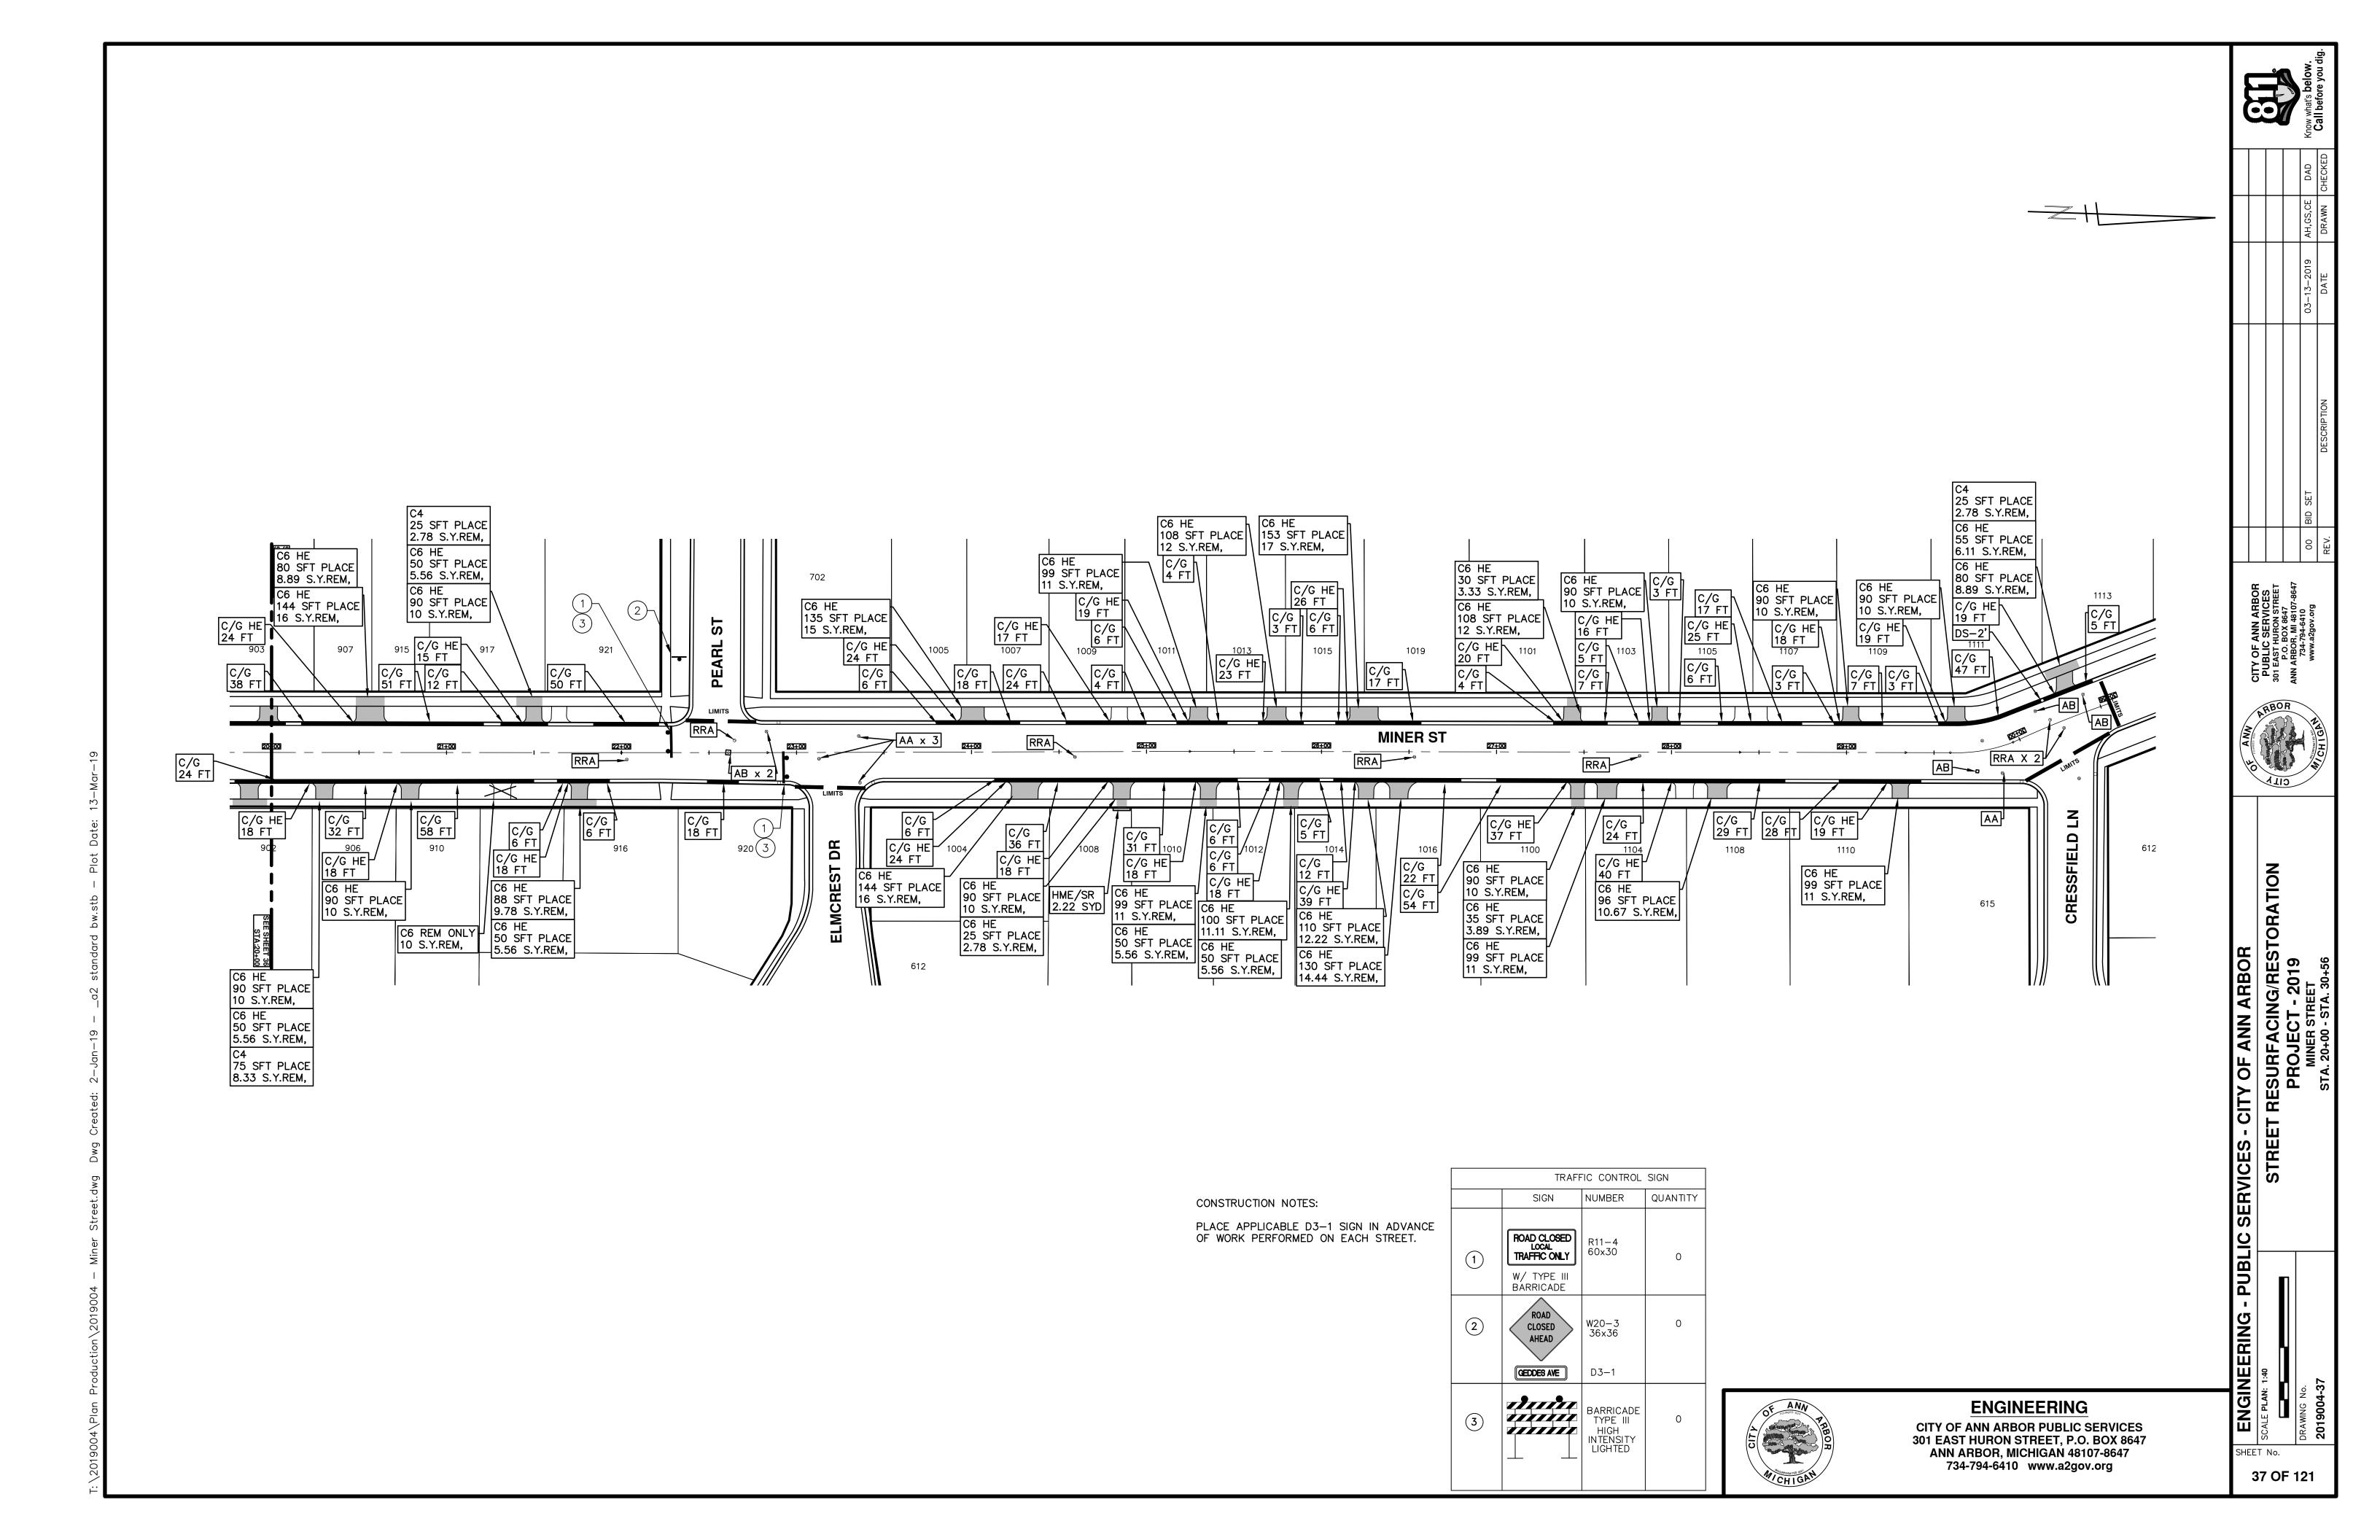


ENGINEERING

CITY OF ANN ARBOR PUBLIC SERVICES 301 EAST HURON STREET, P.O. BOX 8647 ANN ARBOR, MICHIGAN 48107-8647 734-794-6410 www.a2gov.org

SHEET No.







CITY OF ANN ARBOR ENGINEERING PROJECT LOCATION: PEARL STREET

ITB No. 4570 FILE No. 2019004

	CONSTRUCTION KEY
KEY	ASSOCIATED PAY ITEM(S)
	• _Dr Structure, Adj, Case 1, Modified
AA	• _Dr Structure, Adj, Case 2, Modified
	• _Dr Structure, Temp Lowering, Modified
	_Dr Structure, Temp Lowering, Modified
4 D	- Gate Box, Adj, Case 1
AB	Gate Box, Adj, Case 2
	Monument Box Adjust
ADST	Dr Structure, Adj, Add Depth, Modified
AK	• _Dr Structure, Adj, Case 1, Modified
	• _Sidewalk, Sidewalk Ramp, and Driveway Approach, Any Thickness, Rem
C4	• Grading, Sidewalk
	• _Sidewalk, Conc, 4 inch, Modified
	_Sidewalk, Sidewalk Ramp, and Driveway Approach, Any Thickness, Rem
	• _Grading, Sidewalk
C4HE	• Cement
	• _Sidewalk, Conc, 4 inch, Modified
	• _Sidewalk, Sidewalk Ramp, and Driveway Approach, Any Thickness, Rem
	• _Grading, Sidewalk
C6	• _Grading, Sidewalk Ramp
	• _Detectable Warning Surface, Modified
	• _Sidewalk Ramp, Conc, 6 inch, Modified
	• _Sidewalk, Conc, 6 inch, Modified
C8	• _Grading, Driveway Approach
- 00	• _Driveway, Nonreinf Conc, 8 inch, Modified
	• _Sidewalk, Sidewalk Ramp, and Driveway Approach, Any Thickness, Rem
	• _Grading, Driveway Approach
	• _Grading, Sidewalk
	Grading, Sidewalk Ramp
0.115	• Cement
C HE	Driveway, Nonreinf Conc, 6 inch, Modified
	Driveway, Nonreinf Conc, 8 inch, Modified
	Detectable Warning Surface, Modified
	Sidewalk Ramp, Conc, 6 inch, Modified
	• Sidewalk, Conc, 6 inch, Modified
	Curb, Gutter, and Curb and Gutter, Any Type, Rem
C/G	Curb and Gutter, Conc
	• _Curb, Gutter, and Curb and Gutter, Any Type, Rem
CICHE	
C/GHE	• Cement
	• _Driveway Opening, Conc, Det M, Modified
CP	• _Grading, Sidewalk
	• _Sidewalk, Conc, 4 inch, Modified
CR	• _Sidewalk, Sidewalk Ramp, and Driveway Approach, Any Thickness, Rem
	• Dr Structure, Rem
DS	Sewer, Rem, Less than 24 inch
	Dr Structure, 24 inch dia
	Dr Structure, Rem
DSDI	Sewer, Rem, Less than 24 inch
	• _Dr Structure, Double Inlet
PT	• _Dr Structure, Point
	Dr Structure Cover, Type B
DD 4	• _Dr Structure Cover, Type B, Special
RRA	• _Dr Structure, Adj, Case 1, Modified
	• _Dr Structure, Temp Lowering, Modified
	Dr Structure Cover, Type K
RRK	Dr Structure, Adj, Case 1, Modified
RS	Dr Structure, Reconstruct
1/0	<u> </u>
TYPE II	Plastic Drum, High Intensity, Lighted, Furn Plastic Drum, High Intensity, Lighted, Oper
	Plastic Drum, High Intensity, Lighted, Oper Parriseds, Type III, High Intensity, Double Sided, Lighted, Type
TYPE III	 Barricade, Type III, High Intensity, Double Sided, Lighted, Furn Barricade, Type III, High Intensity, Double Sided, Lighted, Oper
—	

NOTES:

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ENGINEERING

CITY OF ANN ARBOR PUBLIC SERVICES 301 EAST HURON STREET, P.O. BOX 8647 ANN ARBOR, MICHIGAN 48107-8647 734-794-6410 www.a2gov.org

		Know what's be	Call before	
		DAD	CHECKED	
		AH,GS,CE	DRAWN	
		03-13-2019	DATE	



T OF ANN ARBOR


RESURFACING/REST

PROJECT - 2019

PEARL STREET

SUBSET COVER SUFF

SHEET No.

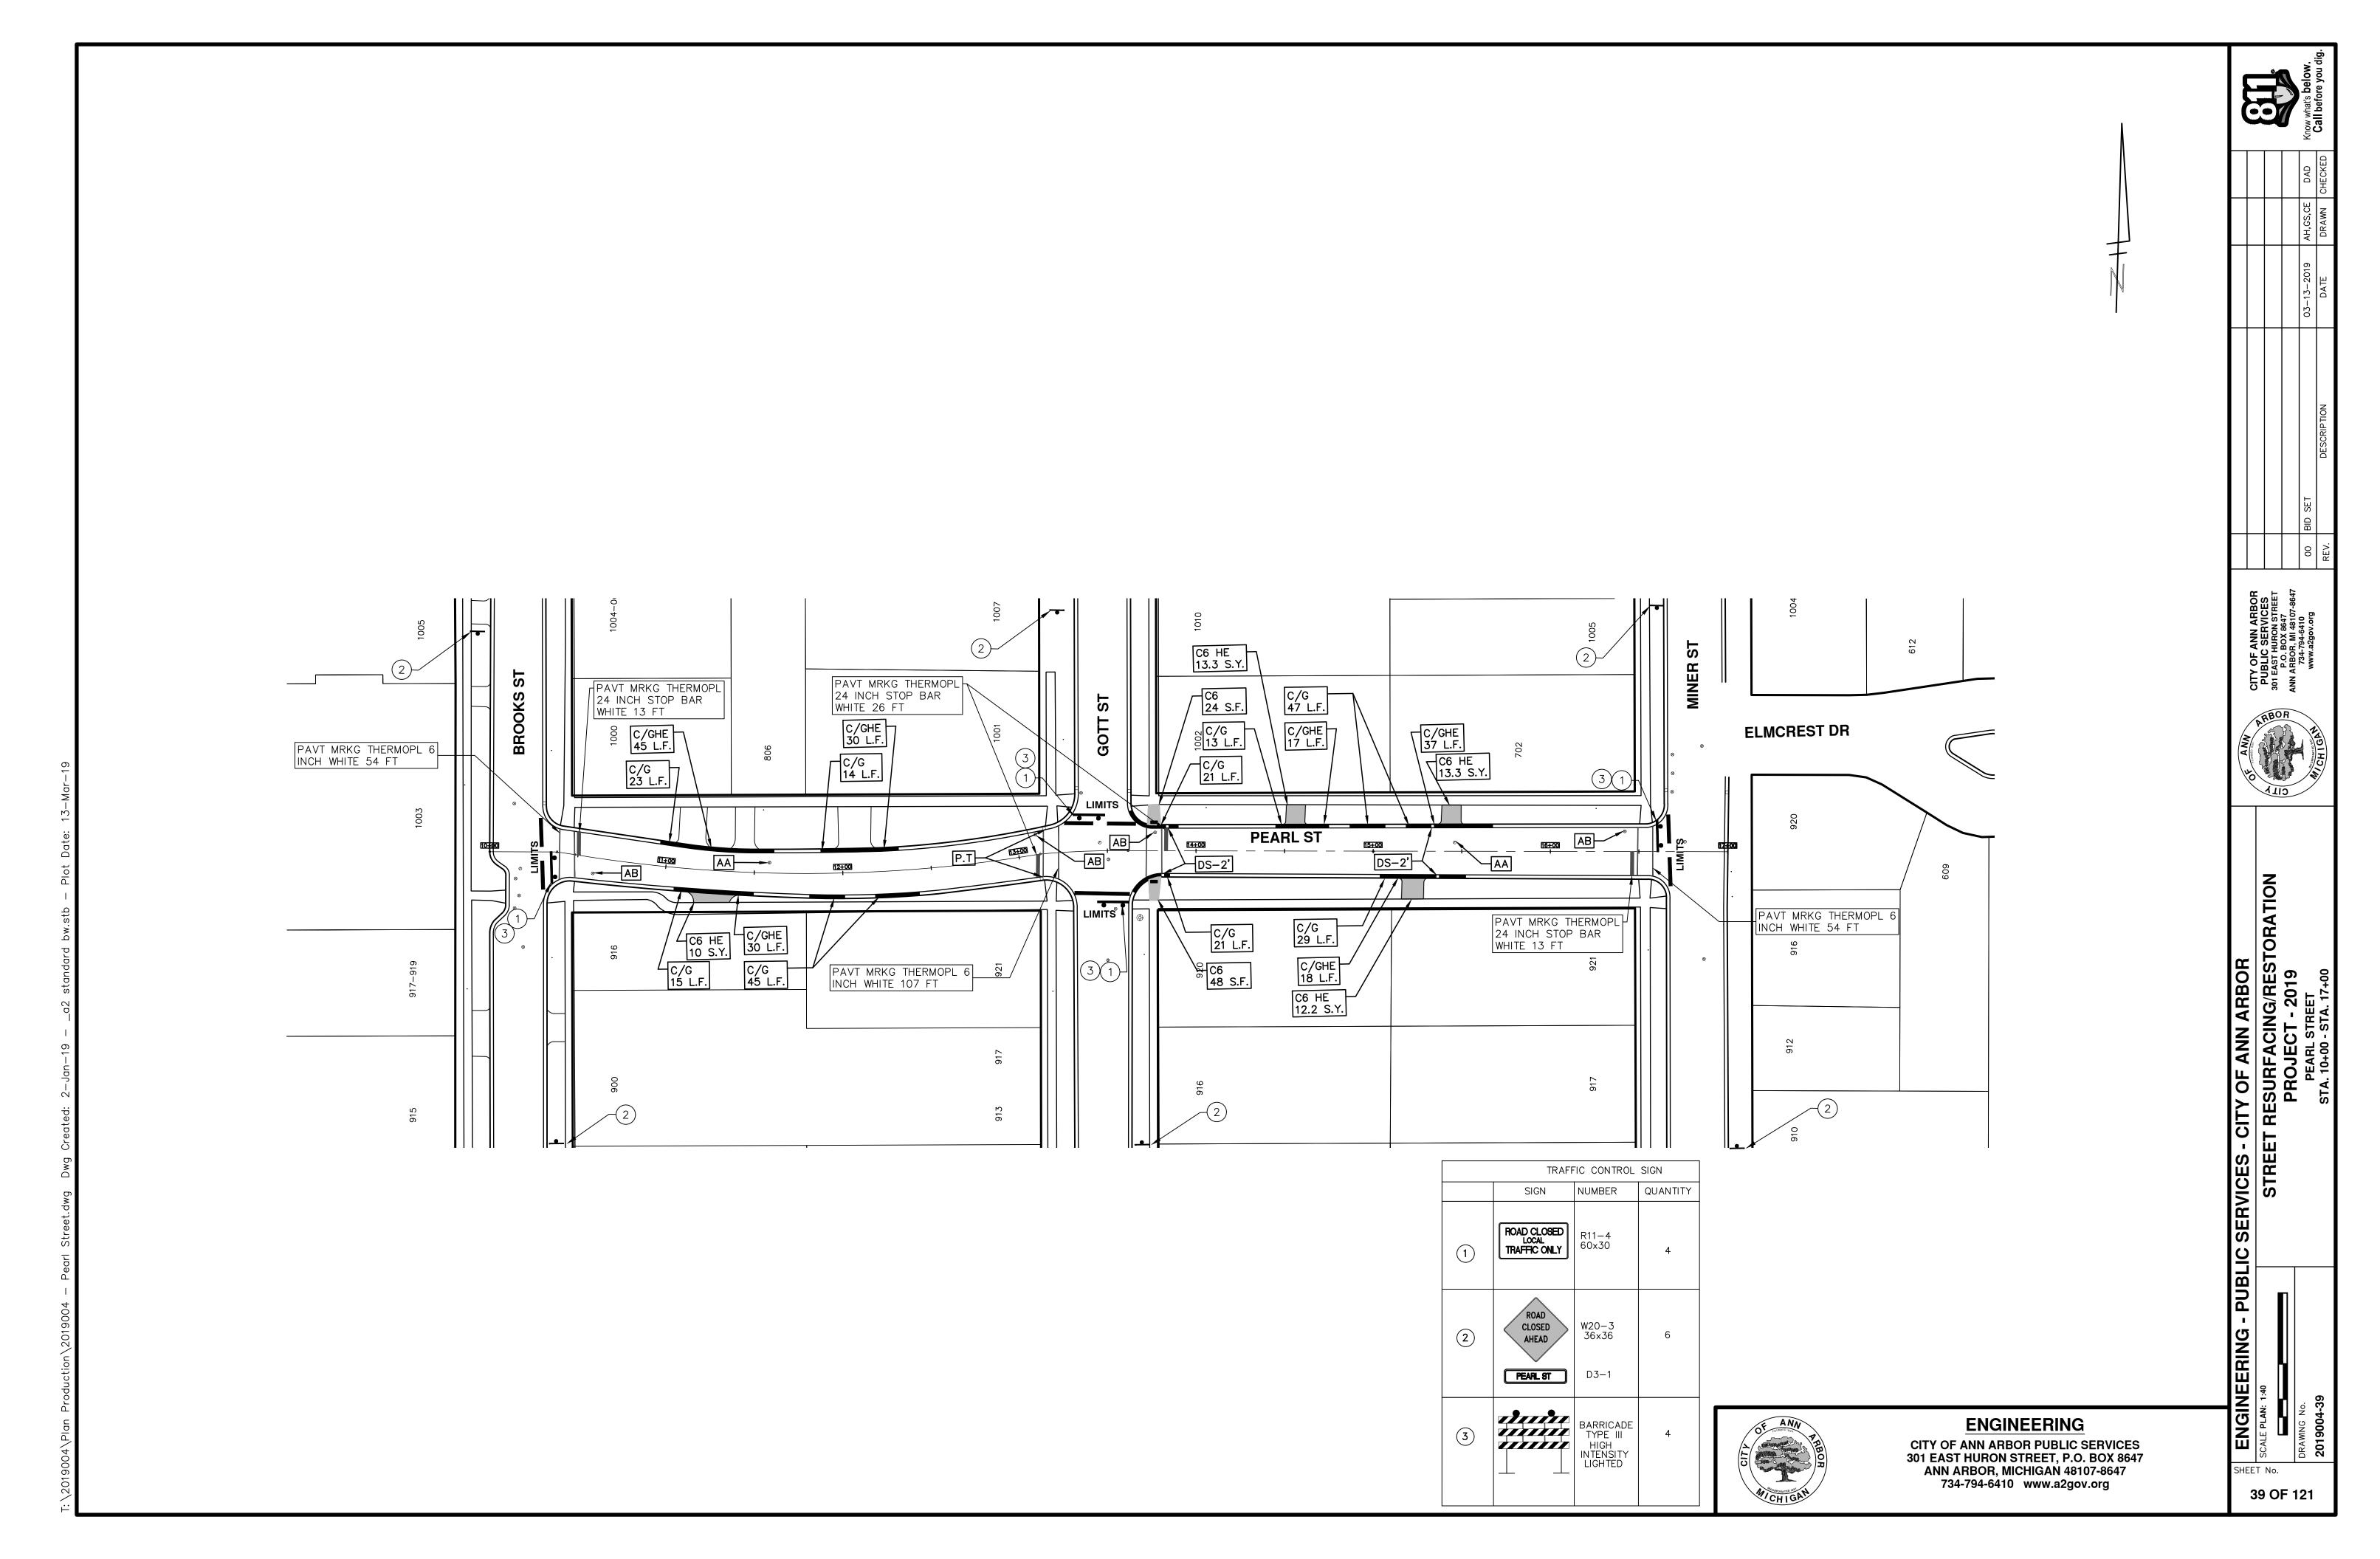



CITY OF ANN ARBOR ENGINEERING PROJECT LOCATION: SHERIDAN DRIVE

ITB No. 4570 FILE No. 2019004

	CONSTRUCTION KEY
KEY	ASSOCIATED PAY ITEM(S)
	• _Dr Structure, Adj, Case 1, Modified
AA	• _Dr Structure, Adj, Case 2, Modified
	• _Dr Structure, Temp Lowering, Modified
	• _Dr Structure, Temp Lowering, Modified
۸۵	• _Gate Box, Adj, Case 1
AB	Gate Box, Adj, Case 2
	Monument Box Adjust
ADST	Dr Structure, Adj, Add Depth, Modified
AK	• _Dr Structure, Adj, Case 1, Modified
7.11.	Sidewalk, Sidewalk Ramp, and Driveway Approach, Any Thickness, Rem
C4	• _Grading, Sidewalk
04	• _Sidewalk, Conc, 4 inch, Modified
	• _Sidewalk, Sidewalk Ramp, and Driveway Approach, Any Thickness, Rem
C4HE	• _Grading, Sidewalk
	• Cement
	• _Sidewalk, Conc, 4 inch, Modified
	• _Sidewalk, Sidewalk Ramp, and Driveway Approach, Any Thickness, Rem
	• _Grading, Sidewalk
C6	• _Grading, Sidewalk Ramp
00	• _Detectable Warning Surface, Modified
	• _Sidewalk Ramp, Conc, 6 inch, Modified
	• _Sidewalk, Conc, 6 inch, Modified
	• _Grading, Driveway Approach
C8	 _Driveway, Nonreinf Conc, 8 inch, Modified
	• _Sidewalk, Sidewalk Ramp, and Driveway Approach, Any Thickness, Rem
	• _Grading, Driveway Approach
	• _Grading, Sidewalk
	Grading, Sidewalk Ramp
	• Cement
C HE	Driveway, Nonreinf Conc, 6 inch, Modified
	Driveway, Nonreinf Conc, 8 inch, Modified
	• _Detectable Warning Surface, Modified
	• _Sidewalk Ramp, Conc, 6 inch, Modified
	• _Sidewalk, Conc, 6 inch, Modified
C/G	• _Curb, Gutter, and Curb and Gutter, Any Type, Rem
	• _Curb and Gutter, Conc
	• _Curb, Gutter, and Curb and Gutter, Any Type, Rem
C/GHE	• Cement
	 _Driveway Opening, Conc, Det M, Modified
СР	• _Grading, Sidewalk
Ol-	• _Sidewalk, Conc, 4 inch, Modified
CR	• _Sidewalk, Sidewalk Ramp, and Driveway Approach, Any Thickness, Rem
	• Dr Structure, Rem
DS	Sewer, Rem, Less than 24 inch
	Dr Structure, 24 inch dia
	• Dr Structure, Rem
DSDI	• Sewer, Rem, Less than 24 inch
	Dr Structure, Double Inlet
PT	• _Dr Structure, Point
1 1	Dr Structure Cover, Type B
RRA	• _Dr Structure Cover, Type B, Special
	• _Dr Structure, Adj, Case 1, Modified
	• _Dr Structure, Temp Lowering, Modified
RRK	Dr Structure Cover, Type K
	• _Dr Structure, Adj, Case 1, Modified
RS	• _Dr Structure, Reconstruct
יי פר יי	Plastic Drum, High Intensity, Lighted, Furn
TYPE II	Plastic Drum, High Intensity, Lighted, Oper
YPE III	Barricade, Type III, High Intensity, Double Sided, Lighted, Furn



Y OF ANN ARBOR
ESURFACING/REST
PROJECT - 2019
SHERIDAN DRIVE

SHEET No.

40 OF 121

ENGINEERING CITY OF ANN ARBOR PUBLIC SERVICES 301 EAST HURON STREET, P.O. BOX 8647 ANN ARBOR, MICHIGAN 48107-8647 734-794-6410 www.a2gov.org


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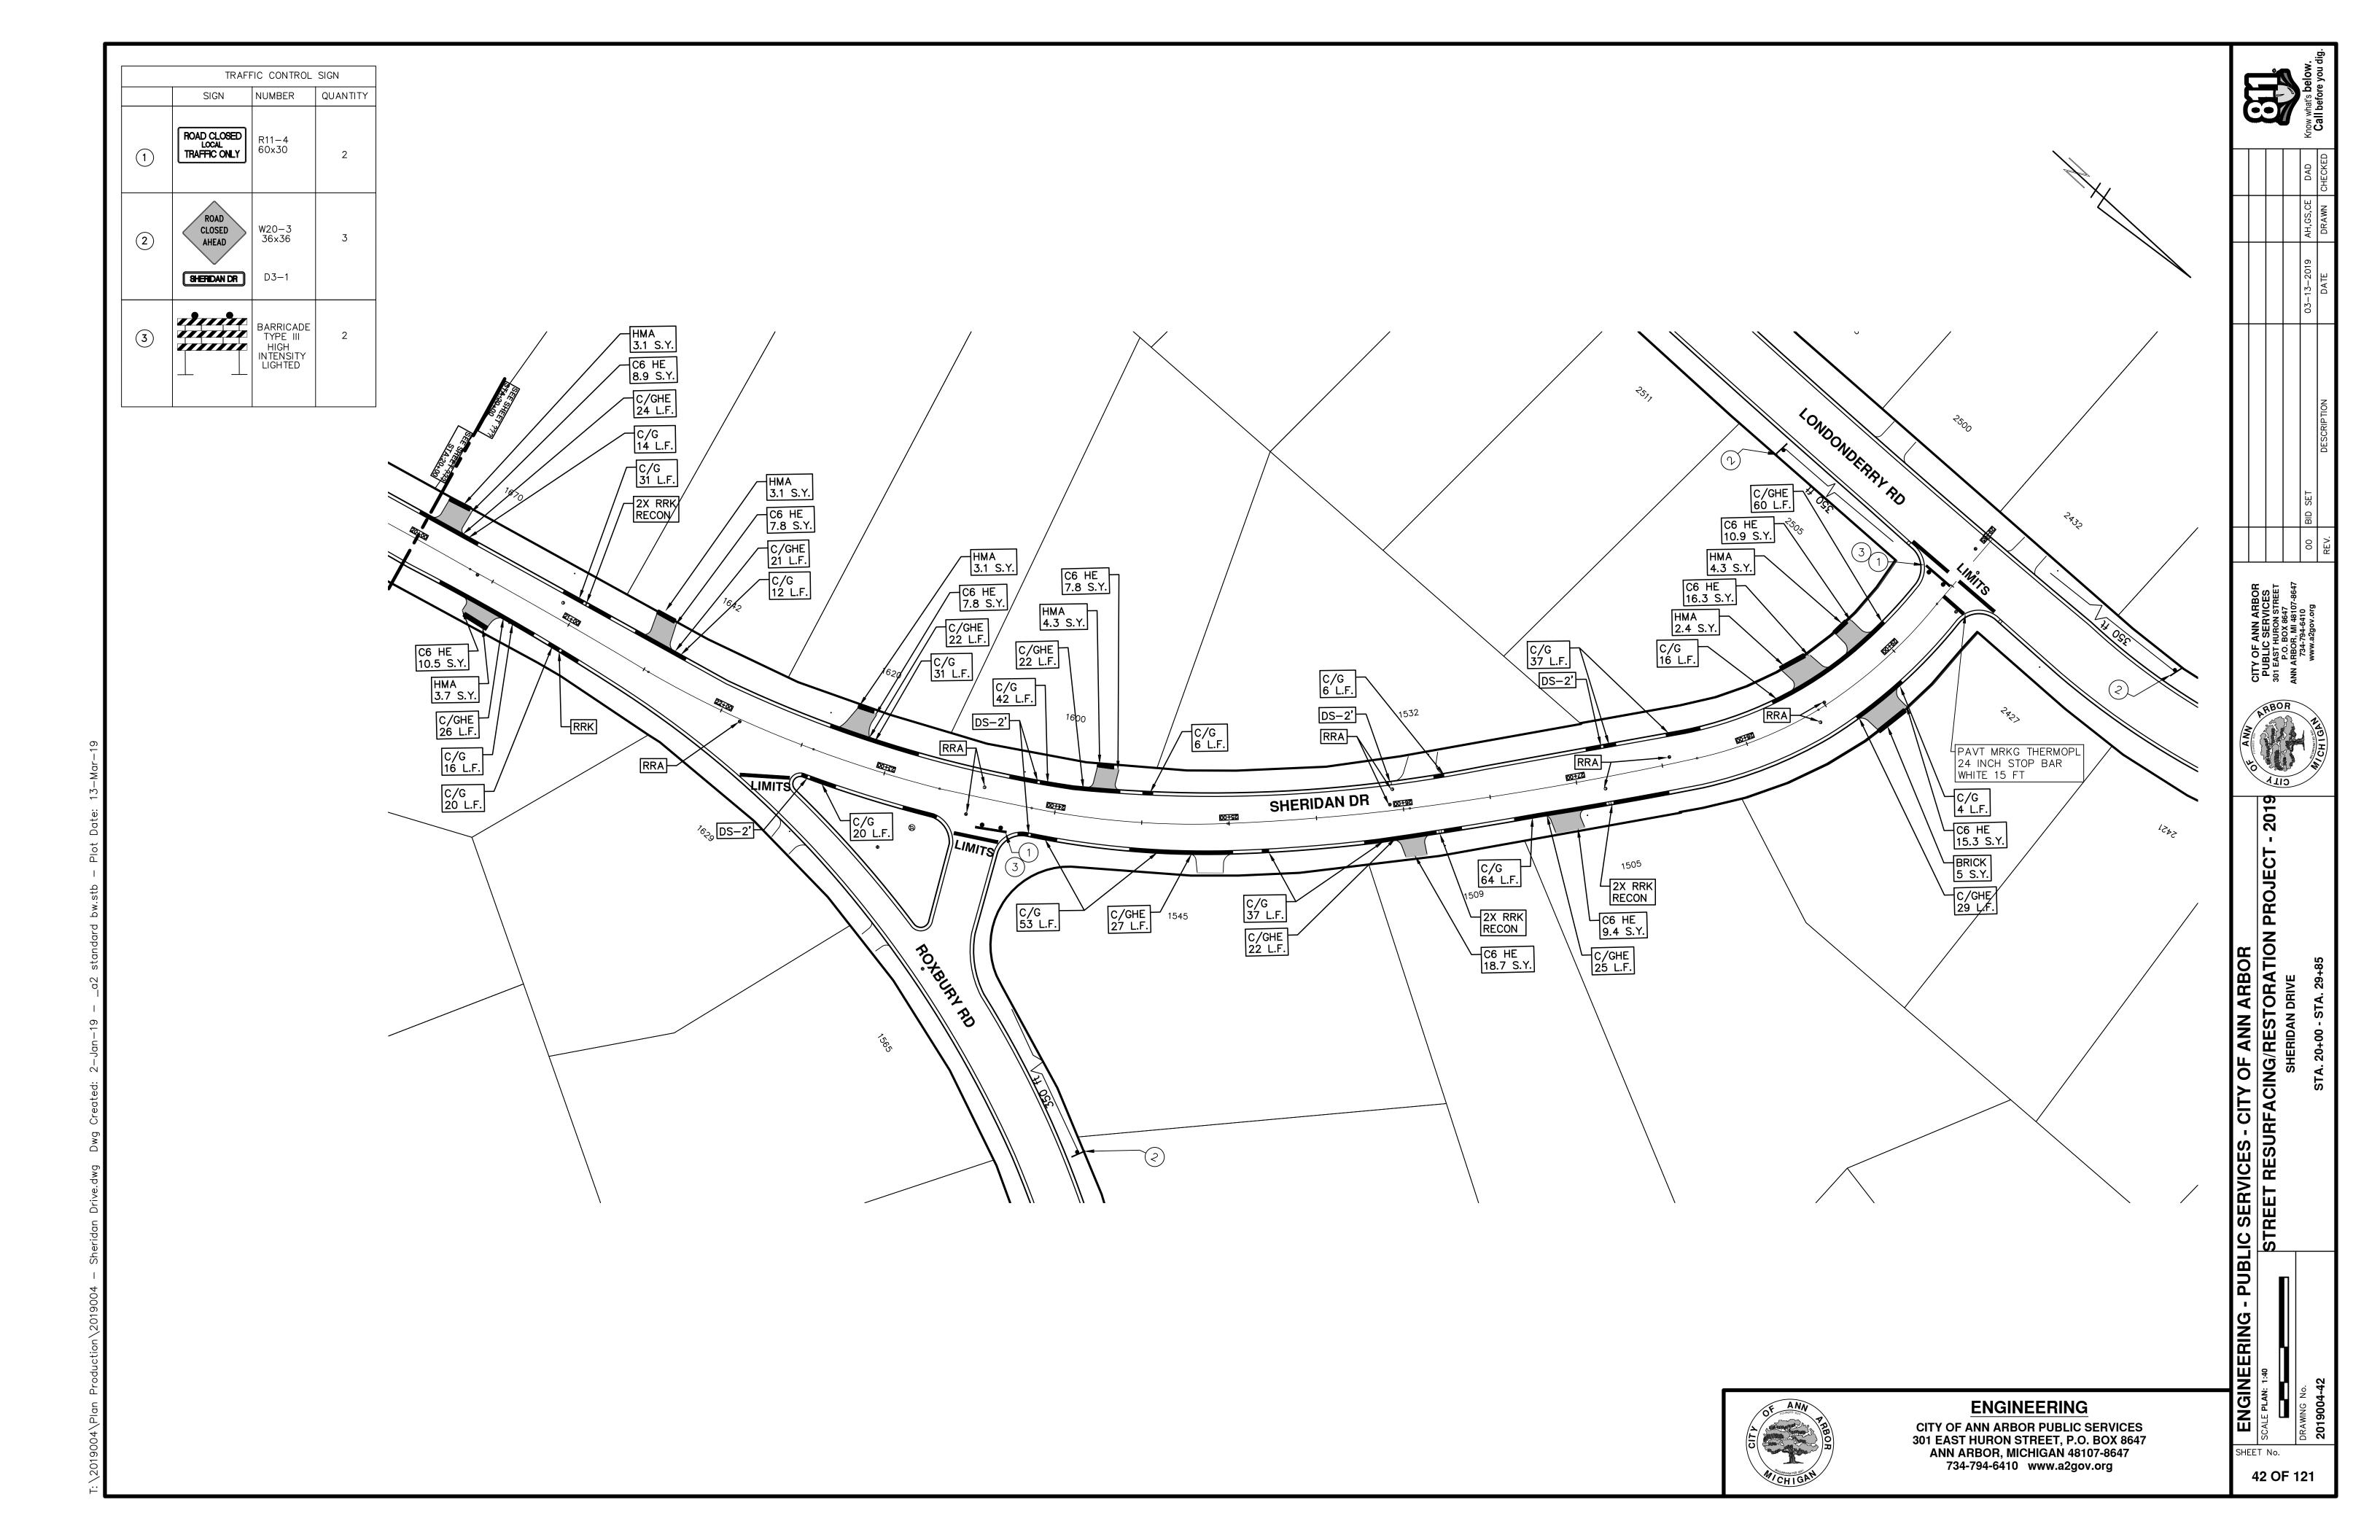
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CITY OF ANN ARBOR ENGINEERING PROJECT LOCATION: W SUMMIT STREET

ITB No. 4570 FILE No. 2019004

	CONSTRUCTION KEY
KEY	ASSOCIATED PAY ITEM(S)
	• _Dr Structure, Adj, Case 1, Modified
AA	• _Dr Structure, Adj, Case 2, Modified
	• _Dr Structure, Temp Lowering, Modified
	• _Dr Structure, Temp Lowering, Modified
AB	• _Gate Box, Adj, Case 1
AD	• _Gate Box, Adj, Case 2
	Monument Box Adjust
ADST	• _Dr Structure, Adj, Add Depth, Modified
AK	• _Dr Structure, Adj, Case 1, Modified
	• _Sidewalk, Sidewalk Ramp, and Driveway Approach, Any Thickness, Rem
C4	Grading, Sidewalk
	Sidewalk, Conc, 4 inch, Modified Sidewalk, Conc, 4 inch, Modified
	• _Sidewalk, Sidewalk Ramp, and Driveway Approach, Any Thickness, Rem
No. 200 100 10	Grading, Sidewalk
C4HE	• Cement
	• _Sidewalk, Conc, 4 inch, Modified
	• _Sidewalk, Sidewalk Ramp, and Driveway Approach, Any Thickness, Rem
	• Grading, Sidewalk
	Grading, Sidewalk Ramp
C6	
	Detectable Warning Surface, Modified Sidewalk Roma, Cons. 6 inch. Modified
	• _Sidewalk Ramp, Conc, 6 inch, Modified
	• _Sidewalk, Conc, 6 inch, Modified
C8	• _Grading, Driveway Approach
	• _Driveway, Nonreinf Conc, 8 inch, Modified
	• _Sidewalk, Sidewalk Ramp, and Driveway Approach, Any Thickness, Rem
	Grading, Driveway Approach
	• _Grading, Sidewalk
	Grading, Sidewalk Ramp
C HE	Cement
OTIL	• _Driveway, Nonreinf Conc, 6 inch, Modified
	• _Driveway, Nonreinf Conc, 8 inch, Modified
	• _Detectable Warning Surface, Modified
	• _Sidewalk Ramp, Conc, 6 inch, Modified
	• _Sidewalk, Conc, 6 inch, Modified
CIC	• _Curb, Gutter, and Curb and Gutter, Any Type, Rem
C/G	Curb and Gutter, Conc
	• _Curb, Gutter, and Curb and Gutter, Any Type, Rem
C/GHE	• Cement
	• _Driveway Opening, Conc, Det M, Modified
	Grading, Sidewalk
CP	• Sidewalk, Conc, 4 inch, Modified
CR	• _Sidewalk, Sidewalk Ramp, and Driveway Approach, Any Thickness, Rem
OI (• Dr Structure, Rem
DS	• Sewer, Rem, Less than 24 inch
ВО	• Dr Structure, 24 inch dia
	Dr Structure, 24 inch dia Dr Structure, Rem
DSDI	
וטטטו	• Sewer, Rem, Less than 24 inch
DT	• _Dr Structure, Double Inlet
PT	• _Dr Structure, Point
	• Dr Structure Cover, Type B
RRA	• _Dr Structure Cover, Type B, Special
	• _Dr Structure, Adj, Case 1, Modified
	• _Dr Structure, Temp Lowering, Modified
RRK	Dr Structure Cover, Type K
T XI XI X	• _Dr Structure, Adj, Case 1, Modified
RS	• _Dr Structure, Reconstruct
TVDE "	Plastic Drum, High Intensity, Lighted, Furn
TYPE II	Plastic Drum, High Intensity, Lighted, Oper
	Barricade Type III High Intensity Double Sided Lighted Furn
TYPE III	



AESURFACING/REST
PROJECT - 2019
W SUMMIT STREET
SUBSET COVER

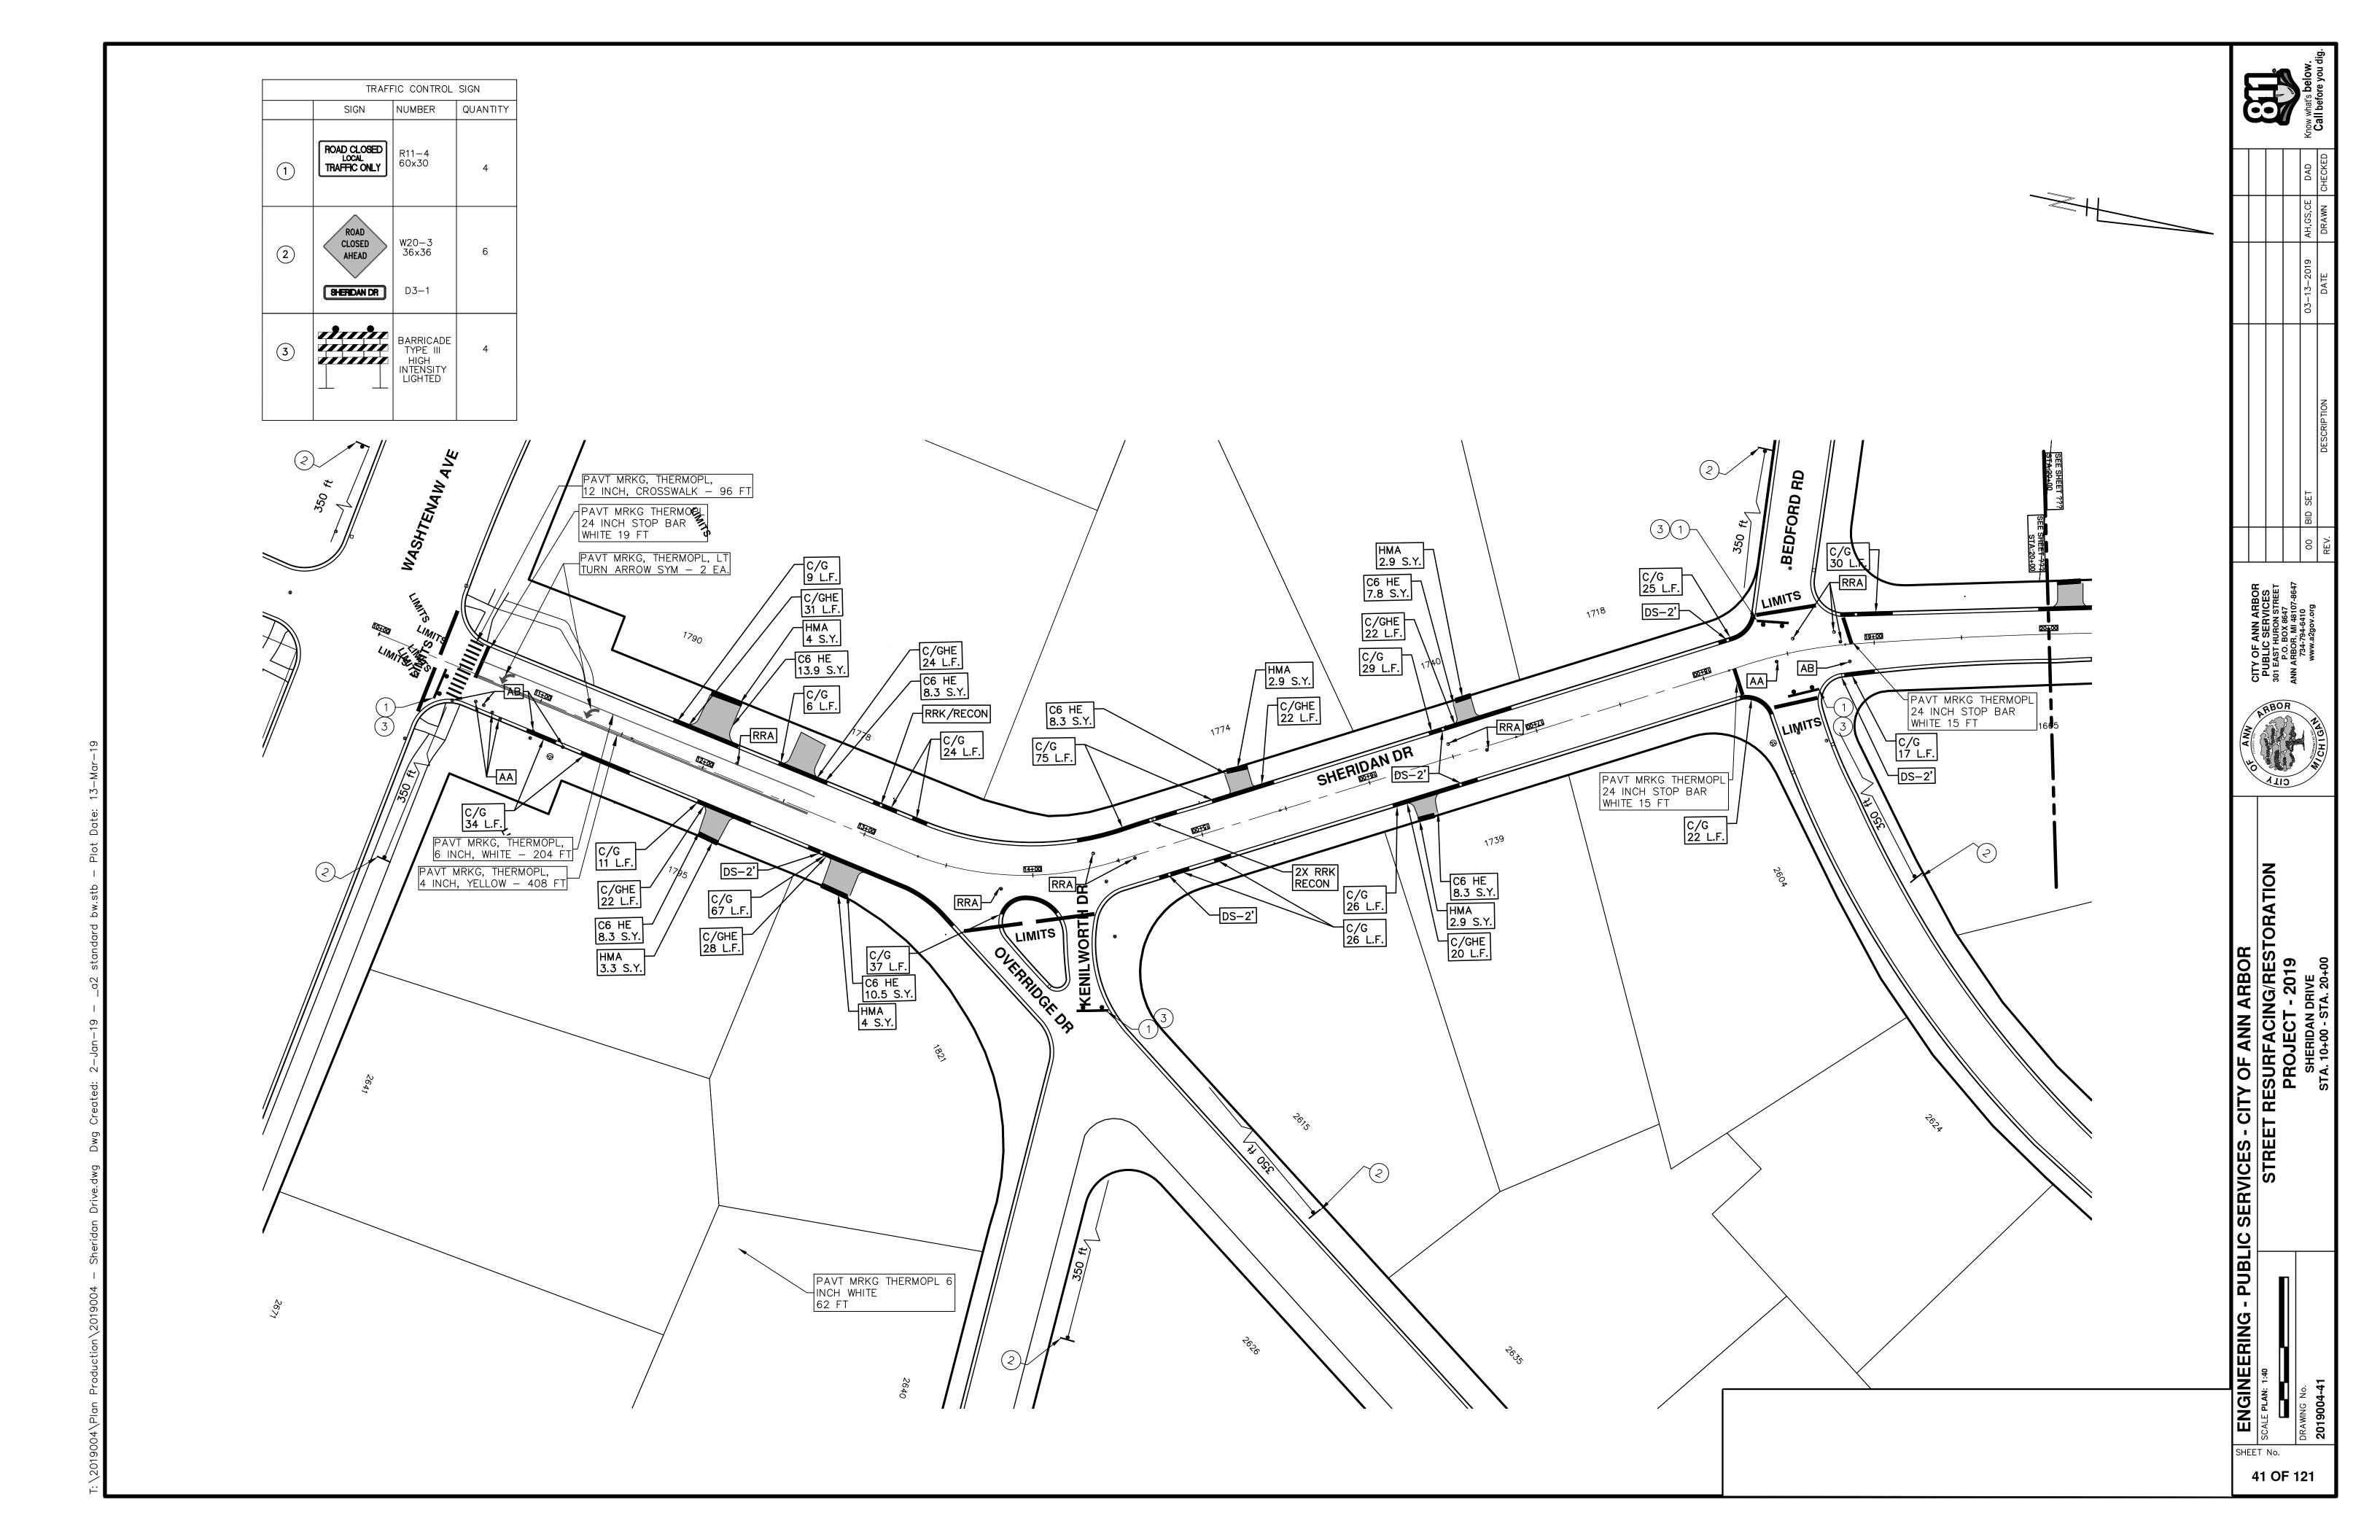FOR PROTECTION OF UNDERGROUND UTILITIES AND IN CONFORMANCE WITH PUBLIC ACT 174 OF 2013, THE CONTRACTOR SHALL CALL 811 OR 1-800-482-7171 A MINIMUM OF THREE FULL WORKING DAYS, EXCLUDING SATURDAYS, SUNDAYS, AND HOLIDAYS, PRIOR TO BEGINNING EACH EXCAVATION IN AREAS WHERE PUBLIC UTILITIES HAVE NOT BEEN PREVIOUSLY LOCATED. MEMBERS WILL THUS BE ROUTINELY NOTIFIED. THIS DOES NOT RELIEVE THE CONTRACTOR OF THE RESPONSIBILITY OF NOTIFYING UTILITY OWNERS POWER, CABLE TV AND FIBER OPTIC LINES ARE APPROXIMATE. THE CITY OF ANN DRAWING. MISS DIG MUST BE CONTACTED PRIOR TO CONSTRUCTION TO LOCATE THESE THE IMPROVEMENTS COVERED BY THESE PLANS SHALL BE PERFORMED IN ACCORDANCE WITH MICHIGAN DEPARTMENT OF TRANSPORTATION (MDOT) 2012 STANDARD SPECIFICATIONS FOR CONSTRUCTION, INCLUDING REFERENCED MDOT PUBLICATIONS, AND

SHEET No.

43 OF 121

ENGINEERING



THE PROJECT CONTRACT DOCUMENTS.

WHO MAY NOT BE A PART OF THE "MISS DIG" ALERT SYSTEM.


THE UNDERGROUND LOCATIONS SHOWN FOR NATURAL GAS, TELEPHONE, ELECTRICAL


ARBOR ASSUMES NO RESPONSIBILITY FOR THEIR ACCURATE REPRESENTATION IN THIS

NOTES:

UTILITIES.

CITY OF ANN ARBOR PUBLIC SERVICES 301 EAST HURON STREET, P.O. BOX 8647 ANN ARBOR, MICHIGAN 48107-8647 734-794-6410 www.a2gov.org

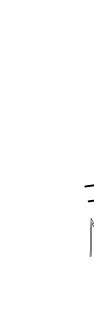

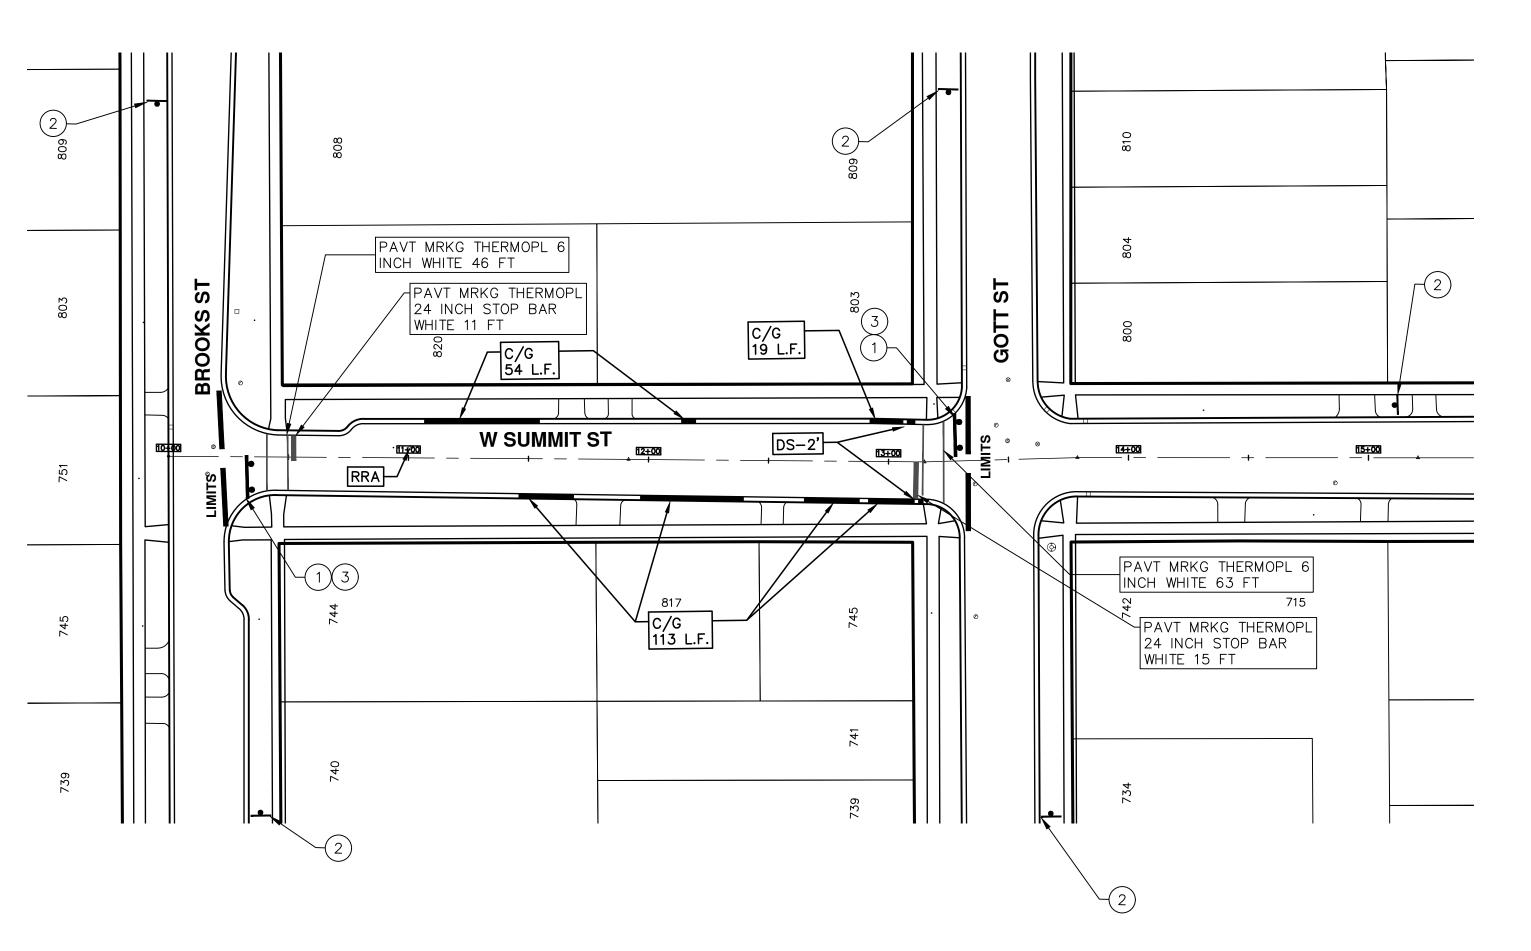

	TRAFFIC CONTROL SIGN						
	SIGN	NUMBER	QUANTITY				
1	ROAD CLOSED LOCAL TRAFFIC ONLY	R11-4 60x30	2				
2	ROAD CLOSED AHEAD W SUMMIT ST	W20-3 36×36 D3-1	5				
3		BARRICADE TYPE III HIGH INTENSITY LIGHTED	2				



CITY OF ANN ARBOR PUBLIC SERVICES 301 EAST HURON STREET, P.O. BOX 8647 ANN ARBOR, MICHIGAN 48107-8647 734-794-6410 www.a2gov.org ENGINEERING - PUBLIC SERVICES - CITY OF ANN ARBOR

SCALE PLAN: 1:40

DRAWING No.

PROJECT - 2019

W SUMMIT STREET


W SUMMIT STREET

STA. 10+00 - STA. 14+00

Z

44 OF 121

Plan Production\2019004 - W Summit Street.dwg Dwg Created: 2-Jan-19

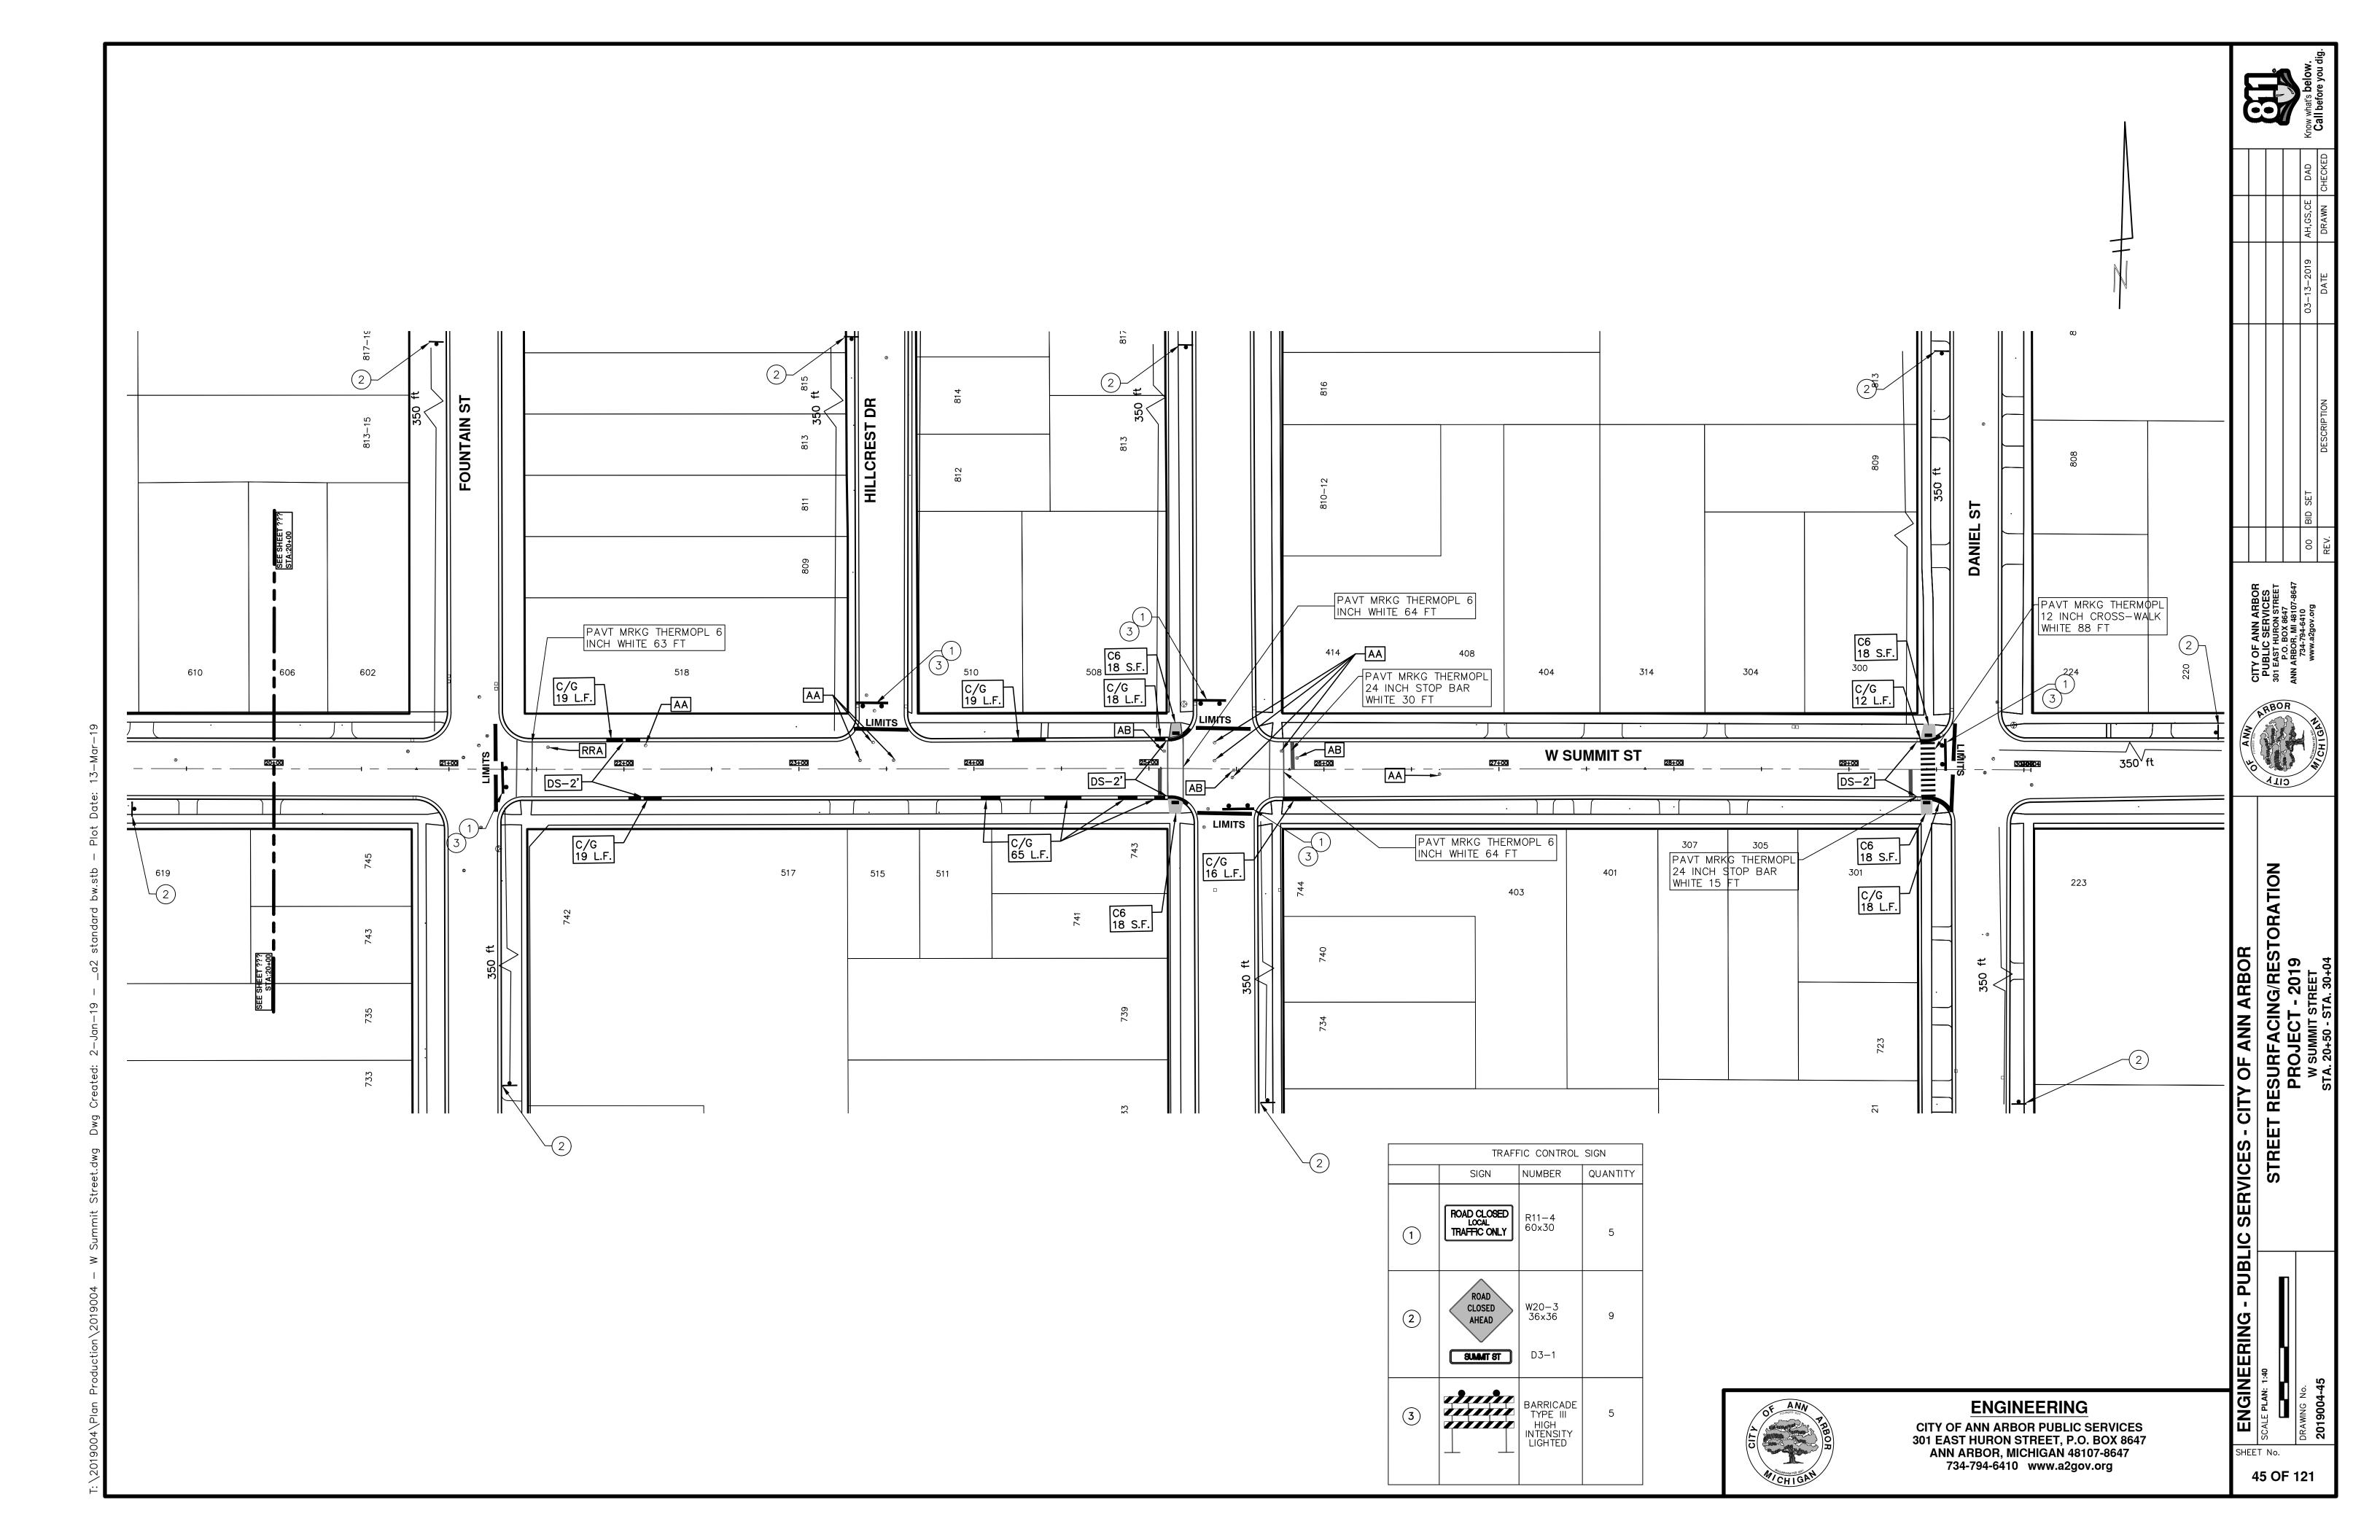



CITY OF ANN ARBOR ENGINEERING PROJECT LOCATION: GEDDES AVENUE

ITB No. 4570FILE No. 2019004

KEY	ASSOCIATED PAY ITEM(S)
	• _Dr Structure, Adj, Case 1, Modified
AA	• _Dr Structure, Adj, Case 2, Modified
	Dr Structure, Temp Lowering, Modified
	Dr Structure, Temp Lowering, Modified
	• _Gate Box, Adj, Case 1
AB	• _Gate Box, Adj, Case 2
	Monument Box Adjust
ADST	- '
	• _Dr Structure, Adj, Add Depth, Modified
AK	• _Dr Structure, Adj, Case 1, Modified
0.4	• _Sidewalk, Sidewalk Ramp, and Driveway Approach, Any Thickness, Rem
C4	• _Grading, Sidewalk
	• _Sidewalk, Conc, 4 inch, Modified
	• _Sidewalk, Sidewalk Ramp, and Driveway Approach, Any Thickness, Rem
C4HE	• _Grading, Sidewalk
OTIL	Cement
	• _Sidewalk, Conc, 4 inch, Modified
	• _Sidewalk, Sidewalk Ramp, and Driveway Approach, Any Thickness, Rem
	• _Grading, Sidewalk
00	Grading, Sidewalk Ramp
C6	Detectable Warning Surface, Modified
	Sidewalk Ramp, Conc, 6 inch, Modified
	Sidewalk, Conc, 6 inch, Modified
	Grading, Driveway Approach
C8	Driveway, Nonreinf Conc, 8 inch, Modified
	• _Sidewalk, Sidewalk Ramp, and Driveway Approach, Any Thickness, Rem
	• _Grading, Driveway Approach
	• _Grading, Sidewalk
	• _Grading, Sidewalk Ramp
C HE	Cement
0112	• _Driveway, Nonreinf Conc, 6 inch, Modified
	• _Driveway, Nonreinf Conc, 8 inch, Modified
	• _Detectable Warning Surface, Modified
	• _Sidewalk Ramp, Conc, 6 inch, Modified
	• _Sidewalk, Conc, 6 inch, Modified
0/0	Curb, Gutter, and Curb and Gutter, Any Type, Rem
C/G	Curb and Gutter, Conc
	• _Curb, Gutter, and Curb and Gutter, Any Type, Rem
C/GHE	• Cement
O/ O/ IL	Driveway Opening, Conc, Det M, Modified
	• _Grading, Sidewalk
CP	
CD	• _Sidewalk, Conc, 4 inch, Modified
CR	• _Sidewalk, Sidewalk Ramp, and Driveway Approach, Any Thickness, Rem
D.C	• Dr Structure, Rem
DS	• Sewer, Rem, Less than 24 inch
	Dr Structure, 24 inch dia
	Dr Structure, Rem
DSDI	Sewer, Rem, Less than 24 inch
	• _Dr Structure, Double Inlet
PT	• _Dr Structure, Point
	Dr Structure Cover, Type B
.	• _Dr Structure Cover, Type B, Special
RRA	• Dr Structure, Adj, Case 1, Modified
	• Dr Structure, Temp Lowering, Modified
RRK	Dr Structure Cover, Type K Dr Structure Adi Coco 1 Medifod
5.0	• _Dr Structure, Adj, Case 1, Modified
RS	• _Dr Structure, Reconstruct
TYPE II	Plastic Drum, High Intensity, Lighted, Furn
	Plastic Drum, High Intensity, Lighted, Oper
TYPE III	Barricade, Type III, High Intensity, Double Sided, Lighted, Furn

IOTES:

FOR PROTECTION OF UNDERGROUND UTILITIES AND IN CONFORMANCE WITH PUBLIC ACT 174 OF 2013, THE CONTRACTOR SHALL CALL 811 OR 1-800-482-7171 A MINIMUM OF THREE FULL WORKING DAYS, EXCLUDING SATURDAYS, SUNDAYS, AND HOLIDAYS, PRIOR TO BEGINNING EACH EXCAVATION IN AREAS WHERE PUBLIC UTILITIES HAVE NOT BEEN PREVIOUSLY LOCATED. MEMBERS WILL THUS BE ROUTINELY NOTIFIED. THIS DOES NOT RELIEVE THE CONTRACTOR OF THE RESPONSIBILITY OF NOTIFYING UTILITY OWNERS WHO MAY NOT BE A PART OF THE "MISS DIG" ALERT SYSTEM.

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ENGINEERING

CITY OF ANN ARBOR PUBLIC SERVICES 301 EAST HURON STREET, P.O. BOX 8647 ANN ARBOR, MICHIGAN 48107-8647 734-794-6410 www.a2gov.org

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		DAD	DRAWN CHECKED	
		AH,GS,CE	DRAWN	
		03-13-2019	DATE	
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IY OF ANN ARBOR UBLIC SERVICES EAST HURON STREET P.O. BOX 8647 VARBOR, MI 48107-8647 734-794-6410 www.a2gov.org



ARBOR G/RESTORATION - 2019

EET RESURFACING/RESTC PROJECT - 2019
GEDDES AVENUE
SUBSET COVER SHEET

ENGINEERING - I
SCALE PLAN: ###

DRAWING No.

SHEET No.

2019004\Plan Productior

DETOUR CONSTRUCTION NOTES:


- 1. DEPENDING ON THE DETOUR ROUTES THAT ARE PUT IN PLACE, CONFLICTING SIGNS MAY BE PRESENT. PRIOR TO THE ORDERING OR PLACEMENT OF ANY SIGNS, MEET WITH THE ENGINEER TO VERIFY THE EXACT NUMBER AND LOCATION OF THE SIGNS TO BE PLACED. THE ENGINEER AND THE CONTRACTOR SHALL WORK TOGETHER TO ELIMINATE ALL CONFLICTS.
- 2. THE CITY RESERVES THE RIGHT TO ORDER ADDITIONAL SIGNS AND PLACE THEM INTO SERVICE IN ORDER TO SAFELY MAINTAIN TRAFFIC. ADJUSTMENTS IN THE UNIT PRICE FOR THESE ITEMS OF WORK SHALL NOT BE ALLOWED FOR THESE OCCURRENCES.
- 3. THE CONTRACTOR SHALL COORDINATE HIS OPERATIONS WITH THOSE OF THE CITY OF ANN ARBOR'S SIGNS AND SIGNALS UNIT DURING THE COURSE OF THE DETOUR ROUTE ESTABLISHMENT TO EFFECTIVELY AND SAFELY MAINTAIN TRAFFIC. DO NOT ERECT ANY SIGNS UNTIL ITS LOCATION AND PROPOSED DATE OF INSTALLATION IS APPROVED BY THE ENGINEER.
- 4. THIS DETOUR IS TO BE IN PLACE DURING GEDDES AVE. CONSTRUCTION AS DIRECTED BY THE ENGINEER, THE CONTRACTOR WILL CLOSE AND DETOUR EAST AND WEST BOUND GEDDES AVE. TRAFFIC. SEE "SPECIAL PROVISION FOR MAINTAINING TRAFFIC AND CONSTRUCTION SEQUENCING" FOR DETAILS ON CONSTRUCTION STAGING, SEQUENCING, CLOSURE AND DETOUR LIMITATIONS, AND OTHER DETAILS.
- 5. REFERENCE THE "DETAILED SPECIFICATION FOR MAINTAINING TRAFFIC AND CONSTRUCTION SEQUENCING" FOR ADDITIONAL PROJECT REQUIREMENTS. THE CONTRACTOR'S ATTENTION IS SPECIFICALLY DIRECTED TO THE SECTION OF SAME SPECIAL PROVISION REGARDING COORDINATION WITH THE CITY SIGNS AND SIGNALS UNIT FOR THE SEVERAL DETOUR ROUTE MODIFICATIONS AND THE MODIFICATIONS TO TRAFFIC SIGNALS FOR THE DETOUR.
- 6. THE CONTRACTOR SHALL FURNISH, ERECT, AND MAINTAIN SIGNS AS SHOWN ON THE PLANS OR OTHERWISE DIRECTED BY THE ENGINEER.
- 7. CONSTRUCTION WARNING SIGNS SHALL HAVE AN ORANGE, HIGH-INTENSITY, REFLECTORIZED BACKGROUND.
- 8. SIGNS SHALL CONFORM TO THE 2011 MICHIGAN MANUAL OF UNIFORM TRAFFIC CONTROL DEVICES.
- 9. THE CONTRACTOR SHALL DRIVE ALL SIGNS INTO EXPOSED GROUND OR INSERT INTO A BORED HOLE IN PAVEMENT AS NECESSARY TO PERMANENTLY SECURE. ALL HOLES IN PAVEMENT SHALL BE FILLED WITH ENGINEER-APPROVED MORTAR WHEN THE SIGN IS REMOVED AND NO LONGER NEEDED. COSTS FOR THIS WORK SHALL BE INCLUDED IN THE PAY ITEM "SIGN, TYPE B, TEMP, PRISMATIC, FURN" OR "SIGN, TYPE B, TEMP, PRISMATIC, FURN, SPECIAL".


TRAFFIC CONTROL SIGN						
	SIGN	NUMBER	QUANTITY			
22)	LEFT LANE CLOSED AHEAD	W20-5L 36"x36"	1			
23		W4-2L 36"x36"	0			
24)	WORK ZONE BEGINS	R5–18C 48"x48"	6			
25)	EAST BOUND GEDDES AVE CLOSED AT WASHTENAW AVE FOLLOW DETOUR	SPECIAL 48x66	3			
26)	WEST BOUND QEDDES AVE CLOSED AT OBSERVATORY ST FOLLOW DETOUR	SPECIAL 48x66	3			
27)	DO NOT ENTER	R5–1 36x36	3			
SIGN, PORTABLE, CHANGEABLE MESSAGE		QUAN LOCA ENGINI	TY EXACT ITITY AND TION WITH EER PRIOR DRDERING			

<u>LEGEND:</u>

EAST BOUND GEDDES AVE DETOUR ROUTE

WEST BOUND GEDDES AVE DETOUR ROUTE **GEDDES AVE** WORK ZONE

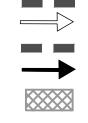

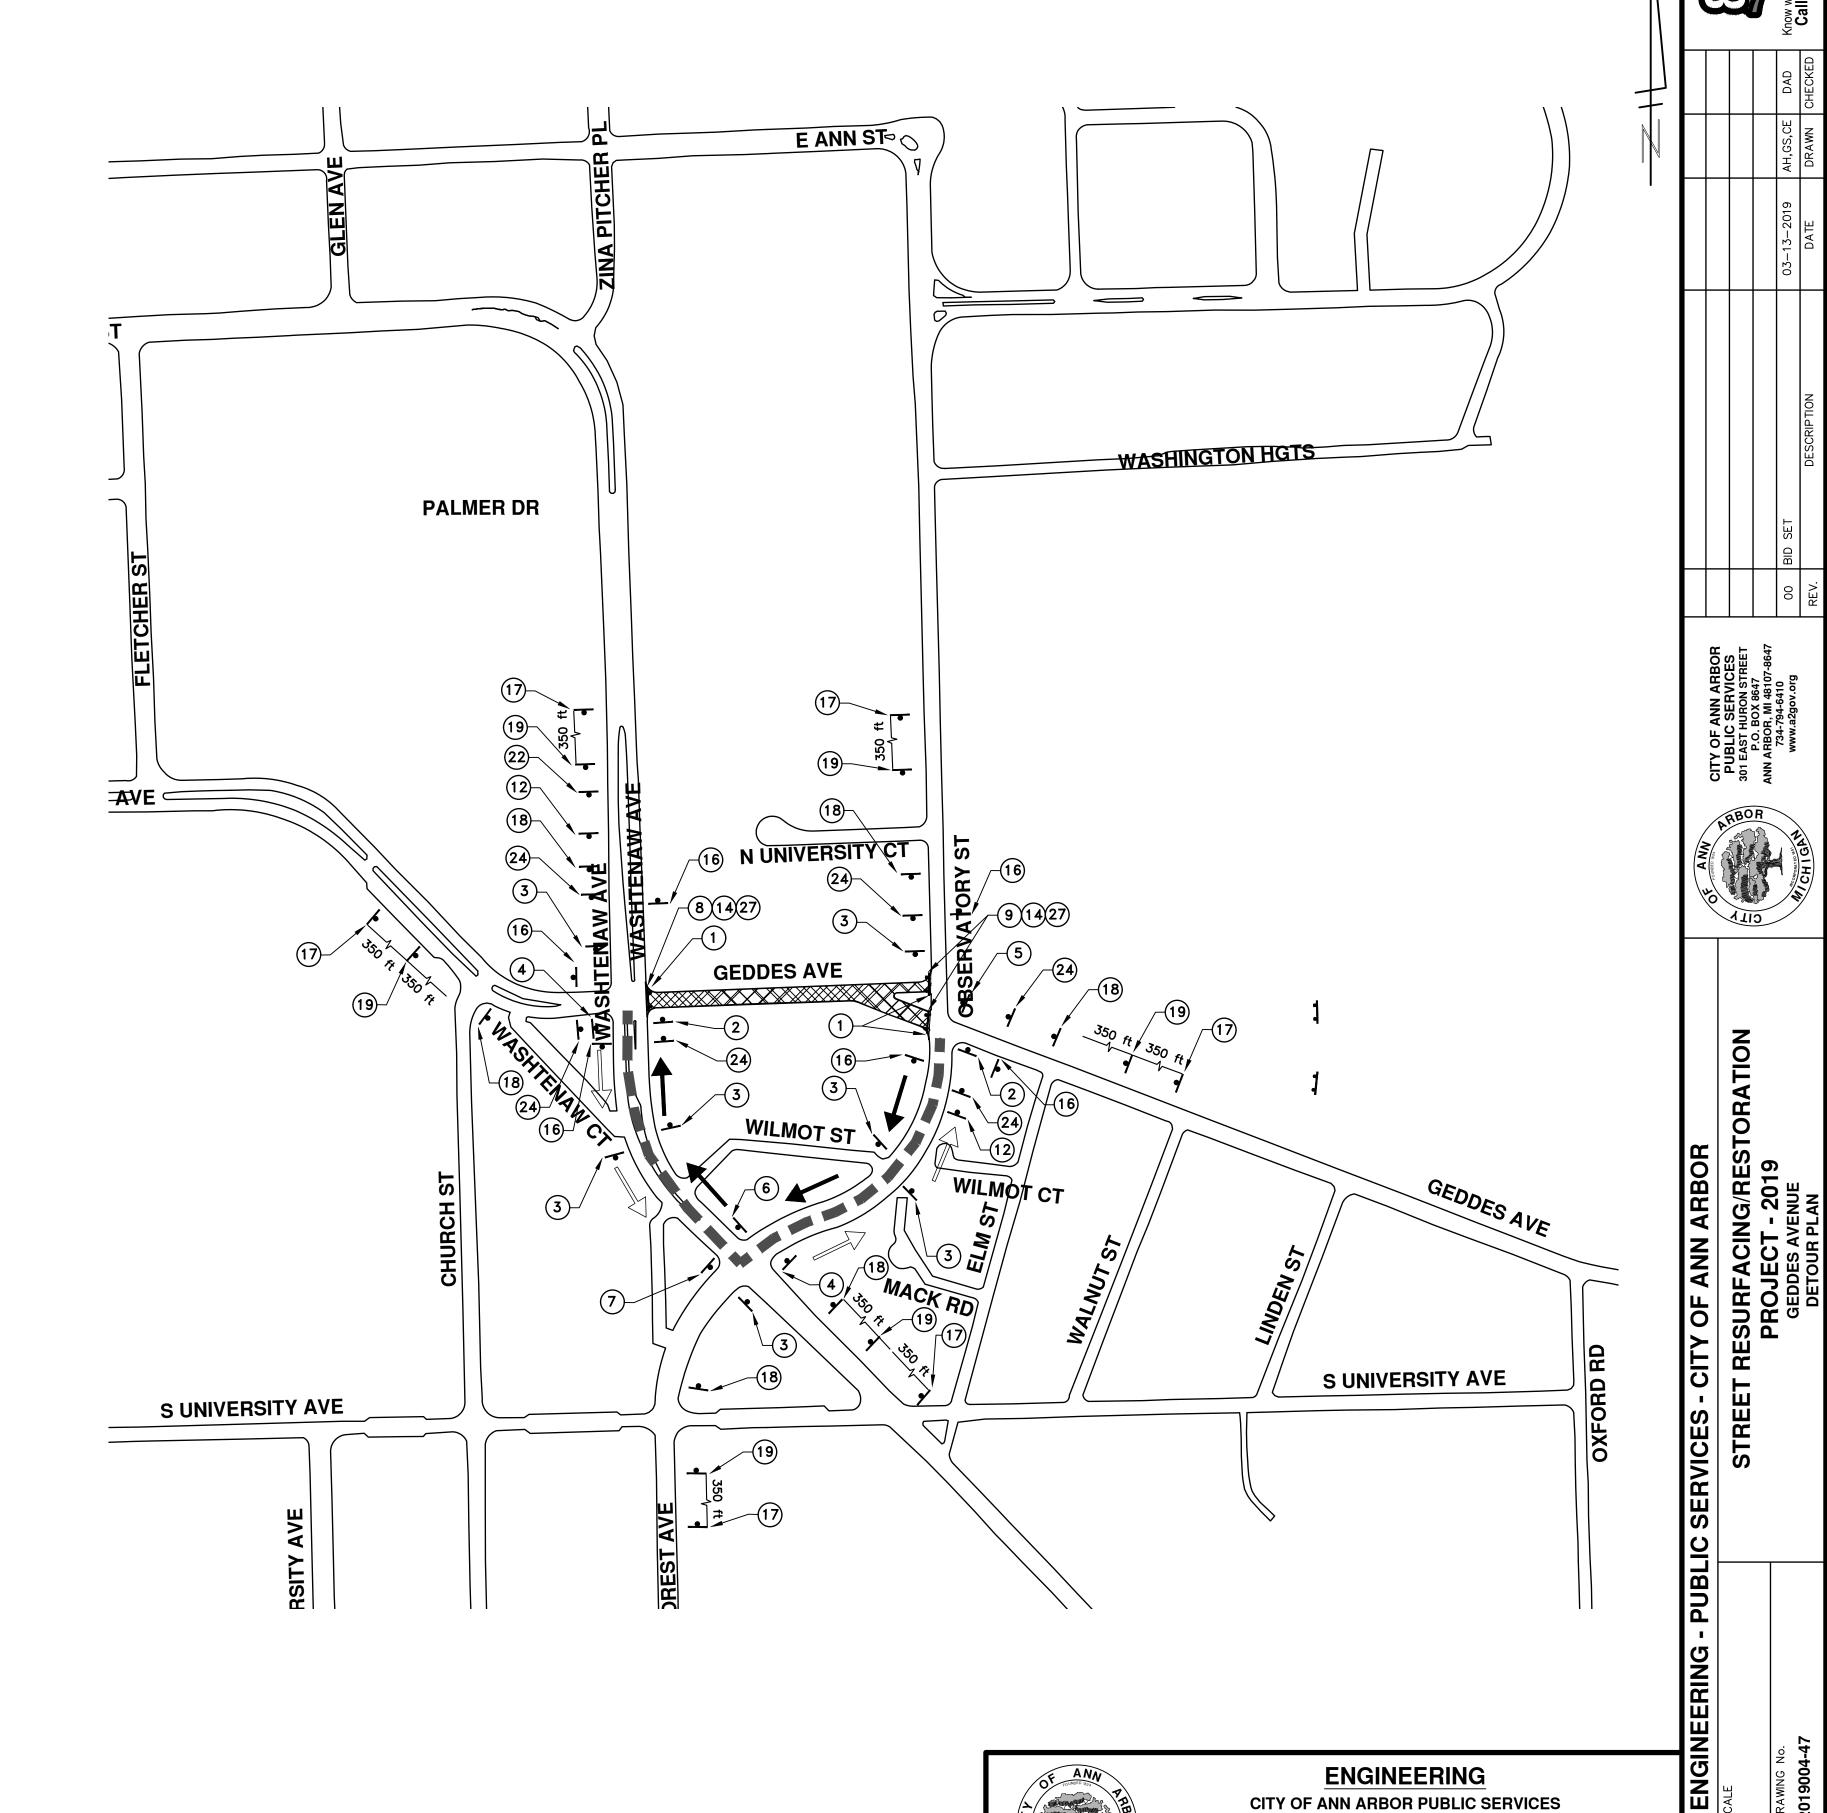



ENGINEERING

CITY OF ANN ARBOR PUBLIC SERVICES 301 EAST HURON STREET, P.O. BOX 8647 ANN ARBOR, MICHIGAN 48107-8647 734-794-6410 www.a2gov.org

47 OF 121

SHEET No.


DETOUR CONSTRUCTION NOTES:

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TRAFFIC CONTROL SIGN						
	SIGN	NUMBER	QUANTITY			
22	LEFT LANE CLOSED AHEAD	W20-5L 36"x36"	0			
23)		W4-2L 36"x36"	0			
24)	WORK ZONE BEGINS	R5–18C 48"x48"	0			
25)	EAST BOUND GEDDES AVE CLOSED AT WASHTENAW AVE FOLLOW DETOUR	SPECIAL 48x66	5			
26	WEST BOUND QEDDES AVE CLOSED AT OBSERVATORY ST FOLLOW DETOUR	SPECIAL 48x66	0			
27)	DO NOT ENTER	R5–1 36x36	0			
SIGN, CHANGEA	PORTABLE, BLE MESSAGE	QUAN LOCA ENGINI	TY EXACT ITITY AND TION WITH EER PRIOR DRDERING			

<u>LEGEND:</u>

EAST BOUND GEDDES AVE
DETOUR ROUTE
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ENGINEERING

CITY OF ANN ARBOR PUBLIC SERVICES 301 EAST HURON STREET, P.O. BOX 8647 ANN ARBOR, MICHIGAN 48107-8647 734-794-6410 www.a2gov.org

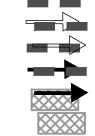48 OF 121

SHEET No.

ENGINEERING - PUBLIC SERVICES - CITY OF ANN ARBOR

STREET RESURFACING/RESTORATIO


PROJECT - 2019

PROJECT - 2019

RAWING NO.

PROJECT - 2019

TRAFFIC CONTROL

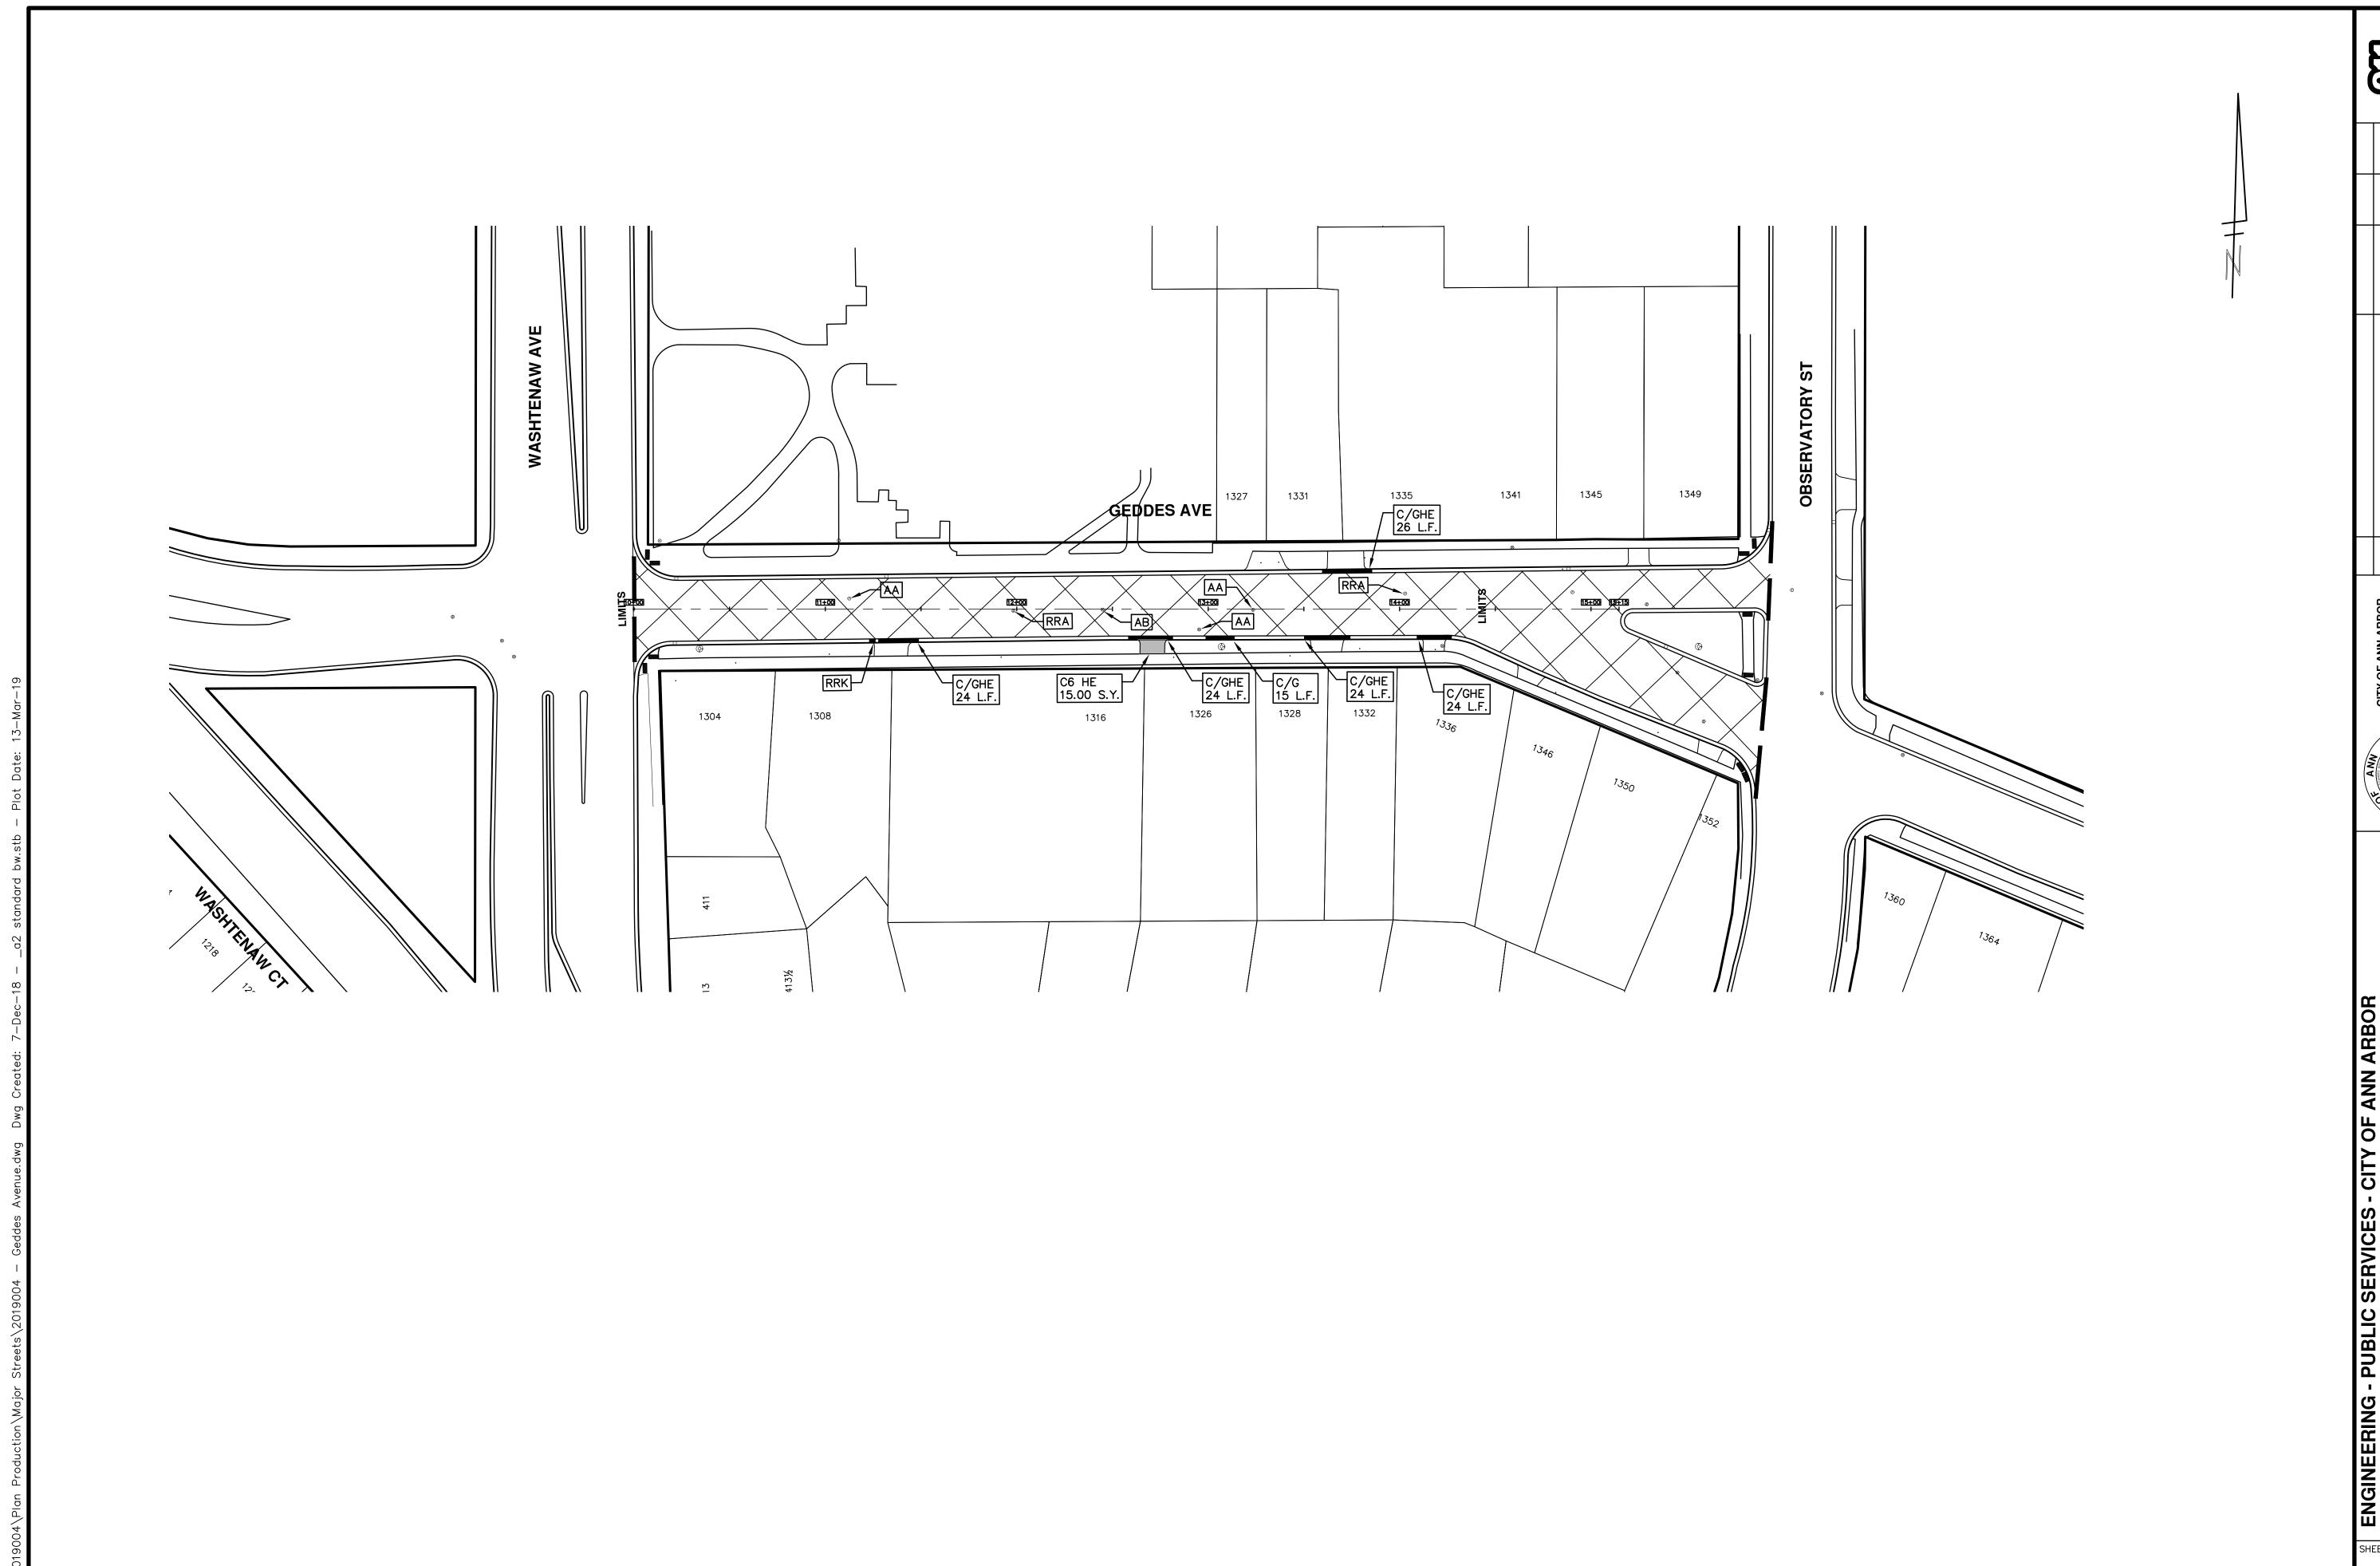


ENGINEERING - PUBLIC SERVICES - CITY OF ANN ARBOR

SCALE PLAN: 1:40

DRAWING No.

GEDDES AVENUE
STA. 10+00 - STA. 15+15

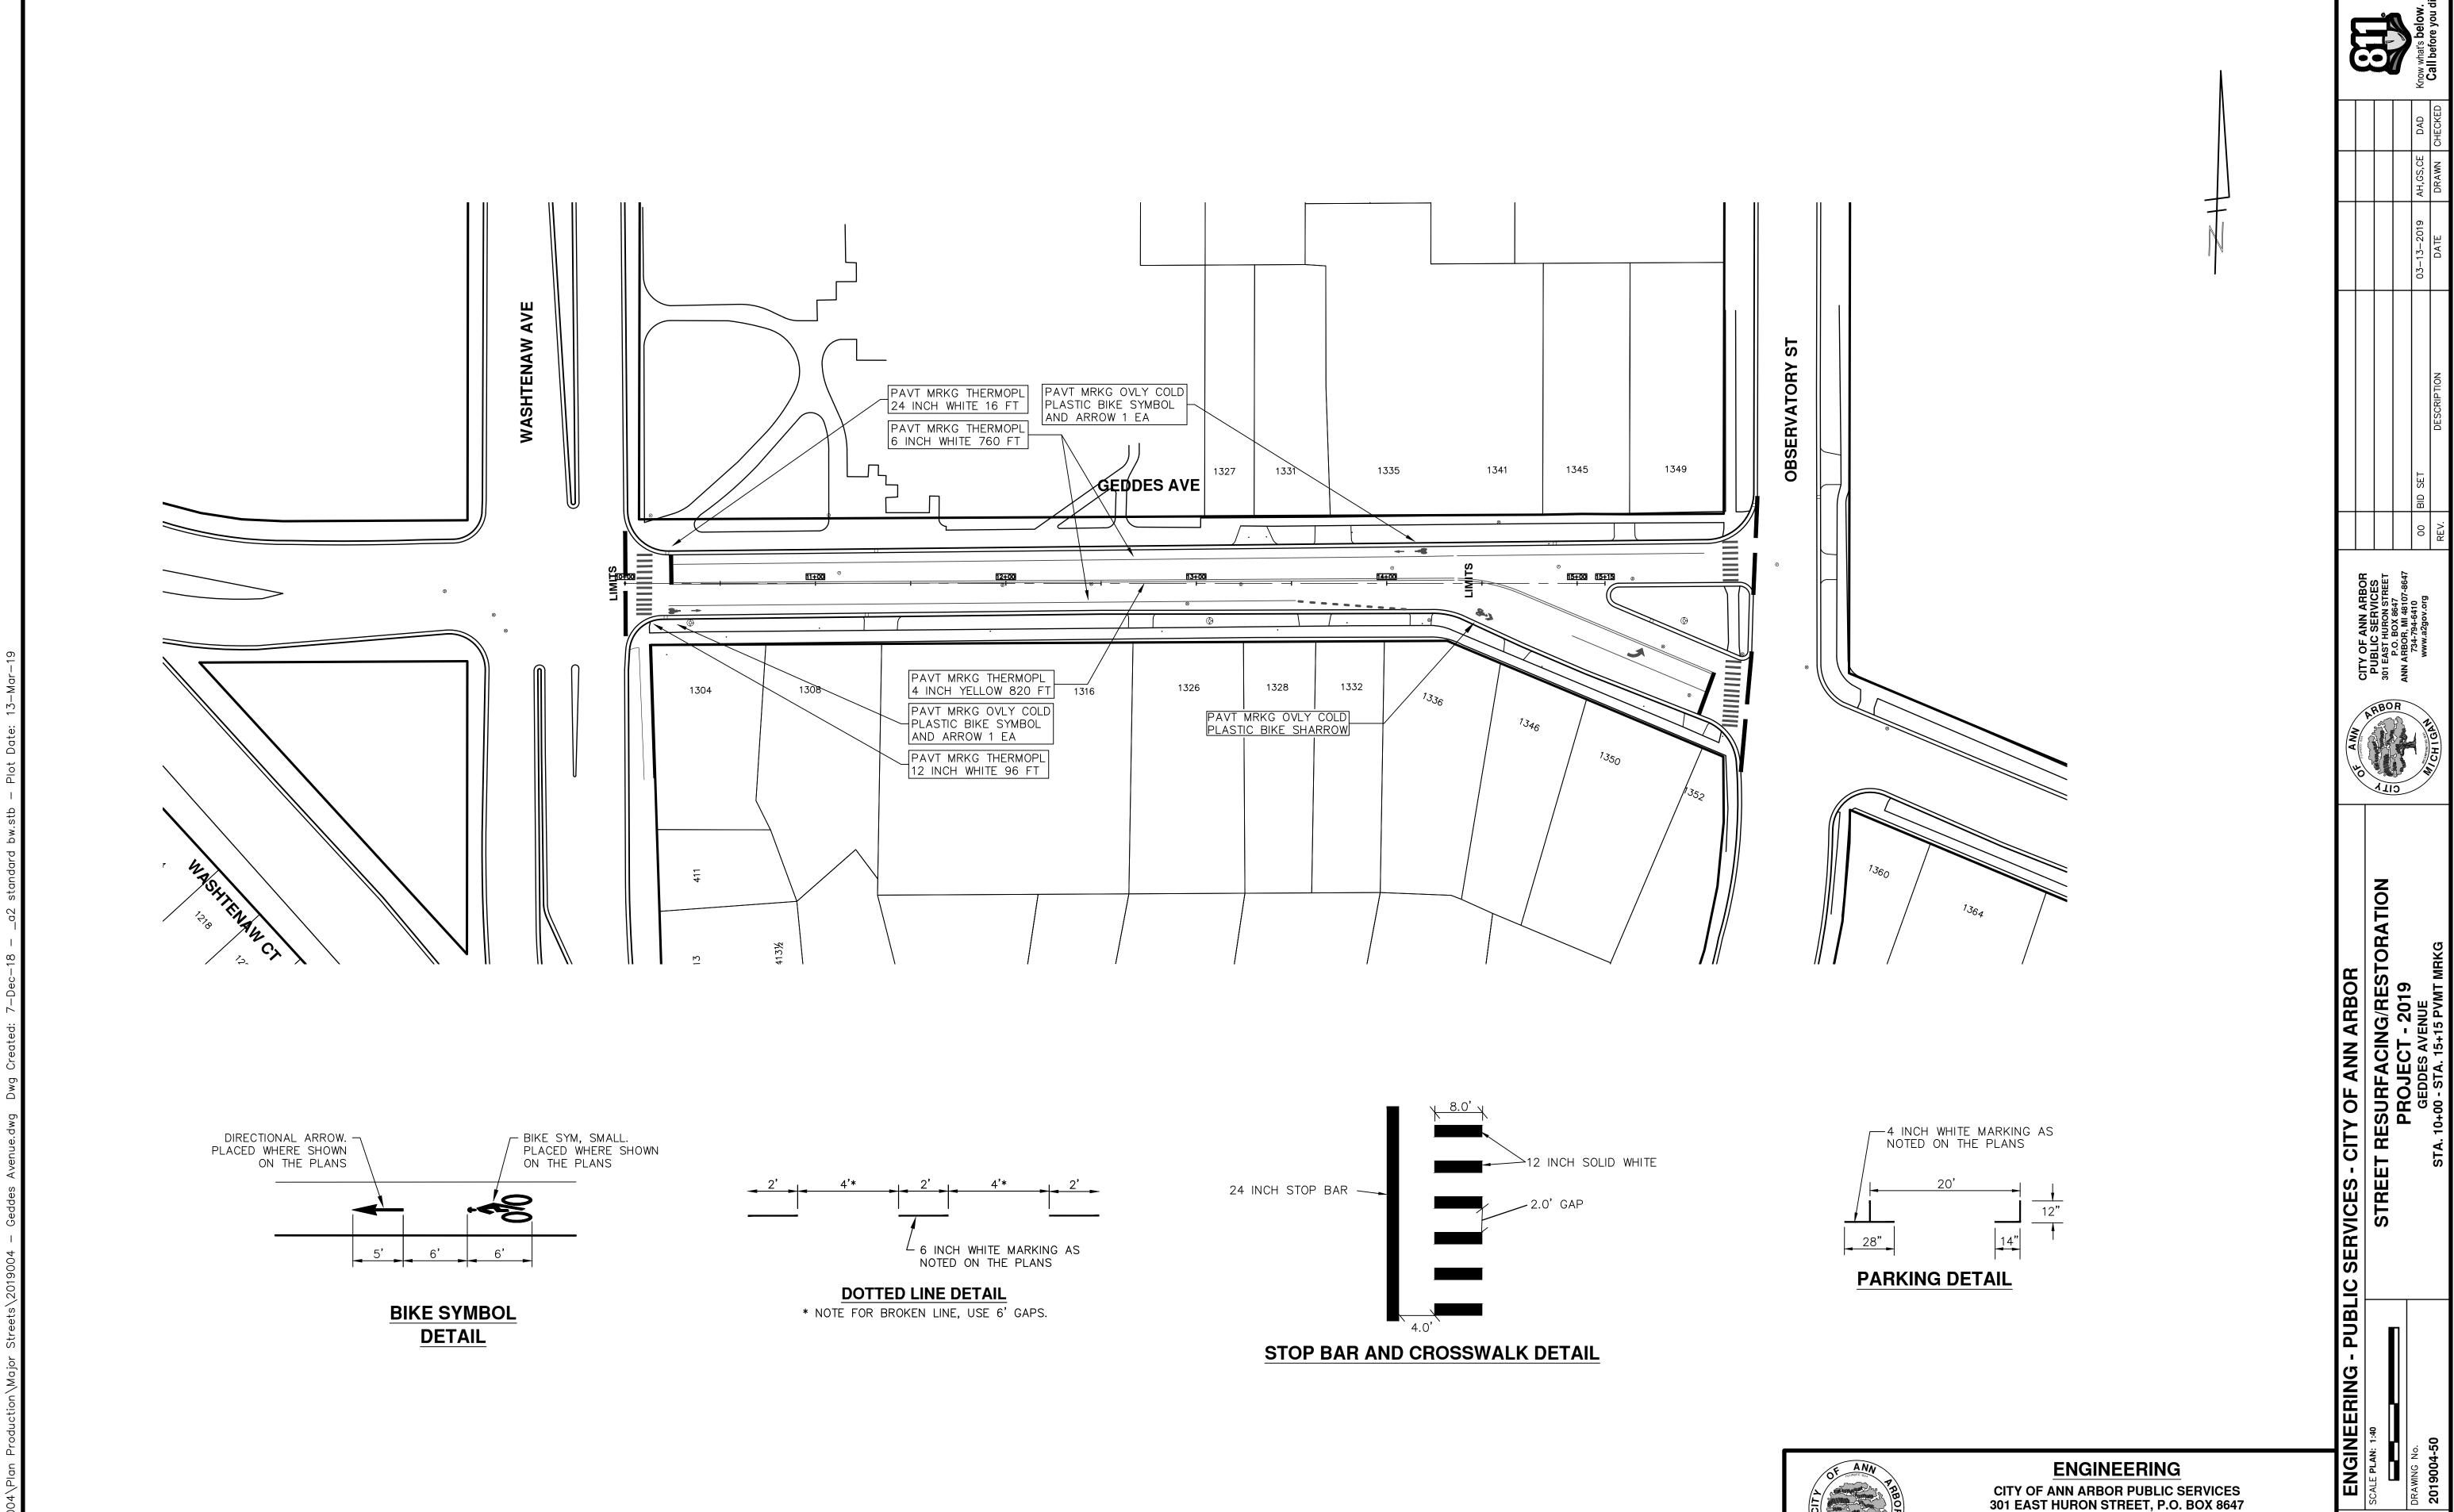

CITY OF ANN ARBOR PUBLIC SERVICES 301 EAST HURON STREET, P.O. BOX 8647 ANN ARBOR, MICHIGAN 48107-8647 734-794-6410 www.a2gov.org

SHEET No. 50 OF 121



CITY OF ANN ARBOR ENGINEERING PROJECT LOCATION: GRANGER AVENUE

ITB No. 4570 FILE No. 2019004

	CONSTRUCTION KEY
KEY	ASSOCIATED PAY ITEM(S)
	• _Dr Structure, Adj, Case 1, Modified
AA	• _Dr Structure, Adj, Case 2, Modified
	Dr Structure, Temp Lowering, Modified
	Dr Structure, Temp Lowering, Modified
	• Gate Box, Adj, Case 1
AB	• _Gate Box, Adj, Case 2
	Monument Box Adjust
ADST	• _Dr Structure, Adj, Add Depth, Modified
AK	• _Dr Structure, Adj, Case 1, Modified
7.11.	• _Sidewalk, Sidewalk Ramp, and Driveway Approach, Any Thickness, Rem
C4	- Grading, Sidewalk
01	• Sidewalk, Conc, 4 inch, Modified
	Sidewalk, Sidewalk Ramp, and Driveway Approach, Any Thickness, Rem
	• _Grading, Sidewalk
C4HE	
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	Sidewalk, Conc, 4 inch, Modified Sidewalk, Sidewalk Rome, and Drivovoy Approach, Any Thickness, Rome
	• _Sidewalk, Sidewalk Ramp, and Driveway Approach, Any Thickness, Rem
	• _Grading, Sidewalk
C6	• _Grading, Sidewalk Ramp
	• _Detectable Warning Surface, Modified
	• _Sidewalk Ramp, Conc, 6 inch, Modified
	• _Sidewalk, Conc, 6 inch, Modified
C8	• _Grading, Driveway Approach
	• _Driveway, Nonreinf Conc, 8 inch, Modified
	 _Sidewalk, Sidewalk Ramp, and Driveway Approach, Any Thickness, Rem
	Grading, Driveway Approach
	• _Grading, Sidewalk
	• _Grading, Sidewalk Ramp
C HE	Cement
CTIL	• _Driveway, Nonreinf Conc, 6 inch, Modified
	• _Driveway, Nonreinf Conc, 8 inch, Modified
	_Detectable Warning Surface, Modified
	• _Sidewalk Ramp, Conc, 6 inch, Modified
	• _Sidewalk, Conc, 6 inch, Modified
CIC	• _Curb, Gutter, and Curb and Gutter, Any Type, Rem
C/G	• _Curb and Gutter, Conc
	• _Curb, Gutter, and Curb and Gutter, Any Type, Rem
C/GHE	• Cement
	• _Driveway Opening, Conc, Det M, Modified
0.5	• Grading, Sidewalk
CP	• _Sidewalk, Conc, 4 inch, Modified
CR	• _Sidewalk, Sidewalk Ramp, and Driveway Approach, Any Thickness, Rem
	• Dr Structure, Rem
DS	• Sewer, Rem, Less than 24 inch
— a = a	• Dr Structure, 24 inch dia
	• Dr Structure, Rem
DSDI	• Sewer, Rem, Less than 24 inch
_ 001	Dr Structure, Double Inlet
PT	Dr Structure, Point
- 1	Dr Structure Cover, Type B
	• _Dr Structure Cover, Type B, Special
RRA	Dr Structure, Adj, Case 1, Modified
	• _Dr Structure, Temp Lowering, Modified
	Dr Structure Cover, Type K
RRK	Dr Churchine Adi Cook 4 Martifier
	• _Dr Structure, Adj, Case 1, Modified
RRK RS	Dr Structure, Reconstruct
RS	Dr Structure, Reconstruct Plastic Drum, High Intensity, Lighted, Fum
	Dr Structure, Reconstruct

NOTES:

FOR PROTECTION OF UNDERGROUND UTILITIES AND IN CONFORMANCE WITH PUBLIC ACT 174 OF 2013, THE CONTRACTOR SHALL CALL 811 OR 1-800-482-7171 A MINIMUM OF THREE FULL WORKING DAYS, EXCLUDING SATURDAYS, SUNDAYS, AND HOLIDAYS, PRIOR TO BEGINNING EACH EXCAVATION IN AREAS WHERE PUBLIC UTILITIES HAVE NOT BEEN PREVIOUSLY LOCATED. MEMBERS WILL THUS BE ROUTINELY NOTIFIED. THIS DOES NOT RELIEVE THE CONTRACTOR OF THE RESPONSIBILITY OF NOTIFYING UTILITY OWNERS WHO MAY NOT BE A PART OF THE "MISS DIG" ALERT SYSTEM.

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ENGINEERING

CITY OF ANN ARBOR PUBLIC SERVICES 301 EAST HURON STREET, P.O. BOX 8647 ANN ARBOR, MICHIGAN 48107-8647 734-794-6410 www.a2gov.org

		Know what's below	Call before you	
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00 BID SET
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PROJECT - 2019
GRANGER AVENUE

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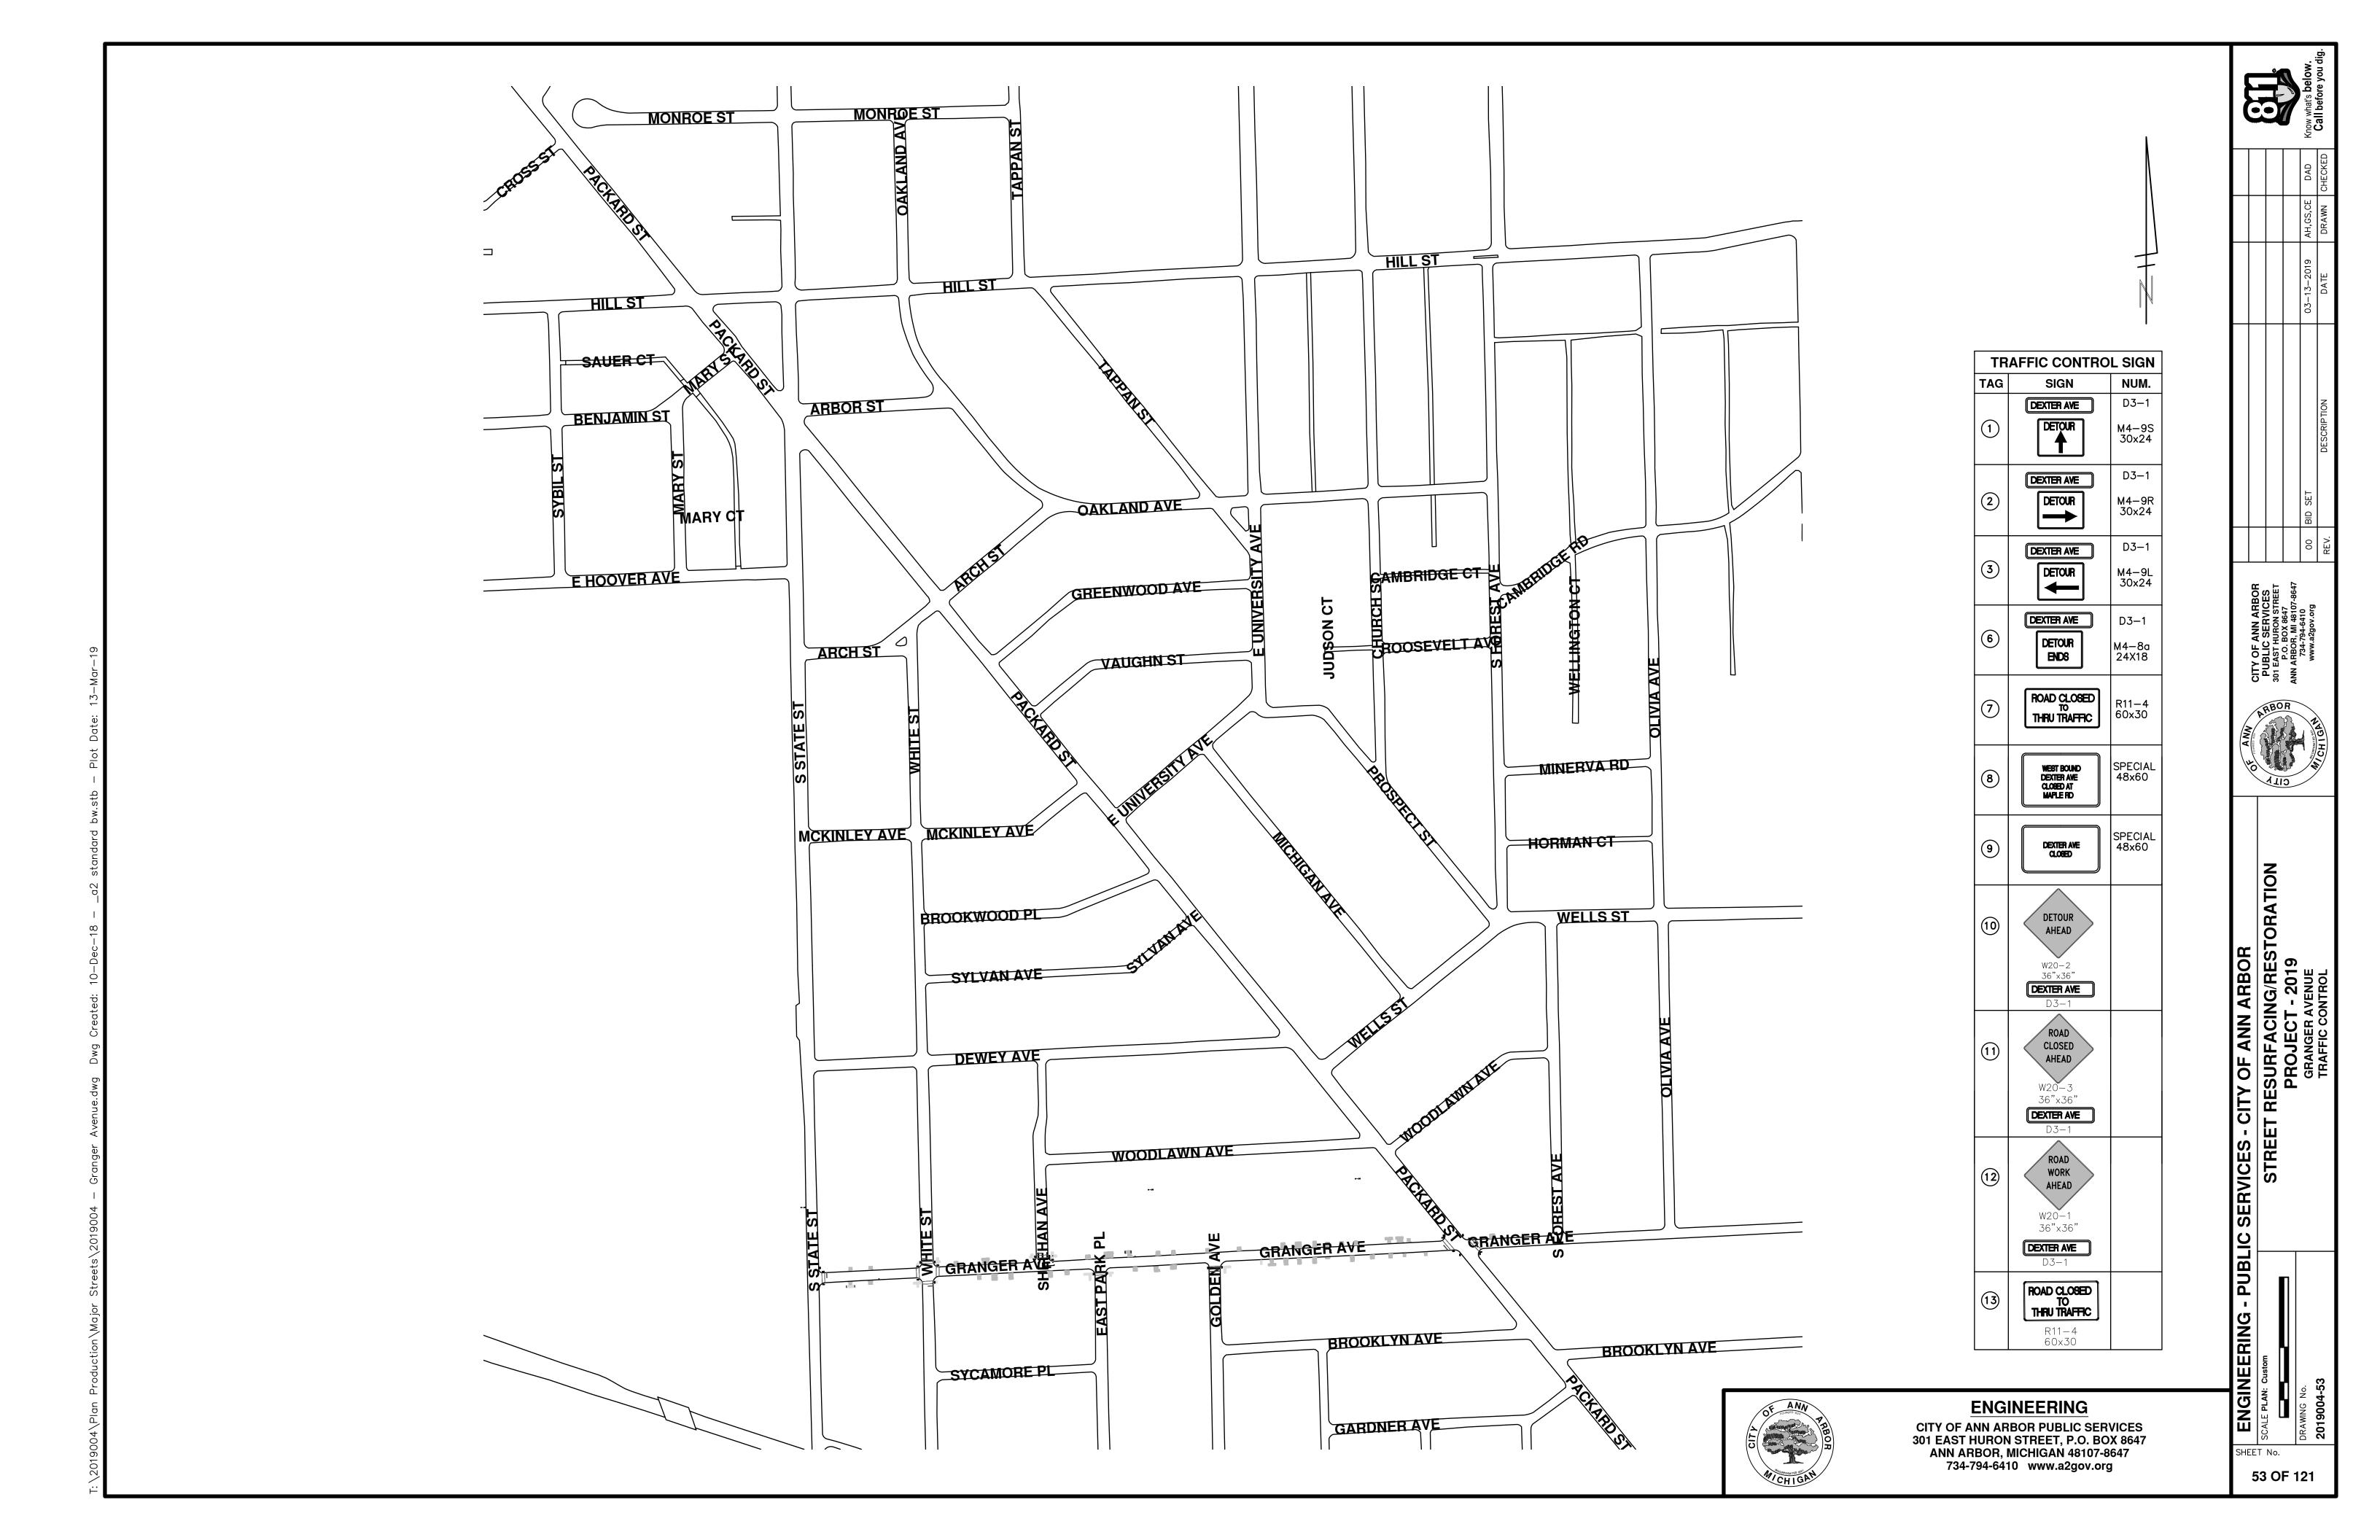
ENGINEERING - P
SCALE PLAN: ###


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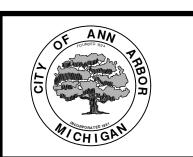
51 **OF 121**

T:\2019004\Plan Production\Major Streets\2019004 —







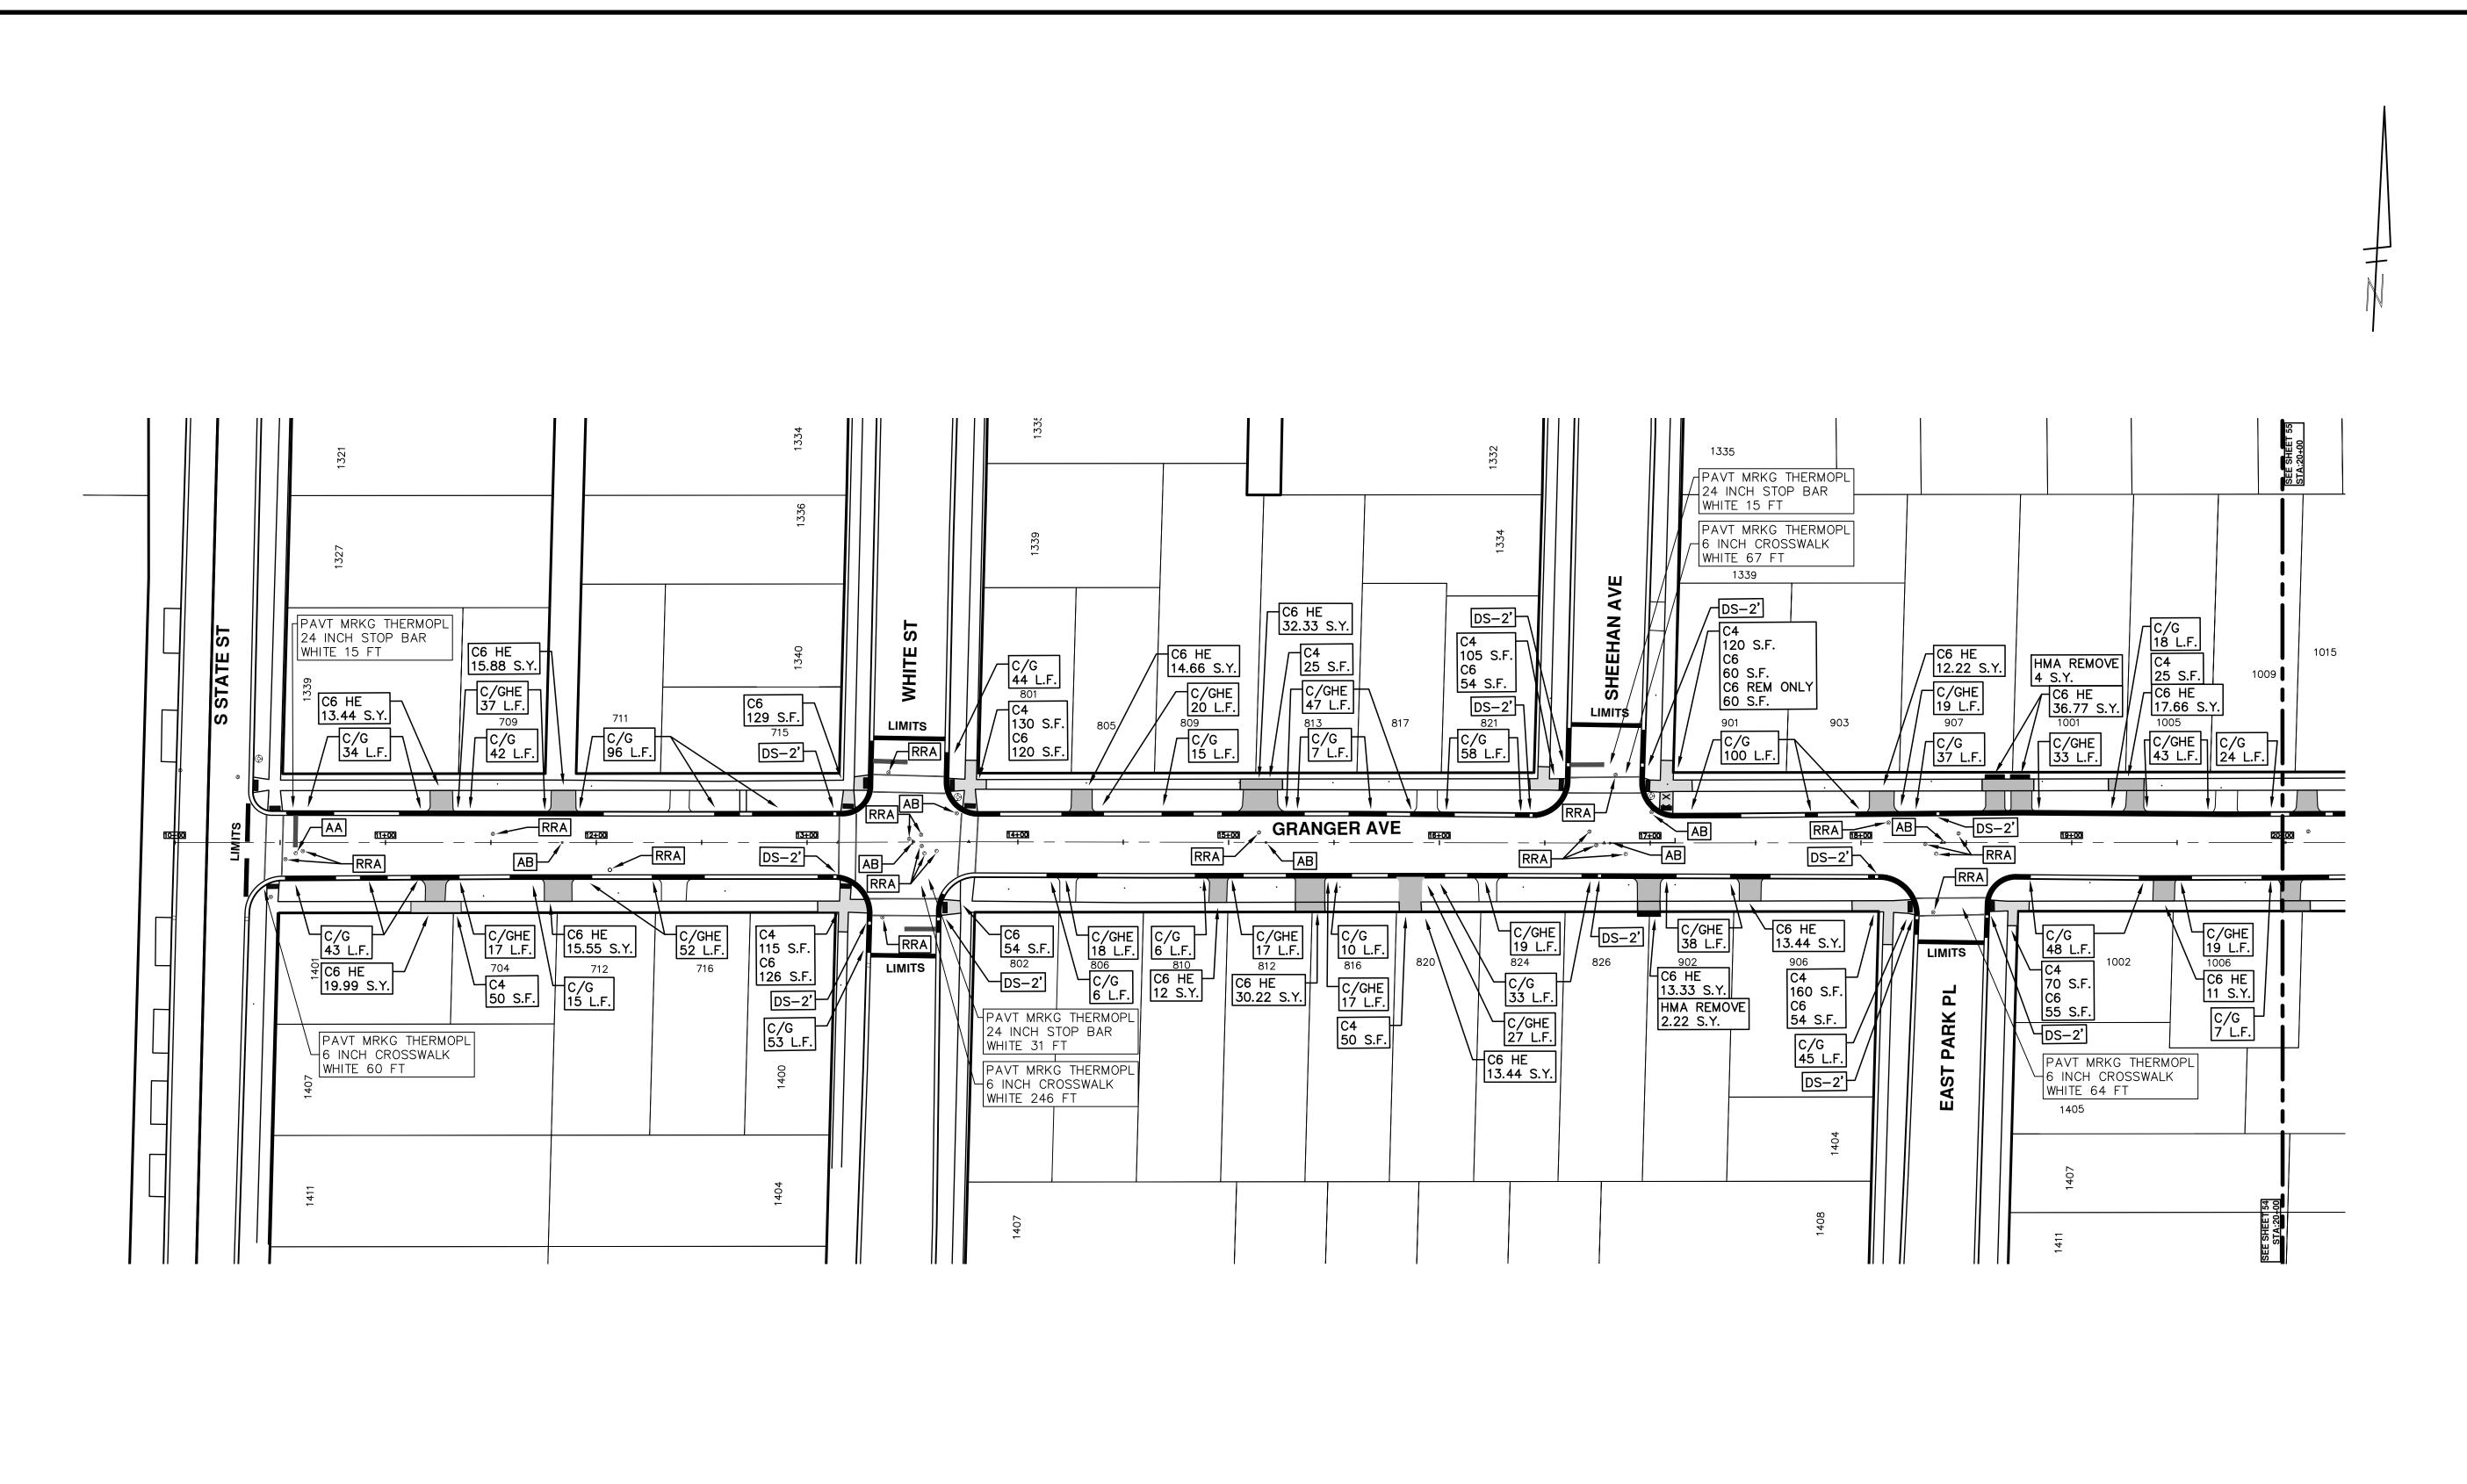

CITY OF ANN ARBOR PUBLIC SERVICES 301 EAST HURON STREET, P.O. BOX 8647 ANN ARBOR, MICHIGAN 48107-8647 734-794-6410 www.a2gov.org

ENGINEERING

54 OF 121

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ENGINEERING - PUBLIC SERVICES - CITY OF ANN ARBOR

SCALE PLAN: 1:40


DRAWING No.

CALE PLAN: 1:40

DRAWING No.

CALE PLAN: 1:40


STA. 10+00 - STA. 20+00

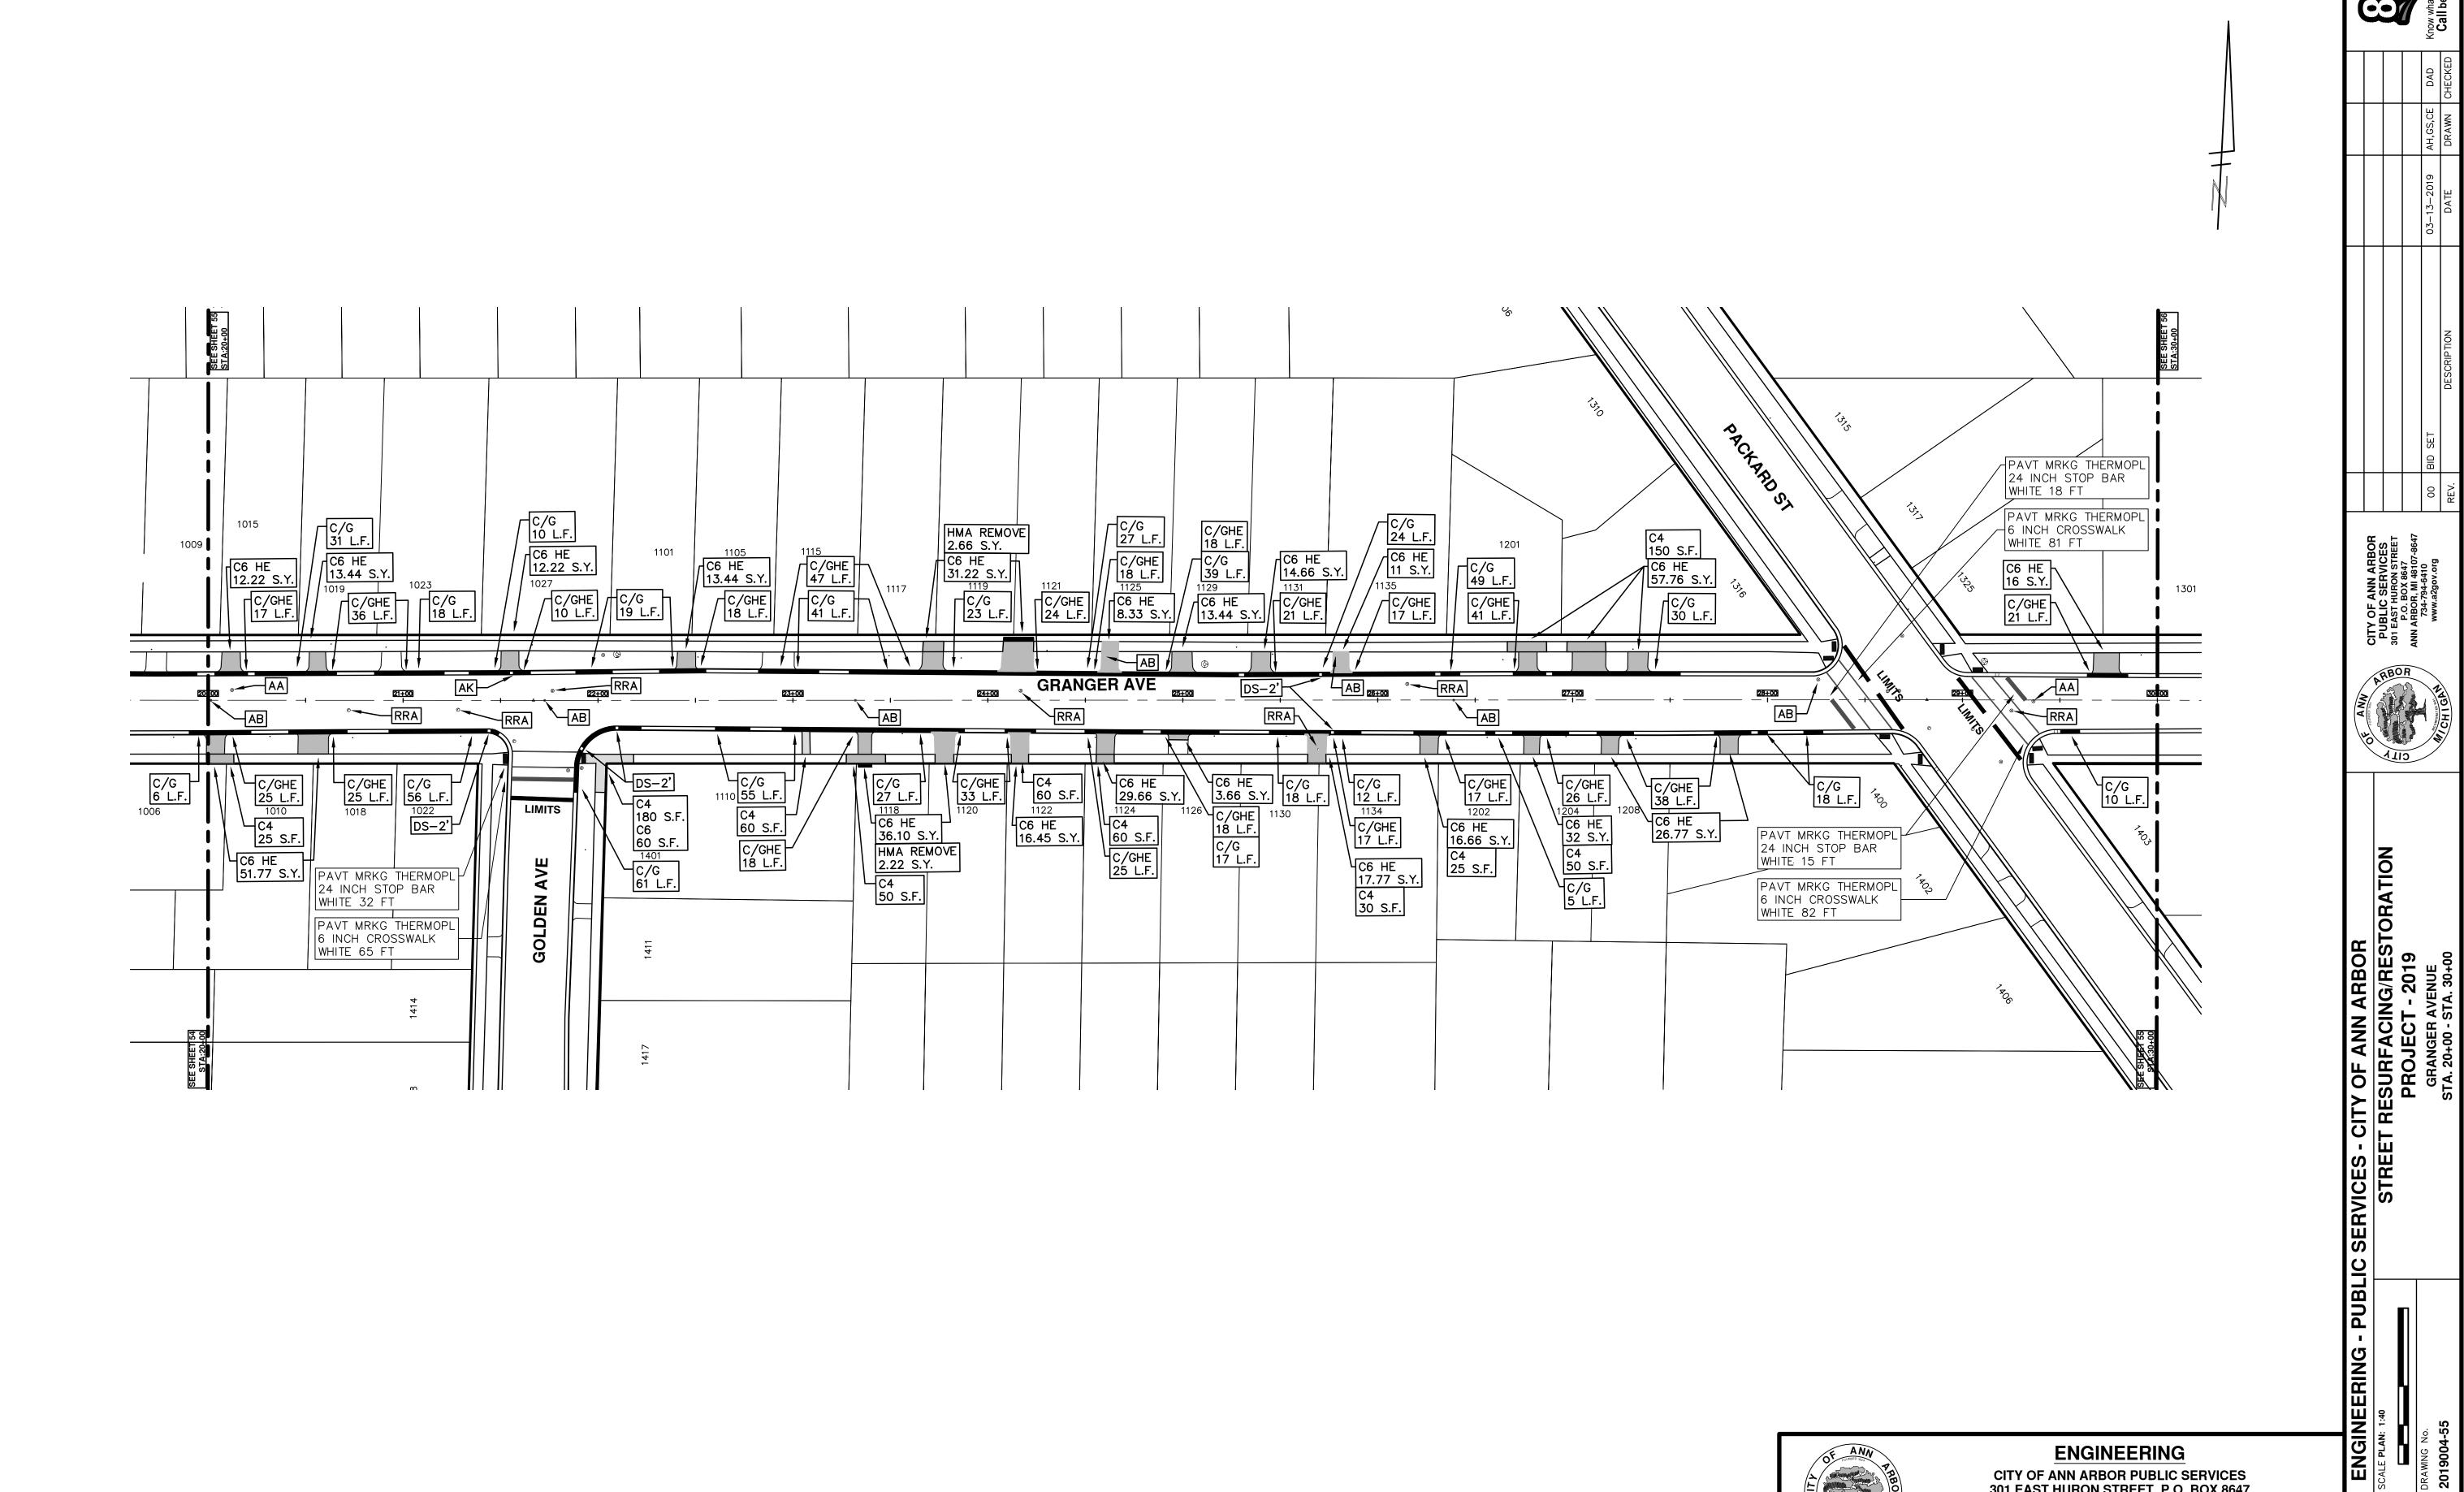

CITY OF ANN ARBOR PUBLIC SERVICES 301 EAST HURON STREET, P.O. BOX 8647 ANN ARBOR, MICHIGAN 48107-8647 734-794-6410 www.a2gov.org

SHEET No.



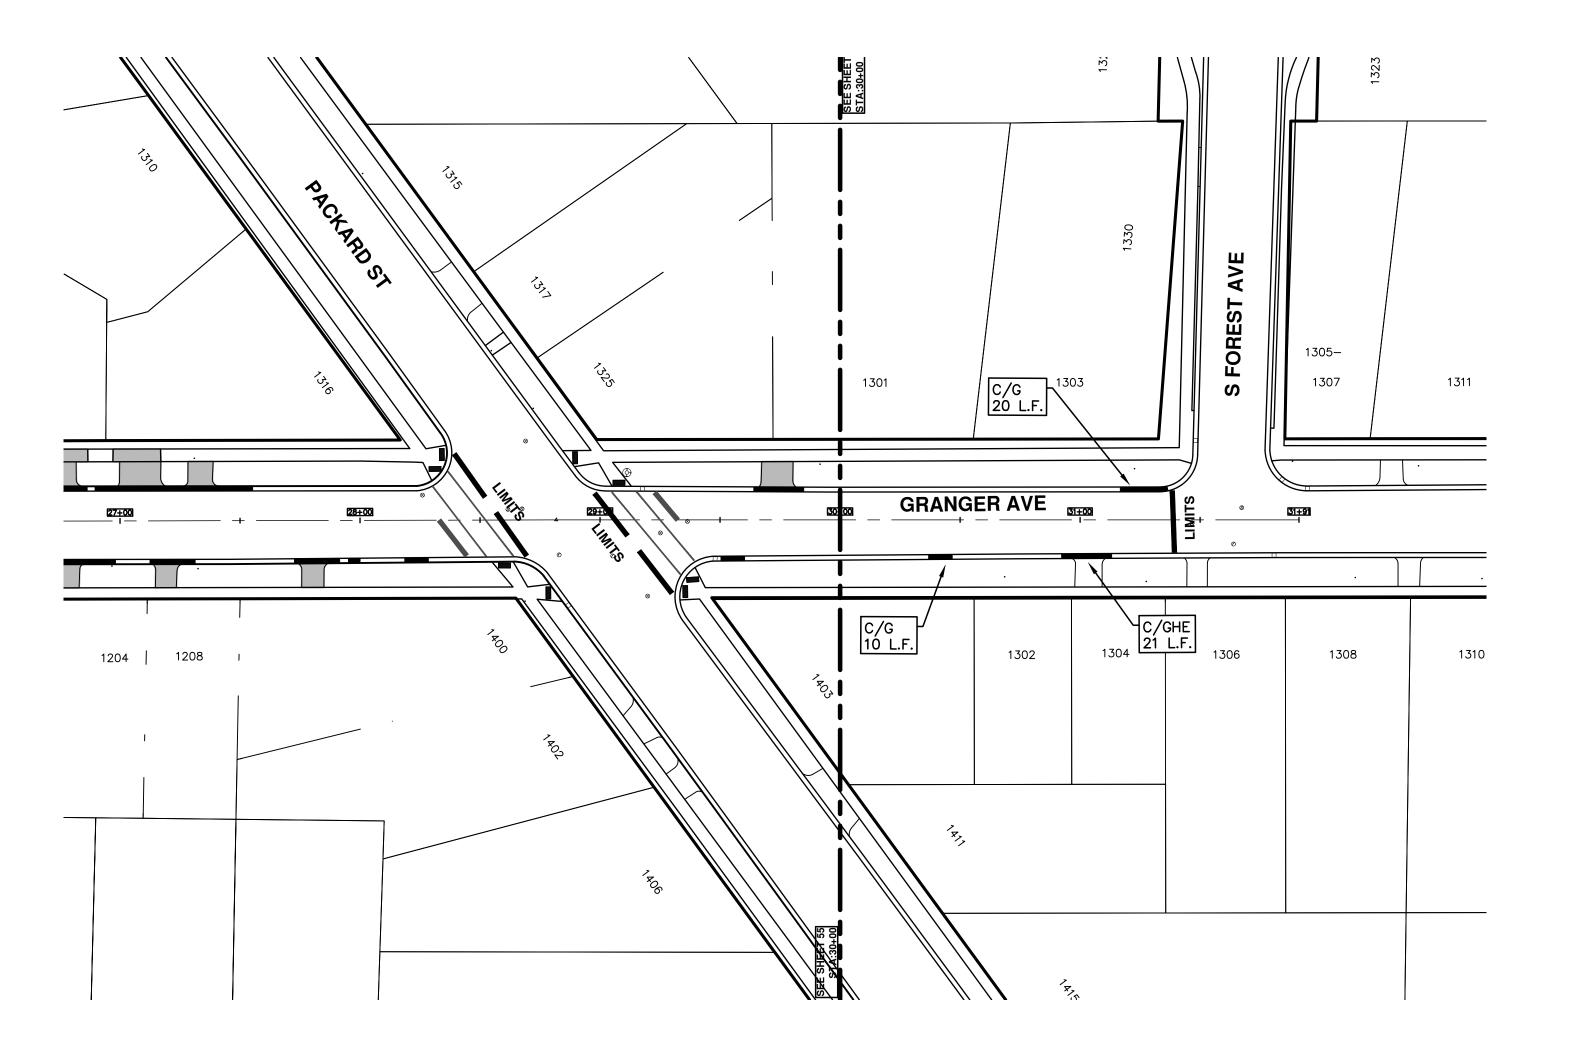

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MICHIGAN	

CITY OF ANN ARBOR PUBLIC SERVICES 301 EAST HURON STREET, P.O. BOX 8647 ANN ARBOR, MICHIGAN 48107-8647 734-794-6410 www.a2gov.org

ENGINEERING - PUBLIC SERVICES - CITY OF ANN ARBOR

SCALE PLAN: 1:40

SCALE PLAN: 1:40

DRAWING No.

CO19004-56

SCALE PLAN ARBOR

STREET RESURFACING/RESTORATION

PROJECT - 2019

GRANGER AVENUE
STA. 30+00 - STA. 31+91 56 OF 121



CITY OF ANN ARBOR ENGINEERING

PROJECT LOCATION: FULLER RD - HURON PKWY HMA PATH

ITB No. 4570 FILE No. 2019004

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47				
	00	00 BID SET	03-13-2019	AH,GS,
	REV.	DESCRIPTION	DATE	DRAW



SHEET No.

57 OF 121


ENGINEERING


CITY OF ANN ARBOR PUBLIC SERVICES 301 EAST HURON STREET, P.O. BOX 8647 ANN ARBOR, MICHIGAN 48107-8647 734-794-6410 www.a2gov.org


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CITY OF ANN ARBOR PUBLIC SERVICES 301 EAST HURON STREET, P.O. BOX 8647 ANN ARBOR, MICHIGAN 48107-8647 734-794-6410 www.a2gov.org



CITY OF ANN ARBOR ENGINEERING PROJECT LOCATION: PLATT ROAD

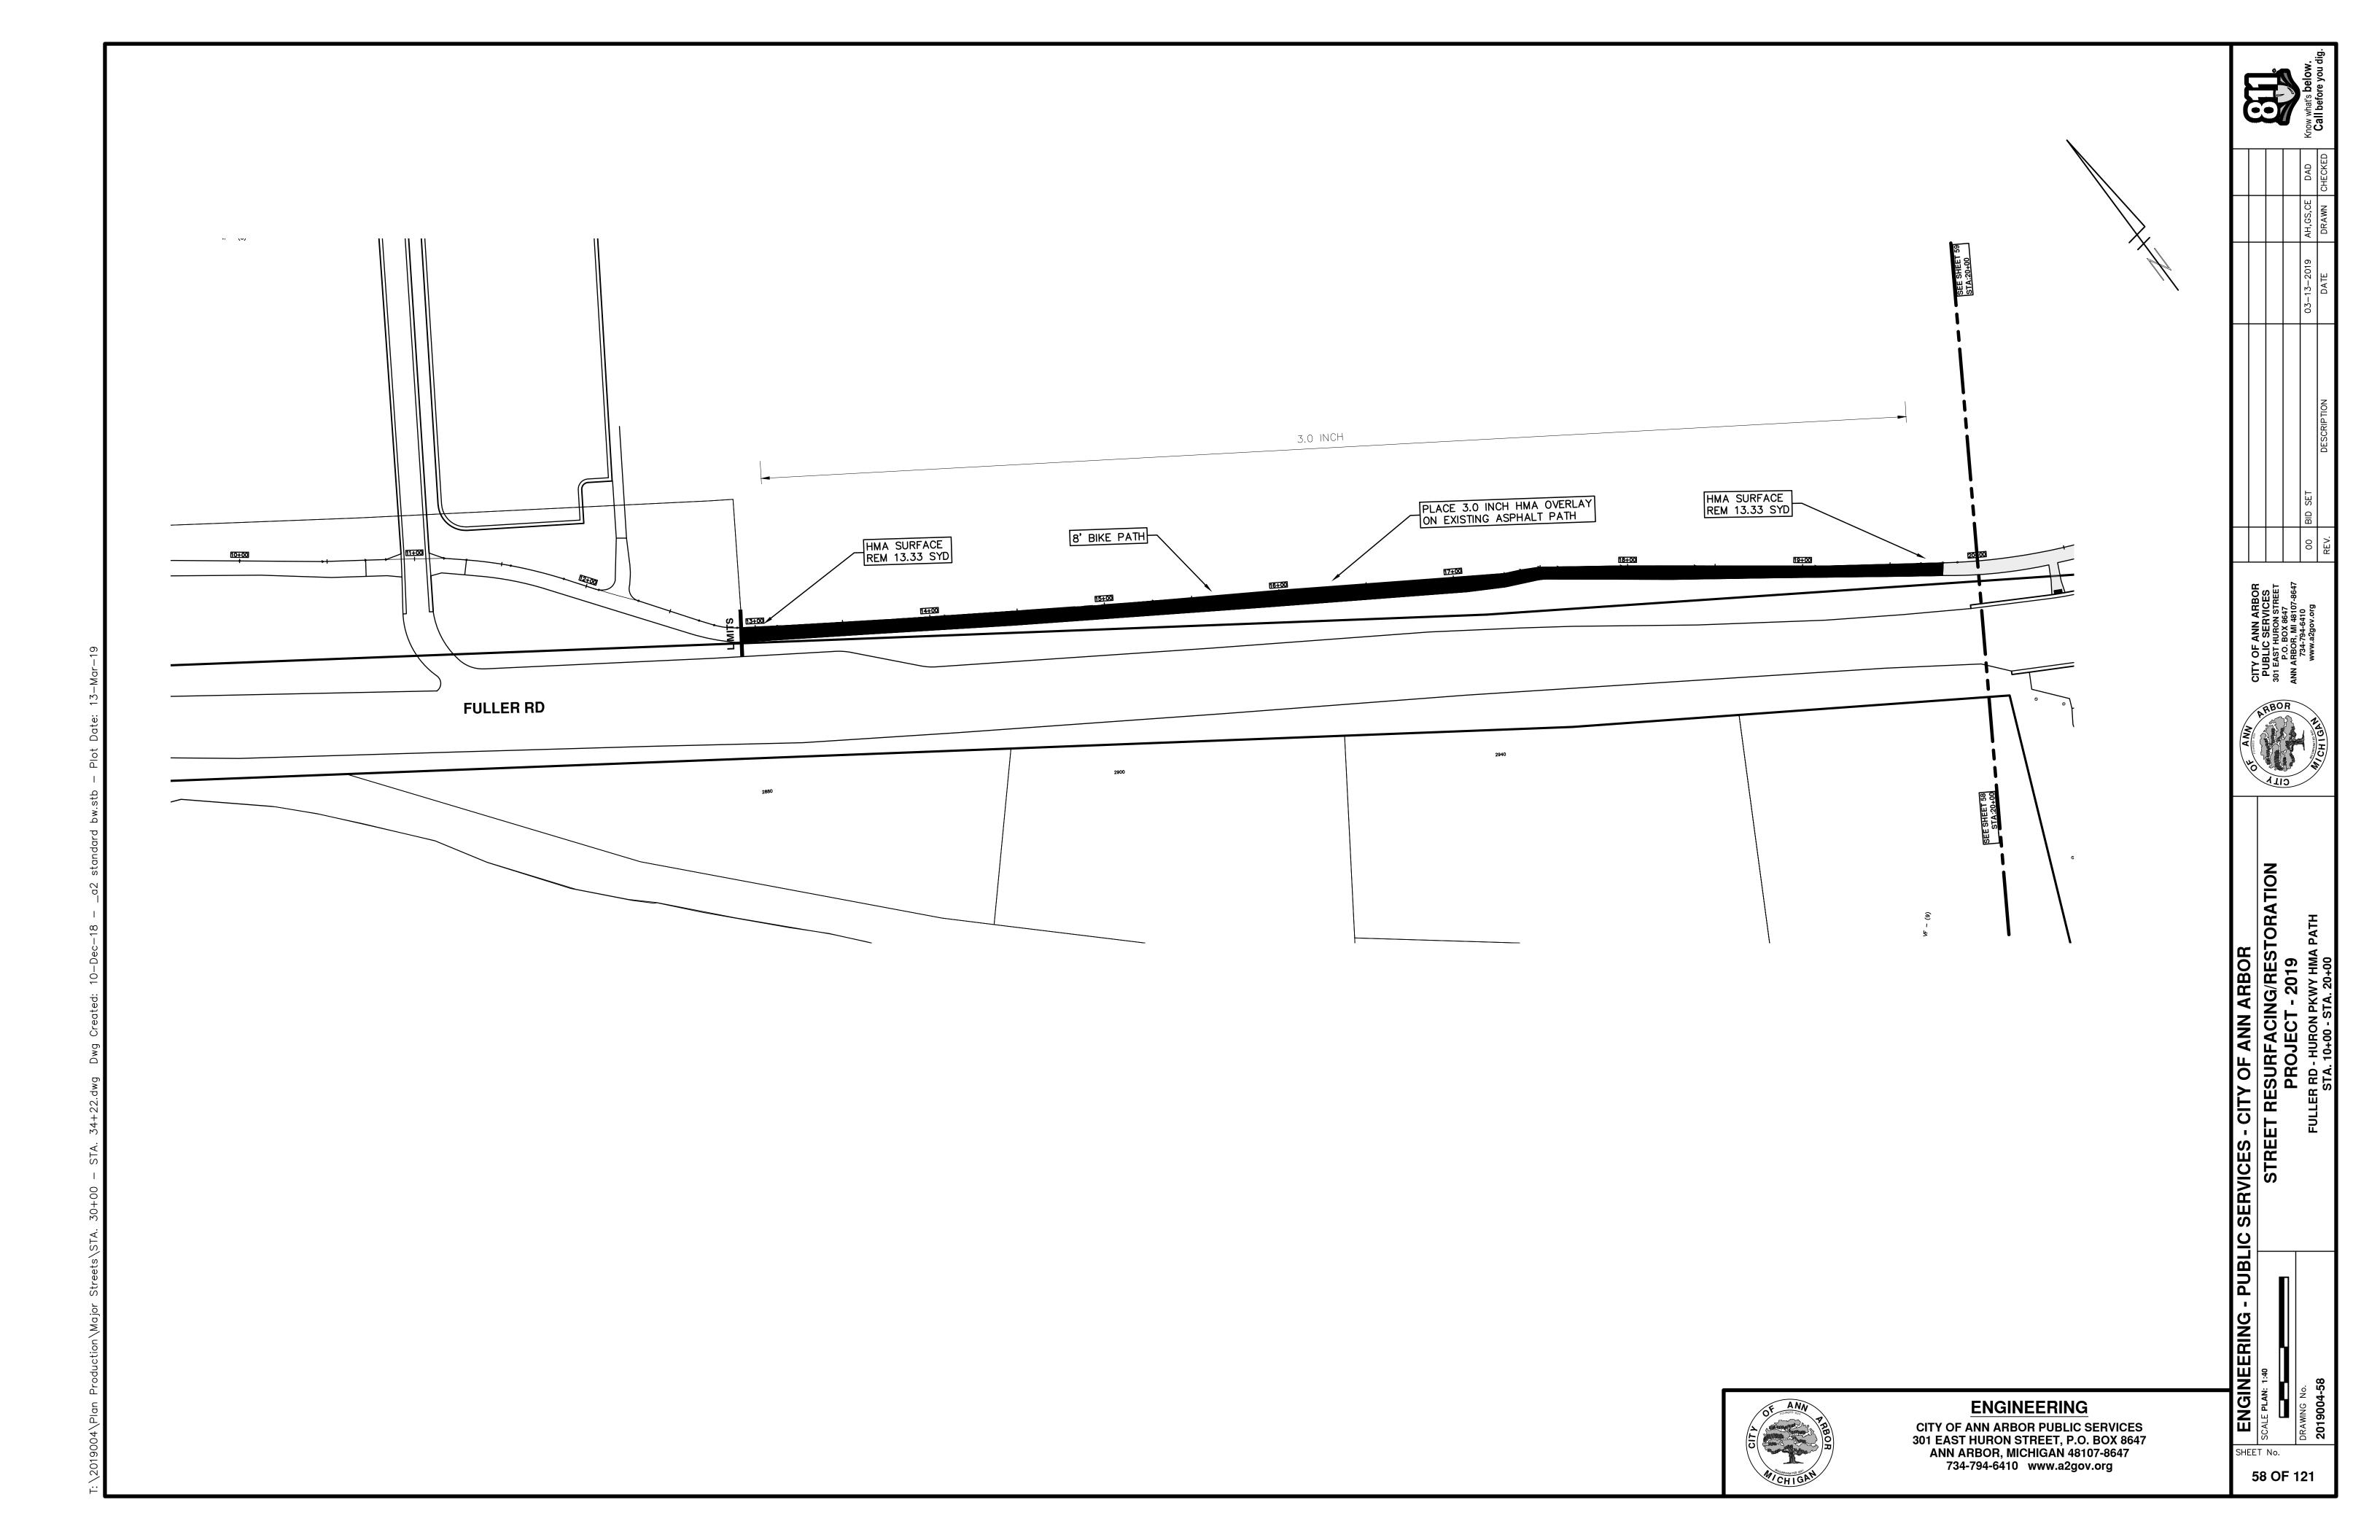CONSTRUCTION KEY				
KEY	ASSOCIATED PAY ITEM(S)			
	• _Dr Structure, Adj, Case 1, Modified			
AA	• _Dr Structure, Adj, Case 2, Modified			
	• _Dr Structure, Temp Lowering, Modified			
	• _Dr Structure, Temp Lowering, Modified			
AB	• _Gate Box, Adj, Case 1			
	• _Gate Box, Adj, Case 2			
ADST	 _Monument Box Adjust Dr Structure, Adj, Add Depth, Modified 			
AK	_Dr Structure, Adj, Add Deptri, Modified _Dr Structure, Adj, Case 1, Modified			
7 (1)	Sidewalk, Sidewalk Ramp, and Driveway Approach, Any Thickness, Rem			
C4	• Grading, Sidewalk			
	Sidewalk, Conc, 4 inch, Modified Sidewalk, Conc, 4 inch, Modified			
	Sidewalk, Sidewalk Ramp, and Driveway Approach, Any Thickness, Rem			
CALIE	• _Grading, Sidewalk			
C4HE	Cement			
	• _Sidewalk, Conc, 4 inch, Modified			
	• _Sidewalk, Sidewalk Ramp, and Driveway Approach, Any Thickness, Rem			
	• _Grading, Sidewalk			
C6	• _Grading, Sidewalk Ramp			
	Detectable Warning Surface, Modified			
	Sidewalk Ramp, Conc, 6 inch, Modified Sidewalk Conc, 6 inch, Modified			
	_Sidewalk, Conc, 6 inch, Modified_Grading, Driveway Approach			
C8	Driveway, Nonreinf Conc, 8 inch, Modified			
	Sidewalk, Sidewalk Ramp, and Driveway Approach, Any Thickness, Rem			
	• Grading, Driveway Approach			
	• Grading, Sidewalk			
	• _Grading, Sidewalk Ramp			
C HE	• Cement			
CTIL	• _Driveway, Nonreinf Conc, 6 inch, Modified			
	Driveway, Nonreinf Conc, 8 inch, Modified			
	Detectable Warning Surface, Modified			
	Sidewalk Ramp, Conc, 6 inch, Modified			
	• _Sidewalk, Conc, 6 inch, Modified			
 C/G Curb, Gutter, and Curb and Gutter, Any Type, Rem Curb and Gutter, Conc 				
	_Curb, Gutter, and Curb and Gutter, Any Type, Rem			
C/GHE	• Cement			
0, 01 12	Driveway Opening, Conc, Det M, Modified			
00	Grading, Sidewalk			
CP	Sidewalk, Conc, 4 inch, Modified Sidewalk, Conc, 4 inch, Modified			
CR • _Sidewalk, Sidewalk Ramp, and Driveway Approach, Any Thickness				
	Dr Structure, Rem			
DS	• Sewer, Rem, Less than 24 inch			
	Dr Structure, 24 inch dia Dr Structure, Dare			
חסטי	• Dr Structure, Rem			
DSDI	Sewer, Rem, Less than 24 inch Dr Structure, Double Inlet			
PT	_Dr Structure, Double InletDr Structure, Point			
Dr Structure, Point Dr Structure Cover, Type B				
55:	Dr Structure Cover, Type B, Special			
RRA	• _Dr Structure, Adj, Case 1, Modified			
	Dr Structure, Temp Lowering, Modified			
RRK	Dr Structure Cover, Type K			
	• _Dr Structure, Adj, Case 1, Modified			
RS	• _Dr Structure, Reconstruct			
TYPE II	Plastic Drum, High Intensity, Lighted, Furn			
	Plastic Drum, High Intensity, Lighted, Oper Demiseds, Type III, High Intensity, Devided Lighted, Type			
TYPE III	Barricade, Type III, High Intensity, Double Sided, Lighted, Oper Barricade, Type III, High Intensity, Double Sided, Lighted, Oper			
	Barricade, Type III, High Intensity, Double Sided, Lighted, Oper			

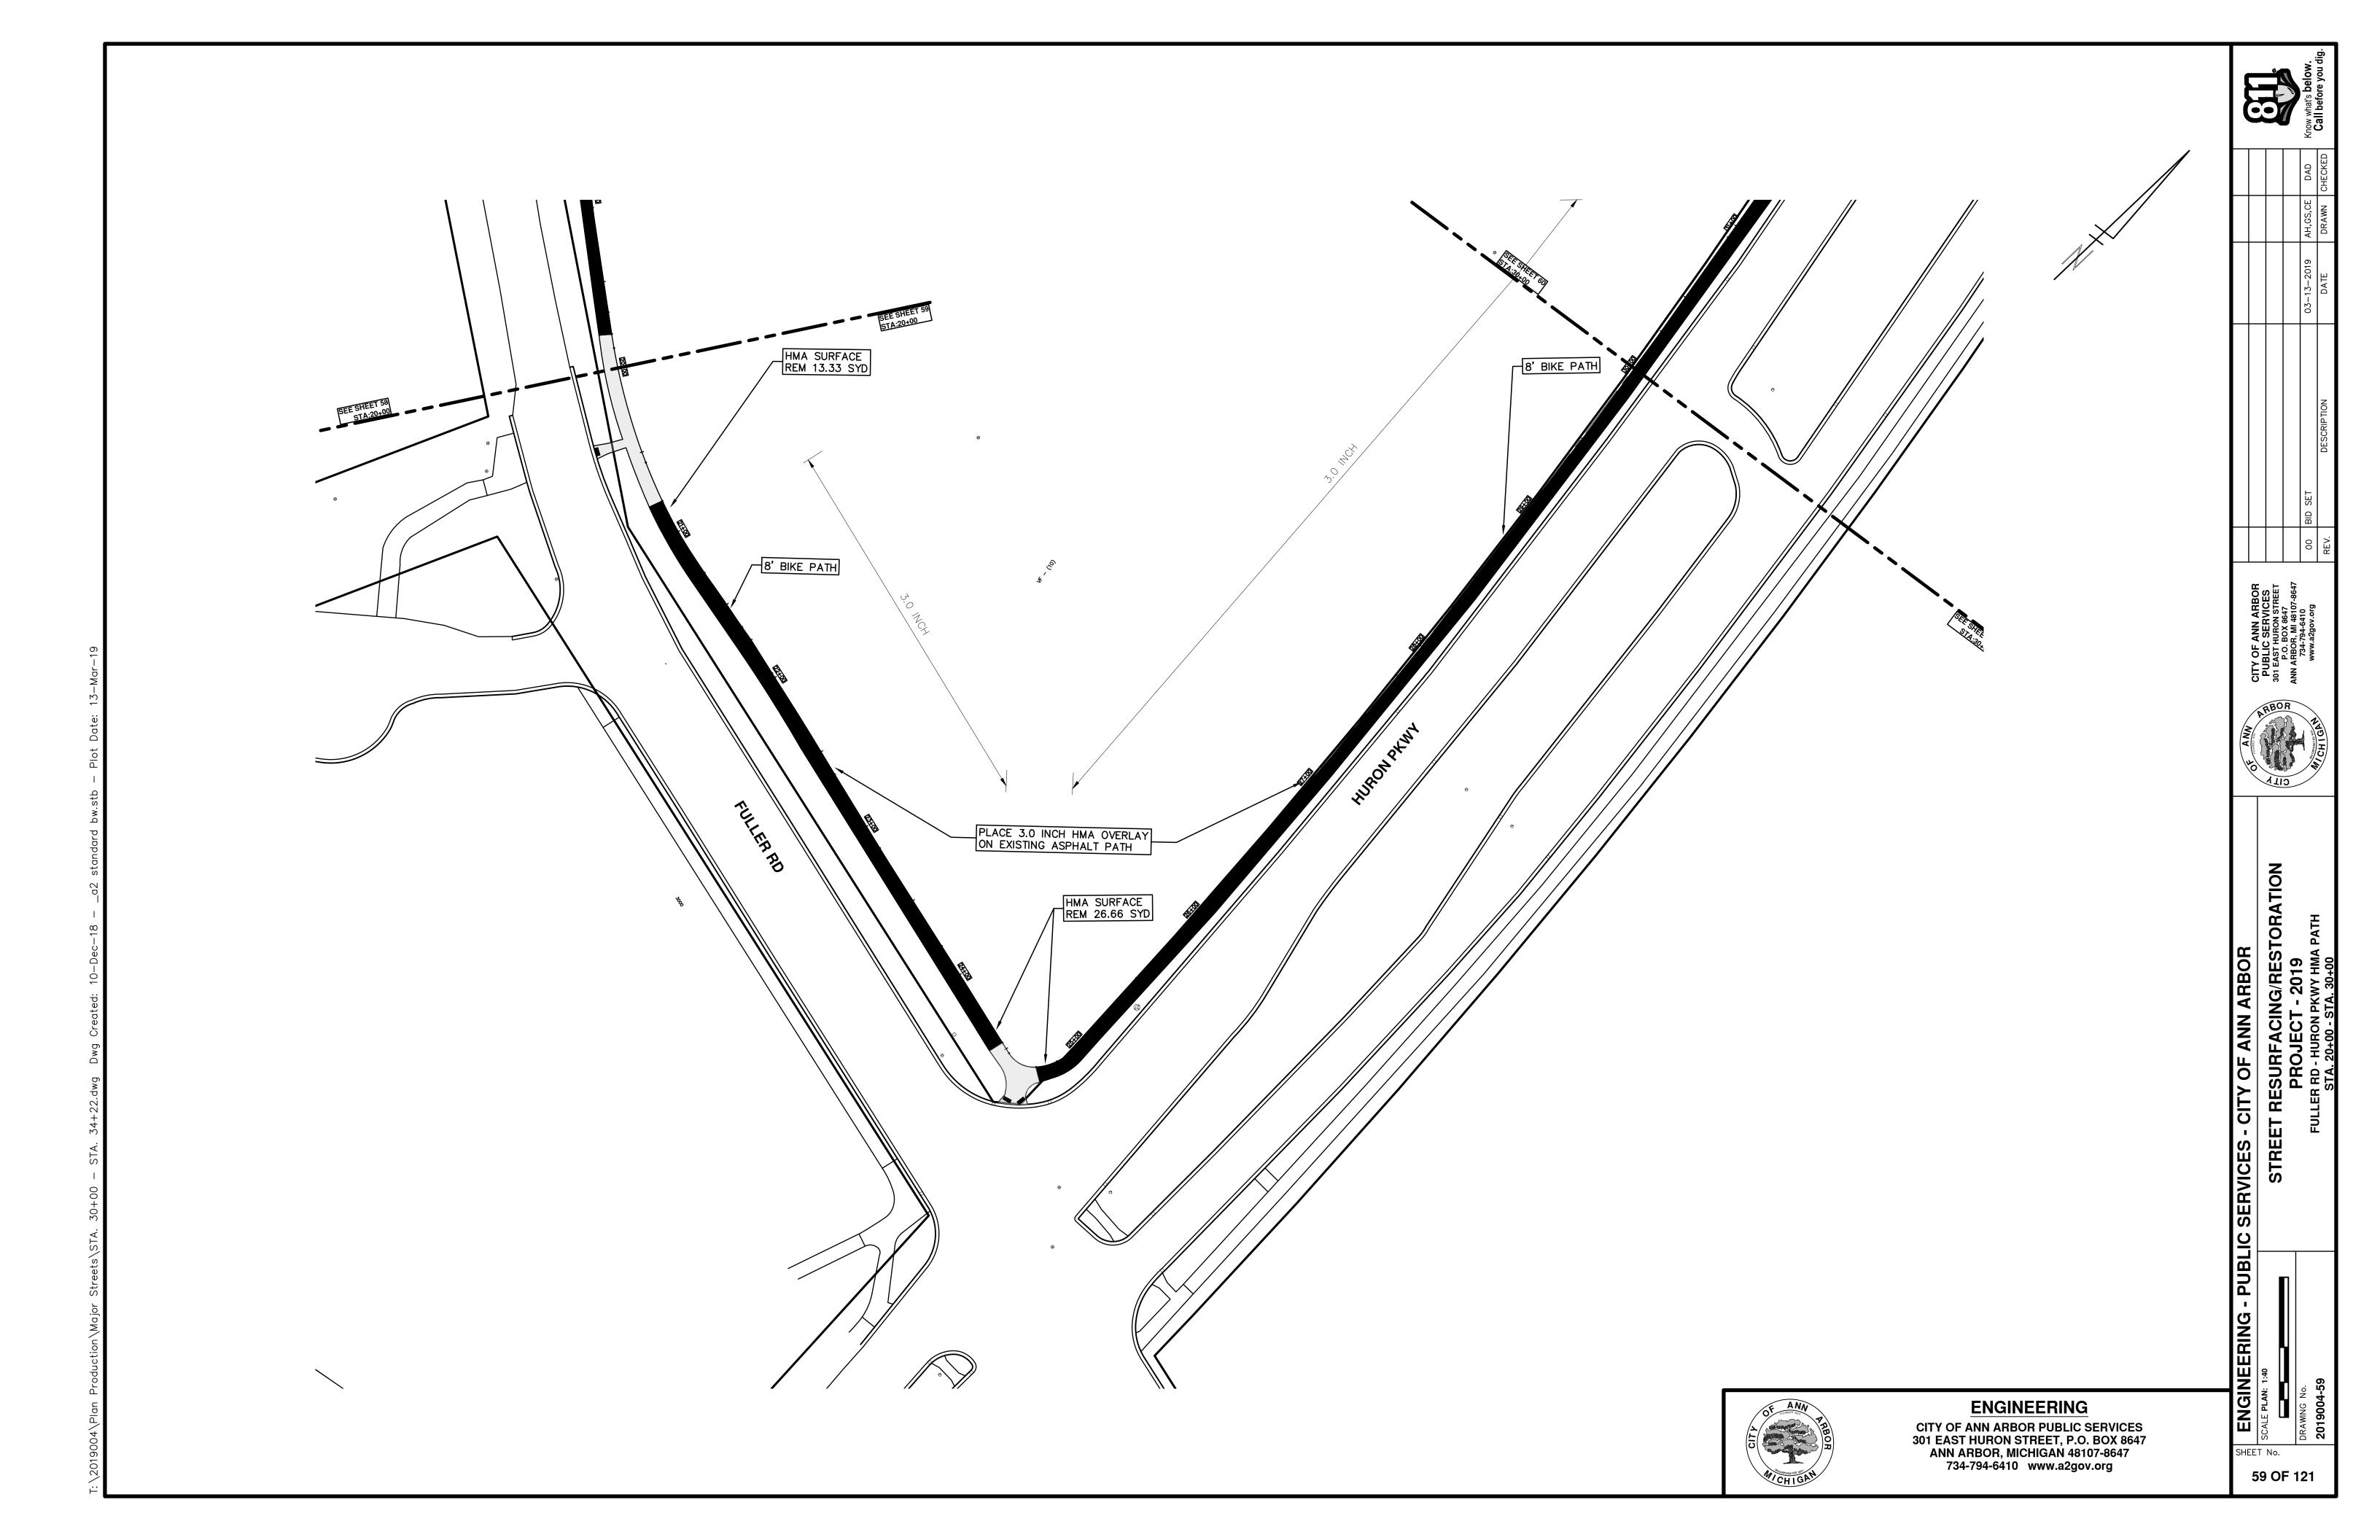ITB No. 4570 FILE No. 2019004

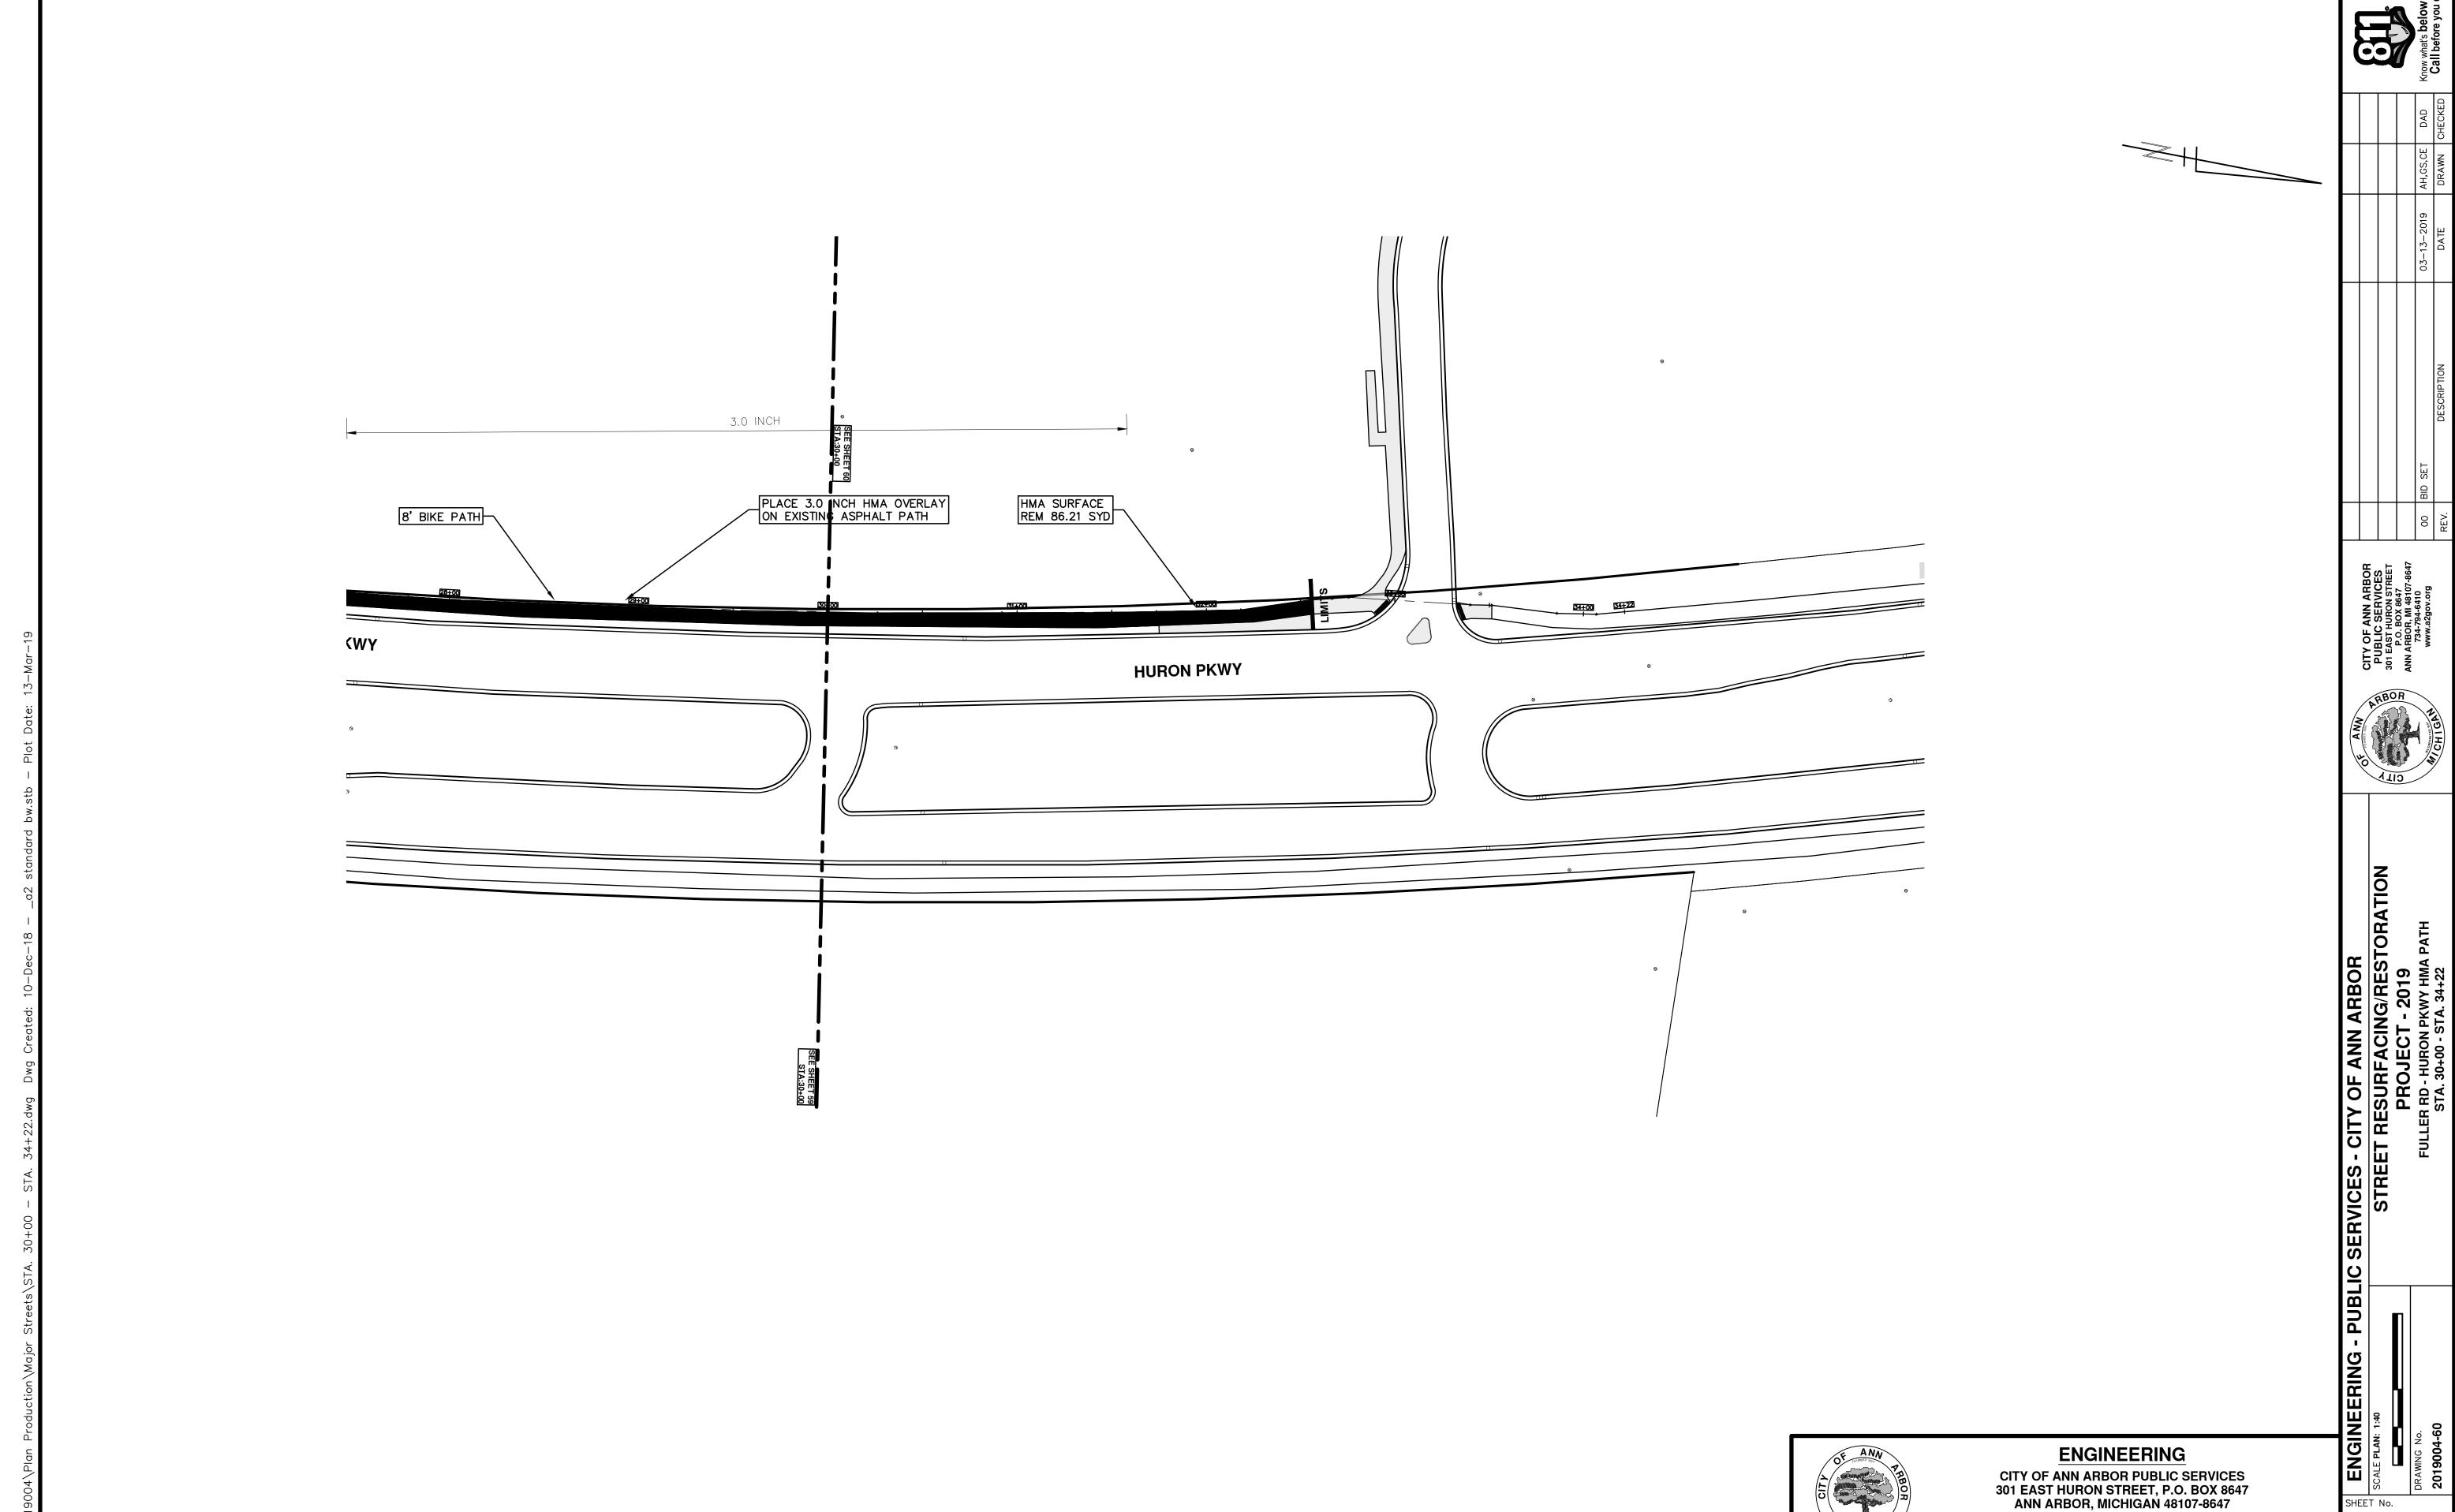NOTES

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ENGINEERING

CITY OF ANN ARBOR PUBLIC SERVICES 301 EAST HURON STREET, P.O. BOX 8647 ANN ARBOR, MICHIGAN 48107-8647 734-794-6410 www.a2gov.org AD Know what's below.

Call before you dig.

00 BID SET 03–13–2019 AH,GS,CE DAD PEV. DESCRIPTION DATE DRAWN CHECKE

ITY OF ANN ARBOF PUBLIC SERVICES 01 EAST HURON STREET P.O. BOX 8647 NN ARBOR, MI 48107-864 734-794-6410 www.a2gov.org





Y OF ANN ARBOR
ESURFACING/RESTORATION
PROJECT - 2019
PLATT ROAD
SLIBSET COVER SHEET


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INFERING - PUBLIC


SHEET No. **61 OF 121**




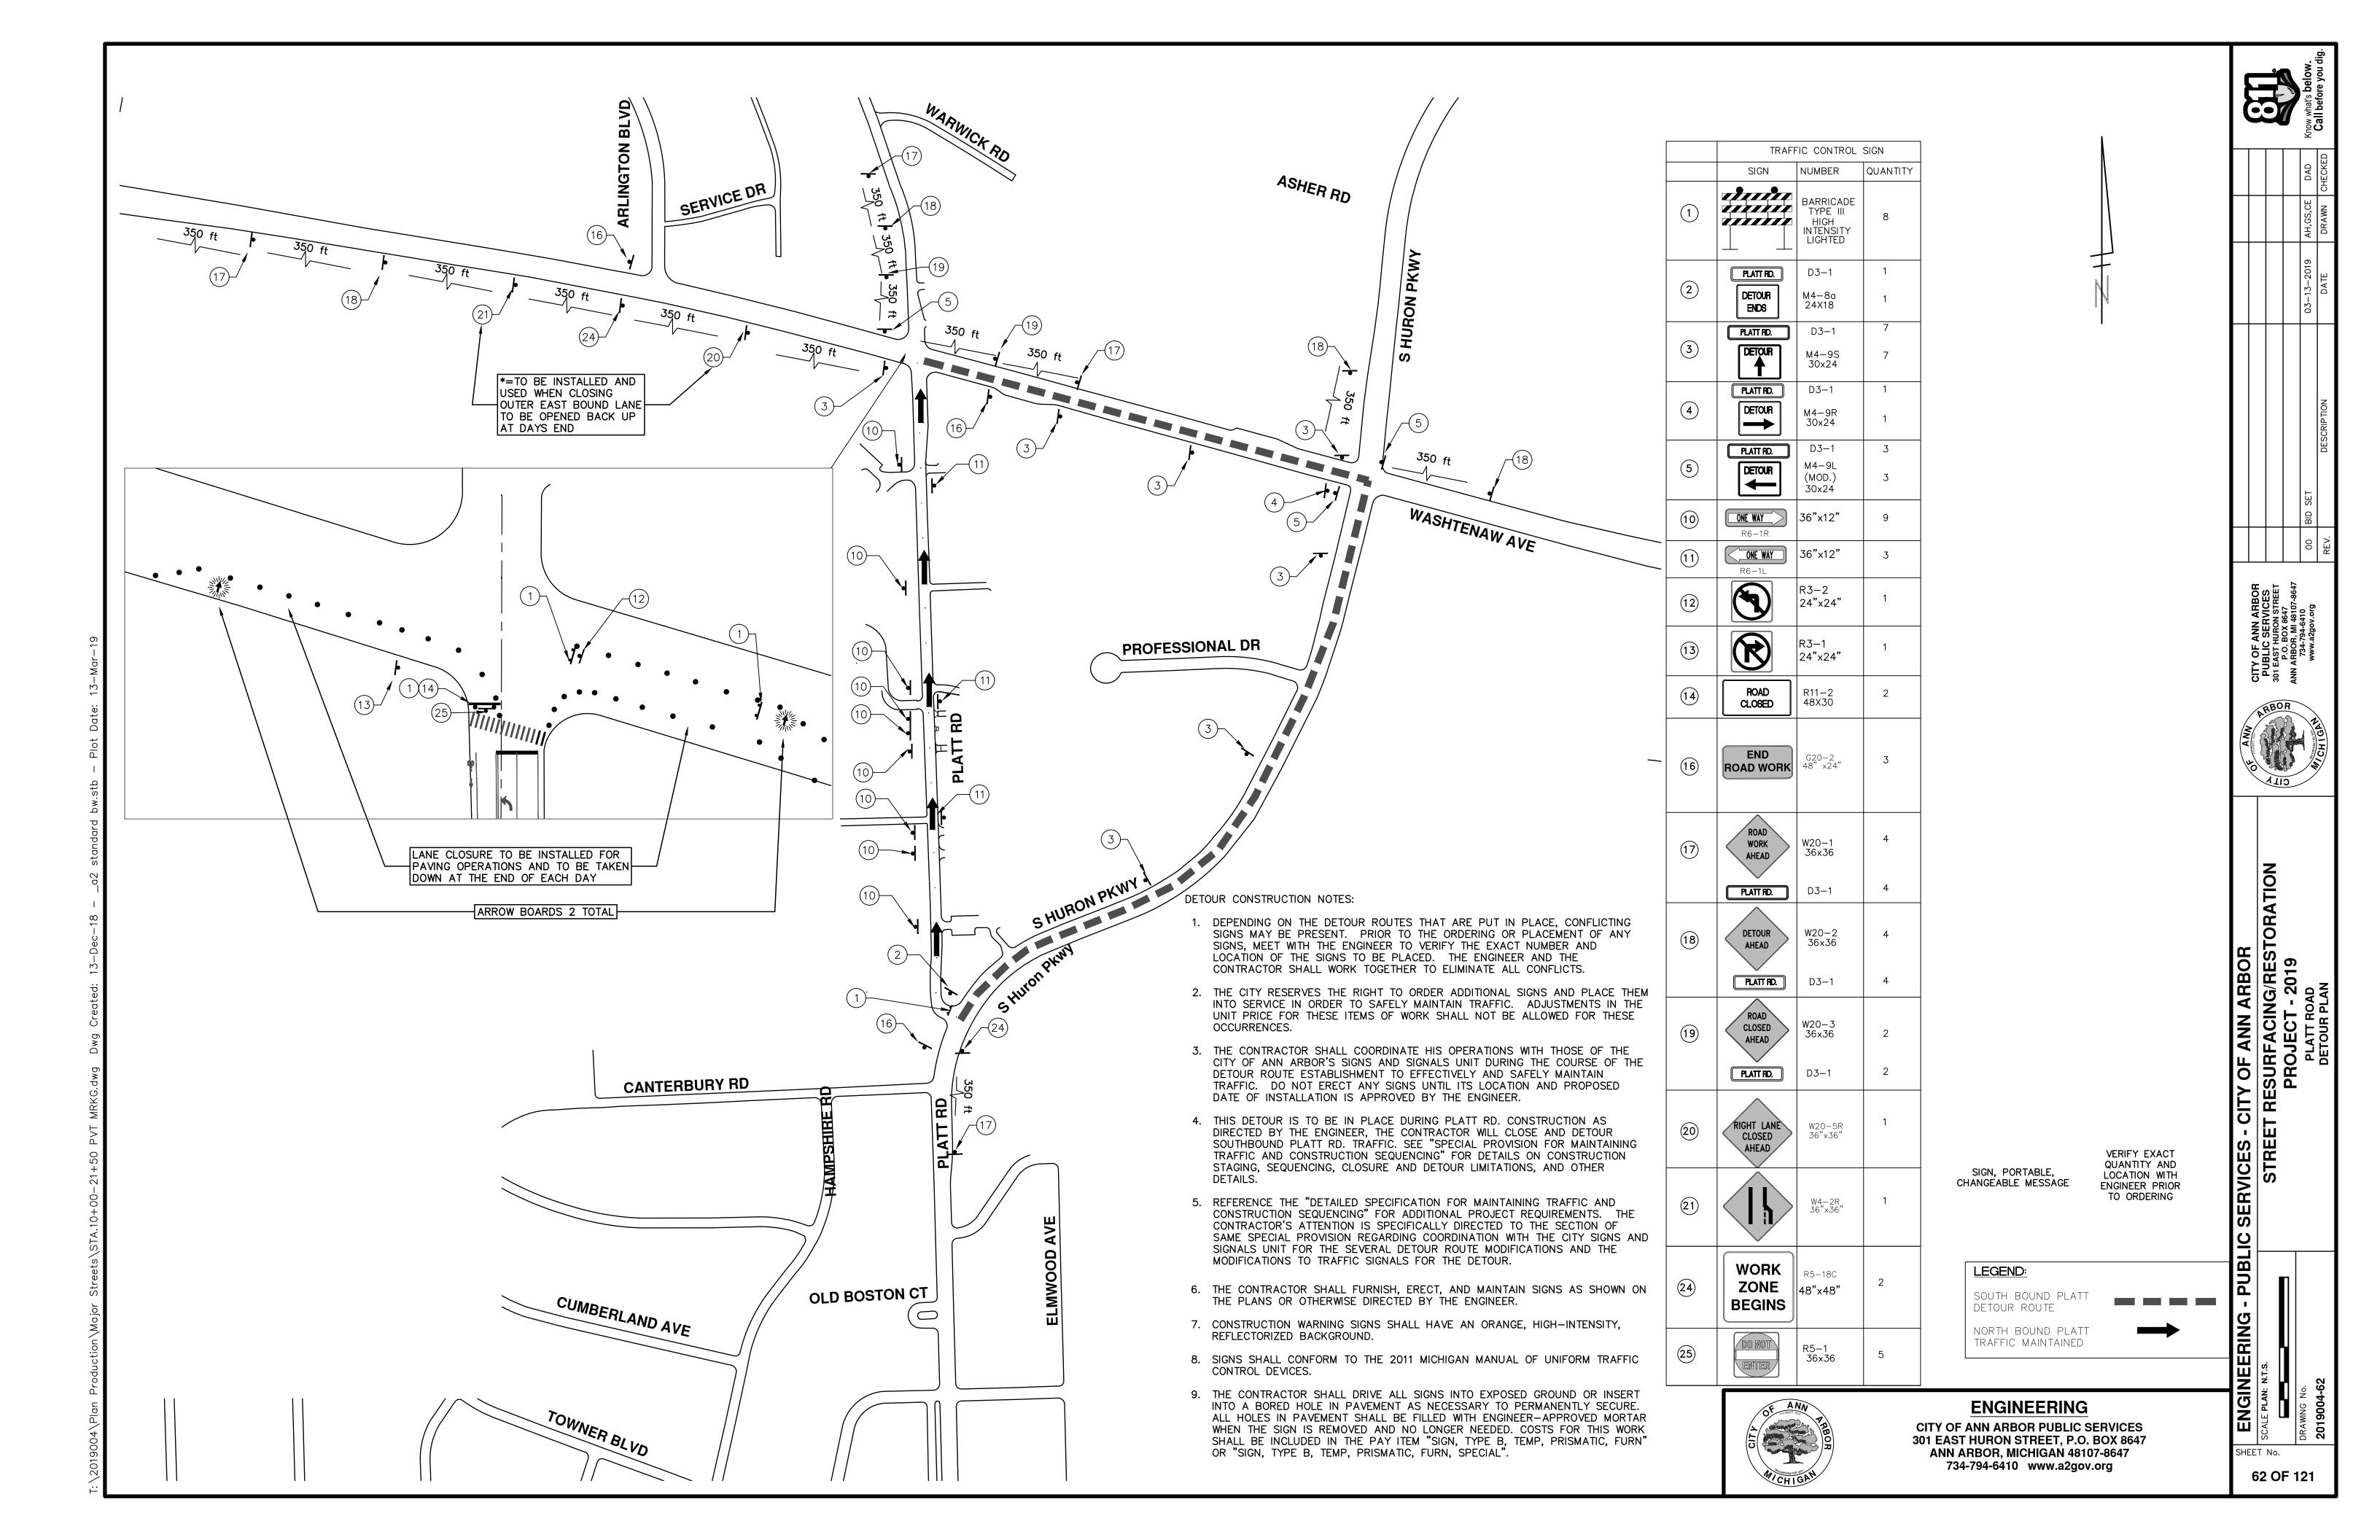

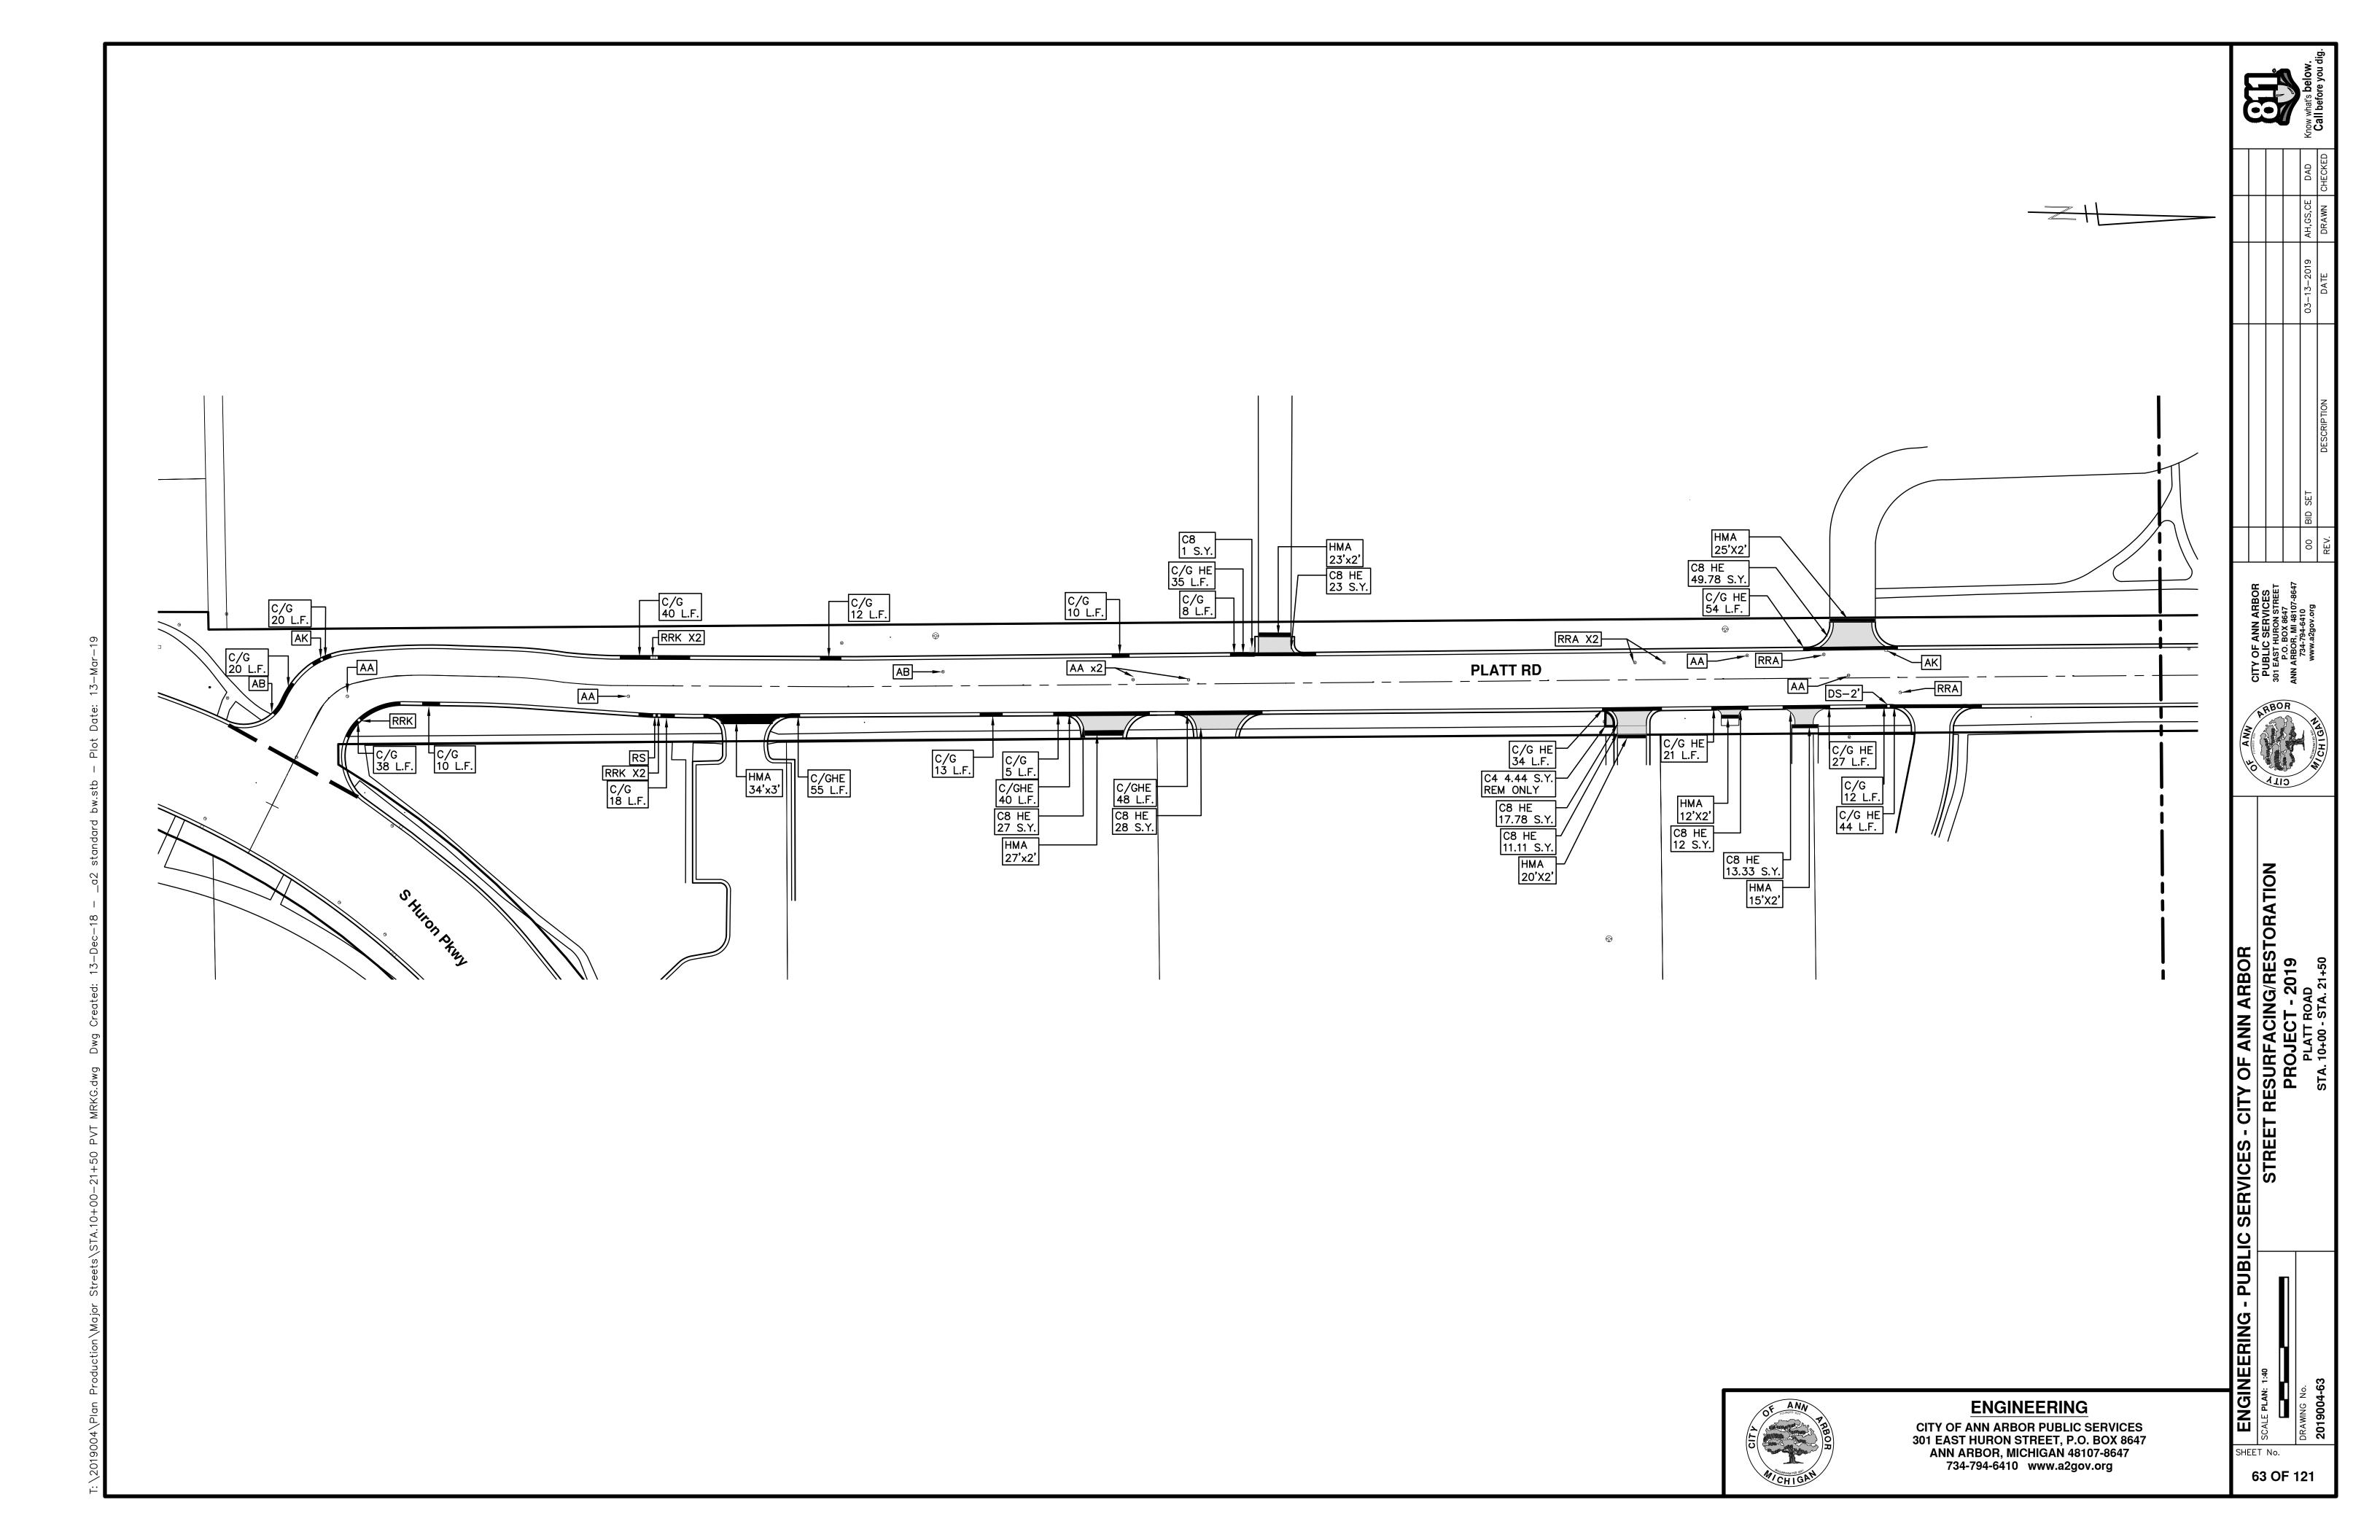

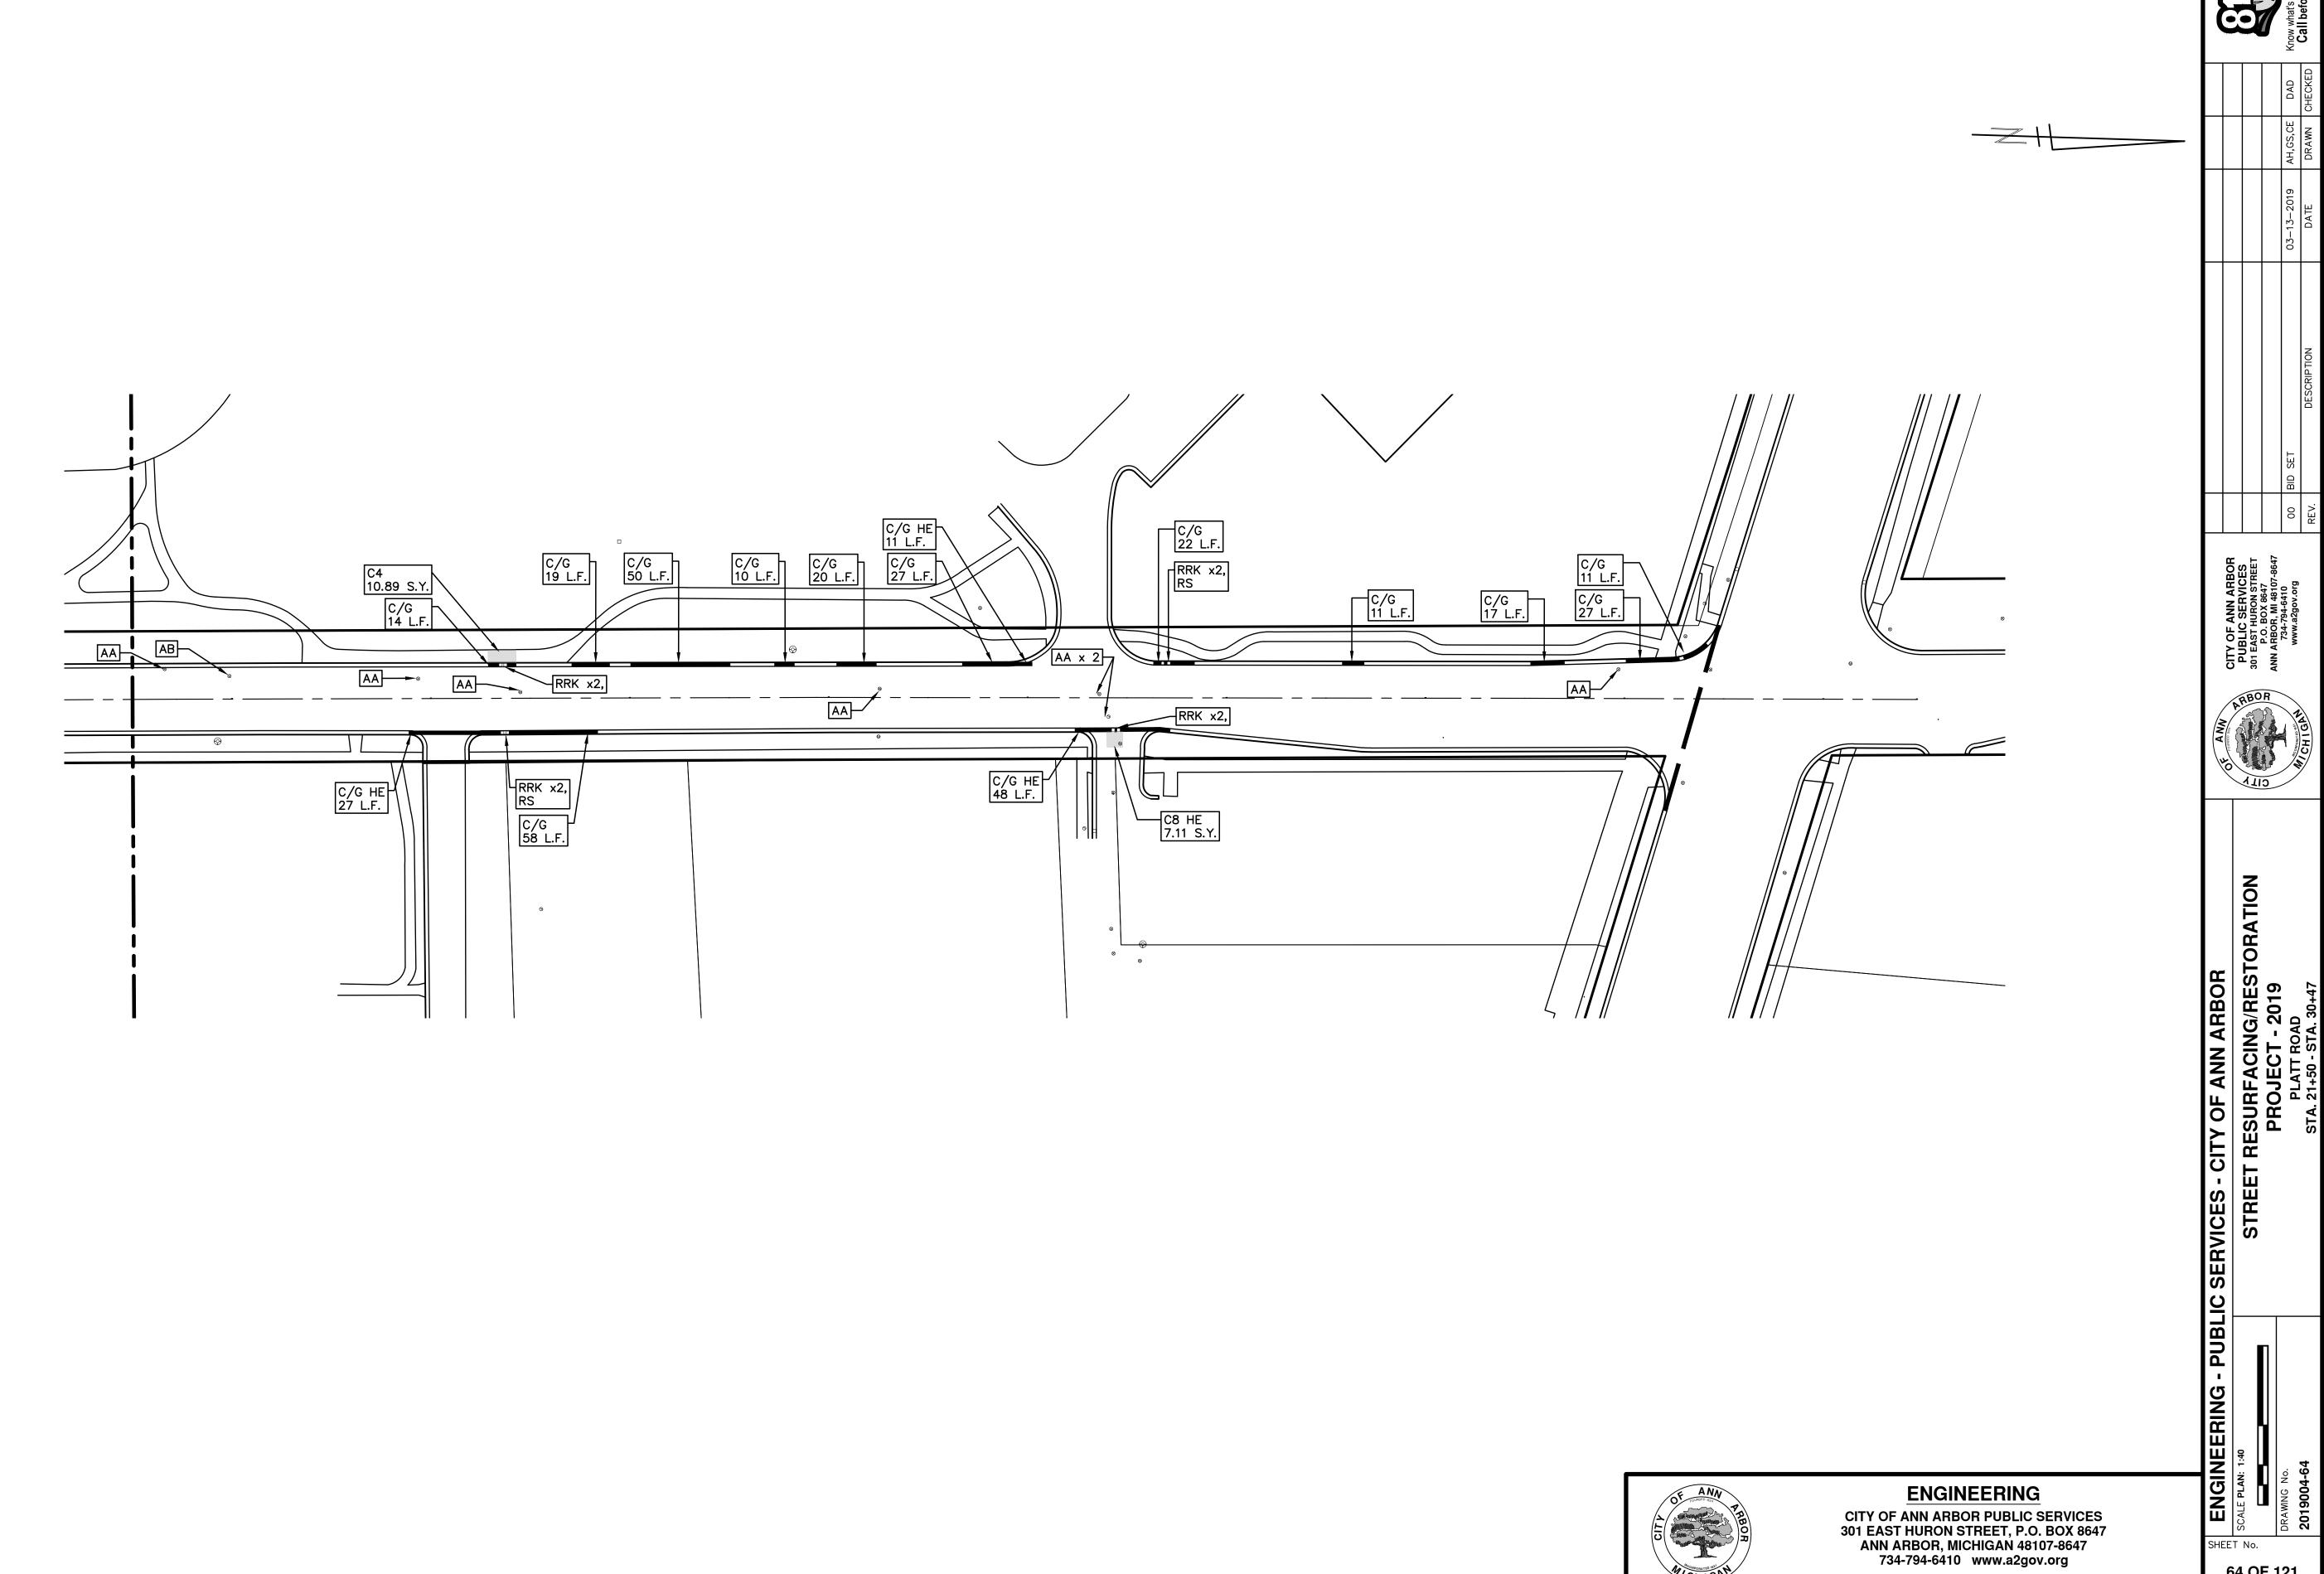

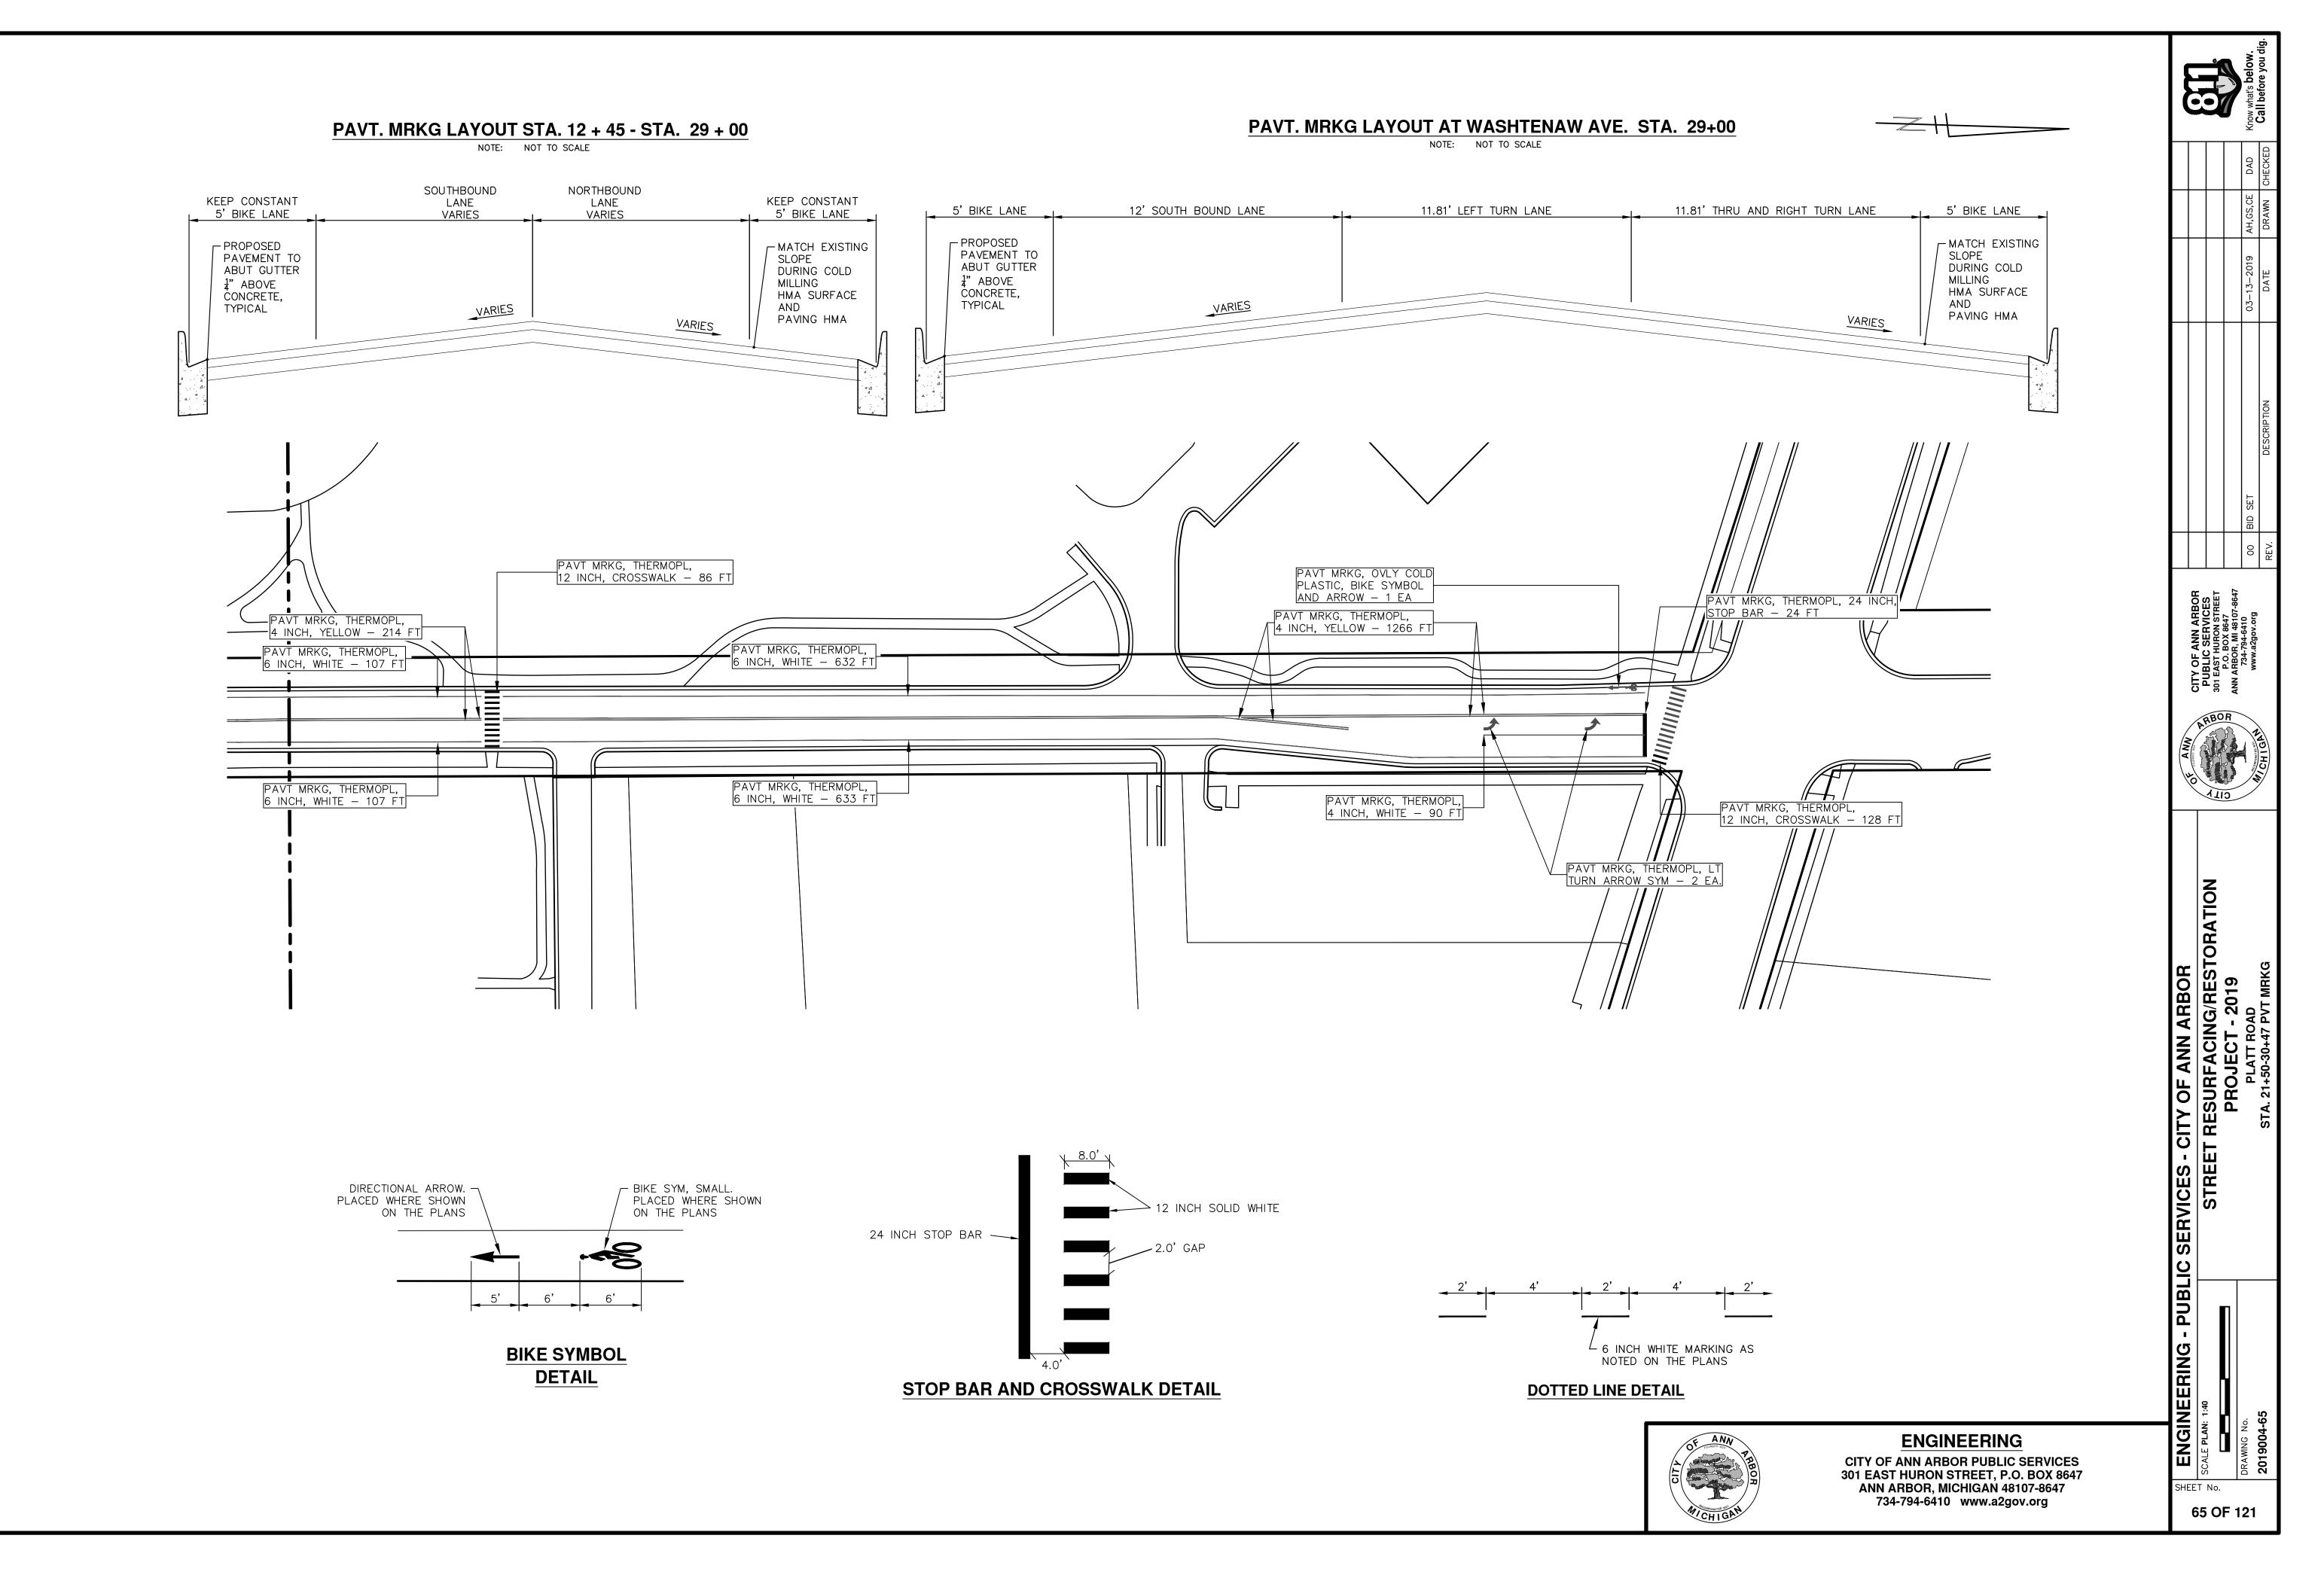

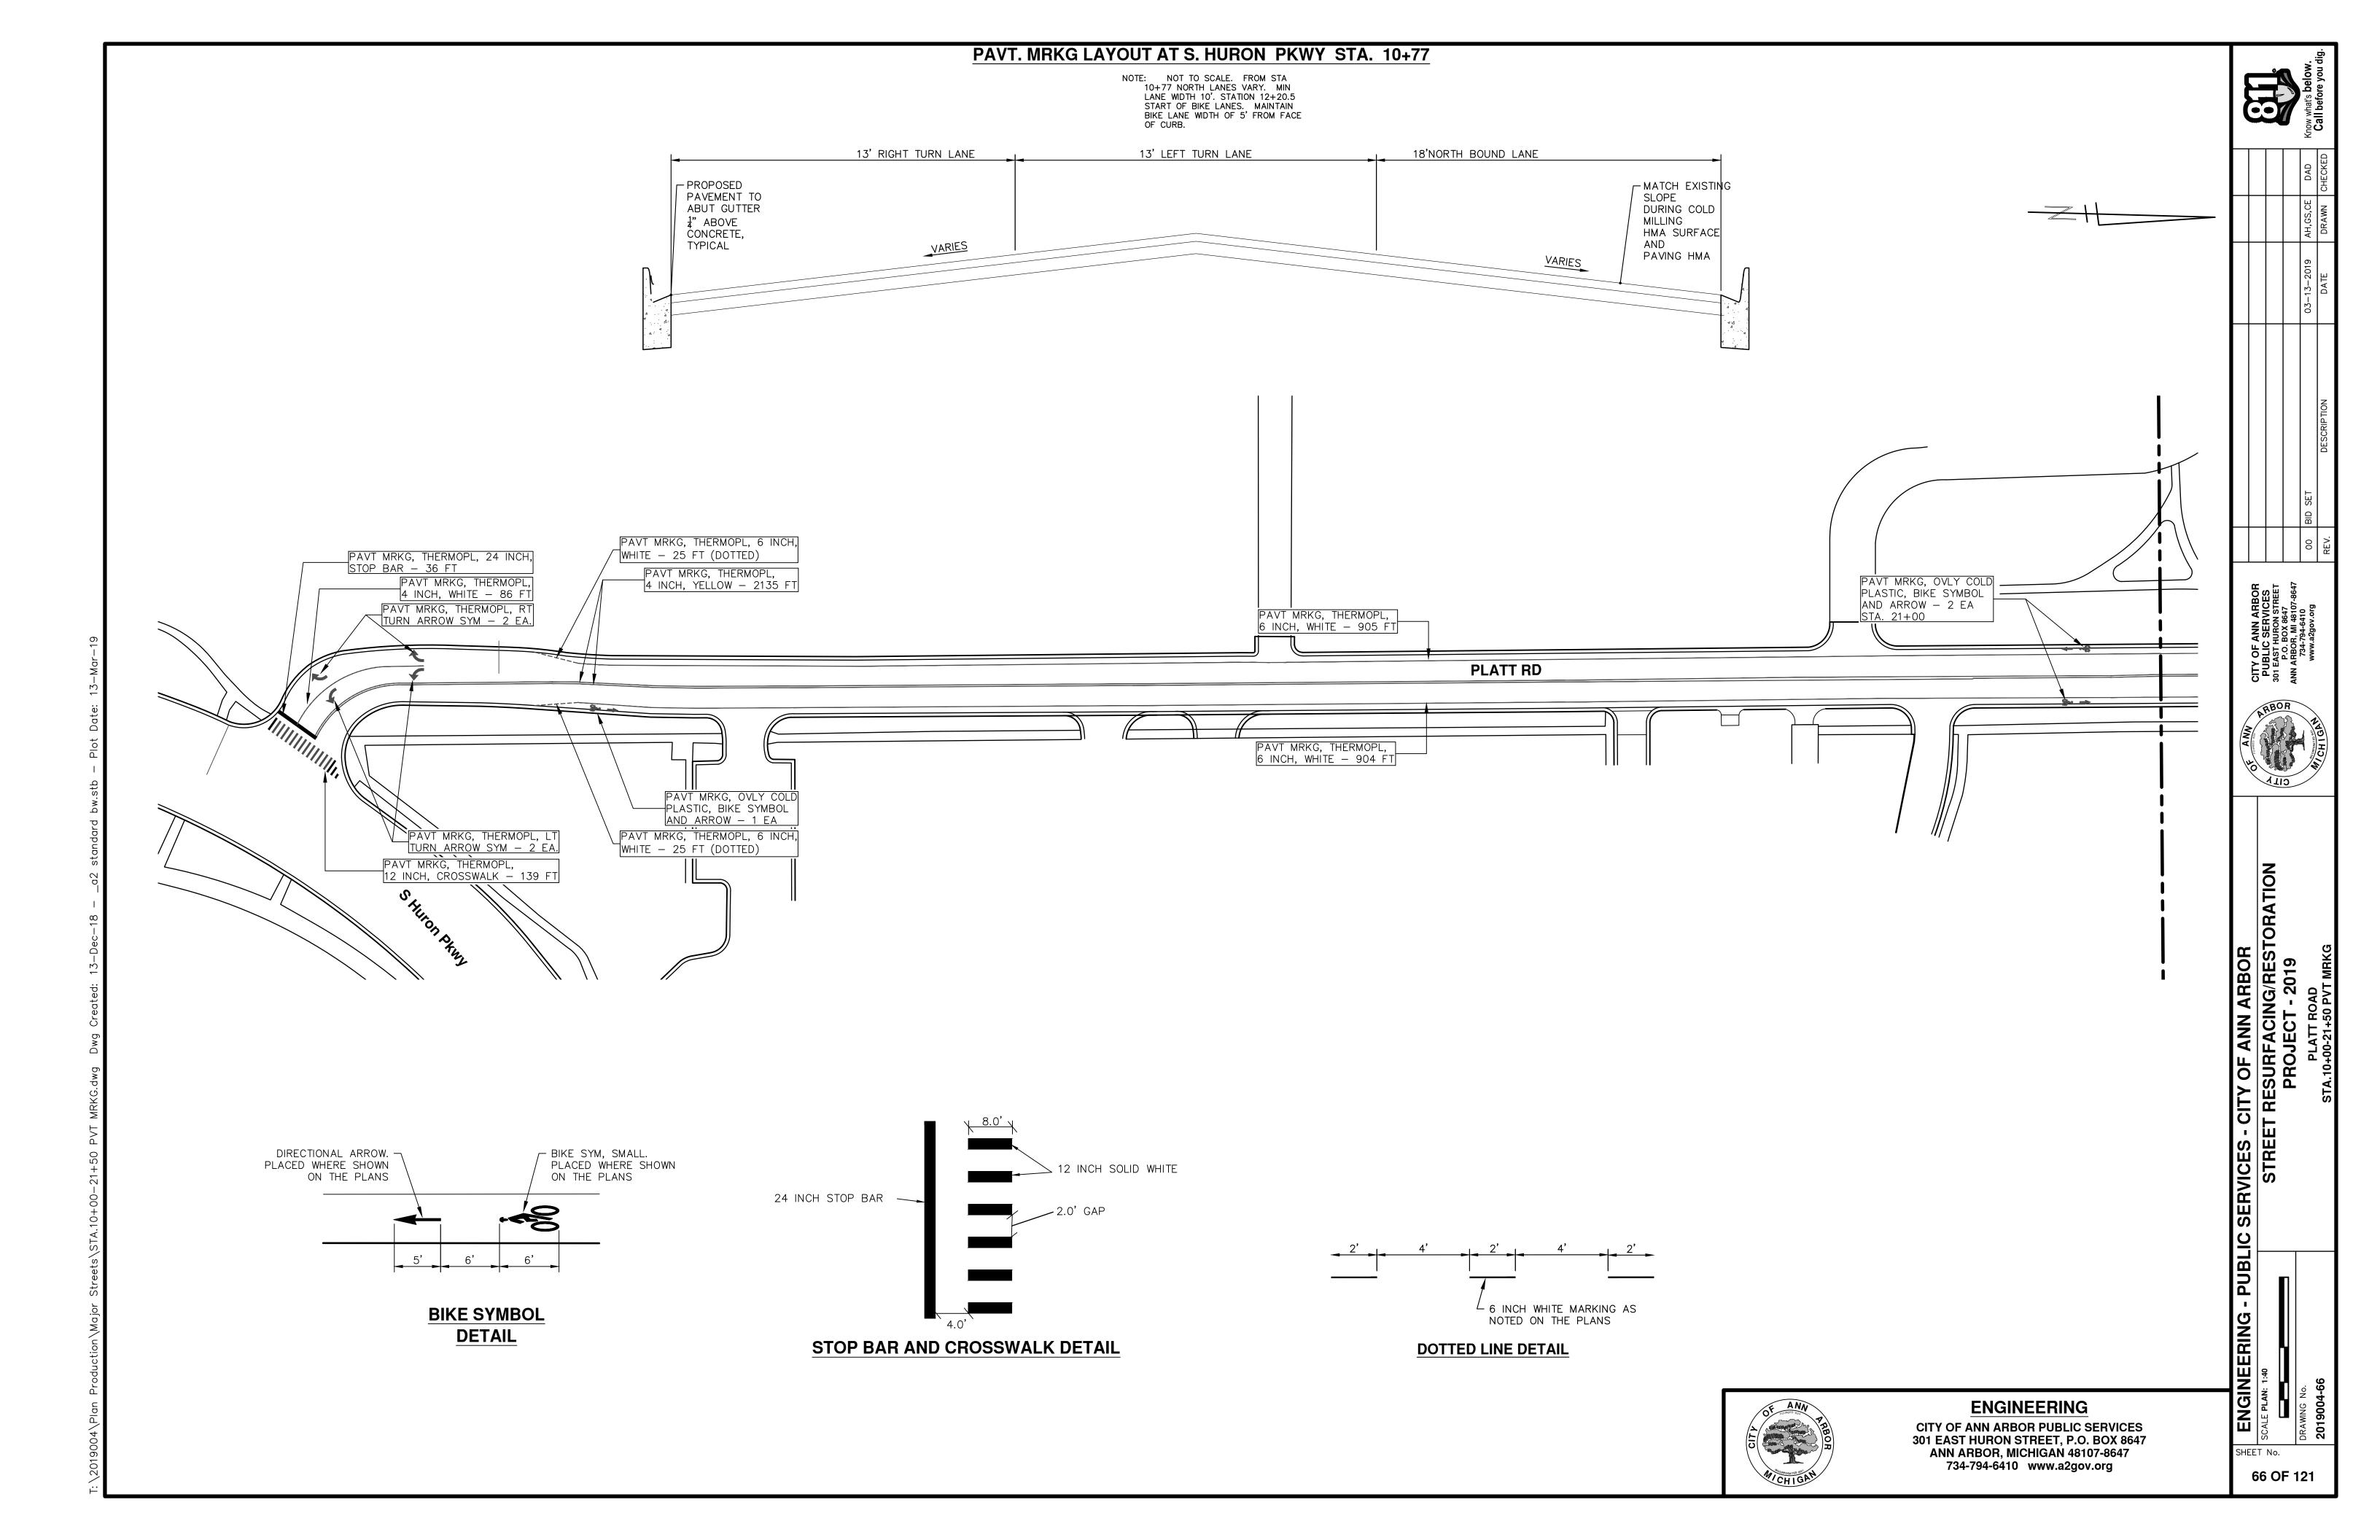



CITY OF ANN ARBOR ENGINEERING PROJECT LOCATION: S. DIVISION STREET

ITB No. 4570 FILE No. 2019004

	CONSTRUCTION KEY			
KEY	ASSOCIATED PAY ITEM(S)			
	• _Dr Structure, Adj, Case 1, Modified			
AA	• _Dr Structure, Adj, Case 2, Modified			
	• _Dr Structure, Temp Lowering, Modified			
	• _Dr Structure, Temp Lowering, Modified			
AB	• _Gate Box, Adj, Case 1			
Ab	• _Gate Box, Adj, Case 2			
	Monument Box Adjust			
ADST	• _Dr Structure, Adj, Add Depth, Modified			
AK	• _Dr Structure, Adj, Case 1, Modified			
	• _Sidewalk, Sidewalk Ramp, and Driveway Approach, Any Thickness, Rem			
C4	• _Grading, Sidewalk			
	• _Sidewalk, Conc, 4 inch, Modified			
	• _Sidewalk, Sidewalk Ramp, and Driveway Approach, Any Thickness, Rem			
C4HE	• _Grading, Sidewalk			
C4HE	• Cement			
	• _Sidewalk, Conc, 4 inch, Modified			
	• _Sidewalk, Sidewalk Ramp, and Driveway Approach, Any Thickness, Rem			
	• _Grading, Sidewalk			
C6	• _Grading, Sidewalk Ramp			
Co	• _Detectable Warning Surface, Modified			
	• _Sidewalk Ramp, Conc, 6 inch, Modified			
	• _Sidewalk, Conc, 6 inch, Modified			
00	Grading, Driveway Approach			
C8	• _Driveway, Nonreinf Conc, 8 inch, Modified			
	• _Sidewalk, Sidewalk Ramp, and Driveway Approach, Any Thickness, Rem			
	Grading, Driveway Approach			
	Grading, Sidewalk			
	Grading, Sidewalk Ramp			
0.115	• Cement			
C HE	• _Driveway, Nonreinf Conc, 6 inch, Modified			
	Driveway, Nonreinf Conc, 8 inch, Modified			
	Detectable Warning Surface, Modified			
	Sidewalk Ramp, Conc, 6 inch, Modified			
	• _Sidewalk, Conc, 6 inch, Modified			
C/G	• _Curb, Gutter, and Curb and Gutter, Any Type, Rem			
C/G	• _Curb and Gutter, Conc			
	• _Curb, Gutter, and Curb and Gutter, Any Type, Rem			
C/GHE	Cement			
	• _Driveway Opening, Conc, Det M, Modified			
СР	• _Grading, Sidewalk			
OF	• _Sidewalk, Conc, 4 inch, Modified			
CR	• _Sidewalk, Sidewalk Ramp, and Driveway Approach, Any Thickness, Rem			
	Dr Structure, Rem			
DS	Sewer, Rem, Less than 24 inch			
	Dr Structure, 24 inch dia			
	Dr Structure, Rem			
DSDI	Sewer, Rem, Less than 24 inch			
	• _Dr Structure, Double Inlet			
PT	• _Dr Structure, Point			
RRA	Dr Structure Cover, Type B			
	• _Dr Structure Cover, Type B, Special			
	• _Dr Structure, Adj, Case 1, Modified			
	• _Dr Structure, Temp Lowering, Modified			
שמם	Dr Structure Cover, Type K			
RRK	• _Dr Structure, Adj, Case 1, Modified			
RS	• _Dr Structure, Reconstruct			
	Plastic Drum, High Intensity, Lighted, Furn			
TYPE II	Plastic Drum, High Intensity, Lighted, Oper			
D/D= ···	• Barricade Type III High Intensity Double Sided Lighted Furn			
TYPE III Barricade, Type III, High Intensity, Double Sided, Lighted, Furn • Barricade, Type III, High Intensity, Double Sided, Lighted, Oper				

PROJECT - 2019
S. DIVISION STREET
SLIBSET COVED SHEET

NOTES:

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ENGINEERING

CITY OF ANN ARBOR PUBLIC SERVICES 301 EAST HURON STREET, P.O. BOX 8647 ANN ARBOR, MICHIGAN 48107-8647 734-794-6410 www.a2gov.org



SHEET No. 67 OF 121

TRAFFIC CONTROL S			
	TRAFF	TIC CONTROL	SIGN
	SIGN	NUMBER	QUANTITY
1		BARRICADE TYPE III HIGH INTENSITY LIGHTED	0
	S. DIVISION ST	D3-1	1
2	DETOUR ENDS	M4-8a 24X18	1
	8. DIVISION ST	D3-1	6
3	DETOUR	M4-9S 30x24	6
	S. DIMSION ST	D3-1	0
4	DETOUR	M4-9R 30x24	0
	8. DMSION ST	D3-1	0
5	DETOUR	M4-9L (MOD.) 30×24	0
	(S. DMSION ST	D3-1	0
6	DETOUR	M4-9R (MOD.) 30x24	0
	S. DIVISION ST	D3-1	0
(7)	DETOUR	M4-9L	
	—	(MOD.) 30x24	0
8	DETOUR	M4-10R 48x18	1
9	DETOUR	M4-10L 48x18	0
10	ONE WAY R6-1R	36"x12"	1
11)	ONE WAY R6-1L	36"x12"	0
12	3	R3-2 24"x24"	1
13)	R	R3-1 24"x24"	0
14)	ROAD CLOSED	R11-2 48X30	0
(15)	ROAD CLOSED TO THRU TRAFFIC	R11-4 60x30	0
16)	END ROAD WORK	G20-2 48" x24"	1
17)	ROAD WORK AHEAD	W20-1 36x36	3
	S. DWSION ST	D3-1	3
18)	DETOUR AHEAD	W20-2 36×36	2
	S. DWSION ST	D3-1	2
19)	ROAD CLOSED AHEAD	W20-3 36x36 D3-1	2
	<u></u>		
20)	RIGHT LANE CLOSED AHEAD	W20-5R 36"×36"	0
21)		W4-2R 36"×36"	0
			

DETOUR CONSTRUCTION NOTES:

- 1. DEPENDING ON THE DETOUR ROUTES THAT ARE PUT IN PLACE, CONFLICTING SIGNS MAY BE PRESENT. PRIOR TO THE ORDERING OR PLACEMENT OF ANY SIGNS, MEET WITH THE ENGINEER TO VERIFY THE EXACT NUMBER AND LOCATION OF THE SIGNS TO BE PLACED. THE ENGINEER AND THE CONTRACTOR SHALL WORK TOGETHER TO ELIMINATE ALL CONFLICTS.
- 2. THE CITY RESERVES THE RIGHT TO ORDER ADDITIONAL SIGNS AND PLACE THEM INTO SERVICE IN ORDER TO SAFELY MAINTAIN TRAFFIC. ADJUSTMENTS IN THE UNIT PRICE FOR THESE ITEMS OF WORK SHALL NOT BE ALLOWED FOR THESE OCCURRENCES.
- 3. THE CONTRACTOR SHALL COORDINATE HIS OPERATIONS WITH THOSE OF THE CITY OF ANN ARBOR'S SIGNS AND SIGNALS UNIT DURING THE COURSE OF THE DETOUR ROUTE ESTABLISHMENT TO EFFECTIVELY AND SAFELY MAINTAIN TRAFFIC. DO NOT ERECT ANY SIGNS UNTIL ITS LOCATION AND PROPOSED DATE OF INSTALLATION IS APPROVED BY THE ENGINEER.
- 4. THIS DETOUR IS TO BE IN PLACE DURING S. DIVISION ST. CONSTRUCTION AS DIRECTED BY THE ENGINEER, THE CONTRACTOR WILL CLOSE AND DETOUR SOUTH BOUND S.DIVISION ST. TRAFFIC. SEE "SPECIAL PROVISION FOR MAINTAINING TRAFFIC AND CONSTRUCTION SEQUENCING" FOR DETAILS ON CONSTRUCTION STAGING, SEQUENCING, CLOSURE AND DETOUR LIMITATIONS, AND OTHER DETAILS.
- 5. REFERENCE THE "DETAILED SPECIFICATION FOR MAINTAINING TRAFFIC AND CONSTRUCTION SEQUENCING" FOR ADDITIONAL PROJECT REQUIREMENTS. THE CONTRACTOR'S ATTENTION IS SPECIFICALLY DIRECTED TO THE SECTION OF SAME SPECIAL PROVISION REGARDING COORDINATION WITH THE CITY SIGNS AND SIGNALS UNIT FOR THE SEVERAL DETOUR ROUTE MODIFICATIONS AND THE MODIFICATIONS TO TRAFFIC SIGNALS FOR THE DETOUR.
- 6. THE CONTRACTOR SHALL FURNISH, ERECT, AND MAINTAIN SIGNS AS SHOWN ON THE PLANS OR OTHERWISE DIRECTED BY THE ENGINEER.
- 7. CONSTRUCTION WARNING SIGNS SHALL HAVE AN ORANGE, HIGH-INTENSITY, REFLECTORIZED BACKGROUND.
- 8. SIGNS SHALL CONFORM TO THE 2011 MICHIGAN MANUAL OF UNIFORM TRAFFIC CONTROL DEVICES.
- 9. THE CONTRACTOR SHALL DRIVE ALL SIGNS INTO EXPOSED GROUND OR INSERT INTO A BORED HOLE IN PAVEMENT AS NECESSARY TO PERMANENTLY SECURE. ALL HOLES IN PAVEMENT SHALL BE FILLED WITH ENGINEER—APPROVED MORTAR WHEN THE SIGN IS REMOVED AND NO LONGER NEEDED. COSTS FOR THIS WORK SHALL BE INCLUDED IN THE PAY ITEM "SIGN, TYPE B, TEMP, PRISMATIC, FURN" OR "SIGN, TYPE B, TEMP, PRISMATIC, FURN, SPECIAL".

TRAFFIC CONTROL SIGN			
	SIGN	NUMBER	QUANTITY
22)	LEFT LANE CLOSED AHEAD	W20-5L 36"x36"	1
23)		W4-2L 36"x36"	0
24)	WORK ZONE BEGINS	R5–18C 48"x48"	6
25)	SOUTH BOUND 8. DWISION ST CLOSED AT HILL STREET FOLLOW DETOUR	SPECIAL 48x66	1
26)	SOUTH BOUND 8. DMSION ST CLOSED AT HLL STREET FOLLOW DETOUR	SPECIAL 48x66	1
27)	DO NOT ENTER	R5–1 36x36	0
SIGN, PORTABLE, CHANGEABLE MESSAGE		VERIFY EXACT QUANTITY AND LOCATION WITH ENGINEER PRIOR TO ORDERING	


LEGEND:

SOUTH BOUND S. DIVISION ST. DETOUR ROUTE

NORTH BOUND S. DIVISION ST. TRAFFIC MAINTAINED

S. DIVISION ST. WORK ZONE



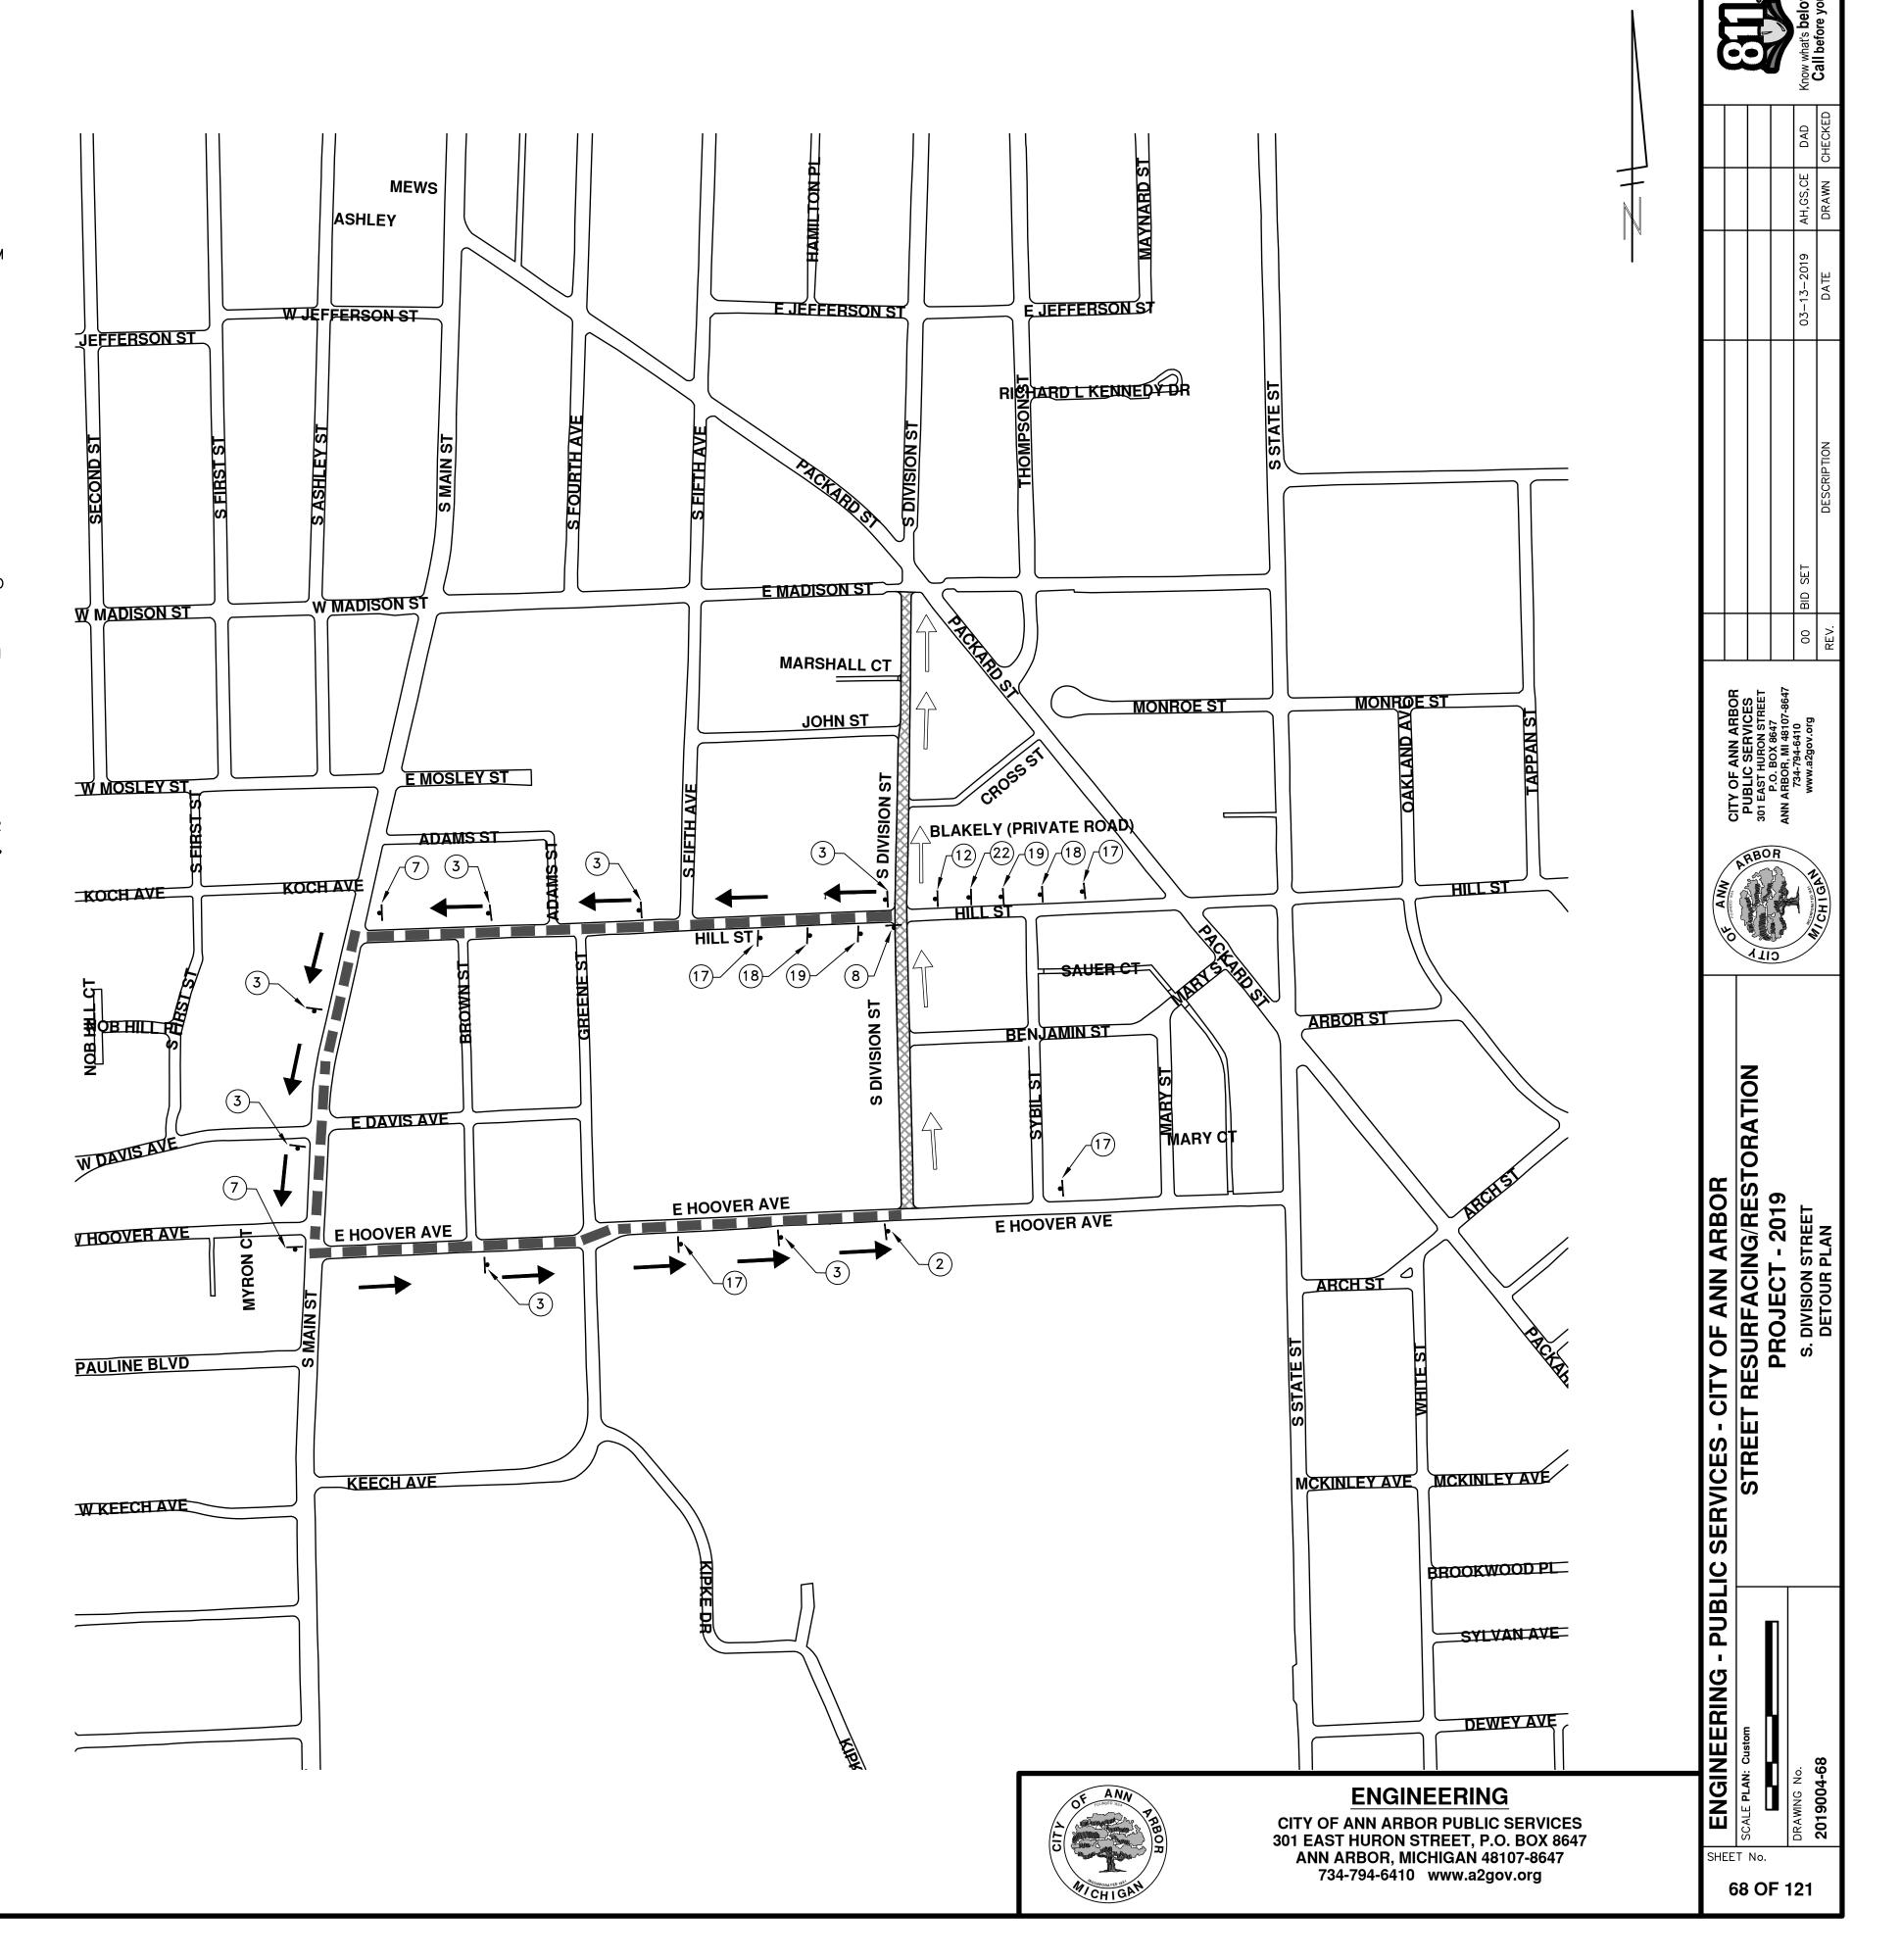

TRAFFIC CONTROL			
	TRAFF SIGN	NUMBER	SIGN QUANTITY
1		BARRICADE TYPE III HIGH INTENSITY LIGHTED	9
2	S. DMSION ST DETOUR	D3-1 M4-8a 24X18	1
	ENDS 8. DMSION ST	D3-1	6
3	DETOUR 1	M4-9S 30x24	6
	(S. DIMSION ST	D3-1	0
4)	DEION DEION	M4-9R 30x24	0
5	8. DMSION ST DETOUR	D3-1 M4-9L (MOD.) 30x24	0
_	S. DIVISION ST	D3-1	0
6	DETOUR	M4-9R (MOD.) 30×24	0
(7)	8. DIVISION ST DETOUR	D3-1 M4-9L	0
(7)		(MOD.) 30x24	0
8	DETOUR	M4-10R 48x18	0
9	DETOUR	M4-10L 48x18	0
10	ONE WAY R6-1R	36"x12"	1
11)	ONE WAY R6-1L	36"x12"	0
12		R3-2 24"x24"	2
13)	R	R3–1 24"x24"	0
14)	ROAD CLOSED	R11-2 48X30	1
(15)	ROAD CLOSED TO THRU TRAFFIC	R11-4 60x30	0
16	END ROAD WORK	G20-2 48" x24"	1
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	S. DIVISION ST	D3-1	3
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21)		W4-2R 36"x36"	0

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	SIGN	NUMBER	QUANTITY
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23)		W4-2L 36"x36"	0
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25)	SOUTH BOUND S. DMSION ST CLOSED AT HILL STREET FOLLOW DETOUR	SPECIAL 48x66	1
26)	SOUTH BOUND 8. DMISION ST CLOSED AT HILL STREET FOLLOW DETOUR	SPECIAL 48x66	1
27)	DO NOT ENTER	R5–1 36x36	1
SIGN, PORTABLE, CHANGEABLE MESSAGE		VERIFY EXACT QUANTITY AND LOCATION WITH ENGINEER PRIOR TO ORDERING	


LEGEND:


SOUTH BOUND S. DIVISION ST. DETOUR ROUTE

NORTH BOUND S. DIVISION ST. TRAFFIC MAINTAINED

S. DIVISION ST. WORK ZONE



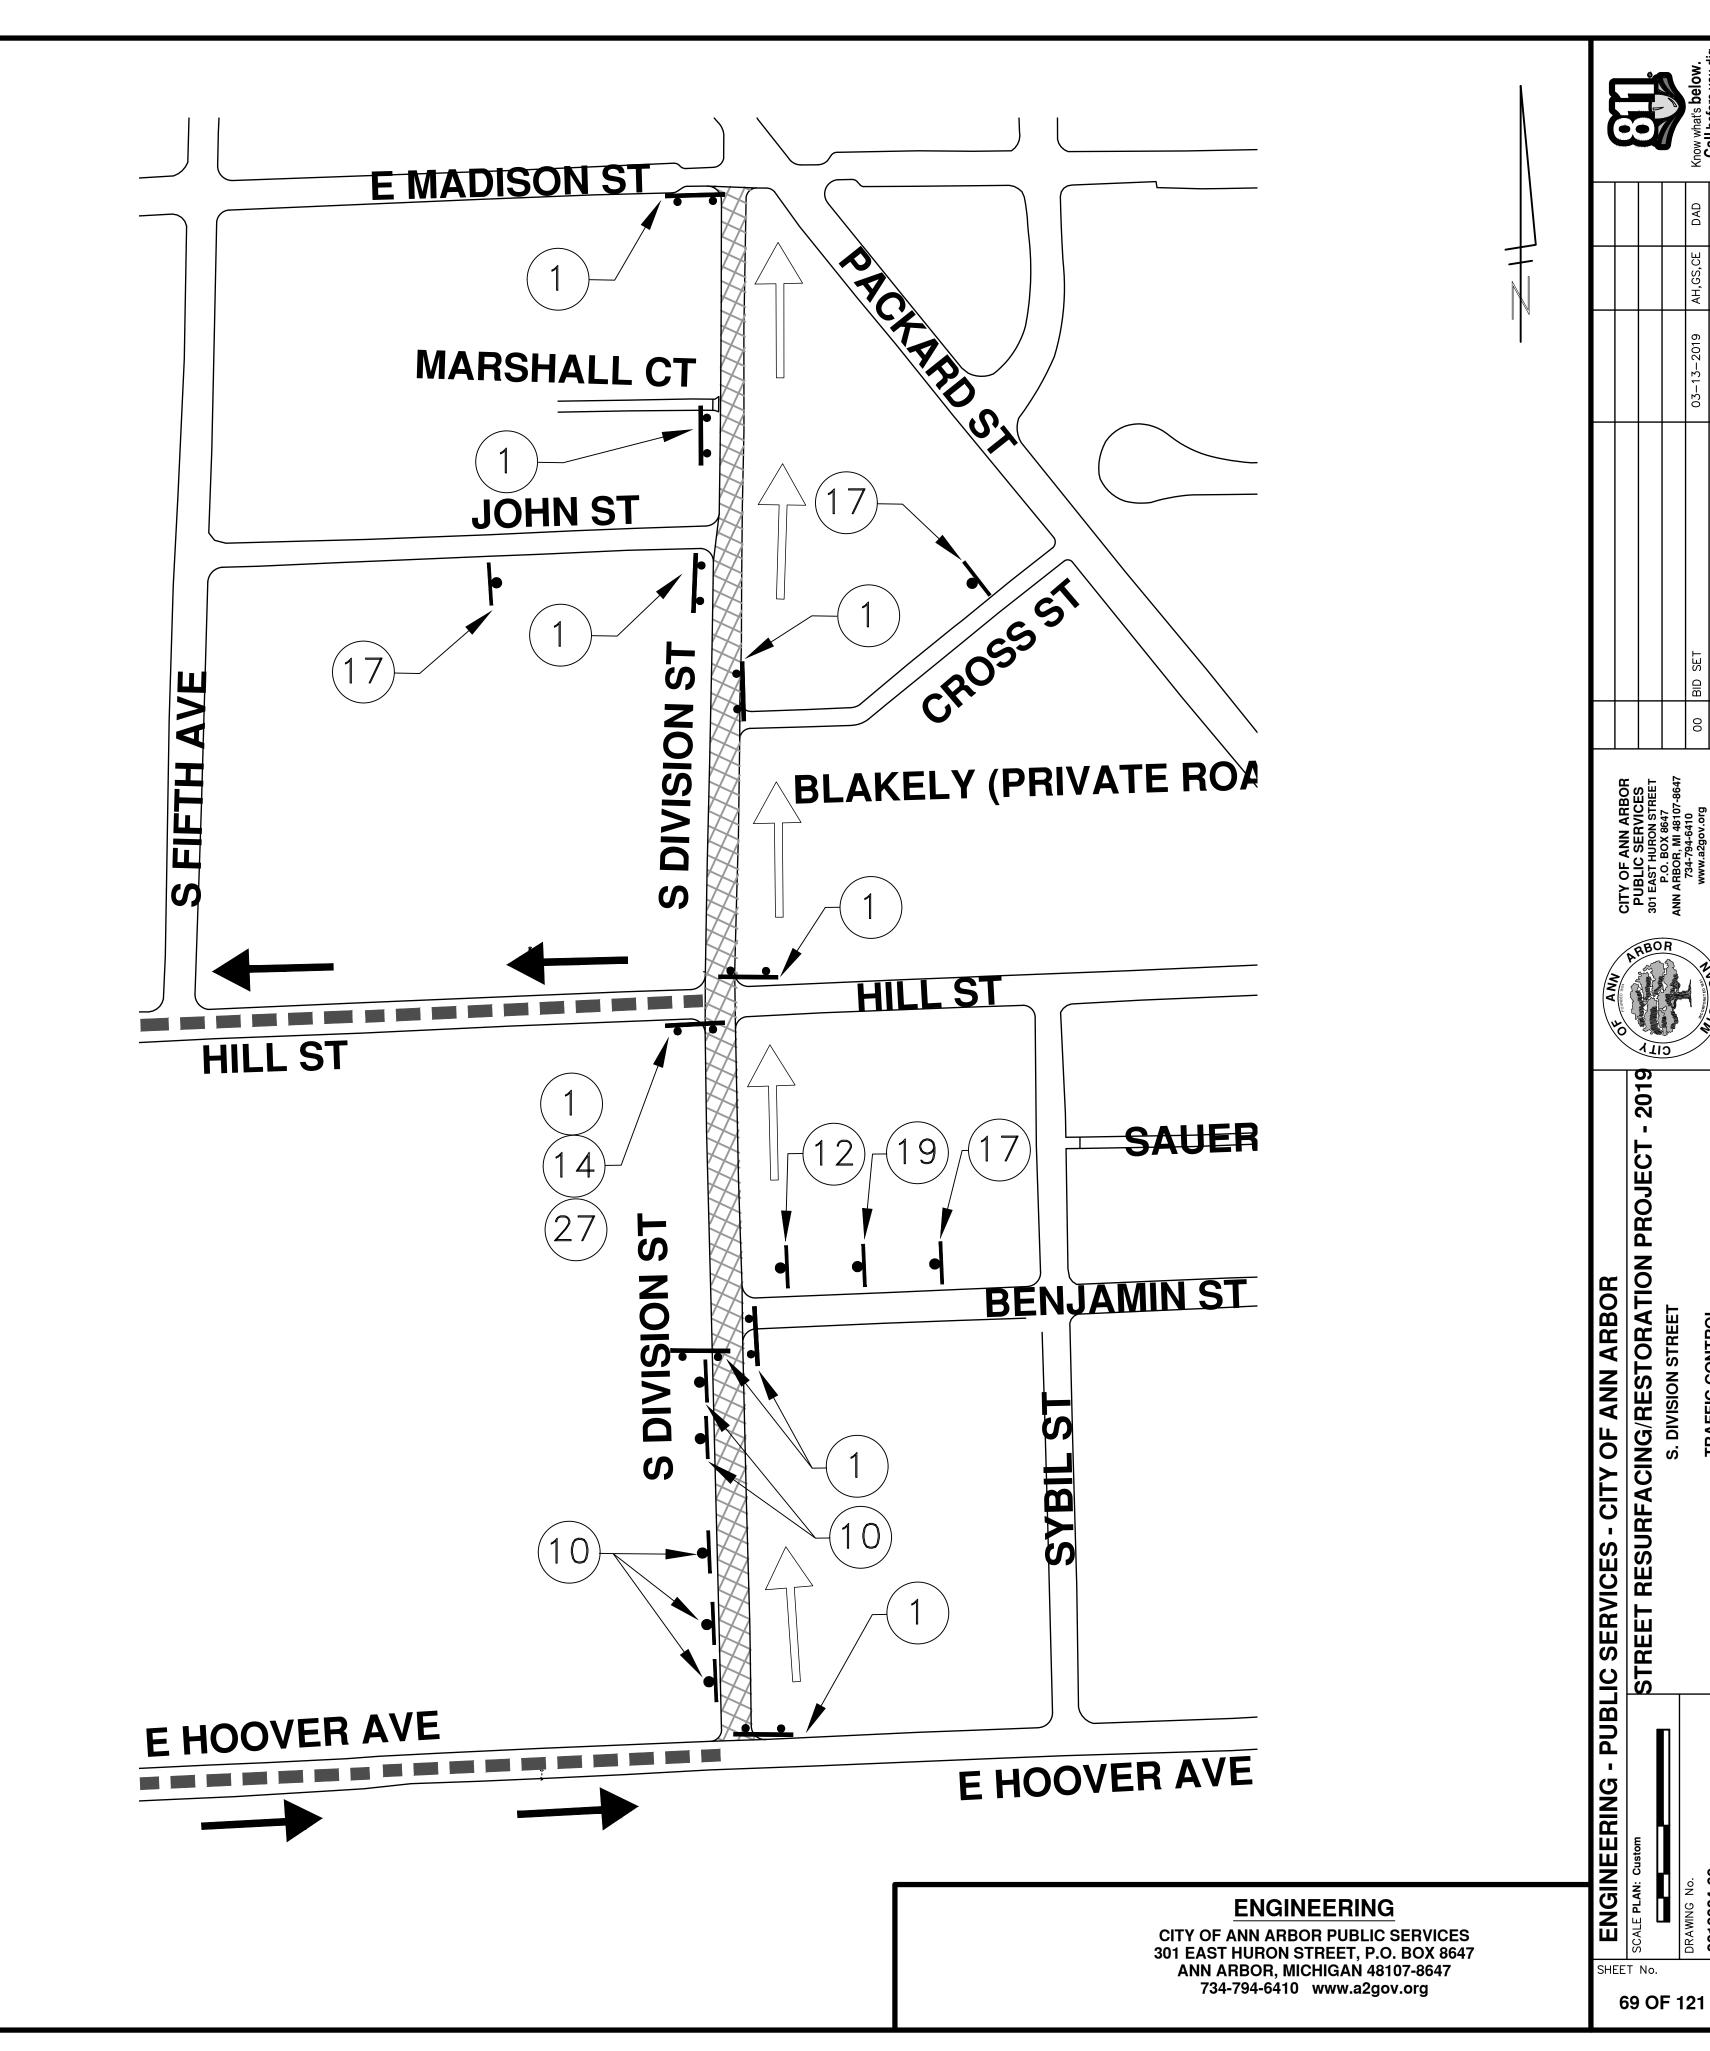

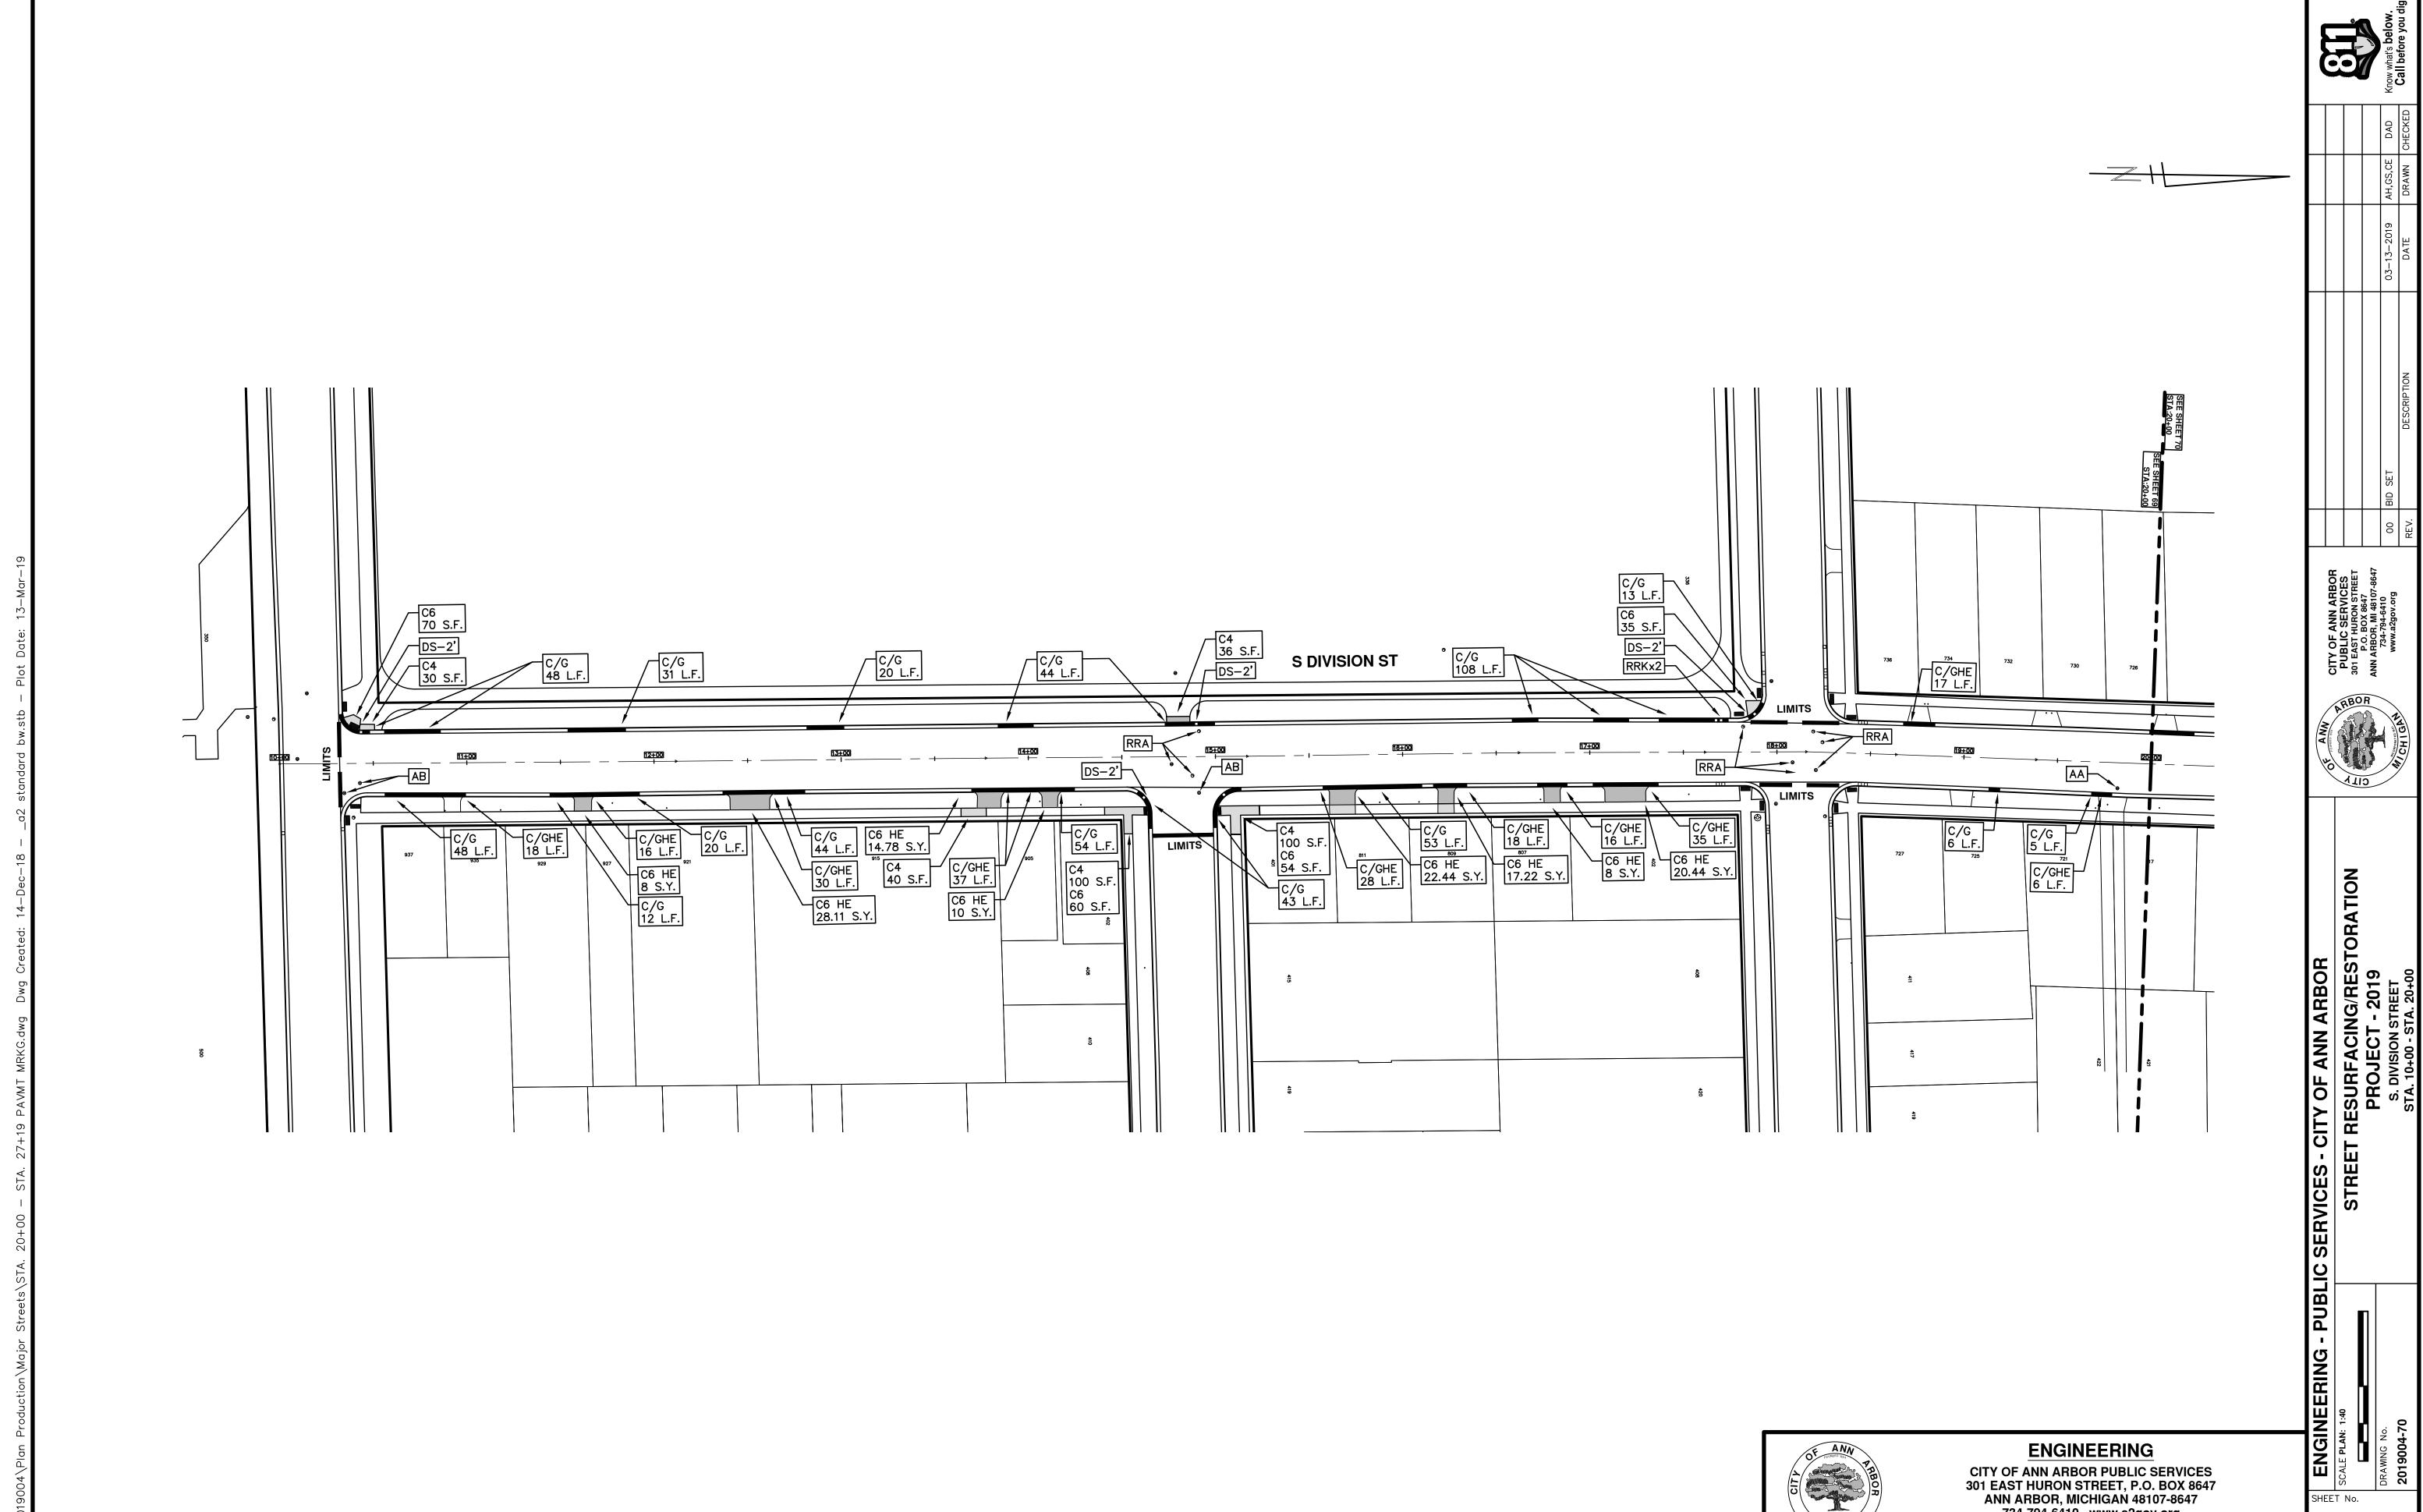

CITY OF ANN ARBOR PUBLIC SERVICES 301 EAST HURON STREET, P.O. BOX 8647 ANN ARBOR, MICHIGAN 48107-8647 734-794-6410 www.a2gov.org





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ENGINEERING - PUBLIC SERVICES - CITY OF ANN ARBOR

SCALE PLAN: 1:40

SCALE PLAN: 1:40


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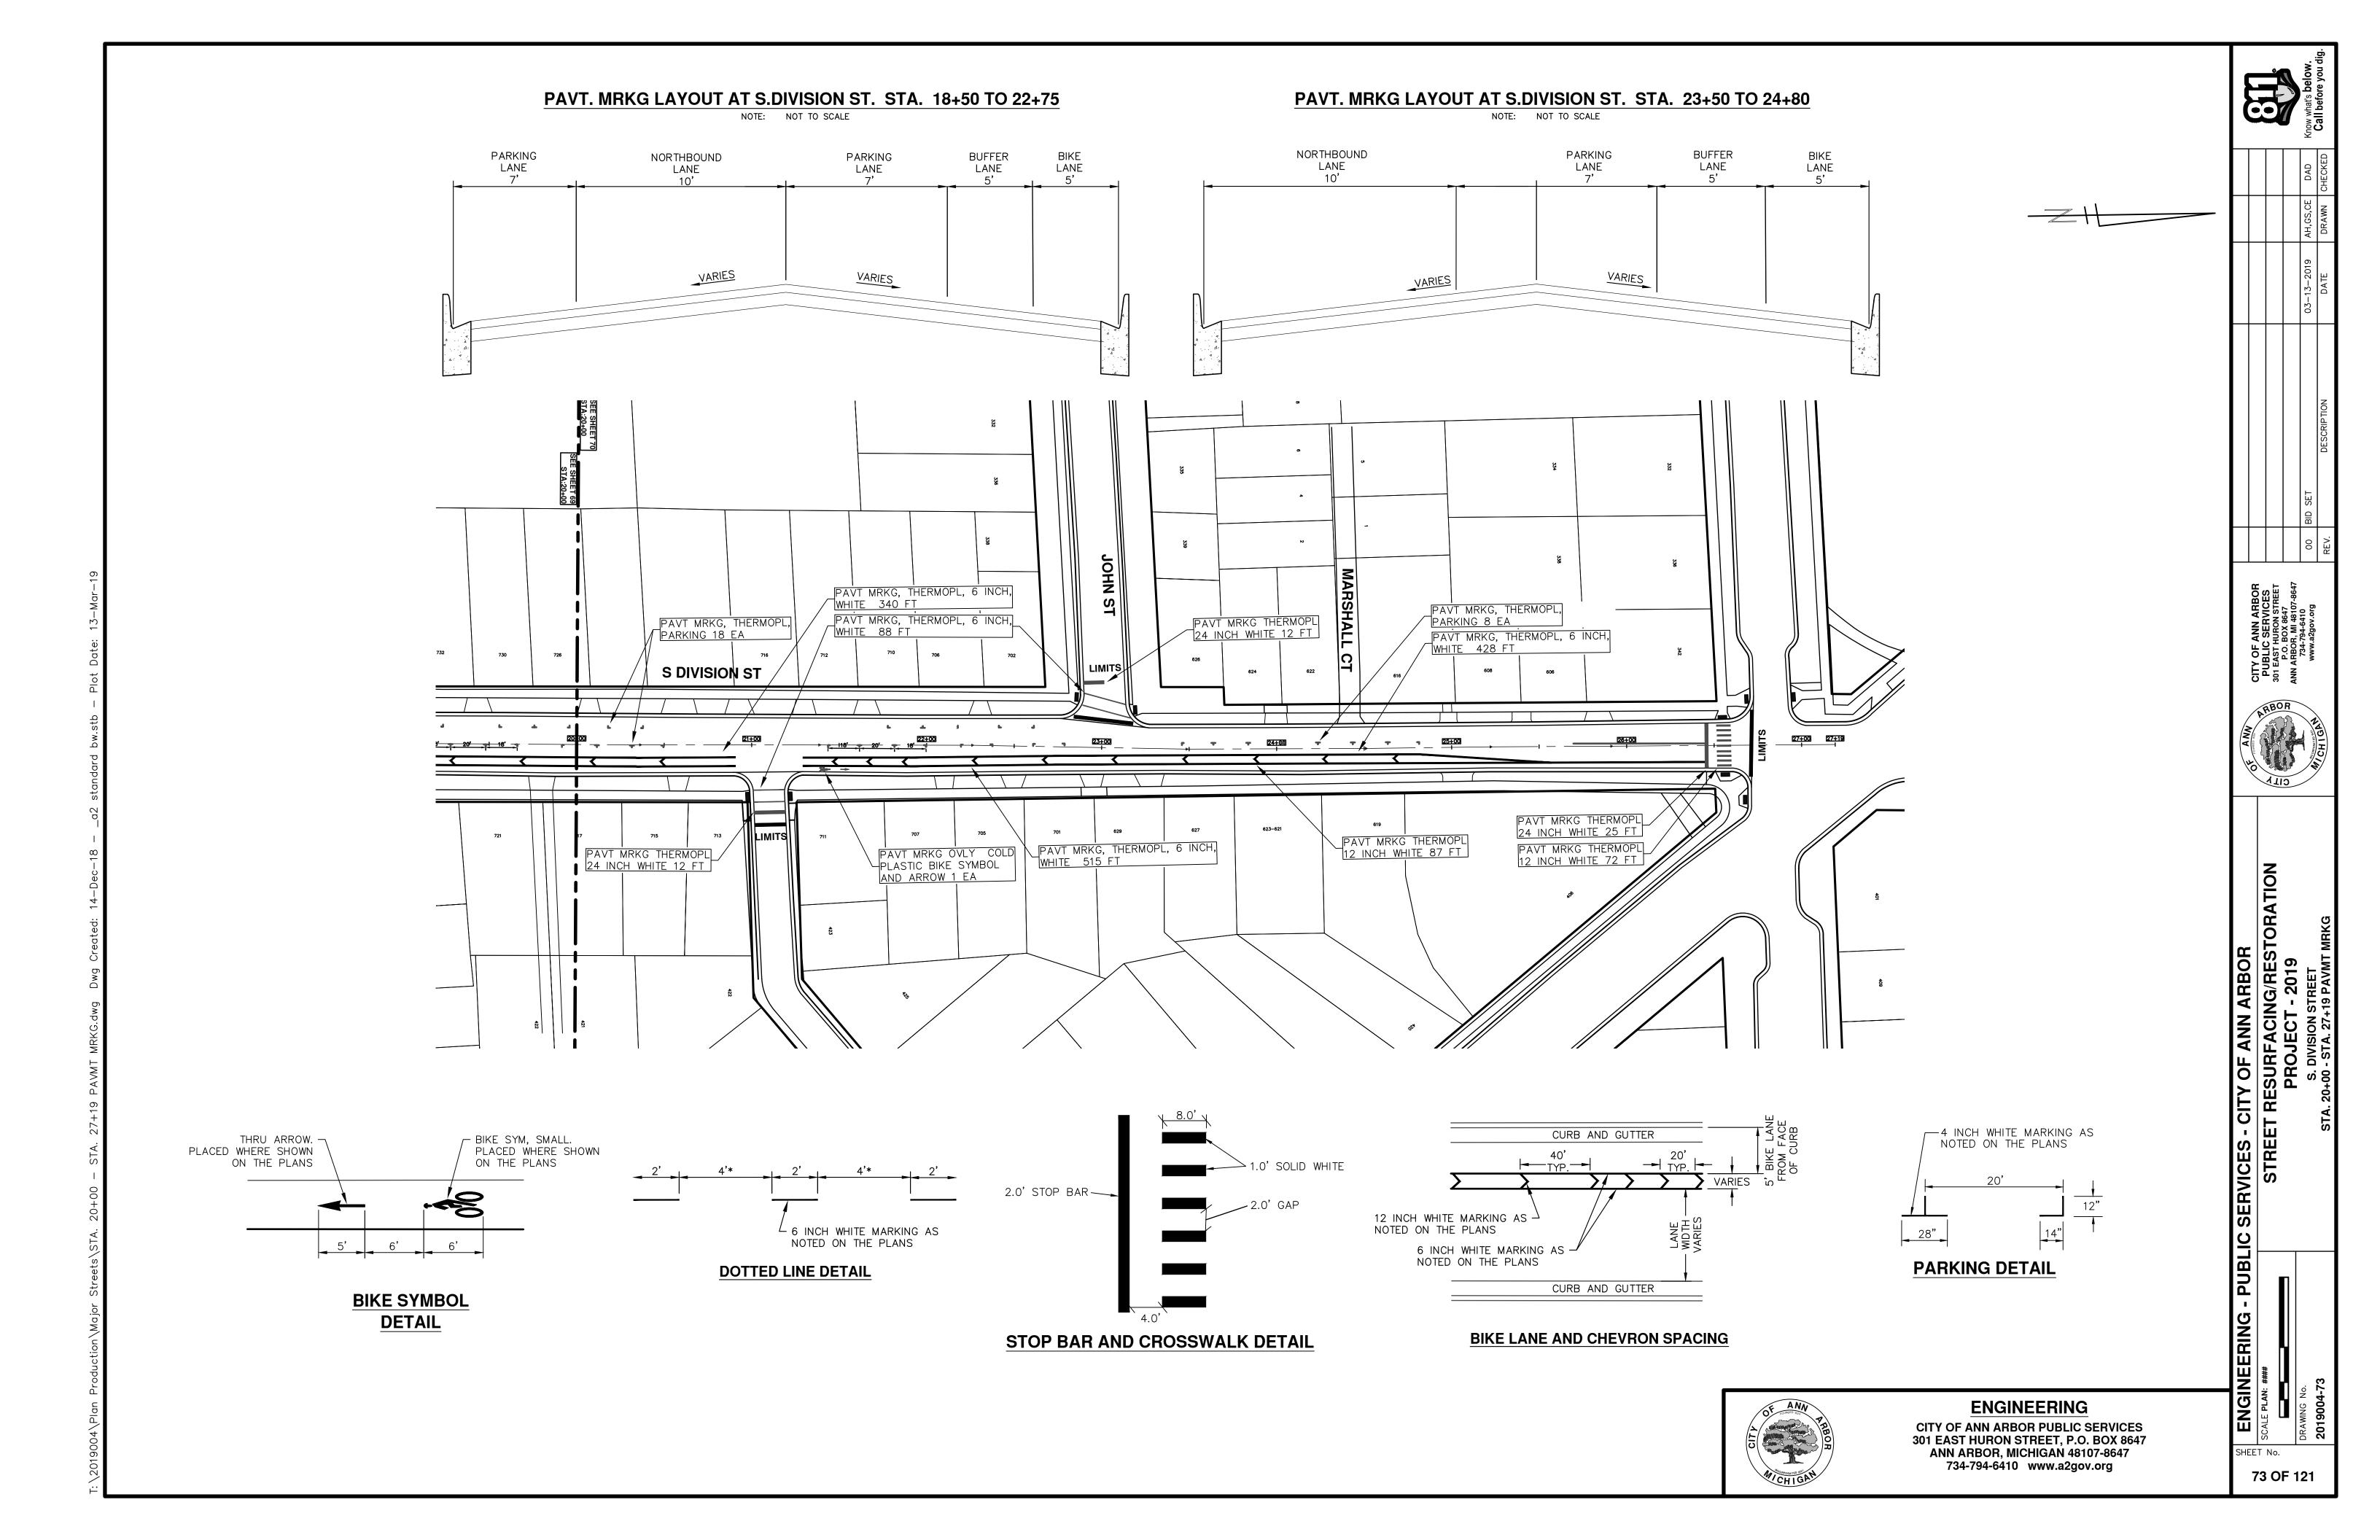
SCALE PLAN: 1:40

STREET RESURFACING/RESTORATIO

PROJECT - 2019

STA. 20+00 - STA. 27+19



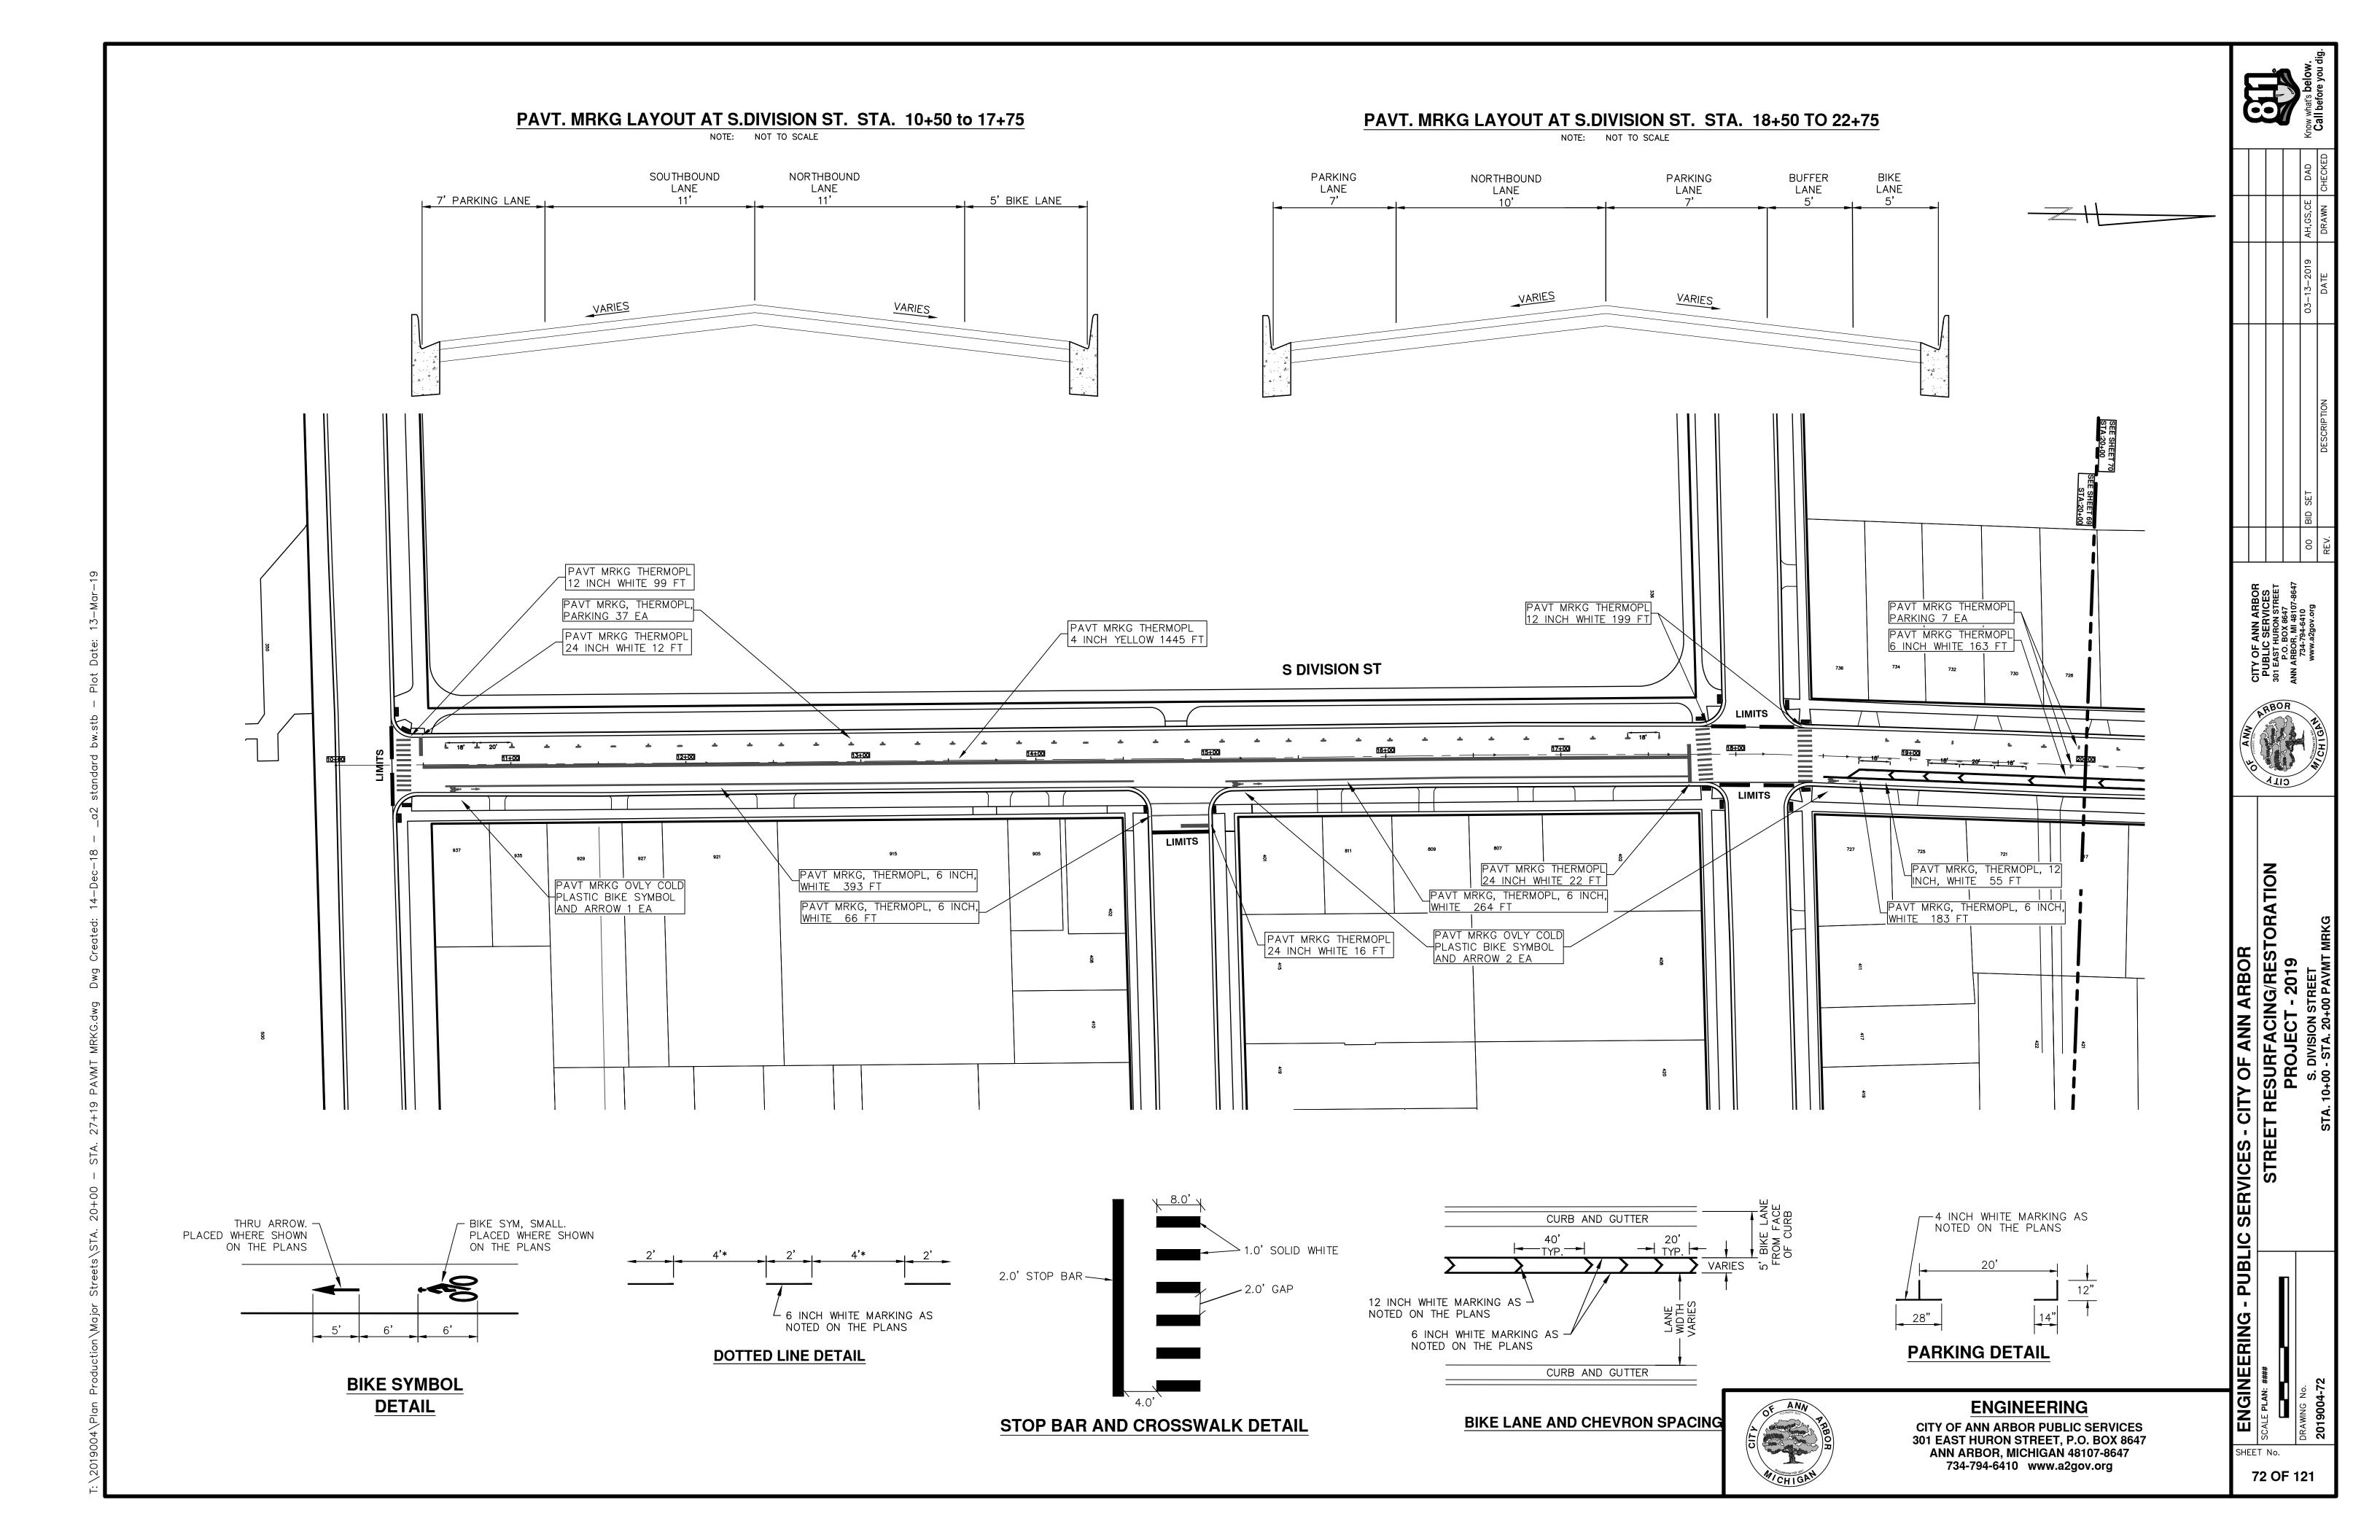



CITY OF ANN ARBOR ENGINEERING PROJECT LOCATION: S STATE STREET

ITB No. 4570 FILE No. 2019004

	CONSTRUCTION KEY
KEY	ASSOCIATED PAY ITEM(S)
	Dr Structure, Adj, Case 1, Modified
AA	Dr Structure, Adj, Case 2, Modified
7.0	• _Dr Structure, Temp Lowering, Modified
	• _Dr Structure, Temp Lowering, Modified
4.5	• _Gate Box, Adj, Case 1
AB	• _Gate Box, Adj, Case 2
	Monument Box Adjust
ADST	Dr Structure, Adj, Add Depth, Modified
AK	• _Dr Structure, Adj, Case 1, Modified
	• _Sidewalk, Sidewalk Ramp, and Driveway Approach, Any Thickness, Rem
C4	• _Grading, Sidewalk
	• _Sidewalk, Conc, 4 inch, Modified
	• _Sidewalk, Sidewalk Ramp, and Driveway Approach, Any Thickness, Rem
C4HE	• _Grading, Sidewalk
01112	Cement
	• _Sidewalk, Conc, 4 inch, Modified
	• _Sidewalk, Sidewalk Ramp, and Driveway Approach, Any Thickness, Rem
	• _Grading, Sidewalk
C6	• _Grading, Sidewalk Ramp
	• _Detectable Warning Surface, Modified
	• _Sidewalk Ramp, Conc, 6 inch, Modified
	• _Sidewalk, Conc, 6 inch, Modified
C8	Grading, Driveway ApproachDriveway, Nonreinf Conc, 8 inch, Modified
	• _Sidewalk, Sidewalk Ramp, and Driveway Approach, Any Thickness, Rem
	Grading, Driveway Approach
	• _Grading, Sidewalk
	• _Grading, Sidewalk Ramp
	• Cement
C HE	Driveway, Nonreinf Conc, 6 inch, Modified
	Driveway, Nonreinf Conc, 8 inch, Modified
	Detectable Warning Surface, Modified
	• _Sidewalk Ramp, Conc, 6 inch, Modified
	• _Sidewalk, Conc, 6 inch, Modified
C/G	• _Curb, Gutter, and Curb and Gutter, Any Type, Rem
	• _Curb and Gutter, Conc
	• _Curb, Gutter, and Curb and Gutter, Any Type, Rem
C/GHE	• Cement
	• _Driveway Opening, Conc, Det M, Modified
CP	• _Grading, Sidewalk
CD	• _Sidewalk, Conc, 4 inch, Modified
CR	• _Sidewalk, Sidewalk Ramp, and Driveway Approach, Any Thickness, Rem
DS	Dr Structure, Rem Sewer, Rem, Less than 24 inch
50	• Dr Structure, 24 inch dia
	• Dr Structure, Rem
DSDI	• Sewer, Rem, Less than 24 inch
	• _Dr Structure, Double Inlet
PT	Dr Structure, Point
and and an analysis of the second	Dr Structure Cover, Type B
DD 4	• _Dr Structure Cover, Type B, Special
RRA	• _Dr Structure, Adj, Case 1, Modified
	Dr Structure, Temp Lowering, Modified
RRK	Dr Structure Cover, Type K
	• _Dr Structure, Adj, Case 1, Modified
RS	• _Dr Structure, Reconstruct
TYPE II	Plastic Drum, High Intensity, Lighted, Furn
,,,,,,,,,,,,,,,,,,,,,,,,,,,,,,,,,,,,,,,	Plastic Drum, High Intensity, Lighted, Oper
TYPE III	Barricade, Type III, High Intensity, Double Sided, Lighted, Furn
	• Barricade, Type III, High Intensity, Double Sided, Lighted, Oper

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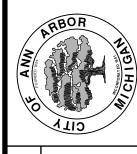
ENGINEERING

CITY OF ANN ARBOR PUBLIC SERVICES 301 EAST HURON STREET, P.O. BOX 8647 ANN ARBOR, MICHIGAN 48107-8647 734-794-6410 www.a2gov.org

٩D	Know what's below.
CKED	Call before you dig.

00 BID SET 03–13–2019 AH,GS,CE DAD REV. DATE DRAWN CHECKEI			DAD	DRAWN CHECKED	
BID SET 03–13–2019 DESCRIPTION DATE			AH,GS,CE	DRAWN	
BID SET				DATE	
00 REV.			BID SET	DESCRIPTION	
			00	REV.	

ITY OF ANN ARBOF PUBLIC SERVICES 01 EAST HURON STREET P.O. BOX 8647 NN ARBOR, MI 48107-864 734-794-6410 www.a2gov.org




ESURFACING/RESTORATION
PROJECT - 2019
S STATE STREET
SUBSET COVER SHEET

SERVICES - CITY OF ANN
STREET RESURFACI

JEERING - PUBLIC SERVICE STE

DRAWING No. 2019004-74


SHEET No.

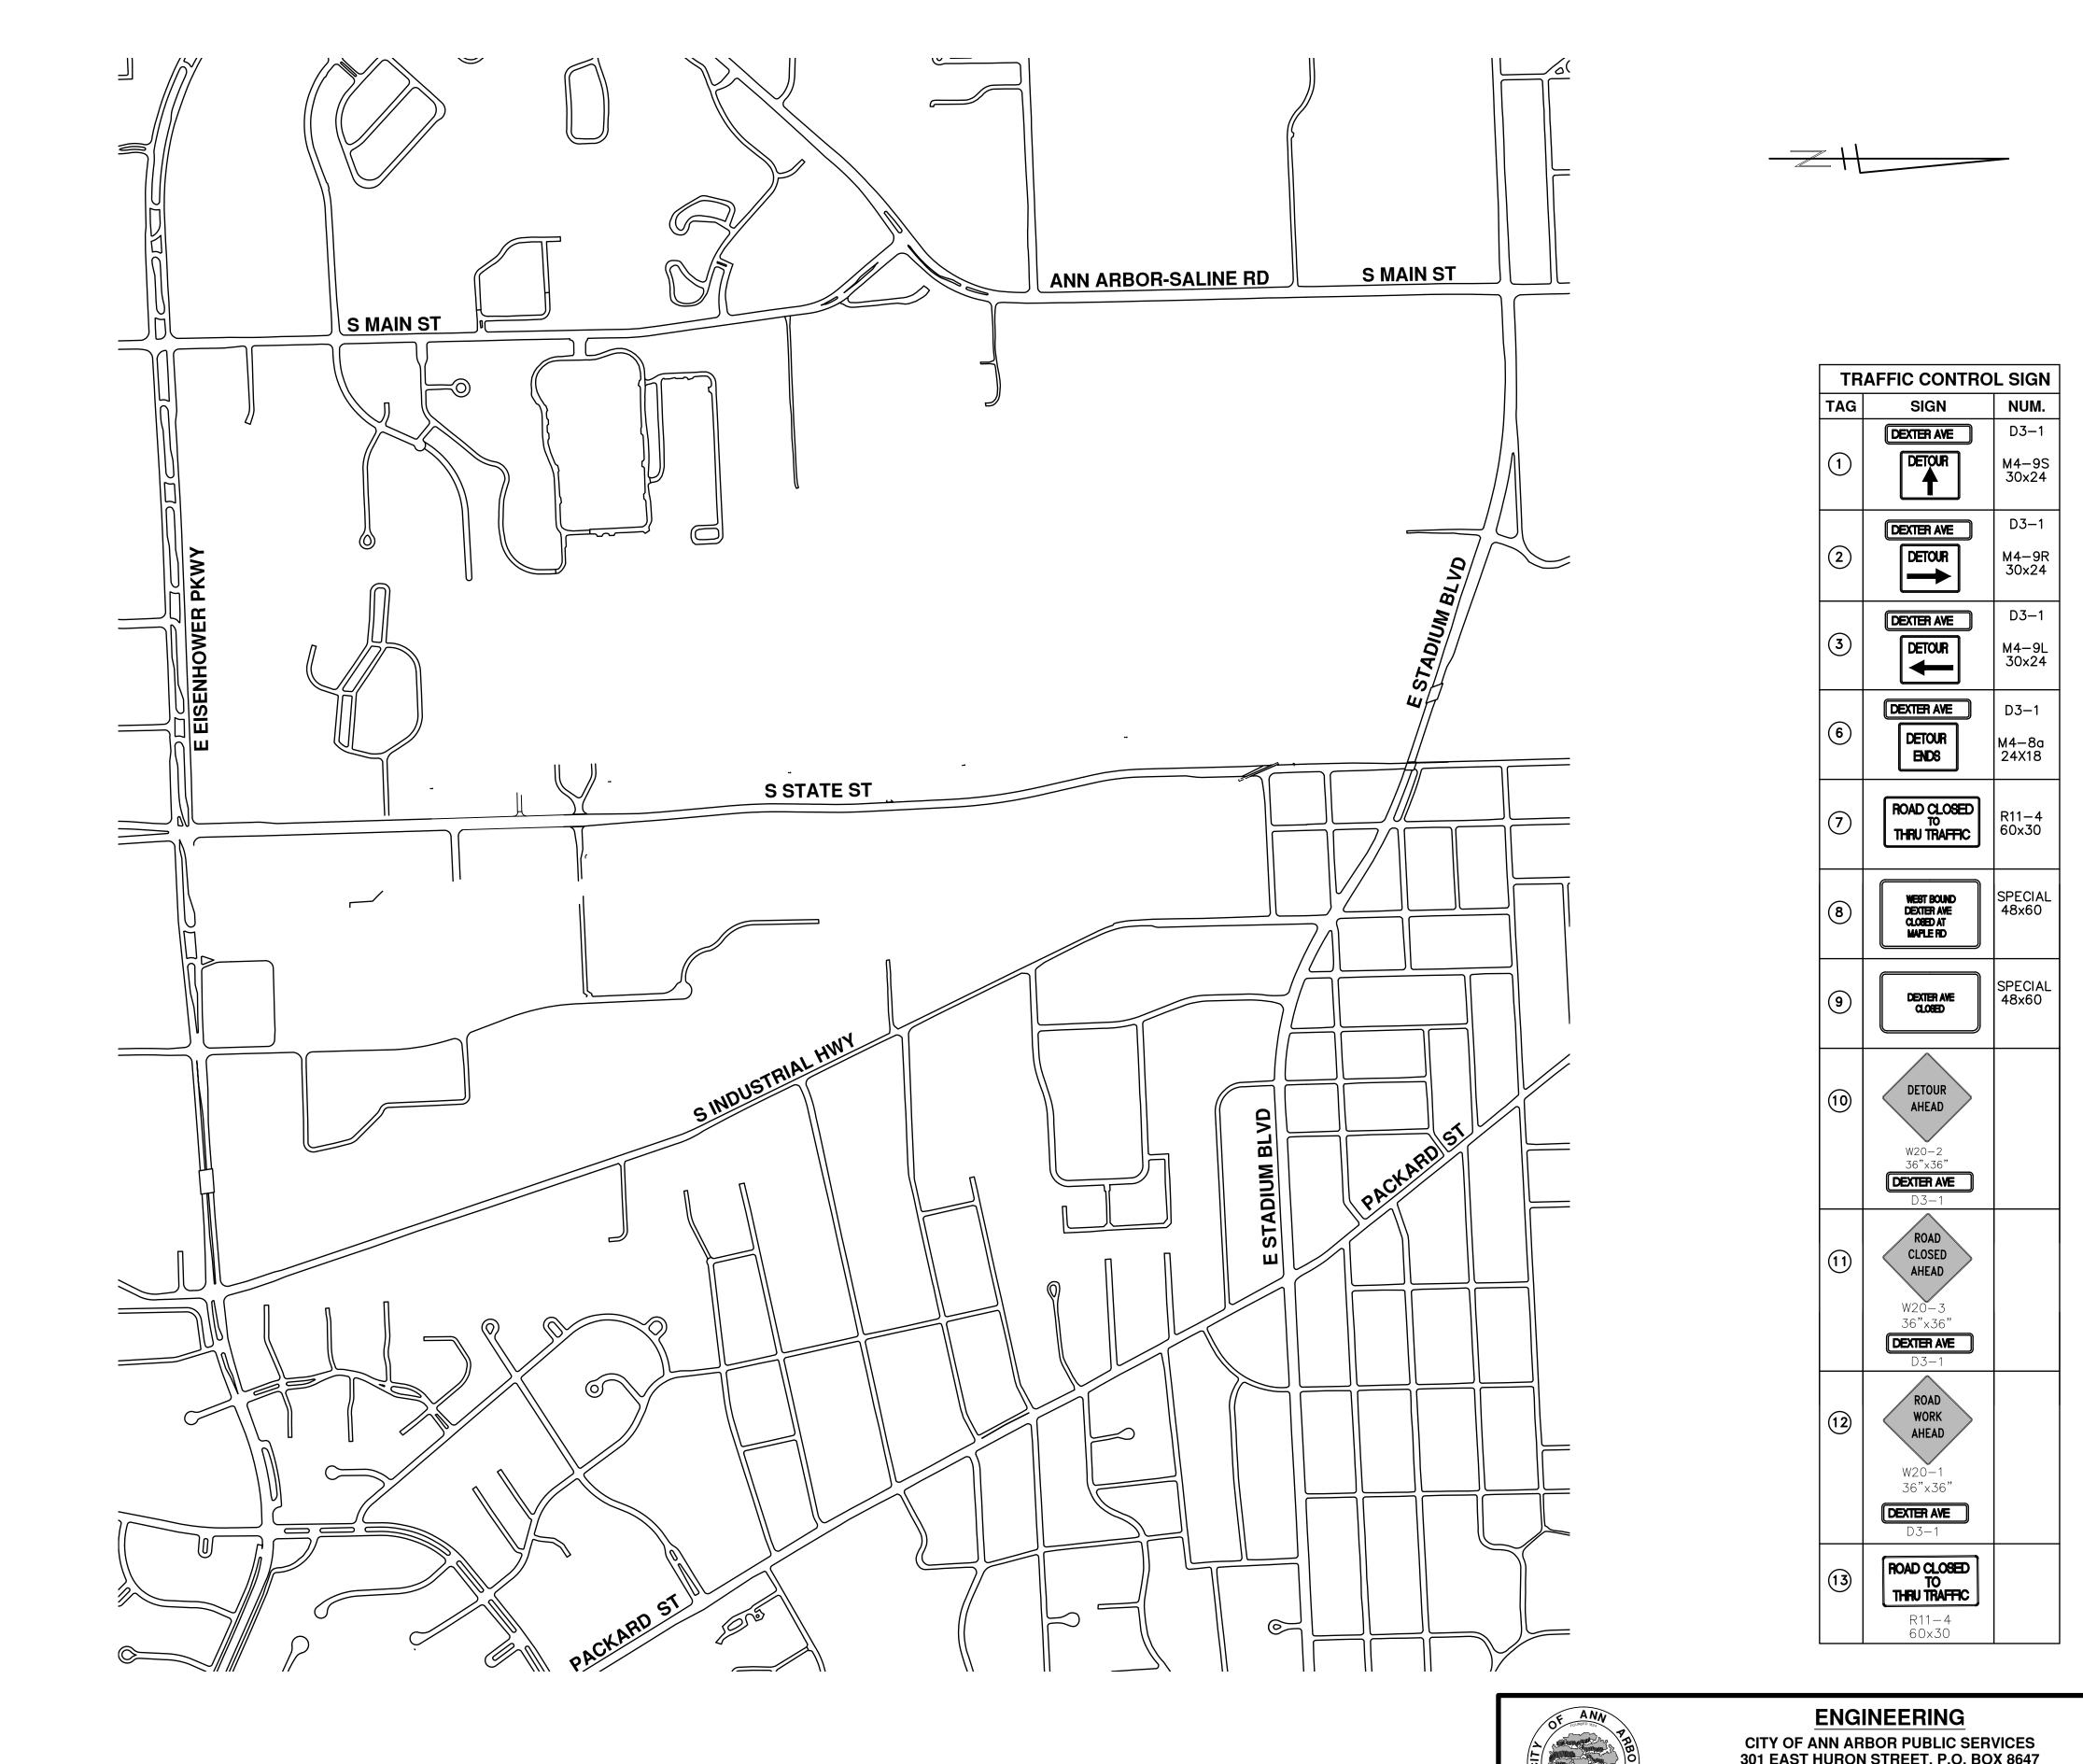



ENGINEERING - PUBLIC SERVICES - CITY OF ANN ARBOR


SCALE PLAN: 1" = 500'


SCALE PLAN: 1" = 75 OF 121

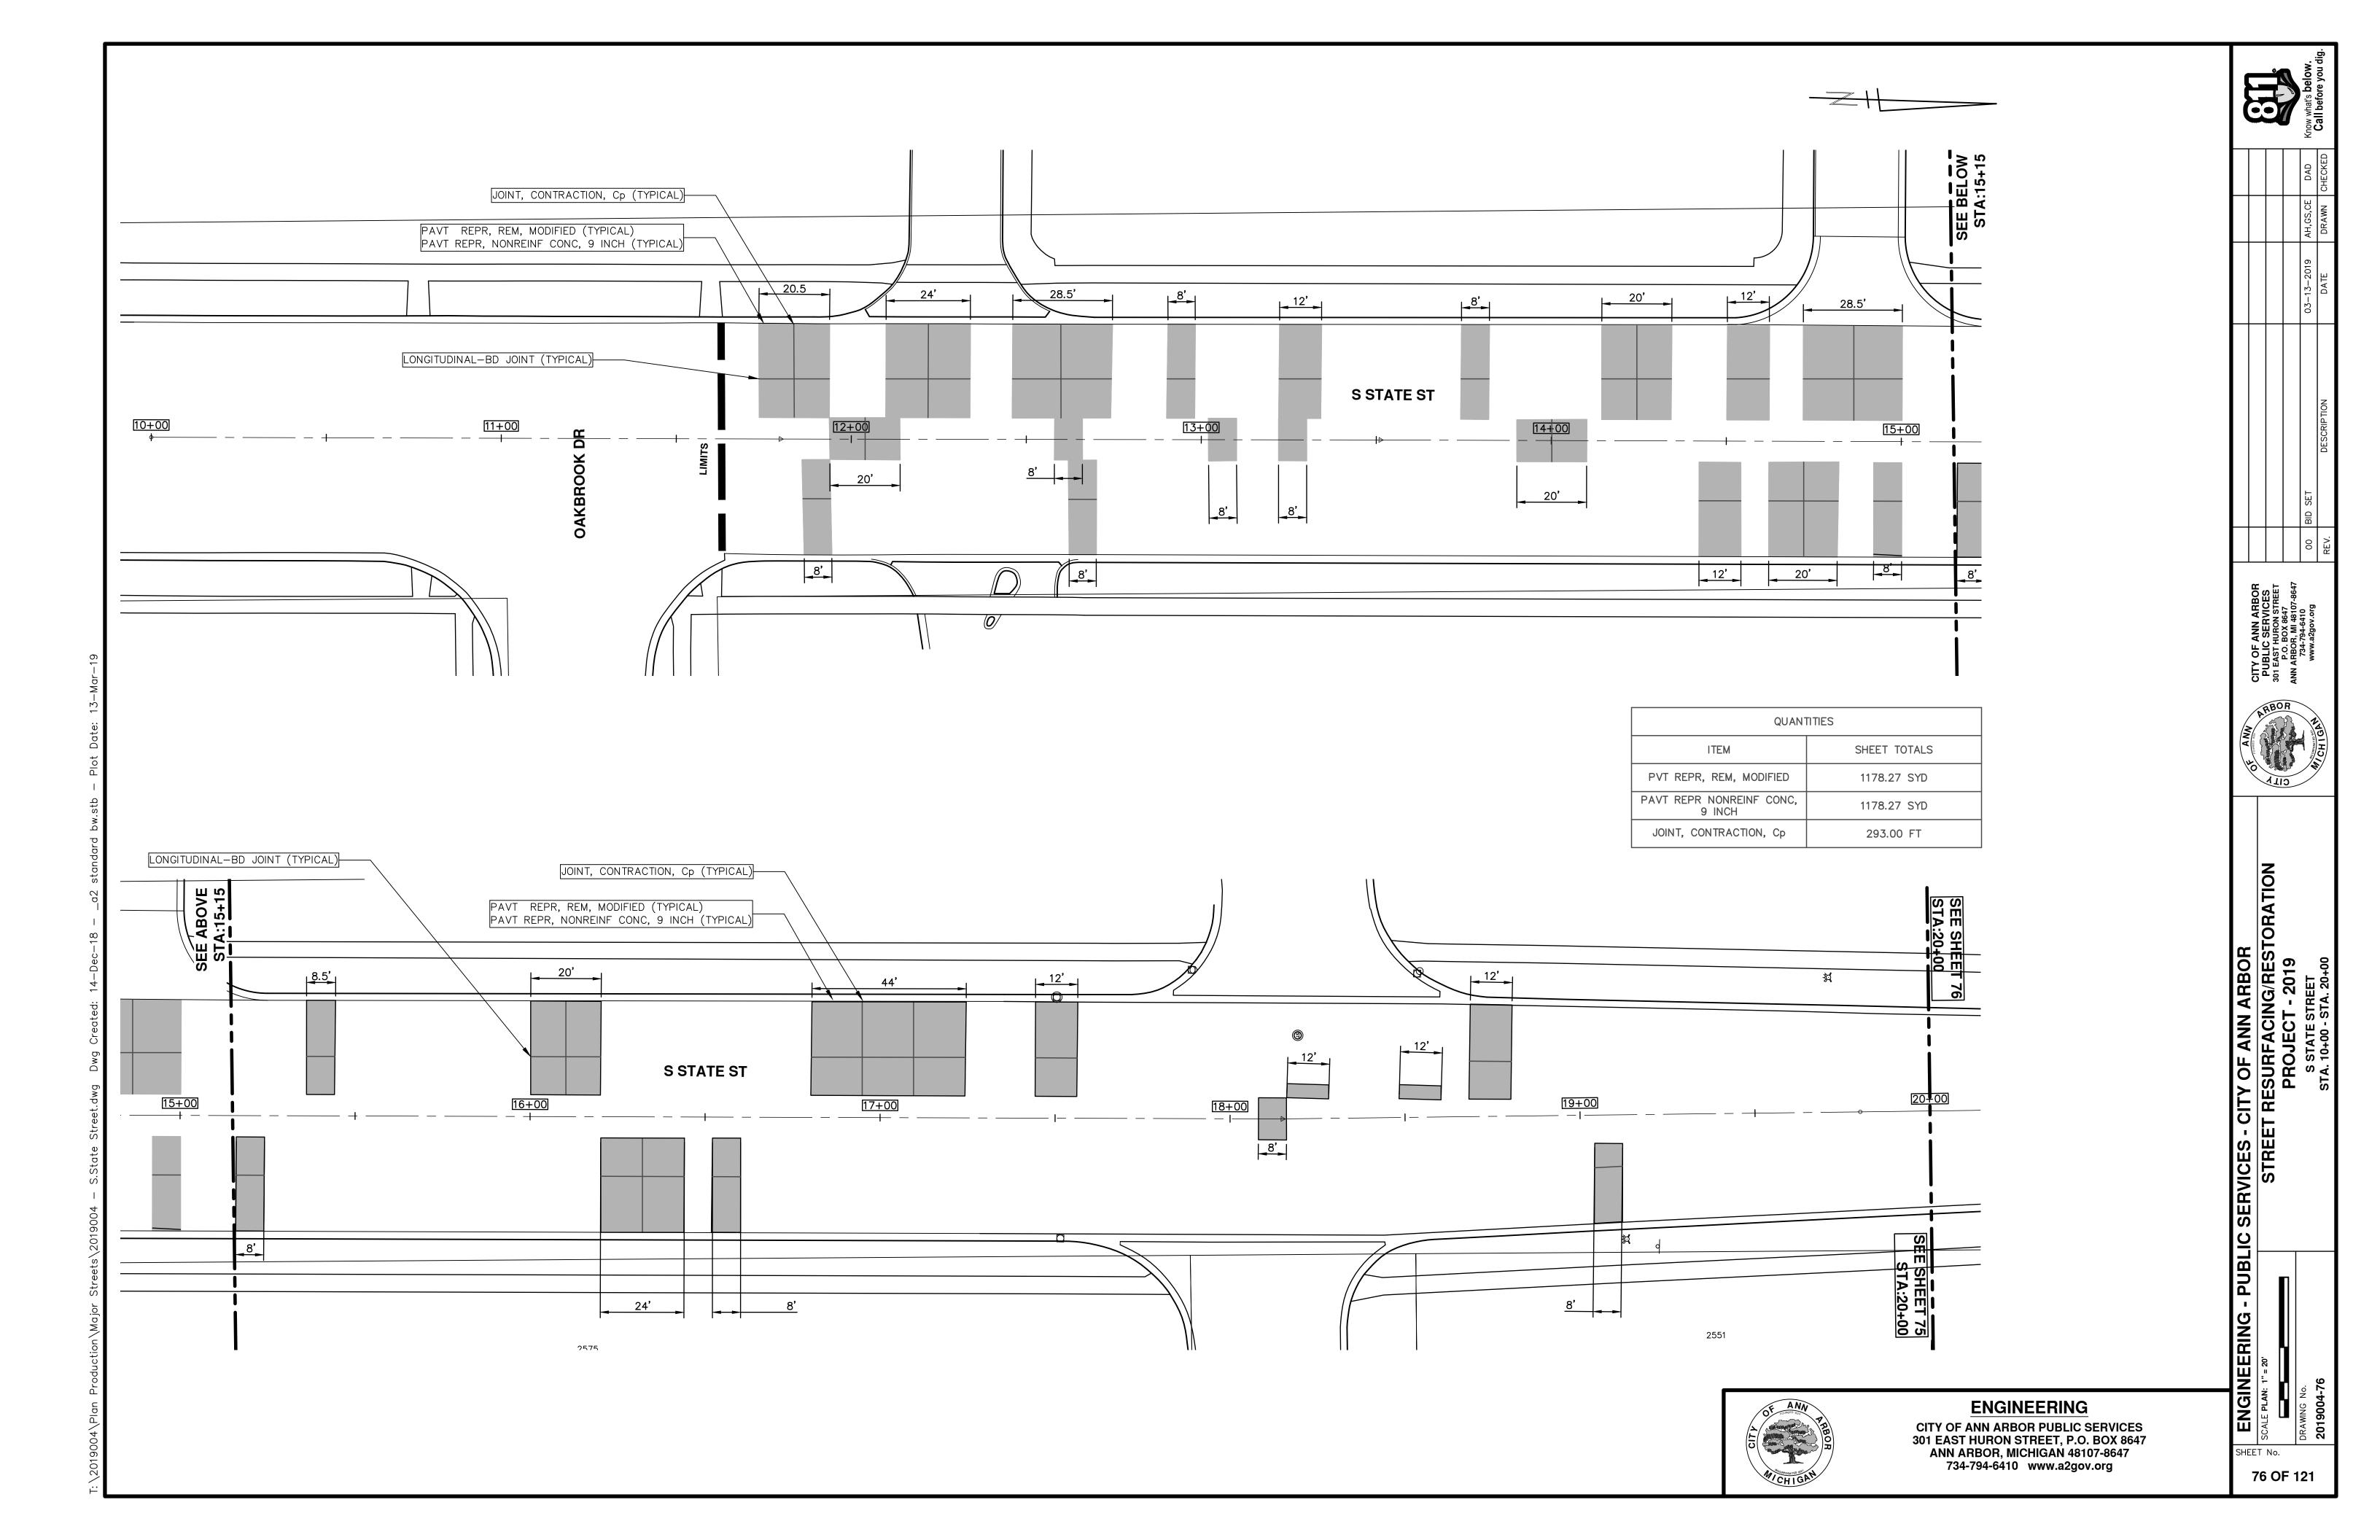


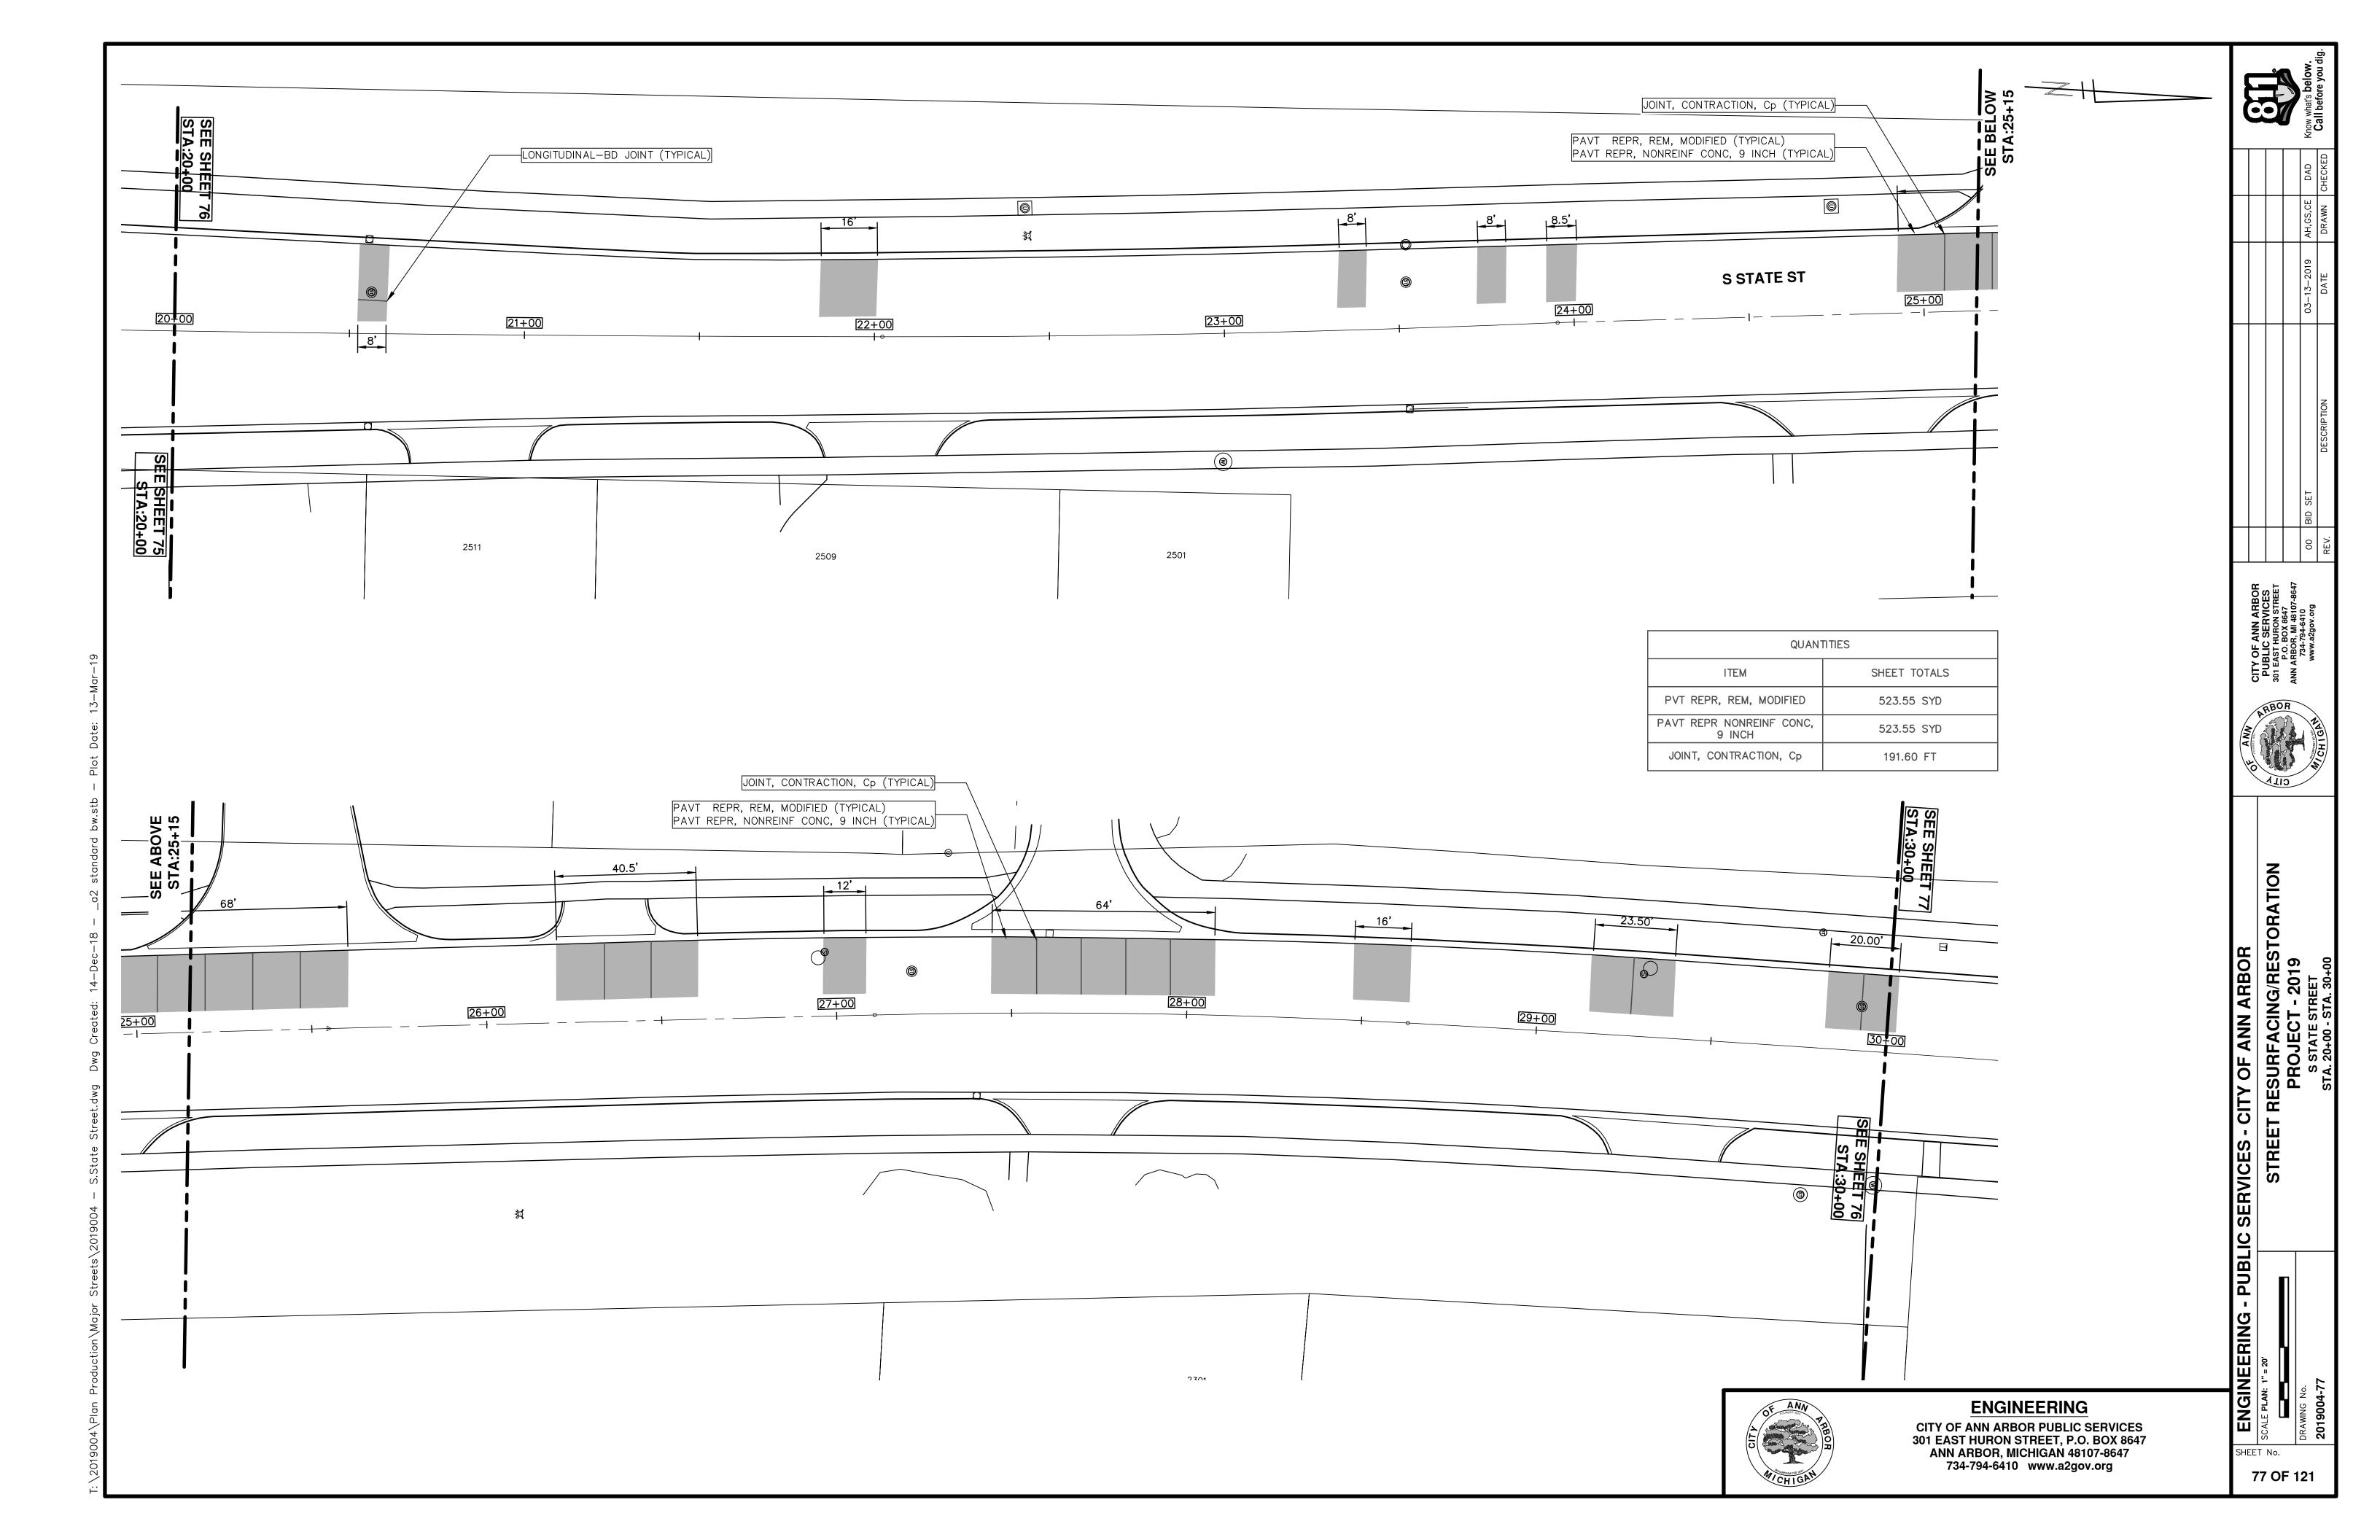


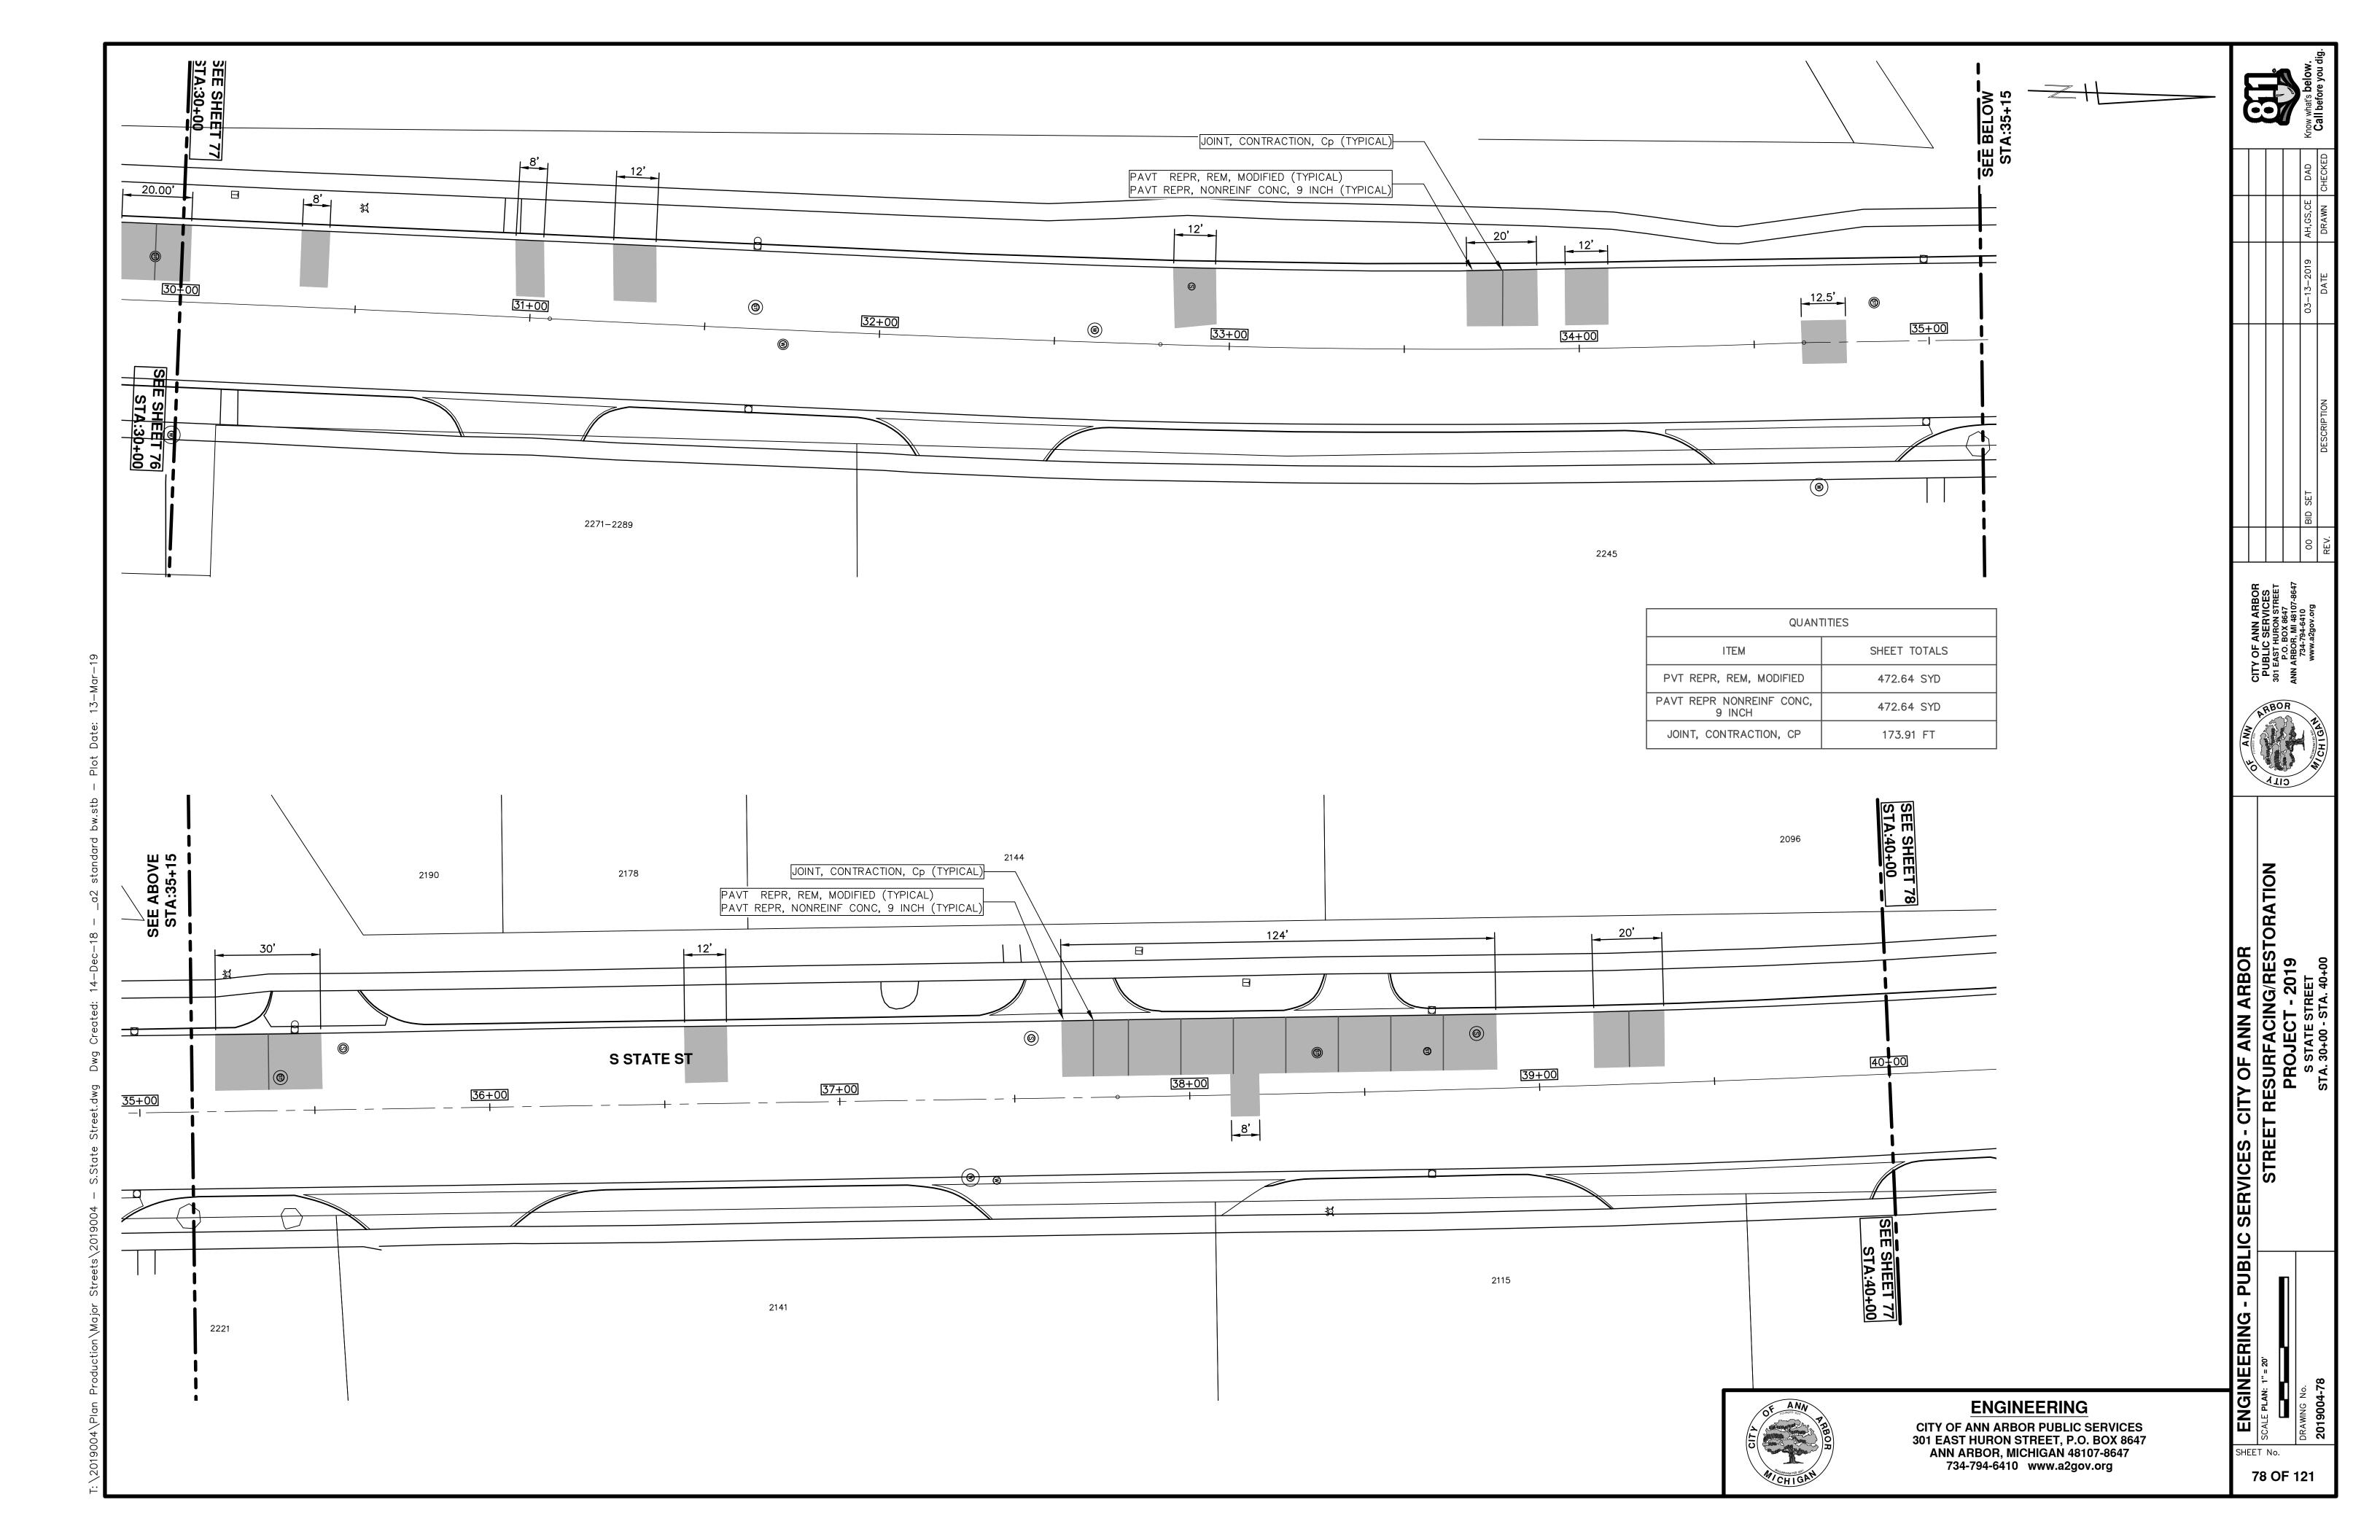


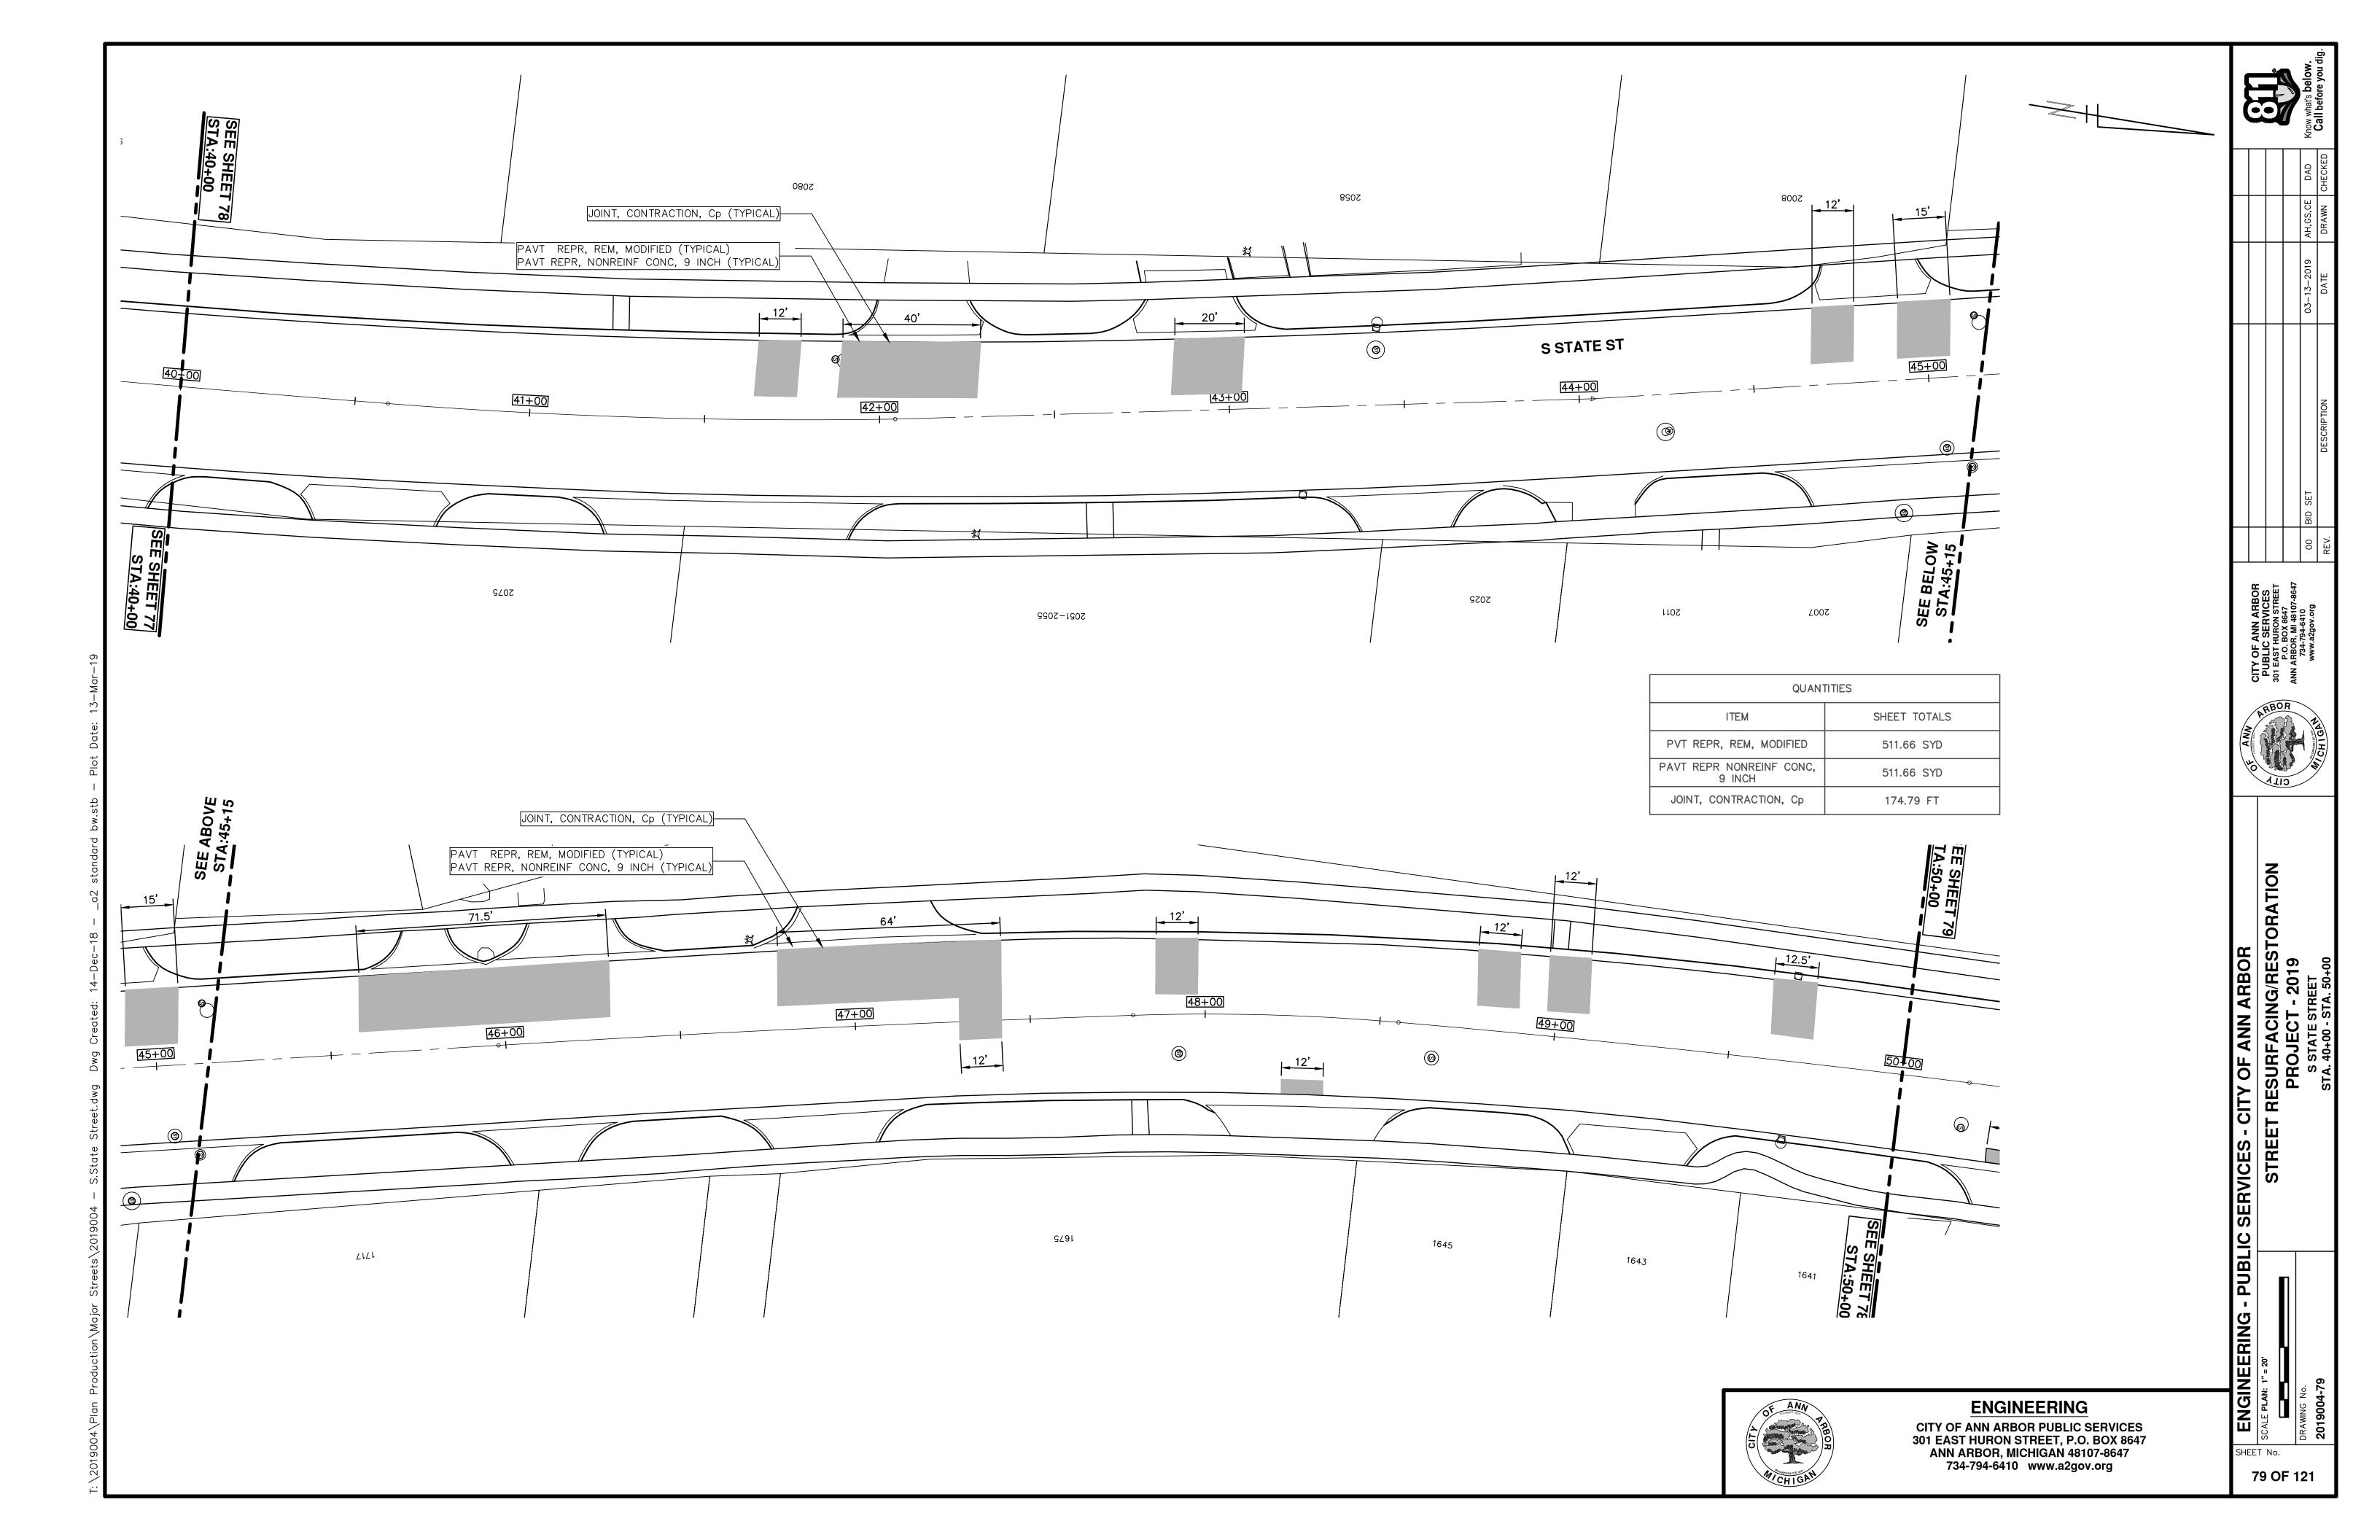


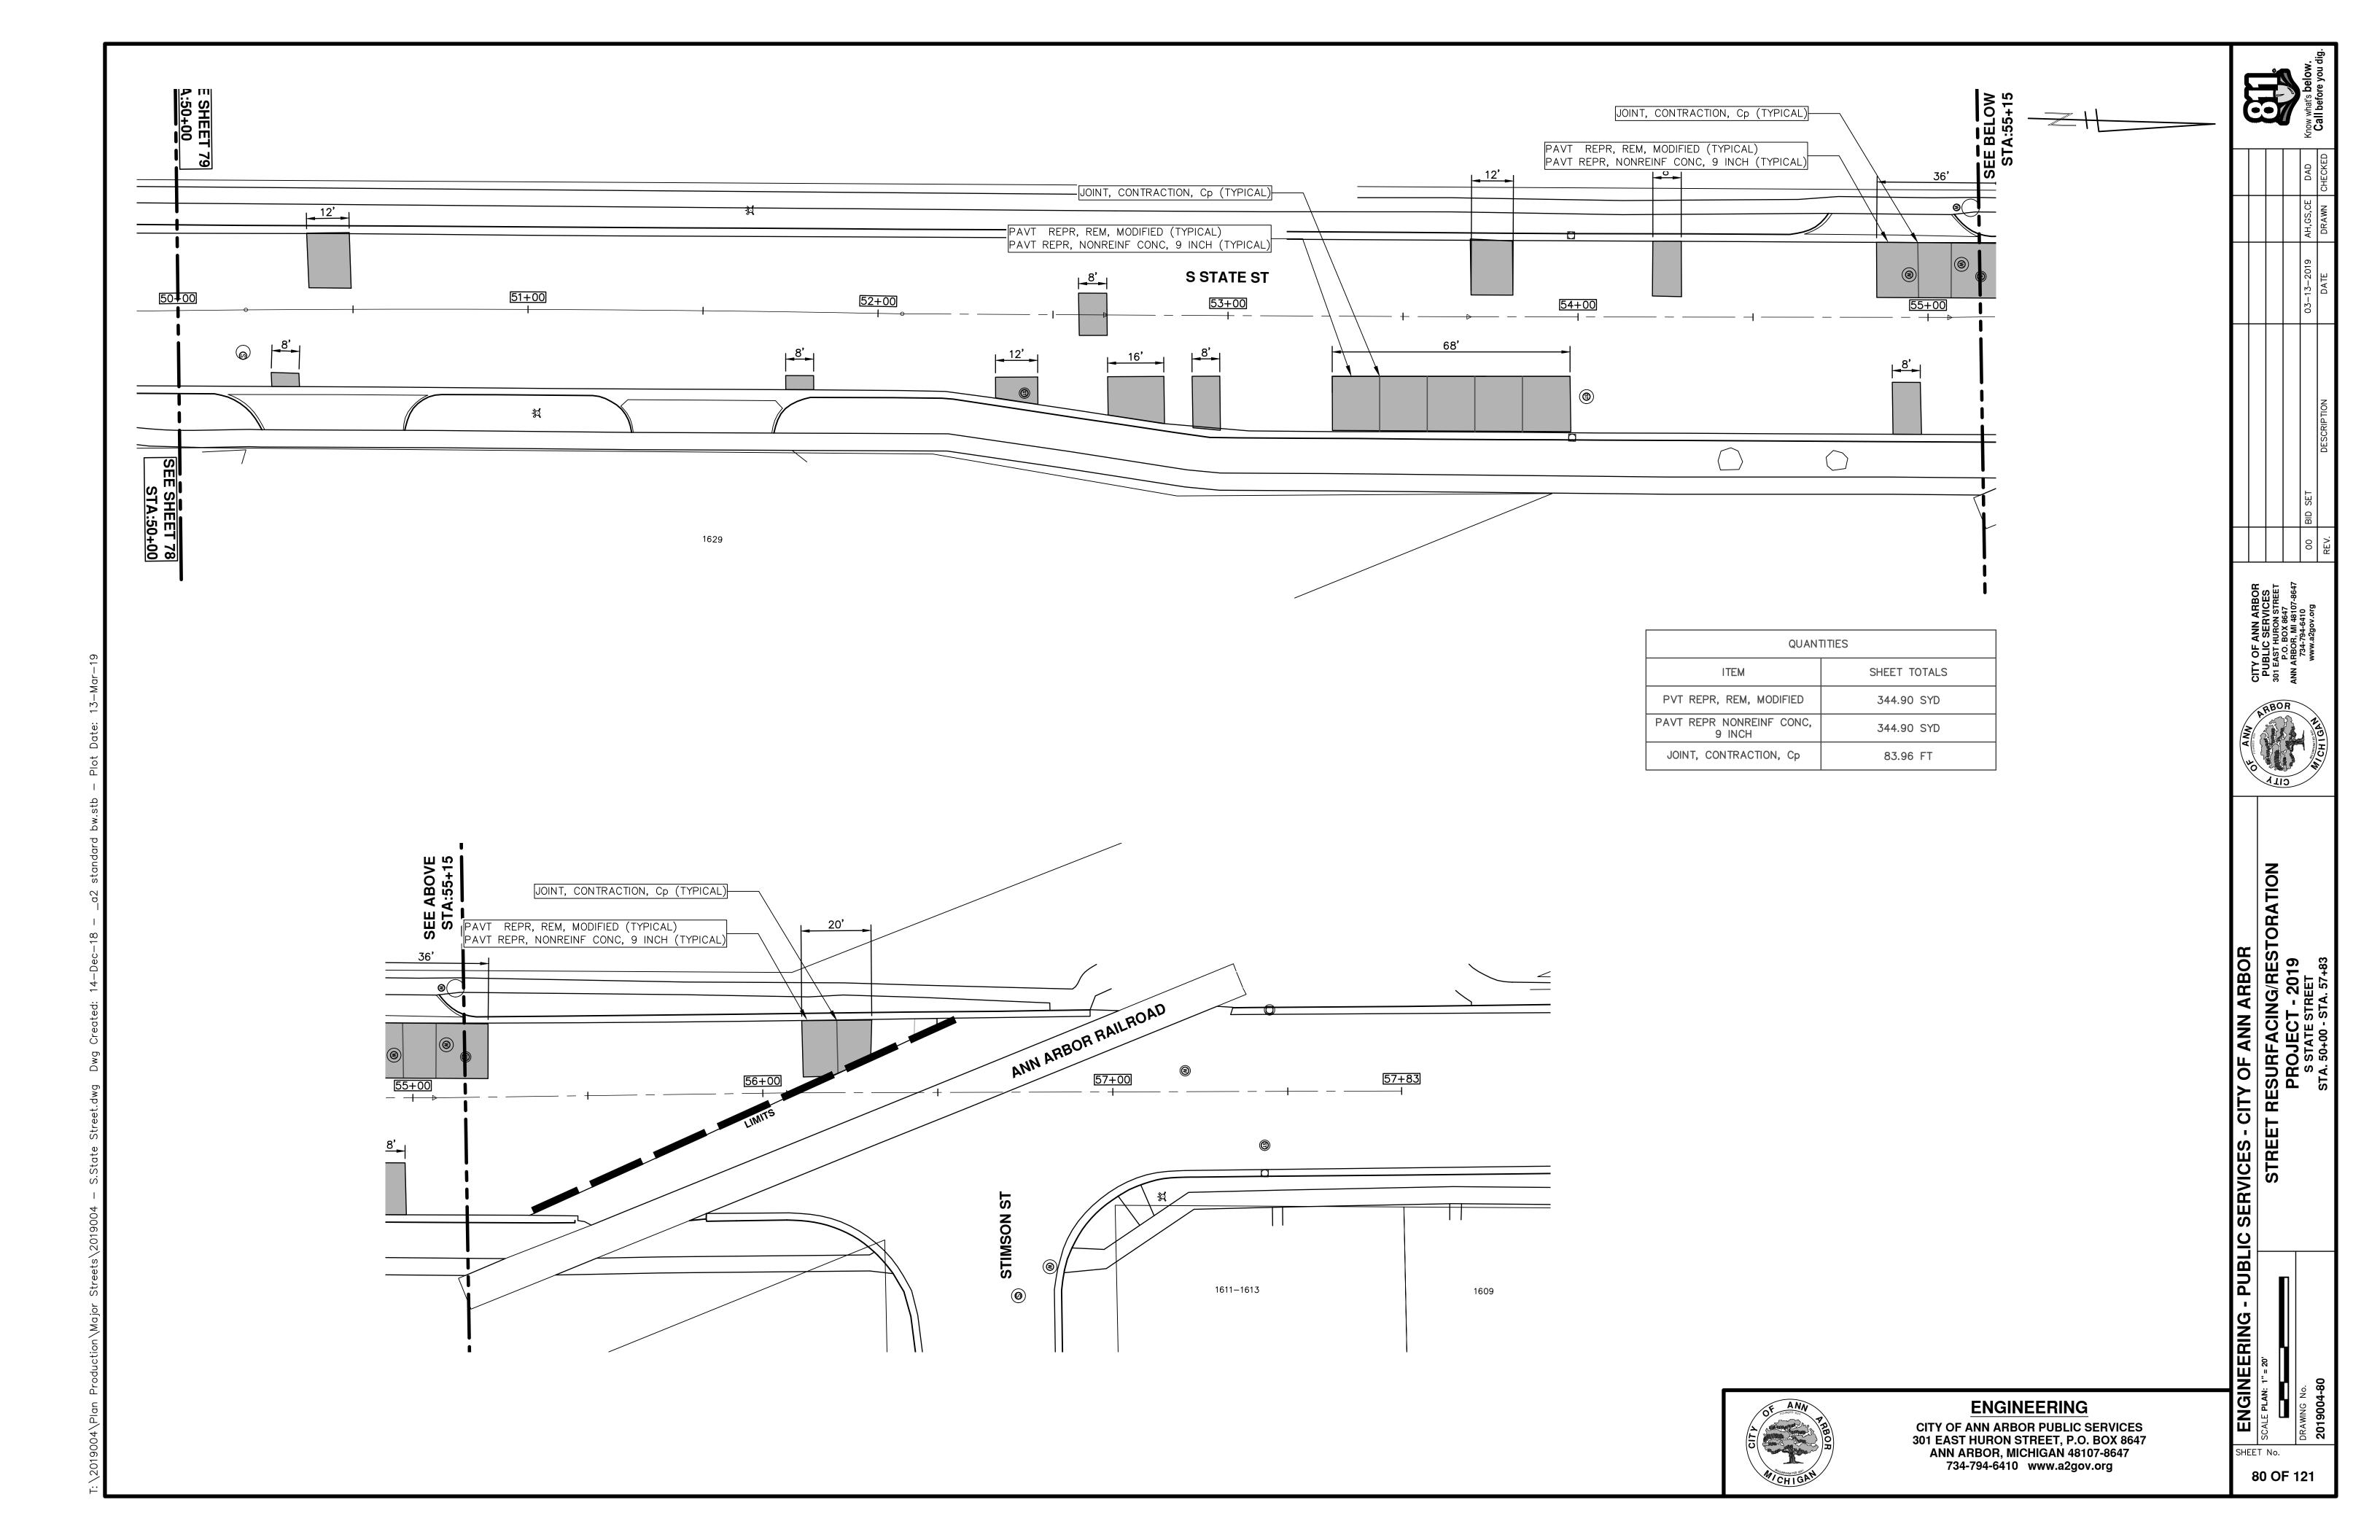


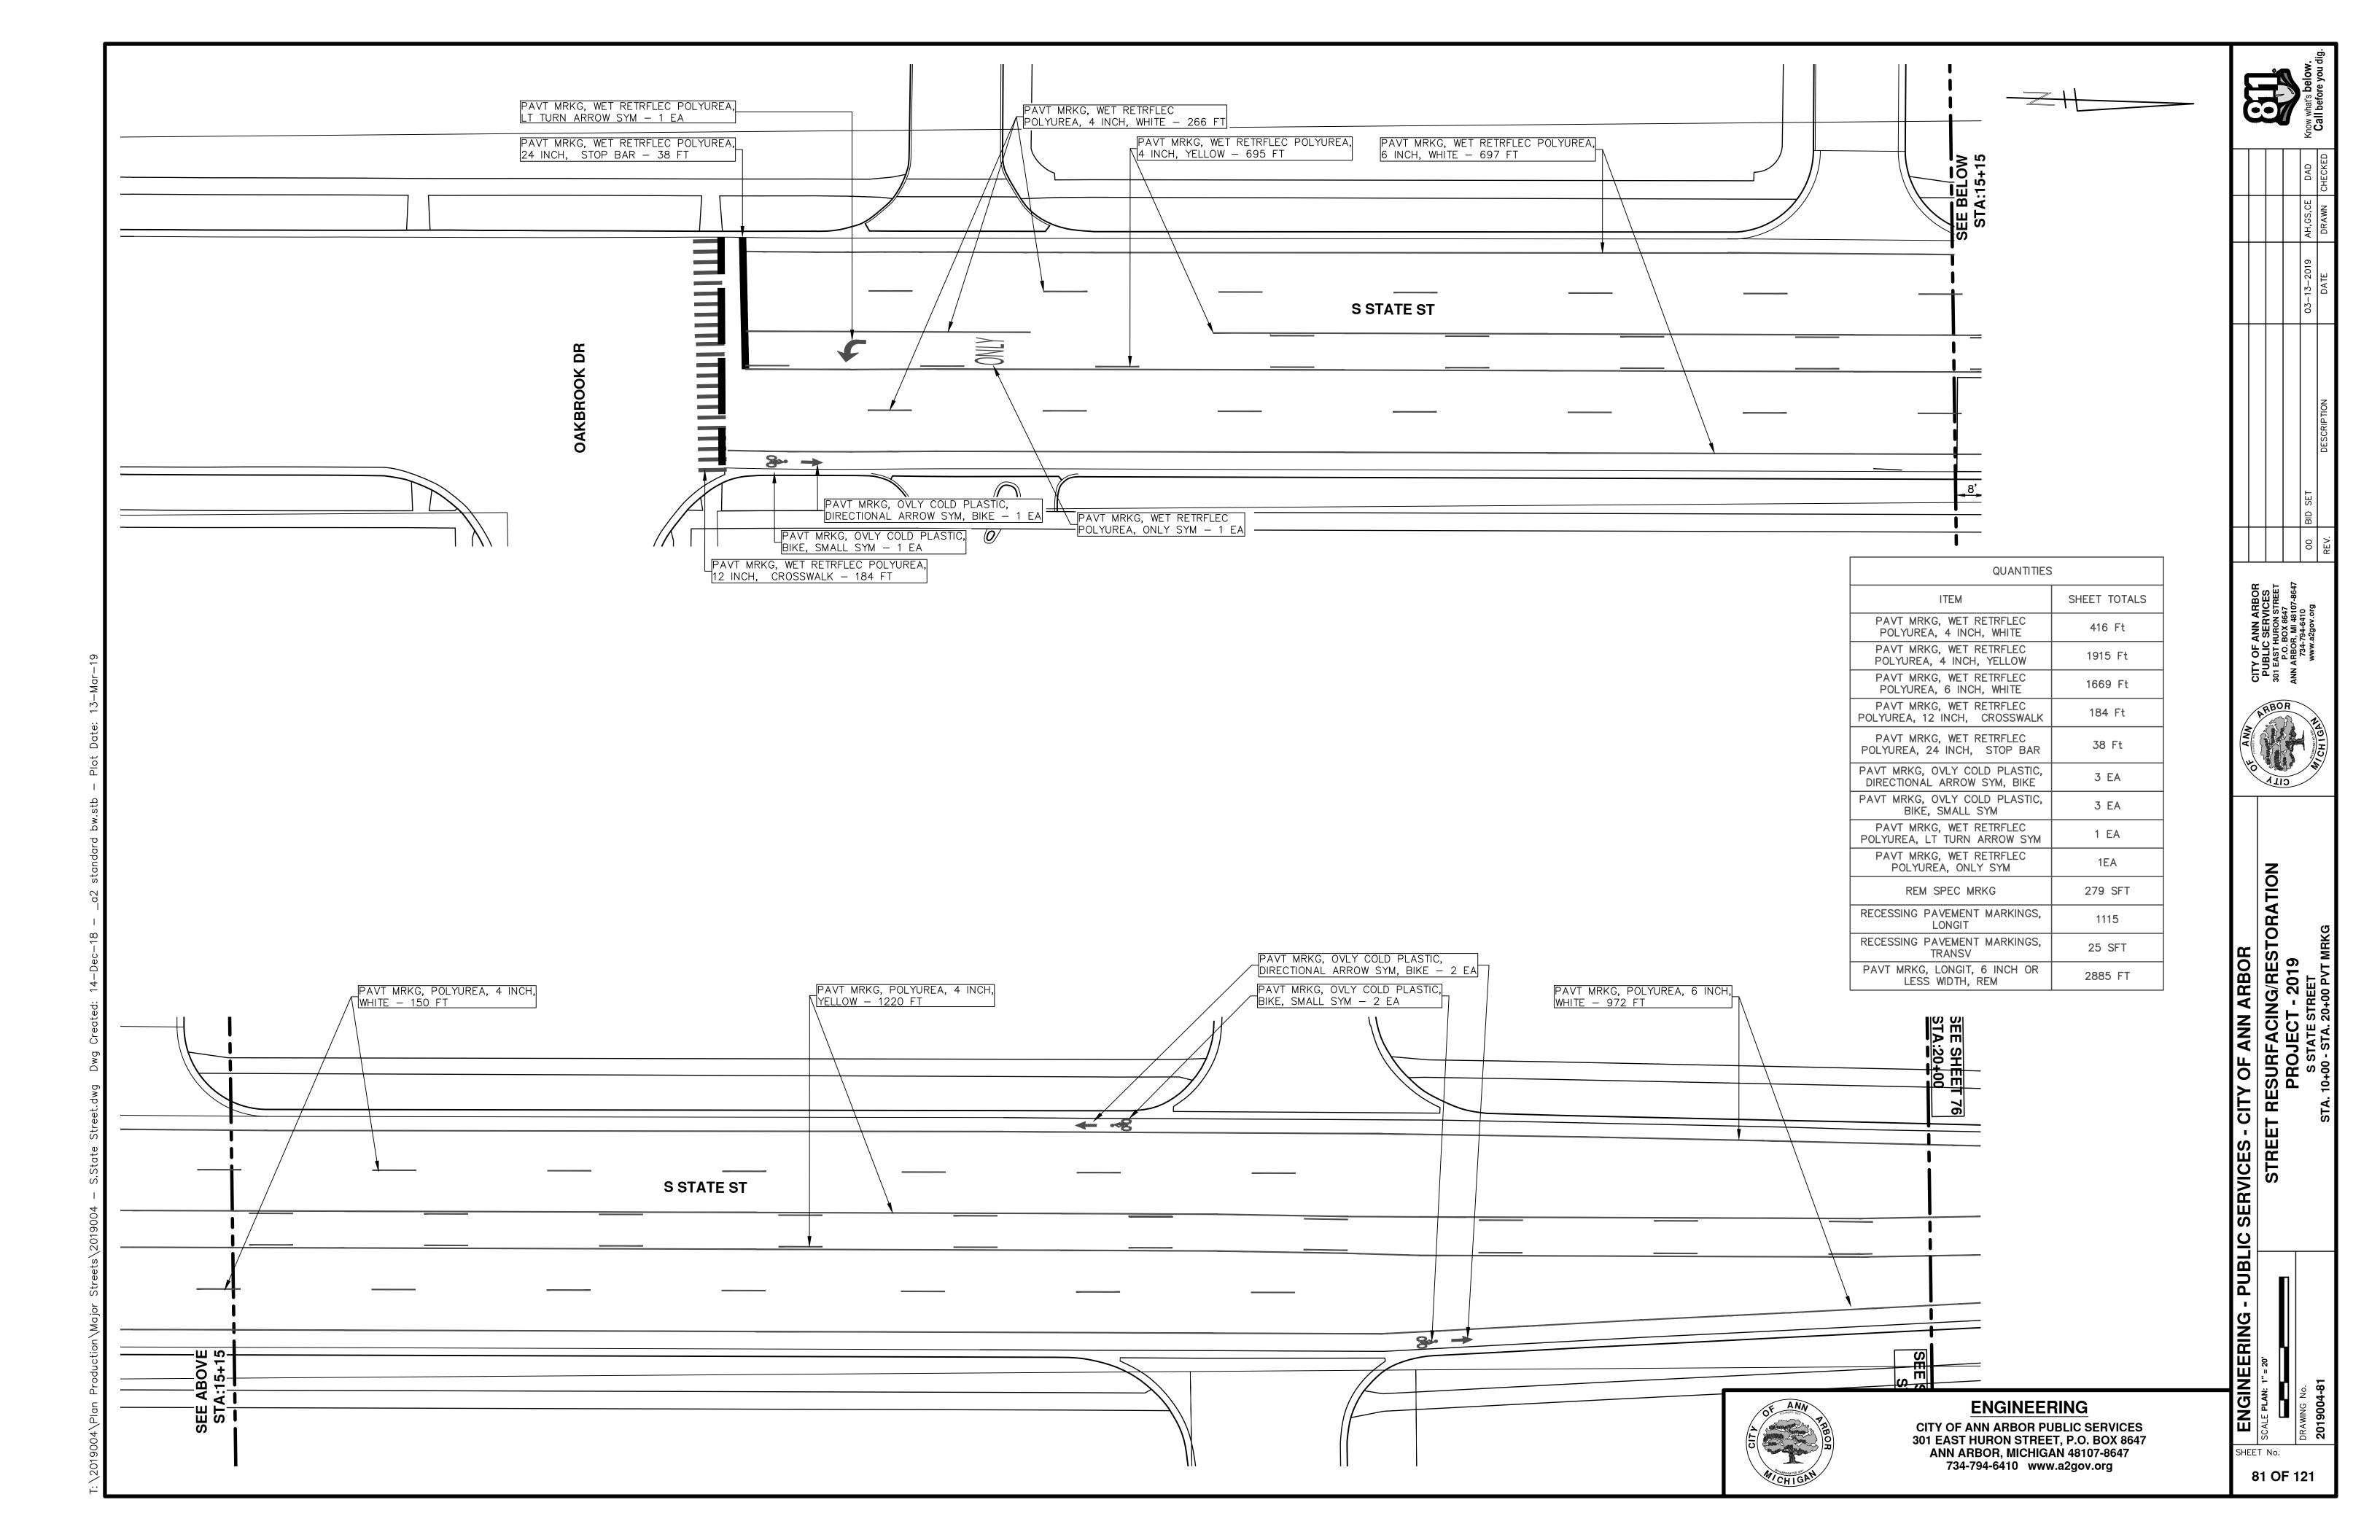

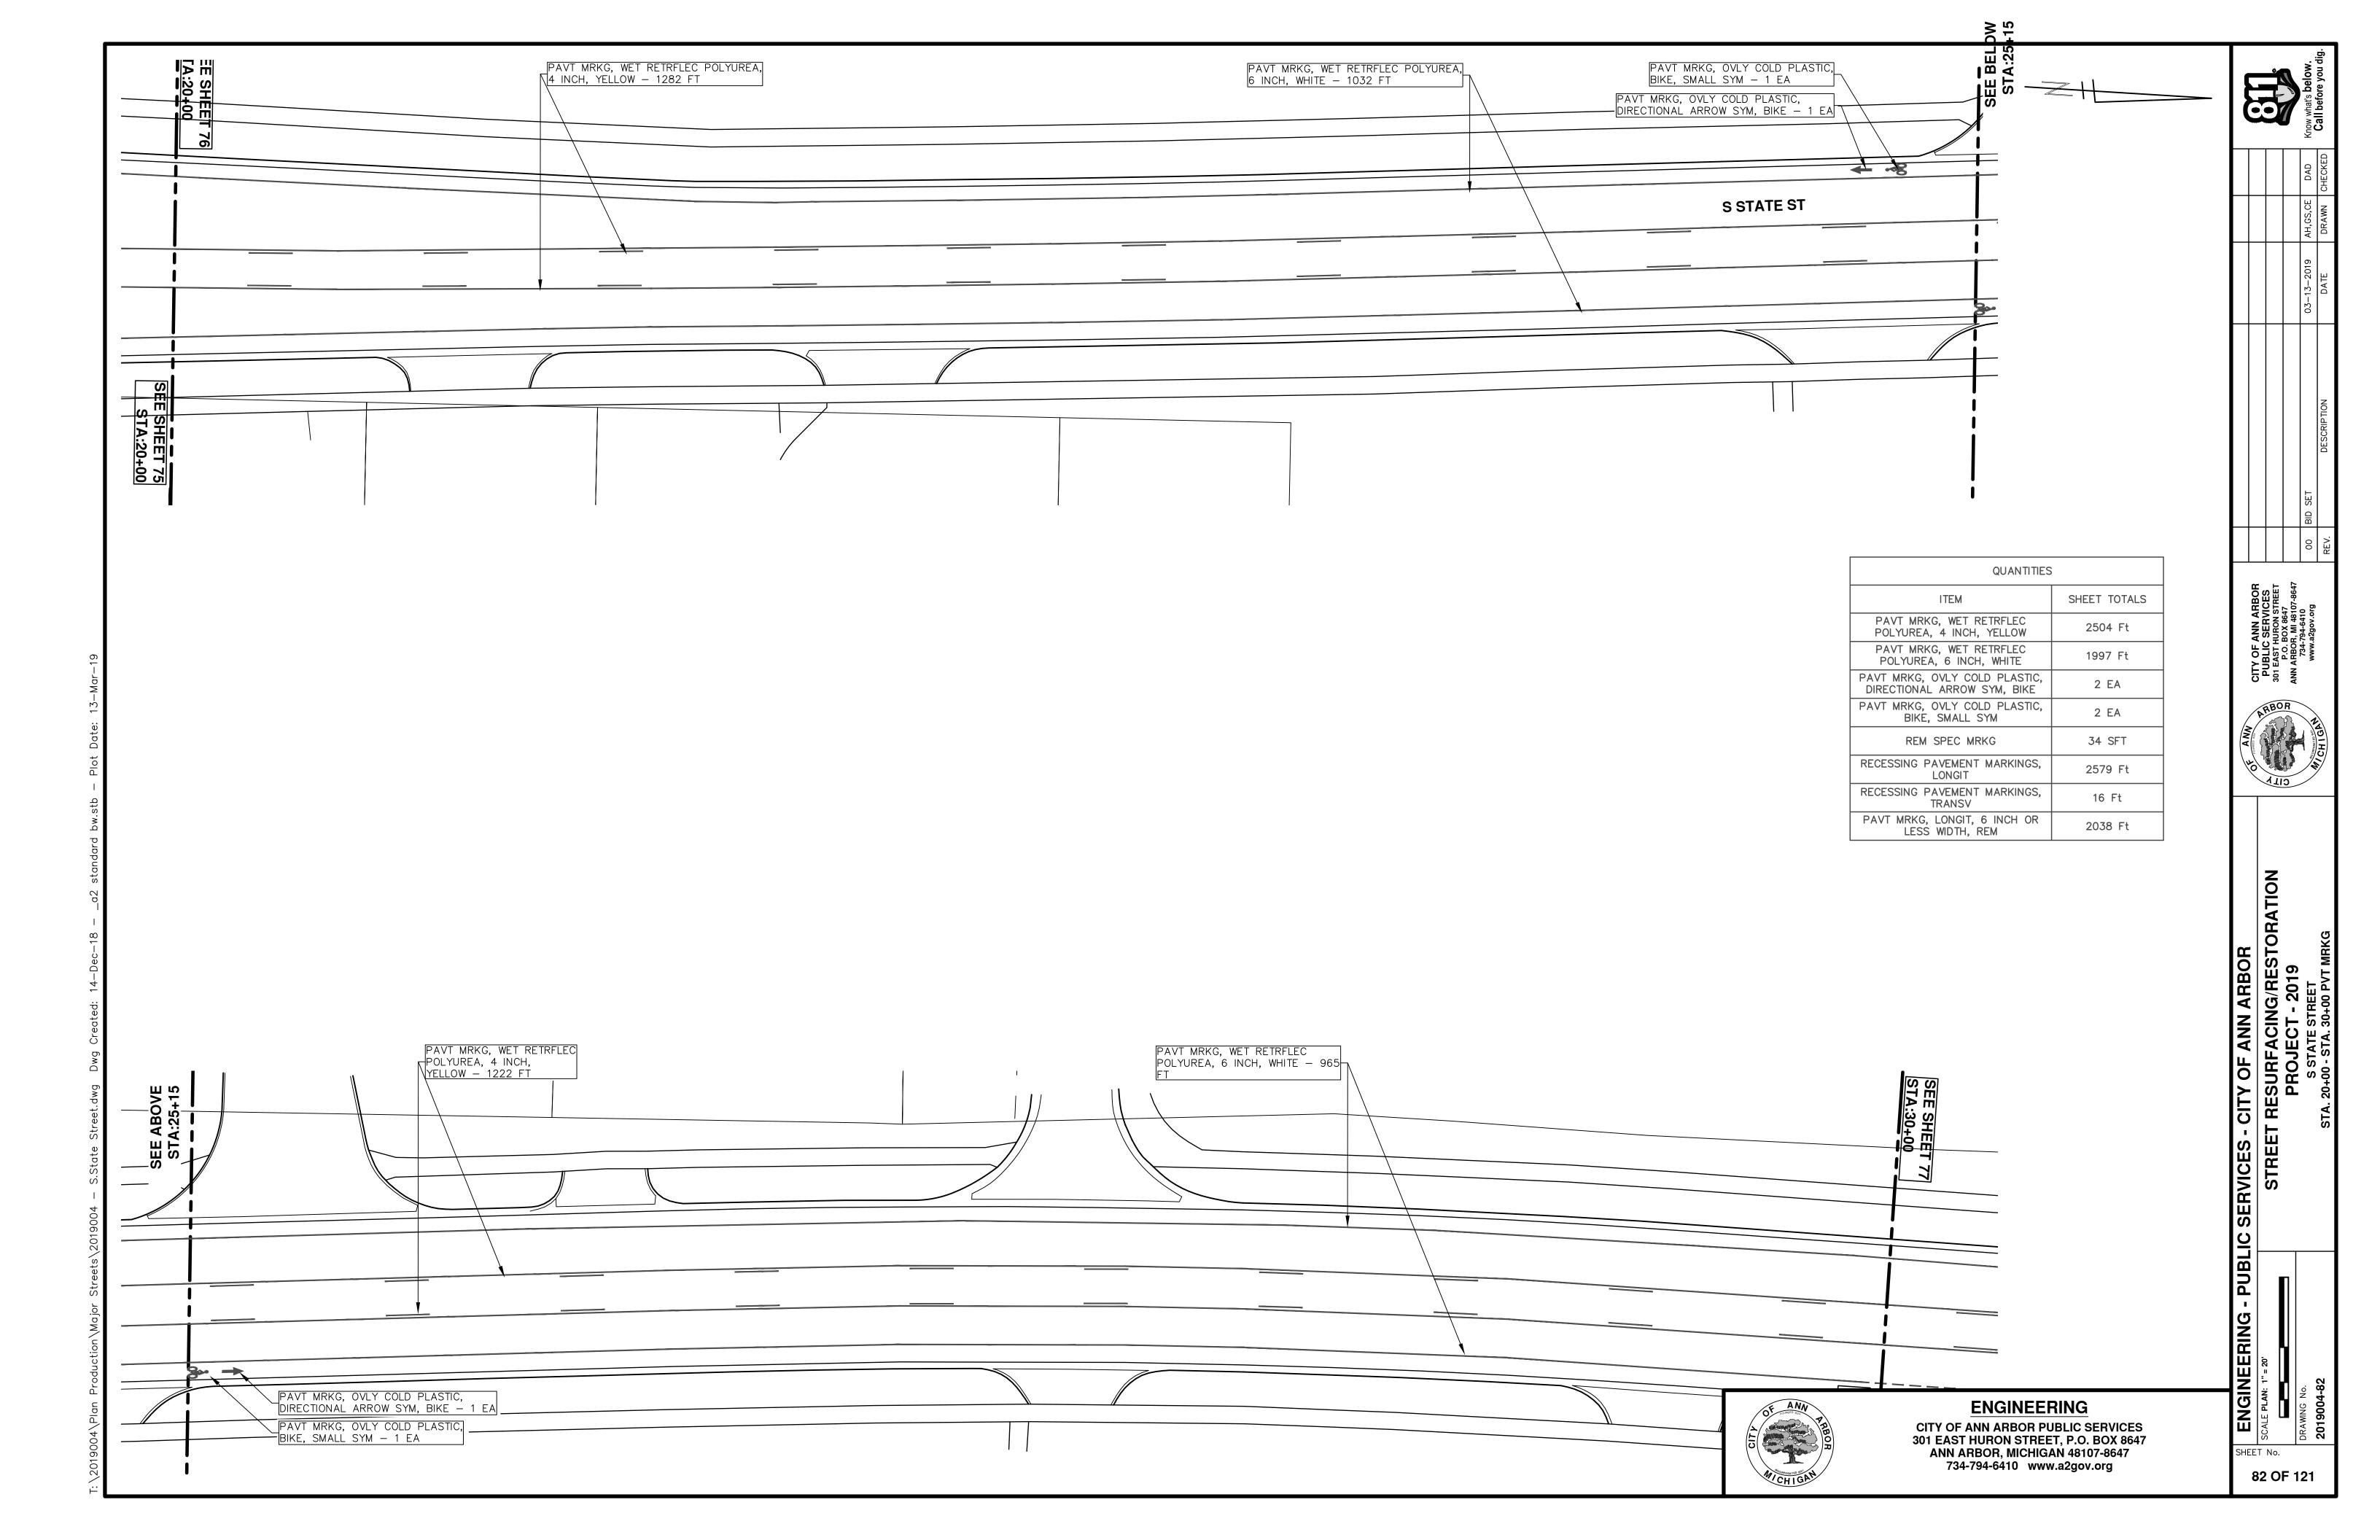

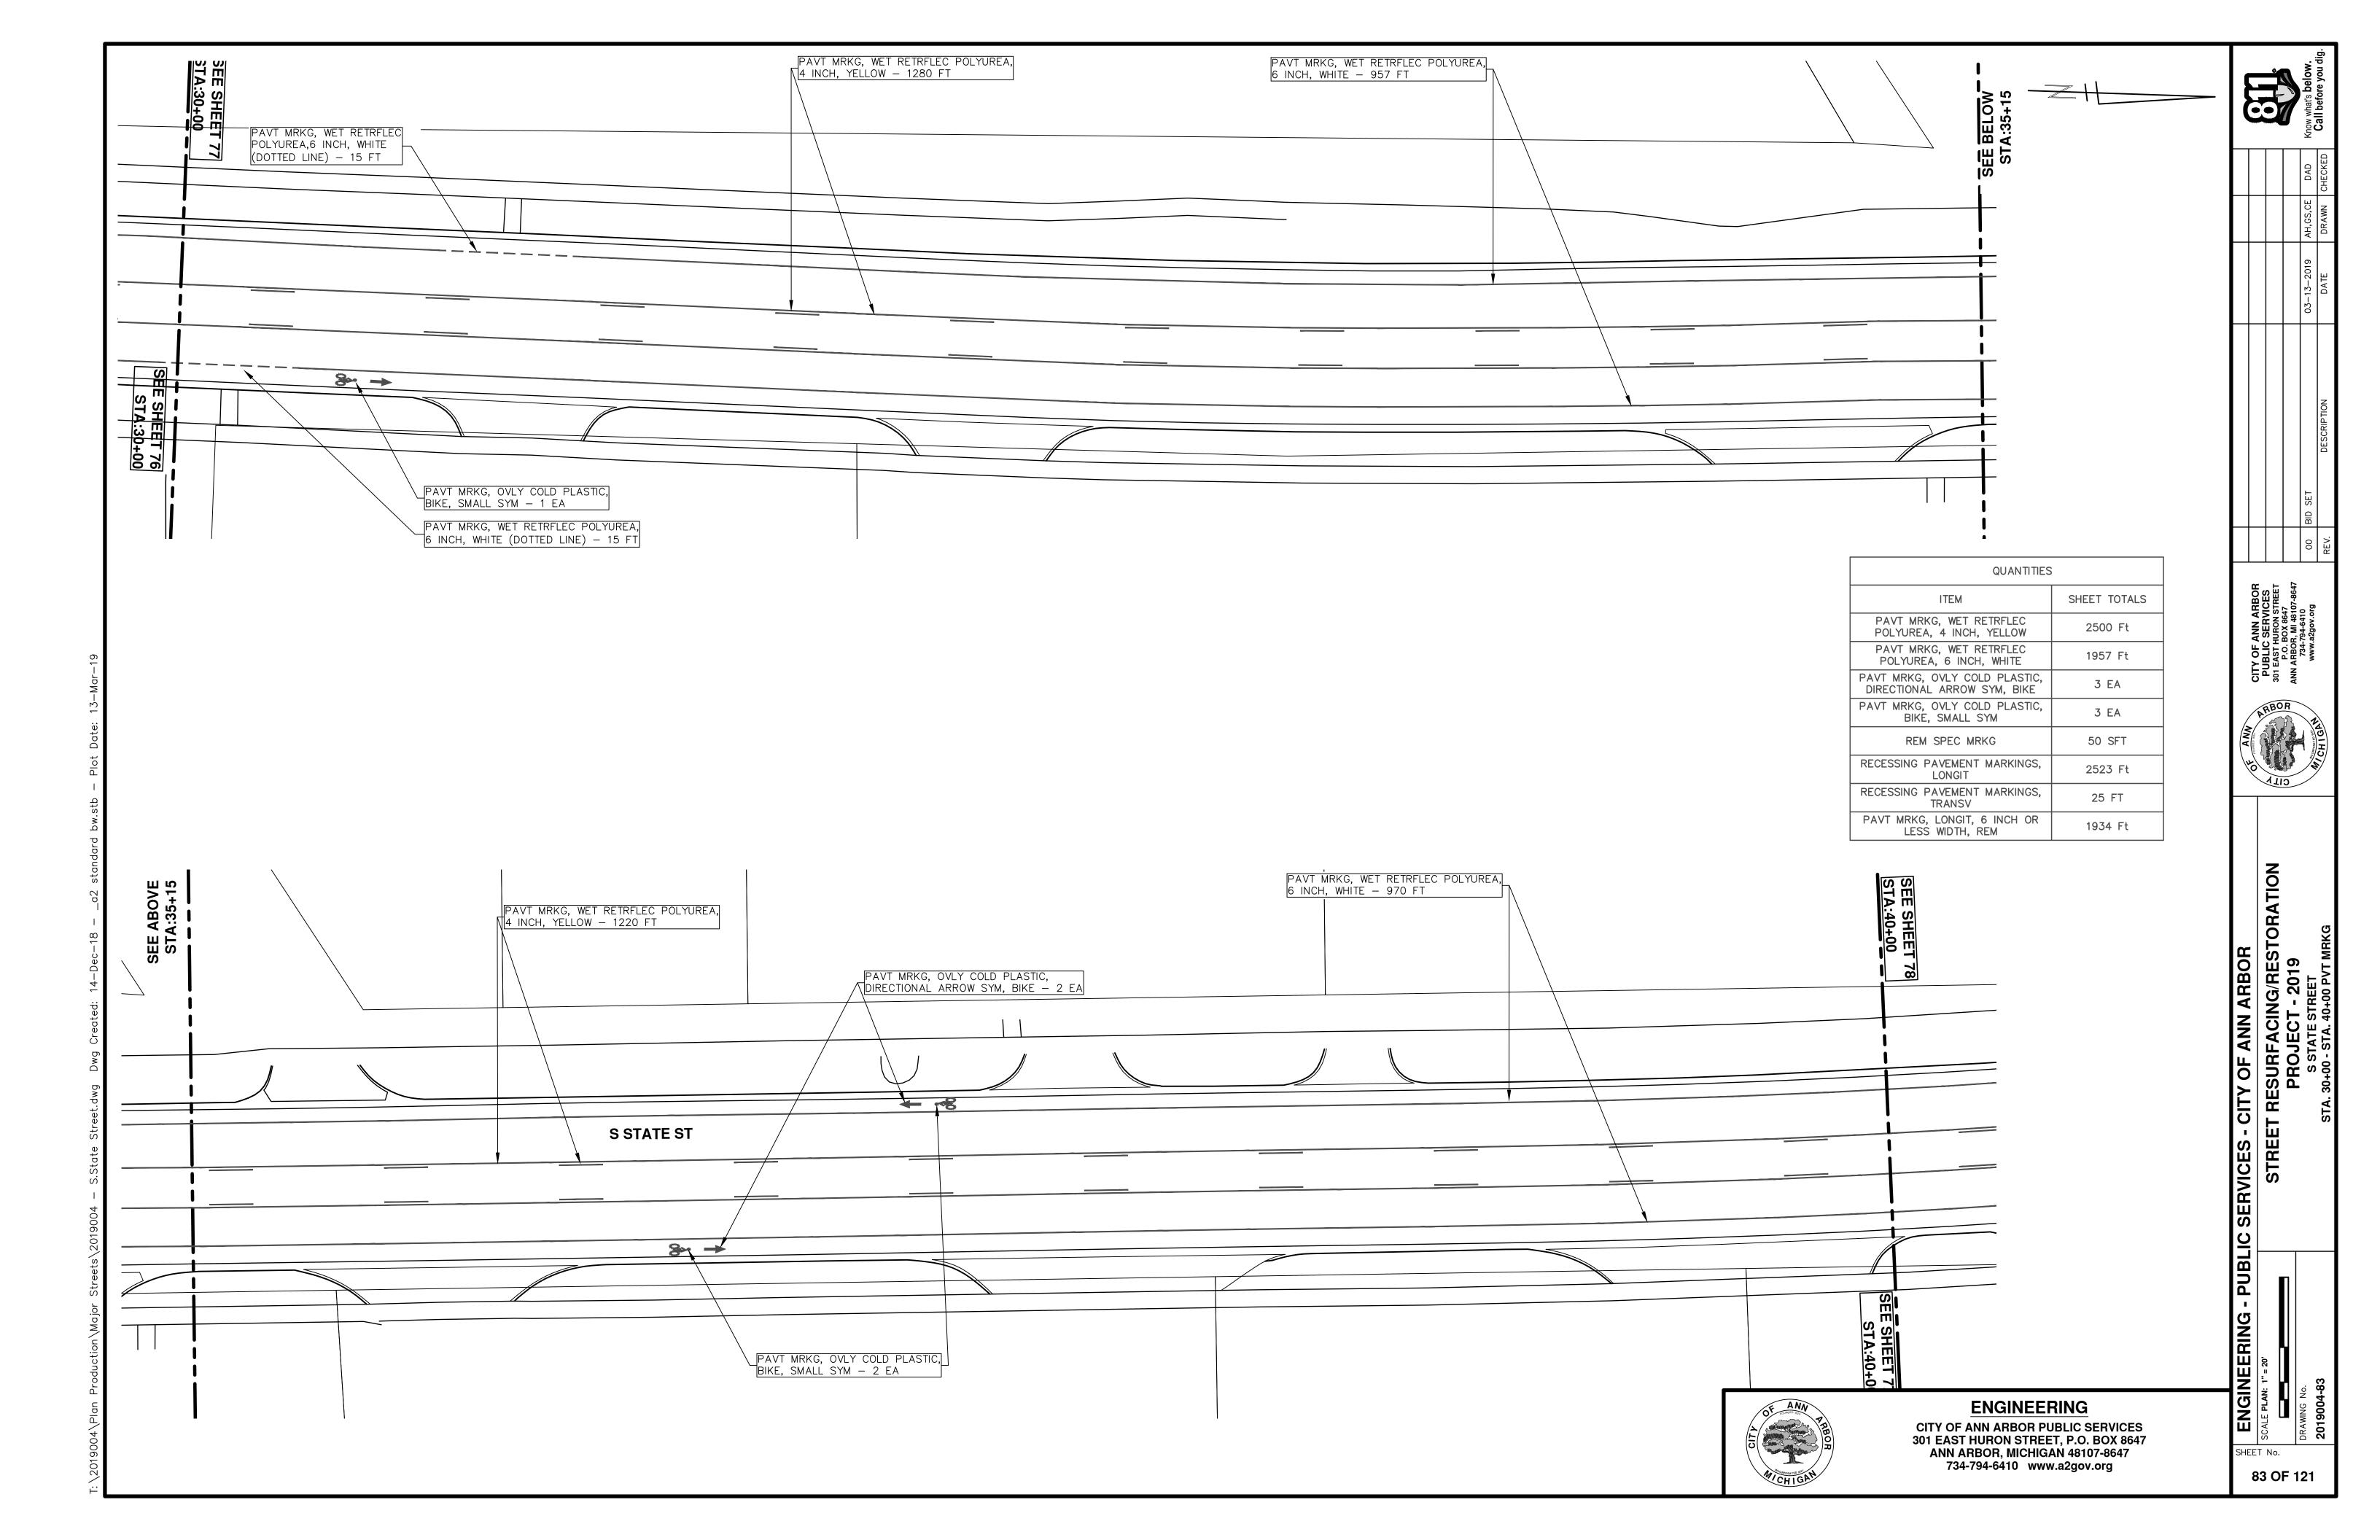

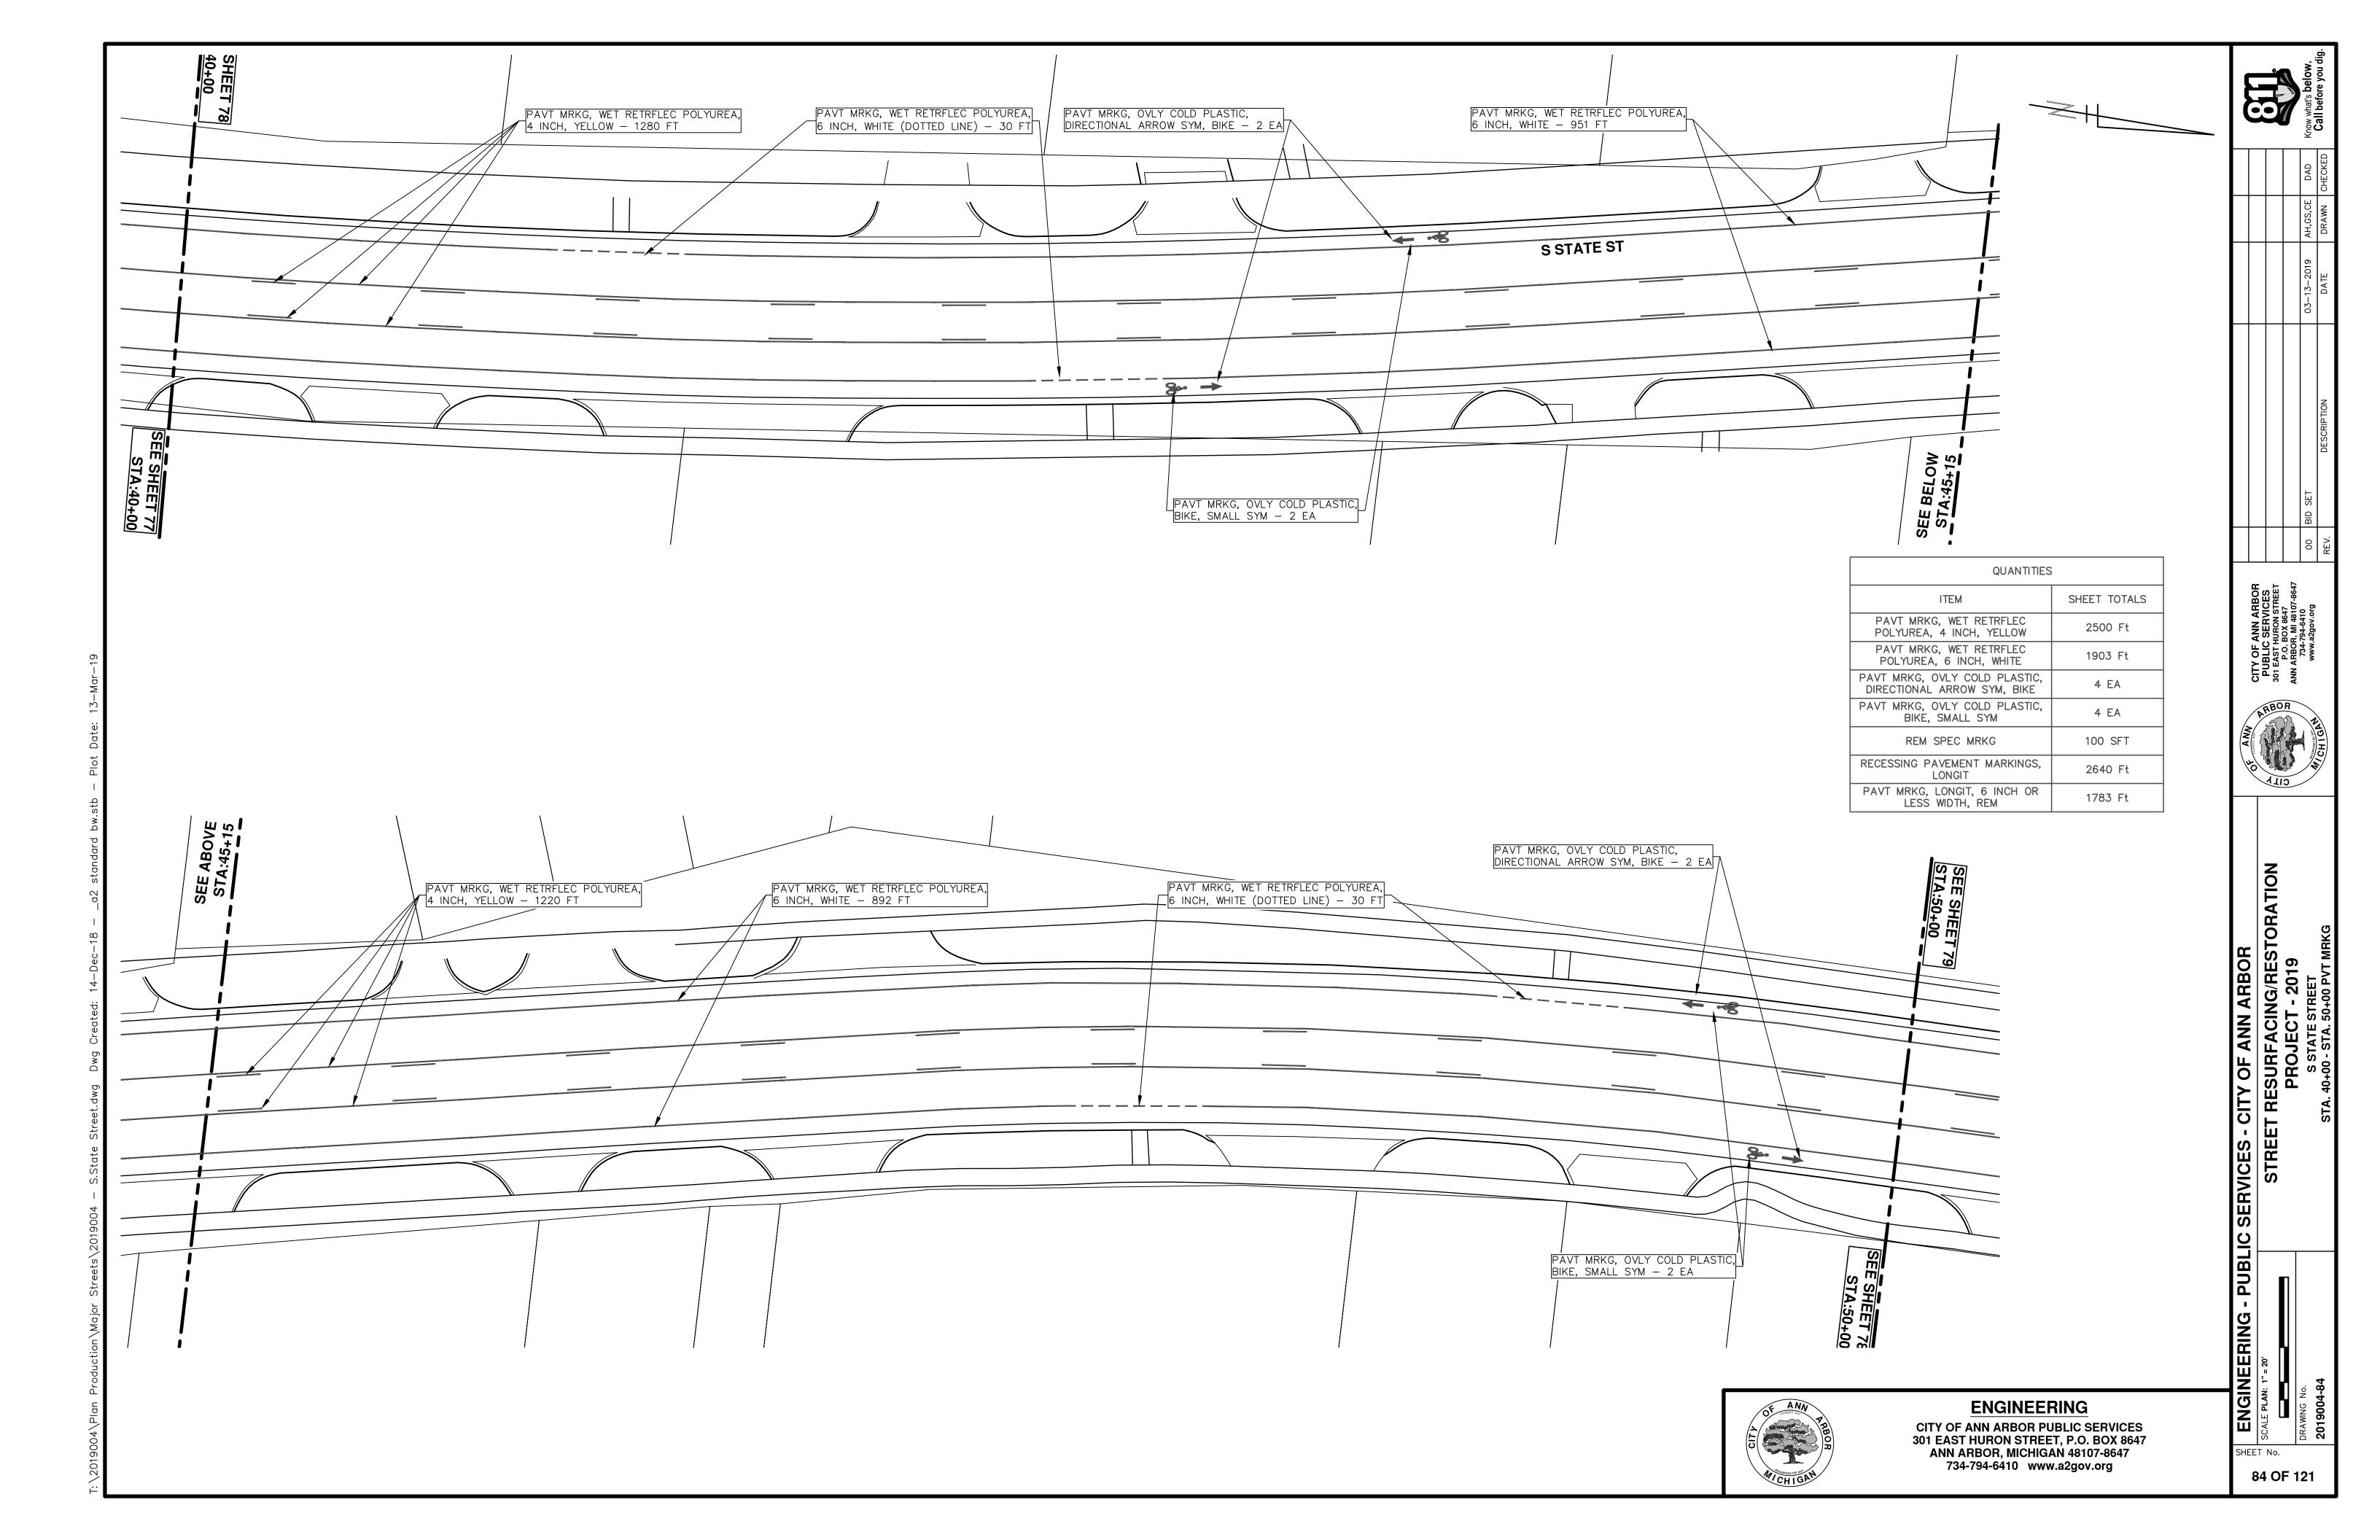

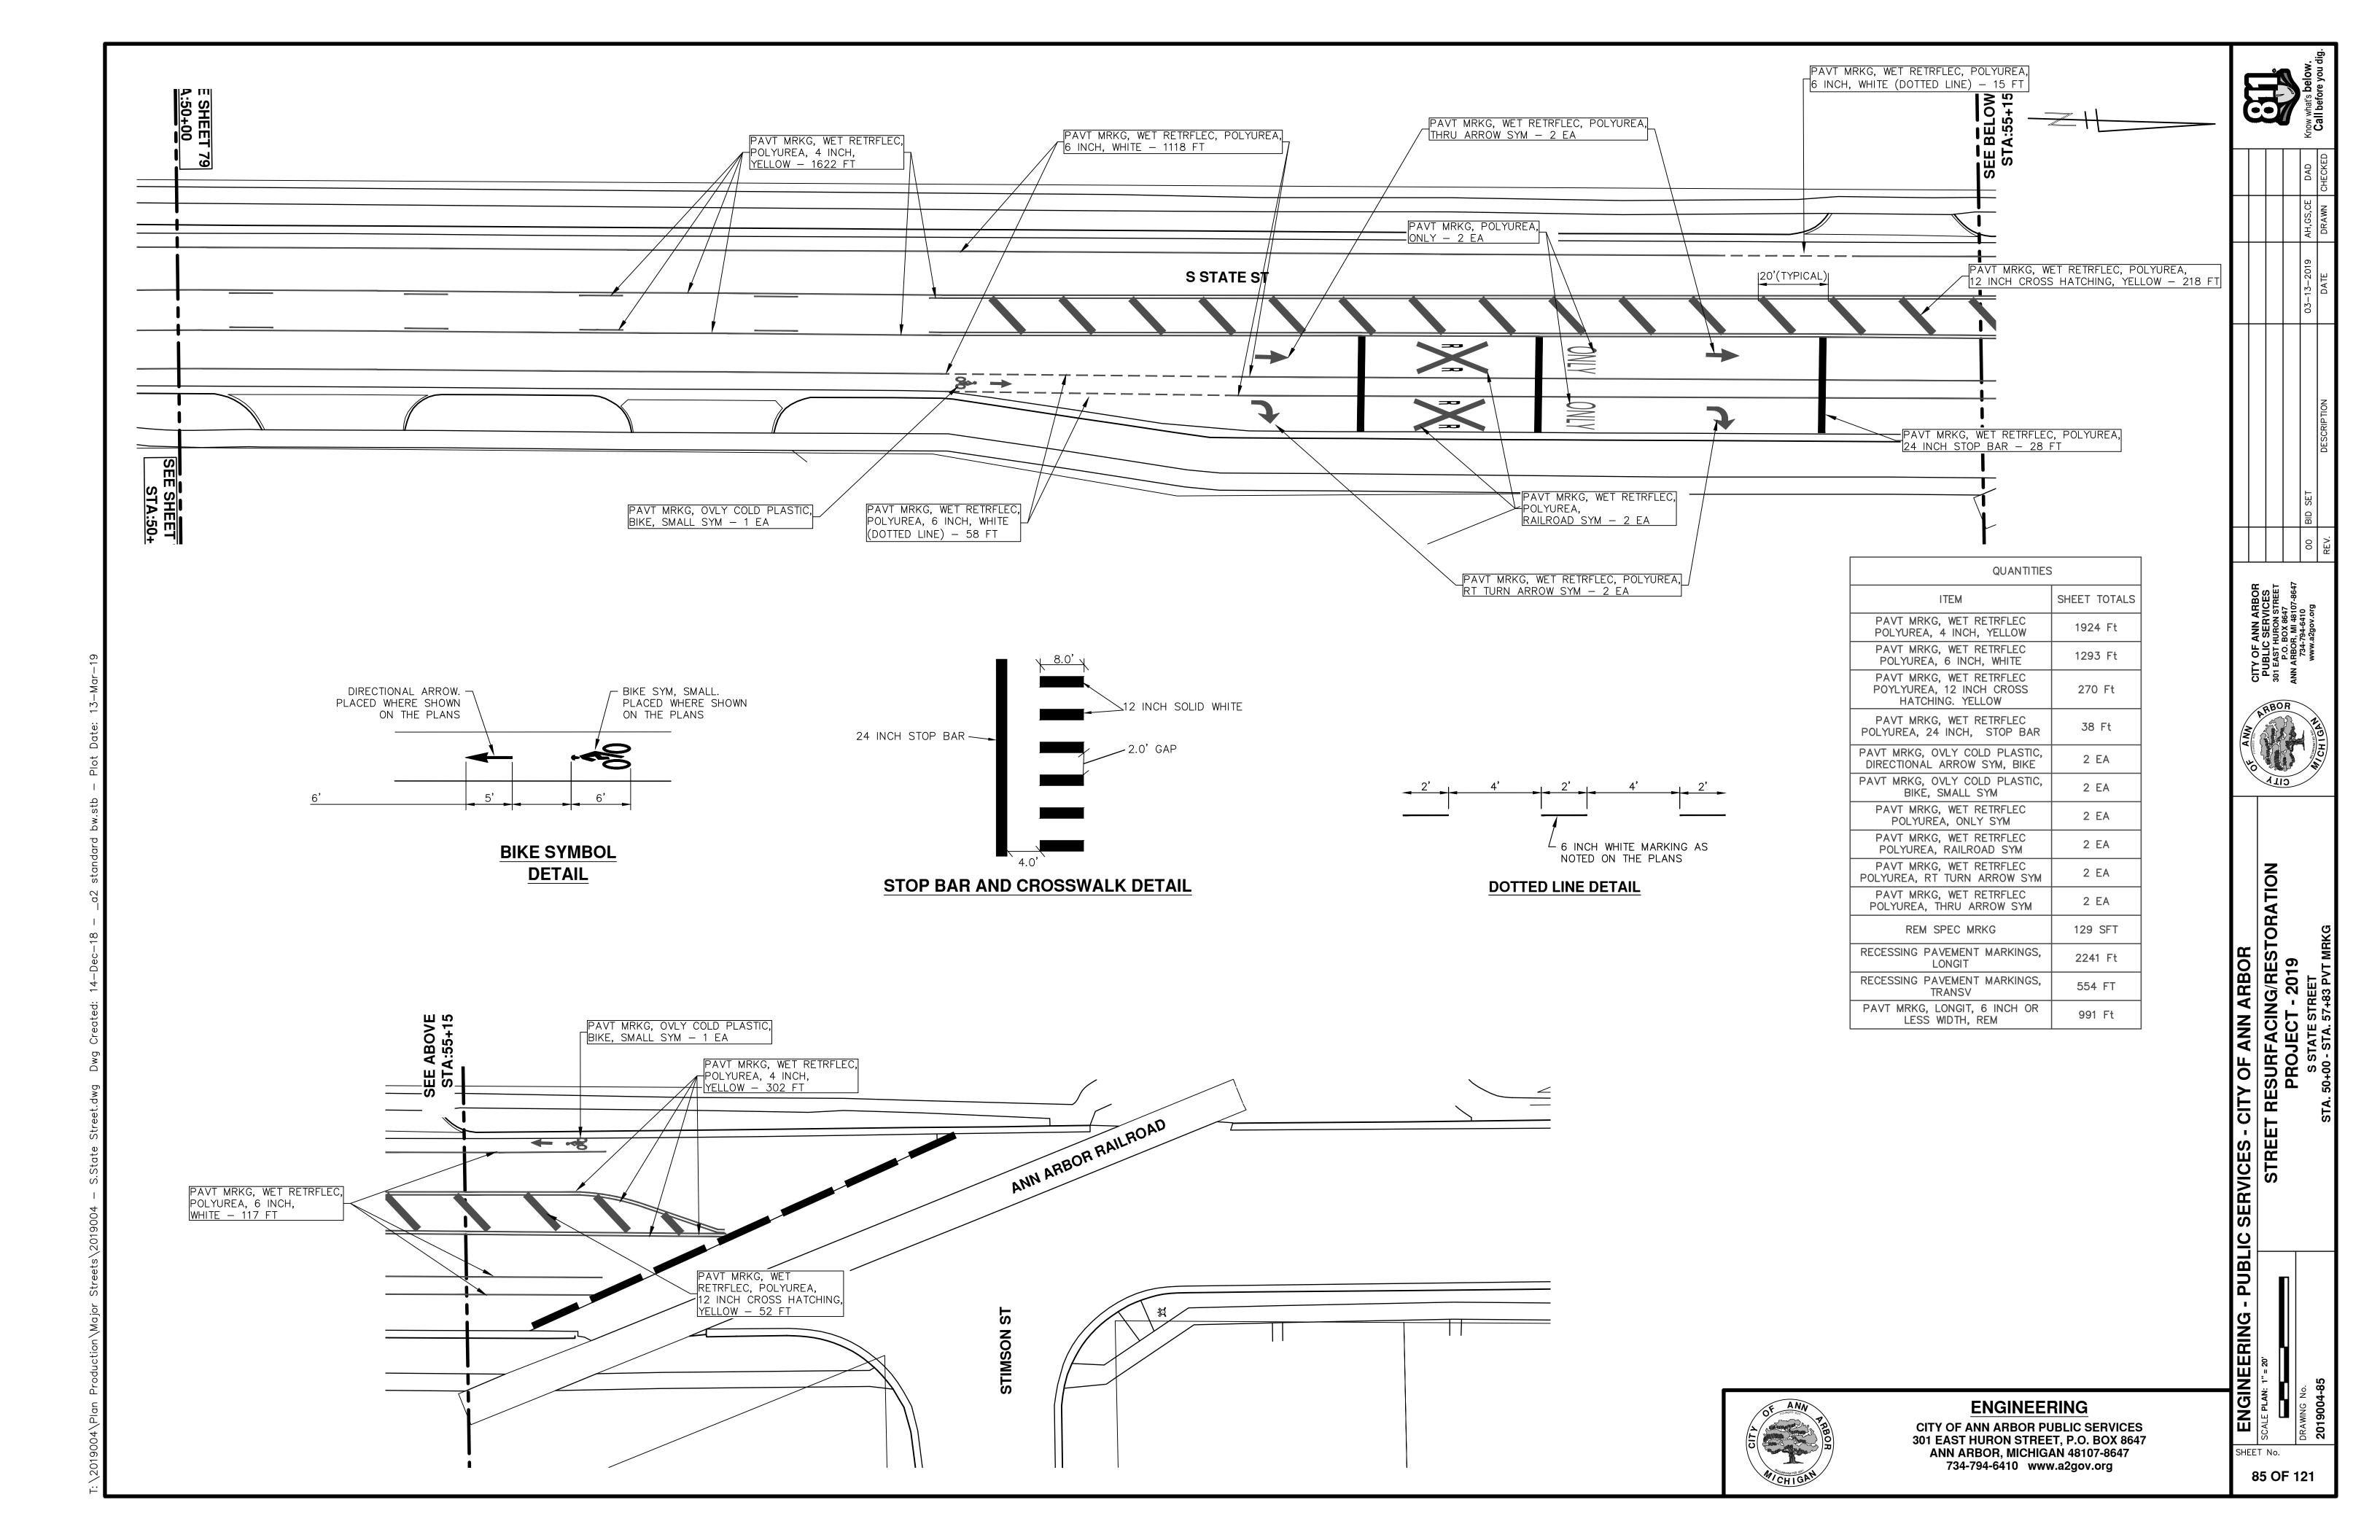



CITY OF ANN ARBOR ENGINEERING

PROJECT LOCATION: STONE SCHOOL ROAD

	CONSTRUCTION KEY
KEY	ASSOCIATED PAY ITEM(S)
	• _Dr Structure, Adj, Case 1, Modified
AA	• _Dr Structure, Adj, Case 2, Modified
	_Dr Structure, Temp Lowering, Modified
	• _Dr Structure, Temp Lowering, Modified
AB	Gate Box, Adj, Case 1Gate Box, Adj, Case 2
	Monument Box Adjust
ADST	Dr Structure, Adj, Add Depth, Modified
AK	• _Dr Structure, Adj, Case 1, Modified
	• _Sidewalk, Sidewalk Ramp, and Driveway Approach, Any Thickness, Rem
C4	• _Grading, Sidewalk
	• _Sidewalk, Conc, 4 inch, Modified
	 _Sidewalk, Sidewalk Ramp, and Driveway Approach, Any Thickness, Rem Grading, Sidewalk
C4HE	Cement
	Sidewalk, Conc, 4 inch, Modified
	• _Sidewalk, Sidewalk Ramp, and Driveway Approach, Any Thickness, Rem
	• _Grading, Sidewalk
C6	• _Grading, Sidewalk Ramp
	• _Detectable Warning Surface, Modified
	• _Sidewalk Ramp, Conc, 6 inch, Modified
	_Sidewalk, Conc, 6 inch, Modified_Grading, Driveway Approach
C8	Driveway, Nonreinf Conc, 8 inch, Modified
	• _Sidewalk, Sidewalk Ramp, and Driveway Approach, Any Thickness, Rem
	• _Grading, Driveway Approach
	• _Grading, Sidewalk
	• _Grading, Sidewalk Ramp
C HE	• Cement
	_Driveway, Nonreinf Conc, 6 inch, ModifiedDriveway, Nonreinf Conc, 8 inch, Modified
	Detectable Warning Surface, Modified
	Sidewalk Ramp, Conc, 6 inch, Modified
	Sidewalk, Conc, 6 inch, Modified
C/G	• _Curb, Gutter, and Curb and Gutter, Any Type, Rem
	• _Curb and Gutter, Conc
CICLIE	• _Curb, Gutter, and Curb and Gutter, Any Type, Rem
C/GHE	Cement _Driveway Opening, Conc, Det M, Modified
	Grading, Sidewalk
CP	• _Sidewalk, Conc, 4 inch, Modified
CR	• _Sidewalk, Sidewalk Ramp, and Driveway Approach, Any Thickness, Rem
	Dr Structure, Rem
DS	• Sewer, Rem, Less than 24 inch
	Dr Structure, 24 inch dia Dr Structure, Rem
DSDI	Sewer, Rem, Less than 24 inch
ВОВ	• _Dr Structure, Double Inlet
PT	Dr Structure, Point
	Dr Structure Cover, Type B
RRA	• _Dr Structure Cover, Type B, Special
	• _Dr Structure, Adj, Case 1, Modified
	• _Dr Structure, Temp Lowering, Modified
RRK	 Dr Structure Cover, Type K Dr Structure, Adj, Case 1, Modified
RS	• _Dr Structure, Reconstruct
	Plastic Drum, High Intensity, Lighted, Furn
TYPE II	Plastic Drum, High Intensity, Lighted, Oper
TYPE III	Barricade, Type III, High Intensity, Double Sided, Lighted, Furn
=	Barricade, Type III, High Intensity, Double Sided, Lighted, Oper

ITB No. 4570 FILE No. 2019004

FOR PROTECTION OF UNDERGROUND UTILITIES AND IN CONFORMANCE WITH PUBLIC ACT 174 OF 2013, THE CONTRACTOR SHALL CALL 811 OR 1-800-482-7171 A MINIMUM OF THREE FULL WORKING DAYS, EXCLUDING SATURDAYS, SUNDAYS, AND HOLIDAYS, PRIOR TO BEGINNING EACH EXCAVATION IN AREAS WHERE PUBLIC UTILITIES HAVE NOT BEEN PREVIOUSLY LOCATED. MEMBERS WILL THUS BE ROUTINELY NOTIFIED. THIS DOES NOT RELIEVE THE CONTRACTOR OF THE RESPONSIBILITY OF NOTIFYING UTILITY OWNERS WHO MAY NOT BE A PART OF THE "MISS DIG" ALERT SYSTEM.

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ENGINEERING

CITY OF ANN ARBOR PUBLIC SERVICES 301 EAST HURON STREET, P.O. BOX 8647 ANN ARBOR, MICHIGAN 48107-8647 734-794-6410 www.a2gov.org

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		DAD	DRAWN CHECKED	
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		03-13-2019	DATE	
		SET	DESCRIPTION	



SHEET No.



DETOUR CONSTRUCTION NOTES:

- DEPENDING ON THE DETOUR ROUTES THAT ARE PUT IN PLACE, CONFLICTING SIGNS MAY BE PRESENT. PRIOR TO THE ORDERING OR PLACEMENT OF ANY SIGNS, MEET WITH THE ENGINEER TO VERIFY THE EXACT NUMBER AND LOCATION OF THE SIGNS TO BE PLACED. THE ENGINEER AND THE CONTRACTOR SHALL WORK TOGETHER TO ELIMINATE ALL CONFLICTS.
- 2. THE CITY RESERVES THE RIGHT TO ORDER ADDITIONAL SIGNS AND PLACE THEM INTO SERVICE IN ORDER TO SAFELY MAINTAIN TRAFFIC. ADJUSTMENTS IN THE UNIT PRICE FOR THESE ITEMS OF WORK SHALL NOT BE ALLOWED FOR THESE
- 3. THE CONTRACTOR SHALL COORDINATE HIS OPERATIONS WITH THOSE OF THE CITY OF ANN ARBOR'S SIGNS AND SIGNALS UNIT DURING THE COURSE OF THE DETOUR ROUTE ESTABLISHMENT TO EFFECTIVELY AND SAFELY MAINTAIN TRAFFIC. DO NOT ERECT ANY SIGNS UNTIL ITS LOCATION AND PROPOSED DATE OF INSTALLATION IS APPROVED BY THE ENGINEER.
- 4. THIS DETOUR IS TO BE IN PLACE DURING GEDDES AVE. CONSTRUCTION AS DIRECTED BY THE ENGINEER, THE CONTRACTOR WILL CLOSE AND DETOUR EAST AND WEST BOUND GEDDES AVE. TRAFFIC. SEE "SPECIAL PROVISION FOR MAINTAINING TRAFFIC AND CONSTRUCTION SEQUENCING" FOR DETAILS ON CONSTRUCTION STAGING, SEQUENCING, CLOSURE AND DETOUR LIMITATIONS, AND OTHER DETAILS.
- 5. REFERENCE THE "DETAILED SPECIFICATION FOR MAINTAINING TRAFFIC AND CONSTRUCTION SEQUENCING" FOR ADDITIONAL PROJECT REQUIREMENTS. THE CONTRACTOR'S ATTENTION IS SPECIFICALLY DIRECTED TO THE SECTION OF SAME SPECIAL PROVISION REGARDING COORDINATION WITH THE CITY SIGNS AND SIGNALS UNIT FOR THE SEVERAL DETOUR ROUTE MODIFICATIONS AND THE MODIFICATIONS TO TRAFFIC SIGNALS FOR THE DETOUR.
- 6. THE CONTRACTOR SHALL FURNISH, ERECT, AND MAINTAIN SIGNS AS SHOWN ON THE PLANS OR OTHERWISE DIRECTED BY THE ENGINEER.
- 7. CONSTRUCTION WARNING SIGNS SHALL HAVE AN ORANGE, HIGH-INTENSITY, REFLECTORIZED BACKGROUND.
- 8. SIGNS SHALL CONFORM TO THE 2011 MICHIGAN MANUAL OF UNIFORM TRAFFIC CONTROL DEVICES.
- 9. THE CONTRACTOR SHALL DRIVE ALL SIGNS INTO EXPOSED GROUND OR INSERT INTO A BORED HOLE IN PAVEMENT AS NECESSARY TO PERMANENTLY SECURE. ALL HOLES IN PAVEMENT SHALL BE FILLED WITH ENGINEER-APPROVED MORTAR WHEN THE SIGN IS REMOVED AND NO LONGER NEEDED. COSTS FOR THIS WORK SHALL BE INCLUDED IN THE PAY ITEM "SIGN, TYPE B, TEMP, PRISMATIC, FURN" OR "SIGN, TYPE B, TEMP, PRISMATIC, FURN, SPECIAL"


O1	ON SIGN, TIFE B, TEMP, PINISMATIC, I				
	TRAFFIC CONTROL SIGN				
	SIGN	NUMBER	QUANTITY		
22)	LEFT LANE CLOSED AHEAD	W20-5L 36"x36"	5		
23)		W4-2L 36"x36"	5		
24)	WORK ZONE BEGINS	R5–18C 48"x48"	5		
25)	EAST BOUND STONE SCHOOL RD CLOSED AT WASHITENAW AVE FOLLOW DETOUR	SPECIAL 48x66	5		
26	WEST BOUND STONE SCHOOL RD CLOSED AT OBSERVATORY ST FOLLOW DETOUR	SPECIAL 48x66	5		
27)	DO NOT ENTER	R5-1 36x36	5		
	PORTABLE, BLE MESSAGE	QUAN LOCA	TY EXACT ITITY AND TION WITH ERPRIOR		

<u>LEGEND:</u>

EAST BOUND GEDDES AVE DETOUR ROUTE

WEST BOUND GEDDES AVE DETOUR ROUTE

GEDDES AVE WORK ZONE

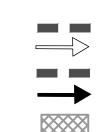

TO ORDERING



ENGINEERING


CITY OF ANN ARBOR PUBLIC SERVICES 301 EAST HURON STREET, P.O. BOX 8647 ANN ARBOR, MICHIGAN 48107-8647 734-794-6410 www.a2gov.org




TESURFACING/REST PROJECT - 2019
STONE SCHOOL ROAD DETOUR PLAN

ENGINEERING - PUBLIC SERVICES

SHEET No.

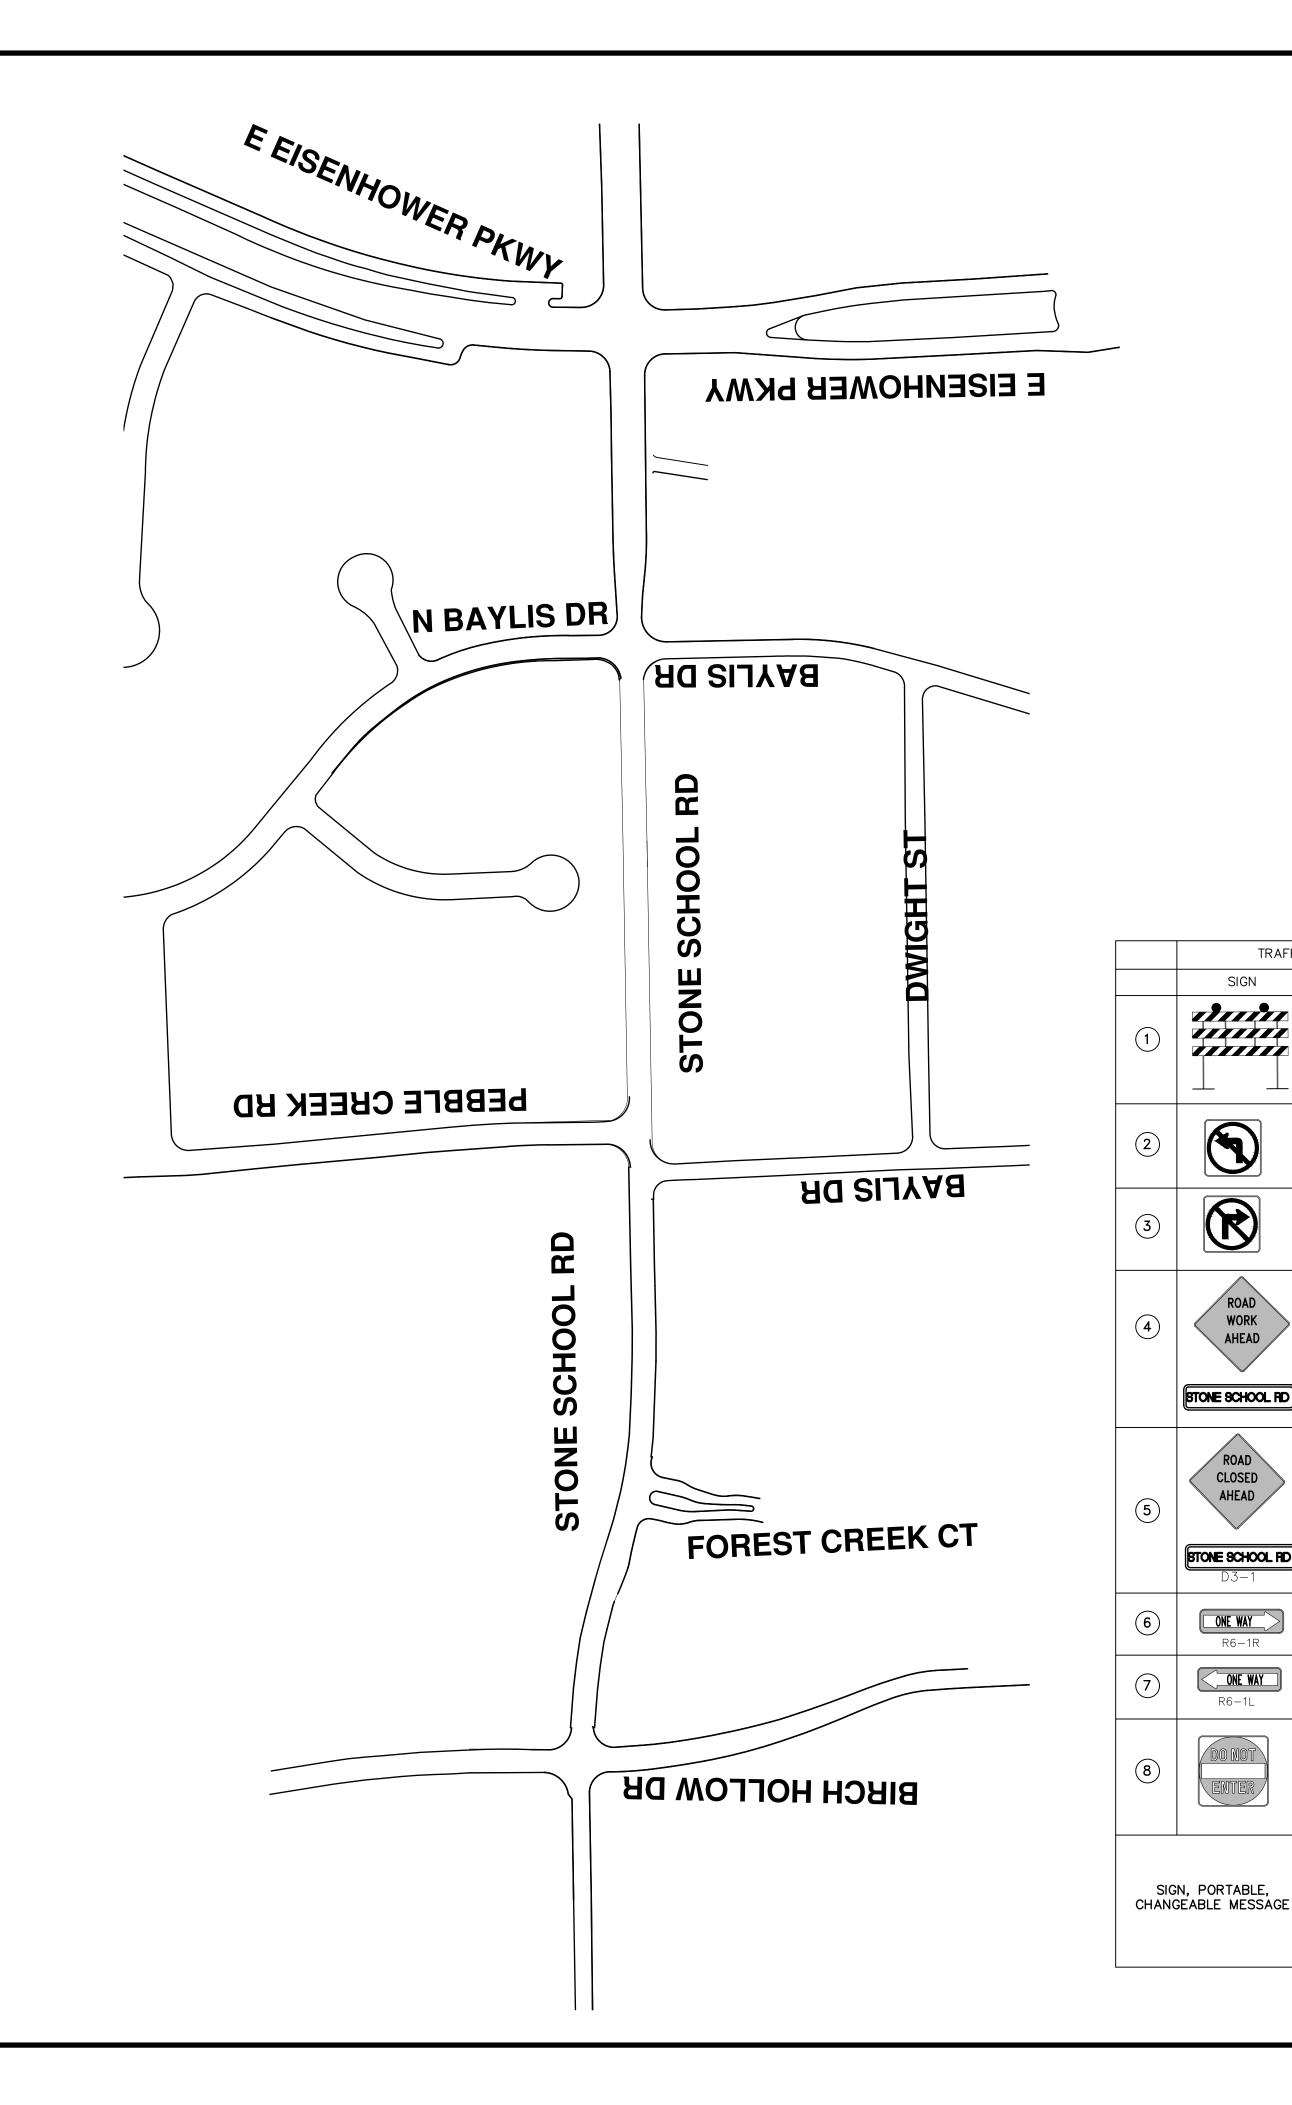

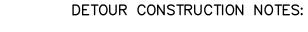

TRAFFIC CONTROL SIGN

HIGH INTENSITY LIGHTED

24"x24"

24"x24"

W20-1

36"x36"

W20 - 3

36"x36"

36"x12"

36"x12"

36"x36"

VERIFY EXACT QUANTITY AND

LOCATION WITH

ENGINEER PRIOR

TO ORDERING

WORK

STONE SCHOOL RD

CLOSED

STONE SCHOOL RD

ONE WAY

ONE WAY


R6-1R

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ENGINEERING

CITY OF ANN ARBOR PUBLIC SERVICES 301 EAST HURON STREET, P.O. BOX 8647 ANN ARBOR, MICHIGAN 48107-8647 734-794-6410 www.a2gov.org



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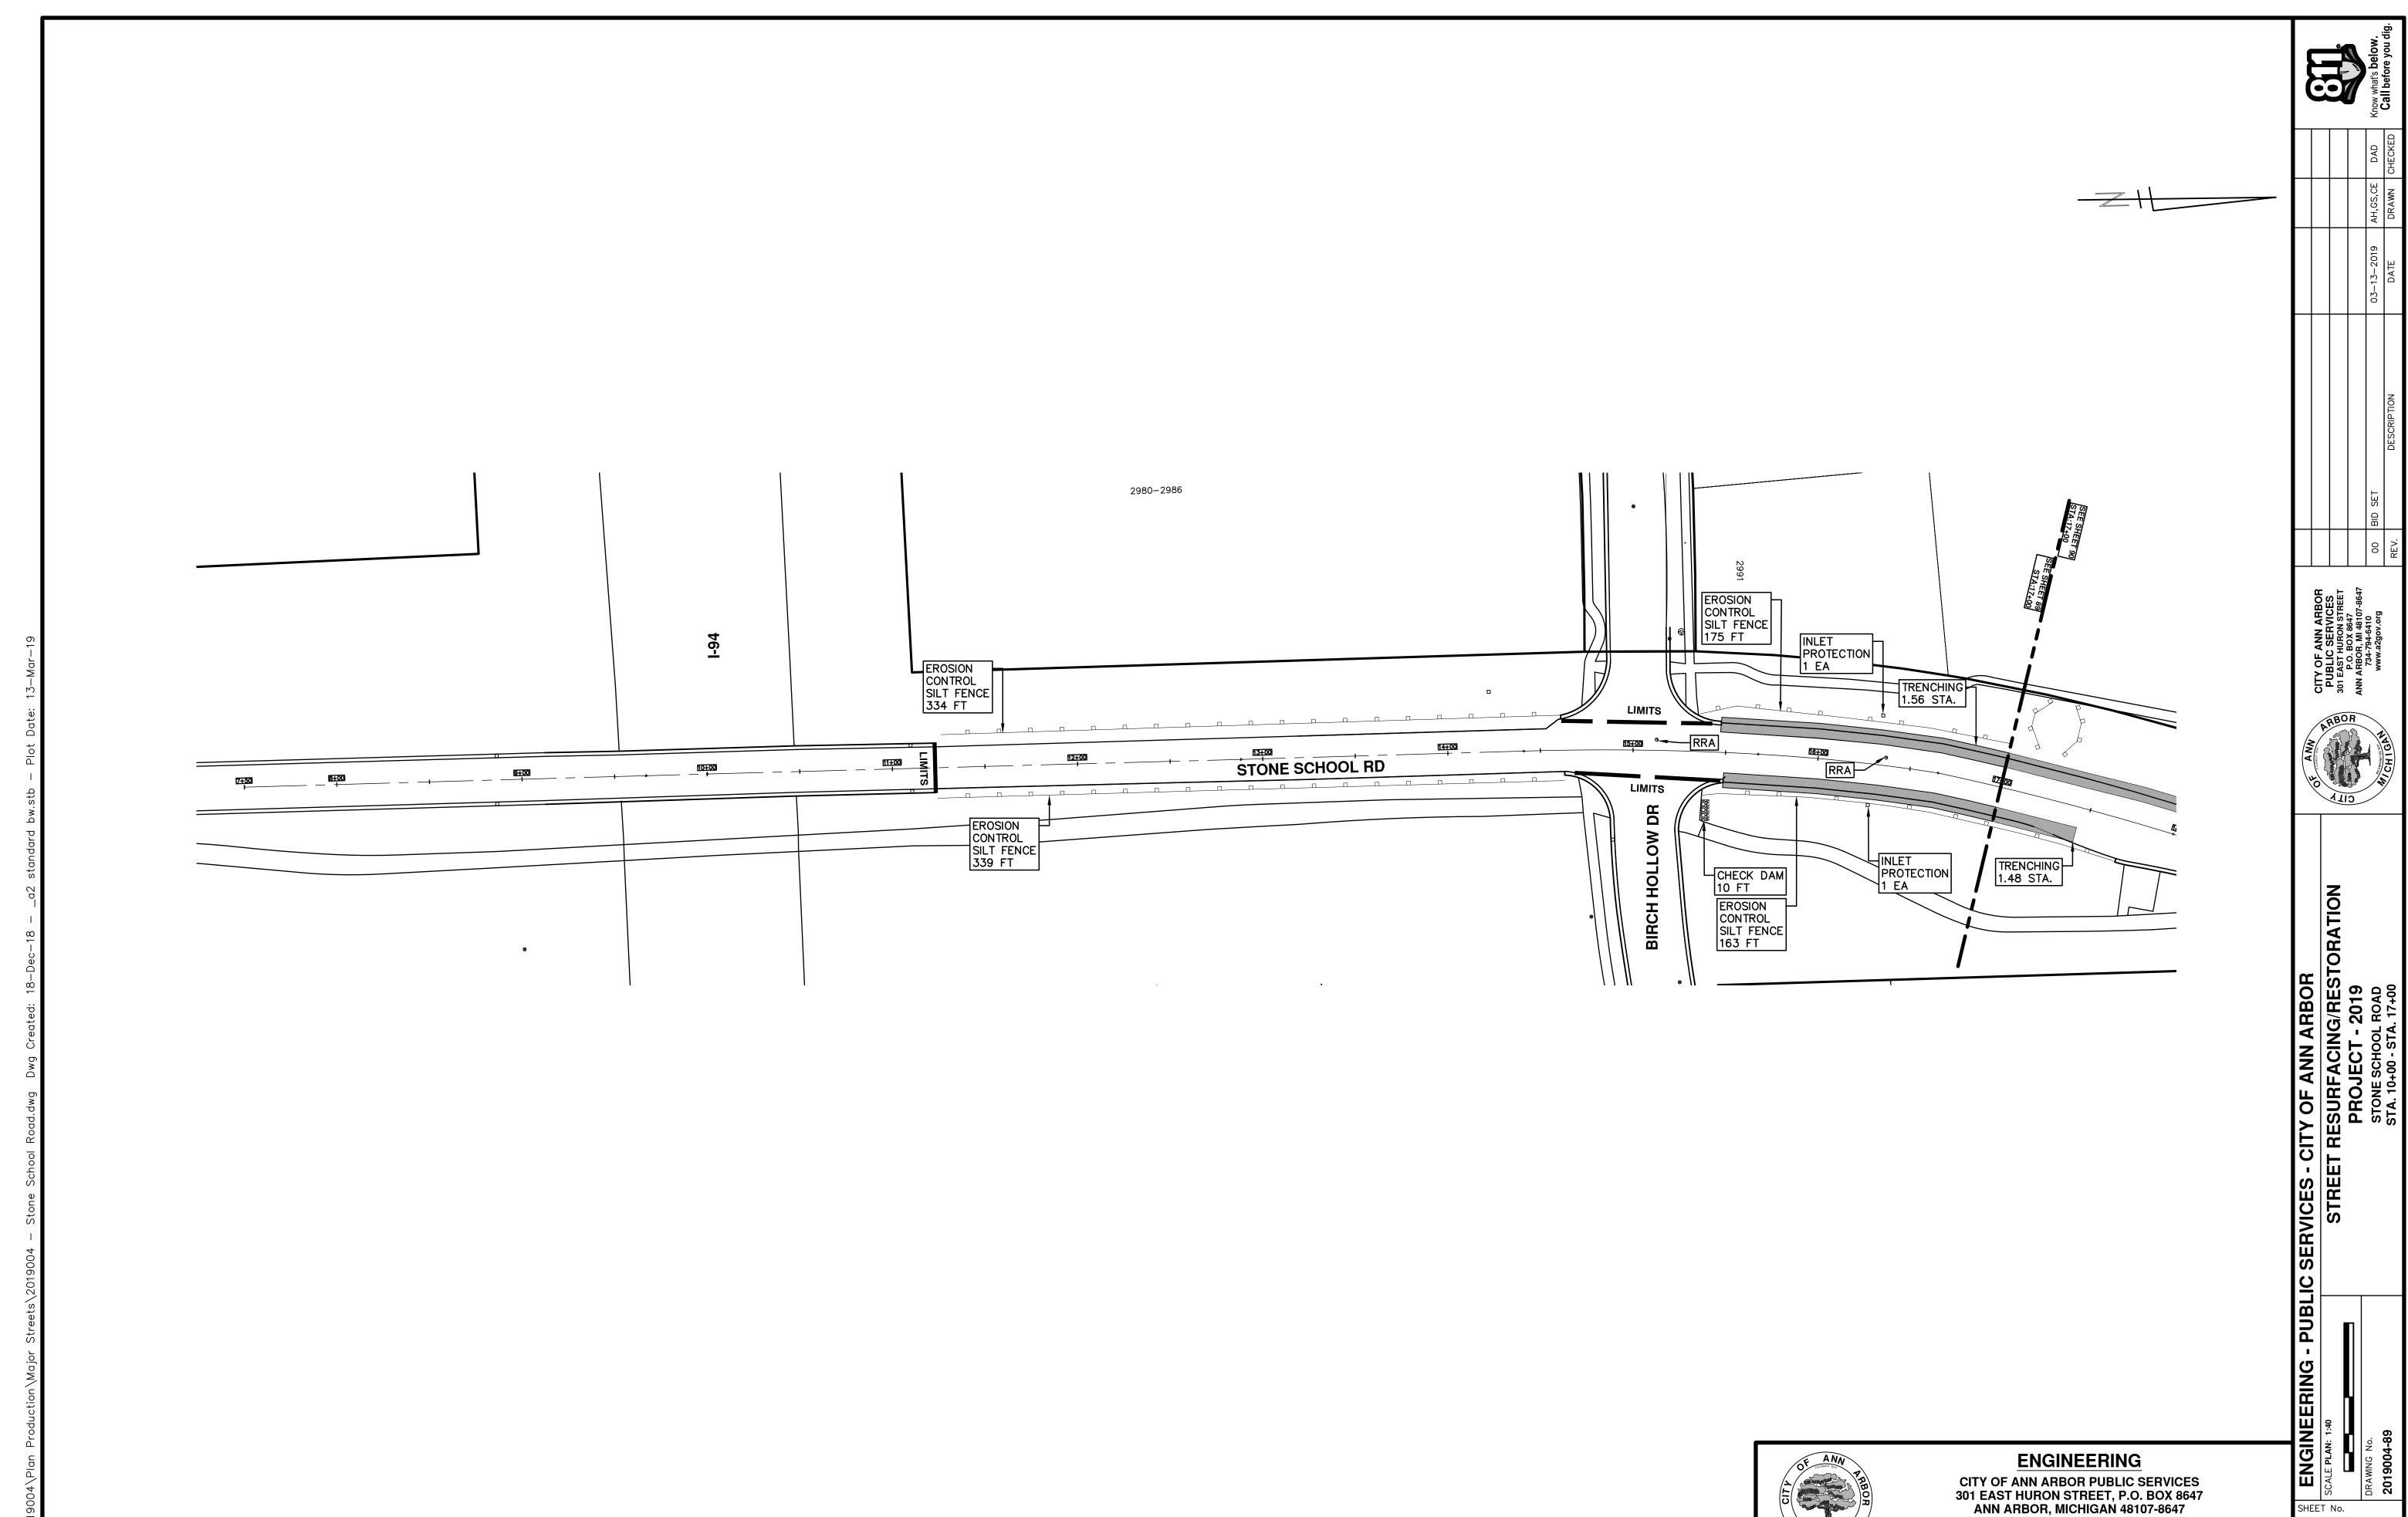
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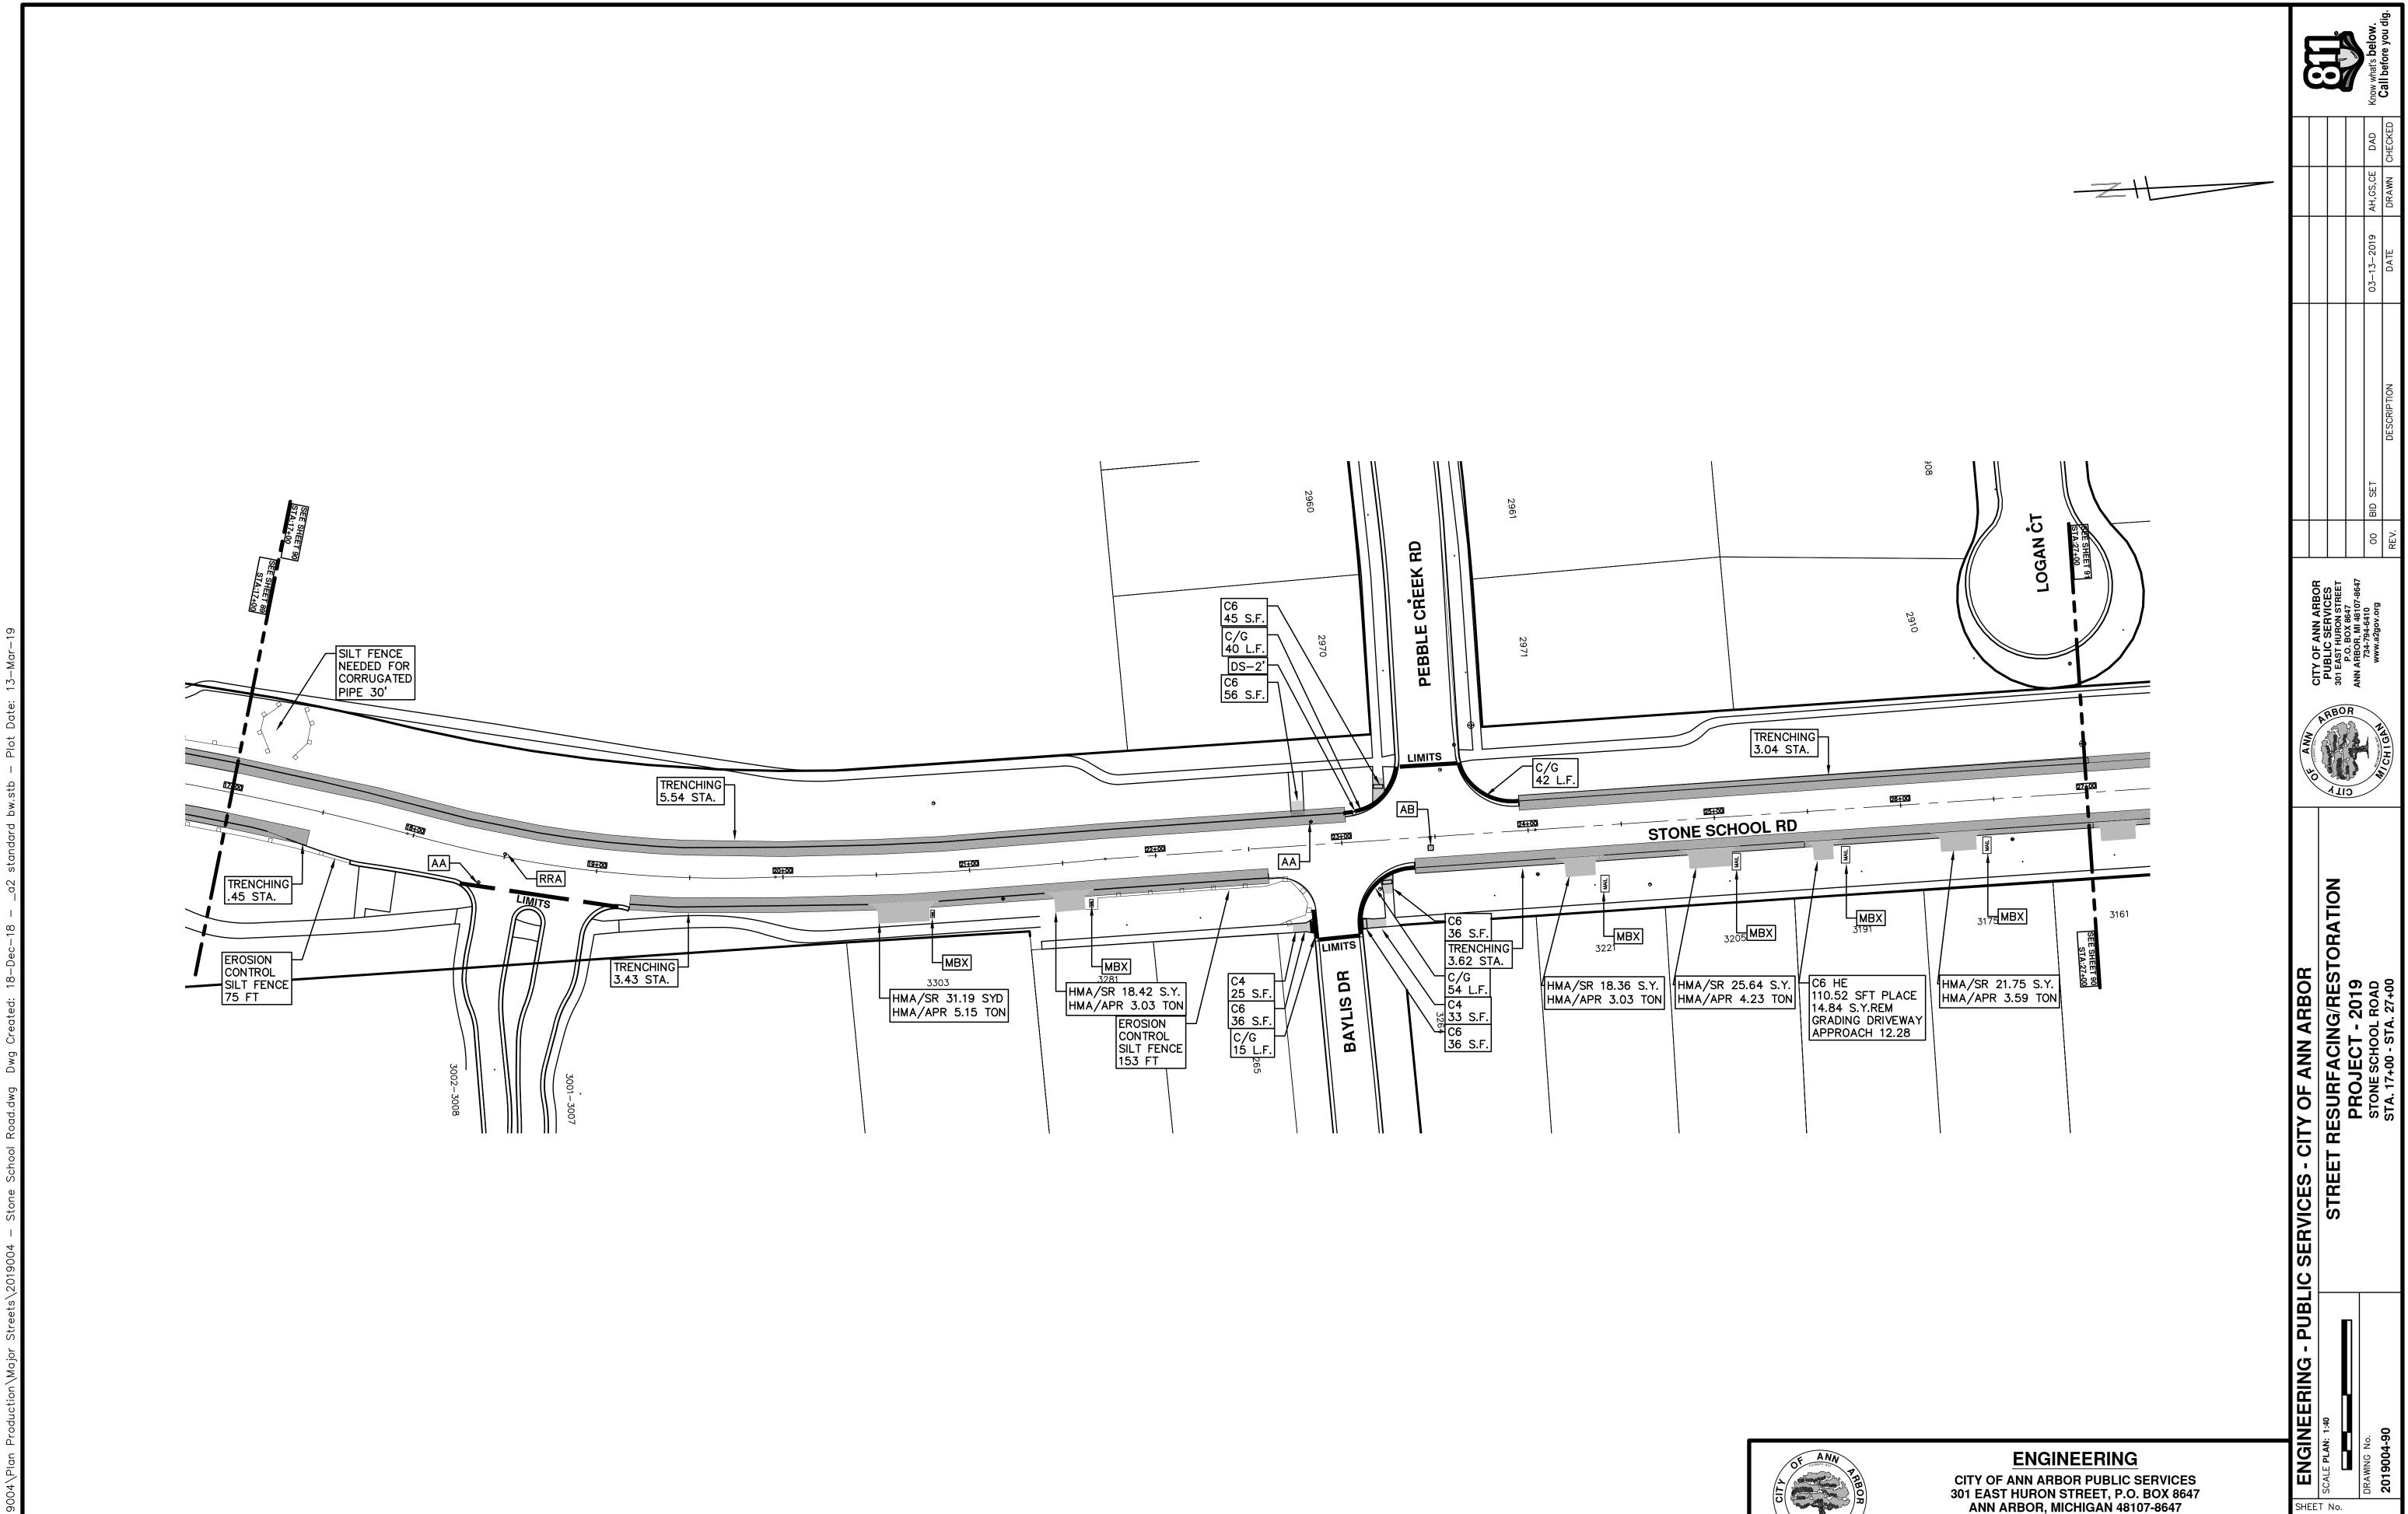
PROJECT - 2019

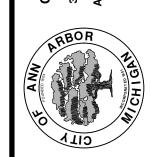
STONE SCHOOL ROAD

TRAFFIC CONTROL

SHEET No.







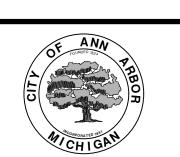



ENGINEERING


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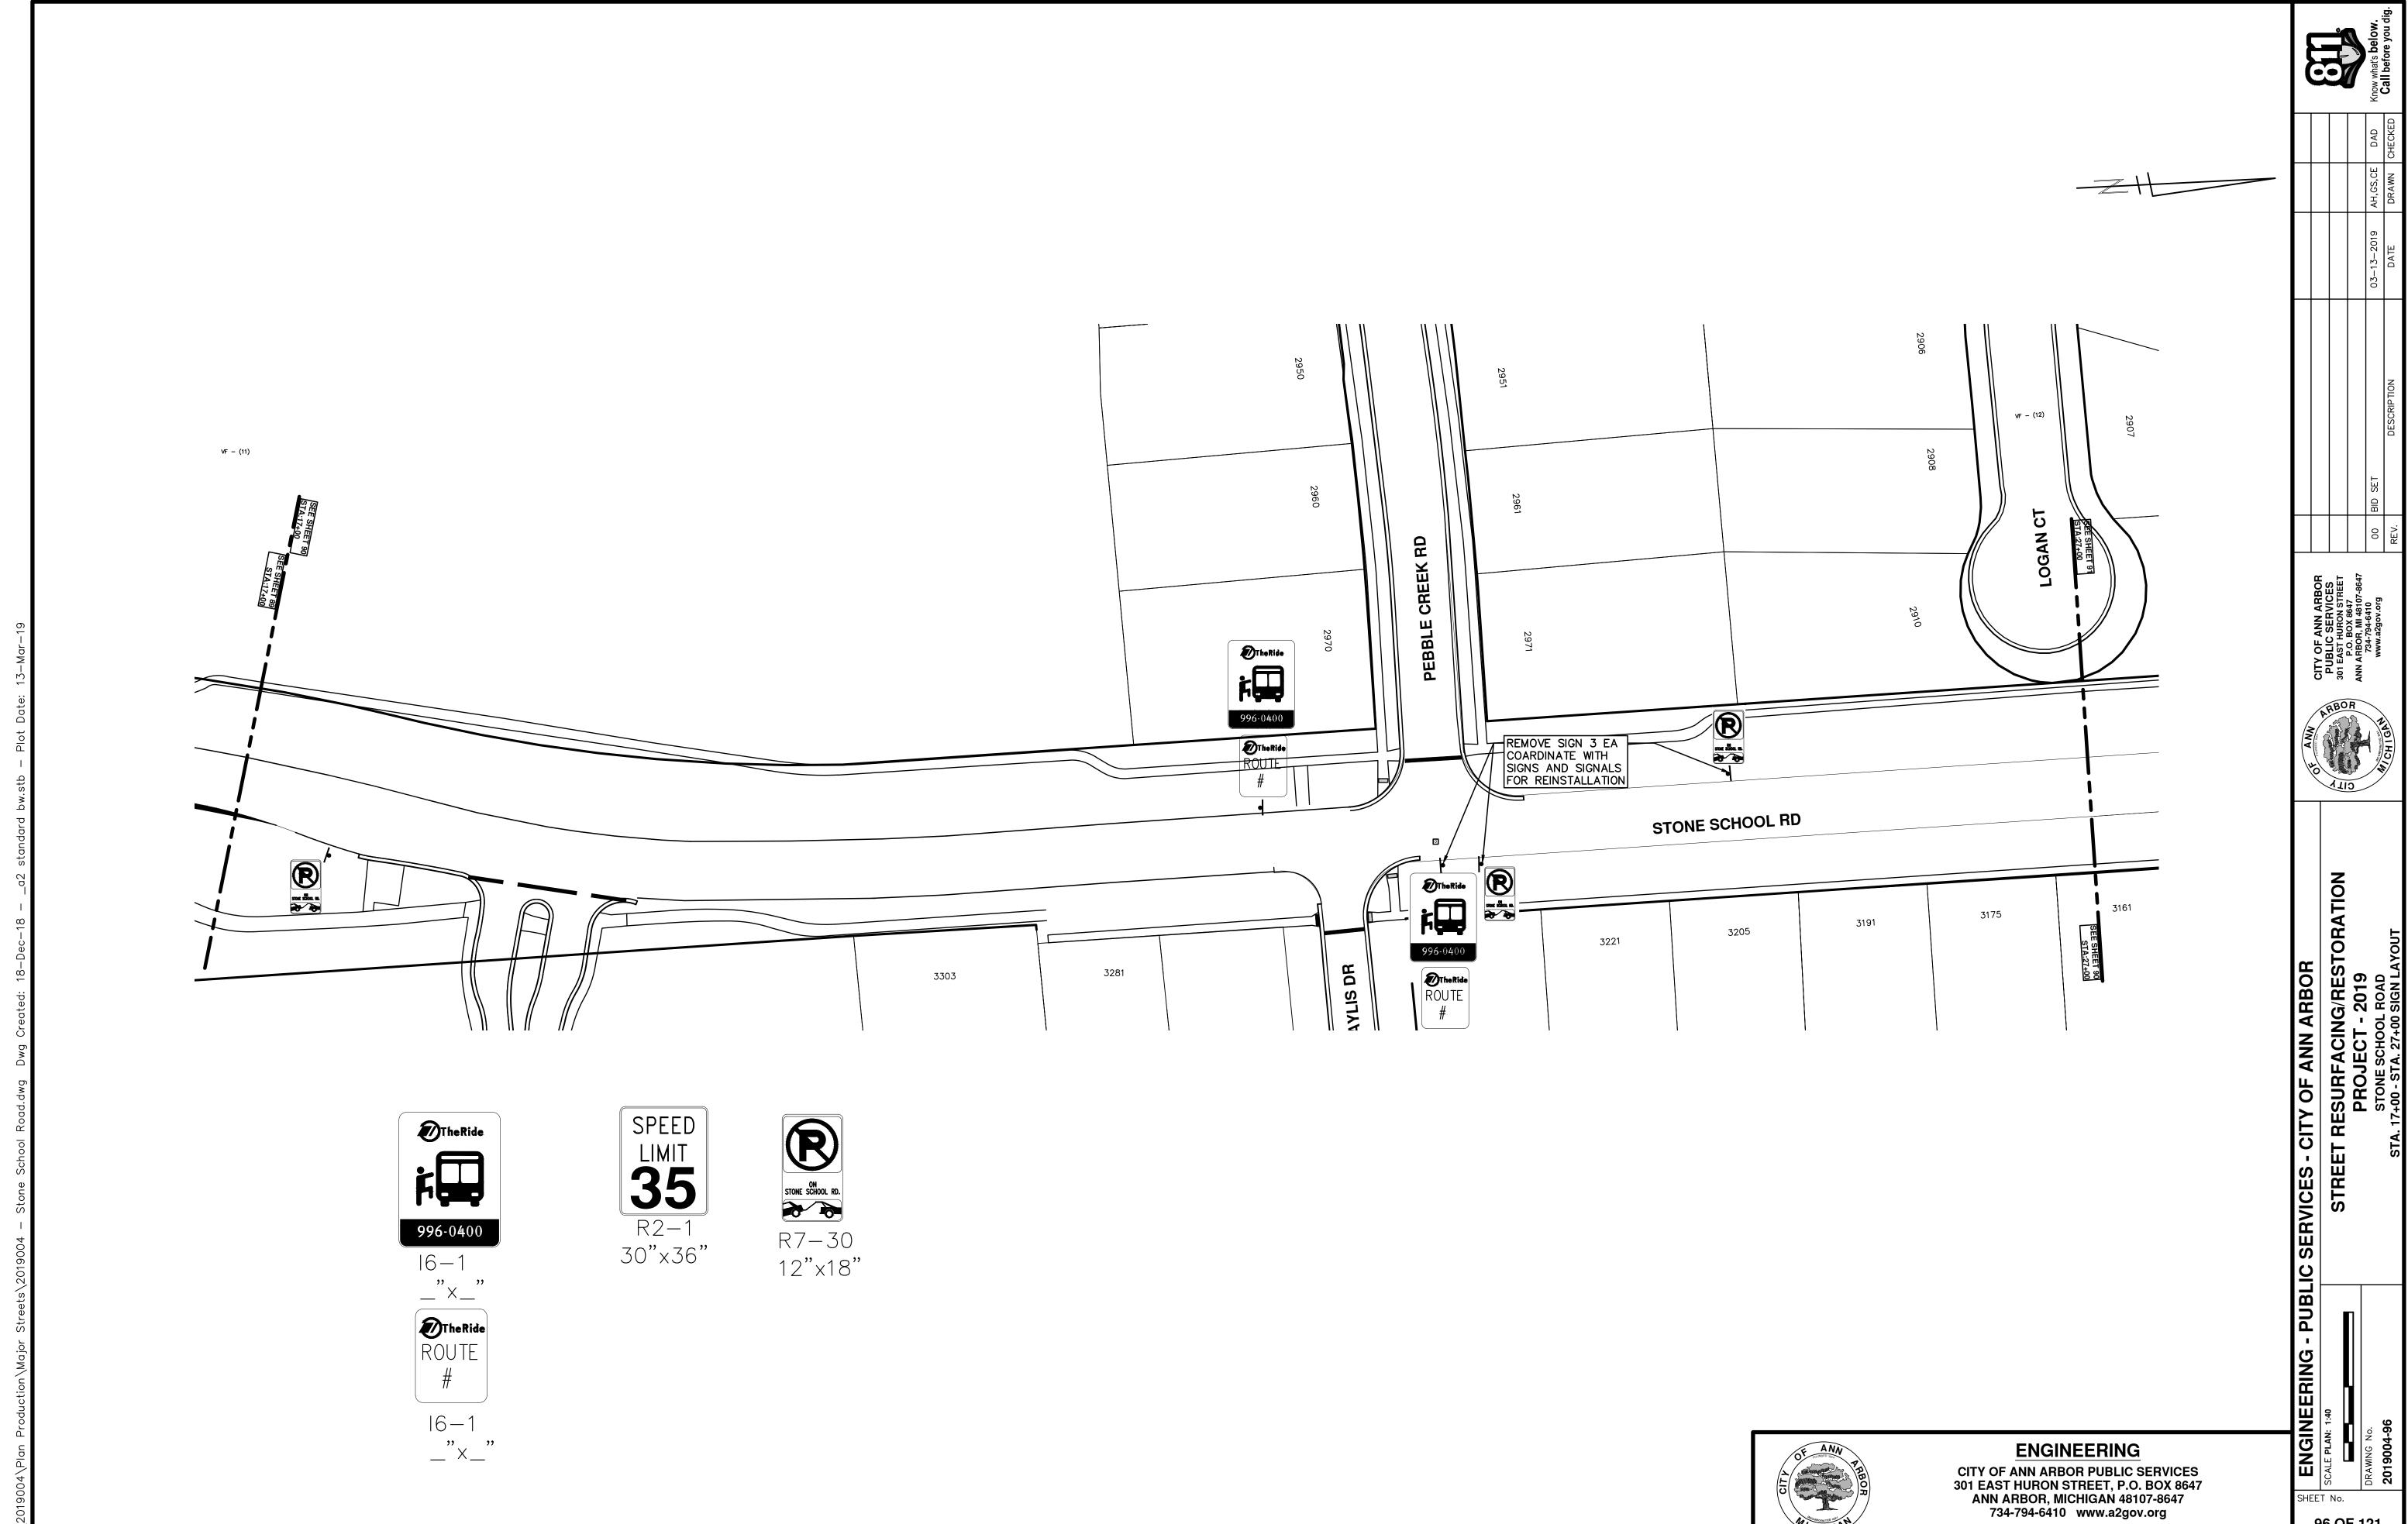


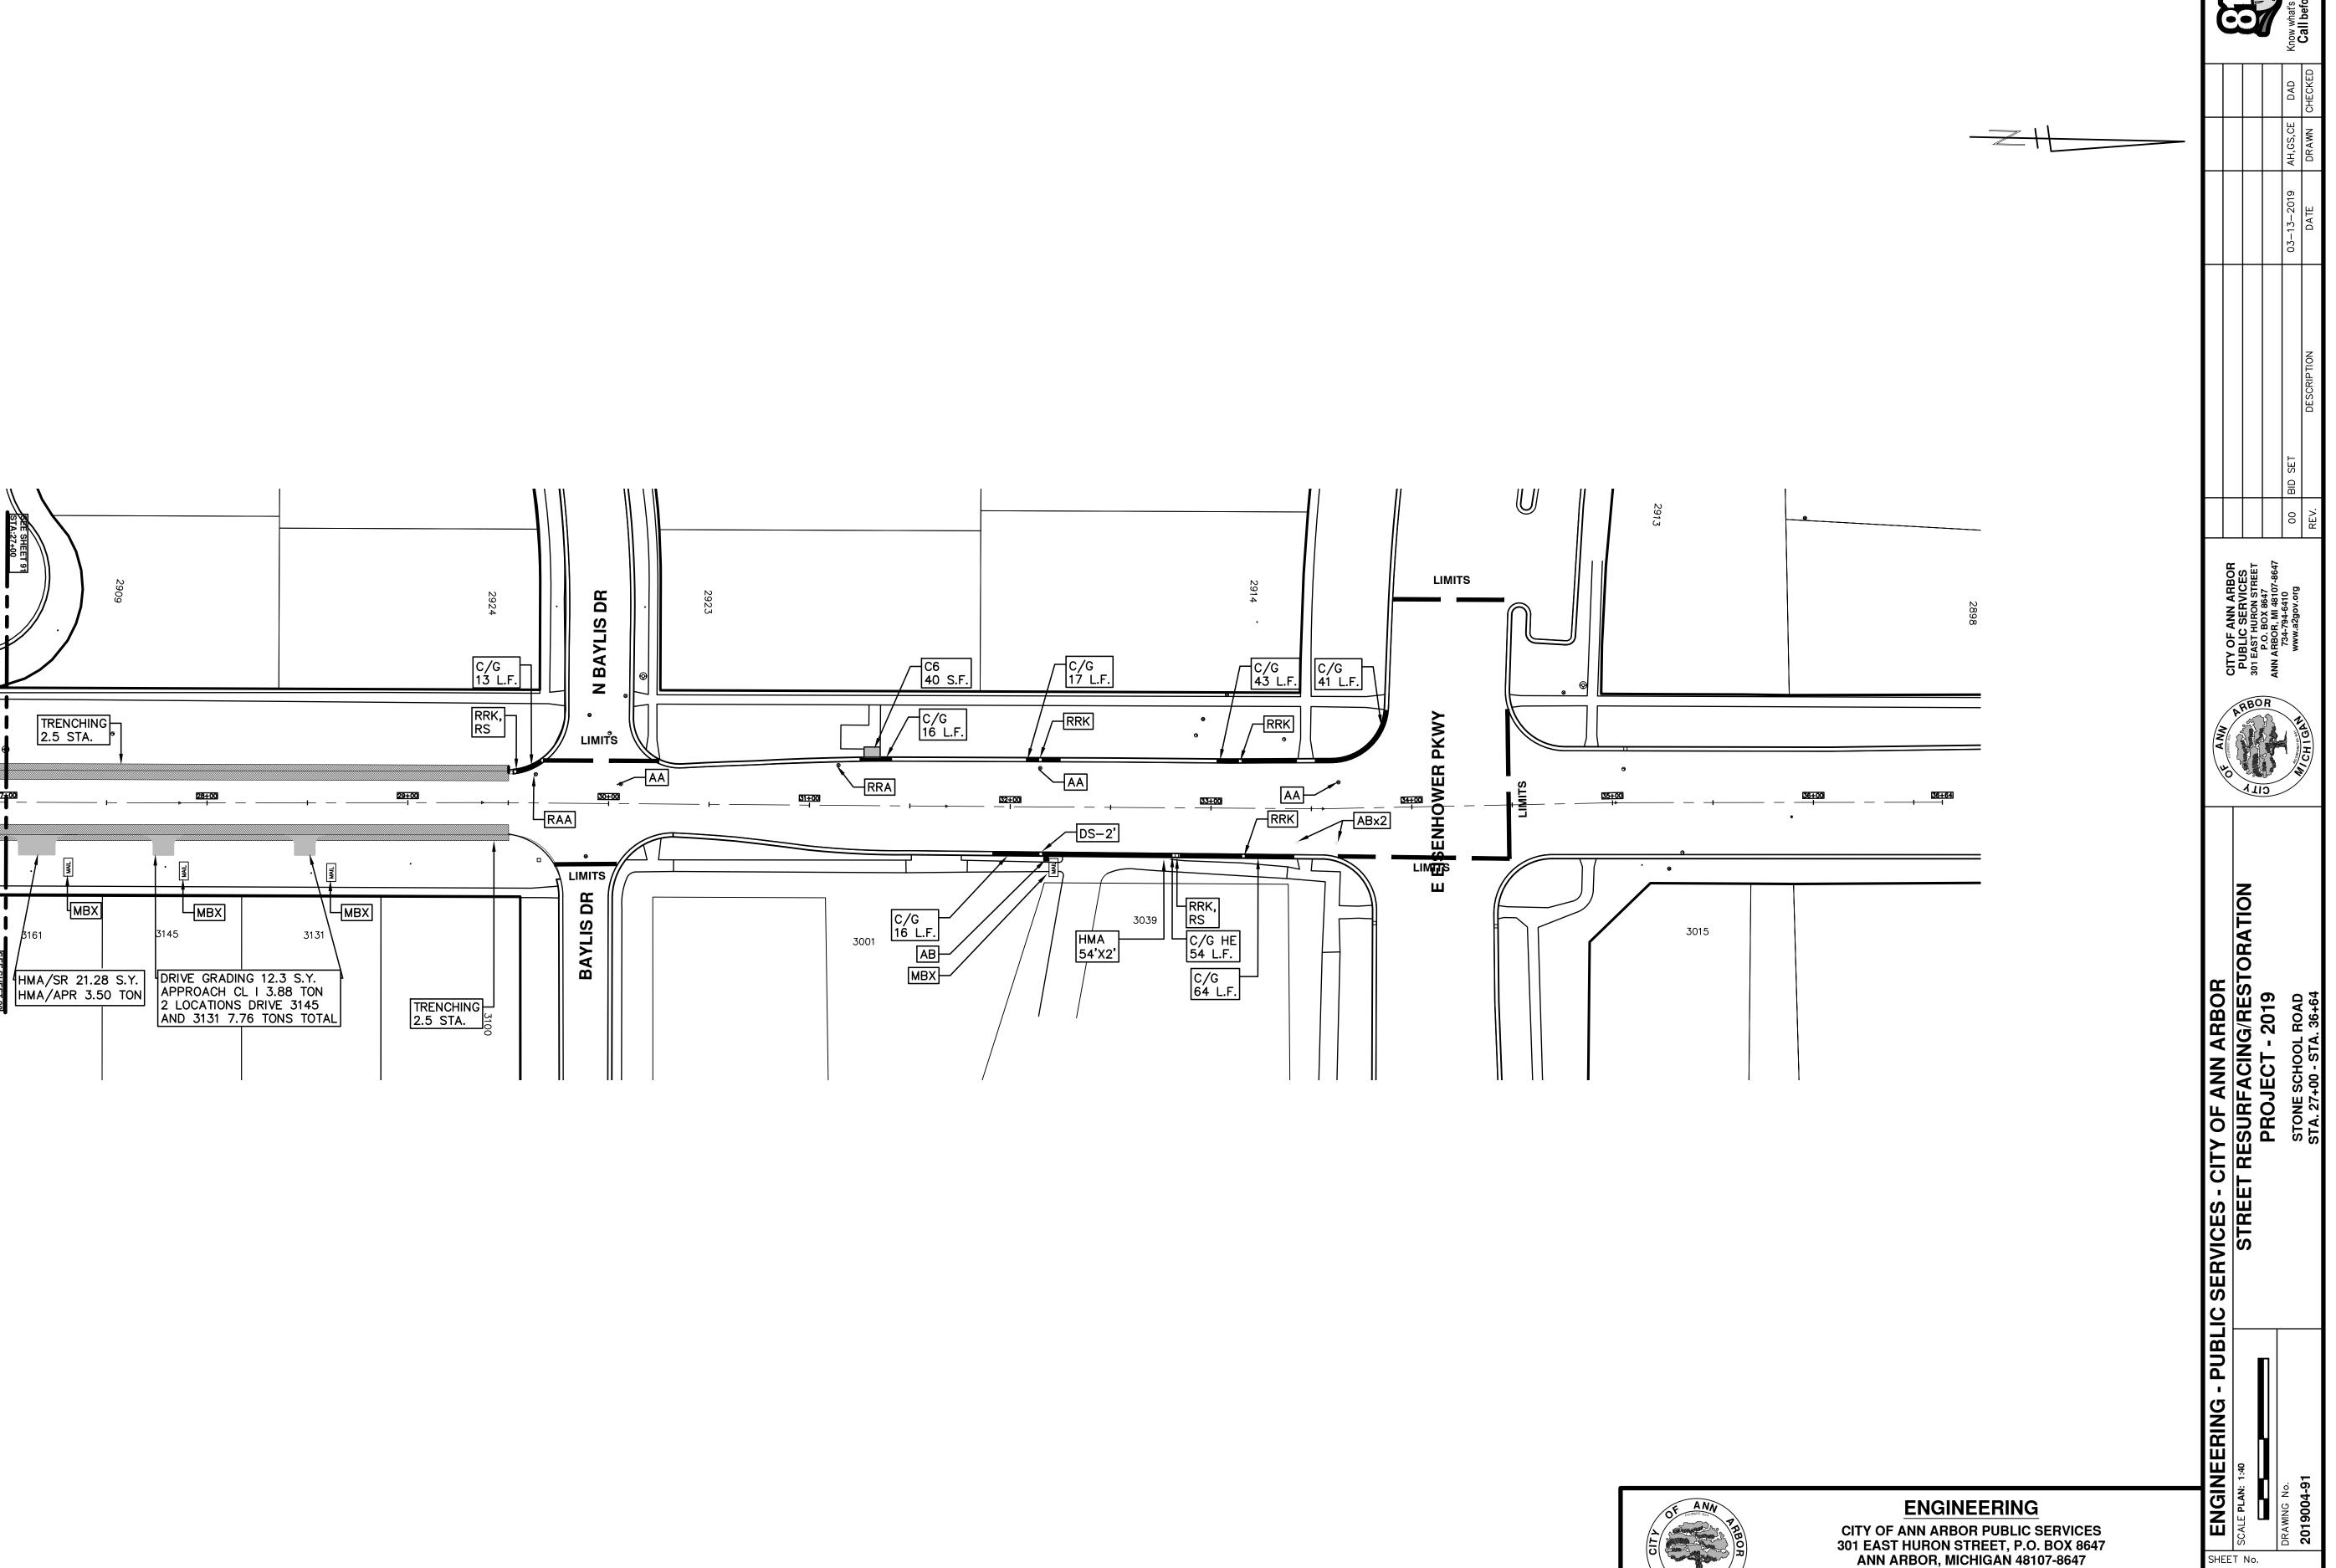

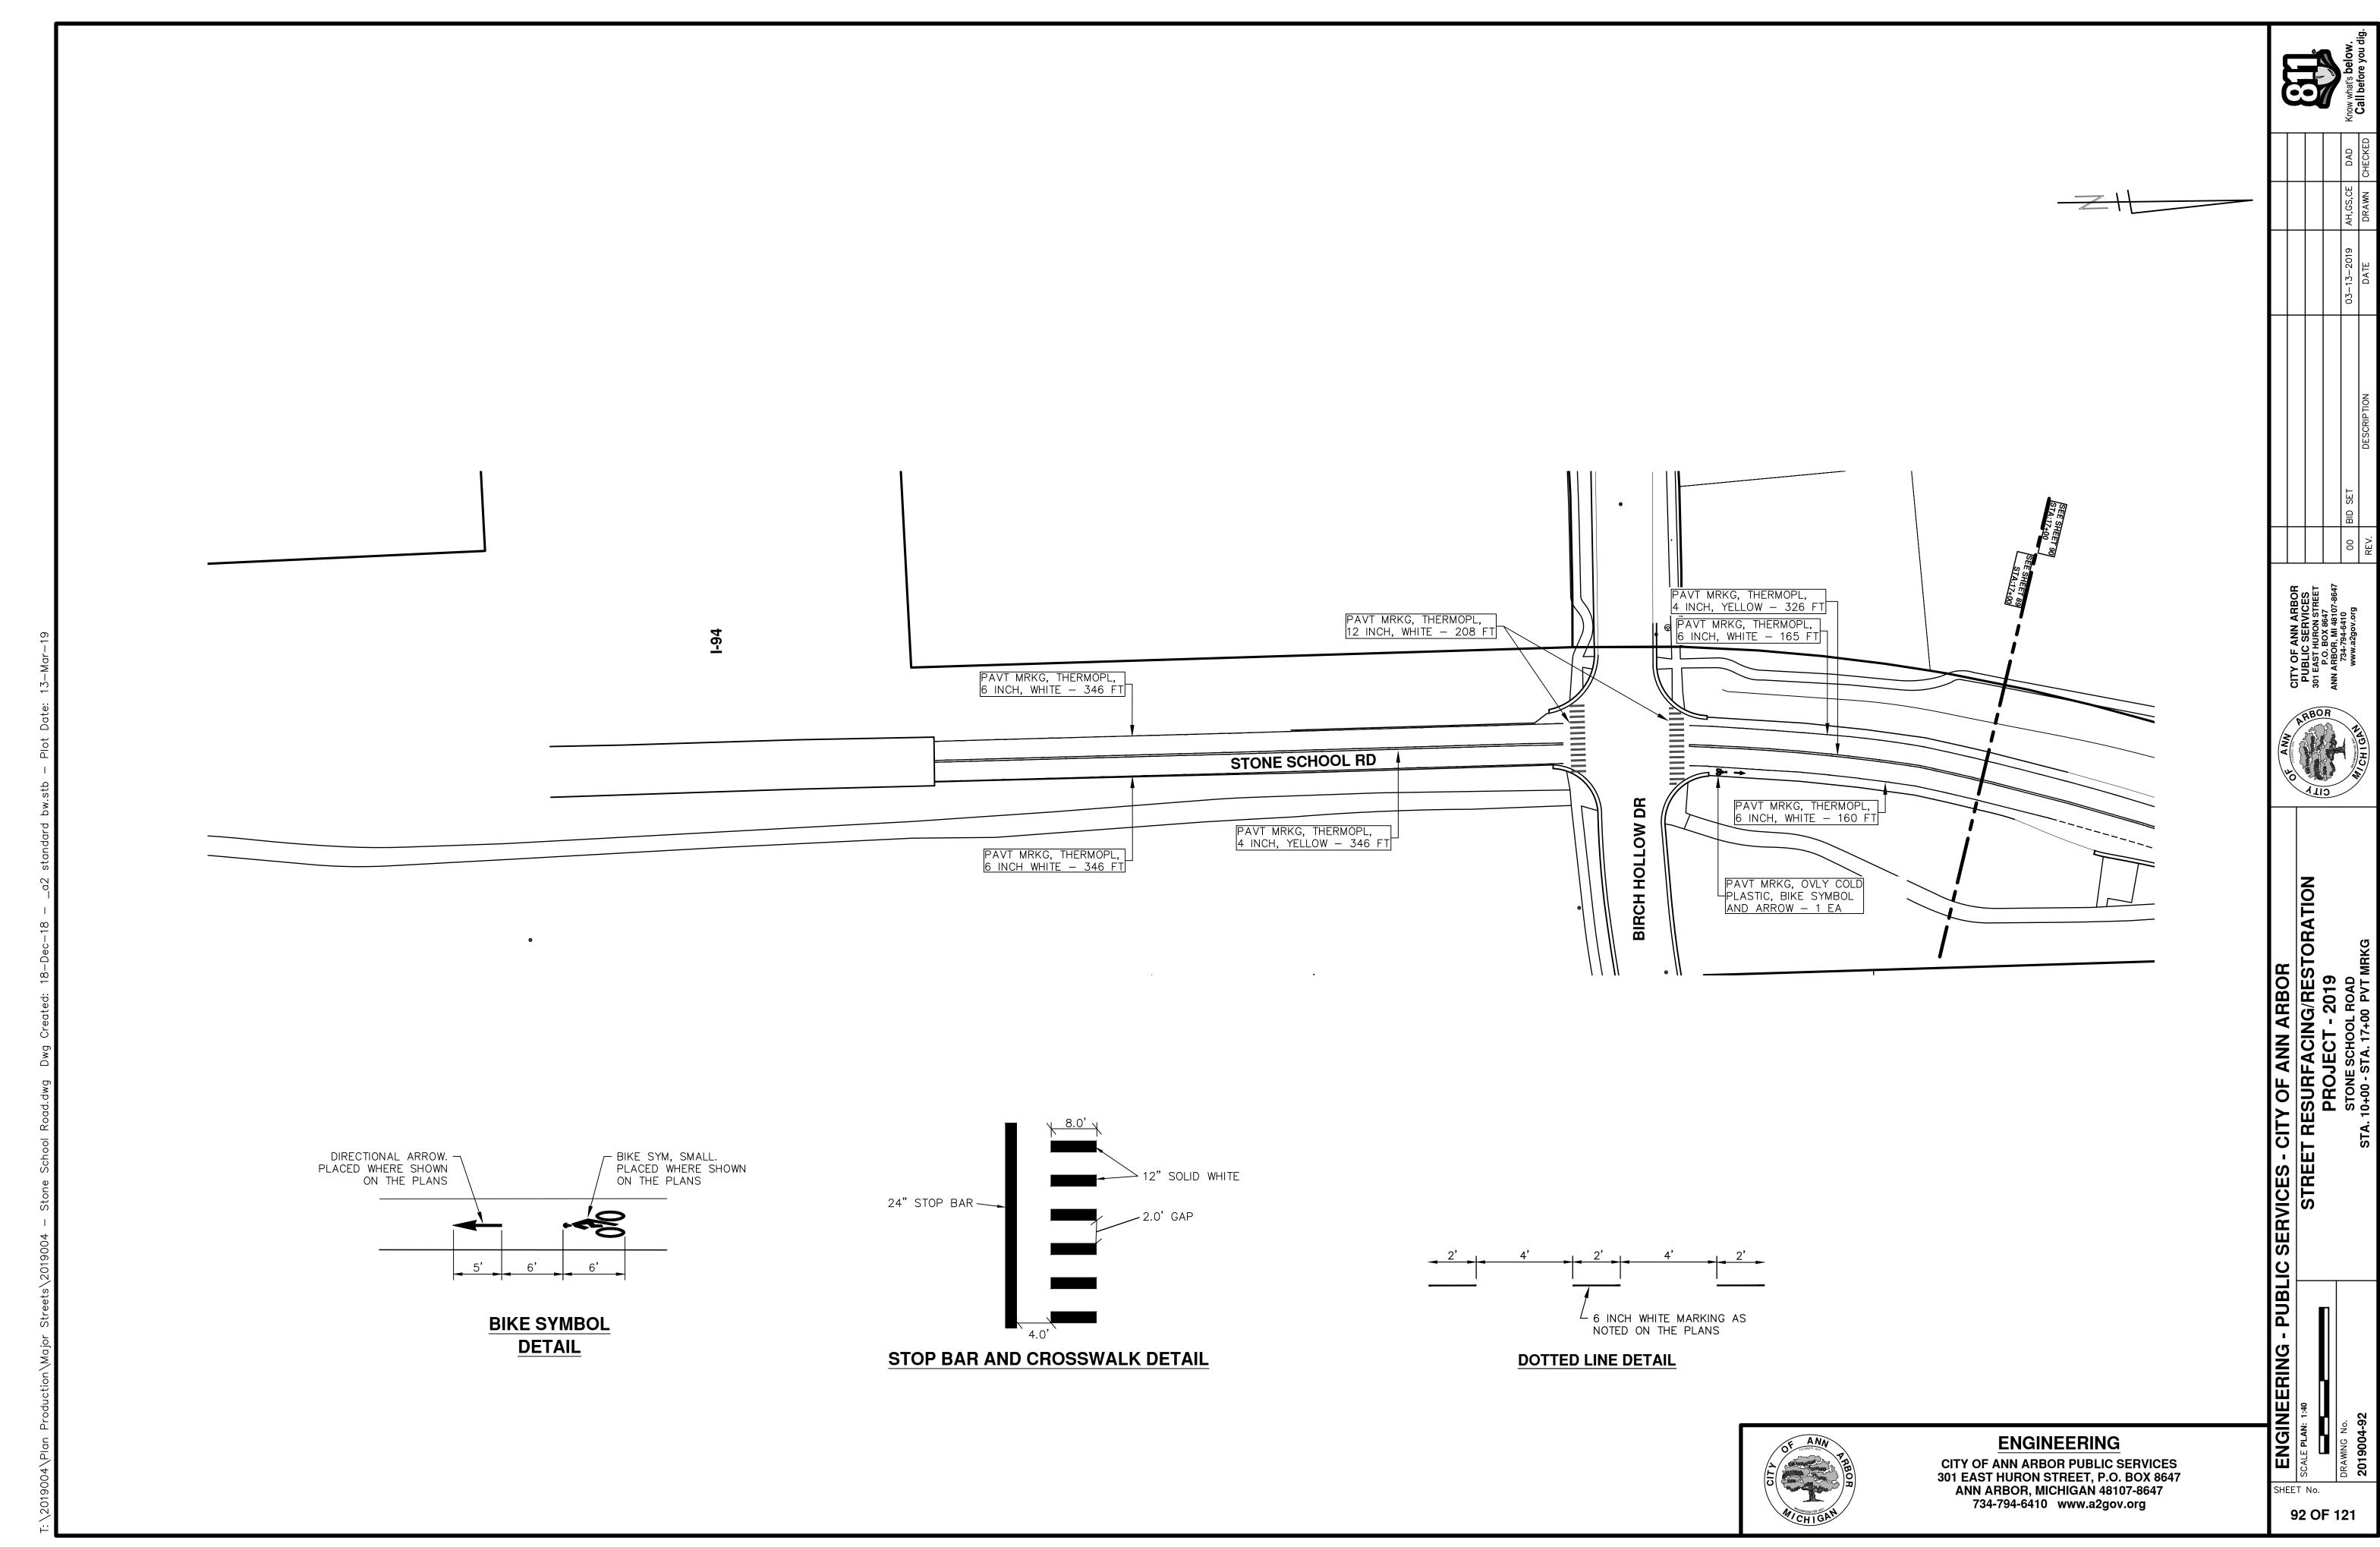


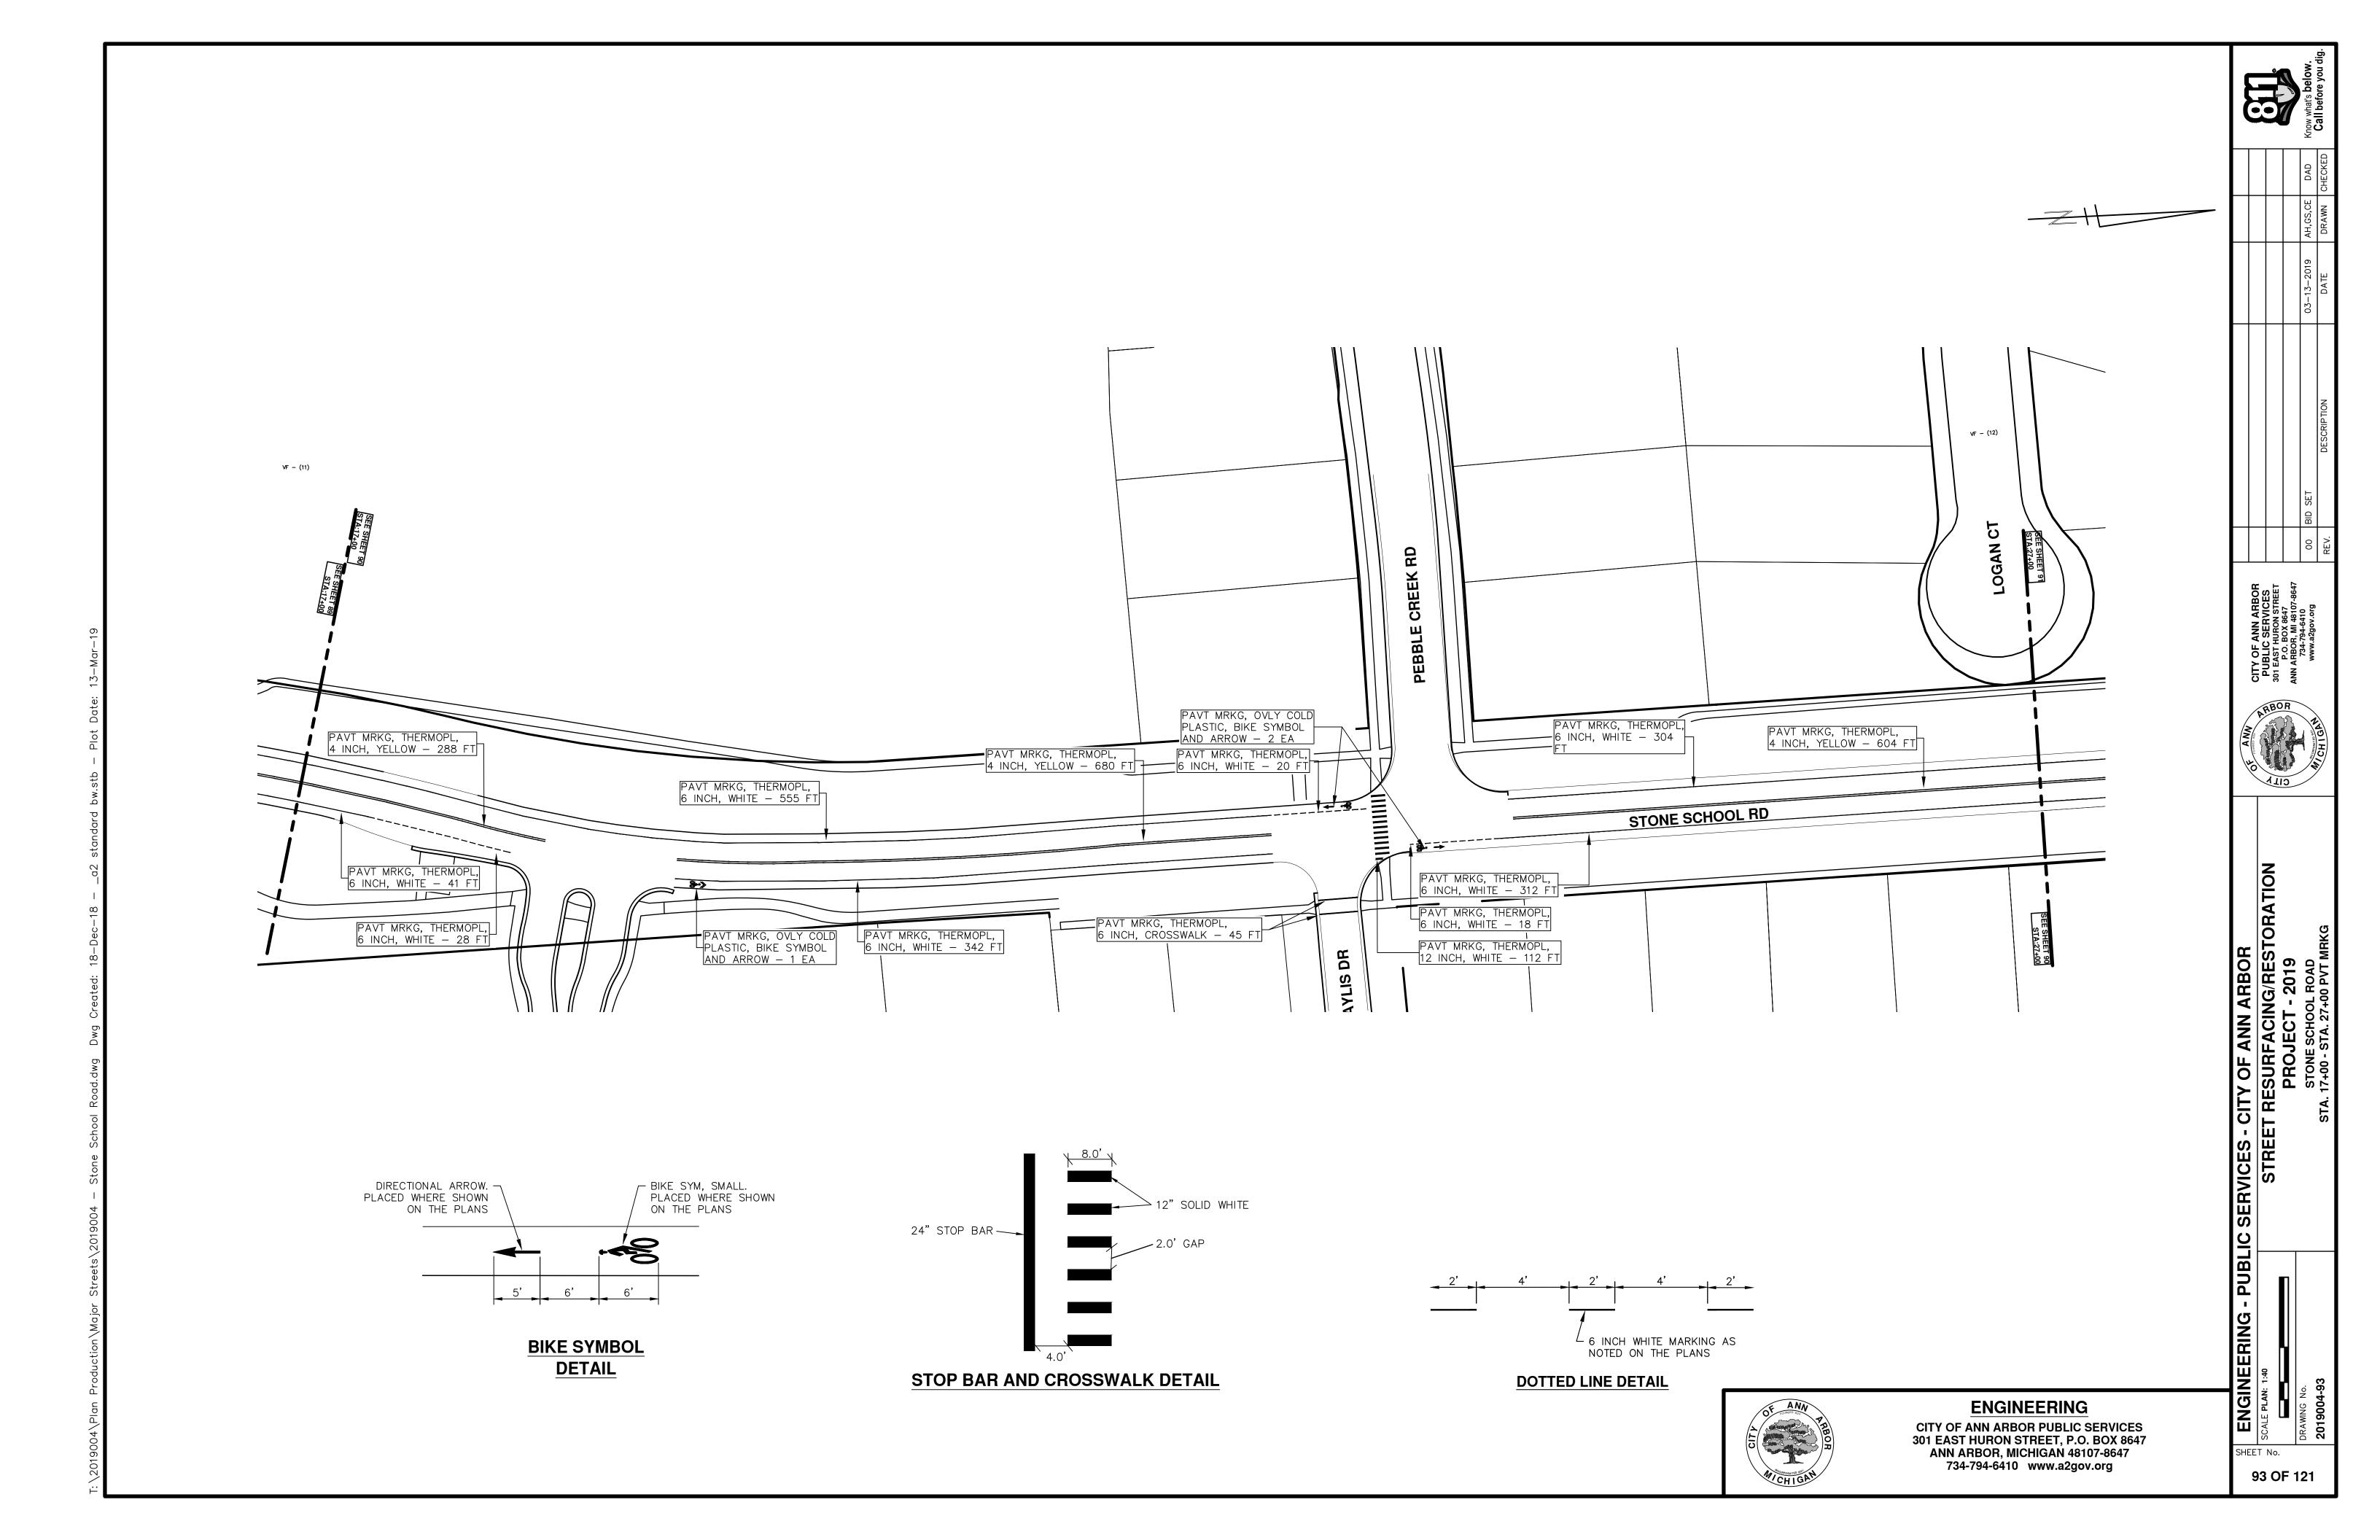

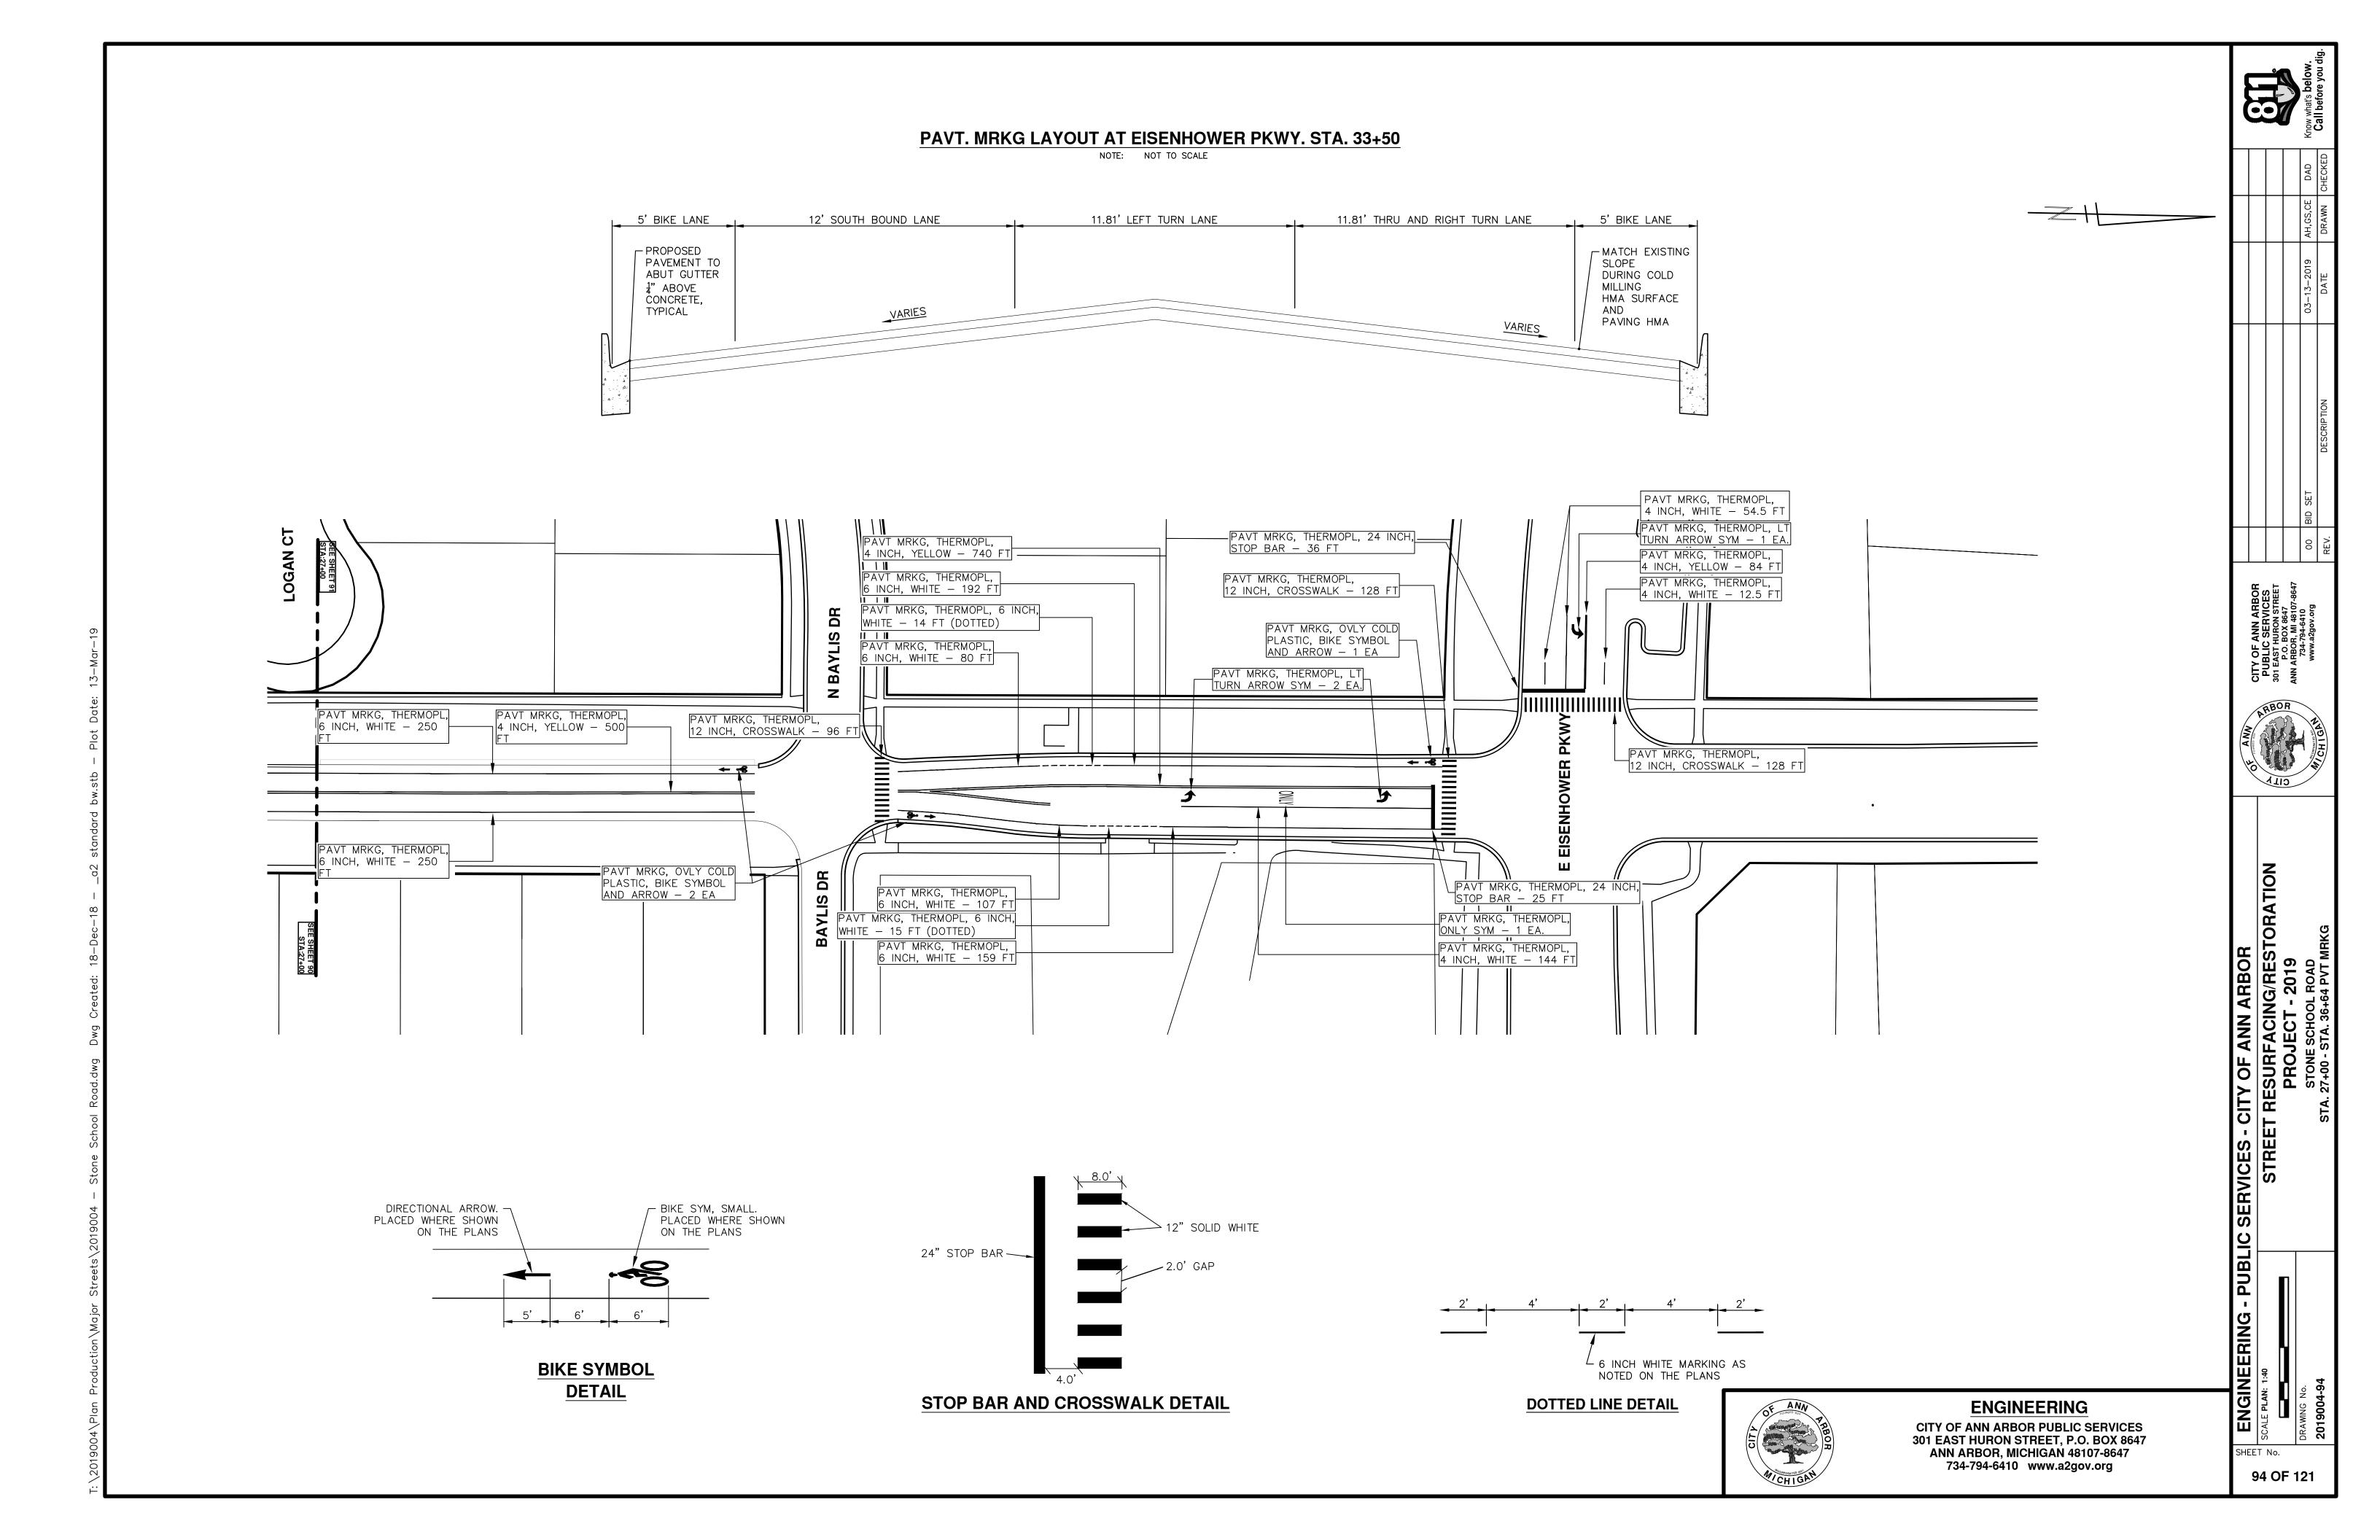

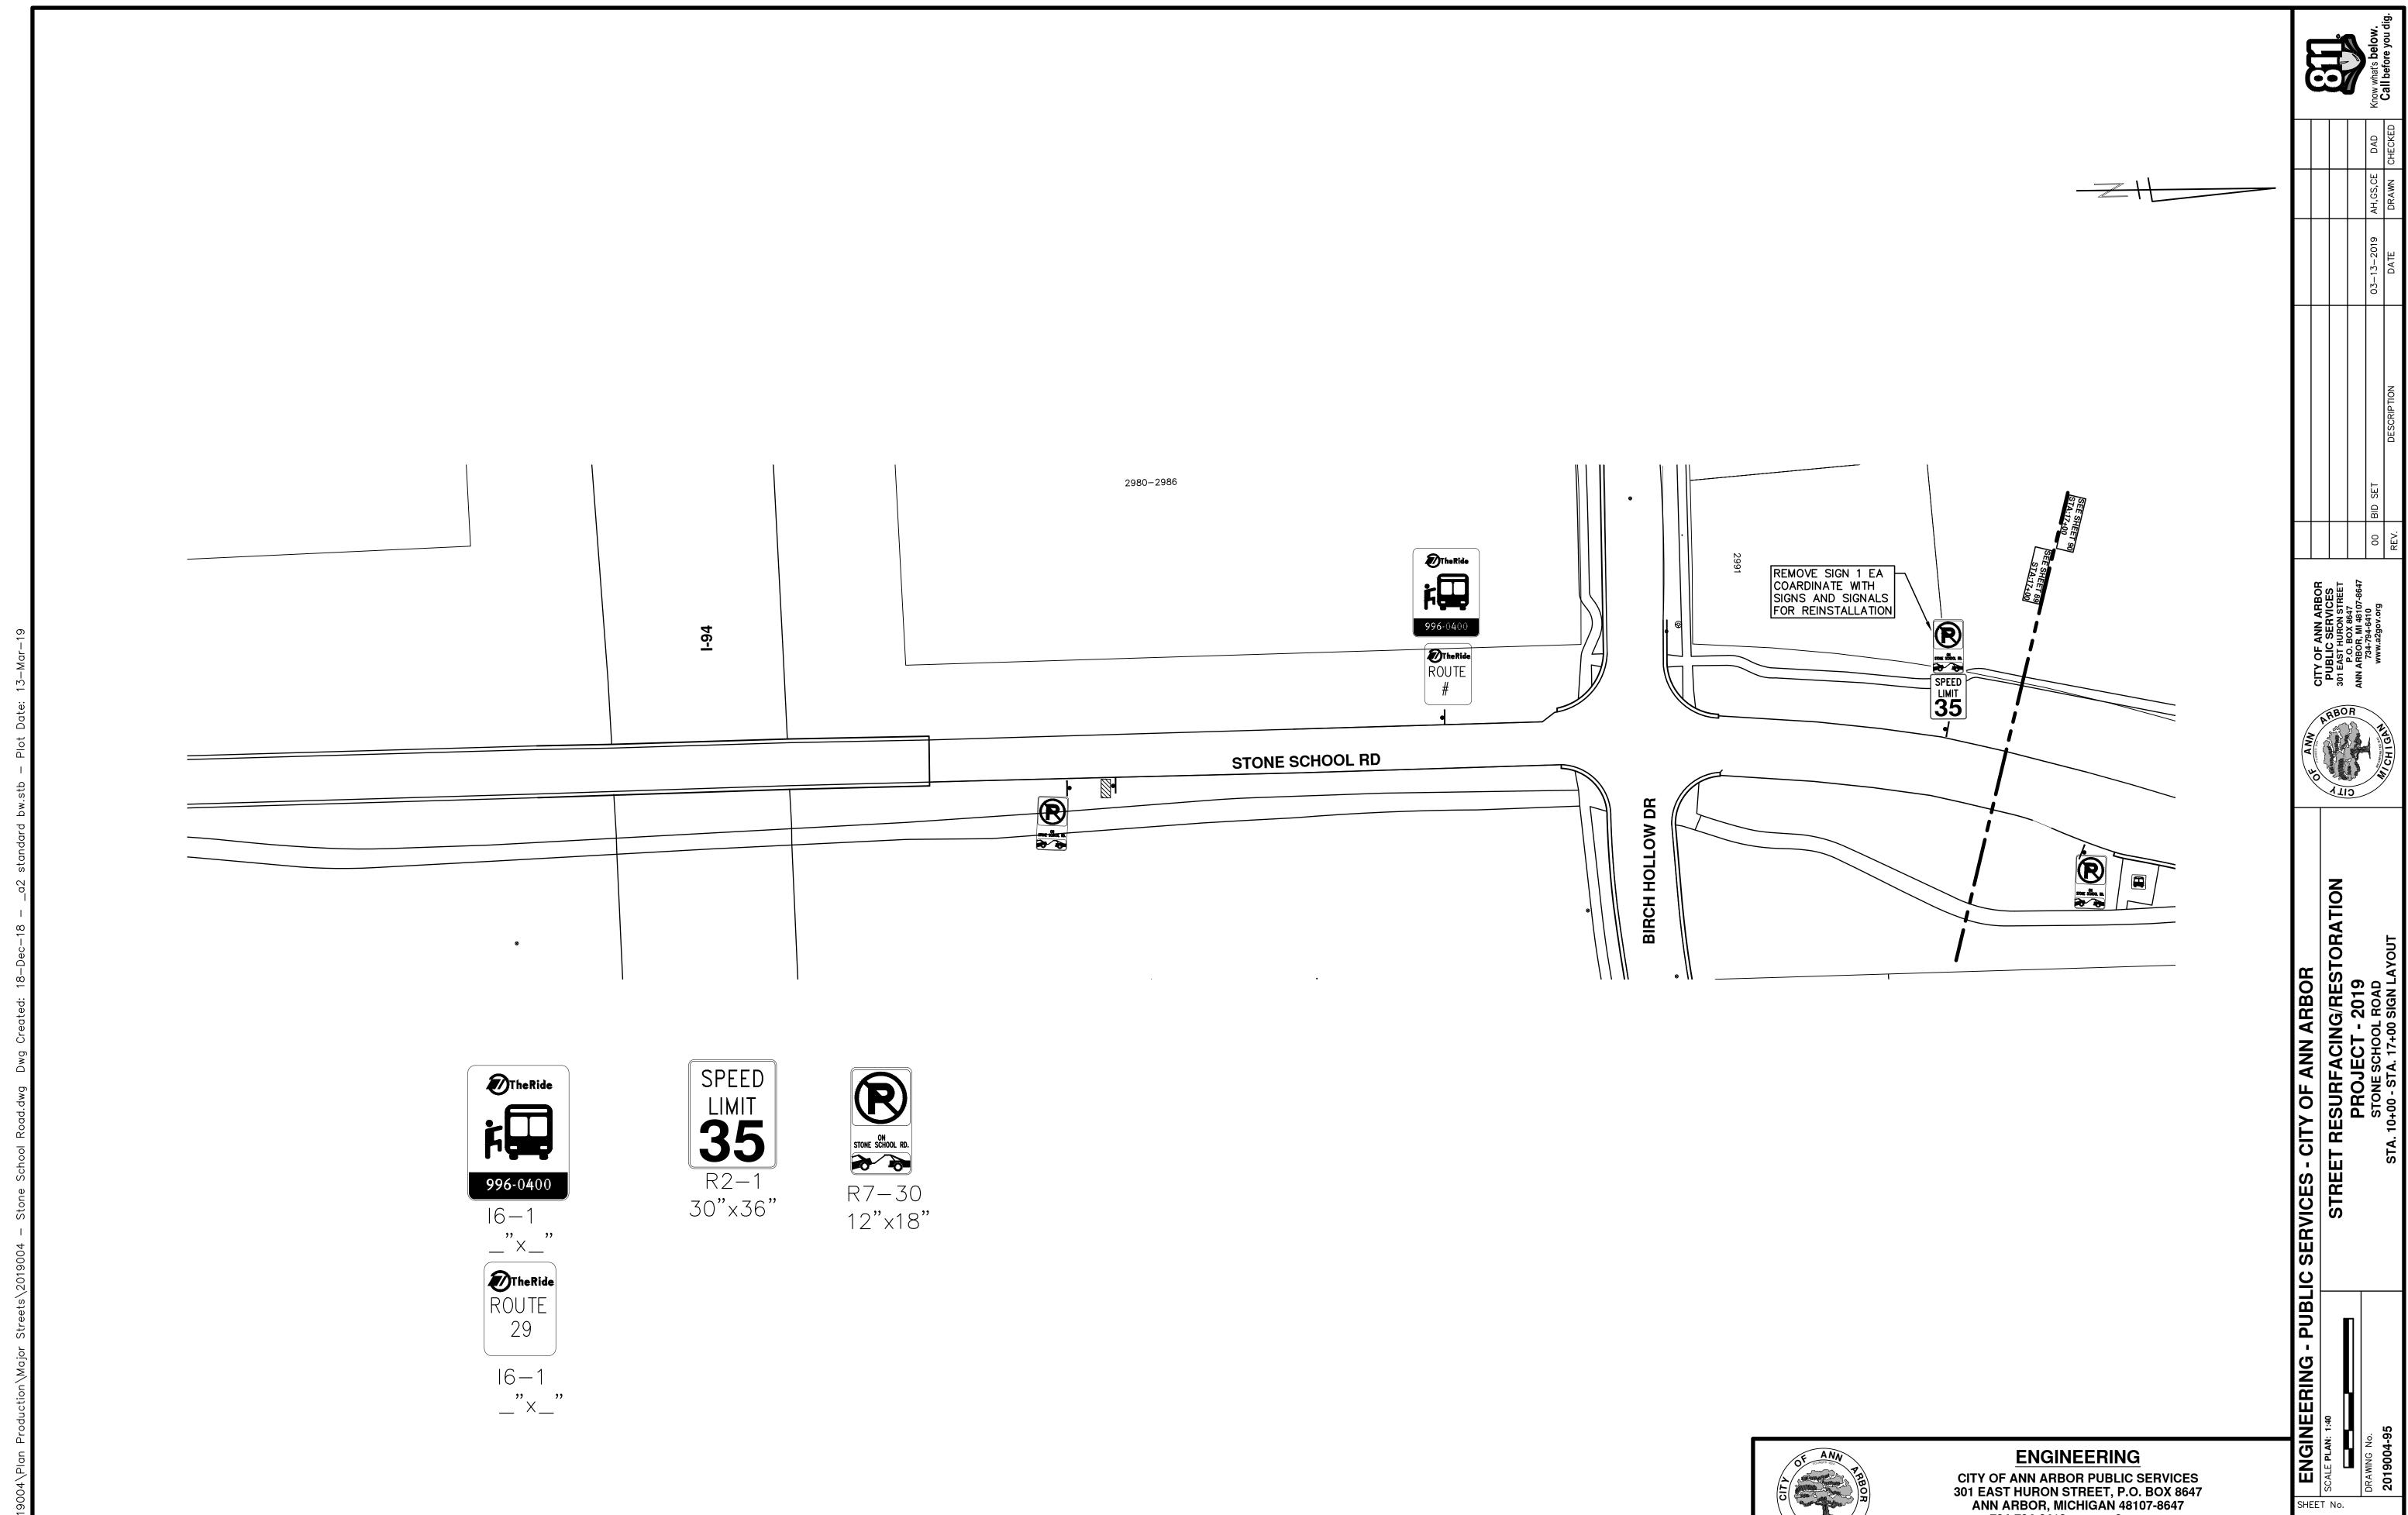



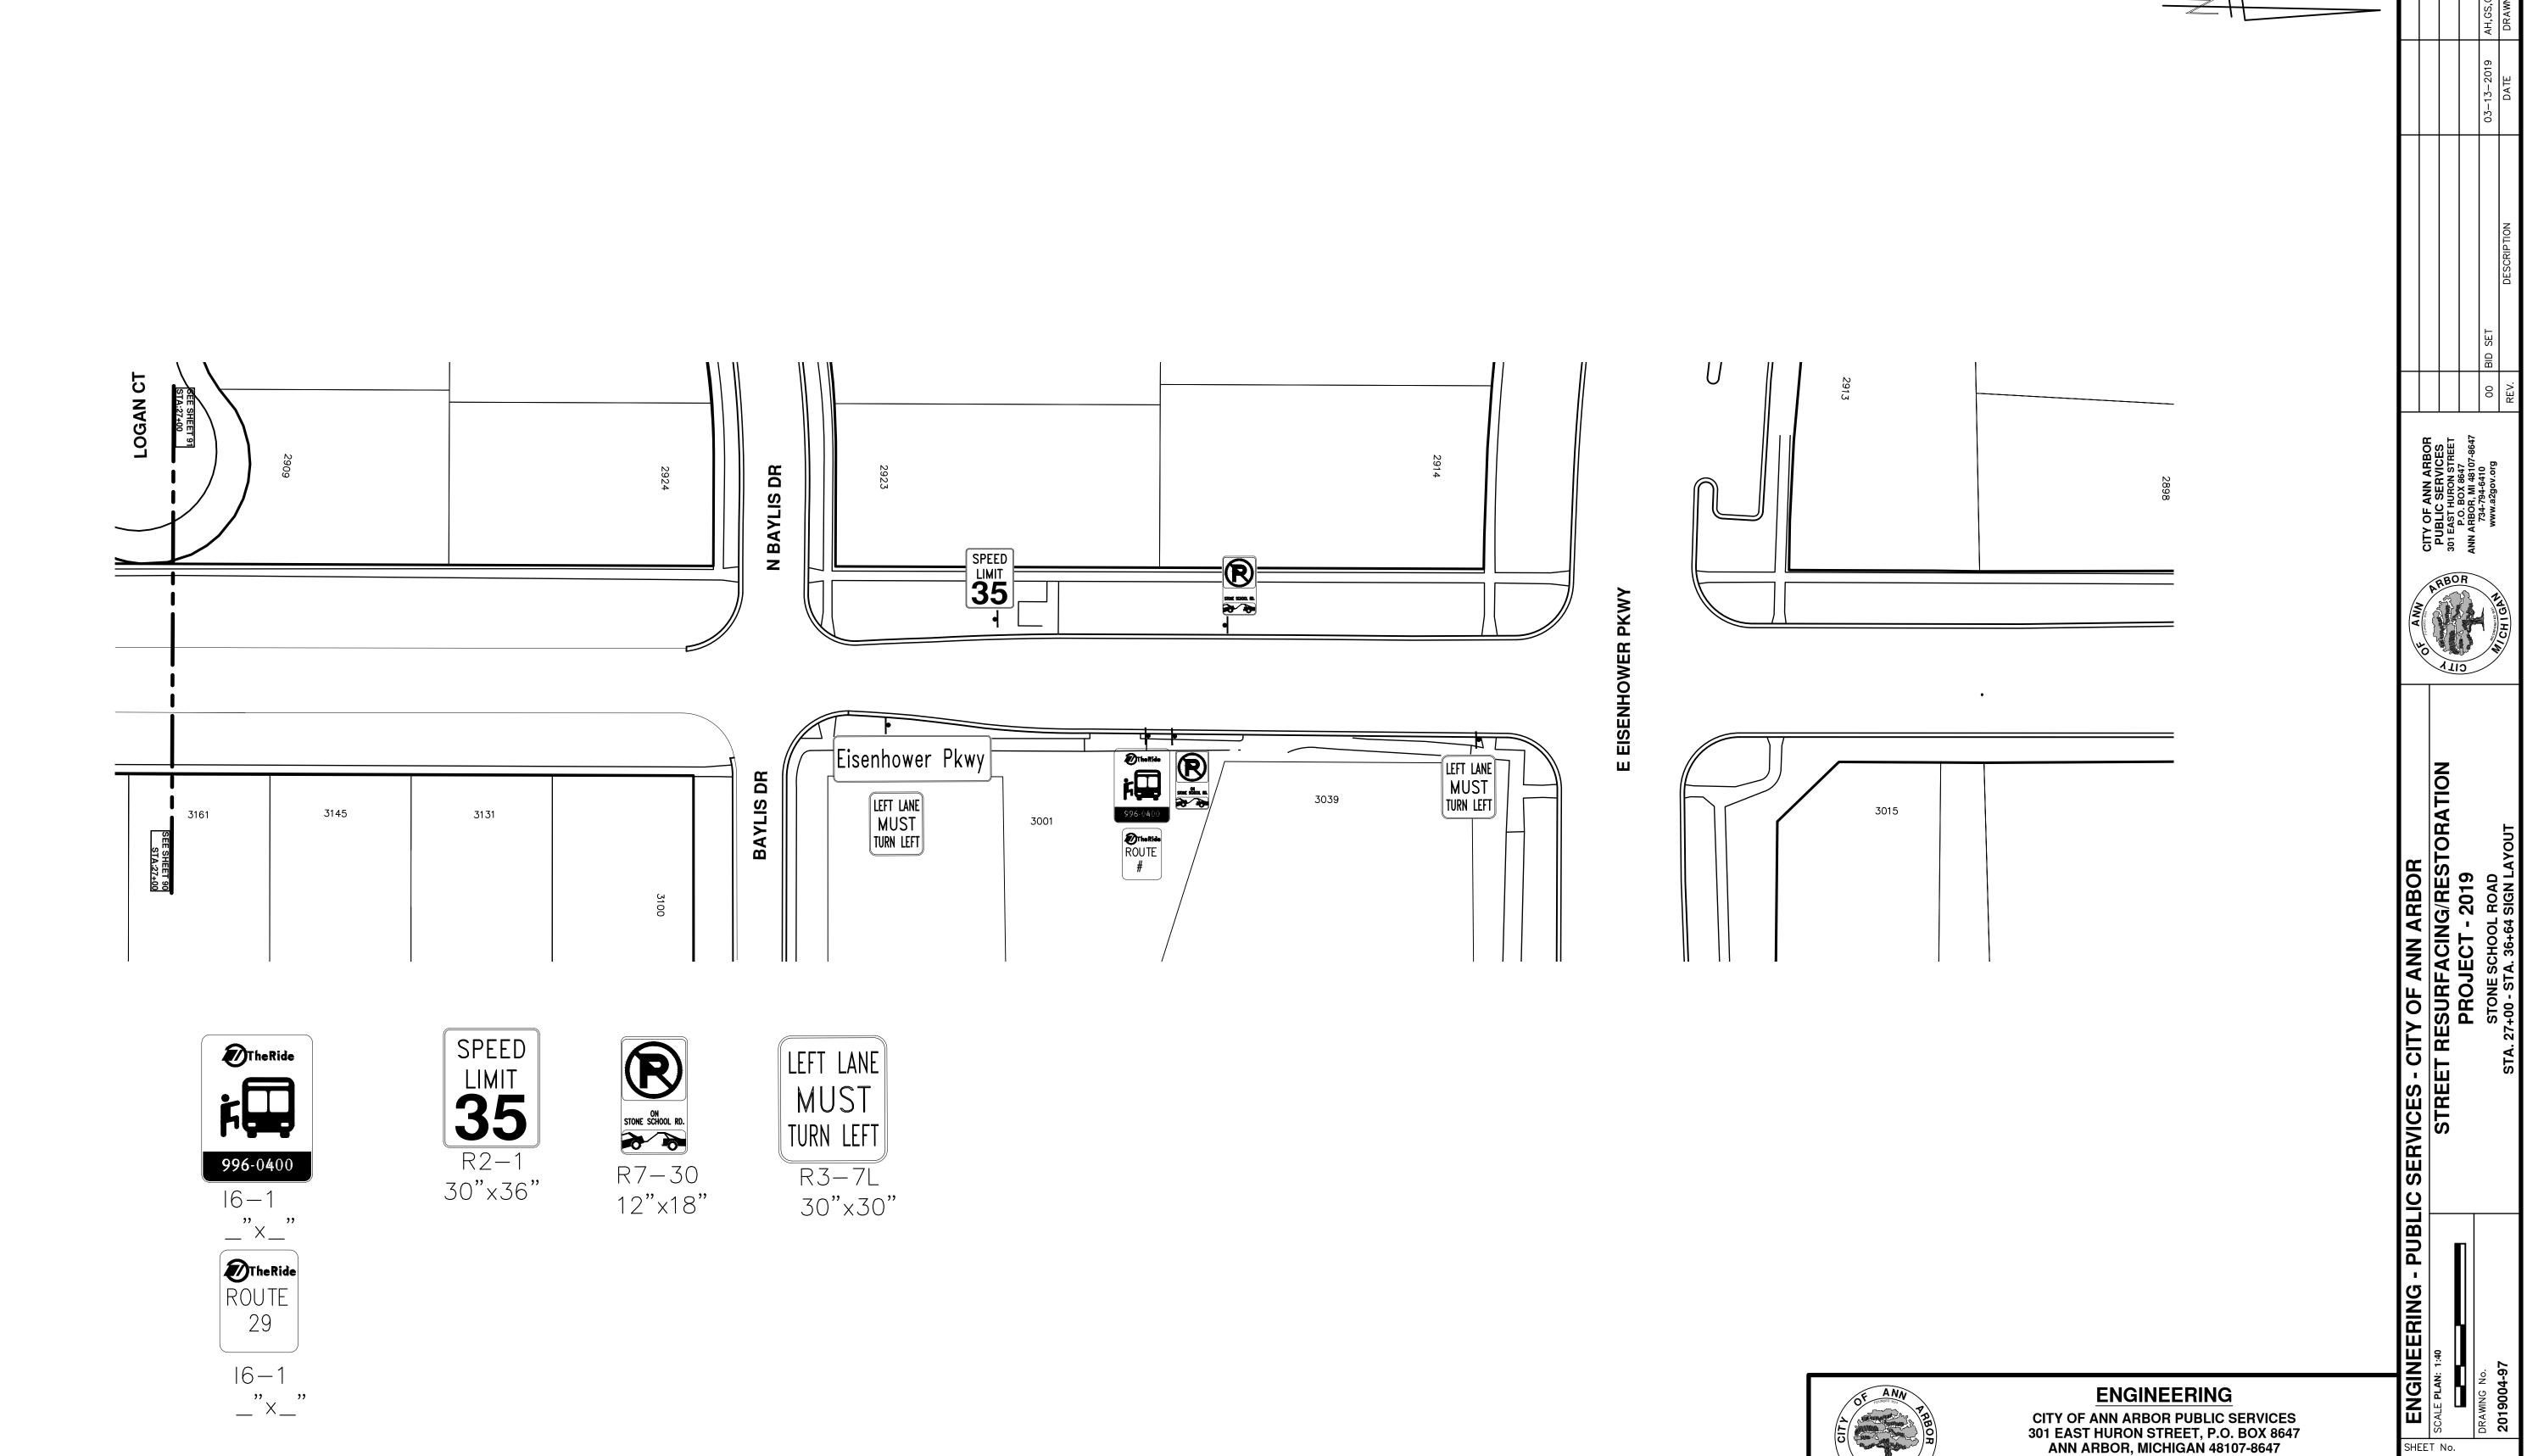

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ENGINEERING

CITY OF ANN ARBOR PUBLIC SERVICES 301 EAST HURON STREET, P.O. BOX 8647 ANN ARBOR, MICHIGAN 48107-8647 734-794-6410 www.a2gov.org



CITY OF ANN ARBOR ENGINEERING PROJECT LOCATION: TRAVERWOOD DRIVE

ITB No. 4570 FILE No. 2019004

	CONSTRUCTION KEY
KEY	ASSOCIATED PAY ITEM(S)
	• _Dr Structure, Adj, Case 1, Modified
AA	• _Dr Structure, Adj, Case 2, Modified
	• _Dr Structure, Temp Lowering, Modified
	• _Dr Structure, Temp Lowering, Modified
A D	• _Gate Box, Adj, Case 1
AB	• _Gate Box, Adj, Case 2
	Monument Box Adjust
ADST	Dr Structure, Adj, Add Depth, Modified
AK	• _Dr Structure, Adj, Case 1, Modified
7	• _Sidewalk, Sidewalk Ramp, and Driveway Approach, Any Thickness, Rem
C4	• Grading, Sidewalk
•	• _Sidewalk, Conc, 4 inch, Modified
	Sidewalk, Sidewalk Ramp, and Driveway Approach, Any Thickness, Rem
	Grading, Sidewalk
C4HE	• Cement
	Sidewalk, Conc, 4 inch, Modified Sidewalk, Sidewalk Ramp, and Driveway Approach, Apy Thickness, Rem.
	• _Sidewalk, Sidewalk Ramp, and Driveway Approach, Any Thickness, Rem
	• _Grading, Sidewalk
C6	• _Grading, Sidewalk Ramp
	• _Detectable Warning Surface, Modified
	• _Sidewalk Ramp, Conc, 6 inch, Modified
	• _Sidewalk, Conc, 6 inch, Modified
C8	• _Grading, Driveway Approach
	• _Driveway, Nonreinf Conc, 8 inch, Modified
	• _Sidewalk, Sidewalk Ramp, and Driveway Approach, Any Thickness, Rem
	• _Grading, Driveway Approach
	• _Grading, Sidewalk
	• _Grading, Sidewalk Ramp
C HE	• Cement
CHE	• _Driveway, Nonreinf Conc, 6 inch, Modified
	• _Driveway, Nonreinf Conc, 8 inch, Modified
	• _Detectable Warning Surface, Modified
	• _Sidewalk Ramp, Conc, 6 inch, Modified
	• _Sidewalk, Conc, 6 inch, Modified
CIC	• _Curb, Gutter, and Curb and Gutter, Any Type, Rem
C/G	Curb and Gutter, Conc
	Curb, Gutter, and Curb and Gutter, Any Type, Rem
C/GHE	• Cement
	• _Driveway Opening, Conc, Det M, Modified
	Grading, Sidewalk
CP	Sidewalk, Conc, 4 inch, Modified
CR	• _Sidewalk, Sidewalk Ramp, and Driveway Approach, Any Thickness, Rem
	• Dr Structure, Rem
DS	• Sewer, Rem, Less than 24 inch
20	• Dr Structure, 24 inch dia
	• Dr Structure, Rem
DSDI	• Sewer, Rem, Less than 24 inch
וטטט	• Dr Structure, Double Inlet
PT	Dr Structure, Double inlet Dr Structure, Point
ГІ	
RRA	Dr Structure Cover, Type B Dr Structure Cover, Type B Special
	• _Dr Structure Cover, Type B, Special
	• _Dr Structure, Adj, Case 1, Modified
	• _Dr Structure, Temp Lowering, Modified
RRK	Dr Structure Cover, Type K
	• _Dr Structure, Adj, Case 1, Modified
RS	• _Dr Structure, Reconstruct
TYPE II	Plastic Drum, High Intensity, Lighted, Furn
	Plastic Drum, High Intensity, Lighted, Oper
YPE III	Barricade Type III High Intensity Double Sided Lighted Furn

NOTES:

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ENGINEERING

CITY OF ANN ARBOR PUBLIC SERVICES 301 EAST HURON STREET, P.O. BOX 8647 ANN ARBOR, MICHIGAN 48107-8647 734-794-6410 www.a2gov.org

				Know wh	Call b	
				DAD	DRAWN CHECKED	
				AH,GS,CE DAD	DRAWN	
				03-13-2019	DATE	
					DESCRIPTION	



ENGINEERING SHEET No.


		FIC CONTROL	1
	SIGN	NUMBER	QUANTITY
1		BARRICADE TYPE III HIGH INTENSITY LIGHTED	2
(2)	TRAVERWOOD DR	D3-1	1
	DETOUR ENDS	M4-8a 24X18	1
3	TRAVERWOOD DR	D3-1 M4-9S	4
	TRAVERWOOD DR	30x24 D3-1	0
4	DETOUR	M4-9R 30x24	0
	TRAVERWOOD DR	D3-1	0
(5)	DETOUR	M4-9L (MOD.) 30x24	0
(6)	(DETOIN)	D3-1 M4-9R	0
	DETOUR	(MOD.) 30x24	0
(7)	TRAVERWOOD DR	D3-1 M4-9L	0
		(MOD.) 30×24	0
8	DETOUR	M4-10R 48x18	1
9	DETOUR	M4-10L 48x18	0
10)	ONE WAY R6-1R	36"x12"	0
11)	ONE WAY R6-1L	36"x12"	0
12		R3-2 24"x24"	1
13)	(R)	R3–1 24"×24"	1
14)	ROAD CLOSED	R11-2 48X30	0
15)	ROAD CLOSED TO THRU TRAFFIC	R11-4 60x30	0
16)	END ROAD WORK	G20-2 48" ×24"	0
17)	ROAD WORK AHEAD	W20-1 36x36	4
	TRAVERWOOD DR	D3-1	4
18)	DETOUR AHEAD	W20-2 36×36	2
	TRAVERWOOD DR	D3-1	2
19	ROAD CLOSED AHEAD	W20-3 36x36	2
	TRAVERWOOD DR	D3-1	2
20)	RIGHT LANE CLOSED AHEAD	W20-5R 36"x36"	0
21)		W4-2R 36"x36"	0

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- 3. THE CONTRACTOR SHALL COORDINATE HIS OPERATIONS WITH THOSE OF THE CITY OF ANN ARBOR'S SIGNS AND SIGNALS UNIT DURING THE COURSE OF THE DETOUR ROUTE ESTABLISHMENT TO EFFECTIVELY AND SAFELY MAINTAIN TRAFFIC. DO NOT ERECT ANY SIGNS UNTIL ITS LOCATION AND PROPOSED DATE OF INSTALLATION IS APPROVED BY THE ENGINEER.
- 4. THIS DETOUR IS TO BE IN PLACE AS DIRECTED BY THE ENGINEER, THE CONTRACTOR WILL CLOSE AND DETOUR SOUTH BOUND TRAVERWOOD DRIVE TRAFFIC. SEE "SPECIAL PROVISION FOR MAINTAINING TRAFFIC AND CONSTRUCTION SEQUENCING" FOR DETAILS ON CONSTRUCTION STAGING, SEQUENCING, CLOSURE AND DETOUR LIMITATIONS, AND OTHER DETAILS.
- 5. REFERENCE THE "DETAILED SPECIFICATION FOR MAINTAINING TRAFFIC AND CONSTRUCTION SEQUENCING" FOR ADDITIONAL PROJECT REQUIREMENTS. THE CONTRACTOR'S ATTENTION IS SPECIFICALLY DIRECTED TO THE SECTION OF SAME SPECIAL PROVISION REGARDING COORDINATION WITH THE CITY SIGNS AND SIGNALS UNIT FOR THE SEVERAL DETOUR ROUTE MODIFICATIONS AND THE MODIFICATIONS TO TRAFFIC SIGNALS FOR THE DETOUR.
- 6. THE CONTRACTOR SHALL FURNISH, ERECT, AND MAINTAIN SIGNS AS SHOWN ON THE PLANS OR OTHERWISE DIRECTED BY THE ENGINEER.
- 7. CONSTRUCTION WARNING SIGNS SHALL HAVE AN ORANGE, HIGH—INTENSITY, REFLECTORIZED BACKGROUND.
- 8. SIGNS SHALL CONFORM TO THE 2011 MICHIGAN MANUAL OF UNIFORM TRAFFIC CONTROL DEVICES.
- 9. THE CONTRACTOR SHALL DRIVE ALL SIGNS INTO EXPOSED GROUND OR INSERT INTO A BORED HOLE IN PAVEMENT AS NECESSARY TO PERMANENTLY SECURE. ALL HOLES IN PAVEMENT SHALL BE FILLED WITH ENGINEER—APPROVED MORTAR WHEN THE SIGN IS REMOVED AND NO LONGER NEEDED. COSTS FOR THIS WORK SHALL BE INCLUDED IN THE PAY ITEM "SIGN, TYPE B, TEMP, PRISMATIC, FURN" OR "SIGN, TYPE B, TEMP, PRISMATIC, FURN, SPECIAL".

LEGEND:	
SOUTH BOUND TRAVERWOOD DETOUR ROUTE	=
NORTH BOUND TRAVERWOOD TRAFFIC MAINTAINED	

	TDAFFIO 00	NTDOL OLG	N.
	TRAFFIC CO		
	SIGN	NUMBER	QUANTITY
22	LEFT LANE CLOSED AHEAD	W20-5L 36"x36"	1
23)		W4-2L 36"x36"	0
24)	WORK ZONE BEGINS	R5-18C 48"x48"	0
25)	SOUTH BOUND TRAVERNOOD DR CLOSED AT HURON PKWY FOLLOW DETOUR	SPECIAL 48x66	1
26)	SOUTH BOUND TRAVERWOOD DR CLOSED AT HURON PKWY FOLLOW DETOUR	SPECIAL 48x66	1
27)	DO NOT ENTER	R5-1 36x36	1
	PORTABLE, ABLE MESSAGE	QUAN LOCA ENGIN	TY EXACT ITITY AND TION WITH EER PRIOR DRDERING

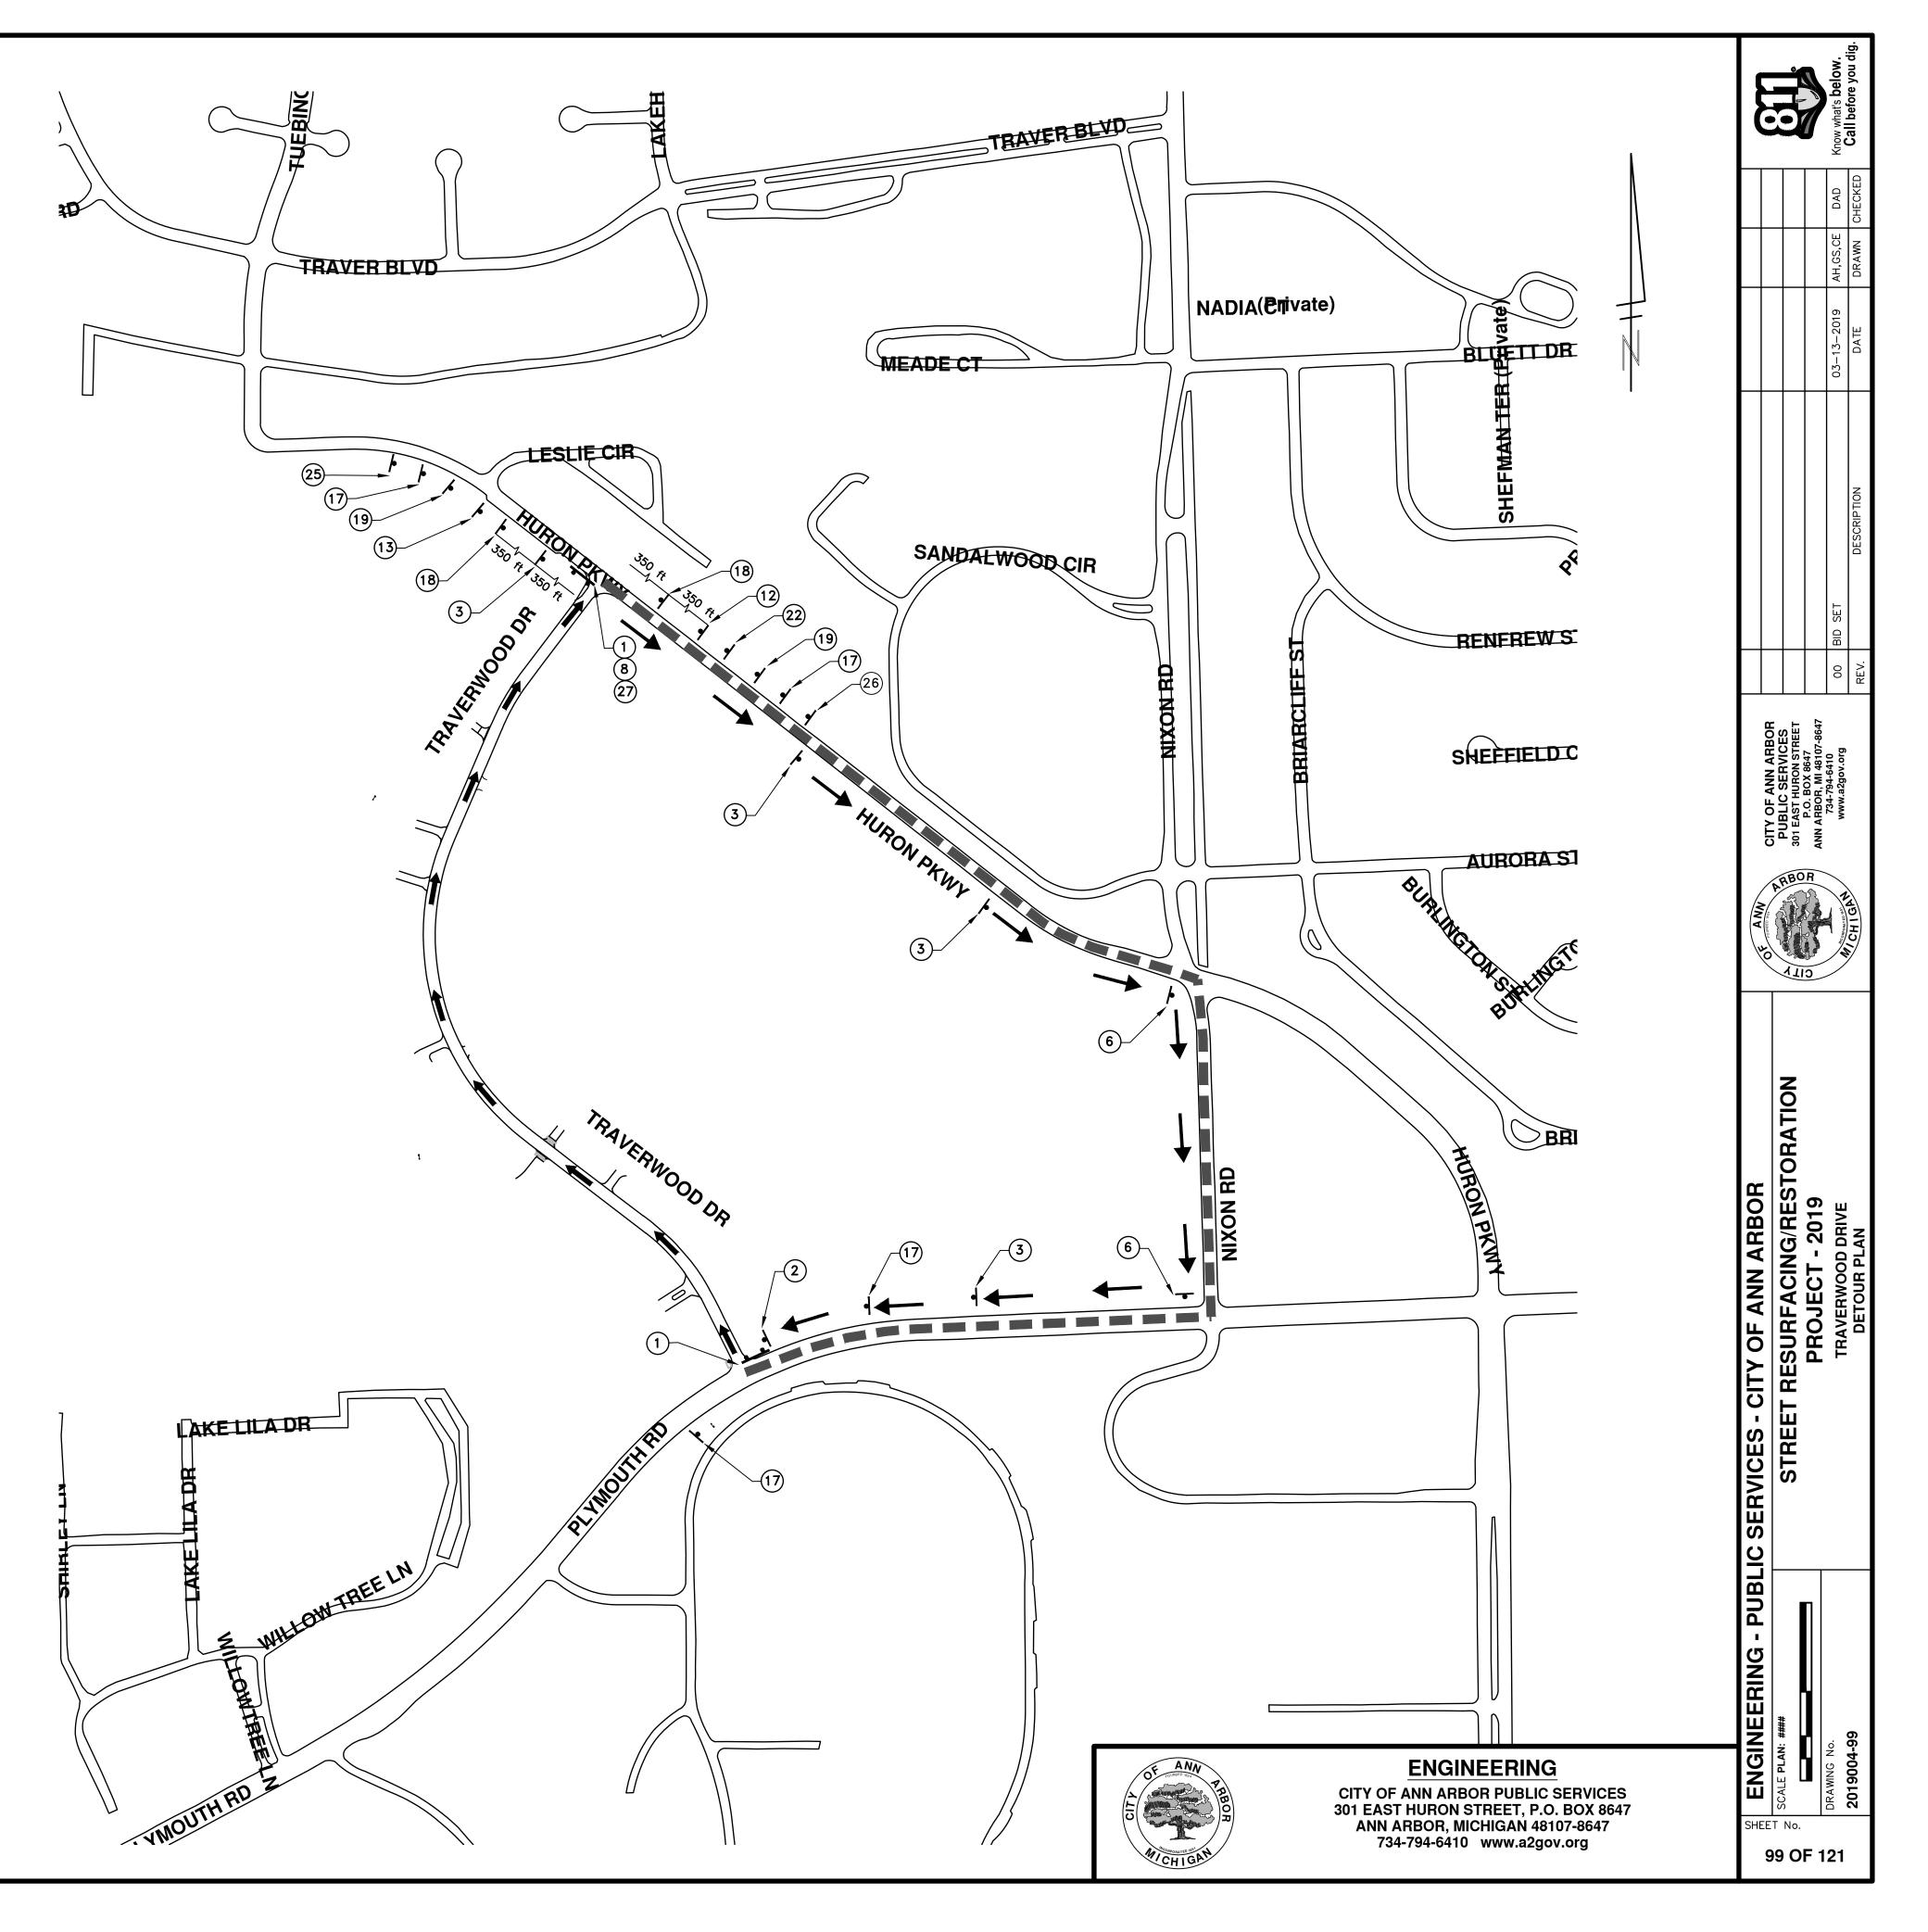


			FIC CONTROL	
		SIGN	NUMBER	QUANTITY
(1		BARRICADE TYPE III HIGH INTENSITY LIGHTED	8
	2)	TRAVERWOOD DR	D3-1 M4-8a	0
		ENDS	24X18	0
	3)	TRAVERWOOD DR	D3-1 M4-9S	0
		TRAVERNOOD DR	30x24 D3-1	0
(4	DETOUR	M4-9R 30x24	0
		TRAVERWOOD DR	D3-1	0
	5	DETOUR	M4-9L (MOD.) 30x24	0
			D3-1	0
(6	DETOUR	M4-9R (MOD.)	0
		TRAVERWOOD DR	30×24 D3-1	0
(7	DETOUR	M4-9L (MOD.)	0
	8)	DETOUR	30x24 M4-10R 48x18	0
		DETOUR	M4-10L	0
	9		48x18	
(10)	R6-1R	36"x12"	3
(11)	R6-1L	36"x12"	6
(12)	3	R3-2 24"x24"	0
(13)	R	R3-1 24"x24"	0
(14)	ROAD CLOSED	R11-2 48X30	1
(15)	ROAD CLOSED TO THRU TRAFFIC	R11-4 60x30	0
(16)	END ROAD WORK	G20-2 48" ×24"	0
(17)	ROAD WORK AHEAD	W20-1 36×36	0
		TRAVERWOOD DR	D3-1	0
(18)	DETOUR AHEAD	W20-2 36×36	0
		TRAVERWOOD DR	D3-1	0
(19)	ROAD CLOSED AHEAD	W20-3 36×36	0
		TRAVERWOOD DR	D3-1	0
	20)	RIGHT LANE CLOSED AHEAD	W20-5R 36"×36"	0
(21)		W4-2R 36"x36"	0


DETOUR CONSTRUCTION NOTES:


- 1. DEPENDING ON THE DETOUR ROUTES THAT ARE PUT IN PLACE, CONFLICTING SIGNS MAY BE PRESENT. PRIOR TO THE ORDERING OR PLACEMENT OF ANY SIGNS, MEET WITH THE ENGINEER TO VERIFY THE EXACT NUMBER AND LOCATION OF THE SIGNS TO BE PLACED. THE ENGINEER AND THE CONTRACTOR SHALL WORK TOGETHER TO ELIMINATE ALL CONFLICTS.
- 2. THE CITY RESERVES THE RIGHT TO ORDER ADDITIONAL SIGNS AND PLACE THEM INTO SERVICE IN ORDER TO SAFELY MAINTAIN TRAFFIC. ADJUSTMENTS IN THE UNIT PRICE FOR THESE ITEMS OF WORK SHALL NOT BE ALLOWED FOR THESE OCCURRENCES.
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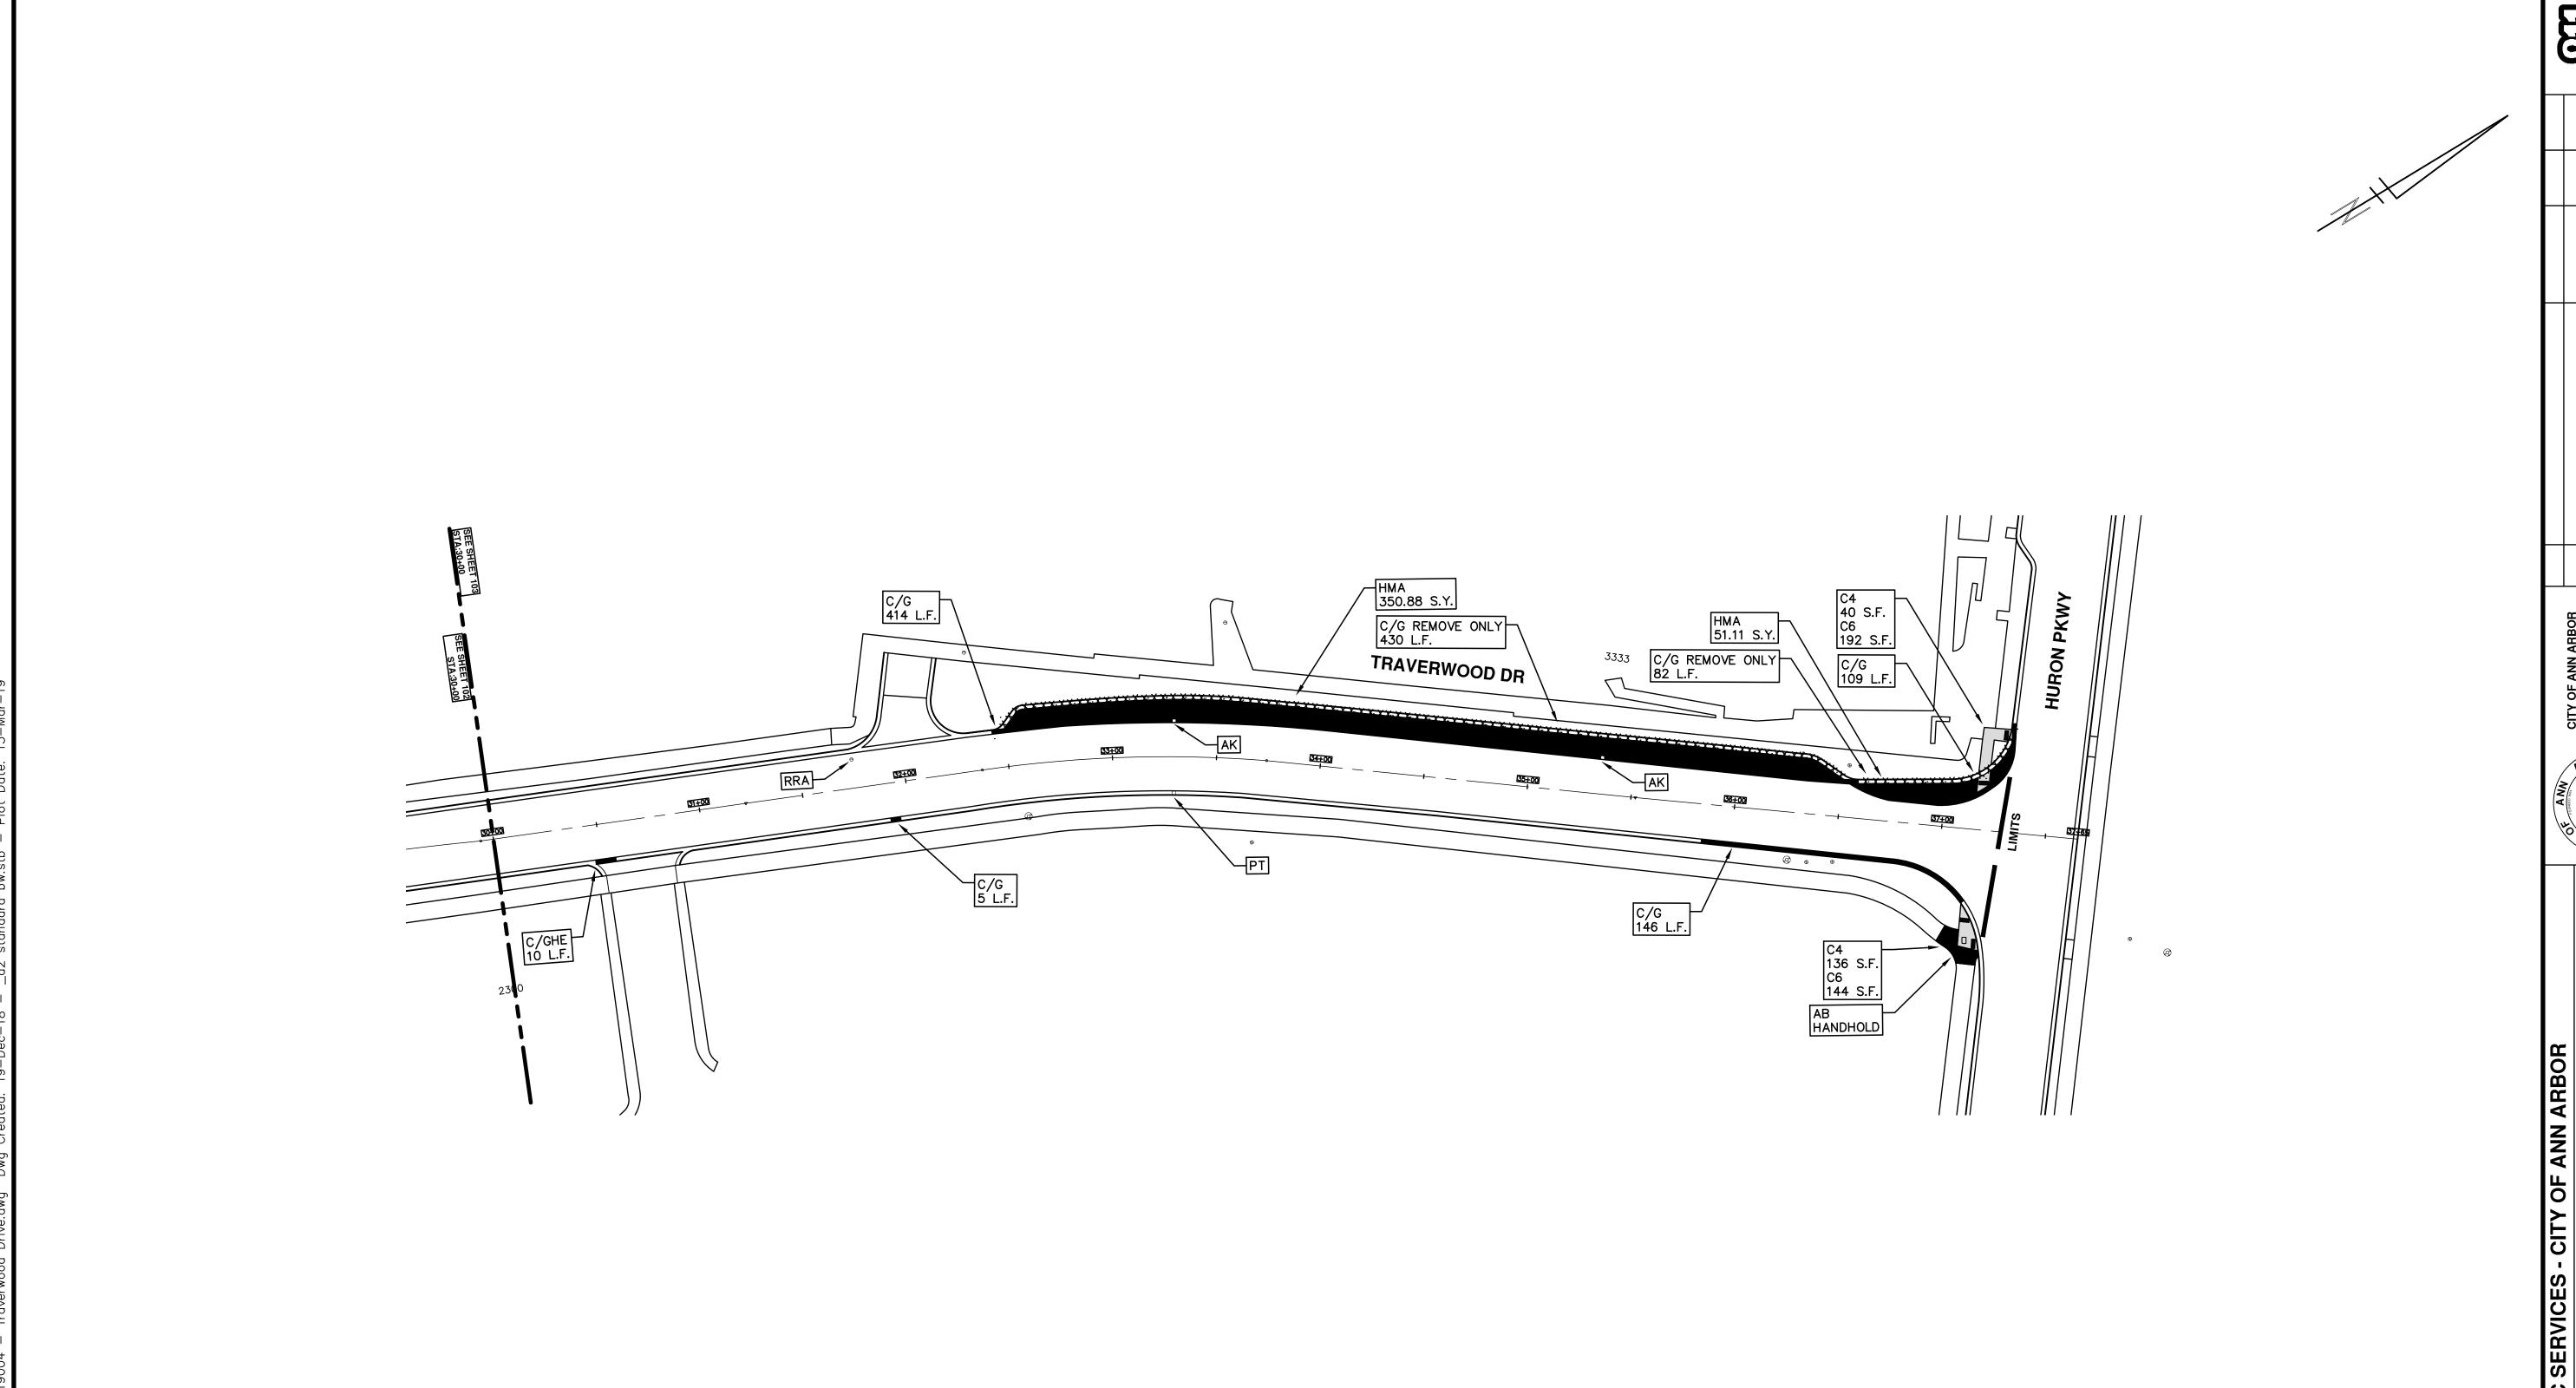
LEGEND:	
SOUTH BOUND PLATT DETOUR ROUTE	
NORTH BOUND PLATT TRAFFIC MAINTAINED	


TRAFFIC CONTROL SIGN						
	SIGN	NUMBER	QUANTITY			
22)	LEFT LANE CLOSED AHEAD	W20-5L 36"x36"	0			
23)		W4-2L 36"×36"	0			
24)	WORK ZONE BEGINS	R5–18C 48"x48"	0			
25)	SOUTH BOUND TRAVERMOOD DR CLOSED AT HURON PKWY FOLLOW DETOUR	SPECIAL 48x66	0			
26)		SPECIAL 48x66	0			
27)	DO NOT ENTER	R5-1 36x36	0			
SIGN, PORTABLE, CHANGEABLE MESSAGE		VERIFY EXACT QUANTITY AND LOCATION WITH ENGINEER PRIOR TO ORDERING				



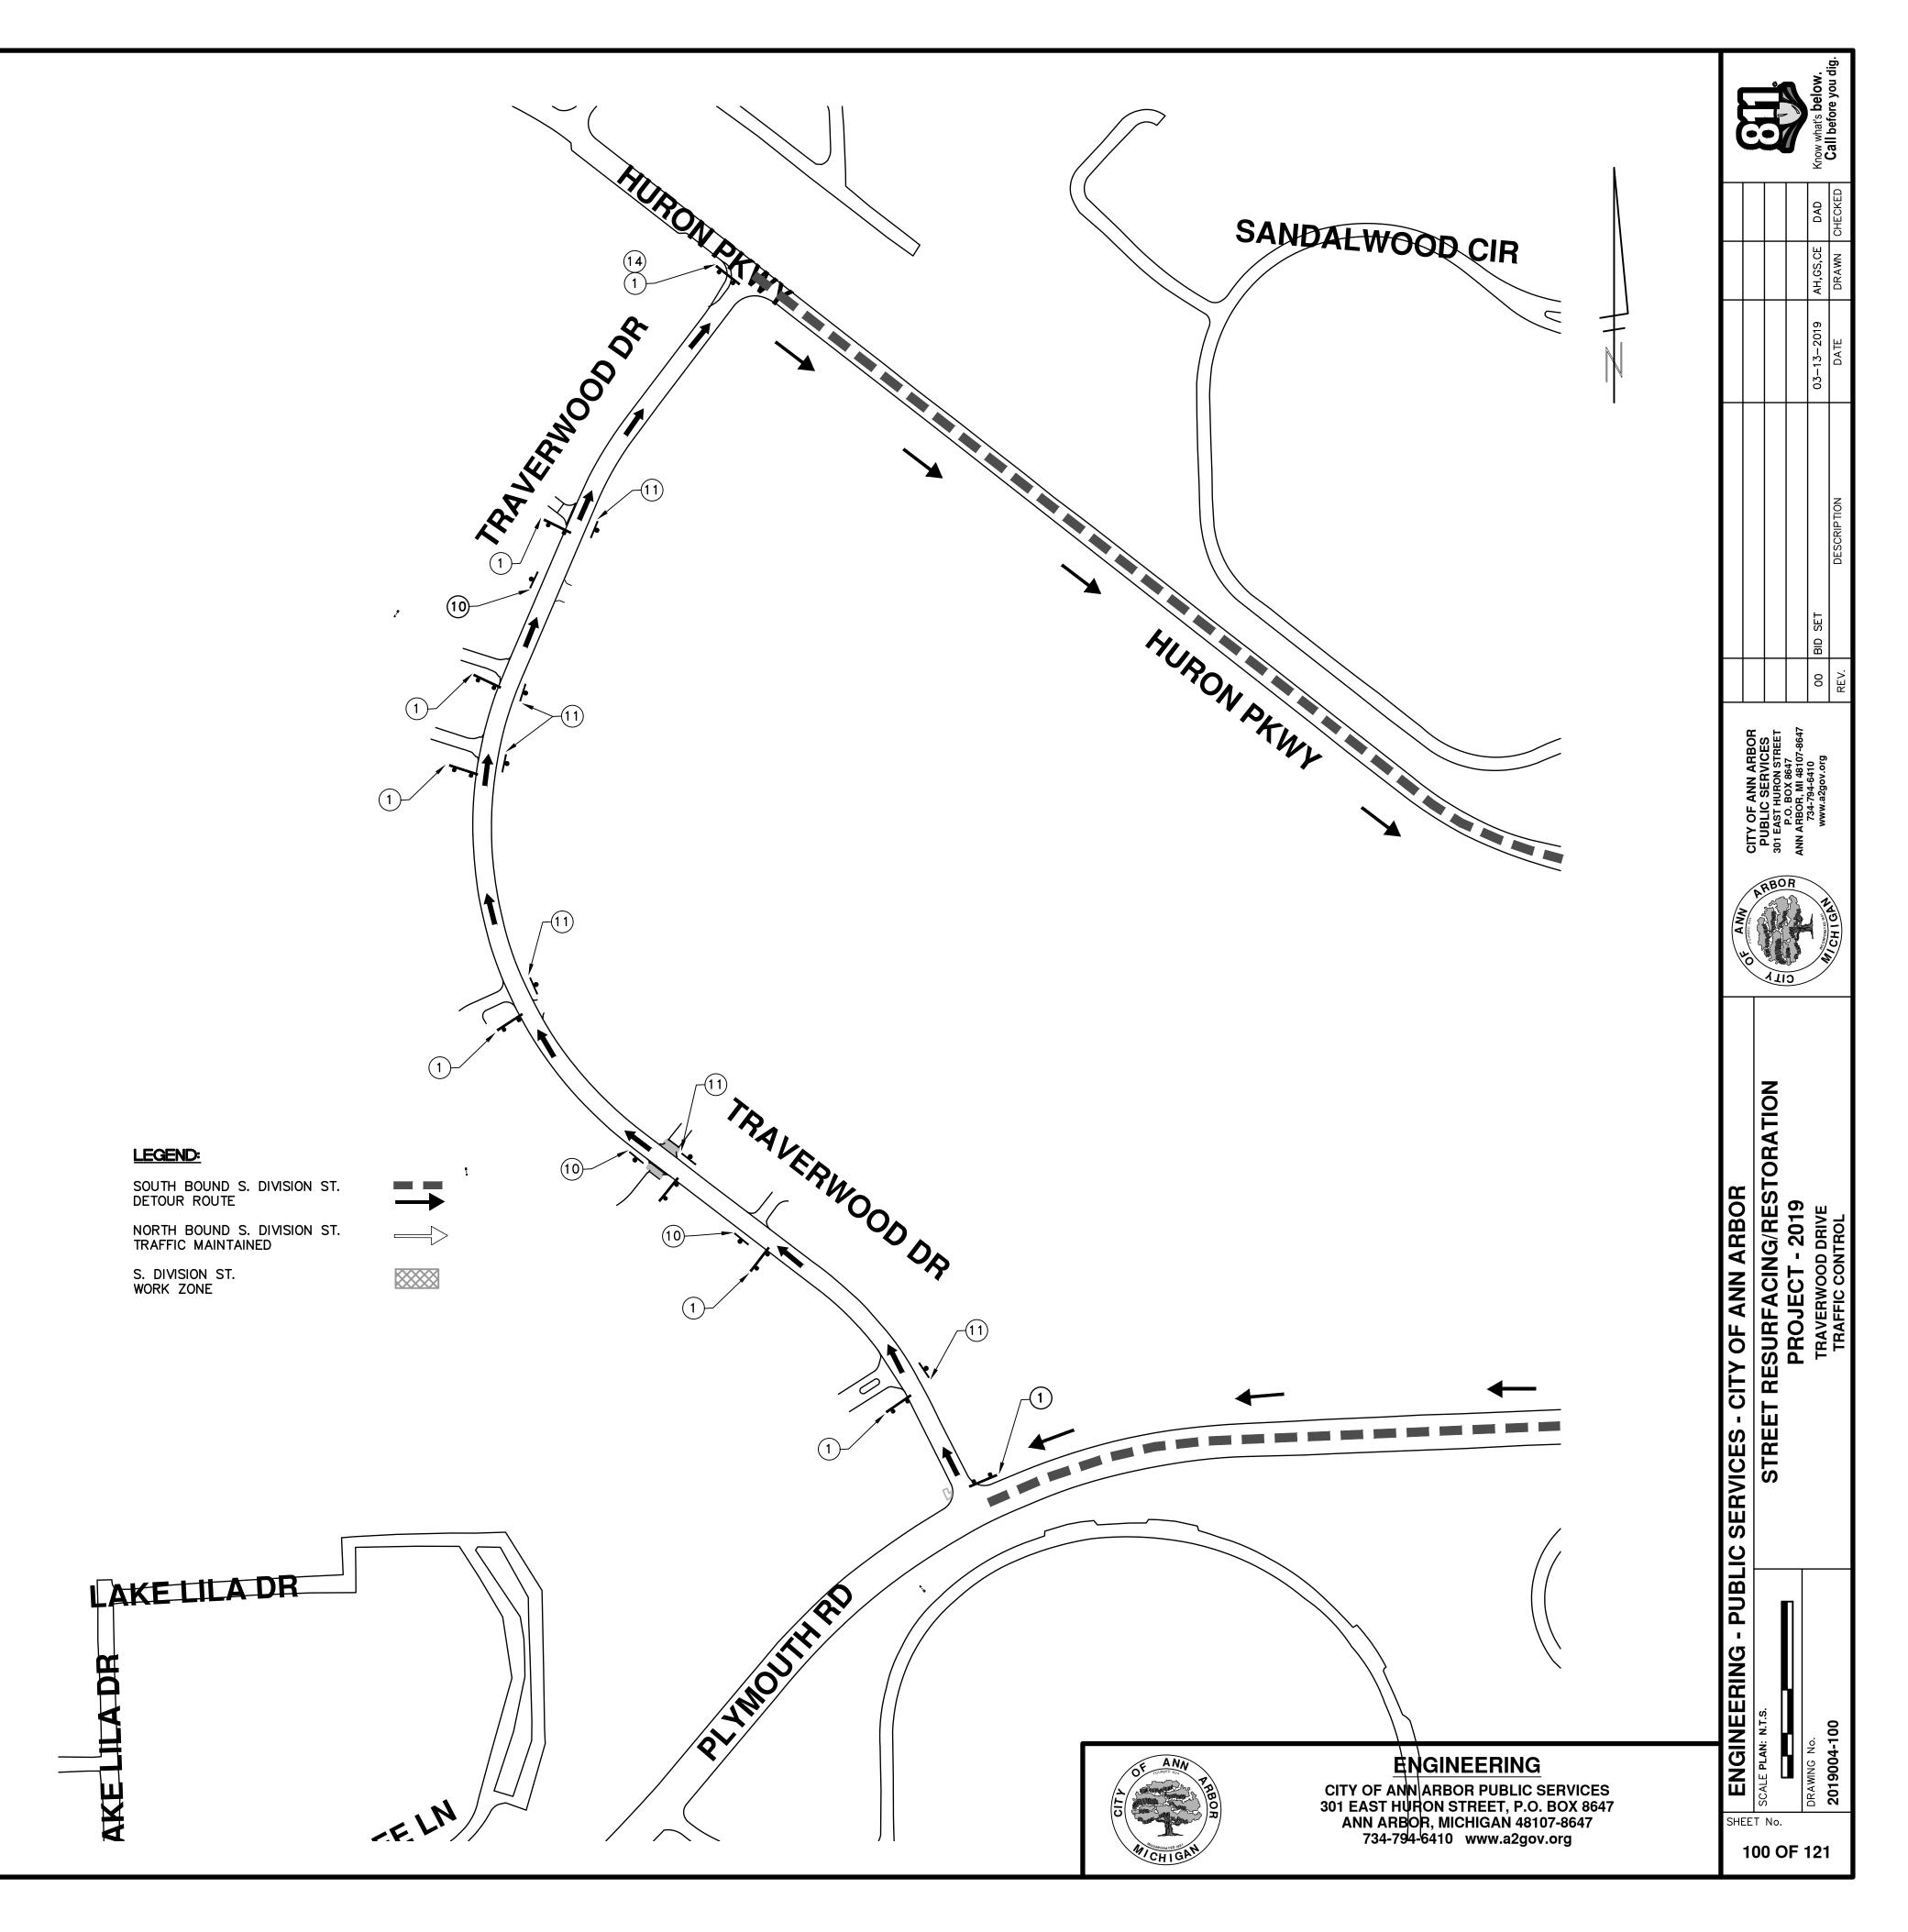

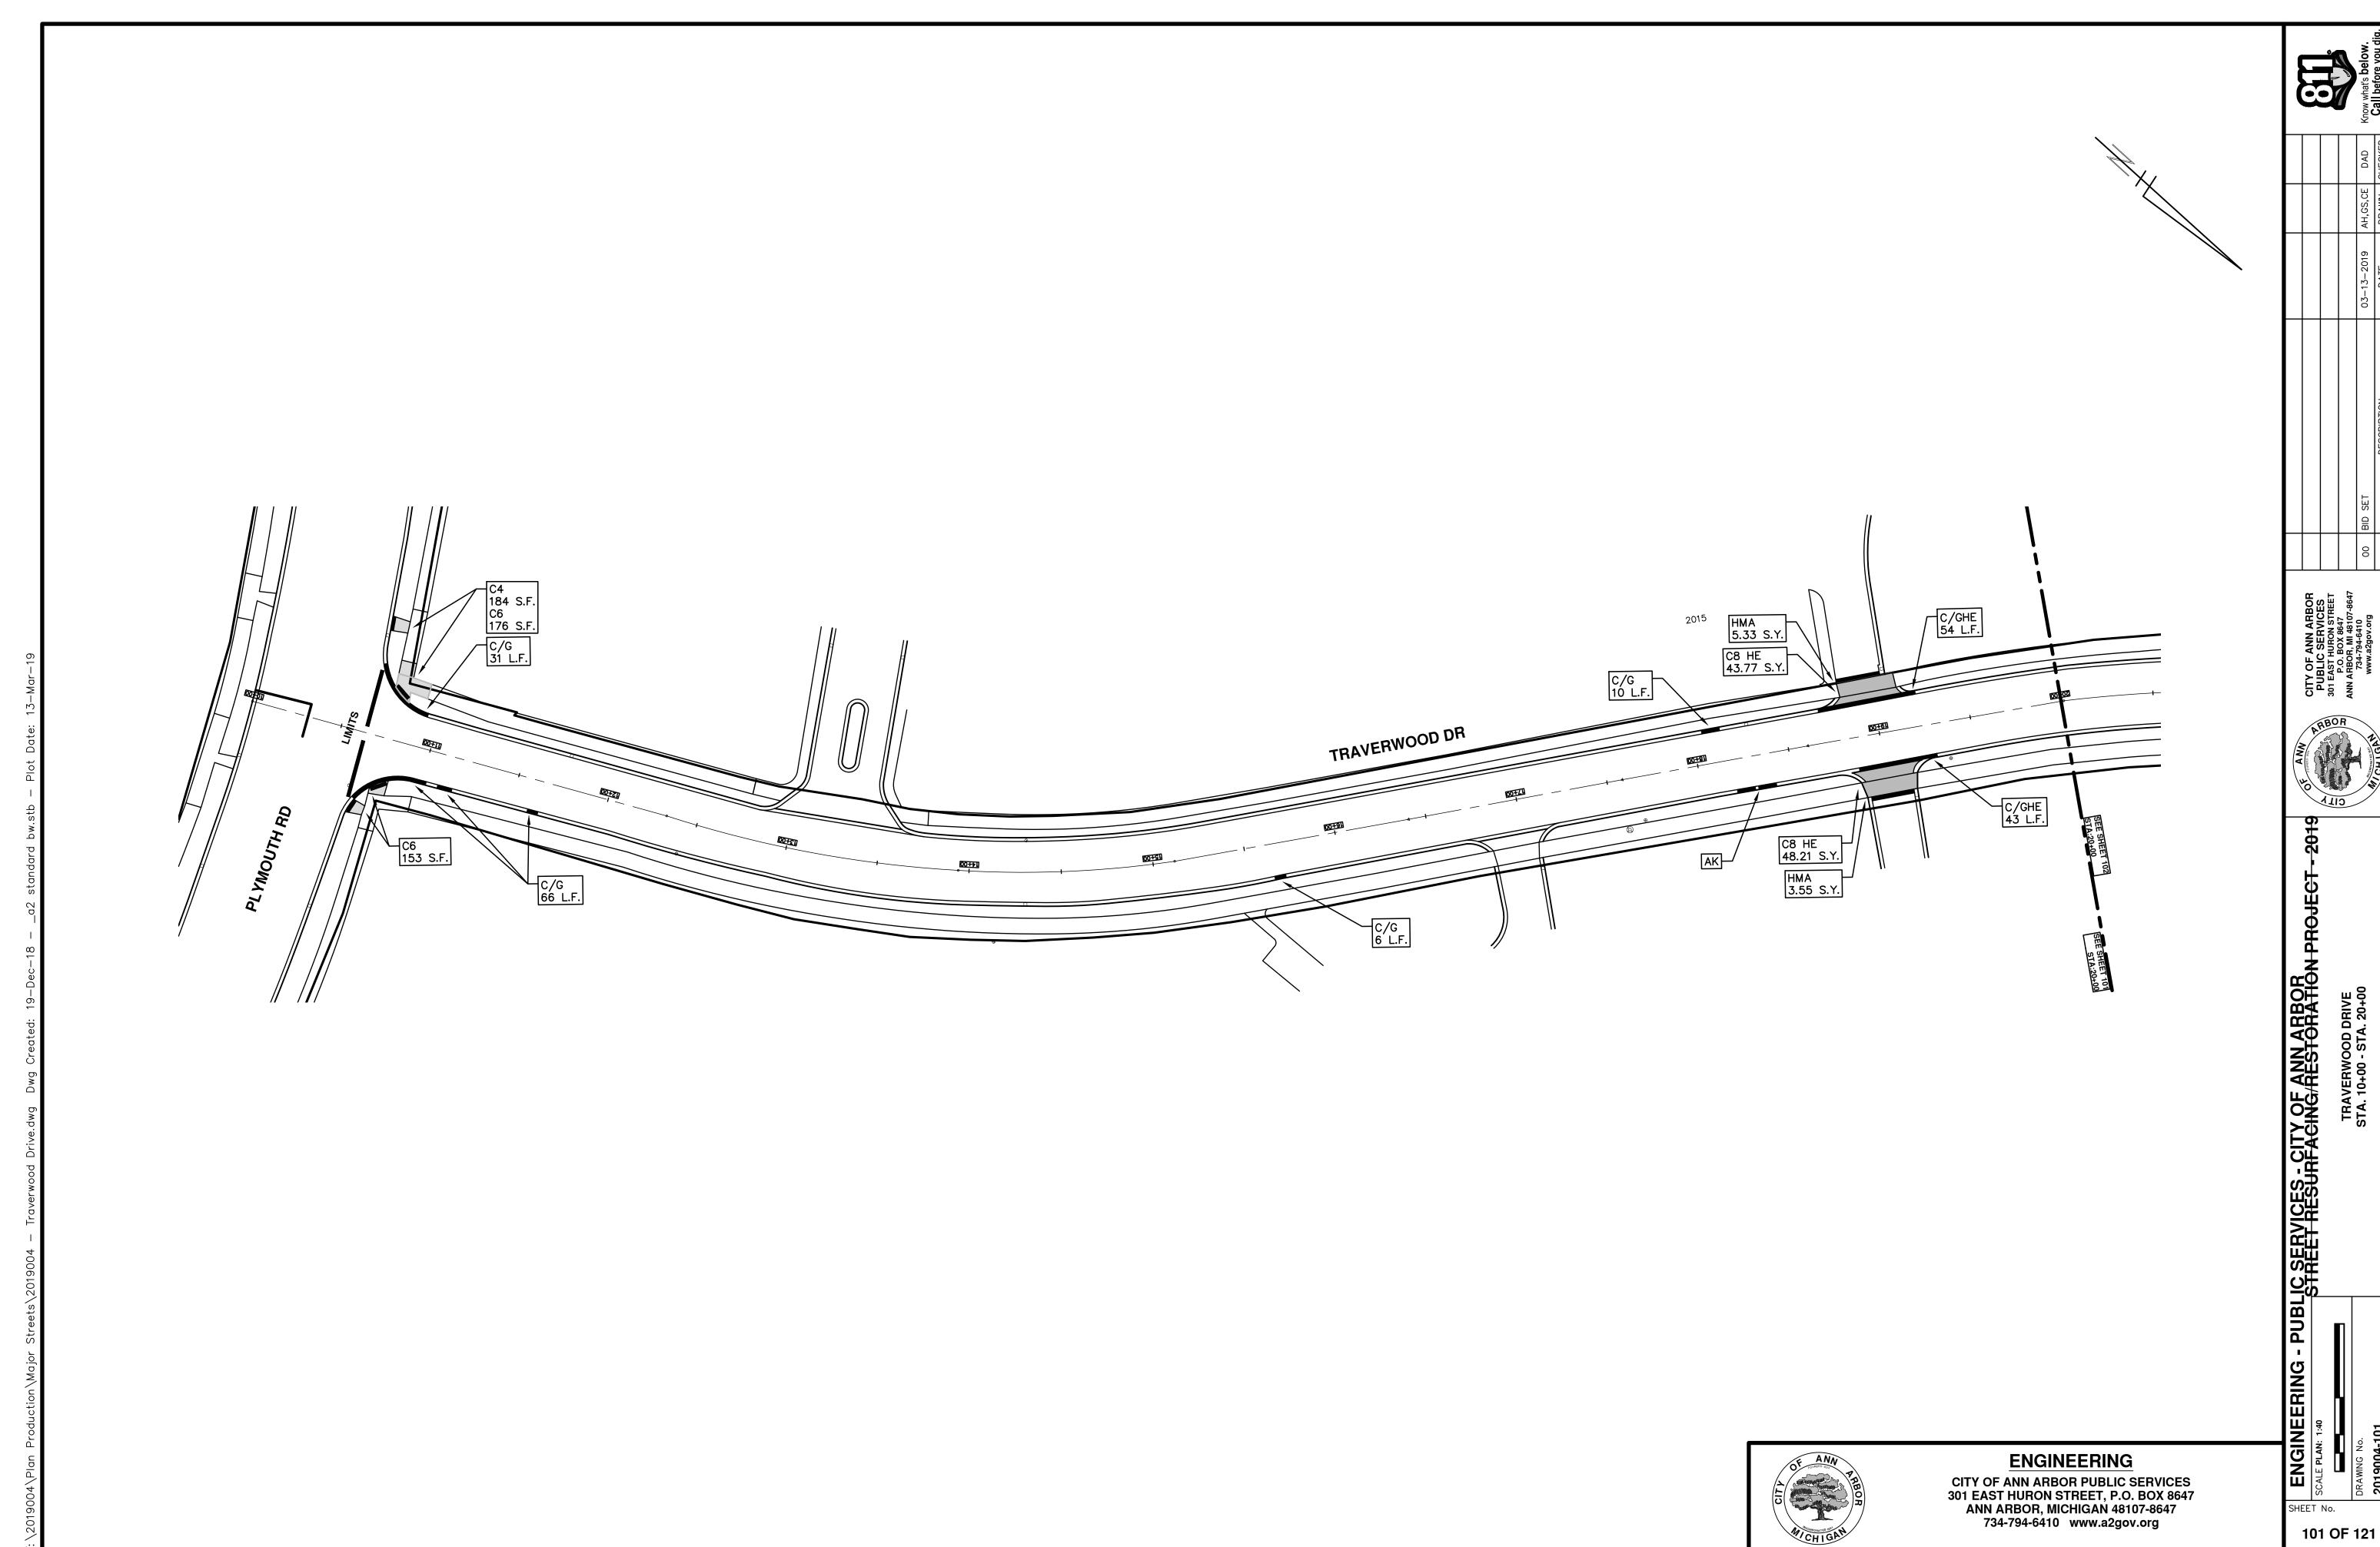

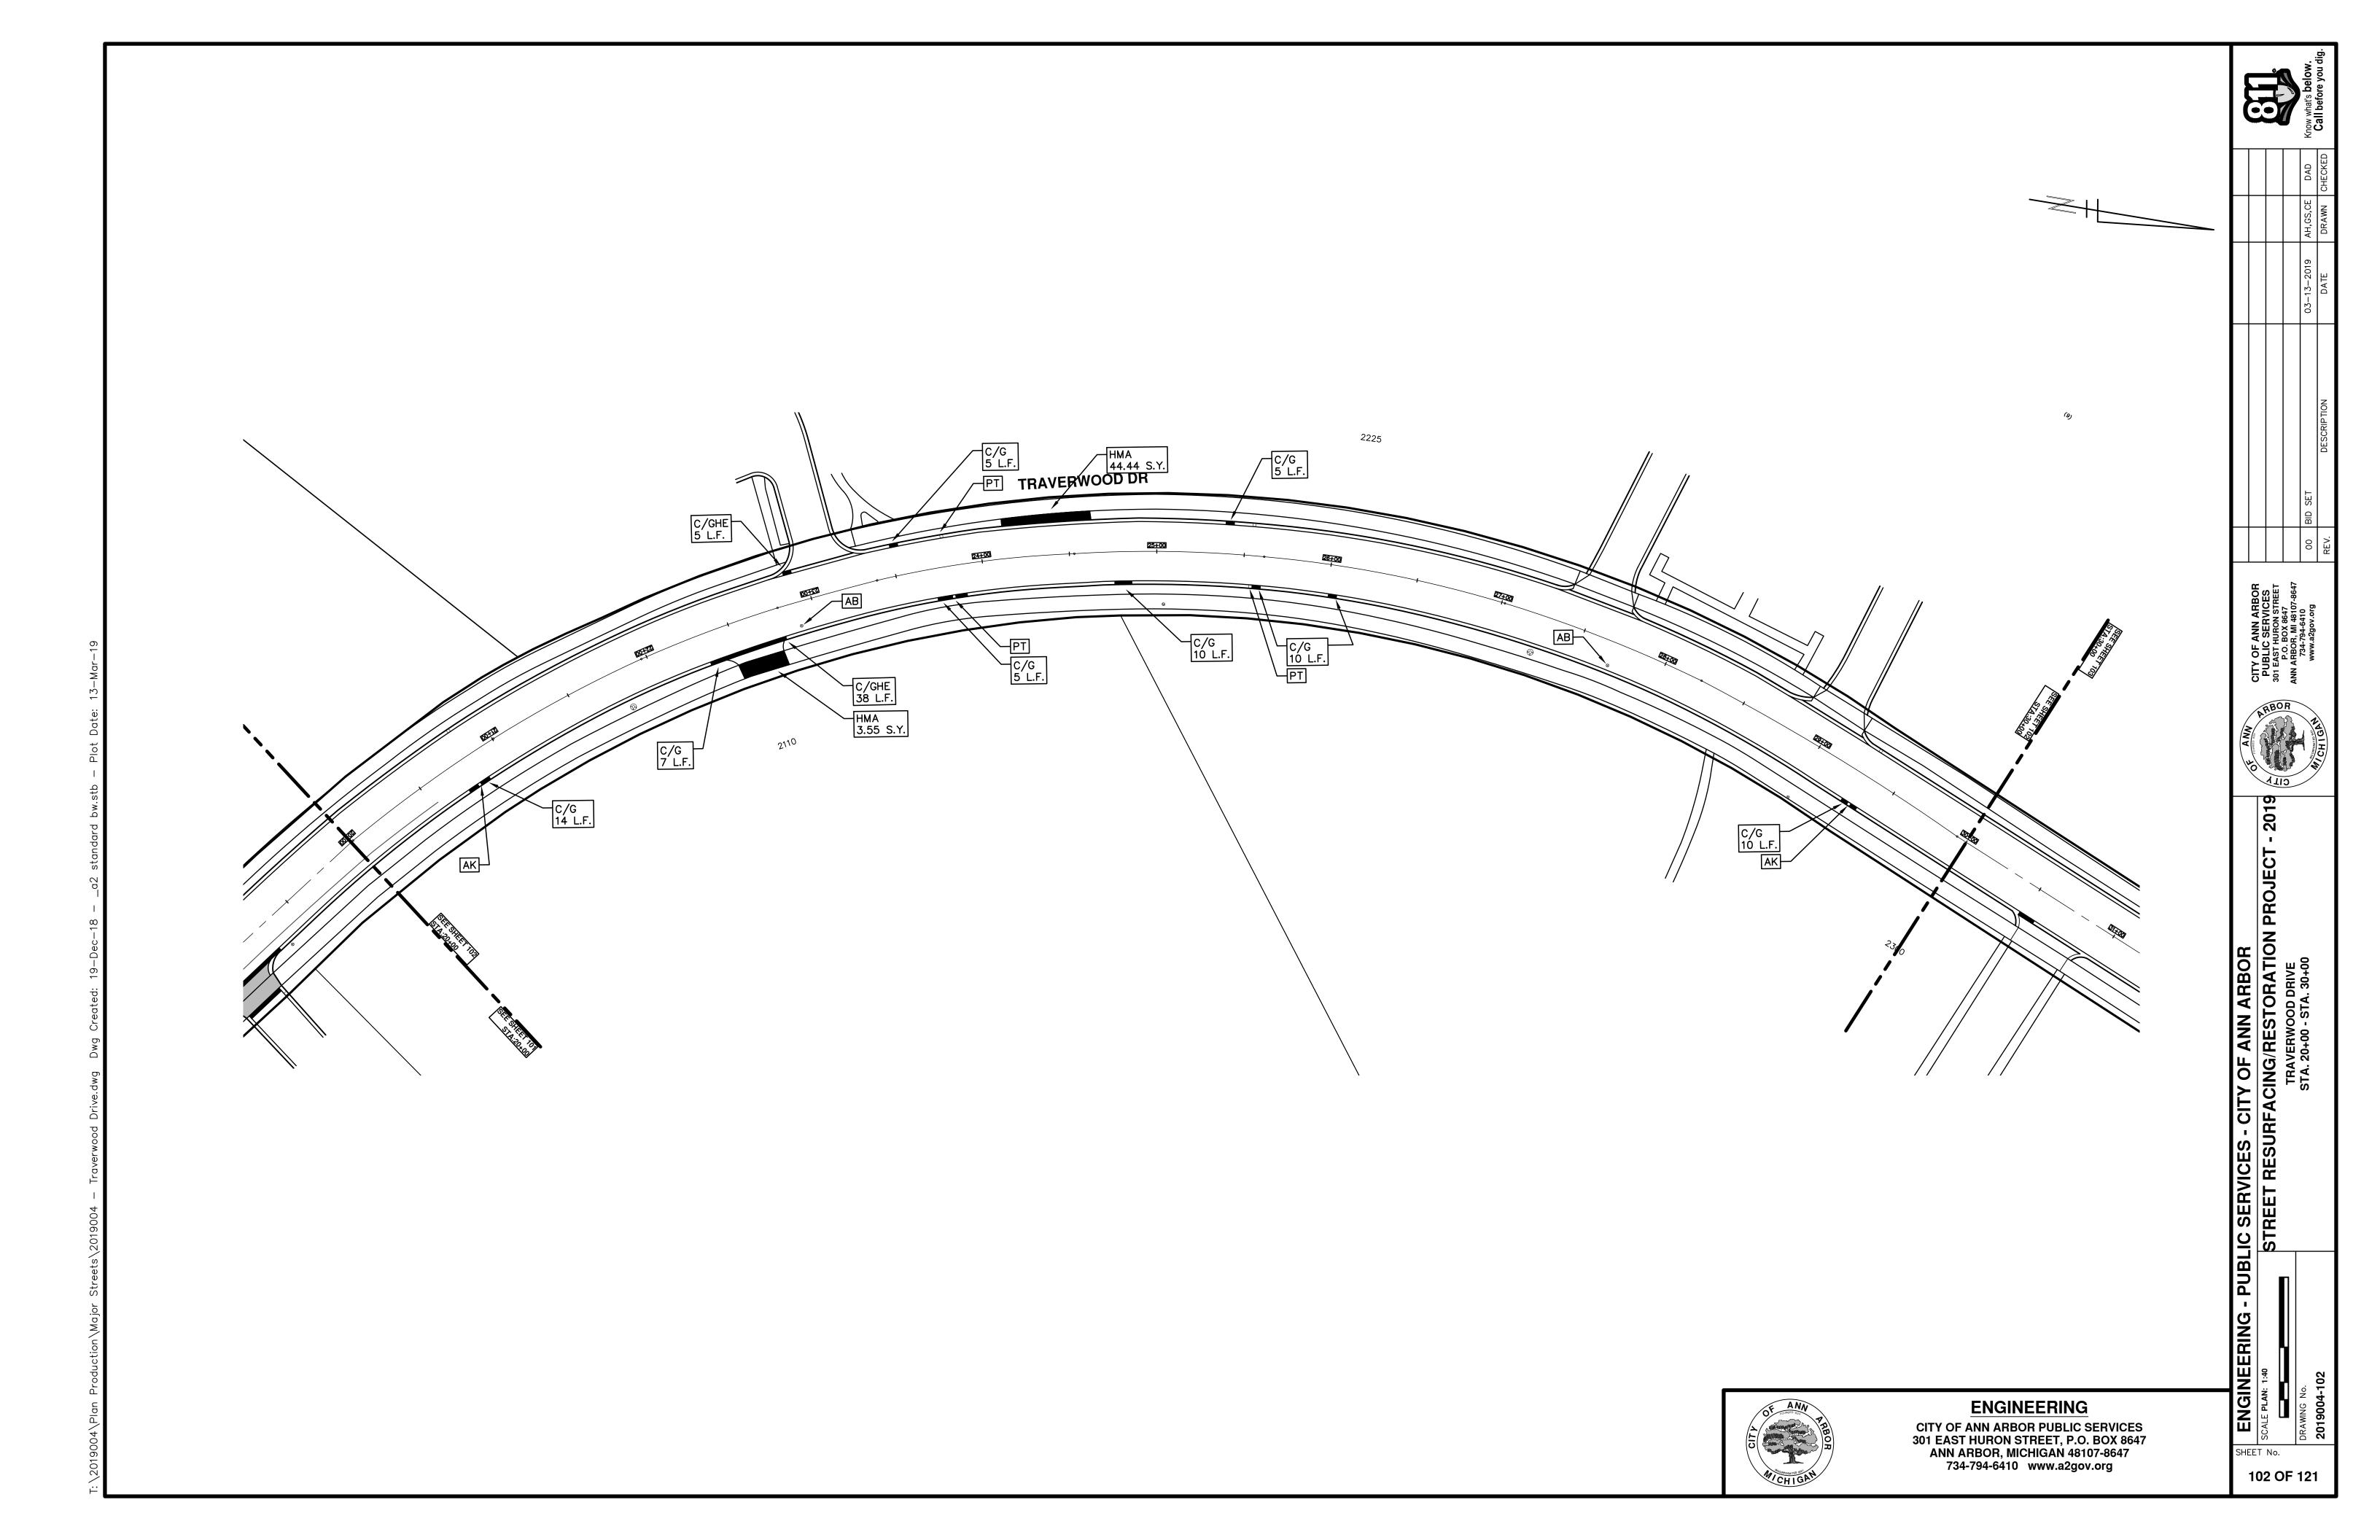

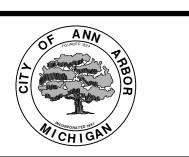


ENGINEERING


CITY OF ANN ARBOR PUBLIC SERVICES 301 EAST HURON STREET, P.O. BOX 8647 ANN ARBOR, MICHIGAN 48107-8647 734-794-6410 www.a2gov.org


ENGINEERING - PUBLIC SERVICES - CITY OF ANN ARBOR

SCALE PLAN: 1:40

STREET RESURFACING/RESTORATION
TRAVERWOOD DRIVE
DRAWING NO.

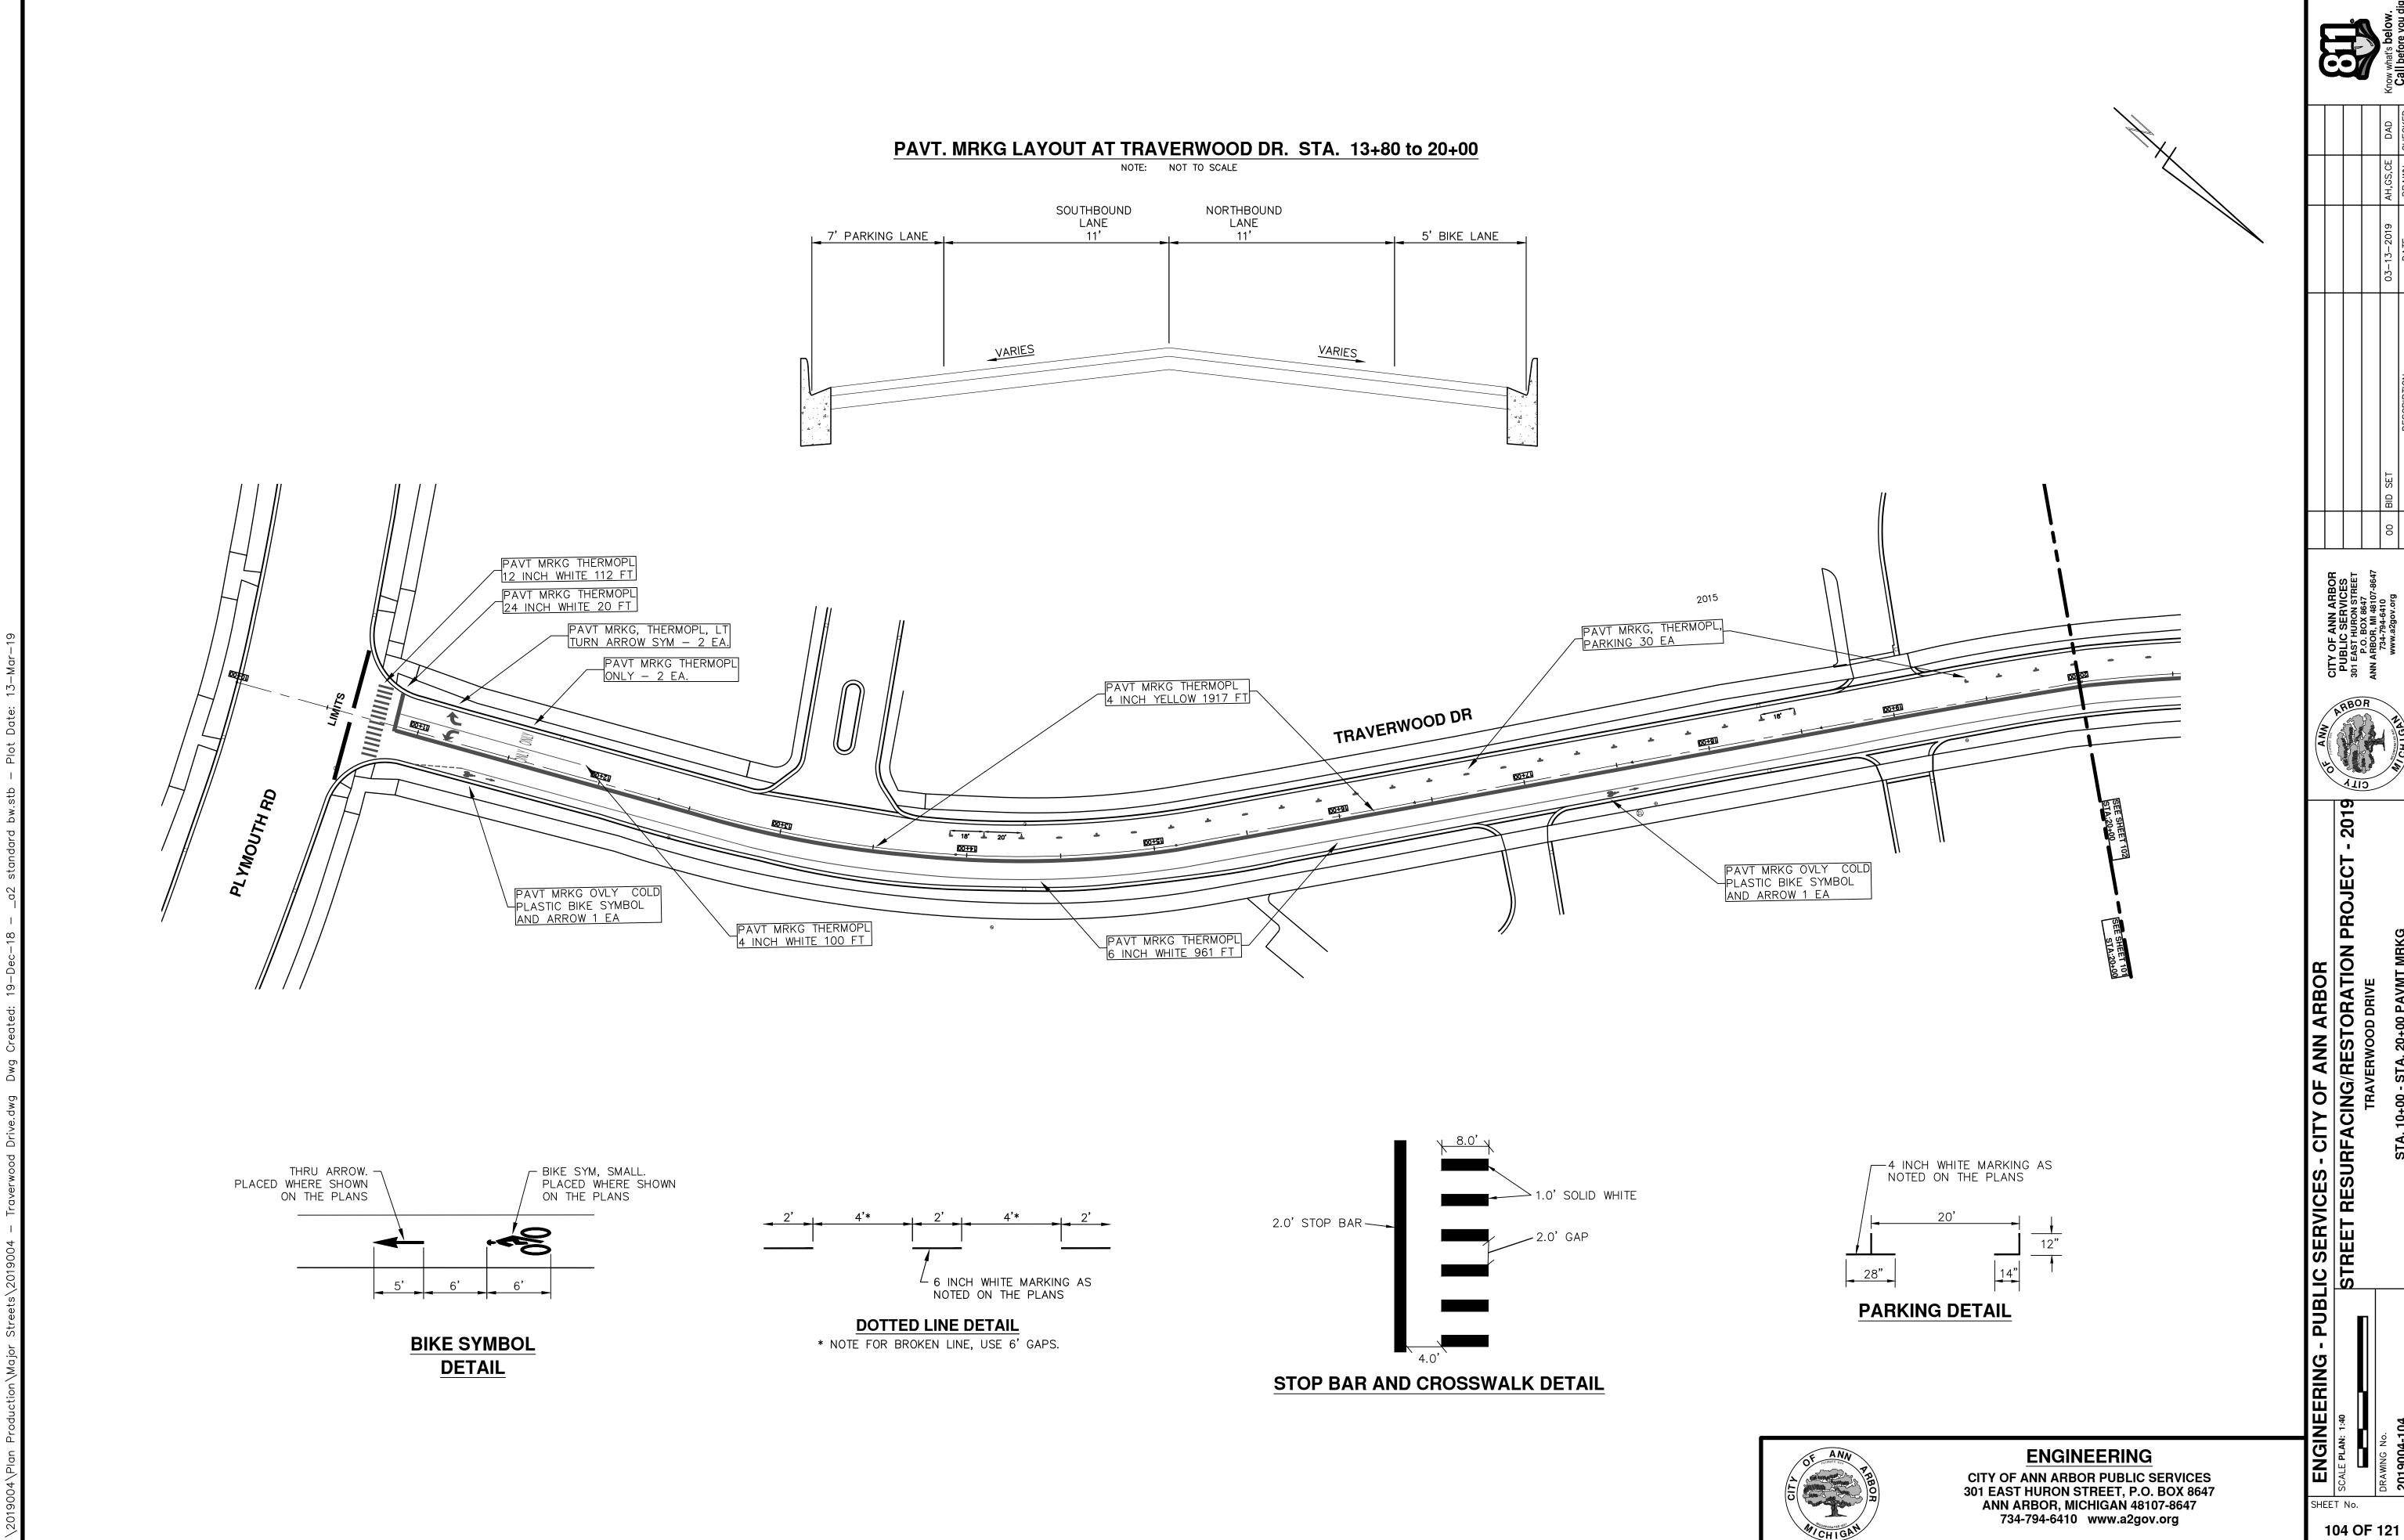

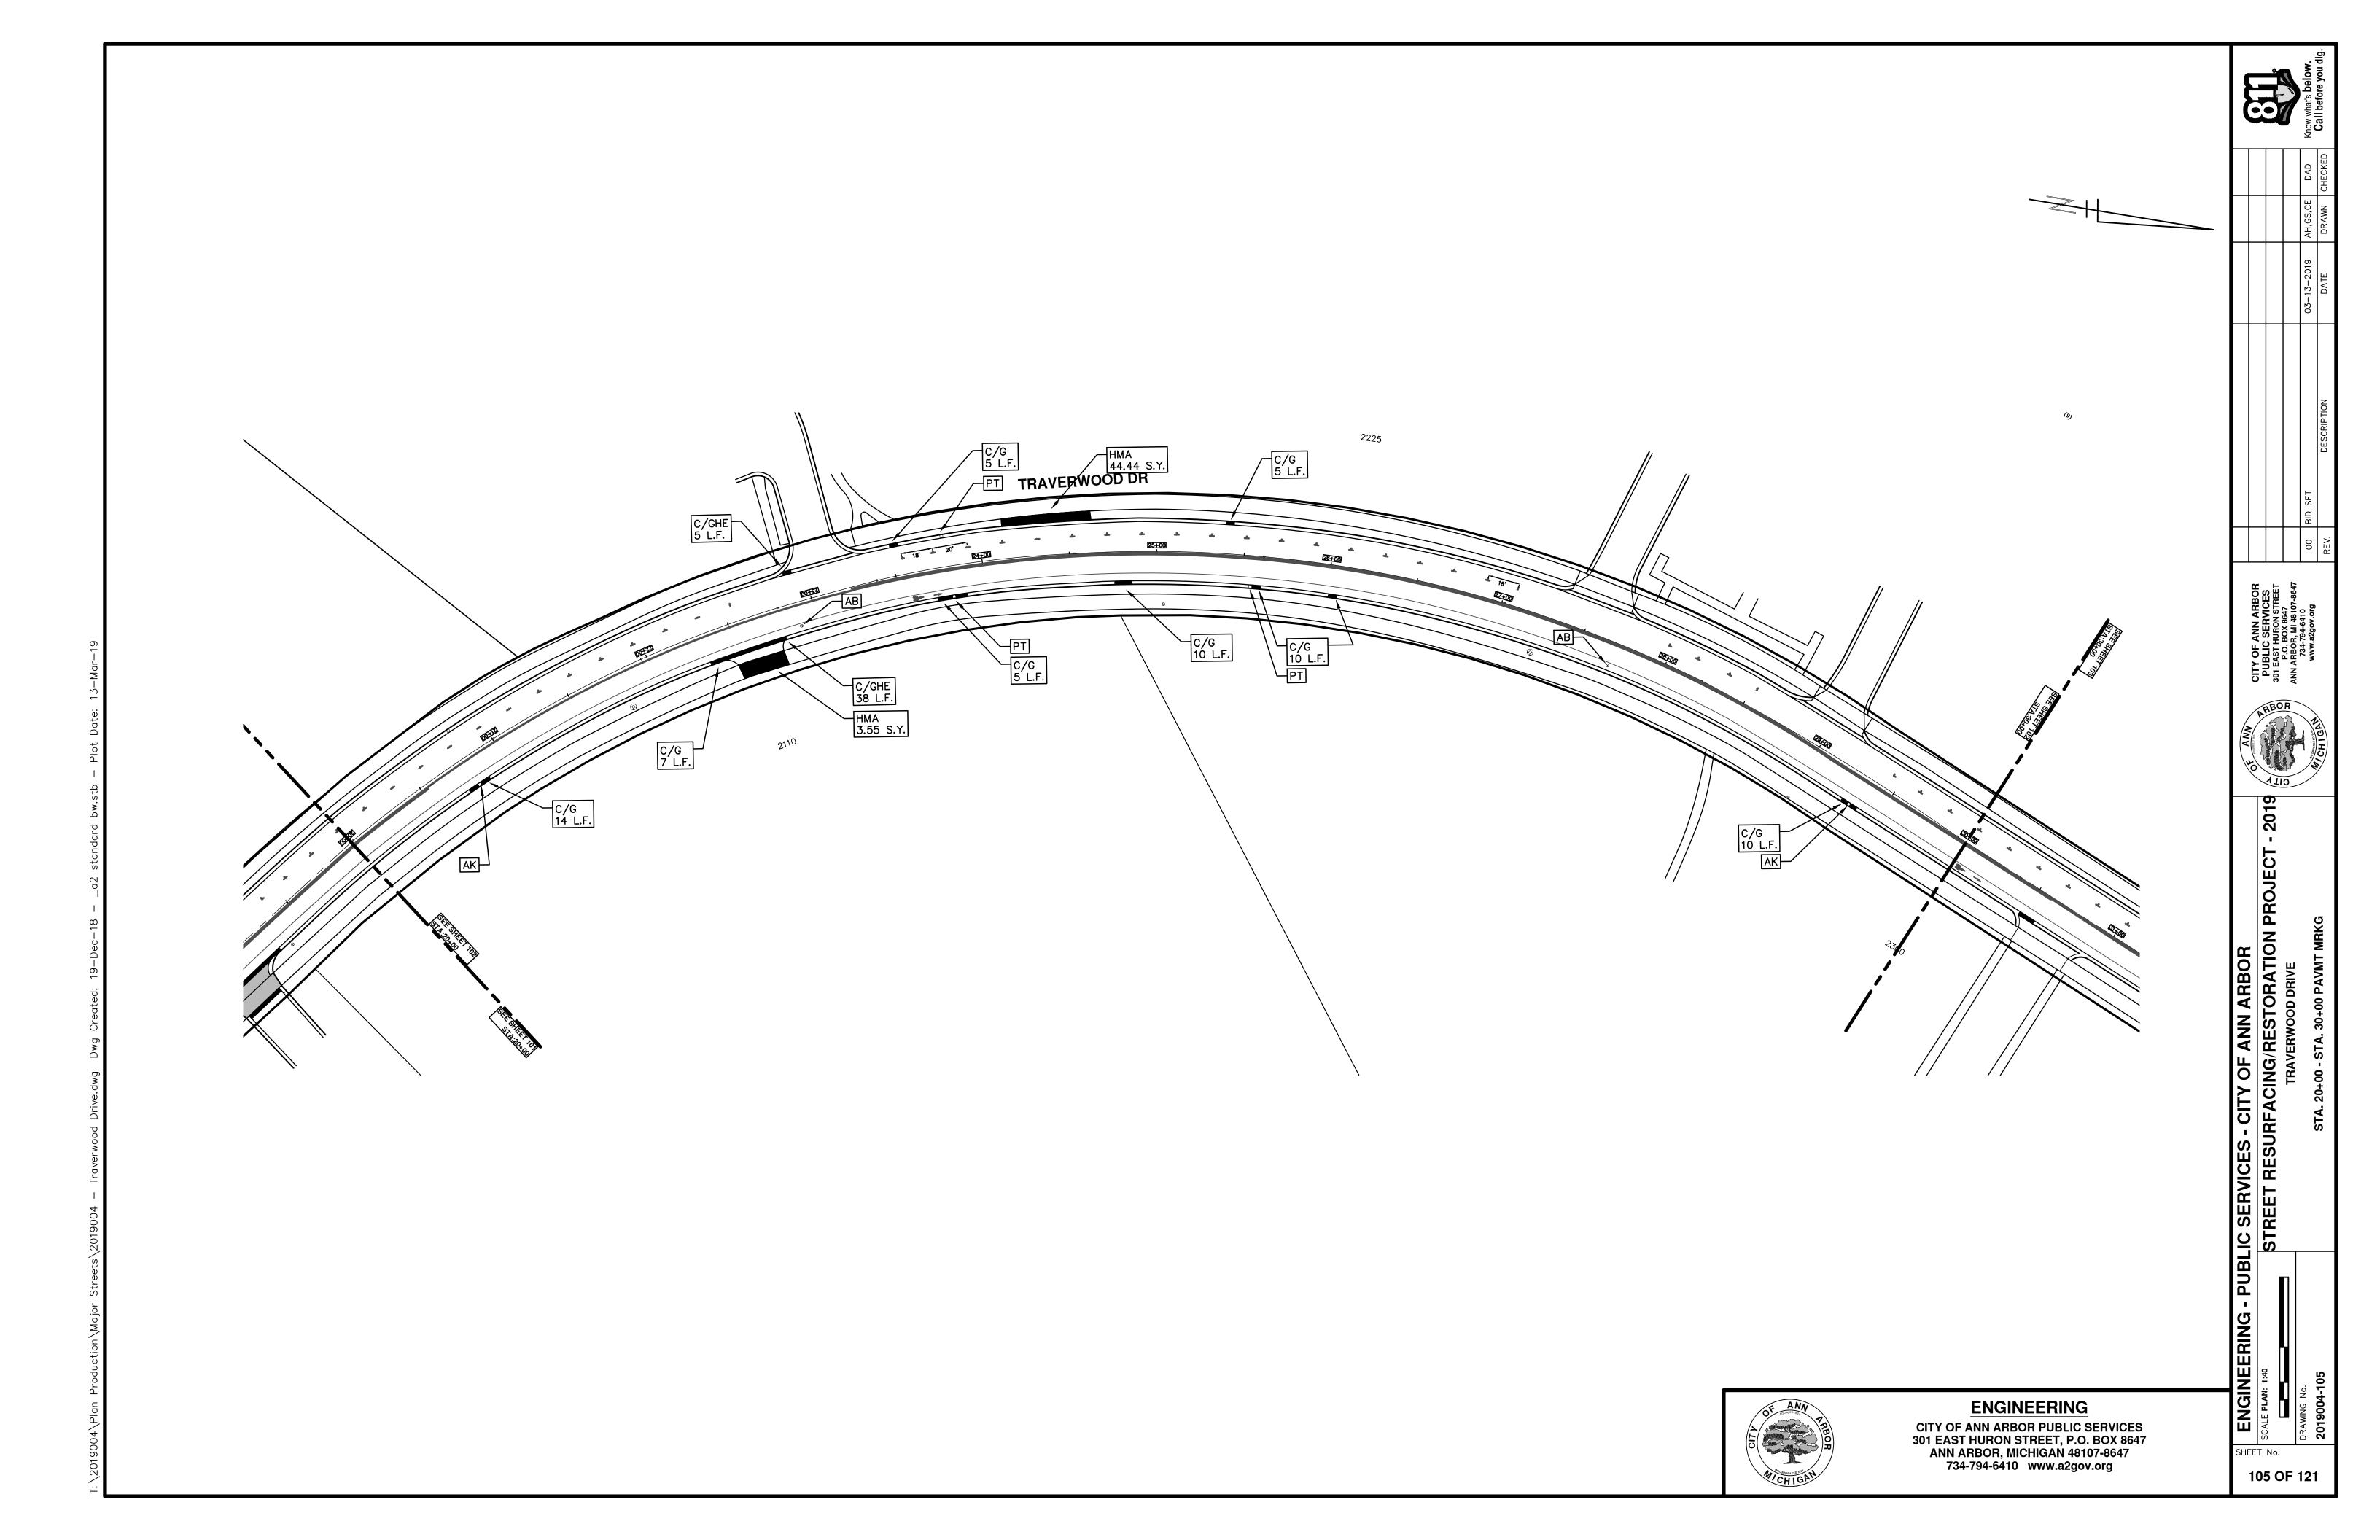

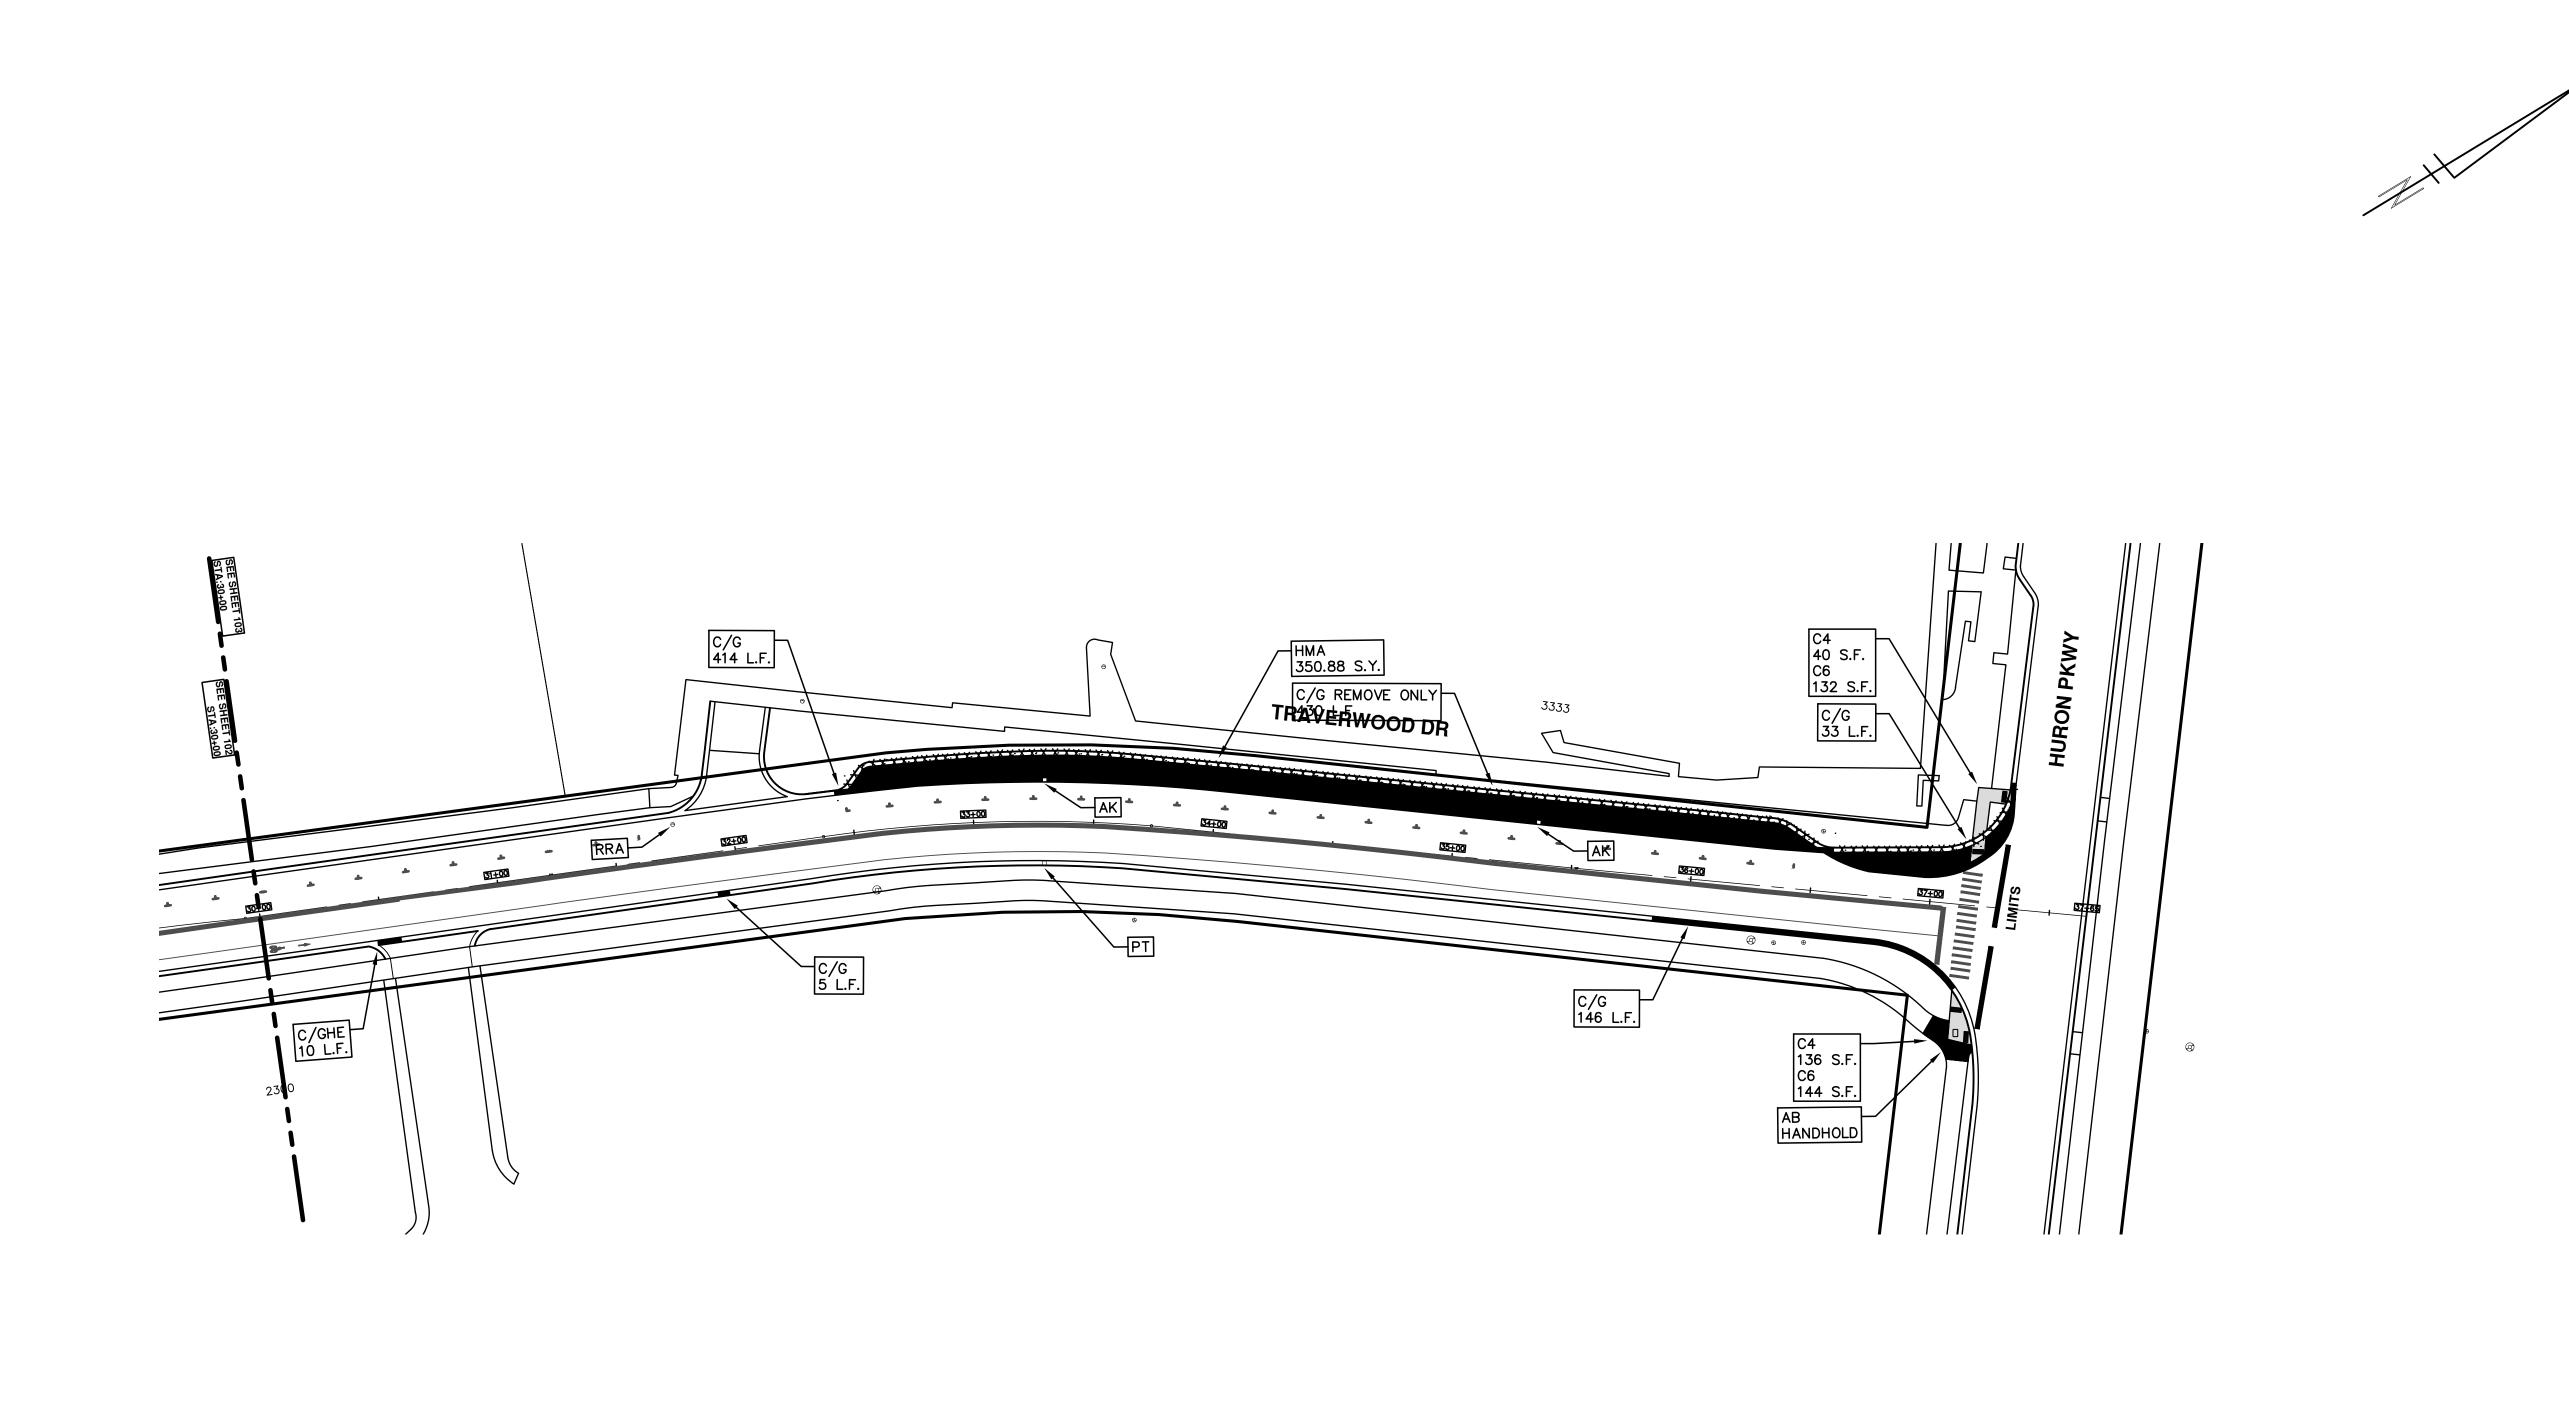



ENGINEERING

CITY OF ANN ARBOR PUBLIC SERVICES 301 EAST HURON STREET, P.O. BOX 8647 ANN ARBOR, MICHIGAN 48107-8647 734-794-6410 www.a2gov.org

ENGINEERING - PUBLIC SERVICES - CITY OF ANN ARBOR

SCALE PLAN: 1:40

STREET RESURFACING/RESTORATION PROJI

TRAVERWOOD DRIVE

DRAWING NO.



CITY OF ANN ARBOR ENGINEERING PROJECT LOCATION: WEST LIBERTY

ITB No.4570 FILE No. 2019004

	CONSTRUCTION KEY
KEY	ASSOCIATED PAY ITEM(S)
	• _Dr Structure, Adj, Case 1, Modified
AA	• _Dr Structure, Adj, Case 2, Modified
	• _Dr Structure, Temp Lowering, Modified
	• _Dr Structure, Temp Lowering, Modified
AB	• _Gate Box, Adj, Case 1
	• _Gate Box, Adj, Case 2
	Monument Box Adjust
ADST	Dr Structure, Adj, Add Depth, Modified
AK	• _Dr Structure, Adj, Case 1, Modified
	• _Sidewalk, Sidewalk Ramp, and Driveway Approach, Any Thickness, Rem
C4	Grading, Sidewalk
	• _Sidewalk, Conc, 4 inch, Modified
	Sidewalk, Sidewalk Ramp, and Driveway Approach, Any Thickness, Rem
	• Grading, Sidewalk
C4HE	• Cement
	Sidewalk, Conc, 4 inch, Modified Sidewalk, Sidewalk Ramp, and Driveway Approach, Apv Thickness, Rem
	_Sidewalk, Sidewalk Ramp, and Driveway Approach, Any Thickness, RemGrading, Sidewalk
C6	• _Grading, Sidewalk Ramp
	• _Detectable Warning Surface, Modified
	• _Sidewalk Ramp, Conc, 6 inch, Modified
	• _Sidewalk, Conc, 6 inch, Modified
C8	• _Grading, Driveway Approach
	• _Driveway, Nonreinf Conc, 8 inch, Modified
	• _Sidewalk, Sidewalk Ramp, and Driveway Approach, Any Thickness, Rem
	• _Grading, Driveway Approach
	• _Grading, Sidewalk
	• _Grading, Sidewalk Ramp
C HE	Cement
OTIL	• _Driveway, Nonreinf Conc, 6 inch, Modified
	• _Driveway, Nonreinf Conc, 8 inch, Modified
	• _Detectable Warning Surface, Modified
	• _Sidewalk Ramp, Conc, 6 inch, Modified
	• _Sidewalk, Conc, 6 inch, Modified
C/G	• _Curb, Gutter, and Curb and Gutter, Any Type, Rem
O/ O	• _Curb and Gutter, Conc
	• _Curb, Gutter, and Curb and Gutter, Any Type, Rem
C/GHE	Cement
	• _Driveway Opening, Conc, Det M, Modified
СР	• _Grading, Sidewalk
CP	• _Sidewalk, Conc, 4 inch, Modified
CR	• _Sidewalk, Sidewalk Ramp, and Driveway Approach, Any Thickness, Rem
	Dr Structure, Rem
DS	Sewer, Rem, Less than 24 inch
	Dr Structure, 24 inch dia
	Dr Structure, Rem
DSDI	Sewer, Rem, Less than 24 inch
	• _Dr Structure, Double Inlet
PT	Dr Structure, Point
	Dr Structure Cover, Type B
	• _Dr Structure Cover, Type B, Special
RRA	• _Dr Structure, Adj, Case 1, Modified
INIMA	• _Dr Structure, Temp Lowering, Modified
INIVI	Dr Structure Cover, Type K
RRK	
RRK	• _Dr Structure, Adj, Case 1, Modified
	• _Dr Structure, Adj, Case 1, Modified • _Dr Structure, Reconstruct
RRK	 _Dr Structure, Adj, Case 1, Modified _Dr Structure, Reconstruct Plastic Drum, High Intensity, Lighted, Fum
RRK RS	• _Dr Structure, Adj, Case 1, Modified • _Dr Structure, Reconstruct

NOTES:

FOR PROTECTION OF UNDERGROUND UTILITIES AND IN CONFORMANCE WITH PUBLIC ACT 174 OF 2013, THE CONTRACTOR SHALL CALL 811 OR 1-800-482-7171 A MINIMUM OF THREE FULL WORKING DAYS, EXCLUDING SATURDAYS, SUNDAYS, AND HOLIDAYS, PRIOR TO BEGINNING EACH EXCAVATION IN AREAS WHERE PUBLIC UTILITIES HAVE NOT BEEN PREVIOUSLY LOCATED. MEMBERS WILL THUS BE ROUTINELY NOTIFIED. THIS DOES NOT RELIEVE THE CONTRACTOR OF THE RESPONSIBILITY OF NOTIFYING UTILITY OWNERS WHO MAY NOT BE A PART OF THE "MISS DIG" ALERT SYSTEM.

THE UNDERGROUND LOCATIONS SHOWN FOR NATURAL GAS, TELEPHONE, ELECTRICAL POWER, CABLE TV AND FIBER OPTIC LINES ARE APPROXIMATE. THE CITY OF ANN ARBOR ASSUMES NO RESPONSIBILITY FOR THEIR ACCURATE REPRESENTATION IN THIS DRAWING. MISS DIG MUST BE CONTACTED PRIOR TO CONSTRUCTION TO LOCATE THESE

THE IMPROVEMENTS COVERED BY THESE PLANS SHALL BE PERFORMED IN ACCORDANCE WITH MICHIGAN DEPARTMENT OF TRANSPORTATION (MDOT) 2012 STANDARD SPECIFICATIONS FOR CONSTRUCTION, INCLUDING REFERENCED MDOT PUBLICATIONS, AND THE PROJECT CONTRACT DOCUMENTS.



ENGINEERING

CITY OF ANN ARBOR PUBLIC SERVICES 301 EAST HURON STREET, P.O. BOX 8647 ANN ARBOR, MICHIGAN 48107-8647 734-794-6410 www.a2gov.org



Y OF ANN ARBOR ESURFACING/REST PROJECT - 2019

SHEET No.

	SIGN	NUMBER	QUANTITY
1		BARRICADE TYPE III HIGH INTENSITY LIGHTED	3
	W. Liberty Street	D3-1	1
2	DETOUR ENDS	M4-8a 24X18	1
3	W. Liberty Street DETOUR	D3-1 M4-9S 30x24	12
4	W. Liberty Street DETOUR	D3-1 M4-9R 30x24	0
	W. Liberty Street	D3-1	0
5	DETOUR	M4-9L (MOD.) 30x24	0
6	W. Liberty Street DETOUR	D3-1 M4-9R (MOD.)	2
		30x24	0
7	W. Liberty Street DETOUR	D3-1 M4-9L (MOD.) 30x24	0
8	DETOUR	M4-10R 48×18	0
9	DETOUR	M4-10L 48x18	1
10	ONE WAY R6-1R	36"x12"	0
(11)	ONE WAY R6-1L	36"x12"	0
12)	(3)	R3-2 24"x24"	0
(13)	(R)	R3-1 24"x24"	0
14)	ROAD CLOSED	R11-2 48X30	1
(15)	ROAD CLOSED TO THRU TRAFFIC	R11-4 60x30	1
16)	END ROAD WORK	G20-2 48" x24"	1
(17)	ROAD WORK AHEAD	W20-1 36x36	6
	W. Liberty Street	D3-1	6
18)	DETOUR AHEAD	W20-2 36x36	3
	W. Liberty Street	D3-1	3
19)	ROAD CLOSED AHEAD	W20-3 36x36	3
	W. Liberty Street	D3-1	3
20	RIGHT LANE CLOSED AHEAD	W20-5R 36"×36"	0
21)		W4-2R 36"×36"	0

TRAFFIC CONTROL SIGN

LEFT LANE CLOSED AHEAD

ZONE **BEGINS**

25)

27)

SIGN, PORTABLE, CHANGEABLE MESSAGE

SPECIAL 48x66

SPECIAL 48x66

R5-1 36x36

VERIFY EXACT QUANTITY AND LOCATION WITH

ENGINEER PRIOR

TO ORDERING


TRAFFIC CONTROL SIGN


NUMBER QUANTITY

DETOUR CONSTRUCTION NOTES:

- 1. DEPENDING ON THE DETOUR ROUTES THAT ARE PUT IN PLACE, CONFLICTING SIGNS MAY BE PRESENT. PRIOR TO THE ORDERING OR PLACEMENT OF ANY SIGNS, MEET WITH THE ENGINEER TO VERIFY THE EXACT NUMBER AND LOCATION OF THE SIGNS TO BE PLACED. THE ENGINEER AND THE CONTRACTOR SHALL WORK TOGETHER TO ELIMINATE ALL CONFLICTS.
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- SEWER EXTENSION. AS DIRECTED BY THE ENGINEER, THE CONTRACTOR WILL PROVISION FOR MAINTAINING TRAFFIC AND CONSTRUCTION SEQUENCING" FOR DETAILS ON CONSTRUCTION STAGING, SEQUENCING, CLOSURE AND DETOUR LIMITATIONS, AND OTHER DETAILS.
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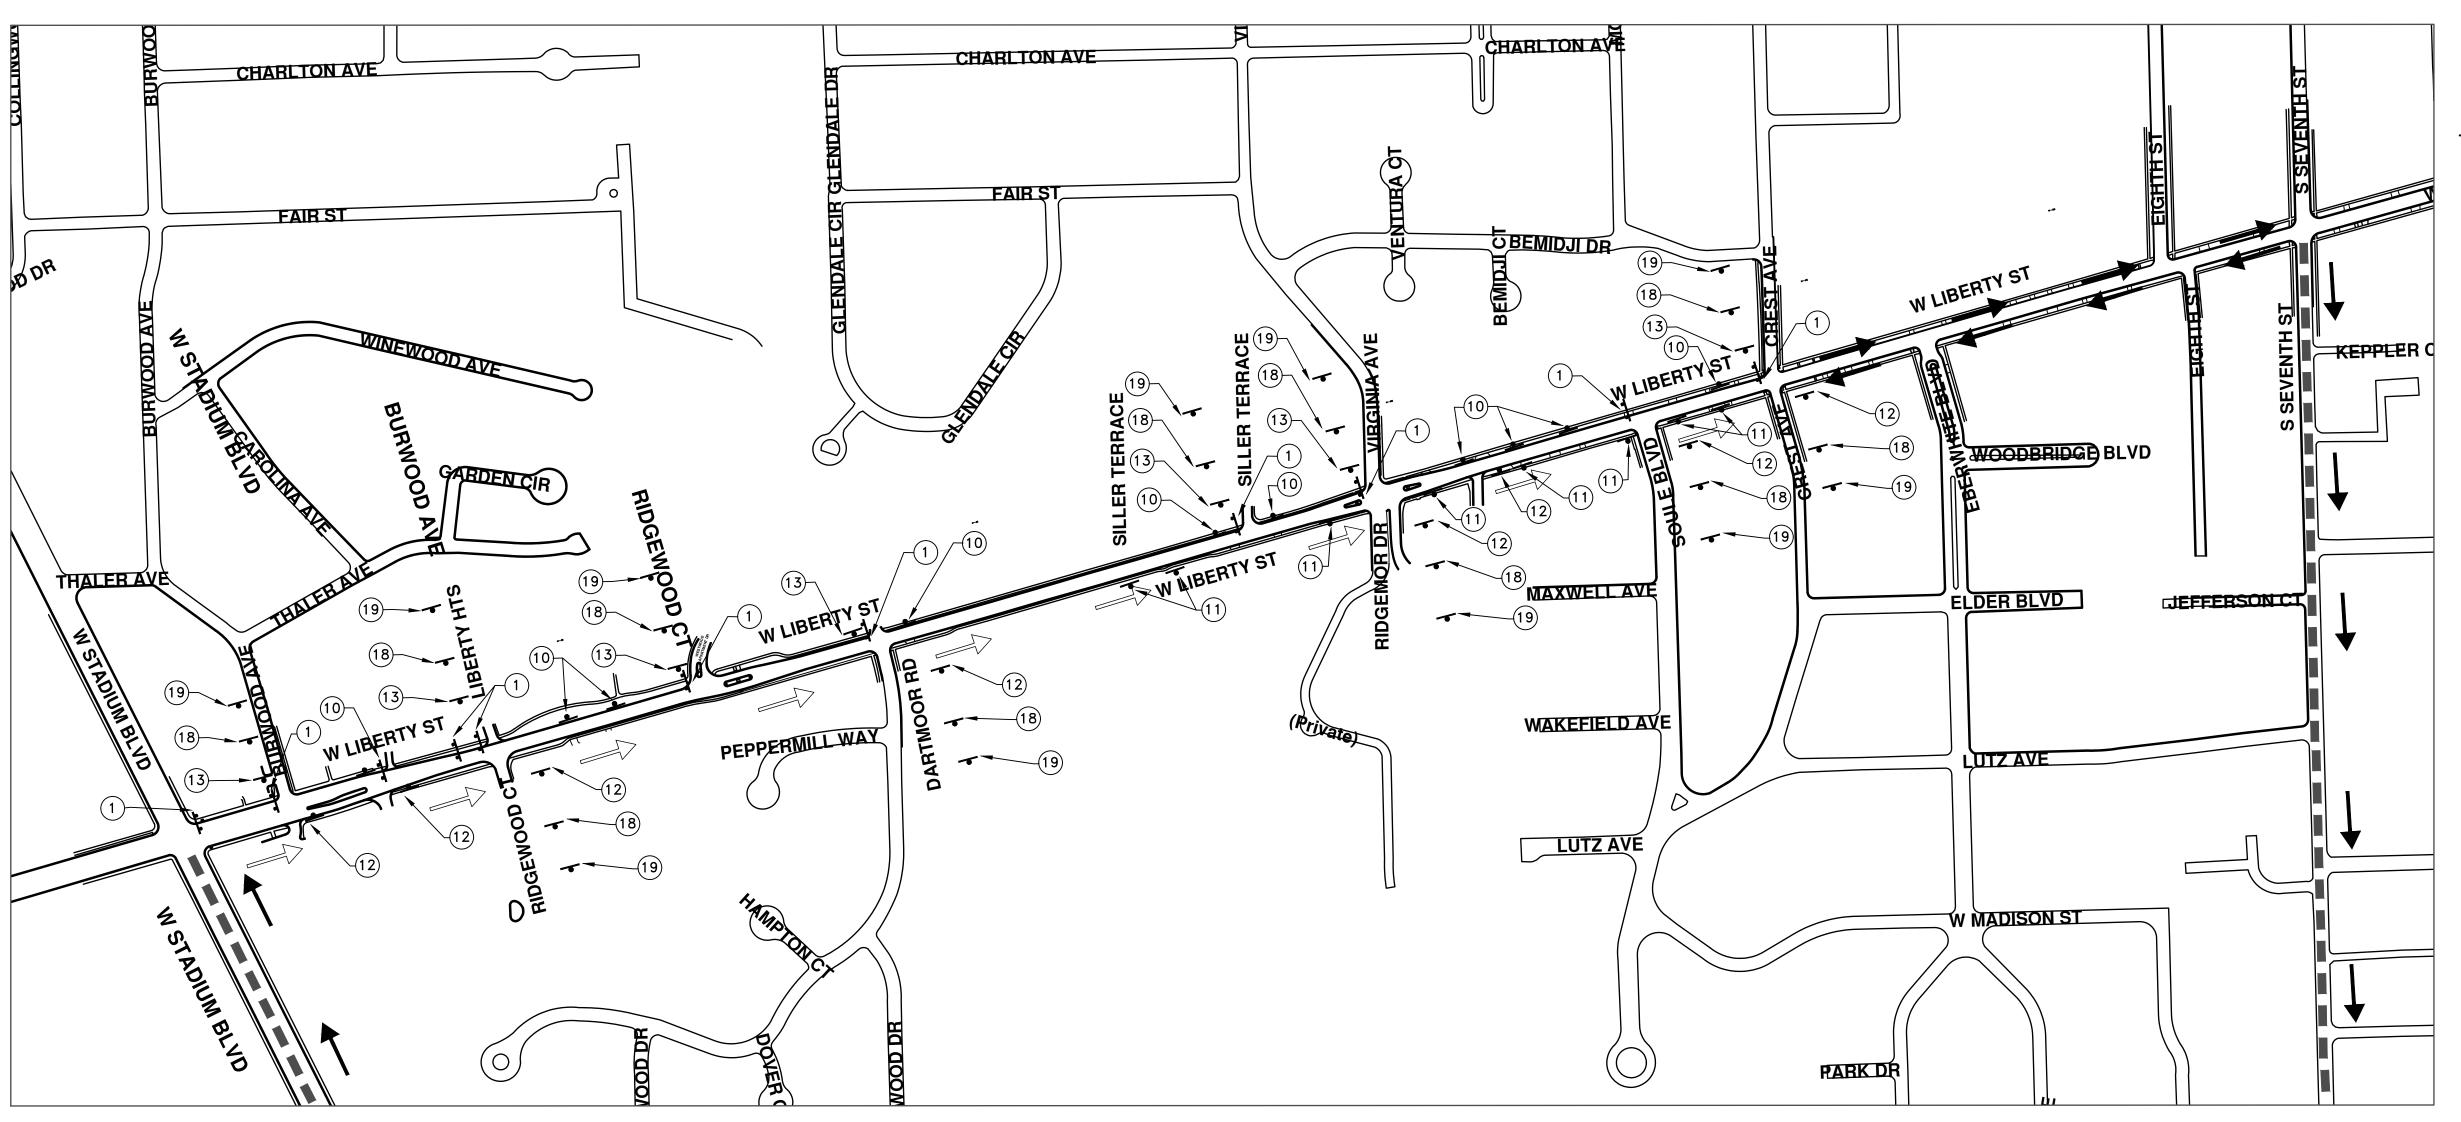
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- 9. THE CONTRACTOR SHALL DRIVE ALL SIGNS INTO EXPOSED GROUND OR INSERT INTO A BORED HOLE IN PAVEMENT AS NECESSARY TO PERMANENTLY SECURE. ALL HOLES IN PAVEMENT SHALL BE FILLED WITH ENGINEER-APPROVED MORTAR



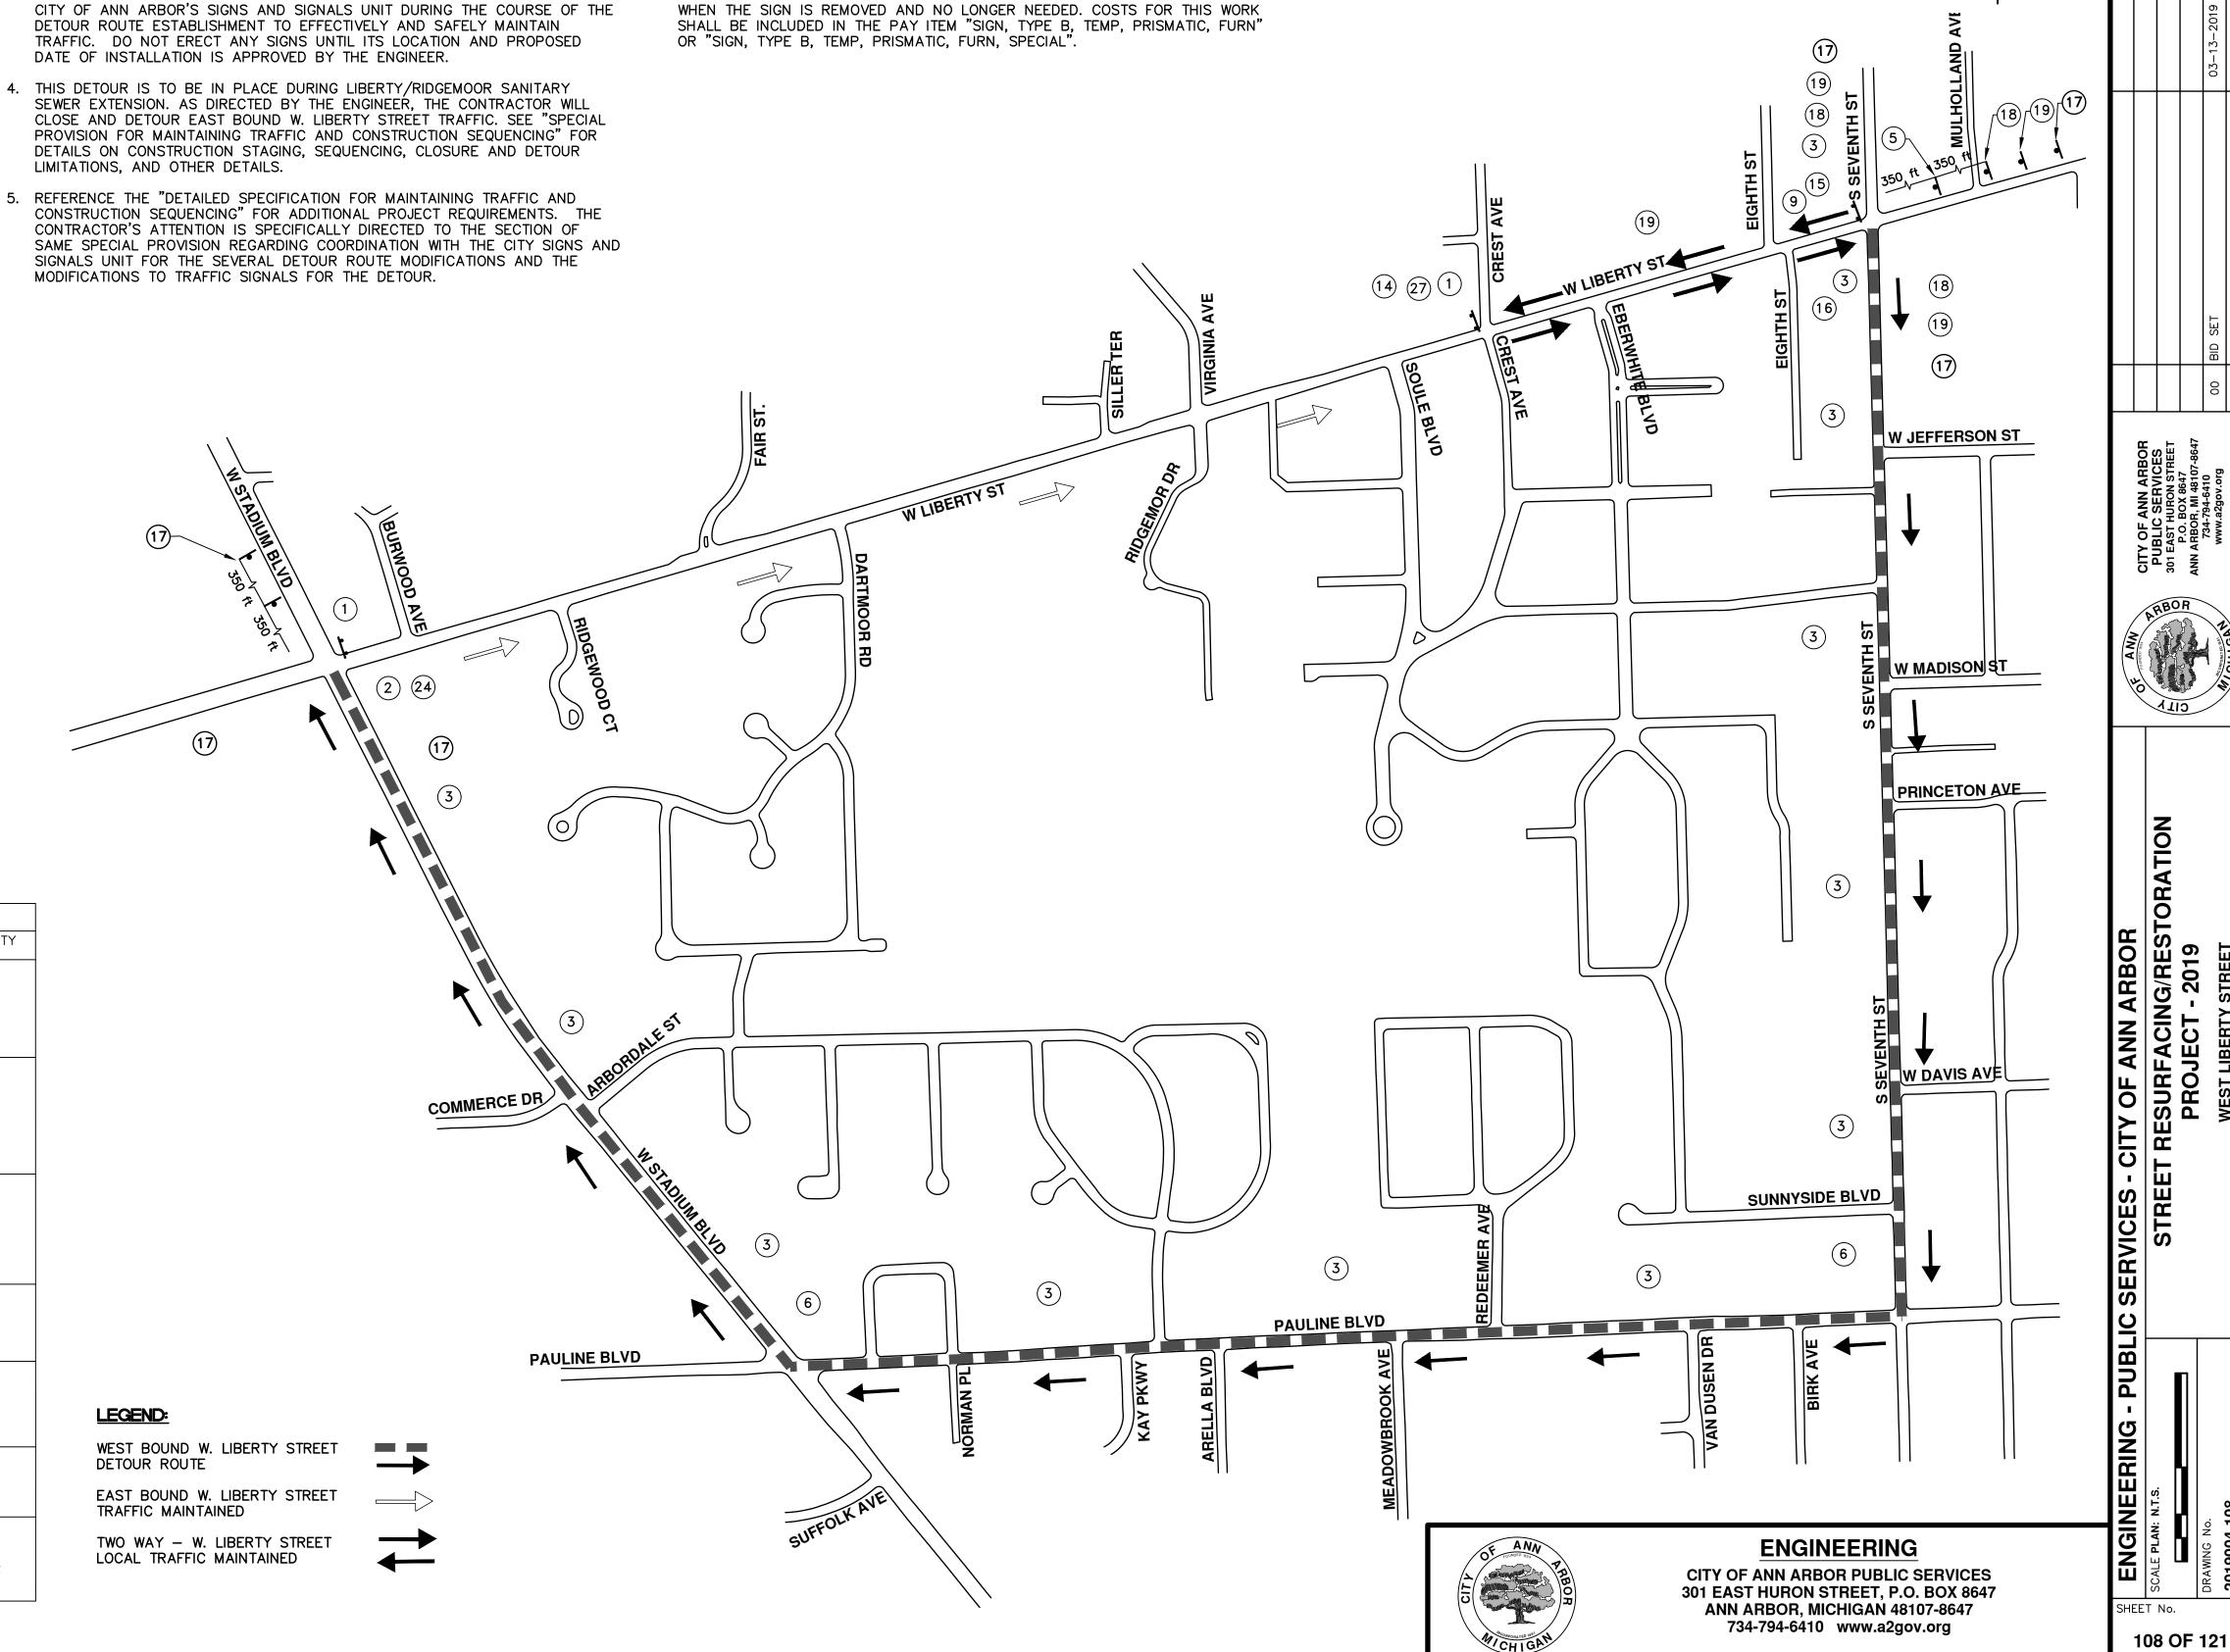

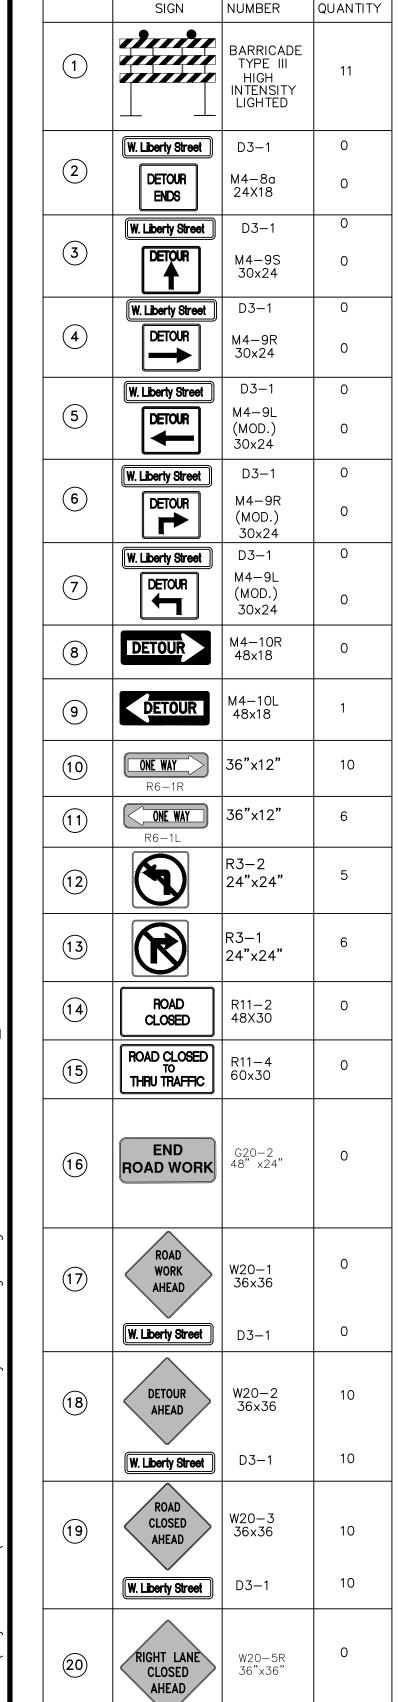21)

TRAFFIC CONTROL SIGN



	TRAFFIC CO	NTROL SIG	N
	SIGN	NUMBER	QUANTITY
22)	LEFT LANE CLOSED AHEAD	W20-5L 36"x36"	0
23)		W4-2L 36"x36"	0
24)	WORK ZONE BEGINS	R5-18C 48"x48"	0
25)		SPECIAL 48x66	0
26)		SPECIAL 48x66	0
27)	DO NOT ENTER	R5-1 36×36	0
SIGN, PORTABLE, CHANGEABLE MESSAGE		VERIFY EXACT QUANTITY AND LOCATION WITH ENGINEER PRIOR	

TO ORDERING

DETOUR CONSTRUCTION NOTES:

LEGEND:

DETOUR ROUTE

TRAFFIC MAINTAINED

WEST BOUND W. LIBERTY STREET


EAST BOUND W. LIBERTY STREET

TWO WAY - W. LIBERTY STREET

LOCAL TRAFFIC MAINTAINED

- 1. DEPENDING ON THE DETOUR ROUTES THAT ARE PUT IN PLACE, CONFLICTING SIGNS MAY BE PRESENT. PRIOR TO THE ORDERING OR PLACEMENT OF ANY SIGNS, MEET WITH THE ENGINEER TO VERIFY THE EXACT NUMBER AND LOCATION OF THE SIGNS TO BE PLACED. THE ENGINEER AND THE CONTRACTOR SHALL WORK TOGETHER TO ELIMINATE ALL CONFLICTS.
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- 4. THIS DETOUR IS TO BE IN PLACE DURING LIBERTY/RIDGEMOOR SANITARY SEWER EXTENSION. AS DIRECTED BY THE ENGINEER, THE CONTRACTOR WILL CLOSE AND DETOUR EAST BOUND W. LIBERTY STREET TRAFFIC. SEE "SPECIAL PROVISION FOR MAINTAINING TRAFFIC AND CONSTRUCTION SEQUENCING" FOR DETAILS ON CONSTRUCTION STAGING, SEQUENCING, CLOSURE AND DETOUR LIMITATIONS, AND OTHER DETAILS.
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- CONTROL DEVICES.
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ENGINEERING


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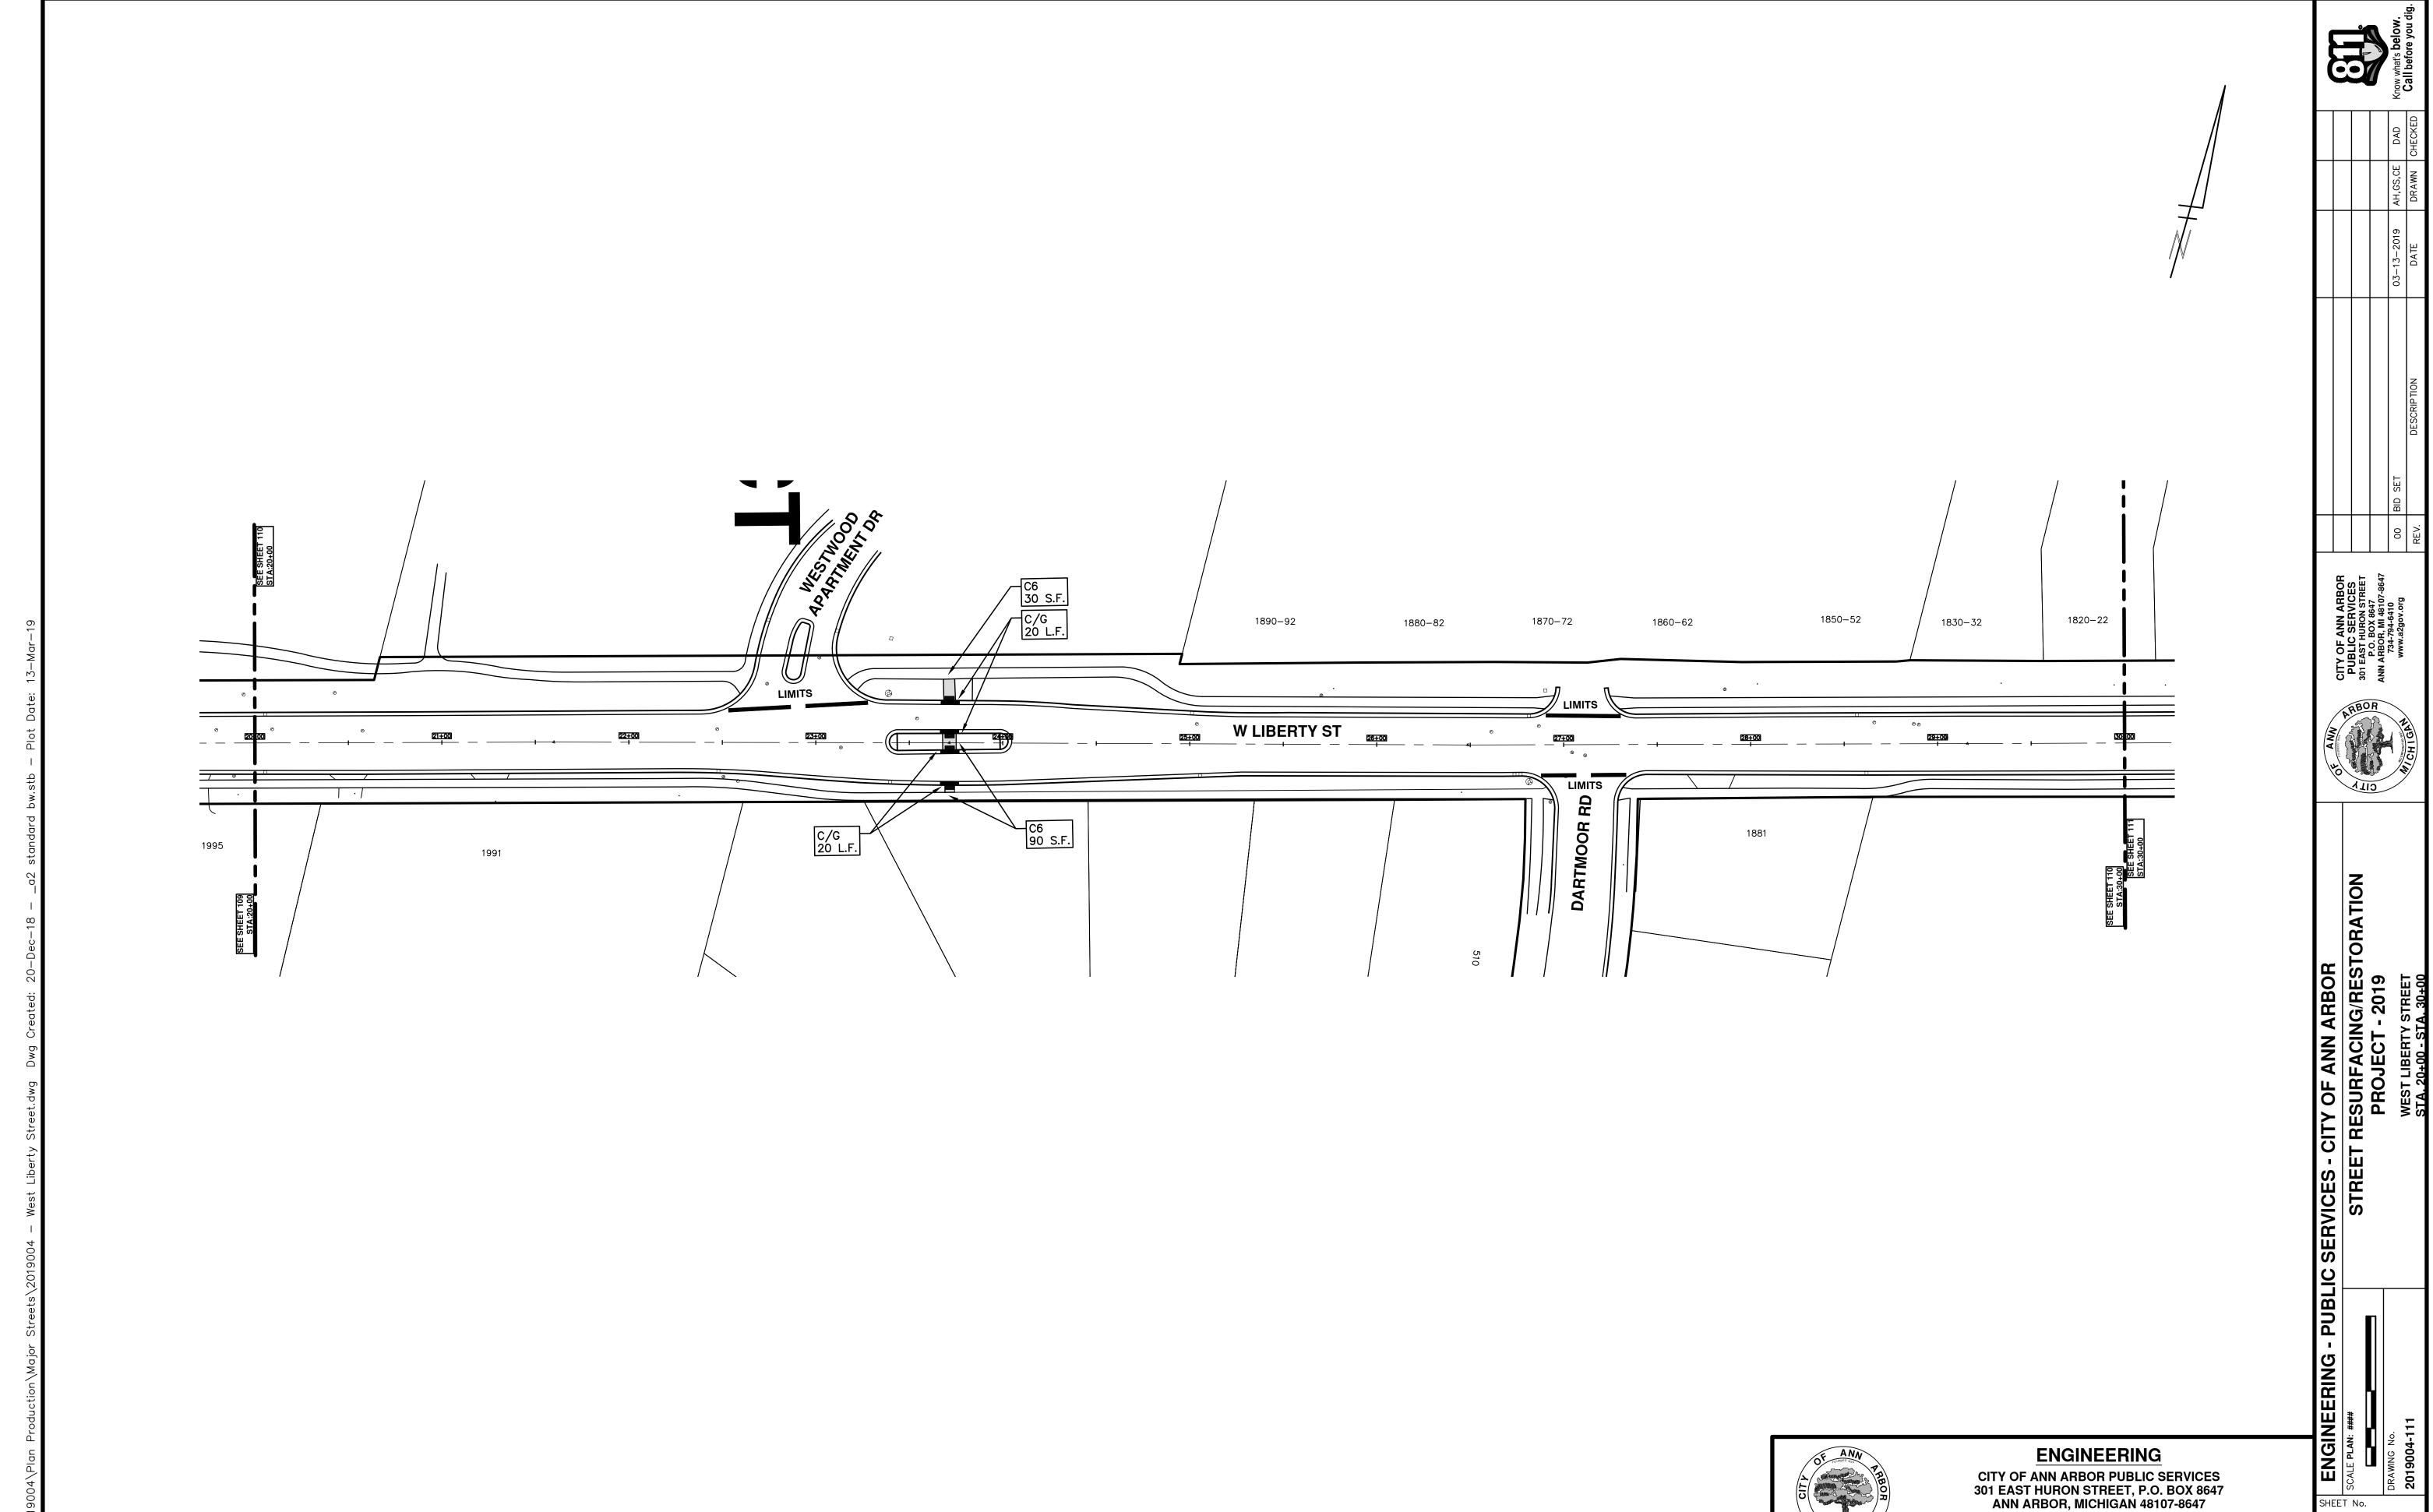
109 OF 121

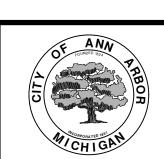ENGINEERING - PUBLIC


Y OF ANN ARBOR ESURFACING/RESTC PROJECT - 2019


SHEET No.



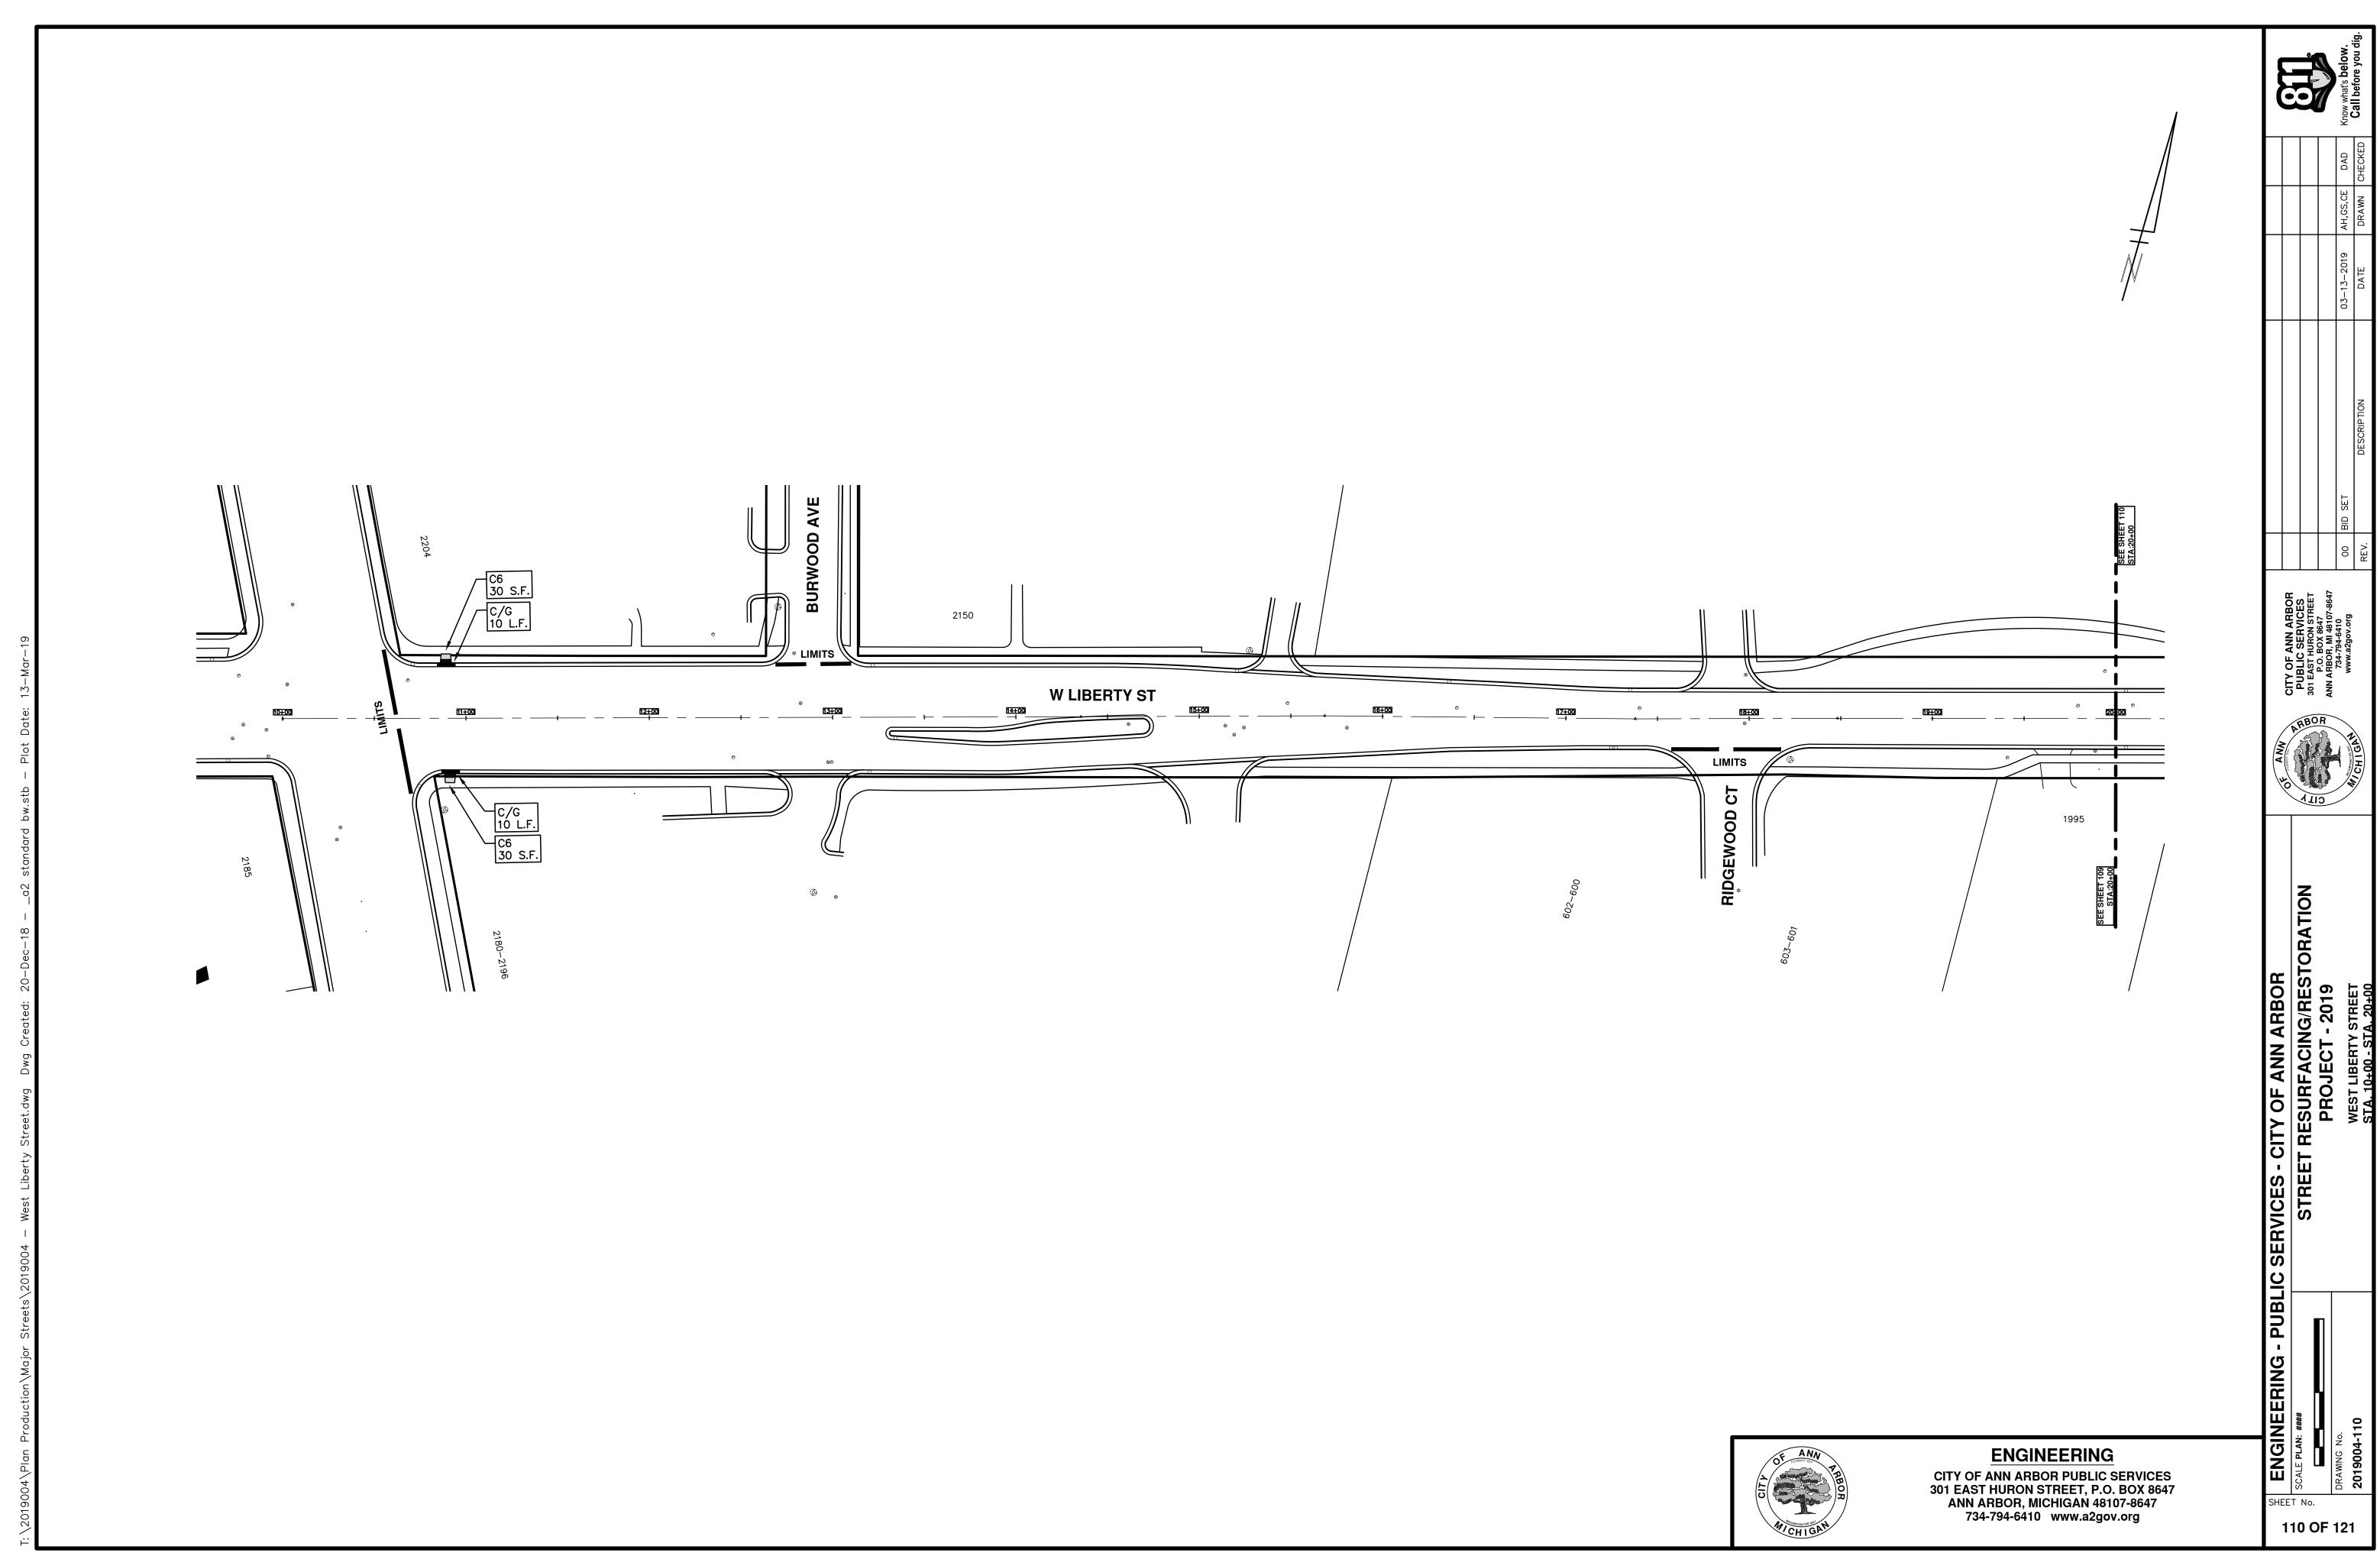



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ENGINEERING
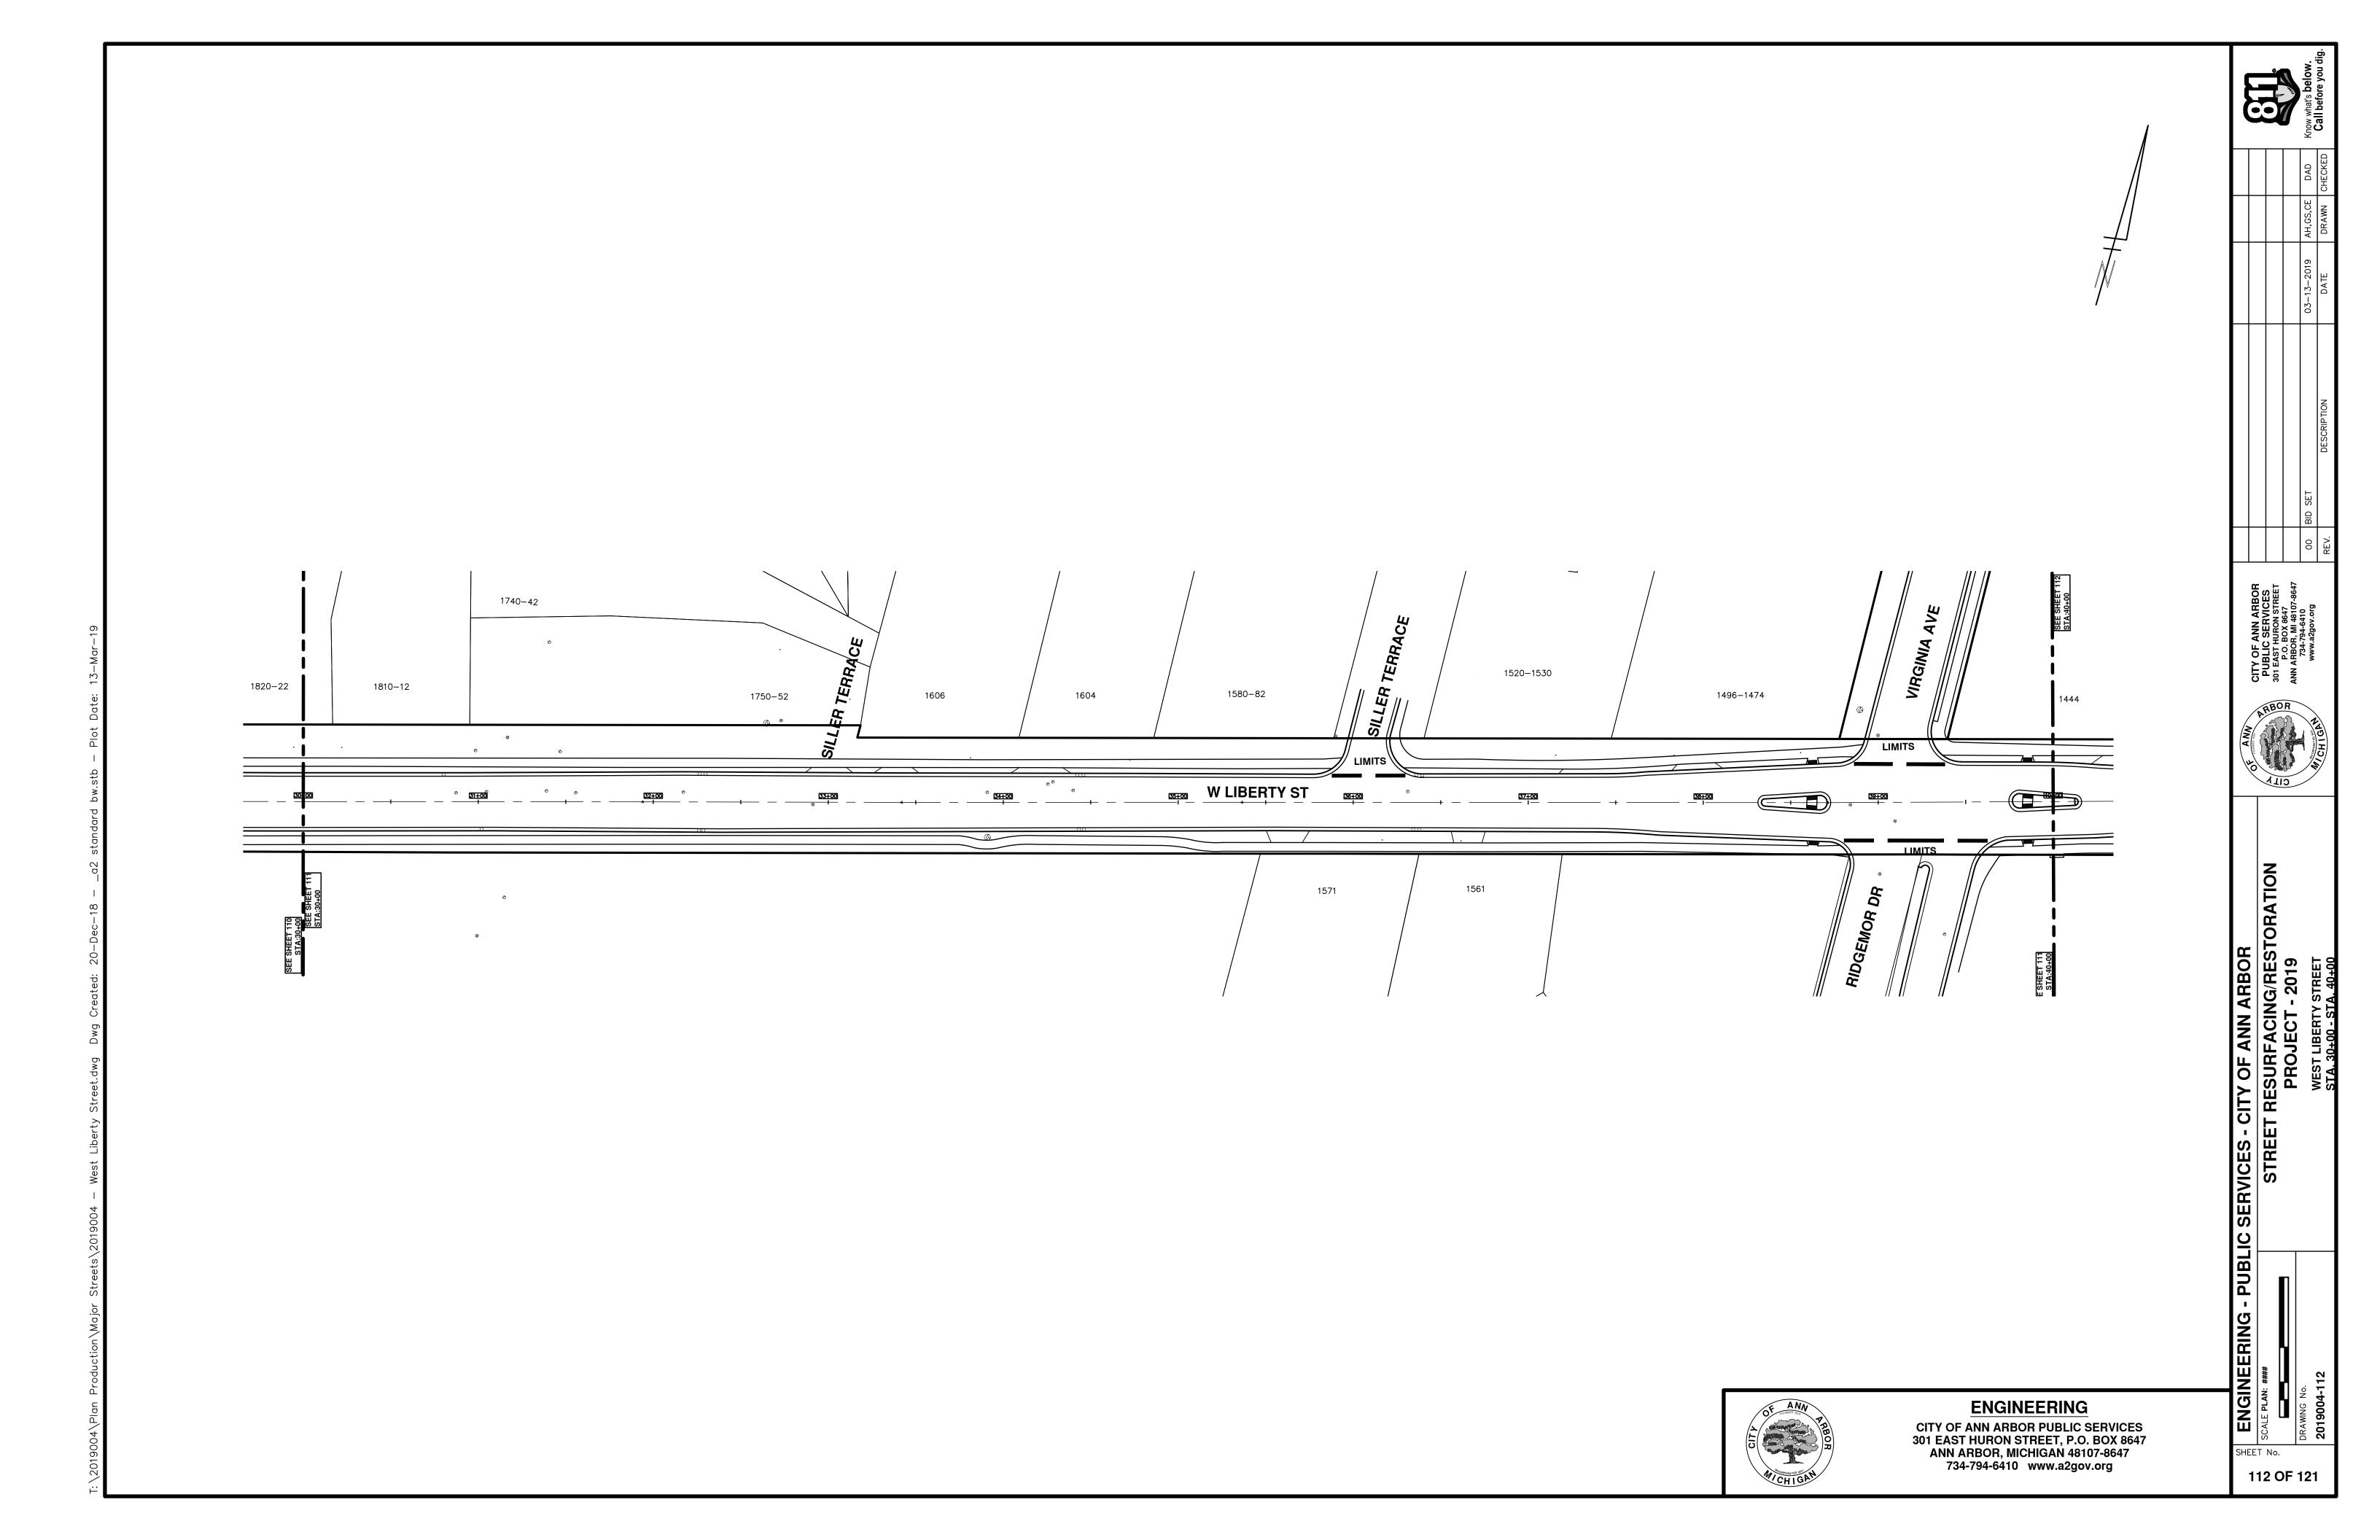
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ENGINEERING - PUBLIC SERVICES - CITY OF ANN ARBOR

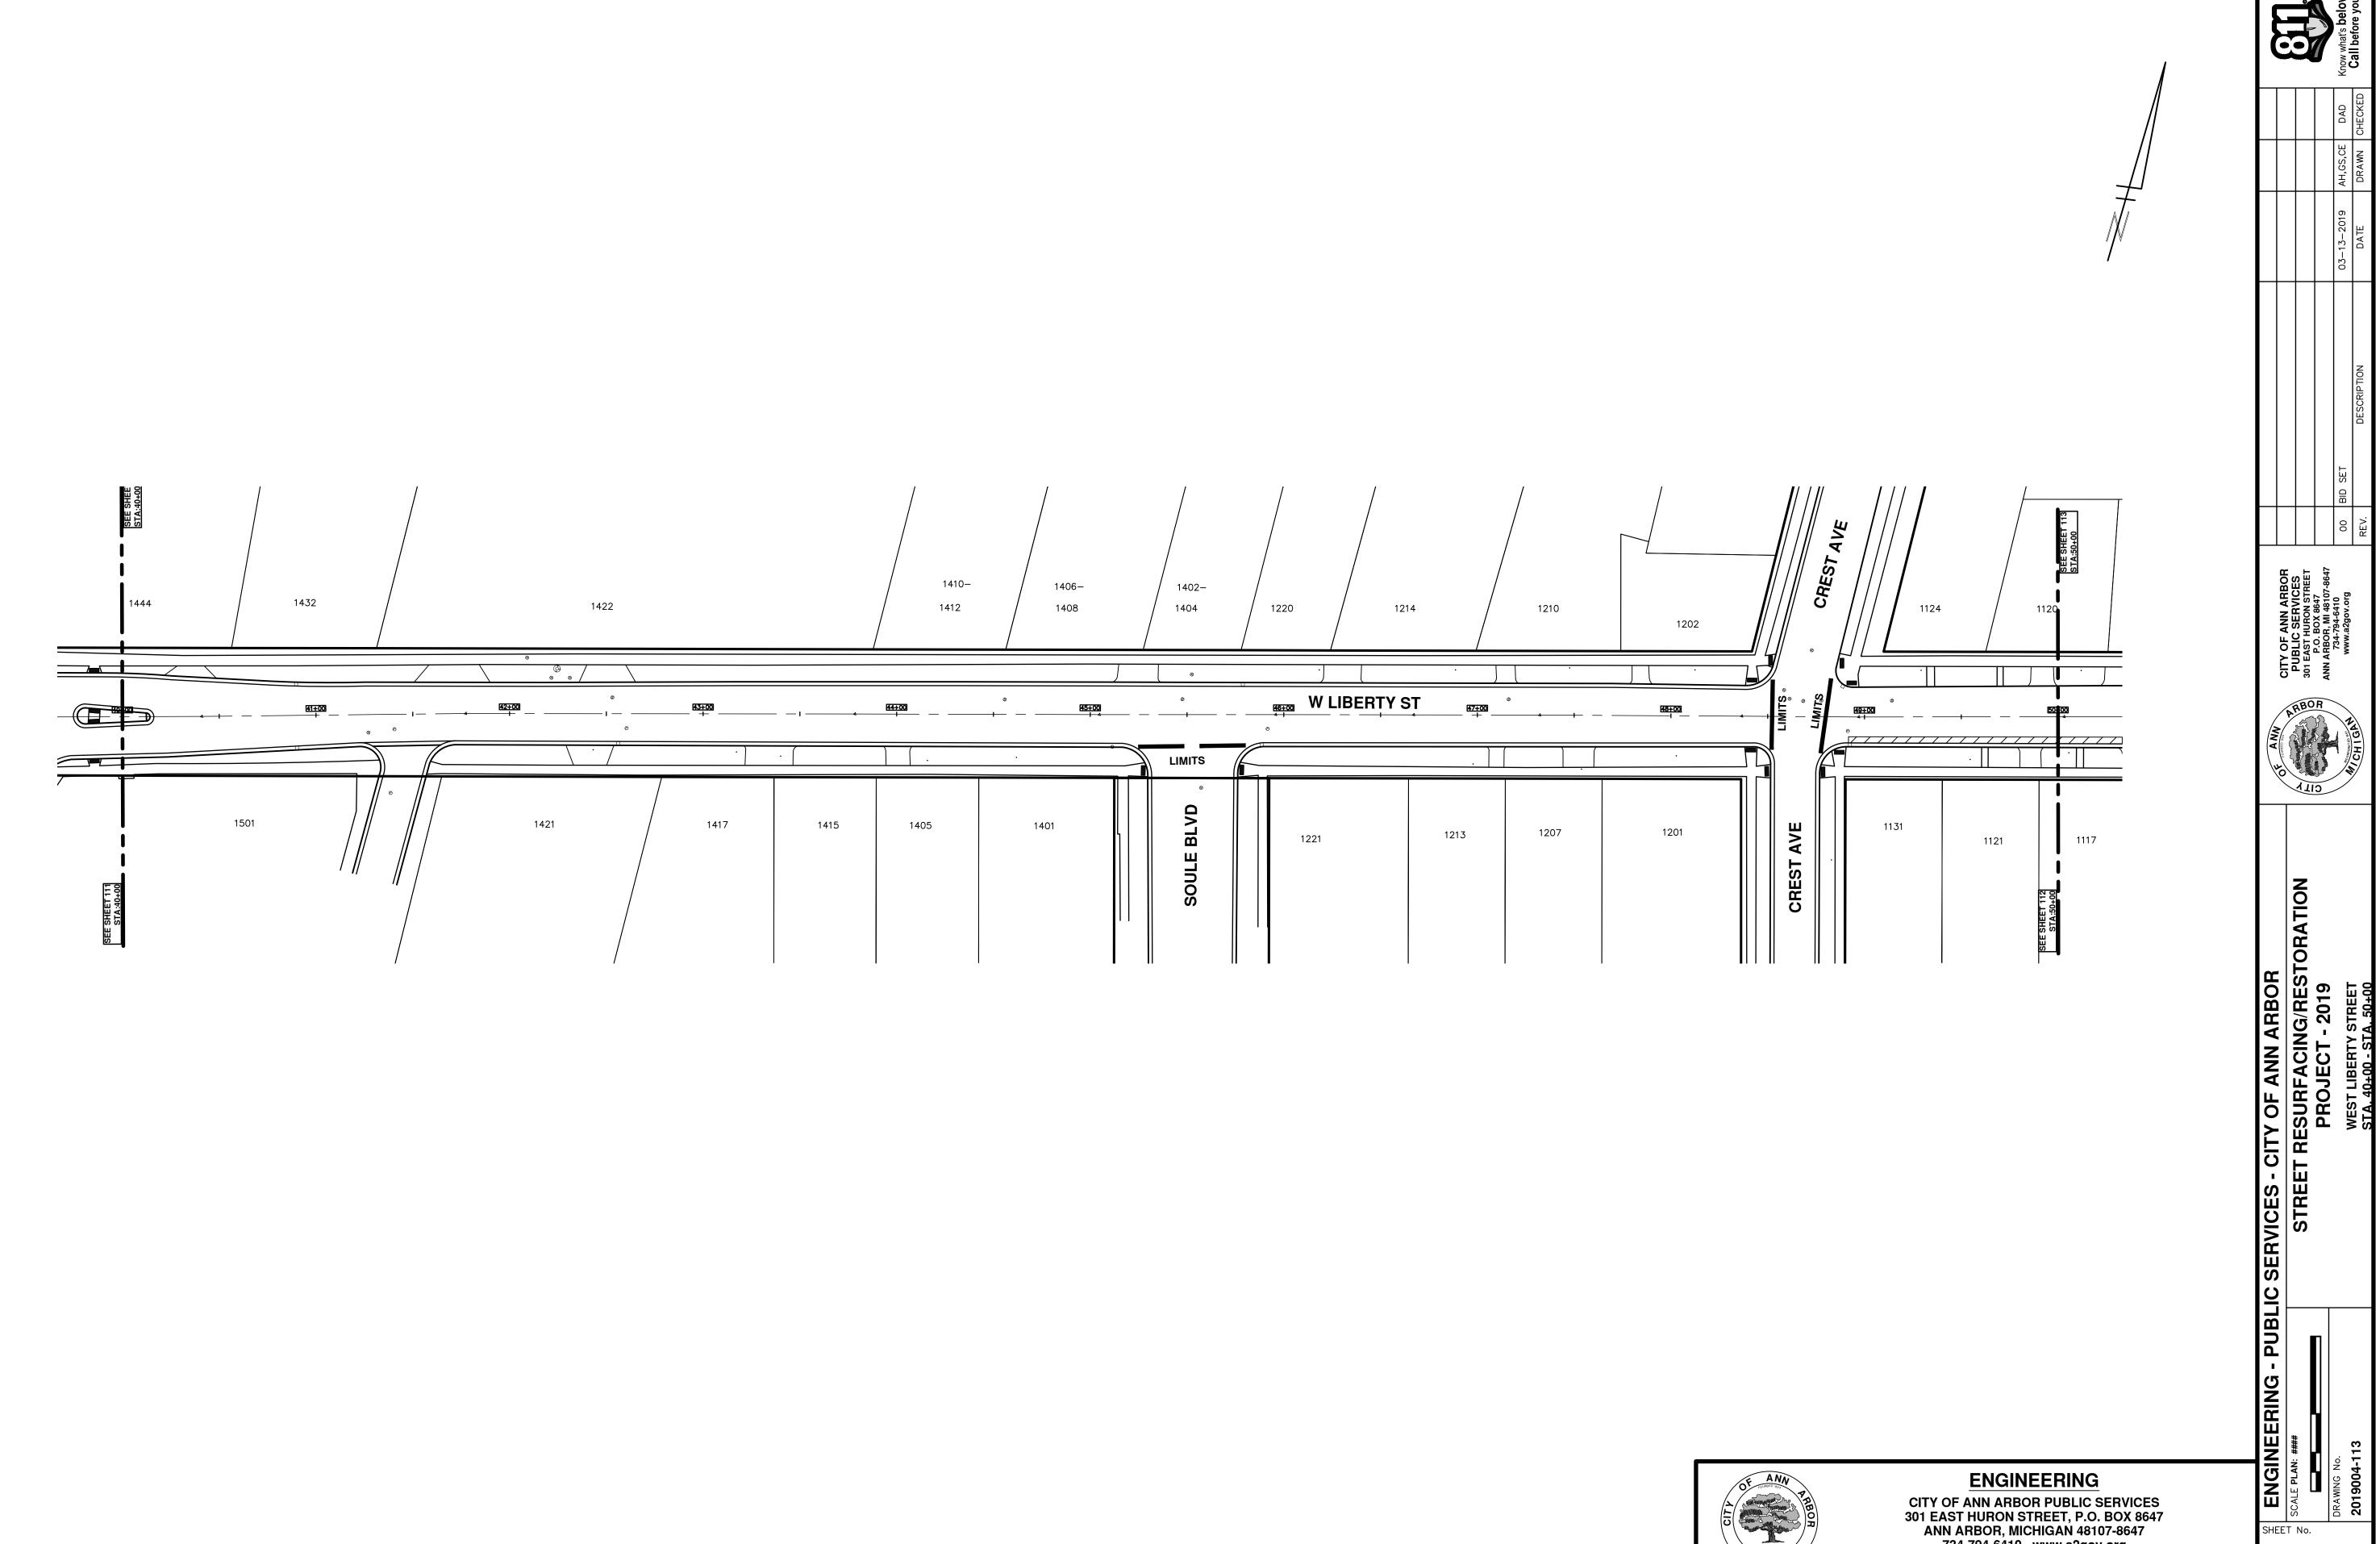SCALE PLAN: ###

SCALE PLAN: ###

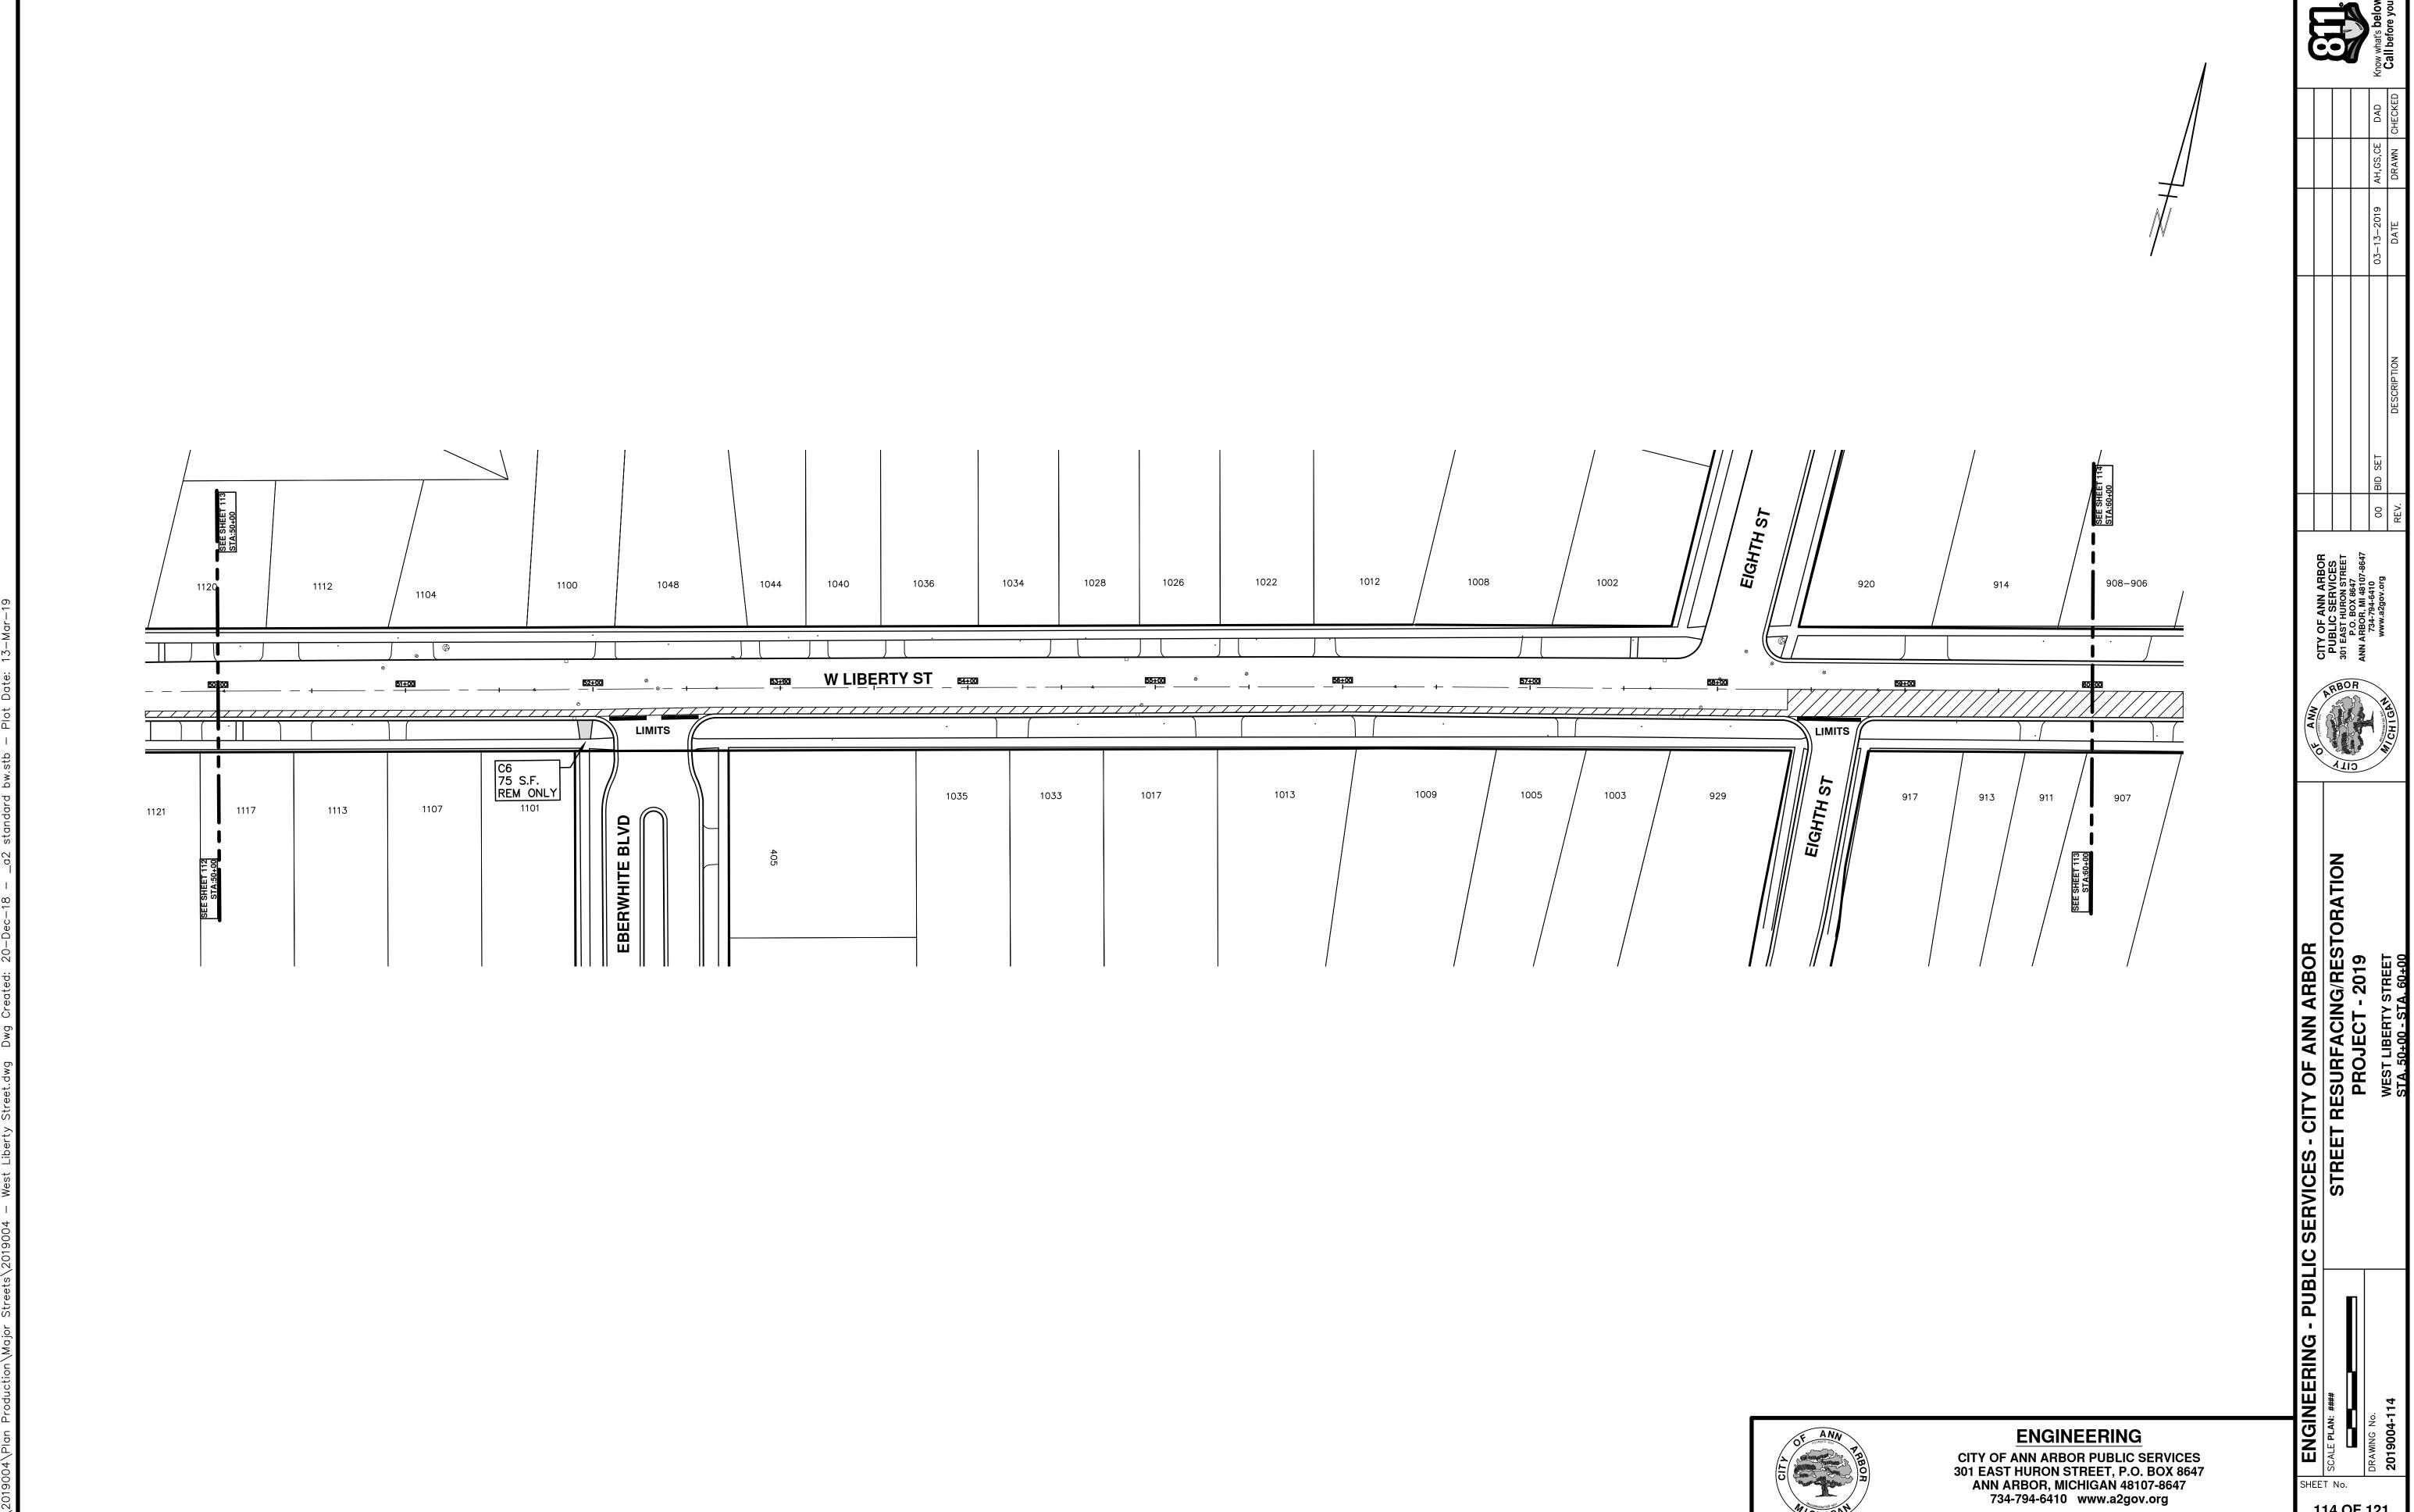DRAWING No.

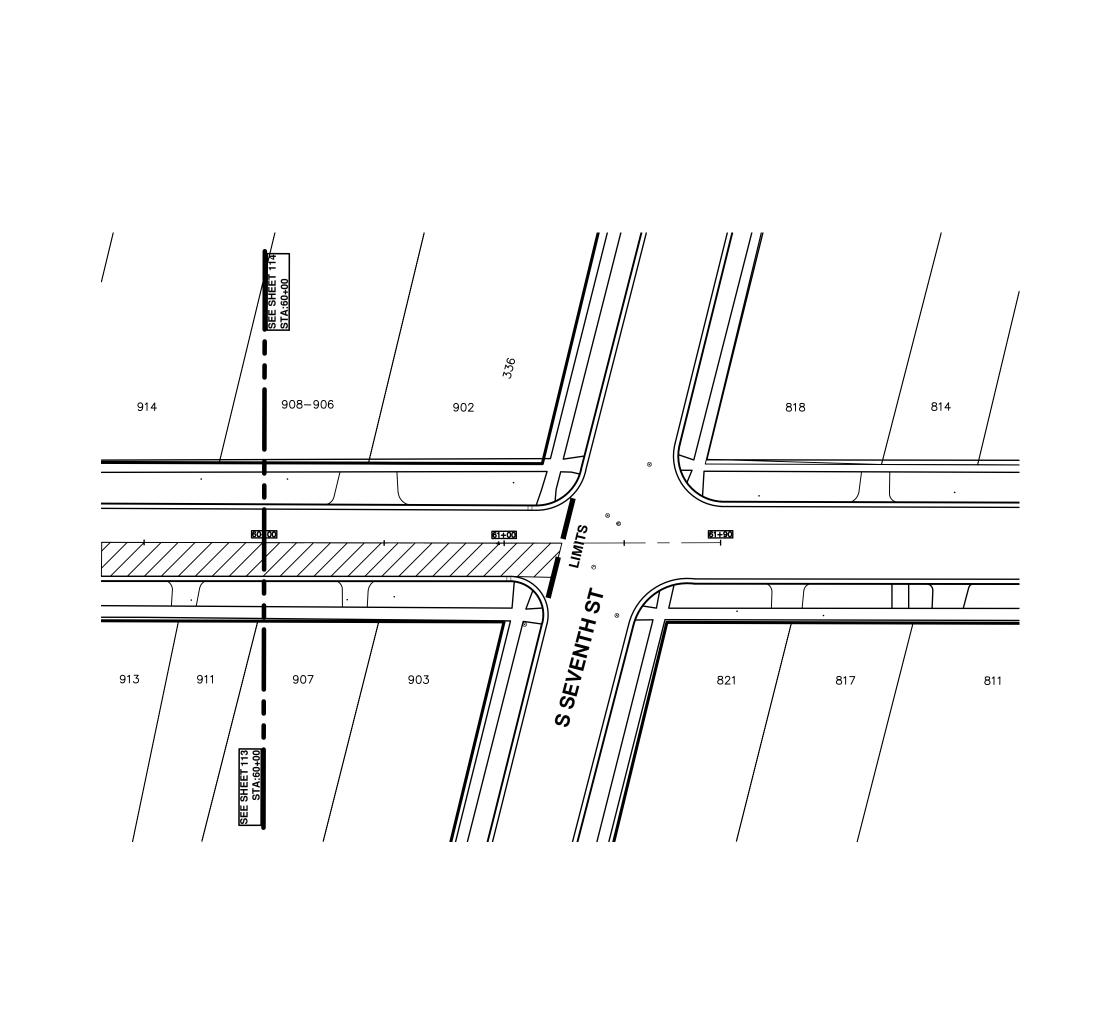DRAWING No.

2019004-115

SCALE PLAN ###

STREET RESURFACING/RESTORATIO
PROJECT - 2019
WEST LIBERTY STREET
STA. 60+00 - STA. 61+90

