#### ADDENDUM No. 1

## ITB No. 4525

## CREST BUENA VISTA WASHINGTON WATER MAIN PROJECT

## Due: Friday, March 2, 2018 by 2:00 pm (local time)

The following changes, additions, and/or deletions shall be made to the Invitation to Bid for Crest, Buena Vista, Washington Water Main Replacement Project ITB No. 4525, on which proposals will be received on/or before Friday March 2, 2018 at 2:00 P.M. (local time)

The information contained herein shall take precedence over the original documents and all previous addenda (if any), and is appended thereto. **This Addendum includes 64 pages.** 

Bidder is to acknowledge receipt of this Addendum No. 1, including all attachments in its Bid by so indicating on page ITB-1 of the Invitation to Bid Form. Bids submitted without acknowledgement of receipt of this addendum may be considered nonconforming.

The following forms provided within the ITB Document must be included in submitted bids at bid opening.

- City of Ann Arbor Prevailing Wage Declaration of Compliance
- City of Ann Arbor Living Wage Ordinance Declaration of Compliance
- Vendor Conflict of Interest Disclosure Form
- City of Ann Arbor Non-Discrimination Ordinance Declaration of Compliance

# Bids that fail to provide these completed forms listed above upon bid opening will be rejected as non-responsive and will not be considered for award.

#### I. CORRECTIONS/ADDITIONS/DELETIONS

Changes to the Bid documents which are outlined below are referenced to a page or Section in which they appear conspicuously. The Bidder is to take note in its review of the documents and include these changes as they may affect work or details in other areas not specifically referenced here.

#### Section/Page(s) Change

BF 1 – BF 4	The Bid Form updated to include new items Integral Sidewalk Retaining Wall, 18" Storm Sewer, Type I Manhole, 6" 11.25 Bend, 8" 11.25 Bend, 8" 22.5 Bend, 12" 11.5 Bend, 6" x 6" x 6" Tee, 8" x 8" x 12" x 12" Cross, 8" Gate Valve-in-Box, and 12" Gate Valve-in-Box, change the unit of Remove Sanitary Sewer Lead, and change quantities.
DS 4 - DS 5	The "Detailed Specification for Maintenance of Traffic" was changed to update approximate quantities of traffic control devices.
DS 14 - DS 17	The "Detailed Specification for Item #204 – Minor Traffic Devices, Max. \$15,000" was changed to update approximate quantities of traffic control devices.
DS 75	The "Detailed Specification for Integral Sidewalk Retaining Wall, 6 inch to 18 inch" was added.

Plan Sheets 1-46 The entire plan set shall be replaced with the attached plan set. Aside from small, insignificant changes, additions, or deletions on multiple sheets, the majority of changes that affect plan quantity or construction methods include sheets 13, 19, 23, 25-28, 32, 34, 35, 38, & 39-45. The significant changes to these plans sheets include the following:

On plan sheet 13, multiple curb & gutter removals and driveway removals from Washington's STA 0+00 to 10+00 were eliminated.

On plan sheet 15, sidewalk removal was added to the corner in Buena Vista.

On plan sheet 19, new storm features were added and Water Main Construction Notes.

On plan sheet 23, the water main valve size changed in the closed valve connection of 12" water on Crest and Buena Vista's proposed 8" water to 12" GVIW.

On plan sheet 25, storm features were added and a note about the dead end connection of water at Washington for the Buena Vista Phase I work.

On plan sheet 26 and 27, storm features were added.

On Plan Sheet 28, the connection to Huron water was eliminated. We will be capping the water main after the last valve on Crest.

On plan sheet 32, fittings to the water for Hydrant 7 were added.

On plan sheets 34 and 35, proposed storm features were added and multiple proposed driveways, M-openings, and curb & gutter were eliminated from Washington station 0+00 to 10+00.

On plan sheet 38, structure and gate box adjustments were added and the sidewalk in the corner of Buena Vista was added.

On plan sheets 39-45, structure and gate box adjustments were added.

#### **II. QUESTIONS AND ANSWERS**

The following Questions have been received by the City. Responses are being provided in accordance with the terms of the ITB. Respondents are directed to take note in its review of the documents of the following questions and City responses as they affect work or details in other areas not specifically referenced here.

- **Question 1:** At what percent compaction is the Aggregate Base installed in the Water Main trench?
- Answer 1: New Aggregate Base installed in the Water Main trench is compacted to 98% of its Maximum Density.

- **Question 2:** Is there sand base under proposed sidewalk and sidewalk ramps?
- **Answer 2:** Yes, its pay item "Sand Subbase Course, Class II C.I.P." and extends past the sidewalk 6 inches on each side, and is 4 inches thick typically, 6 inches thick under proposed sidewalk with retaining wall.
- **Question 3:** Are the water service leads really going past the right-of-way?
- Answer 3: No, the water service leads were drawn on the plans as such for clarity of location. The excavation and backfill will stop as Public Works makes their connections at the existing stop boxes.
- Question 4: Do you expect a conflict with ground water?
- Answer 4: Not generally, but Public Works did encounter ground water when working between Eighth St and S. Seventh St south of the project and cautions the Contractor when abandoning the Civil Defense Water Main on S. Seventh that water may be encountered.
- **Question 5:** Limits of removals (stationing) and grades of curb lines at intersections were not on the plans. Will they be provided prior to construction?
- **Answer 5:** Yes, plan sheets with limits of removals and grades along curbs at the intersections and new curb areas will be provided on new plan sheets prior to construction.
- Question 6: Are the new and replacement structure castings the City of Ann Arbor standard?
- **Answer 6:** No, when ordering castings from your supplier, specify the new Art in Ann Arbor castings if they are available.

**Question 7:** Can the HMA removal be done at one time?

- **Answer 7:** No, The HMA removal for the water main trench shall be done first. After the water main is complete, and prior to paving, the pavement removals on the rest of the road can be done.
- **Question 8:** Is June 16 a hard date for completing Buena Vista, such that Crest and Washington would not be able to start until Buena Vista is done?
- **Answer 8:** It was the intent of the City's to finish Buena Vista before Crest and Washington were started, but we do recognize that we have outlined a tight schedule, and issues come up and testing can delay construction.
- **Question 9:** Is it the City's intention to Flowable Fill the Civil Defense water main, or just cut and cap it at the ends?
- Answer 9: The 12" Civil Defense water main can be cut and capped to abandon it.
- **Question 10:** Does the Contractor have to Flowable Fill the 20" Steel water main on Crest if it's discovered not to be filled where removals take place?
- Answer 10: No, the 20" Steel water line can be cut and capped at the removal limits.
- **Question 11:** Can the City exercise the valves beyond the project limits to test the shut off capabilities?
- **Answer 11:** Yes, we will ask Public Works to exercise the valves.

Question 12: Will the revised plan sheets show the locations of the proposed under drain?Answer 12: No, the underdrains would not have shown up on the plans well, as storm items are shown on the water main sheets. They are intended to be installed under all

new curb and gutter if there is an existing or proposed inlet in the same run of curb. Specific locations can be confirmed at the Pre-Construction meeting.

Respondents are responsible for any conclusions that they may draw from the information contained in the Addendum.

#### Section 1–Schedule of Prices

Company:

Project: Crest, Buena Vista, & Washinton Water Main Replacement Project File #: 2016-029 Bid #: 4525 Addendum 1

<u>ltem</u>	Description	<u>Unit</u>	Estimated <u>Quantity</u>	Unit Price	Total Price
130	Protective Fencing	FT	225	\$ 	\$
140	Exploratory Excavation (0-10' deep)	EA	18	\$ 	\$
200	Tree Removal, 8" or Larger, Modified	EA	3	\$ 	\$
201	Project Supervision, Max. \$25,000.00	LS	1	\$ 	\$
202	General Conditions, Max. \$50,000.00	LS	1	\$ 	\$
203	Digital Audio Visual Coverage	LS	1	\$ 	\$
204	Minor Traffic Devices, Max \$15,000.00	LS	1	\$ 	\$
205	Clean-Up & Restoration, Special	LS	1	\$ 	\$
206	"No Parking" Signs	EA	60	\$ 	\$
209	Sewer, Any Size or Depth, Remove	FT	478	\$ 	\$
210	Drainage Structure, Any Size or Depth, Remove	EA	23	\$ 	\$
211	Remove Sanitary Sewer Lead	FT	100	\$ 	\$
219	Abandoned 20" Steel Water Main Pipe, Remove	FT	1100	\$ 	\$
220	Water Main Pipe Abandonment, Modified	LS	1	\$ 	\$
221	Fire Hydrant Assembly Abandonment	EA	5	\$ 	\$
222	Temporary 6 inch or 8 inch Water Main Line Stop	EA	6	\$ 	\$
223	Temporary 12 inch Water Main Line Stop	EA	2	\$ 	\$
224	Temporary 16 inch Water Main Line Stop	EA	2	\$ 	\$
225	6-Inch Wrapped Underdrain	FT	3230	\$ 	\$
226	Machine Grading, Modified	SYD	14230	\$ 	\$
227	Subgrade Undercutting - Type II	CYD	200	\$ 	\$
230	HMA Pavement Leveling/Top - LVSP	TON	3250	\$ 	\$

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#### Section 1–Schedule of Prices

Company:

Project: Crest, Buena Vista, & Washinton Water Main Replacement Project File #: 2016-029 Bid #: 4525 Addendum 1

Item	Description	Unit	Estimated Quantity		Unit Price		Total Price
240	Concrete Curb or Curb and Gutter - All Types	FT	2232	\$		\$	
241	Concrete Curb or Curb and Gutter - All Types (High Early)	FT	1000	\$		\$_	
242	4 Inch Concrete Sidewalk	SFT	5434	\$		\$	
243	6 Inch Concrete Sidewalk Ramp	SFT	1551	\$		\$	
244	6 Inch Concrete Drive - High Early	SYD	242	\$		\$	
245	Detectable Warning, Cast In Place	SFT	360	\$		\$	
246	Integral Sidewalk Retaining Wall, 6 inch to 18 inch	SFT	100	\$		\$	
250	Sand Subbase Course, Class II - C.I.P.	CYD	319	\$		\$	
251	21AA Limestone, C.I.P.	CYD	200	\$		\$	
252	Aggregate Base Course, 21AA - C.I.P.	CYD	2160	\$		\$	
261	Remove Concrete Curb or Curb and Gutter - Any Type	FT	3155	\$_		\$	
262	Remove Concrete Sidewalk and Drive - Any Thickness	SFT	7239	\$_		\$	
270	Pavt Mrkg, Thermoplastic, 6 inch Crosswalk	FT	424	\$		\$	
271	Pavt Mrkg, Thermoplastic, 12 inch Crosswalk	FT	680	\$		\$	
272	Pavt Mrkg, Thermoplastic, 24 inch Stop Bar	FT	160	\$		\$	
273	Pavt Mrkg, Thermoplastic, School	EA	2	\$		\$	
299	Certified Payroll Compliance and Reporting	LS	1	\$		\$	
320	12" CL IV RCP Storm Sewer Pipe, Trench Detail I	FT	388	\$		\$	
321	15" CL IV RCP Storm Sewer Pipe, Trench Detail I	FT	20	\$		\$	
322	18" CL IV RCP Storm Sewer Pipe, Trench Detail I	FT	7	\$		\$	
353	4 inch SDR 35 PVC Sanitary Lead, Trench Detail I	FT	100	\$		\$	
354	6 inch SDR 35 PVC Sanitary Lead, Trench Detail I	FT	100	\$		\$	
360	Type I Manhole (0-10' deep)	EA	2	\$_		\$_	
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#### Section 1–Schedule of Prices

Company:

Project: Crest, Buena Vista, & Washinton Water Main Replacement Project File #: 2016-029 Bid #: 4525 Addendum 1

<u>ltem</u>	Description	<u>Unit</u>	Estimated <u>Quantity</u>	Unit Price	Total Price
366	Inlet-Junction Chamber	EA	1	\$	\$ 
367	Single Inlet	EA	22	\$	\$
400	6 inch Class 50 DIP w/polywrap, Trench Detail I	FT	82	\$ 	\$ 
401	8 inch Class 50 DIP w/polywrap, Trench Detail I	FT	2078	\$ 	\$ 
402	12 inch Class 50 DIP w/polywrap, Trench Detail I	FT	1826	\$	\$ 
410	6" 11.25° Bend	EA	1	\$	\$ 
411	6" 45° Bend	EA	1	\$	\$ 
412	6" 90° Bend	EA	1	\$ 	\$
413	8" 11.25° Bend	EA	3	\$ 	\$
414	8" 22.5° Bend	EA	3	\$ 	\$
415	8" 45° Bend	EA	39	\$ 	\$ 
416	8" 90° Bend	EA	3	\$ 	\$
417	12" 11.25° Bend	EA	8	\$ 	\$
418	12" 45° Bend	EA	12	\$ 	\$
419	12" 90° Bend	EA	2	\$ 	\$ 
420	8" x 1.5" Reducer	EA	1	\$	\$
421	8" x 2" Reducer	EA	1	\$	\$
422	8" x 6" Reducer	EA	9	\$	\$
423	12" x 6" Reducer	EA	2	\$ 	\$ 
424	12" x 8" Reducer	EA	2	\$ 	\$ 
430	6" x 6" x 6" Tee	EA	1	\$ 	\$
431	8" x 8" x 8" Tee	EA	9	\$ 	\$ 
432	8" x 8" x 8" x 8" Cross	EA	1	\$ 	\$ 
433	8" x 8" x 12" x 12" Cross	EA	1	\$ 	\$ 
434	8" x 8" x 12" Tee	EA	1	\$ 	\$ 

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#### Section 1–Schedule of Prices

Company:

Project: Crest, Buena Vista, & Washinton Water Main Replacement Project File #: 2016-029 Bid #: 4525 Addendum 1

Item	Description	Unit	Estimated Quantity		Unit Price		Total Price
435	12" x 12" x 8" Tee	EA	4	\$		\$	
436	12" x 12" x 12" Tee	EA	3	\$		* - \$	
437	16" x 16" x 12" Tee	EA	1	÷		• _ \$	
440	Fire Hydrant Assembly	EA	8	\$		•_ \$	
442	6" Gate Valve-in-Box	EA	1	* <u>-</u> \$		* _ \$	
443	8" Gate Valve-in-Box	EA	1	\$		• _ \$	
444	12" Gate Valve-in-Box	EA	1	\$		* _ \$	
446	6" Gate Valve-in-Well	EA	1	\$		• <u>-</u> \$	
447	8" Gate Valve-in-Well	EA	9	\$		•_ \$	
448	12" Gate Valve-in-Well	EA	6	• \$		•	
460	Excavate & Backfill for Water Service Tap and Lead	FT	2400	\$		\$	
563	Structure Covers	LBS	11700	\$		\$	
566	Adjust Structure Cover	EA	27	\$		\$	
567	Adjust Monument Box or Gate Valve Box	EA	15	\$		\$	
800	Celtic occidentalis, (Hackberry), 2 inch	EA	10	\$		\$	
801	Gleditsia tracanthos, (Honeylocust), 2 inch	EA	5	\$		\$	
802	Acer rubrum, (Red Maple), 2inch	EA	5	\$		\$	
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	TOTAL FROM PAGE BF-1:			\$			
	TOTAL FROM PAGE BF-2:			\$			
	TOTAL FROM PAGE BF-3:			\$			
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	TOTAL BASE BID:			\$			

## DETAILED SPECIFICATION FOR MAINTENANCE OF TRAFFIC

#### **DESCRIPTION**

Traffic shall be maintained in accordance with the City of Ann Arbor Public Services Department Standard Specifications except as specified in Sections 104.11, 812, and 922 of the Michigan Department of Transportation (MDOT) 2012 Standard Specifications for Construction, the Michigan Manual of Uniform Traffic Control Devices, Latest Revised Edition (MMUTCD) and as amended herein.

The Contractor shall furnish, erect, maintain and, upon completion of the work, remove all traffic control devices and barricade lights within the project and around the perimeter of the project for the safety and protection of local traffic. This includes, but is not limited to, advance, regulatory, and warning signs; barricades and channeling devices at intersecting streets on which traffic is to be maintained; barricades at the ends of the project and at right-of-way lines of intersecting streets; portable changeable message signs; lighted arrow boards, and moving traffic control devices for construction operations. Payment shall be paid for as "Minor Traffic Devices, Max \$15,000".

#### MATERIALS

The materials and equipment shall meet the requirements specified in the corresponding sections of the MDOT 2012 Standard Specifications for Construction and MMUTCD. The approximate quantities of materials are as follows: 3 small Portable Changeable Message Signs, 506 sft Temporary Signs, Type B, 20 Type III Barricades, and 150 Type III Lighted Plastic Drums.

#### **Maintenance of Local Traffic**

Unless otherwise indicated on the plans, all side roads shall not be closed to through traffic except during construction operations of short duration and only upon written approval of the Engineer.

Local access shall be maintained at all times for emergency vehicles, refuse pick-up, mail delivery and ingress/egress to private properties.

Contractor must accommodate the safe access to the residential buildings and businesses located within construction area.

A lane-closure permit shall be obtained by the Contractor from the City Transportation Division, at least 48 hours in advance of any proposed lane or street closing.

The hours of work on all Local streets are 7:00 a.m. to 8:00 p.m., Monday through Saturday, or as specified on the lane-closure permit. No equipment will be allowed in the street before or after these hours. Local streets may only be closed to through traffic (local access only) with written authorization of the Engineer. Work must be completed each day such that all streets are re-opened to through traffic by 8:00 p.m. unless otherwise specified, directed, or authorized in writing by the Engineer. All major changes in traffic control shall be made either between 9:30 a.m. and 3:30 p.m., or between 7:00 p.m. and 6:30 a.m. in order to minimize interference with rush-hour traffic. All traffic controls must be in-place and ready for traffic each day by 6:30 a.m. and 3:30 p.m.

Driveways shall not be blocked for extended periods of time unless arrangements can be made with the affected property owner(s). When it becomes necessary to temporarily block driveways, the Contractor shall notify the affected property owners in advance to coordinate the work and allow sufficient time for vehicles to vacate from properties. It may be necessary to allow for vehicles to temporarily park in the roadway at locations that do not interfere with the Contractor's work. During these periods the owners of the respective vehicles must be available to, with proper notice, move their vehicles if it becomes necessary to accommodate the work.

The Contractor shall maintain pedestrian traffic at all times covered under the pay item "Minor Traffic

Devices, Max \$15,000". For maintaining normal pedestrian traffic while performing sidewalk and driveway repair, Type I barricades shall be placed by the Contractor, as directed by the Engineer. "Sidewalk Closed" and/or "Cross Here" signs shall be placed, by the Contractor, when directed by the Engineer.

During the construction of the water main, storm sewer, and road rehabilitation, parking of residences in the construction area will not be allowed. Temporary "No Parking" signs will be supplied by the City. "No Parking" signs shall be erected after MISS DIG clearance, maintained throughout the project duration, and savaged and returned to the City of Ann Arbor at the W. R. Wheeler Service Center at the completion of the project, as described in the Detailed Specification for "No Parking" Signs. They will be paid for at the Contract Unit Price for ""No Parking" Signs". Any vehicle parked in the construction zone shall be ticketed and towed at the owner's expense.

At times when it becomes necessary to temporarily obstruct local traffic during the performance of the work, the Contractor shall provide traffic regulation in conformance with Chapter 6E of the MMUTCD. A minimum of two traffic regulators are required. The cost of traffic regulation shall be included in the contract pay item "Minor Traffic Devices, Max \$15,000"

The Contractor shall use quantities of dust palliative, maintenance aggregate, and hot patching mixture for use as temporary base, surfacing, and dust control at utility crossings, side roads and driveways (wherever required to maintain traffic), and where directed by the Engineer to maintain local access. The cost for the use of dust palliative, maintenance aggregate and HMA wedging mixture, as required and directed by the Engineer for maintenance of traffic and local access, shall be included in contract pay item "General Conditions, Max. \$50,000" and it will not be paid for separately.

The Contractor shall perform the work of this Contract while maintaining traffic in accordance with the Contract Documents as specified herein. No traffic shall be allowed on newly placed asphalt surfaces until rolling has been satisfactorily completed and the surface has cooled sufficiently to prevent damage from traffic. This is to be accomplished by traffic regulators and by relocating traffic control devices to prevent traffic from entering the work area until such time that it can be safely maintained without damaging the new construction. The Contractor shall provide traffic regulators in sufficient number to maintain traffic as described herein, and to keep traffic off sections being surfaced, and provide for safe travel at all times as directed by the Engineer.

Each pressure distributor, paver and roller shall be equipped with at least one approved flasher light which shall be mounted on the equipment so as to give a warning signal ahead and behind.

There may be areas where the Engineer directs the paving of less than the full width of a phase to stagger the paving joints and to accommodate changes in crown and/or cross-sectional dimensions/locations. In these locations the gravel base courses shall be constructed to the full area of the phase, and the Contractor shall place traffic control devices on the base course grade as necessary, and shall place, maintain, and remove maintenance aggregate (MDOT 21AA) all as necessary, and as directed by the Engineer, to maintain local traffic to side streets and drives.

The City will not allow any shut down of existing water mains without prior written approval of construction methods and timing of shut down, by the City of Ann Arbor and the Engineer. All water main valves are to be operated by City of Ann Arbor personnel.

The Contractor shall place portable, changeable message signs (PCMs) a minimum of one week prior to the start of construction in locations indicated by the Engineer. PCMs shall be the smaller of the two MDOT and MMUTCD approved message signs so they can fit on Seventh Street in the lawn extension or the limited right-of-way beyond the sidewalk.

Before the detour of southbound S Seventh, the Contractor shall coordinate their activities with the City Public Works and the Signal Unit prior to setting up signs and rerouting traffic. The detour is for the water main connection in the S Seventh Street and W Washington Street intersection and the Civil Defense Water Main Abandonment along S Seventh Street, and shall not be installed until approved by the Engineer.

## DETAILED SPECIFICATION FOR ITEM #204 - MINOR TRAFFIC DEVICES, MAX. \$15,000

#### **DESCRIPTION**

The work of Temporary Traffic Devices shall consist of protecting and maintaining vehicular and pedestrian traffic as shown on the plans, in the Maintenance of Traffic specification, and as directed by the Engineer, in accordance with Sections 103.05, 103.06, and 812 of the 2012 MDOT Standard Specifications for Construction; Part 6 of the Michigan Manual of Uniform Traffic Control Devices, Latest Revised Edition (MMUTCD); and the City Standard Specifications, except as modified herein. These devices include, but not limited to, advance, regulatory, and warning signs; barricades and channeling devices at intersecting streets on which traffic is to be maintained; barricades at the ends of the project and at right-of-way lines of intersecting streets; changeable message signs; lighted arrow boards; sign/signal covers and pavement marking cover tape for construction operations.

The work of Minor Traffic Devices shall include, but not be limited to:

- The furnishing and operating of miscellaneous signs, warning devices, flag-persons, and cones;
- The operation of additional signs furnished by the City;
- Furnishing and installing meter bags;
- Coordinating with the City to have meter heads removed and reinstalled;
- Maintaining pedestrian traffic;
- Temporarily covering traffic controls;
- Temporarily covering existing signs as directed;
- Any and all other miscellaneous and/or incidental items which are necessary to properly perform the work.

The Contractor shall maintain vehicular and pedestrian traffic during the work by the use of flag-persons, channelizing devices, and signs as necessary, as directed by the Engineer, and in accordance with MMUTCD. Typical applications for maintaining pedestrian traffic in accordance with the MMUTCD are included in this detailed specification.

#### MATERIALS, EQUIPMENT, AND CONSTRUCTION METHODS

#### General

Materials and equipment shall meet the requirements specified in the above-designated sections of the MDOT Standard Specifications.

All temporary traffic/pedestrian control devices furnished by the Contractor shall remain the property of the Contractor. The City shall not be responsible for stolen or damaged signs, barricades, barricade lights or other traffic maintenance items. The Contractor shall replace missing traffic control devices immediately, at no additional cost to the City.

All existing signs, and signs erected by the City of Ann Arbor on this project shall be preserved, protected, and maintained by the Contractor. Existing City owned signs which are damaged by the Contractor during the work will be repaired by the City at the Contractor's expense.

The Contractor shall temporarily cover conflicting traffic and/or parking signs when directed by the Engineer.

When traffic control devices have been damaged by, or due to, the negligence of the Contractor, his subcontractors or material suppliers, the traffic control devices shall be replaced at the Contractor's expense.

Lighted Plastic Drums; Barricades; Temporary Signs; Portable Changeable Message Signs; Lighted Arrow Boards; Pavement Marking Cover Tape; Temporary Pavement Markings The Contractor shall furnish and operate these items as directed by the Engineer.

Approximate quantities for these items are 3 Portable Changeable Message Signs, 506 sft Temporary Signs, Type B, 20 Type III Barricades, and 150 Type III Lighted Plastic Drums.

Traffic control devices meeting current MDOT and MMUTCD specifications shall be used on this project.

Lighted plastic drums shall be sufficiently ballasted to minimize tipping.

Type I and III barricades shall have standard orange-and-white stripes on both sides of the barricade.

Sufficient signs shall be provided by the Contractor to ensure the safety of the workers and the general public in accordance with the current MMUTCD.

"Road Work Ahead" warning signs shall be placed, as indicated on the Plans, or as directed by the Engineer, prior to the start of work, regardless of the nature, magnitude or duration of the work.

Removable black pavement marking cover tape shall be used to cover conflicting pavement markings as directed by the Engineer.

Temporary pavement markings may be used within transition areas as directed by the Engineer and shall be removable.

#### MEASUREMENT AND PAYMENT

This item of work will be paid for on a pro rata basis at the time of each progress payment. Measurement will be based on the ratio between work completed during the payment period and the total contract amount. When all of the work of this Contract has been completed, the measurement of this item shall be 1.0 Lump Sum.

The completed work as measured for this item of work will be paid for at the Contract Unit Price for the following Contract (Pay) Item:

#### PAY ITEM

#### PAY UNIT Lump Sum

Minor Traffic Devices, Max 15,000

The unit price for this item of work shall include all labor, material, and equipment costs to perform all the work specified in the Standard Specifications and as modified by this Detailed Specification.

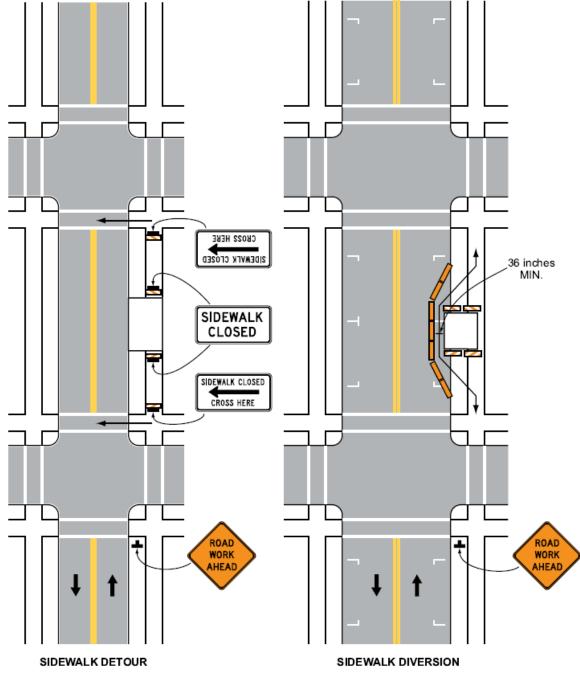


Figure 6H-28. Sidewalk Detour or Diversion (TA-28)

**Typical Application 28** 

Note: See Tables 6H-2 and 6H-3 for the meaning of the symbols and/or letter codes used in this figure.

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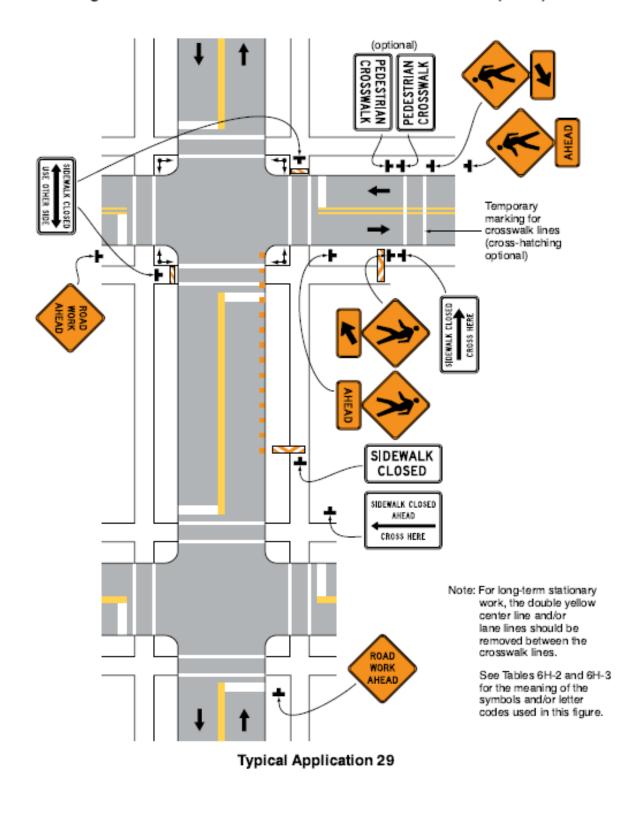


Figure 6H-29. Crosswalk Closures and Pedestrian Detours (TA-29)

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#### CITY OF ANN ARBOR

#### SPECIAL PROVISION FOR INTEGRAL SIDEWALK RETAINING WALL

AA:JN:JKA

#### 1 of 2

2/15/18

**a. Description.** This work shall consist of constructing concrete retaining walls adjacent to sidewalks, in accordance with Section 802 of the 2012 edition of the MDOT Standard Specifications for Construction, except as specified herein, as shown in this Detailed Specification, and as directed by the Engineer.

**b. Material.** Concrete mixtures shall be Grade P1 or S2 concrete, or as directed by the Engineer, meeting the requirements specified in Section 803 of the MDOT Standard Specifications.

**c. Construction.** The Contractor shall construct the Integral Sidewalk Retaining Walls as shown herein. Construction shall be in accordance with Section 802 of the 2012 MDOT Standard Specifications for Construction.

**d. Payment.** Payment shall be measured by the exposed face area of the retaining wall in square feet. The completed work, as described, will be measured and paid for at the contract unit price for the following pay item:

Contract Item (Pay Item)	Pay Unit
Integral Sidewalk Retaining Wall, 6 inch to 18 inch	Square Foot

Payment for "Integral Sidewalk and Retaining Wall, 6 inch to 18 inch" shall include all labor, equipment and materials to complete this work.

#### <u>Pre-Bid Meeting for the</u> <u>Crest, Buena Vista, Washington Water Main Replacement Project</u>

#### February 16, 2018 @ 10:00 a.m. in the Larcom Fourth Floor Conference Room, City Hall

#### I. <u>Introductions</u>

- II. Addendum Items
  - a. Addendum #1 -will include the following:
    - i. Pre-Bid minutes, including Sign-in Sheet
    - ii. Updated Plan Sheets
    - iii. Updated Bid Form Quantities
    - iv. Updated Detailed Specification for Maintenance of Traffic
    - v. Updated Detailed Specification for Minor Traffic Devices
    - vi. New Detailed Specification for Integral Sidewalk Retaining Wall

#### III. <u>General</u>

- a. Project Overview
  - i. Buena Vista, 8" and 12" water main
  - ii. Crest, 8" water main north of Buena Vista
  - iii. Washington, 8" and 12" water main
- b. Standard Specifications and Detailed Specifications
  - i. Project Schedule

Starting Date – May 14<sup>th</sup> – Can start earlier.

Completion Date – September 1, 2018 (110 days after commencement of work) Hours of work: 7:00 a.m. to 8:00 p.m. Monday thru Saturday (Sundays with permission)

Buena Vista done first to completion with temp water connection at Washington. Crest and Washington Starting June 16, after school's out.

- ii. Engineer's estimate \$1,898,295.50
- iii. General Conditions
  - 1. Coordination with the School
  - 2. Street sweeping & dust control
  - 3. Maintenance gravel
  - 4. Maintaining drainage
- iv. Access to driveways Contractor responsible for maintaining access to driveways during construction, and notifying residents when access will be unavailable (i.e. during water main installation, during paving, concrete work)

#### IV. Construction

- a. Utility Construction
  - i. Water Main Installation and Testing
    - 1. HMA removal for trench
    - 2. 16" Sleeves at 16" x 16" x 12" Tee Washington and Seventh
    - 3. 8" x 2" Reducer and 8" x 1.5" Reducer are 8" cap with 2" or 1.5" nipple.
  - ii. Sanitary leads when conflicts exist

- iii. Drainage Structure replacements
  - 1. Removals and Installations on Water Main Plan Sheets
- iv. Reminder that all new sanitary and storm sewers (including manholes) shall be cleaned and televised before final acceptance
- b. Resurfacing the road and paving –
- c. Sidewalk and ADA Ramps ADA compliance MUST be achieved at all locations
- d. Landscape Items and Restoration
  - i. Topsoil and Seeding
  - ii. Trees and shrubs
- V. <u>Other Items</u>
  - a. The existing 20" water main along Crest was flowable filled, which may or may not fill the entire steel pipe.
  - b. The 6" underdrains are intended to be installed where new curb and gutter is proposed, when an outlet basin is present.
  - c. The sanitary sewers were all inspected in 2014, and subsequently lined on Crest and Washington within the project limits. Video is available upon request.
  - d. Public Works encountered ground water when working between Eighth and Seventh, south of Washington St. Be cautious when working to abandon the Civil Defense water main on Seventh.
  - e. New Art in Ann Arbor castings might be ready when ordering from suppliers.

#### VI. Questions are due today at 1:00pm

Contact Information:

Jane Allen Project Manager Phone: (734) 794-6410 ext. 43678 Fax: (734) 994-1744 E-mail: jallen2@a2gov.org PRE-BID CONFERENCE SIGN-IN SHEET

DATE: February 16, 2018 10:00am PROJECT: Crest, Buena Vista, Washington Water Main Replacement Bid# 4525 FILE #: 2016-029

PLEASE PRINT (All information needs to be filled in to receive meeting minutes)

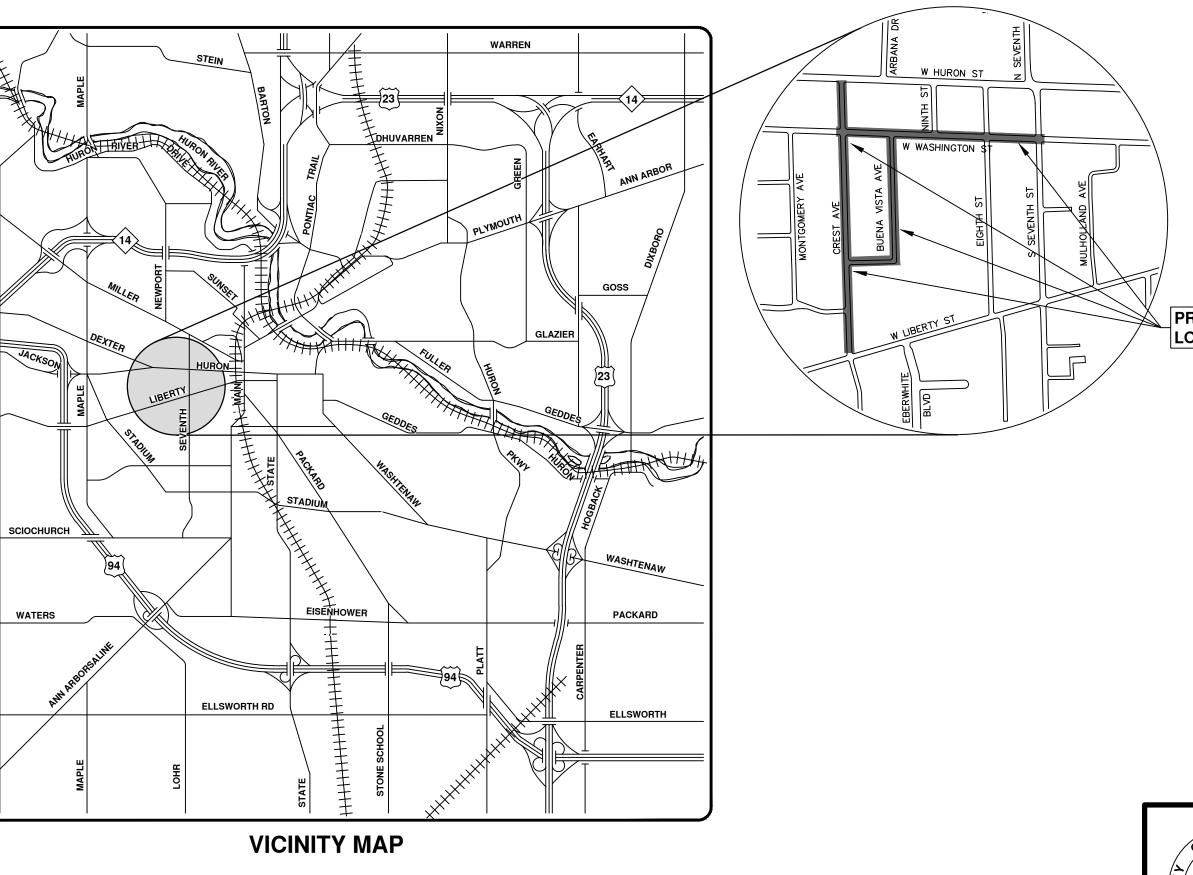
Itlen				LIVIAIL
K Allen			Direct: (734) 794-6410 x43678	
K Allen	City of Ann Arbor	Address: 301 E Huron St	Mobile: (419) 345-1976	Jallen2@a2gov.org
	Engineering	City, State: Ann Arbor, MI Zip: 48107	Fax (734) 994-1744	
		2241) Trent Out Of Che A	Direct: 734-996-9520	
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	COMPANY	City, State Arv MASUC - MI Zip: 48103	Fax: 734-761-5323	
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Brendan Fons F	Fonson		Direct: 810-231-5188	810-231-5188 inheaver
	companyith	Address 1641 Whitmore Lake Kd	Mobile:	tonsoninc. com
		City, State Brighton, MI Zip: 48116	Fax: 810-231-5404	
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	SHEET LIST TABLE
SHEET NUMBER	SHEET TITLE
1	COVER SHEET
2	STANDARD NOTES
3	LEGEND
4 - 7	TYPICAL PROPOSED ROAD SECTIONS
8 - 10	DETAILS
11	OVERALL TRAFFIC CONTROL
12	SOUTH BOUND S SEVENTH ST DETOUR
13 - 14	WASHINGTON ST. REMOVALS
15 - 16	BUENA VISTA AVE. REMOVALS
17 - 18	CREST AVE. REMOVALS
19 - 22	WASHINGTON ST. WATER MAIN PLAN AND PROFILE
23 - 25	BUENA VISTA AVE. WATER MAIN PLAN AND PROFILE
26 - 28	CREST AVE. WATER MAIN PLAN AND PROFILE
29	NINTH ST. AND EIGHTH ST. WATER MAIN PLAN AND PROFILE
30 - 32	HYDRANT PROFILES
33	CIVIL DEFENSE WATER MAIN ABANDONMENT
34 - 37	WASHINGTON ST. ROAD PLAN AND PROFILE
38 - 40	BUENA VISTA AVE. ROAD PLAN AND PROFILE
41 - 45	CREST AVE. ROAD PLAN AND PROFILE
46	PAVEMENT MARKINGS

# **CITY OF ANN ARBOR** ENGINEERING CREST, BUENA VISTA, WASHINGTON WATER MAIN

BID No. 4525, FILE No. 2016029



## NOTES:

FOR PROTECTION OF UNDERGROUND UTILITIES AND IN CONFORMANCE WITH PUBLIC ACT 174 OF 2013, THE CONTRACTOR SHALL CALL 811 OR 1-800-482-7171 A MINIMUM OF THREE FULL WORKING DAYS, EXCLUDING SATURDAYS, SUNDAYS, AND HOLIDAYS, PRIOR TO BEGINNING EACH EXCAVATION IN AREAS WHERE PUBLIC UTILITIES HAVE NOT BEEN PREVIOUSLY LOCATED. MEMBERS WILL THUS BE ROUTINELY NOTIFIED. THIS DOES NOT RELIEVE THE CONTRACTOR OF THE RESPONSIBILITY OF NOTIFYING UTILITY OWNERS WHO MAY NOT BE A PART OF THE "MISS DIG" ALERT SYSTEM.

THE UNDERGROUND LOCATIONS SHOWN FOR NATURAL GAS, TELEPHONE, ELECTRICAL POWER, CABLE TV AND FIBER OPTIC LINES ARE APPROXIMATE. THE CITY OF ANN ARBOR ASSUMES NO RESPONSIBILITY FOR THEIR ACCURATE REPRESENTATION IN THIS DRAWING. MISS DIG MUST BE CONTACTED PRIOR TO CONSTRUCTION TO LOCATE THESE UTILITIES

THE CONSTRUCTION COVERED BY THESE PLANS SHALL CONFORM TO THE 1994 EDITION OF THE CITY OF ANN ARBOR PUBLIC SERVICES DEPARTMENT STANDARD SPECIFICATIONS, IT'S DETAILS, WHICH ARE INCLUDED BY REFERENCE, AND THIS PROJECT'S CONTRACT DOCUMENTS. THE OMISSION OF ANY CURRENT STANDARD DETAIL DOES NOT RELIEVE THE CONTRACTOR FROM THIS REQUIREMENT.



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-	)		CITY OF ANN ARBOR						
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16	DRAWING No.	WATERMAIN REPLACEMENT PROJECT	734-794-6410	ON OUT FOR BID		2-6-18	CEC /DPF	JKA	Know what's
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15	REST, BUENA VIST	BUENA VISTA, WASHINGTON WATER MAIN; BID No. 4525; 2016029							

PROJECT LOCATION



PREPARED UNDER THE SUPERVISION OF

ANE KATHERINE ALLEN, P.E. - MI LICENSE No. 57254 **ROJECT MANAGER** 

2/06/2018

DATE



## **CONSTRUCTION NOTES:**

- DRIVEWAYS AND ENTRANCES TO BUILDINGS, REAL PROPERTY AND THE LIKE SHALL NOT BE BLOCKED EXCEPT FOR SHORT DURATIONS AND ONLY WHEN APPROVED BY THE ENGINEER. VEHICULAR AND PEDESTRIAN ACCESS SHALL BE MAINTAINED AT ALL TIMES. IT SHALL BE THE CONTRACTOR'S RESPONSIBILITY TO COORDINATE ALL NECESSARY DRIVEWAY CLOSURES WITH THE PROPERTY OWNER(S) AND RESIDENT(S) IN THE AREAS OF CONSTRUCTION.
- 2. THE LOCATION AND DEPTH OF ALL EXISTING UTILITIES AND SERVICE LEADS ARE TO BE FIELD VERIFIED BY THE CONTRACTOR PRIOR TO CONSTRUCTION.
- 3. LOCATION AND DEPTH OF UTILITIES AS DEPICTED ON THE PLANS IS APPROXIMATE AND SHOWN ACCORDING TO THE BEST INFORMATION AVAILABLE. IT IS THE CONTRACTOR'S RESPONSIBILITY TO EXCAVATE AHEAD AND ADJUST DEPTH OF CONFLICT UTILITIES ACCORDINGLY. ANY DAMAGE TO UTILITIES IS THE CONTRACTOR'S RESPONSIBILITY TO AVOID AND/OR REPAIR AS NECESSARY.
- 4. THE CONTRACTOR IS TO TAKE SPECIAL CARE TO PROTECT THE EXISTING WATER MAIN AND BE RESPONSIBLE FOR MAINTAINING CONSISTENT WATER SERVICE.
- 5. DURING NON-WORKING HOURS NO TRENCH SHALL REMAIN OPEN; ANY OPEN TRENCH SHALL BE PROPERLY SECURED WITH PROTECTIVE FENCING. THIS WORK SHALL BE INCLUDED IN THE ITEM OF WORK "GENERAL CONDITIONS".
- 6. TRENCHES FOR NEW WATER SERVICES SHALL BE EXCAVATED TO MIOSHA AND CITY OF ANN ARBOR PUBLIC WORKS REQUIREMENTS.
- 7. CITY OF ANN ARBOR PUBLIC WORKS WILL INSTALL THE CORPORATION AND COPPER SERVICE LEAD(S) TO TRANSFER THE CONNECTION(S). IF AN EXISTING WATER SERVICE IS FOUND TO BE FAILING OR IS NOT COPPER, THE LEAD WILL BE REPLACED TO THE CURB BOX BY PUBLIC WORKS.
- 8. FOR THE INSTALLATION OF CORPORATIONS, OR ANY OTHER RELATED ACTIVITIES, THE CONTRACTOR SHALL NOT RECEIVE ADDITIONAL COMPENSATION FOR DELAYS DUE TO THE SCHEDULING OF OR COORDINATION WITH THE CITY OF ANN ARBOR PUBLIC WORKS.
- 9. THE CONTRACTOR SHALL BACKFILL TRENCHES IN ACCORDANCE WITH TRENCH DETAIL SPECIFIED ON PLANS. THIS WORK SHALL BE INCLUDED IN THE ITEM OF WORK "EXCAVATE AND BACKFILL FOR WATER SERVICE TAP AND LEAD". ALL CONCRETE REMOVALS AND REPLACEMENTS REQUIRED FOR THIS WORK WILL BE PAID FOR SEPARATELY.
- 10. ALL DUCTILE IRON PIPE AND FITTINGS SHALL BE POLYETHYLENE ENCASED PER ANSI/AWWA C105/A21.5.
- 11. FLUOROPOLYMER COATED BOLTS TO BE USED AT ALL MECHANICAL WATER MAIN JOINTS AT HYDRANTS AND MEGALUG FITTINGS
- 12. THE CONTRACTOR SHALL CONSTRUCT, FLUSH, AND BACTERIOLOGICALLY TEST THE WATER MAIN PER DETAILED SPECIFICATION "WATER MAIN INSTALLATION AND TESTING" AND AS APPROVED BY THE ENGINEER. ALL CHLORINATED WATER SHALL BE DISCHARGED DIRECTLY INTO AN APPROVED SANITARY SEWER. THE CONTRACTOR SHALL SUPPLY ALL NECESSARY HOSES, FITTINGS AND THE LIKE TO ACCOMPLISH THIS WORK.
- 13. WATER MAIN FITTINGS, OTHER THAN THOSE SPECIFICALLY LISTED AS SEPARATE PAY ITEMS, WHICH ARE REQUIRED TO COMPLETE THE WORK, SUCH AS BLOW-OFF ASSEMBLIES, CONCRETE THRUST BLOCKS. SOLID SLEEVES AND MECHANICAL PLUGS, SHALL NOT BE PAID FOR SEPARATELY, BUT SHALL BE INCLUDED IN THE PIPE PAY ITEMS.
- 14. "NO PARKING" SIGNS SHALL BE INSTALLED BY THE CONTRACTOR AT LOCATIONS AS APPROVED OR DIRECTED BY THE ENGINEER. ALL SIGNS SHALL BE INSTALLED IN ACCORDANCE WITH THE DETAILED SPECIFICATIONS.
- 15. POSTAL DELIVERY AND REFUSE PICKUP SERVICE SHALL BE MAINTAINED AT ALL TIMES BY THE CONTRACTOR.
- 16. ALL FITTINGS, HYDRANTS, VALVES AND CASTINGS REMOVED DURING CONSTRUCTION ARE THE PROPERTY OF THE CITY OF ANN ARBOR. THE CONTRACTOR WITHIN 48 HOURS SHALL DELIVER TO CITY OF ANN ARBOR FIELD OPERATIONS AND MAINTENANCE FACILITY AT THE W.R. WHEELER SERVICE CENTER LOCATED AT 4251 STONE SCHOOL ROAD.
- 17. WHERE STREET CURBS ARE UNDERMINED DUE TO CONSTRUCTION ACTIVITIES, THEY SHALL BE REMOVED AND REPLACED AS DIRECTED BY THE ENGINEER.
- 18. THE CONTRACTOR SHALL BE RESPONSIBLE FOR THE CONTINUOUS MAINTENANCE OF THE TEMPORARY ROAD SURFACE AND SOIL EROSION CONTROL MEASURES WITHIN THE CONSTRUCTION AREA UNTIL THE FULL COMPLETION OF THE PROJECT. THIS WORK SHALL BE INCLUDED IN THE ITEM OF WORK "GENERAL CONDITIONS".
- 19. ALL CURB, SIDEWALK, DRIVEWAY APPROACH REMOVALS SHALL BE APPROVED BY ENGINEER BEFORE THE WORK IS DONE.
- 20. SAWED SEWER PIPE CONNECTIONS SHALL BE COUPLED WITH A FERNCO FLEXIBLE COUPLING AND A STAINLESS STEEL SHEAR RING.
- 21. THE LOCATION OF MATERIAL STOCK PILES AND ON-SITE STAGING AREAS TO BE APPROVED BY THE ENGINEER.
- 22. FOR MAINLINE PAVING, THE WIDTH OF THE MAT FOR EACH PASS OF THE PAVER SHALL BE NOT LESS THAN 10.5' OR GREATER THAN 15', AS DIRECTED BY THE ENGINEER. THE ENGINEER WILL DIRECT THE LAYOUT OF THE LONGITUDINAL JOINTS DURING CONSTRUCTION.
- 23. ALL STRUCTURES SHALL RECEIVE NEW CASTINGS AS DIRECTED BY THE ENGINEER, AS SPECIFIED ON THE STANDARD CASTING SCHEDULE. THE EXISTING CASTINGS ARE THE PROPERTY OF THE CITY OF ANN ARBOR. THE CONTRACTOR SHALL DELIVER TO CITY OF ANN ARBOR FIELD OPERATIONS AND MAINTENANCE FACILITY AT THE W.R. WHEELER SERVICE CENTER LOCATED AT 4251 STONE SCHOOL

ROAD.

- 24. PAYMENT FOR DRAINAGE STRUCTURE SUMPS, WHERE SPECIFIED, SHALL BE INCLUDED IN THE PAYMENT FOR THE VARIOUS DRAINAGE STRUCTURE SIZES AND OR TYPES.
- 25. WHERE SEWER PIPES OF DIFFERENT SIZES OR MATERIALS ARE JOINED, FERNCO FLEXIBLE COUPLINGS WITH STAINLESS STEEL SHEAR RINGS SHALL BE USED. ALL COSTS ASSOCIATED WITH THE INSTALLATION OF THESE DEVICES SHALL BE INCLUDED IN THE PAYMENT FOR THE SEWER.
- 26. WHERE SEWER AND WATER MAIN ARE TO BE REMOVED & REPLACED OR ADDED, ALL PIPE SHALL BE INSTALLED USING TRENCH DETAIL DETAILED IN THE SPECIFICATIONS OR SHOWN ON PLANS. BACKFILL FOR SEWER AND WATER CONSTRUCTION SHALL BE MDOT GRANULAR MATERIAL, CLASS II.
- 27. EXISTING STREET NAME, GUIDE, AND REGULATORY SIGNS, AND MAILBOXES WHICH CONFLICT WITH THE PROPOSED CONSTRUCTION SHALL BE REMOVED PRIOR TO CONSTRUCTION, STORED IN A MANNER WHICH WILL PREVENT DAMAGE, AND RE-SET IN LOCATIONS AS DIRECTED BY THE ENGINEER. THIS WORK WILL NOT BE PAID FOR SEPARATELY, BUT SHALL BE INCLUDED IN "MACHINE GRADING, MODIFIED"
- 28. IN AREAS WHERE EDGE DRAIN CANNOT BE INSTALLED IN ACCORDANCE WITH CITY OF ANN ARBOR DETAIL SD-TD-11, THE EDGE DRAIN SHALL BE INSTALLED AT THE DEPTH AS INDICATED ON THE PLANS, OR AS DIRECTED BY ENGINEER. IN NO CASE SHALL THE EDGE DRAIN BE INSTALLED AT A GRADE LESS THAN 0.50% OR AT A DEPTH OF LESS THAN 2' BELOW TOP OF PROPOSED PAVEMENT.

GENERAL NOTIFY THE CITY OF ANN ARBOR SOIL EROSION CONTROL OFFICE 48 HOURS PRIOR TO BEGINNING WORK ON THE PROJECT. PHONE: 734-794-6265.

- GRADE.
- SITUATIONS THAT PROMOTE EROSION.
- AND/OR DUST PALLATIVE AS REQUIRED.
- ADJACENT PROPERTIES.

# 24 HOURS OF A STORM EVENT.

- DRIVES, ETC.).
- 1.6. COMPLETE ALL FINE GRADING.

- PRIOR TO FINAL INSPECTION

TEMPORARY SEEDING:

THE CONTRACTOR SHALL IMPLEMENT AND MAINTAIN THE SOIL EROSION CONTROL MEASURES AS SHOWN ON THE PLANS AND AS DIRECTED BY THE ENGINEER AT ALL TIMES DURING CONSTRUCTION. ANY MODIFICATIONS OR ADDITIONS TO THE SOIL EROSION CONTROL MEASURES DUE TO CONSTRUCTION OR CHANGED CONDITIONS SHALL BE AS DIRECTED AND APPROVED BY THE ENGINEER.

2. ALL SOIL EROSION AND SEDIMENTATION CONTROL WORK SHALL CONFORM TO THE PERMIT REQUIREMENTS OF THE CITY OF ANN ARBOR, CITY ORDINANCE CHAPTER 63, CITY OF ANN ARBOR STANDARDS DIVISION VI, THE LAWS OF THE STATE OF MICHIGAN, AND THE REQUIREMENTS OF THE CONTRACT DOCUMENTS.

3. DAILY, OR AFTER ANY STORM EVENT, INSPECTIONS OF EROSION CONTROL MEASURES SHALL BE MADE BY THE CONTRACTOR. PERIODIC INSPECTIONS MAY BE MADE BY THE ENGINEER TO DETERMINE THE EFFECTIVENESS OF EROSION AND SEDIMENTATION CONTROL MEASURES. ANY NECESSARY CORRECTIONS SHALL BE MADE WITHOUT DELAY, AND WITHOUT ADDITIONAL COST TO THE CITY OF ANN ARBOR.

4. EROSION AND SEDIMENTATION FROM WORK ON THE SITE SHALL BE CONTAINED ON THE SITE AND NOT BE ALLOWED TO COLLECT ON ANY OFF-SITE AREAS, ROADWAYS OR WATERWAYS.

5. ALL MUD/SOIL TRACKED ONTO ROADWAYS FROM THE SITE DUE TO CONSTRUCTION, SHALL BE PROMPTLY REMOVED BY THE CONTRACTOR. IF SO ORDERED, THE CONTRACTOR SHALL PROVIDE AND OPERATE A VACUUM-TYPE STREET SWEEPER, AT NO ADDITIONAL COST TO THE CITY OF ANN ARBOR, WITHIN FOUR (4) HOURS OF BEING SO ORDERED.

6. RESTORATION OF ALL DISTURBED AREAS, INCLUDING PLACEMENT OF TOPSOIL, SEED, FERTILIZER AND MULCH AND/OR SOD SHALL BE PERFORMED WITHIN FIVE (5) DAYS OF THE COMPLETION OF FINAL

CONSTRUCTION OPERATIONS SHALL BE SCHEDULED AND PERFORMED SO THAT PREVENTATIVE SOIL EROSION CONTROL MEASURES ARE IN PLACE PRIOR TO EXCAVATION IN CRITICAL AREAS AND TEMPORARY STABILIZATION MEASURES ARE IN PLACE IMMEDIATELY FOLLOWING BACKFILLING OPERATIONS. 8. SPECIAL PRECAUTIONS WILL BE TAKEN IN THE USE OF CONSTRUCTION EQUIPMENT TO PREVENT

9. PROPER DUST CONTROL SHALL BE MAINTAINED DURING CONSTRUCTION BY USE OF WATER TRUCKS

10. THE CONTRACTOR SHALL BE RESPONSIBLE FOR MAINTAINING ALL TEMPORARY SOIL EROSION CONTROL MEASURES AND REMOVAL OF SOME MEASURES UPON AUTHORIZED COMPLETION OF THE PROJECT FINAL COMPLETION OF PROJECT WILL NOT BE AUTHORIZED UNTIL ALL SITE WORK AND UTILITY CONSTRUCTION IS COMPLETE AND ALL SOILS ARE STABILIZED.

11. THE CONTRACTOR SHALL NOT GRADE INTO ADJACENT PROPERTIES. SILT AND PROTECTIVE FENCE SHALL BE INSTALLED AND MAINTAINED TO PREVENT GRADING, EROSION AND SEDIMENTATION INTO THE

12. TREE PROTECTION FENCING MUST REMAIN INTACT UNTIL RESTORATION OF THE SITE IS COMPLETE. SEQUENCE OF EROSION CONTROL MEASURES:

THE CONTRACTOR IS TO SUBMIT TO THE ENGINEER, A SEQUENCE OF CONSTRUCTION WITH RESPECT TO THE SOIL EROSION CONTROL MEASURES FOR REVIEW, COMMENT AND APPROVAL. THIS SCHEDULE IS TO INCLUDE INSPECTION AND REPAIR OF ALL TEMPORARY EROSION CONTROL MEASURES DAILY AND WITHIN

SAMPLE SOIL EROSION AND SEDIMENTATION CONTROL INSTALLATION MINIMUM REQUIREMENTS: 1.1. INSTALL SILT FENCE, TREE PROTECTION FENCING, MUD MATS, INLET FILTERS ON EXISTING DRAINAGE FEATURES, AND ALL OTHER TEMPORARY SOIL EROSION CONTROLS, PRIOR TO ANY CLEARING OR EARTH MOVING OPERATION.

1.2. STRIP AND STOCKPILE TOPSOIL. STABILIZE STOCKPILE AS REQUIRED.

1.3. INSTALL WATER MAINS, STORM AND SANITARY SEWERS, AND OTHER ENCLOSED DRAINAGE FEATURES NEW INLET FILTERS SHALL BE INSTALLED IMMEDIATELY FOLLOWING INSTALLATION OF NEW DRAINAGE

1.4. PERFORM MACHINE GRADING OPERATIONS AND CONSTRUCT PAVEMENTS (MAINLINE, SIDEWALKS,

1.5. CONTINUALLY MAINTAIN EROSION AND SEDIMENTATION CONTROL MEASURES, AS REQUIRED TO ALLOW DRAINAGE AND SEDIMENT REMOVAL. REMOVE ANY ACCUMULATED SEDIMENT IMMEDIATELY.

1.7. TEMPORARY SEED AND INSTALL EROSION CONTROL BLANKET IN ALL DISTURBED AREAS.

1.8. REFER TO LANDSCAPE PLANTING PLANS FOR PERMANENT SITE STABILIZATION.

1.9. CLEAN OUT STORM SEWER SYSTEMS.

1.10. REMEDY ANY NOTED DEFECTS TO THE SATISFACTION OF THE CITY OF ANN ARBOR'S SOIL EROSION AND SEDIMENTATION CONTROL OFFICIAL.

1.11. ALL TEMP. SOIL EROSION CONTROL MEASURES MUST BE REMOVED, WITH ENGINEERS APPROVAL

NOTE: THIS SEQUENCE IS FOR INFORMATION ONLY. IT IS INTENDED TO SHOW THE SEQUENCE OF CONSTRUCTION WITH RESPECT TO THE SOIL EROSION AND SEDIMENTATION CONTROL MEASURES. THE CONTRACTOR IS RESPONSIBLE FOR SUBMITTING THEIR OWN DETAILED CONSTRUCTION SEQUENCE AND SCHEDULE TO THE ENGINEER FOR REVIEW, COMMENT, AND APPROVAL.

1. SEED IN ACCORDANCE WITH PROJECT DRAWINGS AND SPECIFICATIONS.

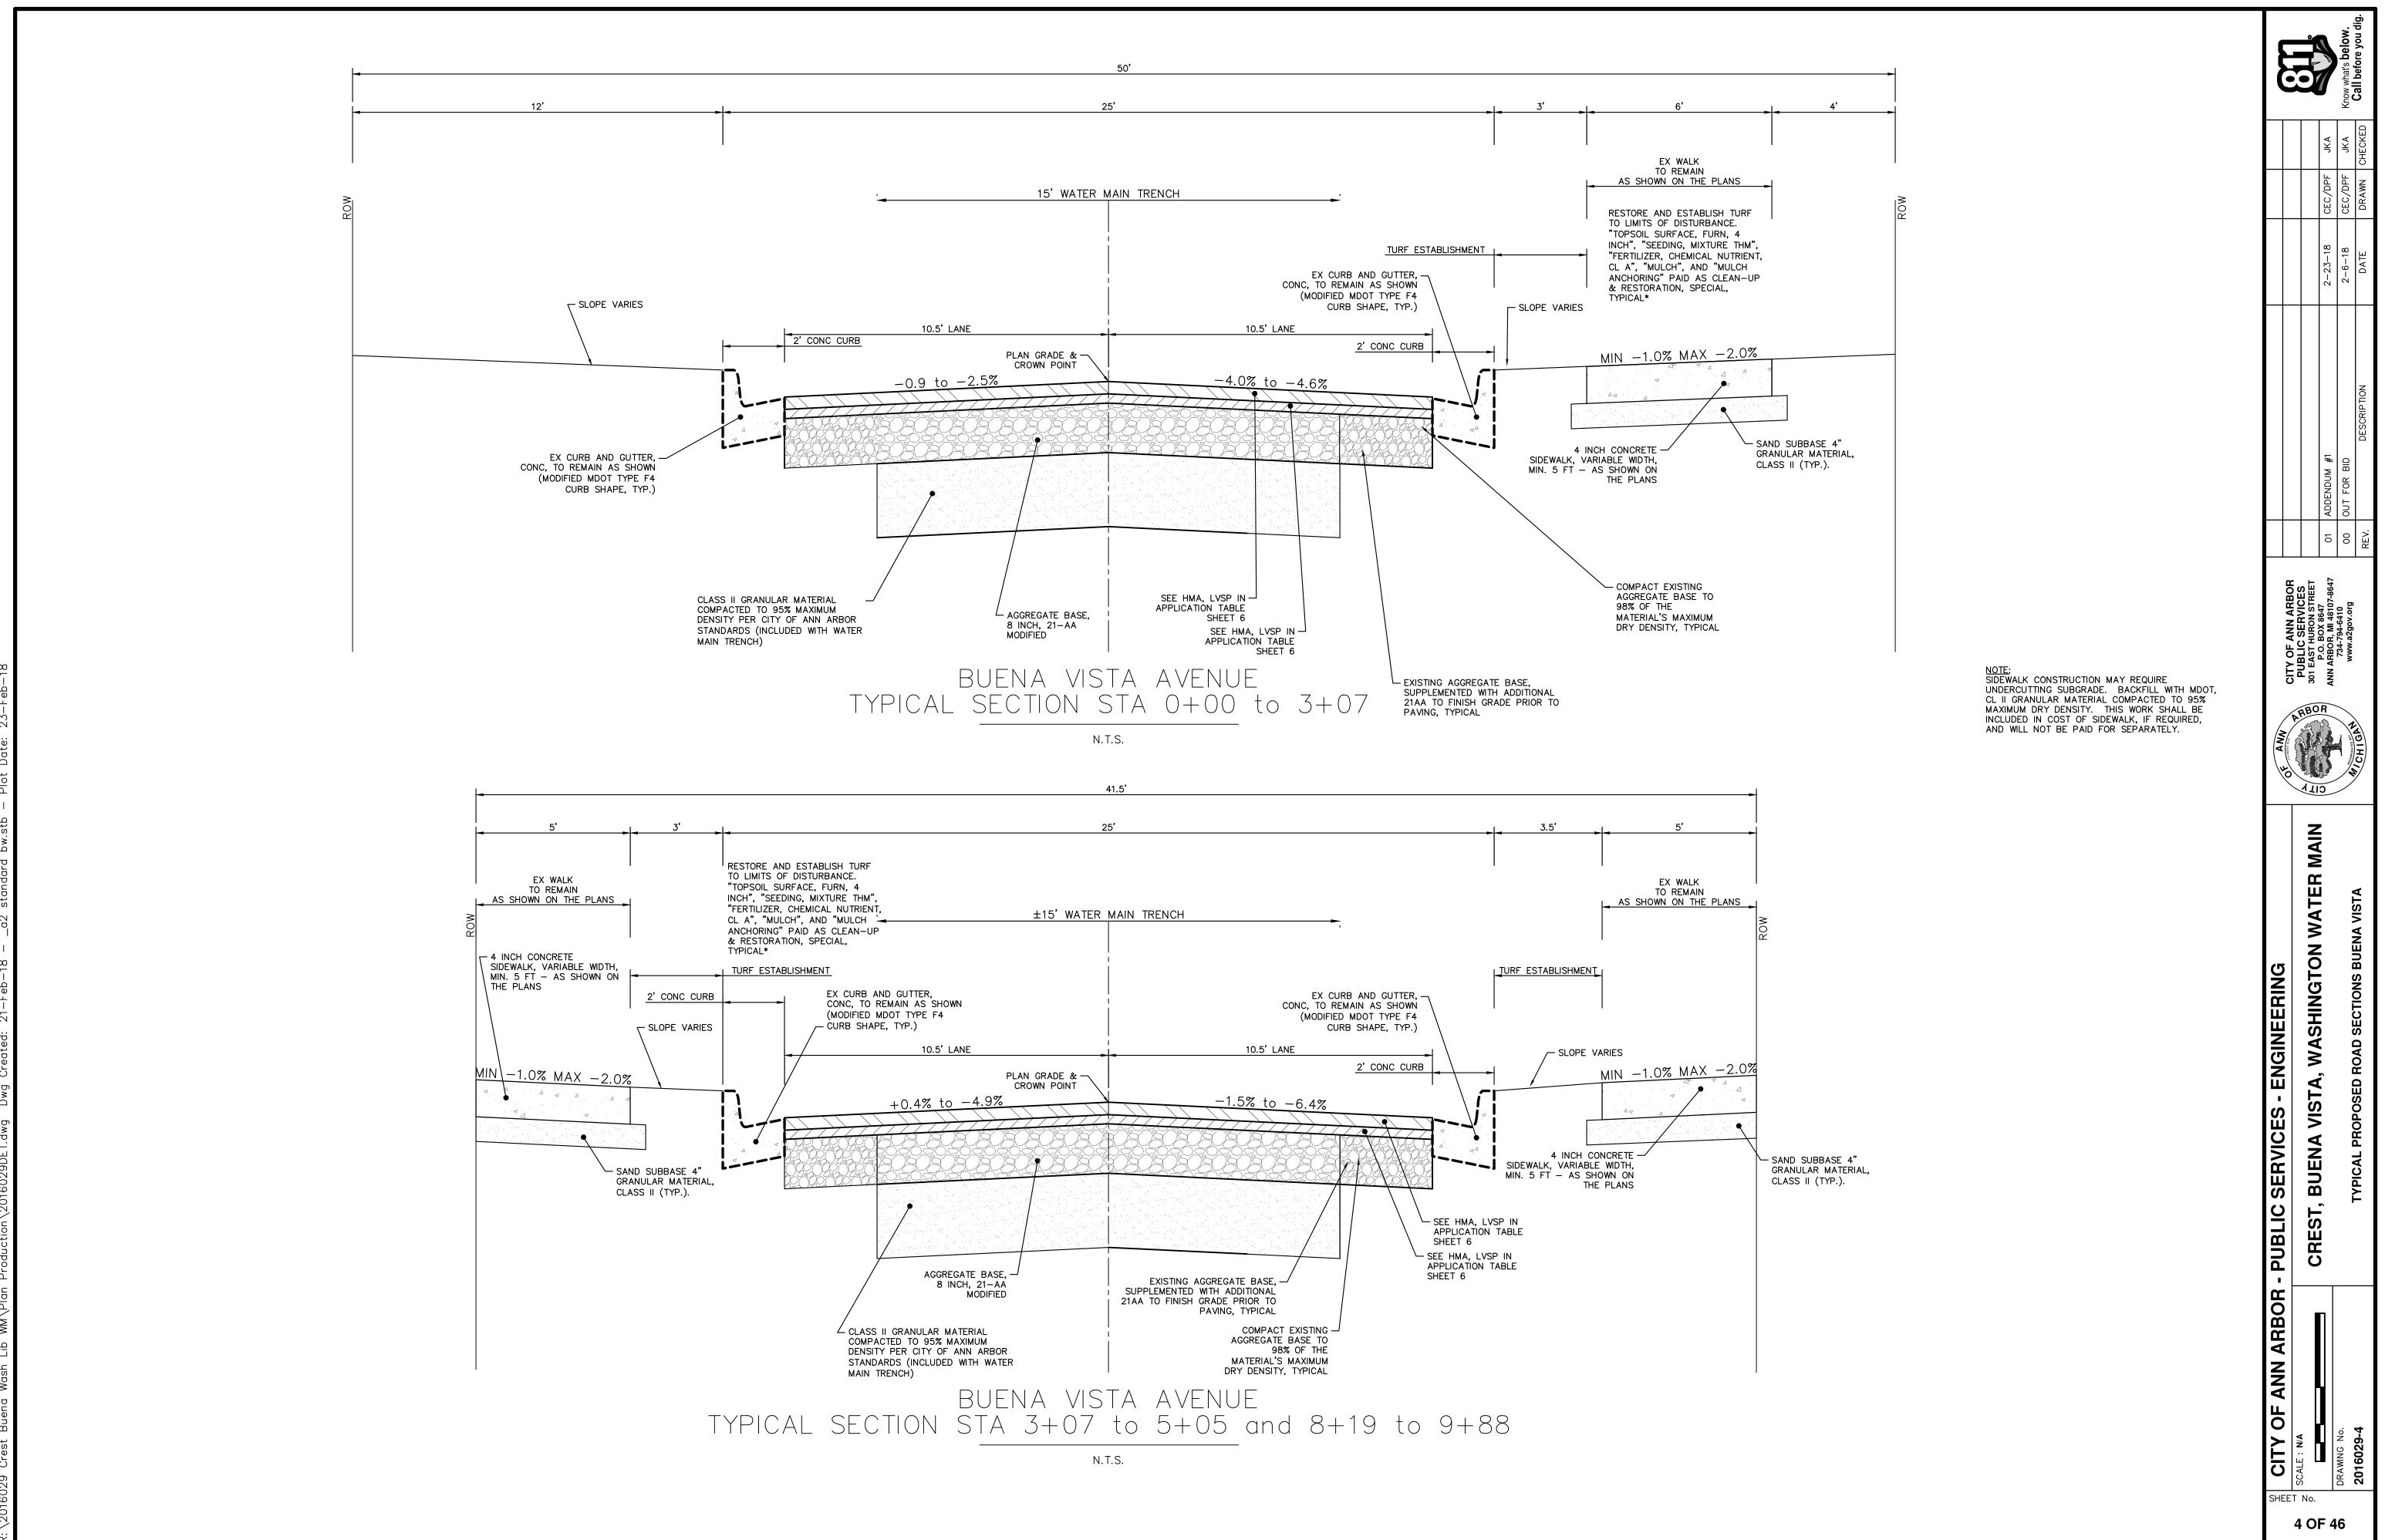
2. ANY DISTURBED AREA NOT PAVED, SEEDED, MULCHED, SODDED OR BUILT UPON BY NOVEMBER 15TH OR JUNE 30TH IS TO BE TEMPORARILY STABILIZED PER SPECIFICATIONS.

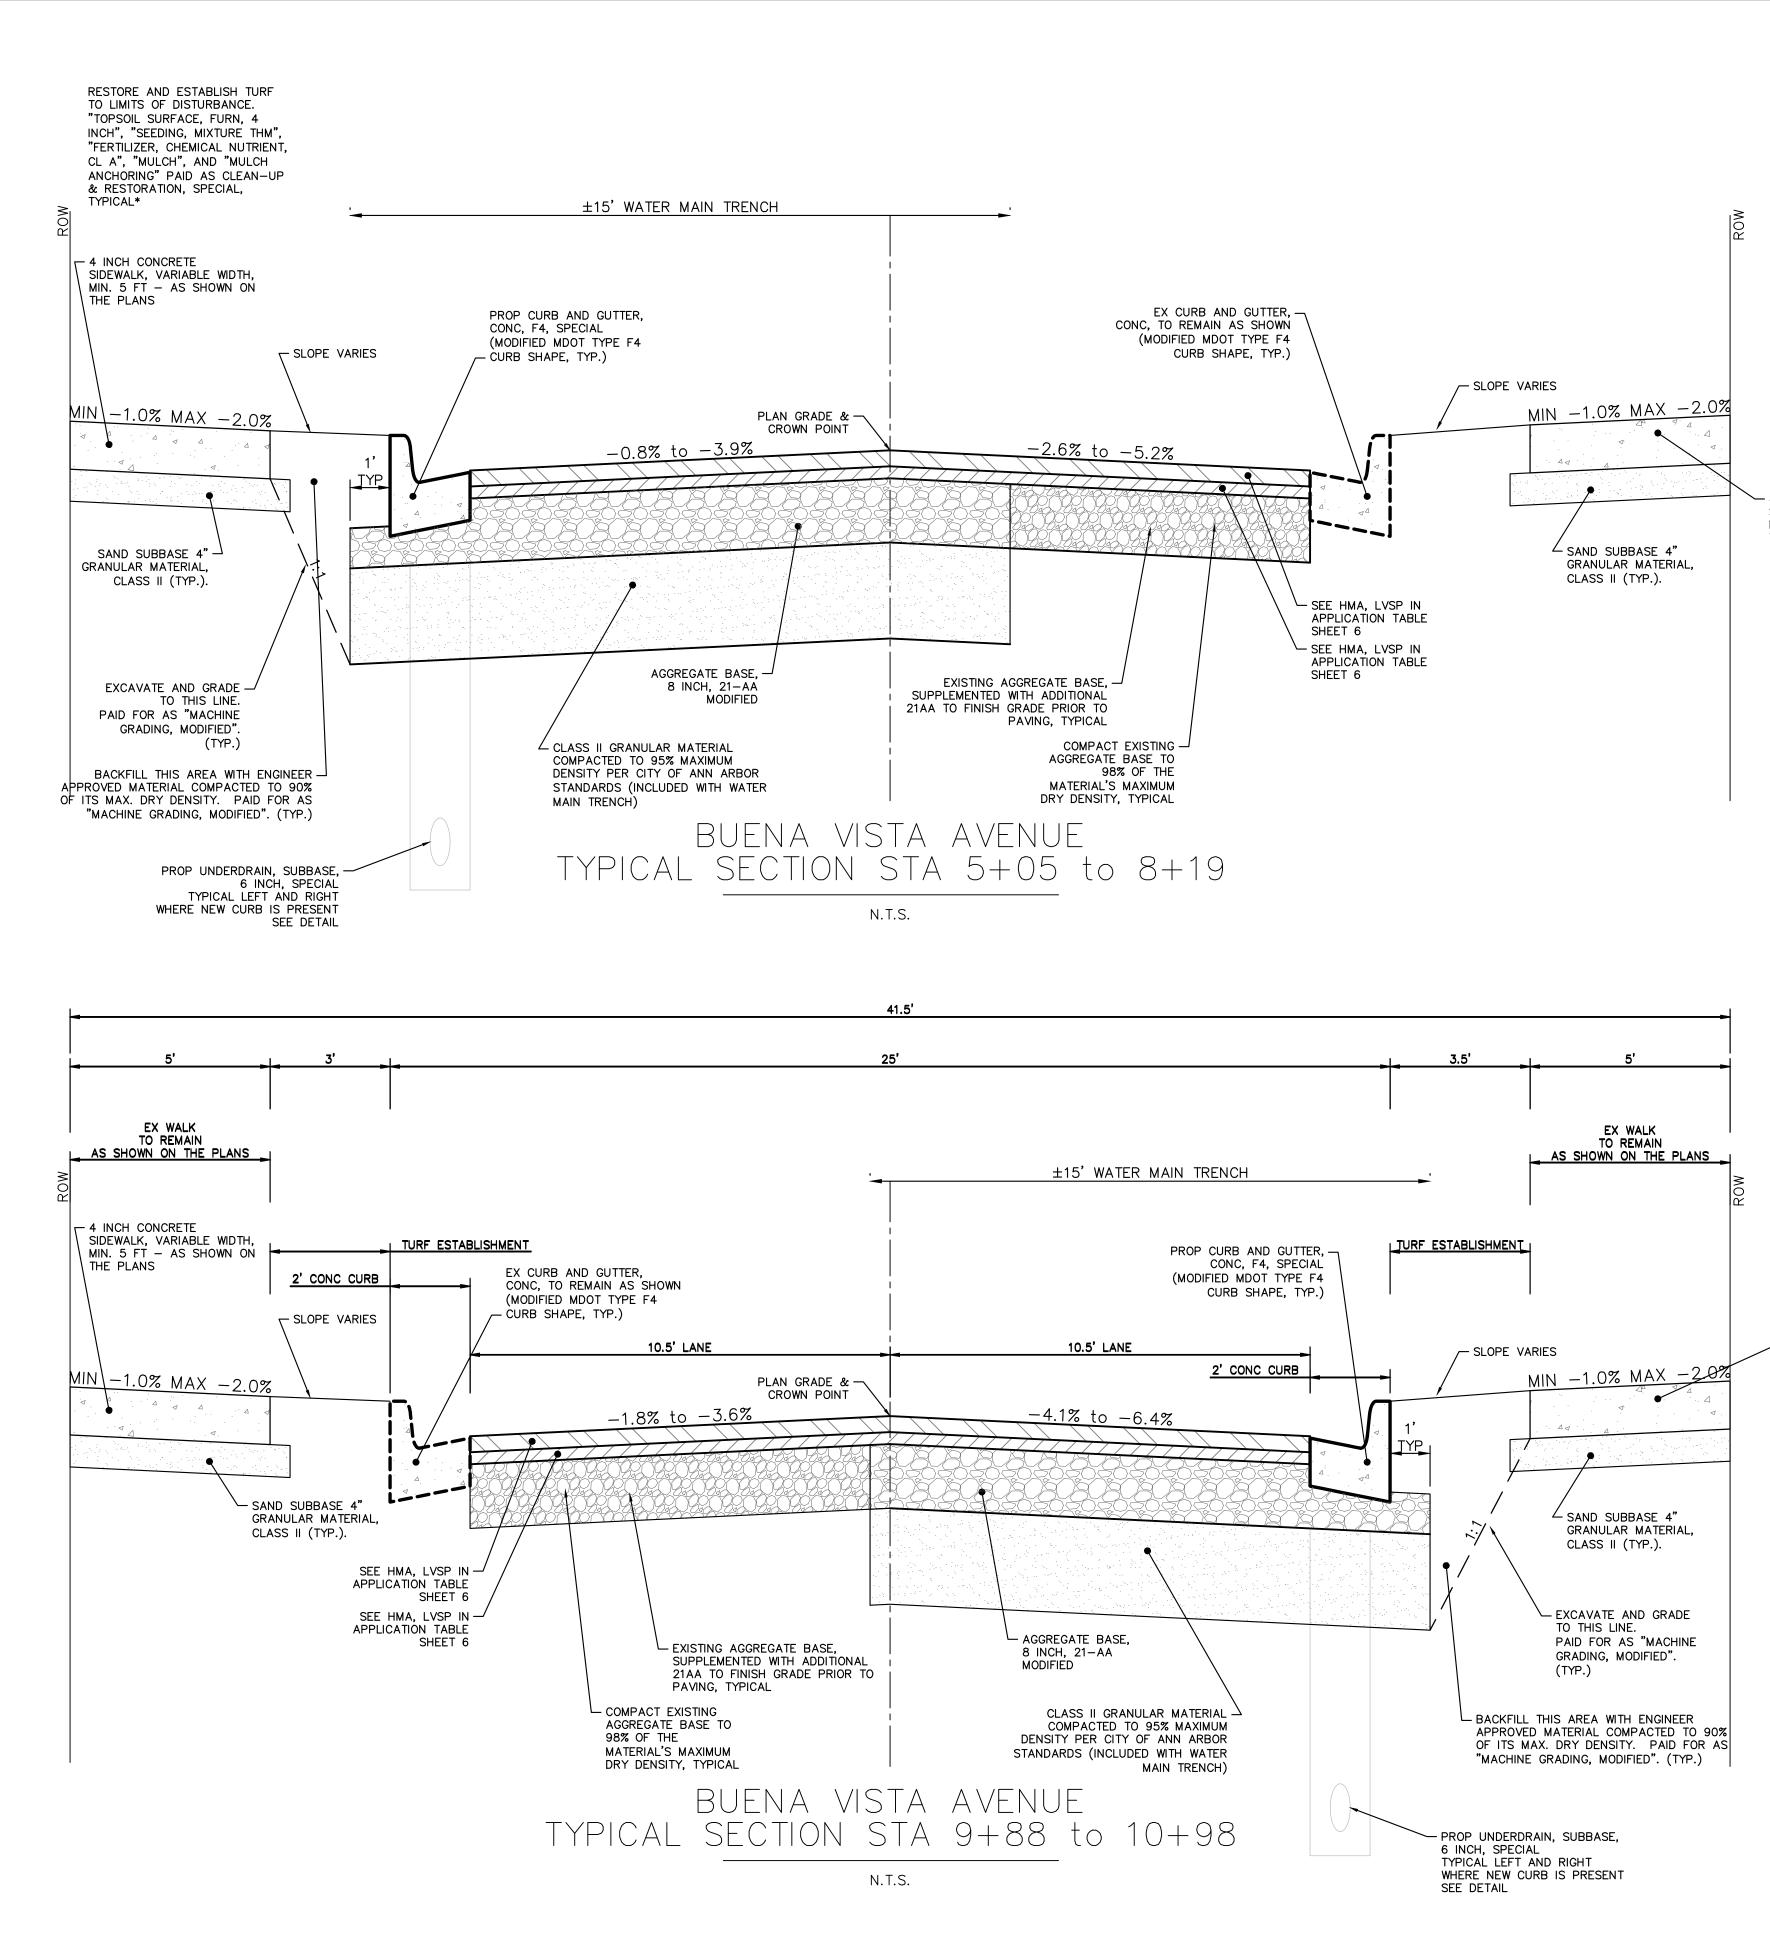
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CEC/DPF		CITY OF ANN ARBOR CUSTOMER SERVICE	DIMENTATION	GRADING/SOIL EROSION & SED CONTROL PERMIT*			
		CITY OF ANN ARBOR CUSTOMER SERVICE		RIGHT-OF-WAY PERMIT*			
2-23-18		CONTRACTOR	* NO COST TO				
				PERMITS REQUIRED			
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NDUM #1			ΓΙΟΝ	CONTACT INFORMAT			
ADDENDUM	CONTACT	OWNER		PUBLIC UTILITIES			
	DAN WOODEN (734) 794–6350			WATER			
0	RYAN FERREL			SANITARY			
N ARBOR ERVICES ON STREET (8647 II 48107-8647	PAT MAINO (734) 794–6350		CITY OF ANN PUBLIC WORK	STORM			
ANN AF SERVIC URON ST SOX 8647 MI 4810	MATT WALDSMITH	SCHOOL ROAD		FORESTRY			
CITY OF / PUBLIC 301 EAST H 201 EAST H PO.E ANN ARDOF	(734) 794–6350 CHUCK FOJTIK (734) 794–6361			SIGNS SIGNALS STREET LIGHTS			
ARBOR	CONTACT	OWNER		PRIVATE UTILITIES			
ANN	ROBERT CZAPIEWSKI (734) 544–7818	IGAN AVE, WNSHIP, MI 48198	DTE ENERGY 3150 E. MICH YPSILANTI TO	GAS			
	CLAY COMBEE (734) 397-4112		DTE ENERGY WESTERN WA' 8001 HAGGER BELLEVILLE, M	ELECTRIC			
MAIN	RON SUTHERLAND (313) 999–8300		COMCAST 27800 FRANK SOUTHFIELD,	CABLE			
WATER	(734) 996–2135		AT&T 550 S. MAPL ANN ARBOR,	PHONE			
Z	DEAN BOYERS (972) 729-6016		MCI 2800 N. GLEI RICHARDSON,	FIBER OPTIC			
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		Y ST. & EBERWHITE BLVD.	RNER OF LIBERT	PIKE IN N. SIDE OF U.P. @ S.E. COF	RF	863.006	4
BUENA VIS	RTY ST. & CREST AVE.	E @ SW CORNER OF LIBER	K" MAST ARM PO	ANCHOR BOLT FOR "CROSS-WALK	N.'	870.196	5
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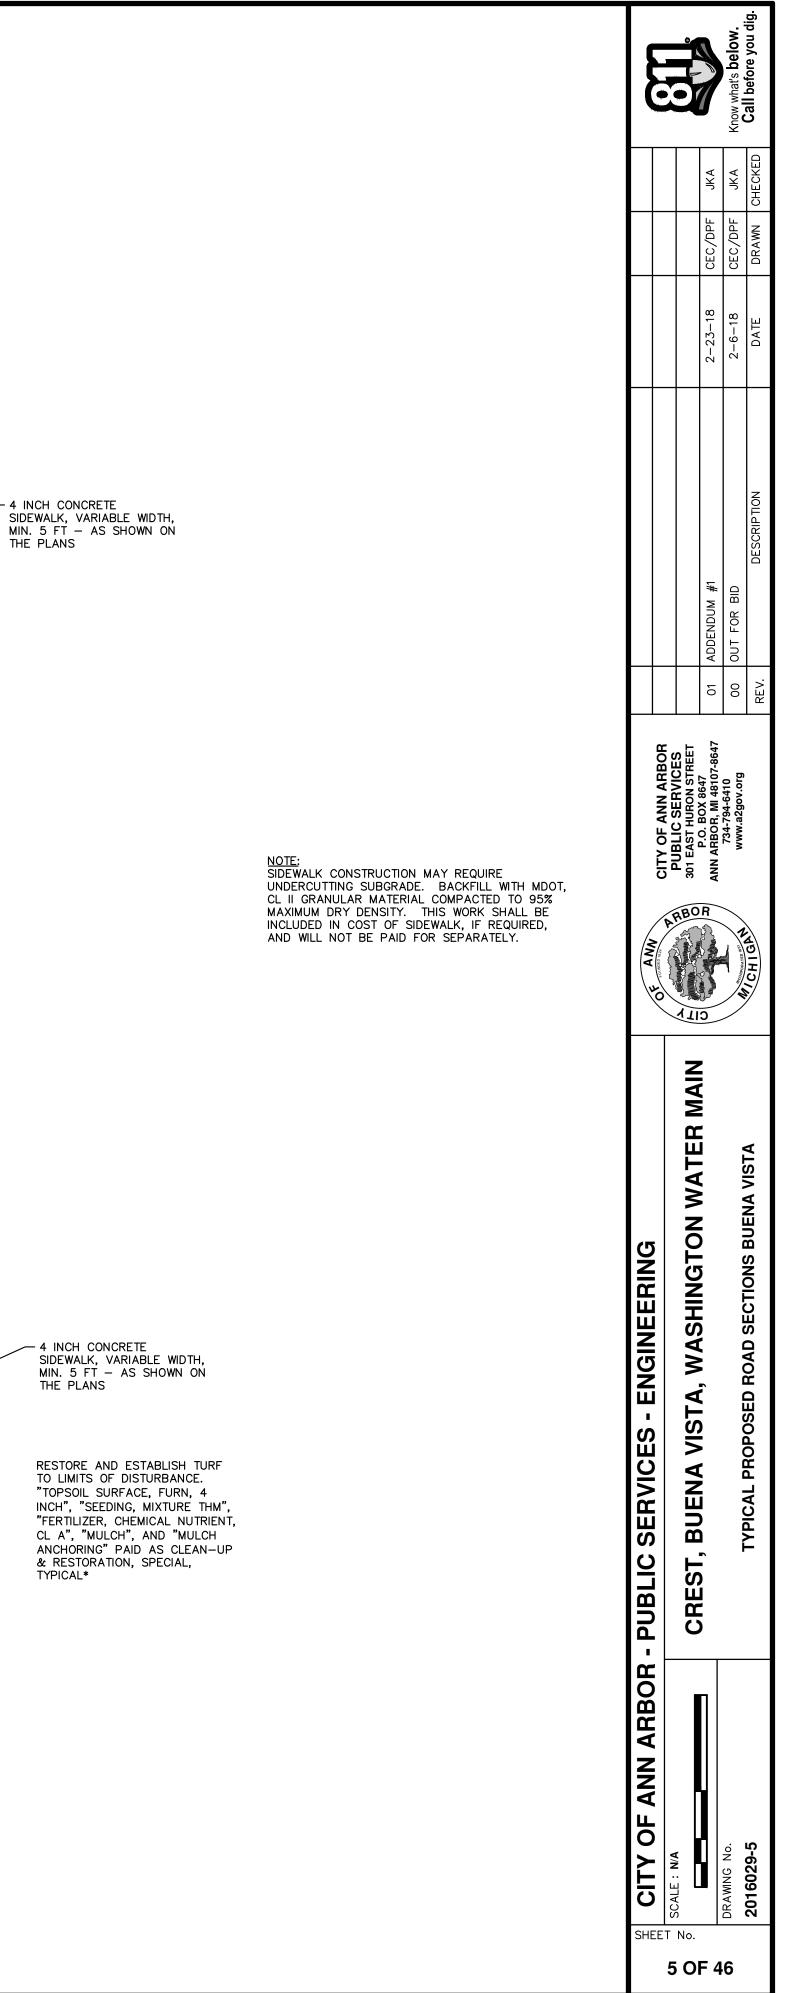
EXISTING LEGEND			PROPOSED LEGEND		
↓ FIRE HYDRANT	<i>W</i>	WATER MAIN	∳+ HYDRANT (PLAN)	w	WATER MAIN
GATE VALVE IN BOX	/ -/ -// -/ -//	WATER MAIN ABANDONED	↓ VATER GATE WELL		STORM SEWER
⊗ GATE VALVE IN WELL		STORM SEWER	▼ REDUCER	S	SANITARY SEWER
⊛ STOP BOX	///	STORM SEWER ABANDONED	WATER GATE VALVE	——F0— — — — ——	FIBER OPTIC
WATER VAULT	<u></u>	SANITARY SEWER	• • WATER STOP BOX	——E — — — — —	ELECTRICAL
Well	///	SANITARY SEWER ABANDONED	W WATER VAULT		CENTERLINE OF DITCH
🗆 CATCH BASIN (SQ)	g	GAS MAIN			CENTERLINE OF ROAD
⊕ CATCH BASIN (RD)	g (DEAD)	GAS MAIN (DEAD)	DOUBLE INLET	////	FENCE
O STORM MANHOLE	o~~~o	ELECTRICAL OVER HEAD	INLET JUNCTION CHAMBER	;;;	GRAVEL
□ NON-CURB CATCH BASIN (SQ)		ELECTRICAL UNDER GROUND	ROUND CATCH BASIN		SILT FENCE
) END SECTION	e duct bank	ELECTRICAL DUCT BANK	STORM MANHOLE		PROTECTIVE FENCE
O SANITARY MANHOLE					GUARDRAIL
O CLEAN-OUT		TELEPHONE OVER HEAD	FLARED END SECTION		
• POST	tt	TELEPHONE UNDER GROUND	SANITARY MANHOLE		CURB
PEDESTRIAN SIGNAL	t duct bank	TELEPHONE DUCT BANK	© CLEAN-OUT		
► SIGN	ohtv	CABLE TV OVER HEAD	<ul> <li>BARREL</li> </ul>	800	TEMPORARY GRADING PERMIT CONTOUR MAJOR
HAND HOLE	— tv —	CABLE TV UNDER GROUND		799	CONTOUR MINOR
🔅 ORNAMENTAL LIGHT	fo	FIBER OPTIC			
举 FLOOD LIGHT	fo duct bank	FIBER OPTIC DUCT BANK	PUSH BUTTON		WATER EASMENT
③ UNKNOWN MANHOLE		BOUNDARY	HAND HOLE		STORM EASEMENT
<ul> <li>ONKNOWN MANHOLE</li> <li>TELEPHONE MANHOLE</li> </ul>		BUILDING			SANITARY EASEMENT
	<u> </u>	CENTERLINE OF DITCH			R.O.W.
<ul> <li>GAS VALVE</li> </ul>		CENTERLINE/CROWN OF ROAD			LIMITS OF CONSTRUCTION
O GAS VENT	800	CONTOUR MAJOR			LIMIT OF GRADING
	799	CONTOUR MINOR			STONE WALL
🖻 GAS BOX		EDGE OF WATER			DETECTABLE WARNING
		FLOODPLAIN		000000000000000000000000000000000000000	
TRANSFORMER		FLOODFLAIN			ASPHALT
Ø UTILITY POLE	<i>—//////////</i>	FENCE			
C LAMP POLE	:::	GRAVEL			CONCRETE
► GUY ANCHOR		GUARDRAIL			
ο GUY POLE	~~~~~~~~~~~~~~~~~~~~~~~~~~~~~~~~~~~~~~~	STONE WALL			SIDEWALK
MONITORING WELL		R.O.W.			
MAILBOX		TREELINE		$\frown$	
SOIL BORING		WETLAND			TREE (DECIDUOUS)
🛆 TRAVERSE POINT	and and a second and a second	EDGE OF BRUSH			
+ BENCH MARK		HEDGE			
• IRON PIPE		TILDOL		2Mz	
• MON BOX				5113	
	• }	TREE (DECIDUOUS)		$\geq \bullet \geq$	TREE (CONIFEROUS)
				ZWVZ	
				, , , , , , , , , , , , , , , , , , ,	
	N ()				
	2Mz				
	<ul> <li>.</li> <li>.</li> </ul>	TREE (CONIFEROUS)			TREE TO BE REMOVED (DECIDUOUS)
				X	
				JA4	
		SHRUB (DECIDUOUS)			TREE TO BE REMOVED (CONIFEROUS)
		STUMP			
		STUMP			
		R.Z.			
	$\sim$				STUMP TO BE REMOVED
		TREE TO REMAIN & PROTECT (DECIDUOUS, CRITICAL ROOT ZONE (C.R.Z.) = DIAMETE	) ER BREAST HEIGHT (INCHES) X 10	$\sim$	
	کر ک				
		2.2.			
	STV V ZG.	TREE TO REMAIN & PROTECT (CONIFEROUS	(۲		
	$\geq$ $\checkmark$ $\geq$	CRITICAL ROOT ZONE (C.R.Z.) = DIAMETE	ER BREAST HEIGHT (INCHES) X 10		
	4 MM				
	r V 4				




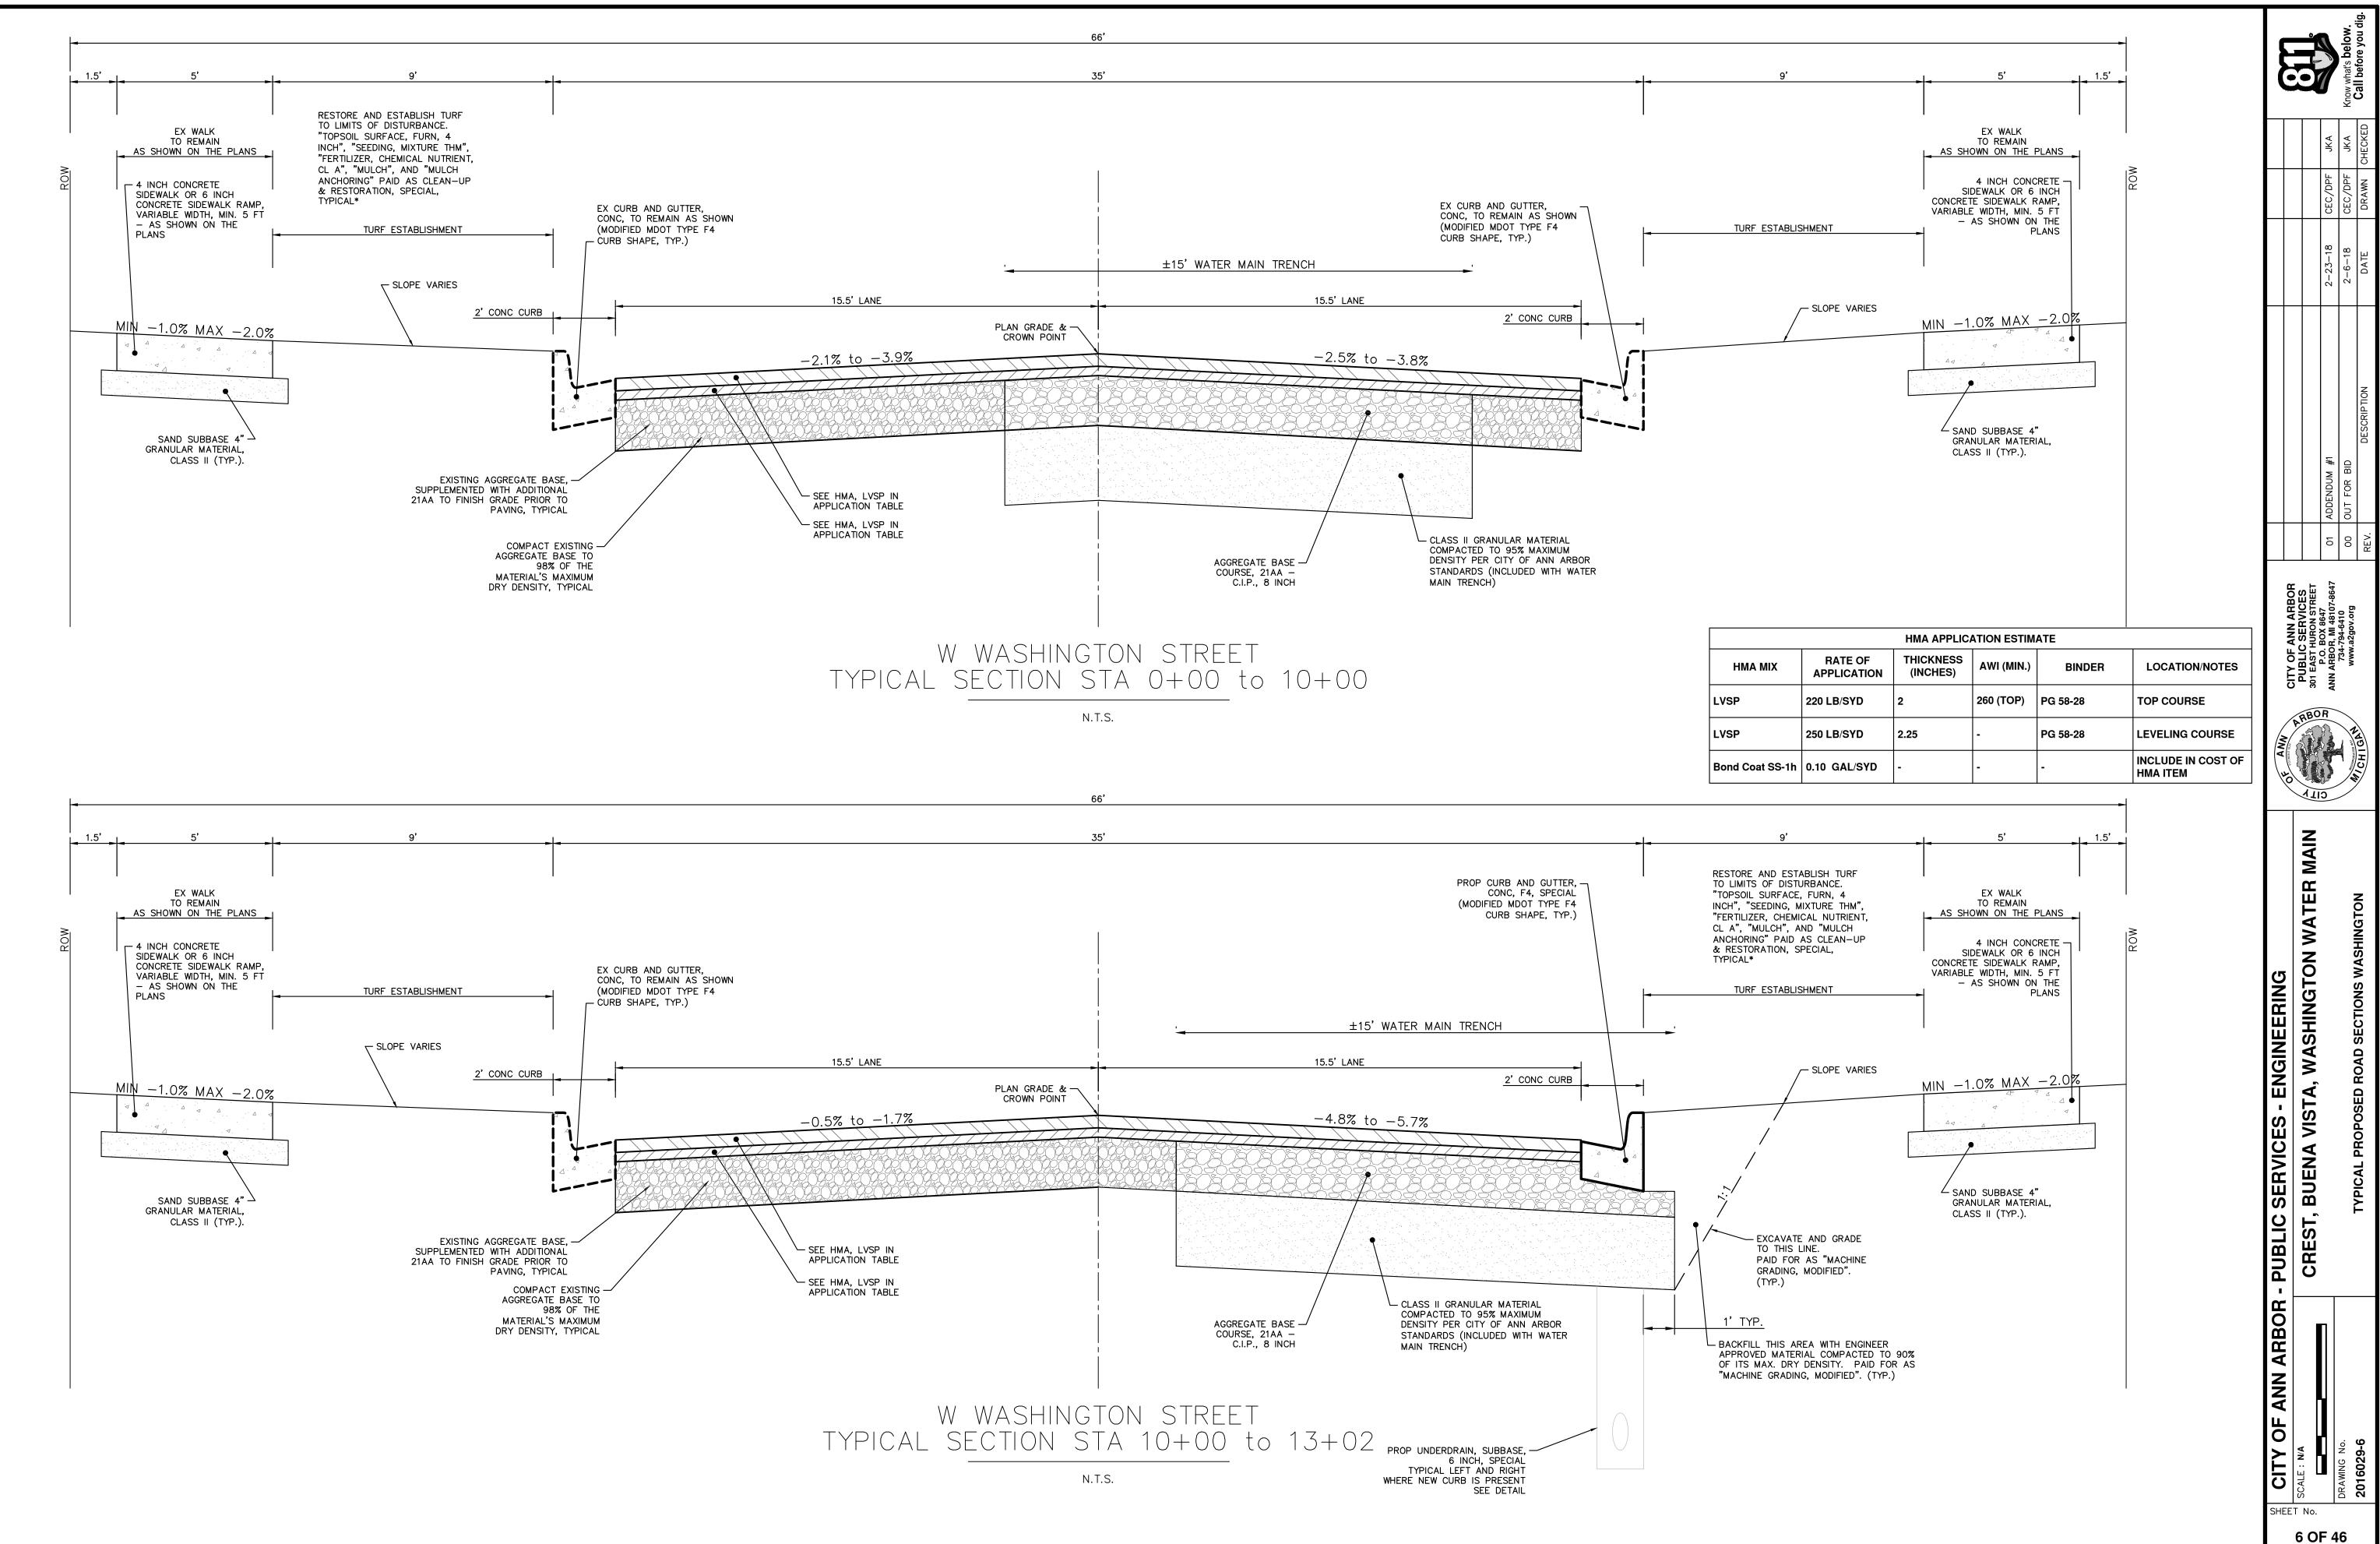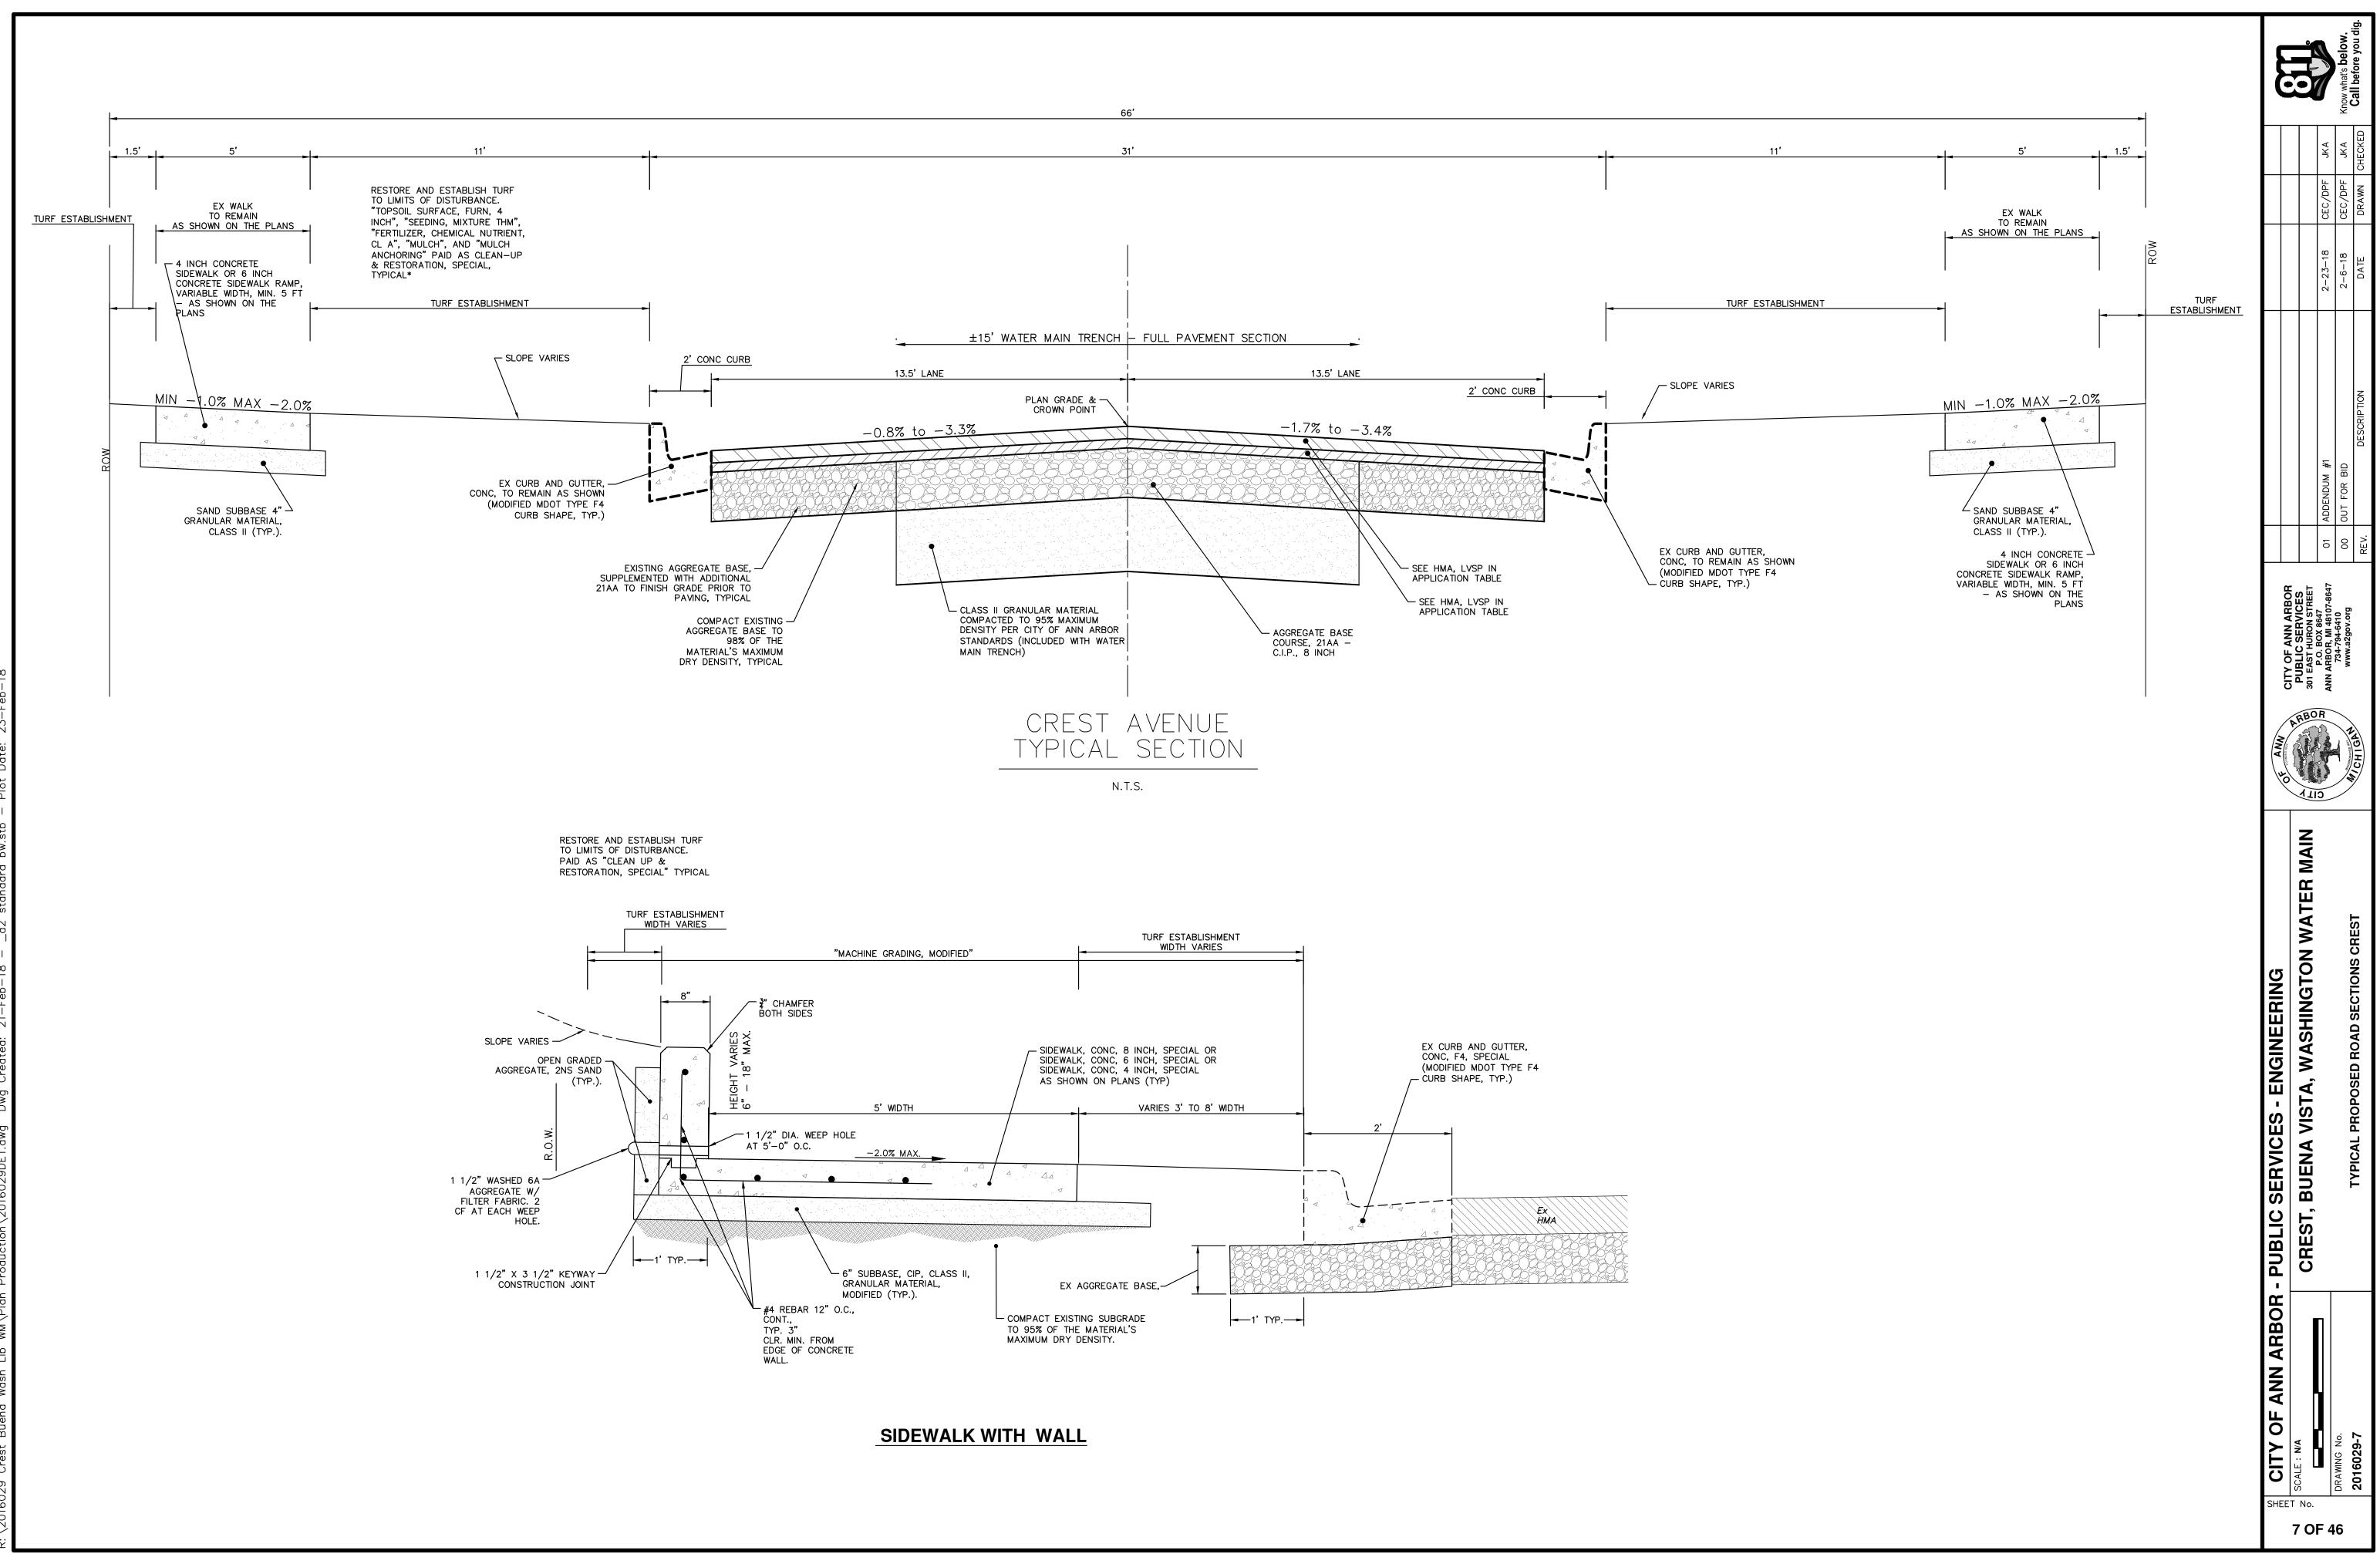
E ' AXU AXU CEC/DPF CEC/DPF ADDENDUM #1 OUT FOR BID 6 0 CITY OF ANN ARBOR PUBLIC SERVICES 301 EAST HURON STREET P.O. BOX 8647 734-794-6410 www.a2gov.org ARBOR ER MAIN CITY OF ANN ARBOR - PUBLIC SERVICES - ENGINEERING SCALE : NA CREST, BUENA VISTA, WASHINGTON WATE LEGEND DRAWING No. 2016029-3 3 OF 46

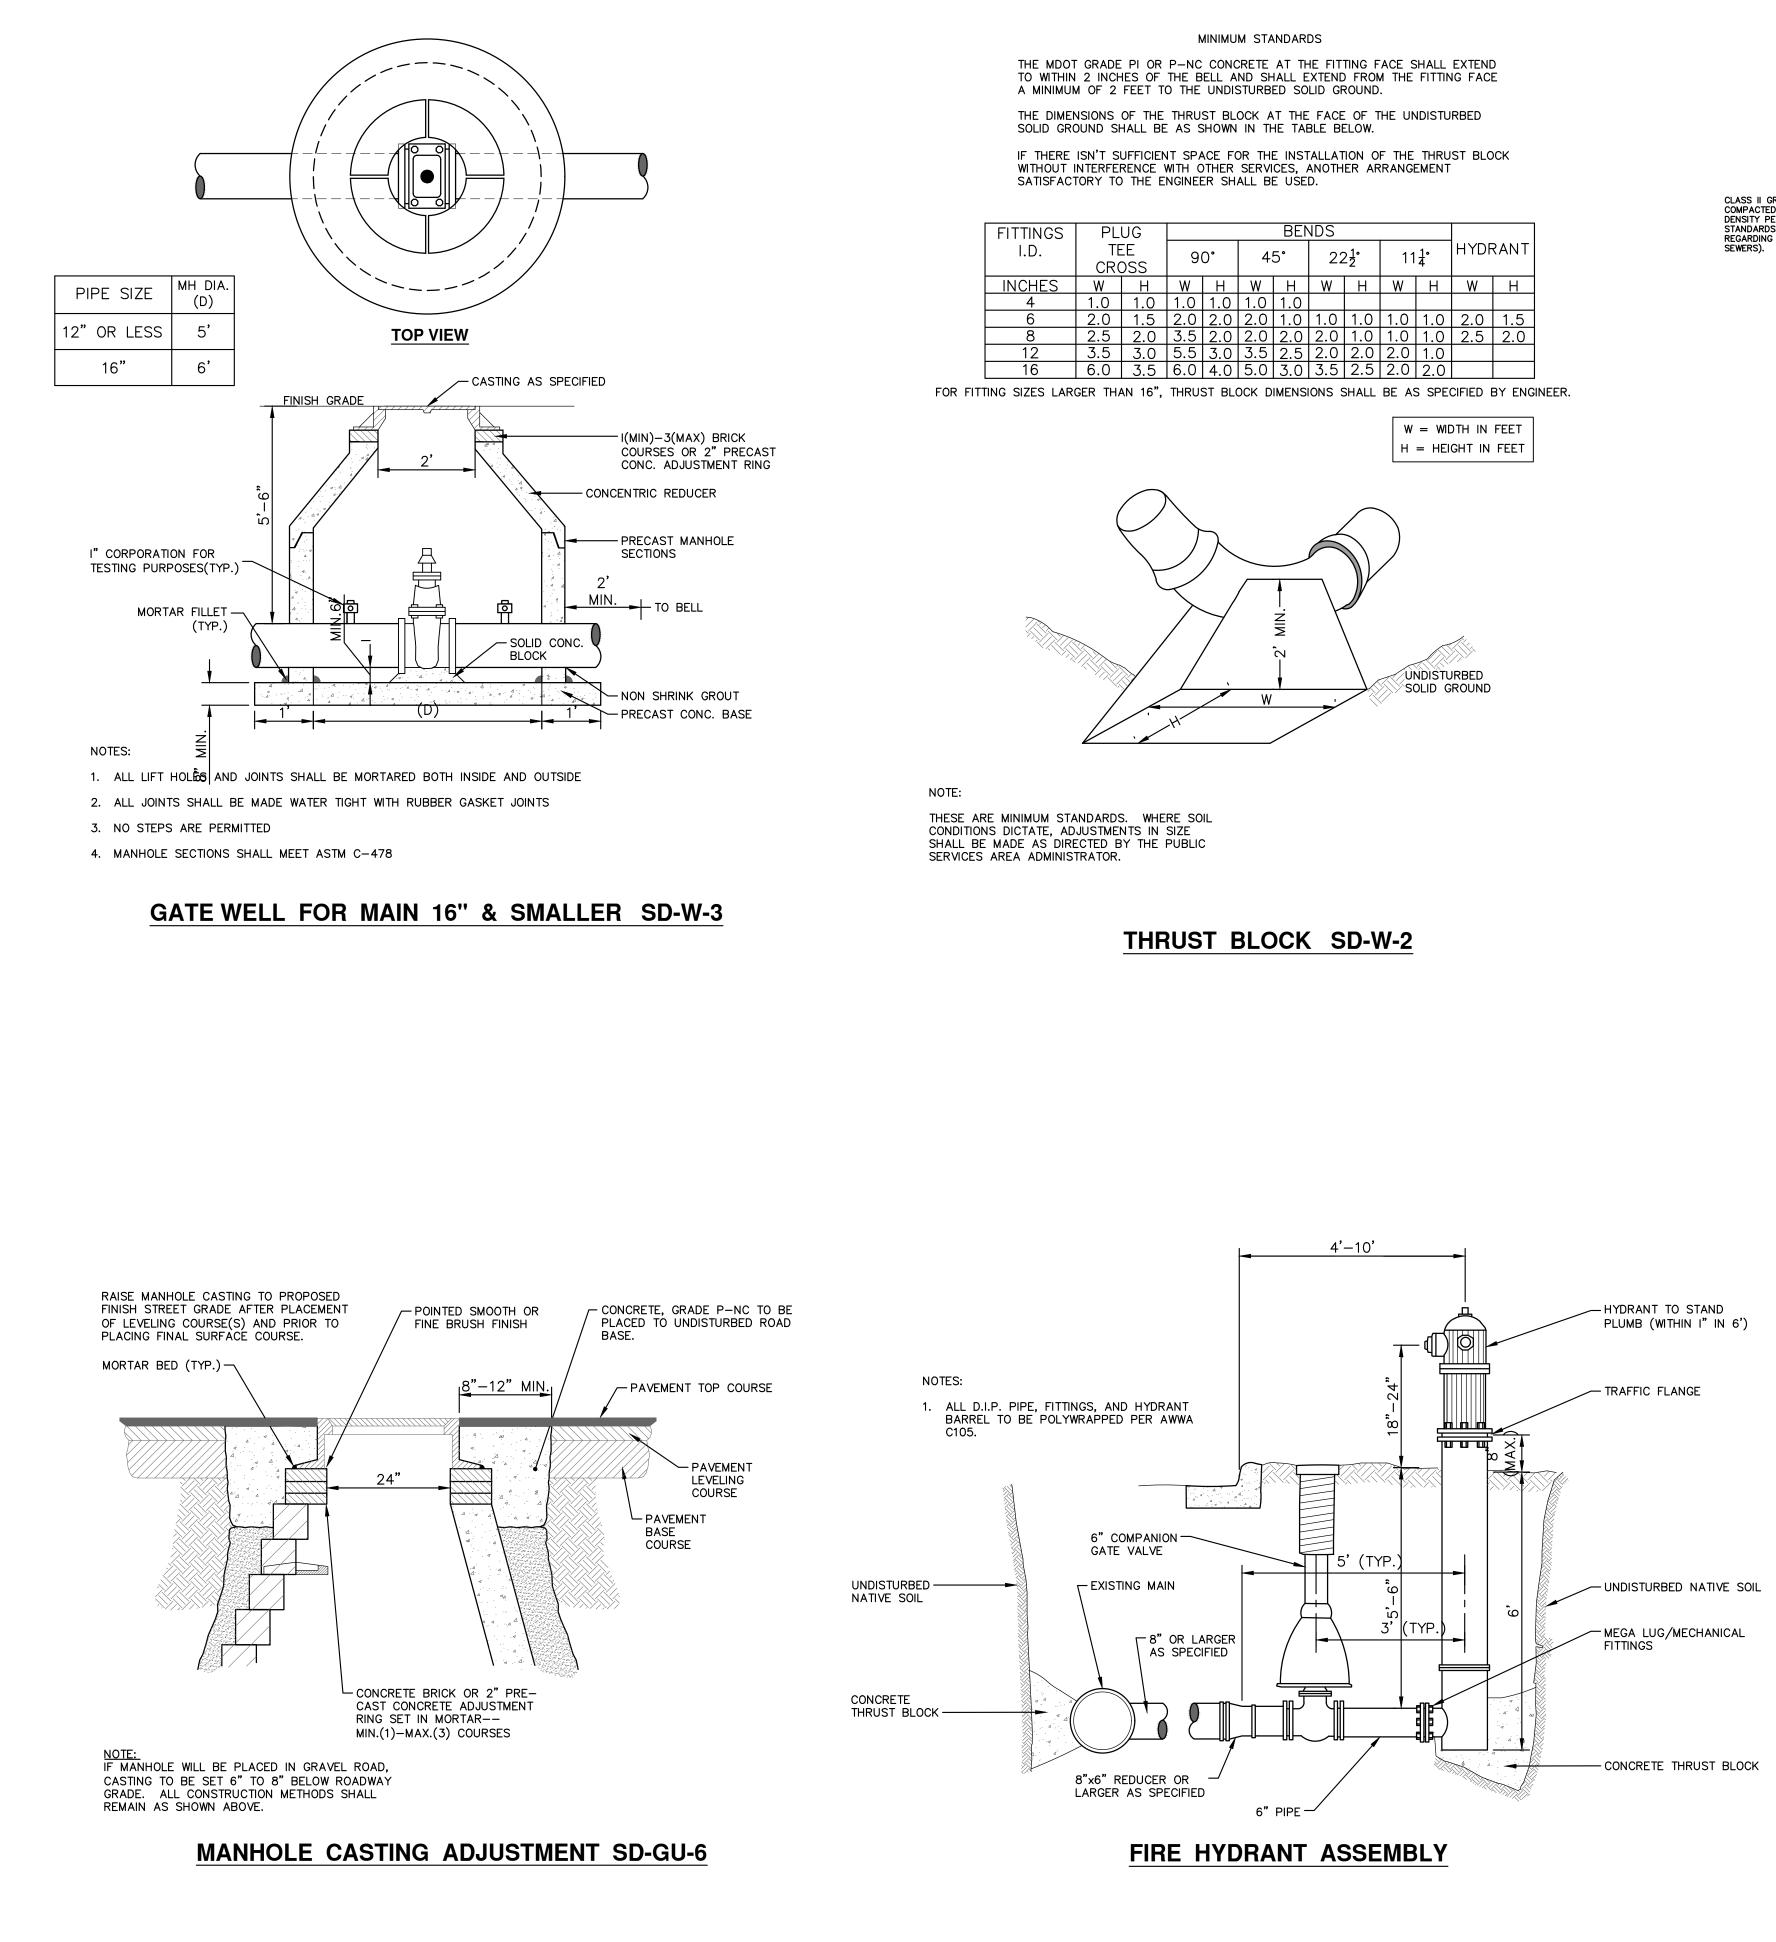













PL	UG				BEN	<b>IDS</b>					
		9	0°	4	5°	22	2 <u>1</u> ° -2	11	<u>1</u> ° 4	HYDF	RANT
W	H	W	H	W	Η	W	H	W	Τ	W	Н
1.0	1.0	1.0	1.0	1.0	1.0						
2.0	1.5	2.0	2.0	2.0	1.0	1.0	1.0	1.0	1.0	2.0	1.5
2.5	2.0	3.5	2.0	2.0	2.0	2.0	1.0	1.0	1.0	2.5	2.0
3.5	3.0	5.5	3.0	3.5	2.5	2.0	2.0	2.0	1.0		
6.0	3.5	6.0	4.0	5.0	3.0	3.5	2.5	2.0	2.0		
	TE CR( W 1.0 2.0 2.5 3.5	1.01.02.01.52.52.03.53.0	TEE         9           CROSS         W           W         H         W           1.0         1.0         1.0           2.0         1.5         2.0           2.5         2.0         3.5           3.5         3.0         5.5	TEE CROSS         90°           W         H         W           1.0         1.0         1.0           2.0         1.5         2.0         2.0           2.5         2.0         3.5         2.0           3.5         3.0         5.5         3.0	TEE CROSS         90°         4           W         H         W         H         W           1.0         1.0         1.0         1.0         1.0           2.0         1.5         2.0         2.0         2.0           2.5         2.0         3.5         2.0         2.0           3.5         3.0         5.5         3.0         3.5	TEE CROSS         90°         45°           W         H         W         H         W           1.0         1.0         1.0         1.0         1.0           2.0         1.5         2.0         2.0         2.0         1.0           2.5         2.0         3.5         2.0         3.5         2.5	$\begin{array}{c c c c c c c c c c c c c c c c c c c $	$\begin{array}{c c c c c c c c c c c c c c c c c c c $	$\begin{array}{c c c c c c c c c c c c c c c c c c c $	$\begin{array}{c c c c c c c c c c c c c c c c c c c $	$\begin{array}{c c c c c c c c c c c c c c c c c c c $




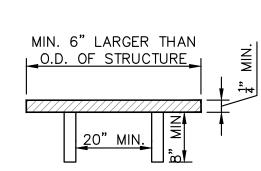
1/4" MIN. THICKNESS AND SUFFICIENT TO CARRY THE CONSTRUCTION LOAD.



SECTION A - A

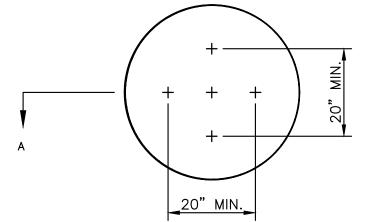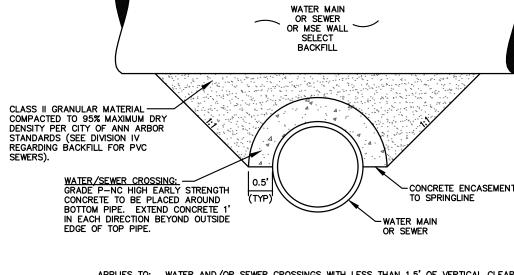
NOTE: PLATE MAY BE CIRCULAR, SQUARE OR RECTANGULAR







APPLIES TO: WATER AND/OR SEWER CROSSINGS WITH LESS THAN 1.5' OF VERTICAL CLEARANCE

# **CONCRETE UTILITY SADDLE**

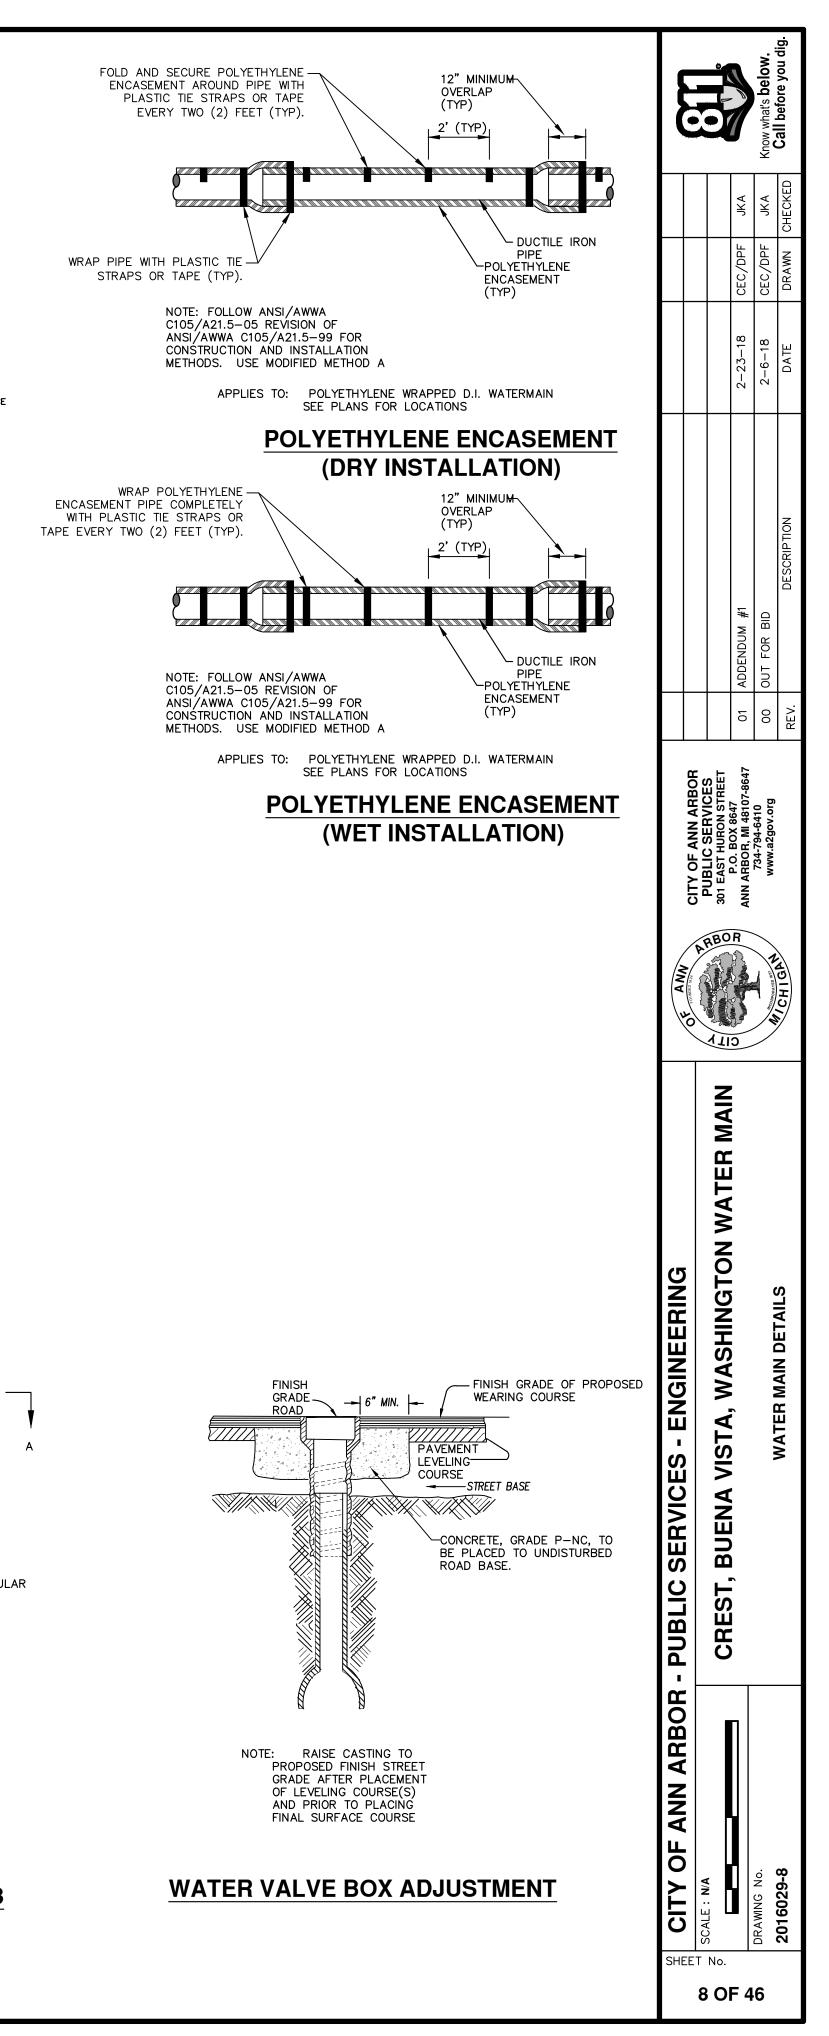

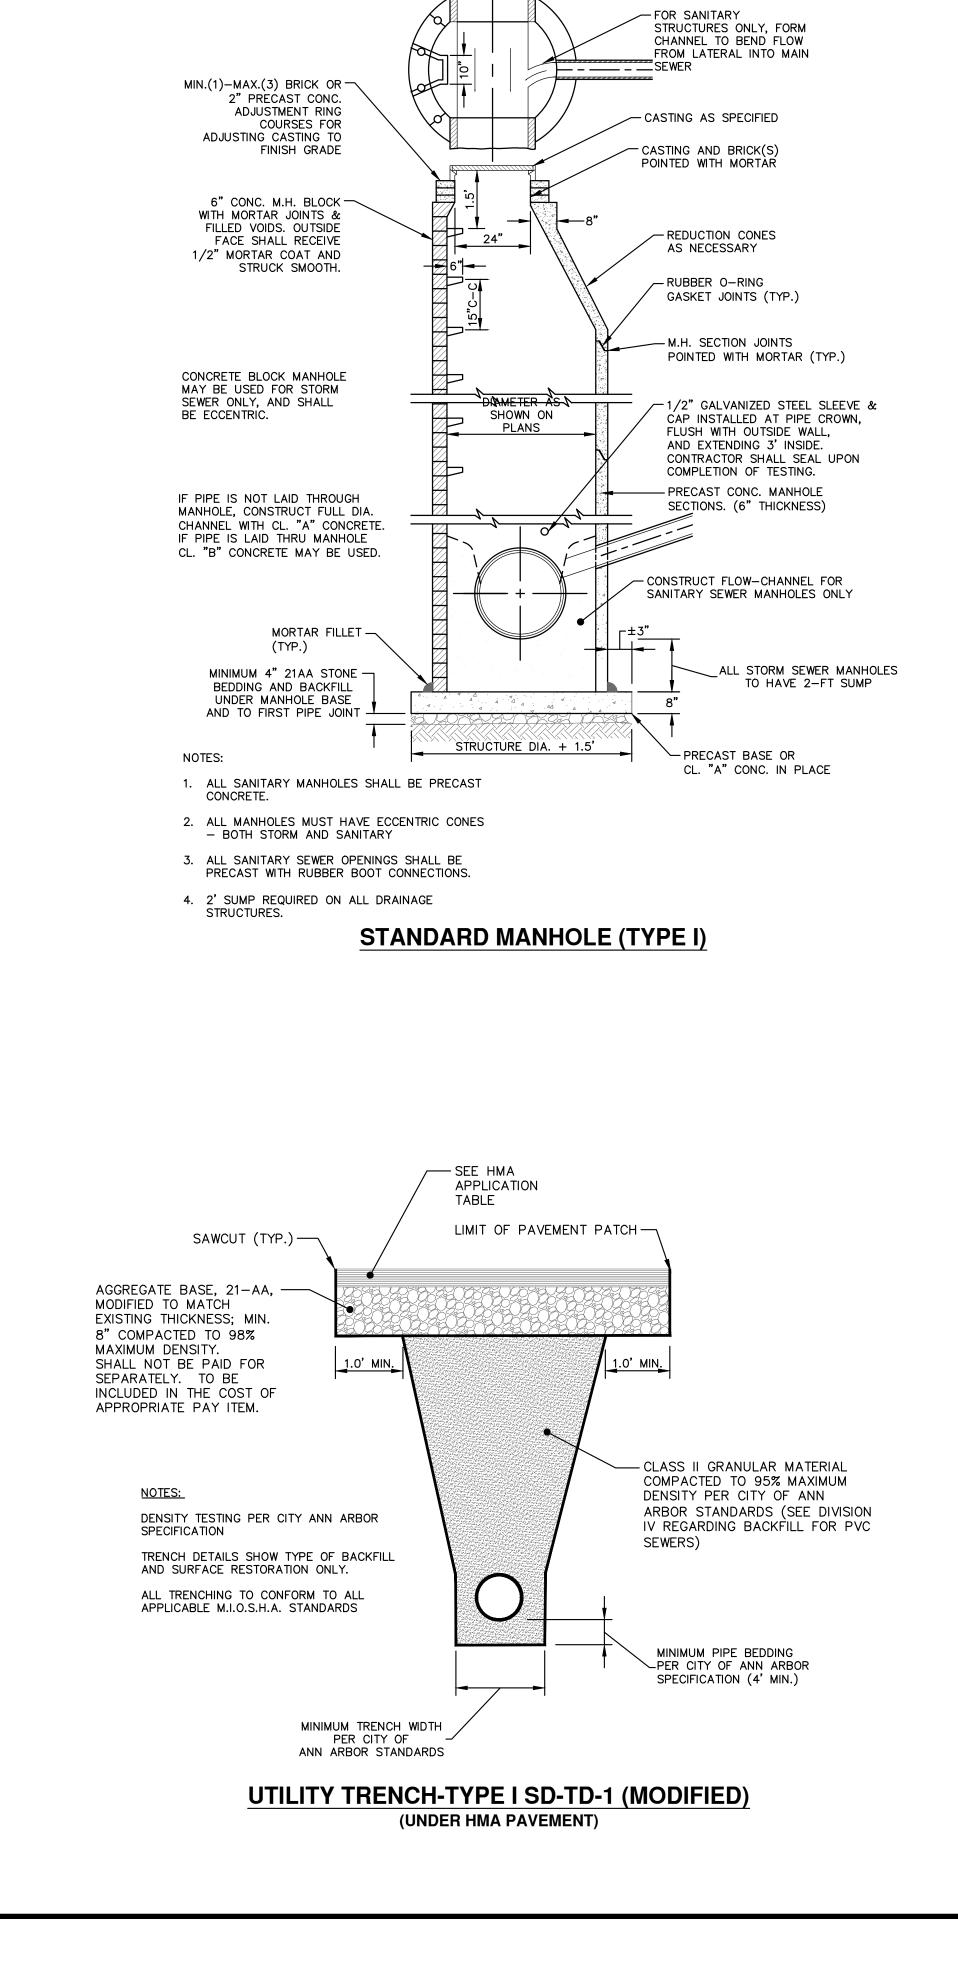


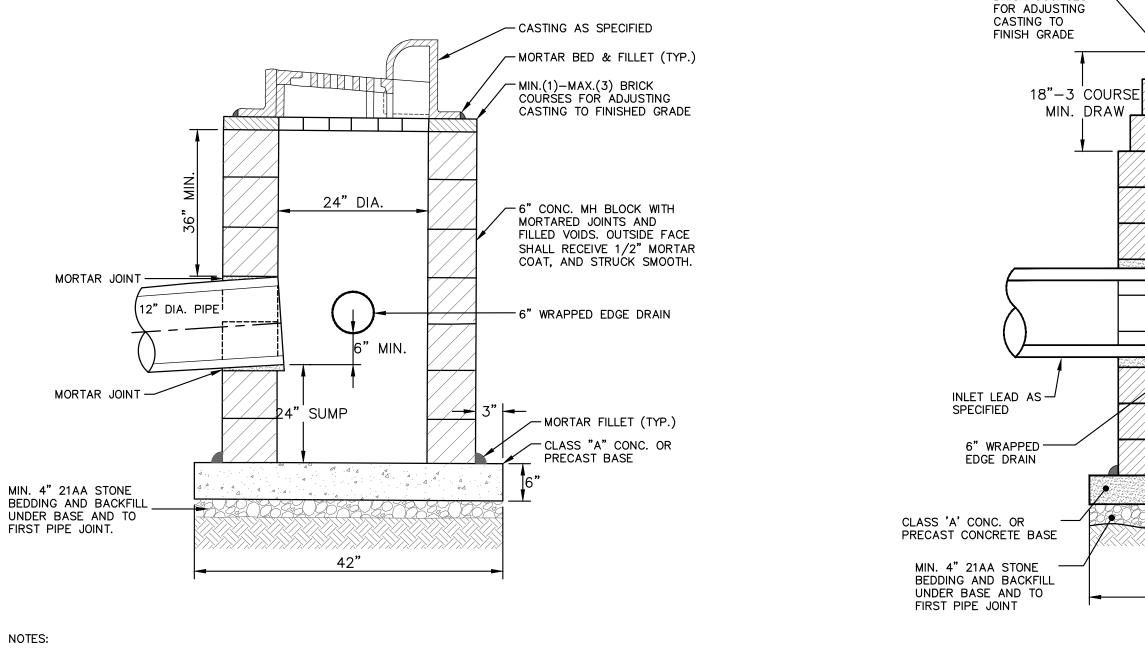

1. MAY BE USED WITH ONLY SINGLE OUTLET PIPE, AND NO INLET PIPE

2. FRONT EDGE OF INLET CASTING SHALL BE FLUSH WITH FRONT EDGE OF GUTTER (EDGE-OF-METAL)

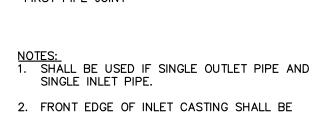
SINGLE INLET STRUCTURE SD-S-10



FLUSH WITH FRONT EDGE OF GUTTER (EDGE-OF-METAL)

MIN.(1) - MAX.(3) -

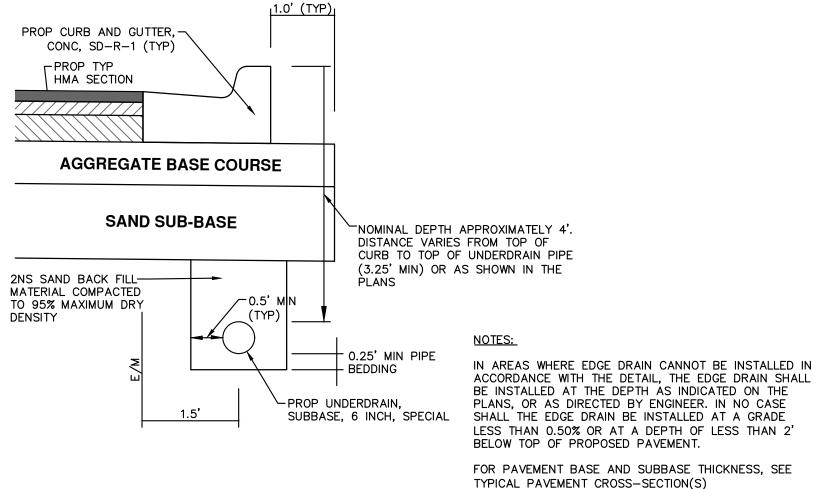BRICK COURSES



BASED ON CITY OF ANN ARBOR STANDARD SD-TD-10 APPLIES TO: HMA PAVEMENT

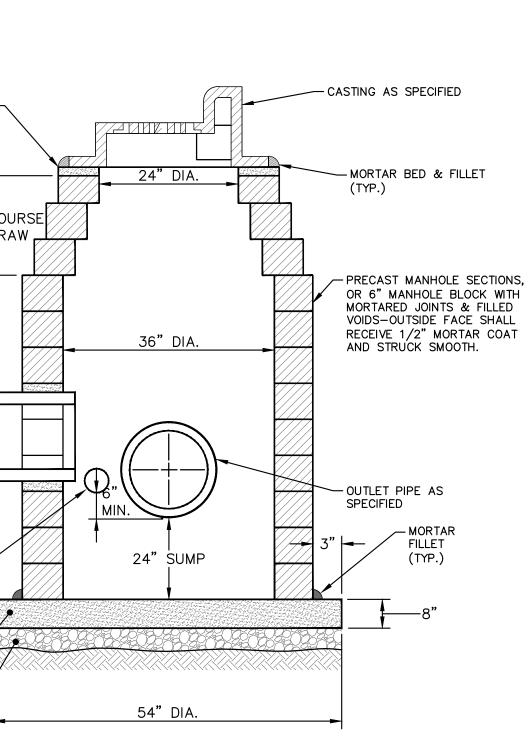
**TRENCH DETAIL FOR UNDER DRAIN** (UNDER HMA PAVEMENT)

PLANS, OR AS DIRECTED BY ENGINEER. IN NO CASE SHALL THE EDGE DRAIN BE INSTALLED AT A GRADE LESS THAN 0.50% OR AT A DEPTH OF LESS THAN 2' BELOW TOP OF PROPOSED PAVEMENT.

FOR PAVEMENT BASE AND SUBBASE THICKNESS, SEE TYPICAL PAVEMENT CROSS-SECTION(S)


TRENCH DETAILS SHOW TYPE OF BACKFILL AND SURFACE RESTORATION ONLY

ALL TRENCHING TO CONFORM TO ALL APPLICABLE M.I.O.S.H.A. STANDARDS




## **INLET-JUNCTION CHAMBER SD-S-9**

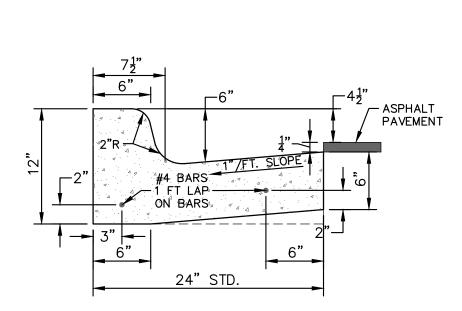
571	E CITY OF ANN ARROR .	N ARBOR - PURLIC SERVICES - ENGINEERING	ANN						
_⊑			O FOUNDER BASE CITY OF ANN ARROR						
9									
No.	No.	CREST RIJENA VISTA WASHINGTON WATER MAIN	E 201 EAST HURON STREET						
F 4			O P.O. BOX 8647 ANN ARBOR. MI 48107-8647		01 ADDENDUM #1	2-23-18	CEC/DPF	JKA	
16	DRAWING No.		734-794-6410		00 OUT FOR BID	2-6-18	CEC/DPF	JKA	Know what's below.
	2016029-9	STORM SEWER AND TRENCH DETAILS	M/CHIGAN WWW.4290V.019	REV.	DESCRIPTION	DATE	DRAWN	DRAWN CHECKED	Call before you dig.



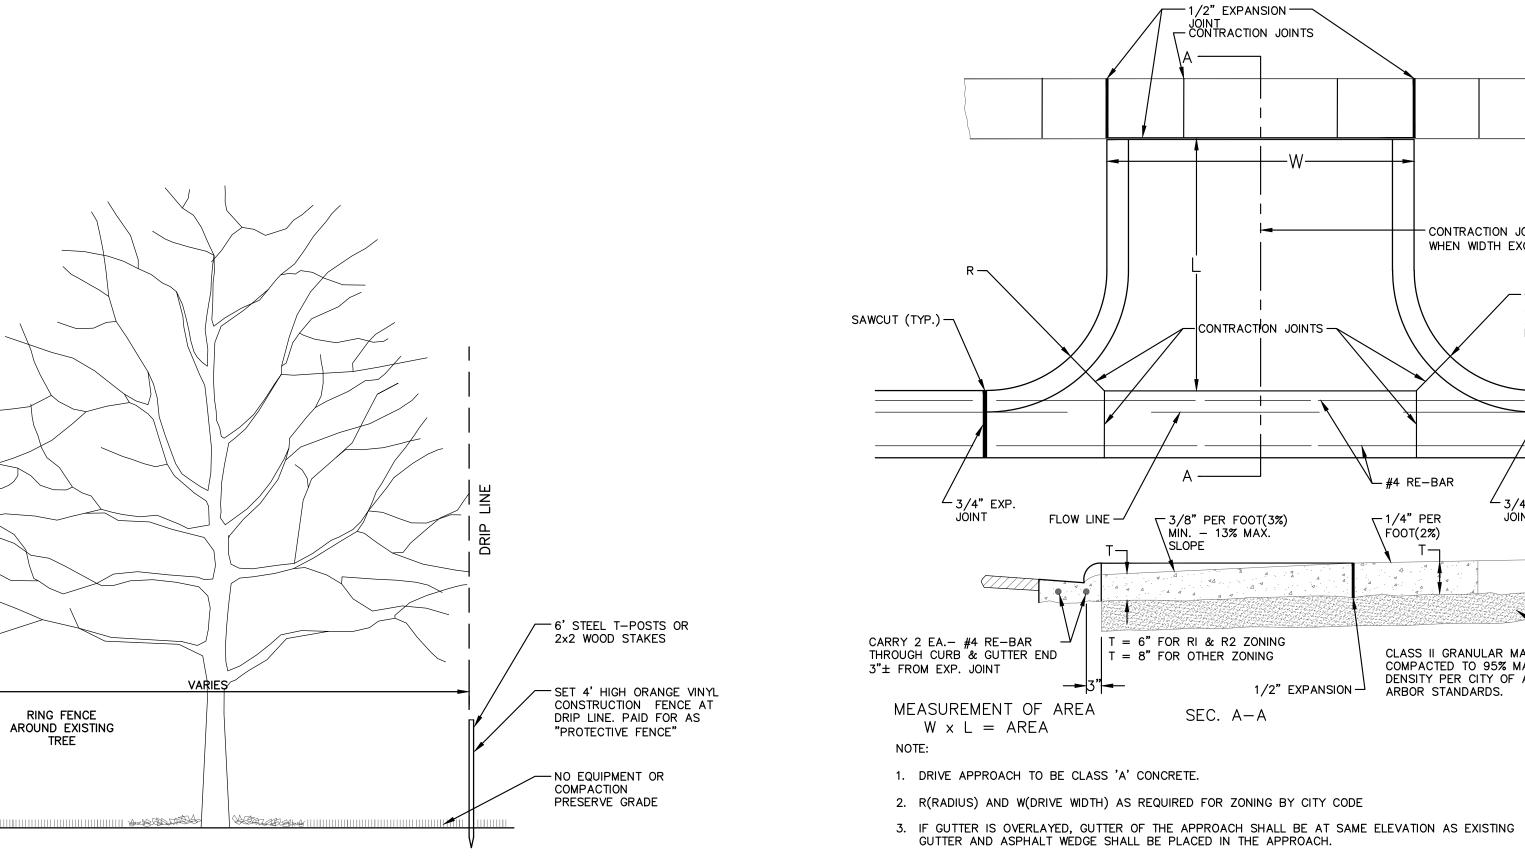CURB AND GUTTER, CONC, DET F4, SPECIAL NO SCALE



# TREE PROTECTION DETAIL

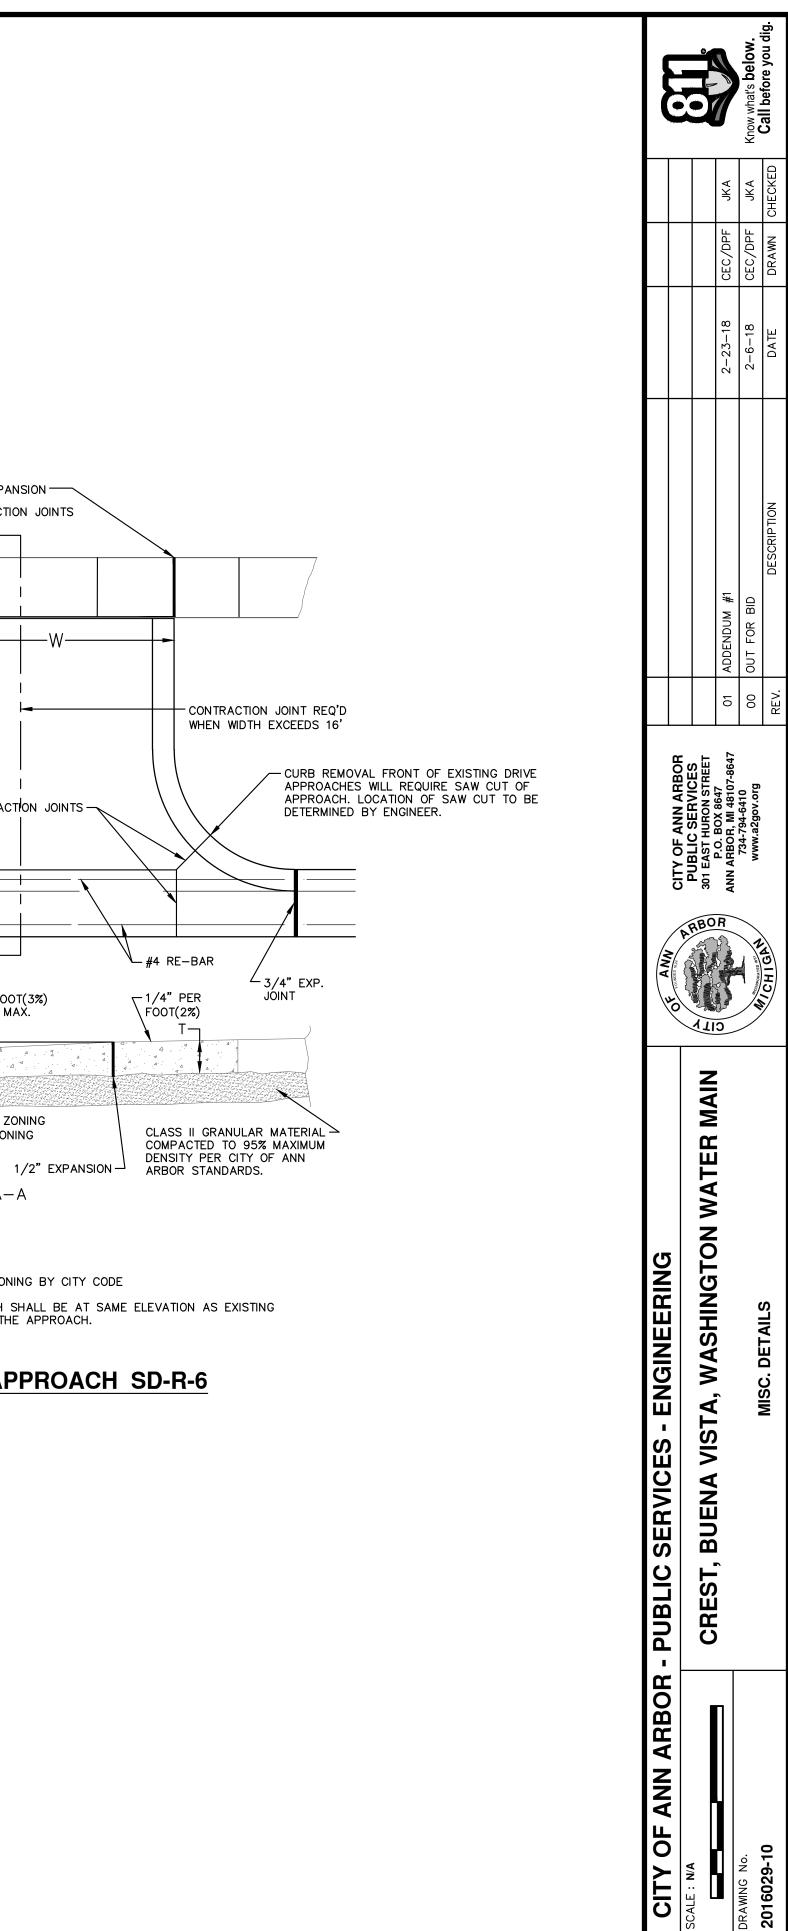

# TYPE 'M' DRIVE APPROACH SD-R-6

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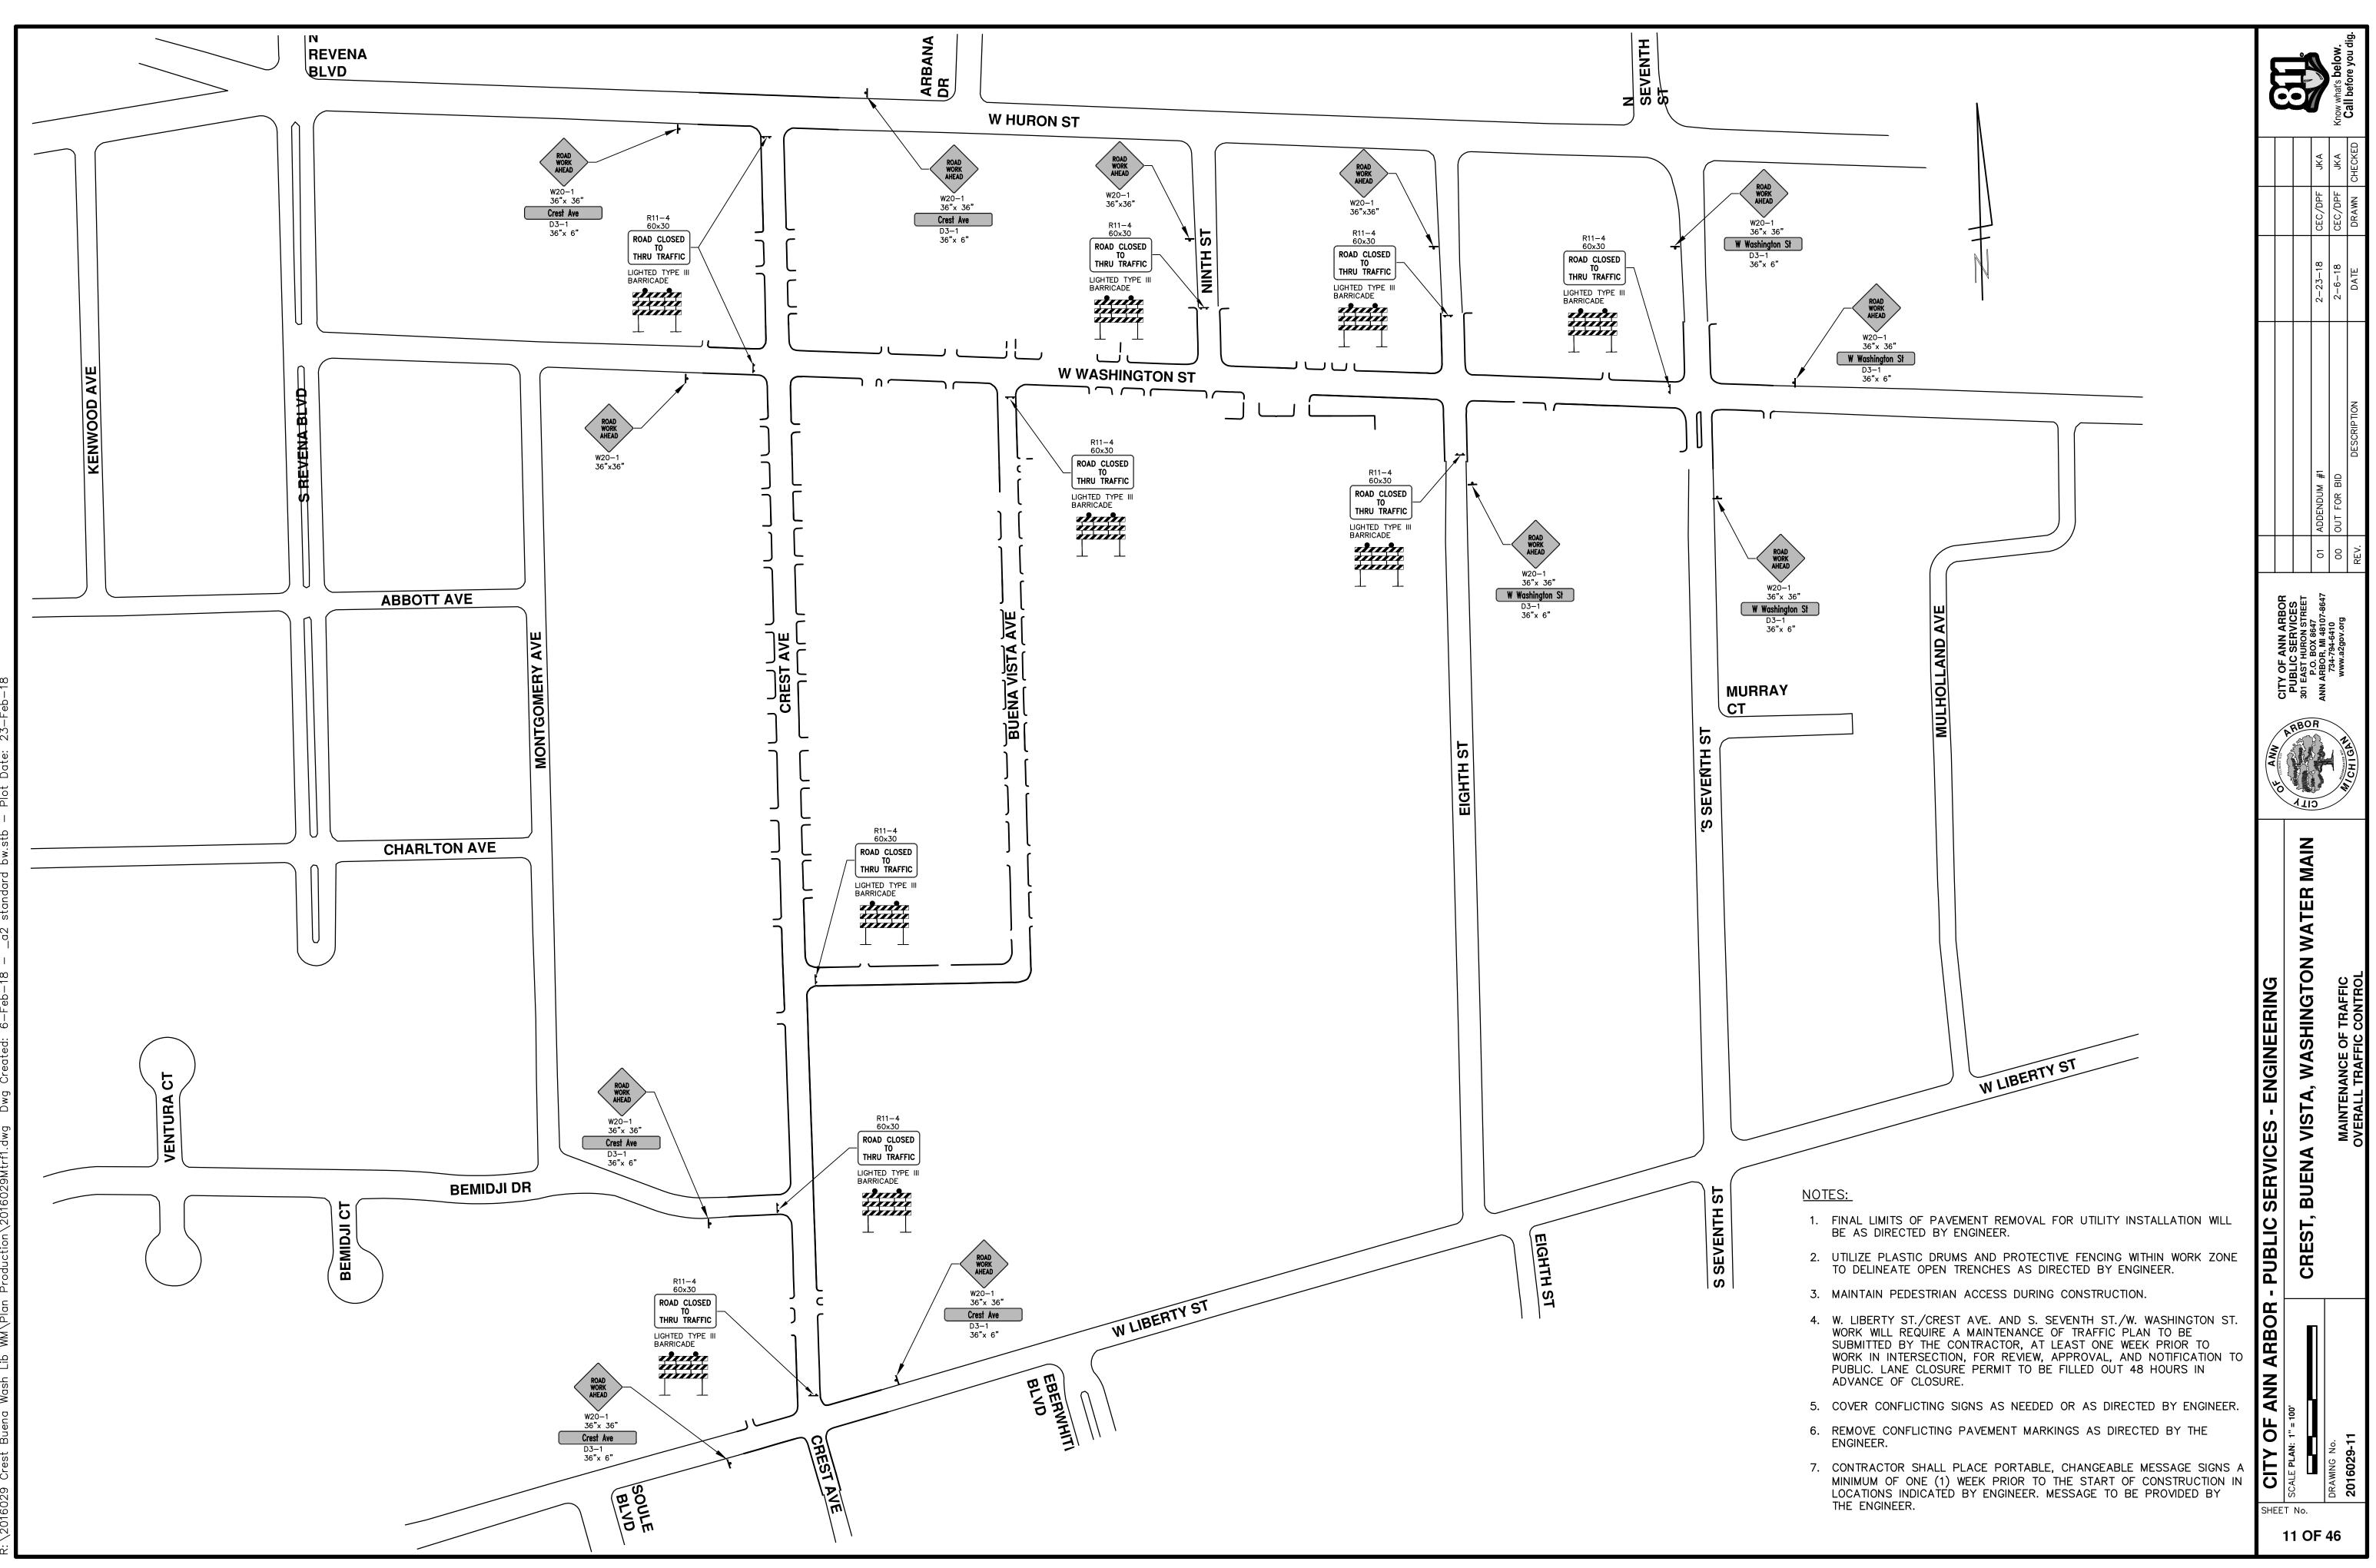
4

SHEET No. 10 OF 46

0

MING 6029

DRAV 201



DETOUR CONSTRUCTION NOTES:

- 1. DEPENDING ON THE DETOUR ROUTE THAT IS PUT IN PLACE, CONFLICTING SIGNS MAY BE PRESENT. PRIOR TO THE ORDERING OR PLACEMENT OF ANY SIGNS, MEET WITH THE ENGINEER TO VERIFY THE EXACT NUMBER AND LOCATION OF THE SIGNS TO BE PLACED. THE ENGINEER AND THE CONTRACTOR SHALL WORK TOGETHER TO ELIMINATE ALL CONFLICTS.
- 2. THE CITY RESERVES THE RIGHT TO ORDER ADDITIONAL SIGNS AND PLACE THEM INTO SERVICE IN ORDER TO SAFELY MAINTAIN TRAFFIC. ADJUSTMENTS IN THE UNIT PRICE FOR THESE ITEMS OF WORK SHALL NOT BE ALLOWED FOR THESE OCCURRENCES.
- 3. THE CONTRACTOR SHALL COORDINATE HIS OPERATIONS WITH THOSE OF THE CITY OF ANN ARBOR'S SIGNS AND SIGNALS UNIT DURING THE COURSE OF THE DETOUR ROUTE ESTABLISHMENT TO EFFECTIVELY AND SAFELY MAINTAIN TRAFFIC. DO NOT ERECT ANY SIGNS UNTIL ITS LOCATION AND PROPOSED DATE OF INSTALLATION IS APPROVED BY THE ENGINEER.
- 4. THE DETOUR IS TO BE IN PLACE DURING THE S. SEVENTH STREET WATER MAIN CONNECTION AND THE CIVIL DEFENSE WATER MAIN ABANDONMENT. AS DIRECTED BY THE ENGINEER, THE CONTRACTOR WILL CLOSE AND DETOUR SOUTH BOUND S. SEVENTH STREET TRAFFIC. SEE DETAILED SPECIFICATION FOR MAINTAINING TRAFFIC AND FOR DETAILS ON CONSTRUCTION STAGING, SEQUENCING, CLOSURE AND DETOUR LIMITATIONS, AND OTHER DETAILS.
- 5. REFERENCE THE DETAILED SPECIFICATION FOR MAINTAINING TRAFFIC AND FOR ADDITIONAL PROJECT REQUIREMENTS. THE CONTRACTOR'S ATTENTION IS SPECIFICALLY DIRECTED TO THE SECTION OF SAME SPECIAL PROVISION REGARDING COORDINATION WITH THE CITY SIGNS AND SIGNALS UNIT FOR MODIFICATIONS TO TRAFFIC SIGNALS FOR THE DETOUR.

SOUTH BOUND S. SEVENTH ST.

D3-1

M4-9S

30"x24"

D3-1

M4-9R

30"x24'

D3-1

M4-9L

30"x24'

D3-1

M4-9L (MOD)

30"x24"

D3-1

M4-9R

| (MOD) | 30"x24"

D3-1

M4-8A

24"x18"

R11-2

48"x30"

M4-10L

48"x18"

D3-1

W20-2

36"x36"

D3-1

W20-1

36"x36"

R11-4

R3-2

BARRICADE, TYPE III, HIGH

INTENSITY, LIGHTED - 10 EACH

SIGN, PORTABLE, CHANGEABLE

MESSAGE – 2 EACH

VERIFY EXACT QUANTITY

AND LOCATION WITH

ENGINEER PRIOR

TO ORDERING

24"x24"

60"x30"

SIGN

SB S SEVENTH ST

DETOUR

1

SB S SEVENTH ST

DETOUR

\_\_\_\_

SB S SEVENTH ST

DETOUR

SB S SEVENTH ST

DETOUR

(SBSSEVENTHST)

DETOUR

SB S SEVENTH ST

END

DETOUR

ROAD

CLOSED

DETOUR

SB S SEVENTH ST

DETOUR

AHEAD

S SEVENTH ST

ROAD WORK AHEAD

ROAD CLOSED

TO

THRU TRAFFIC

NUMBER QUANTIT

3

.3

4

4

4

2

2

2

3

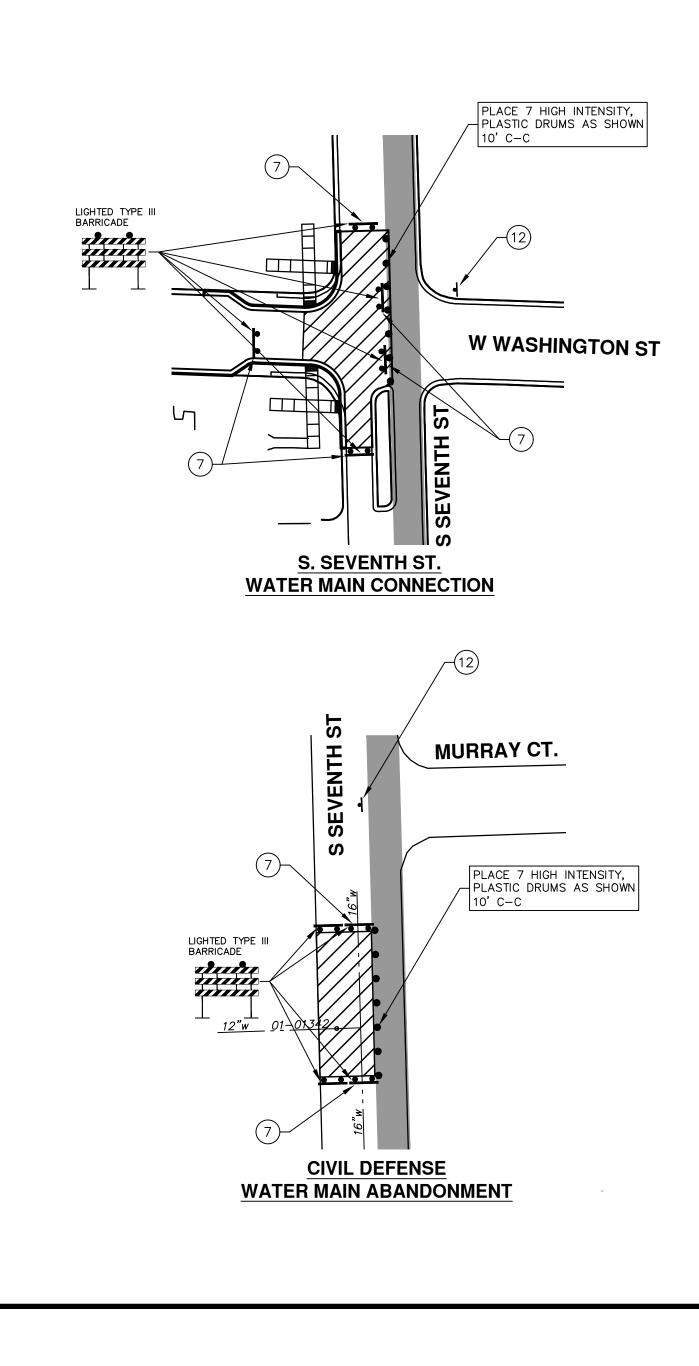
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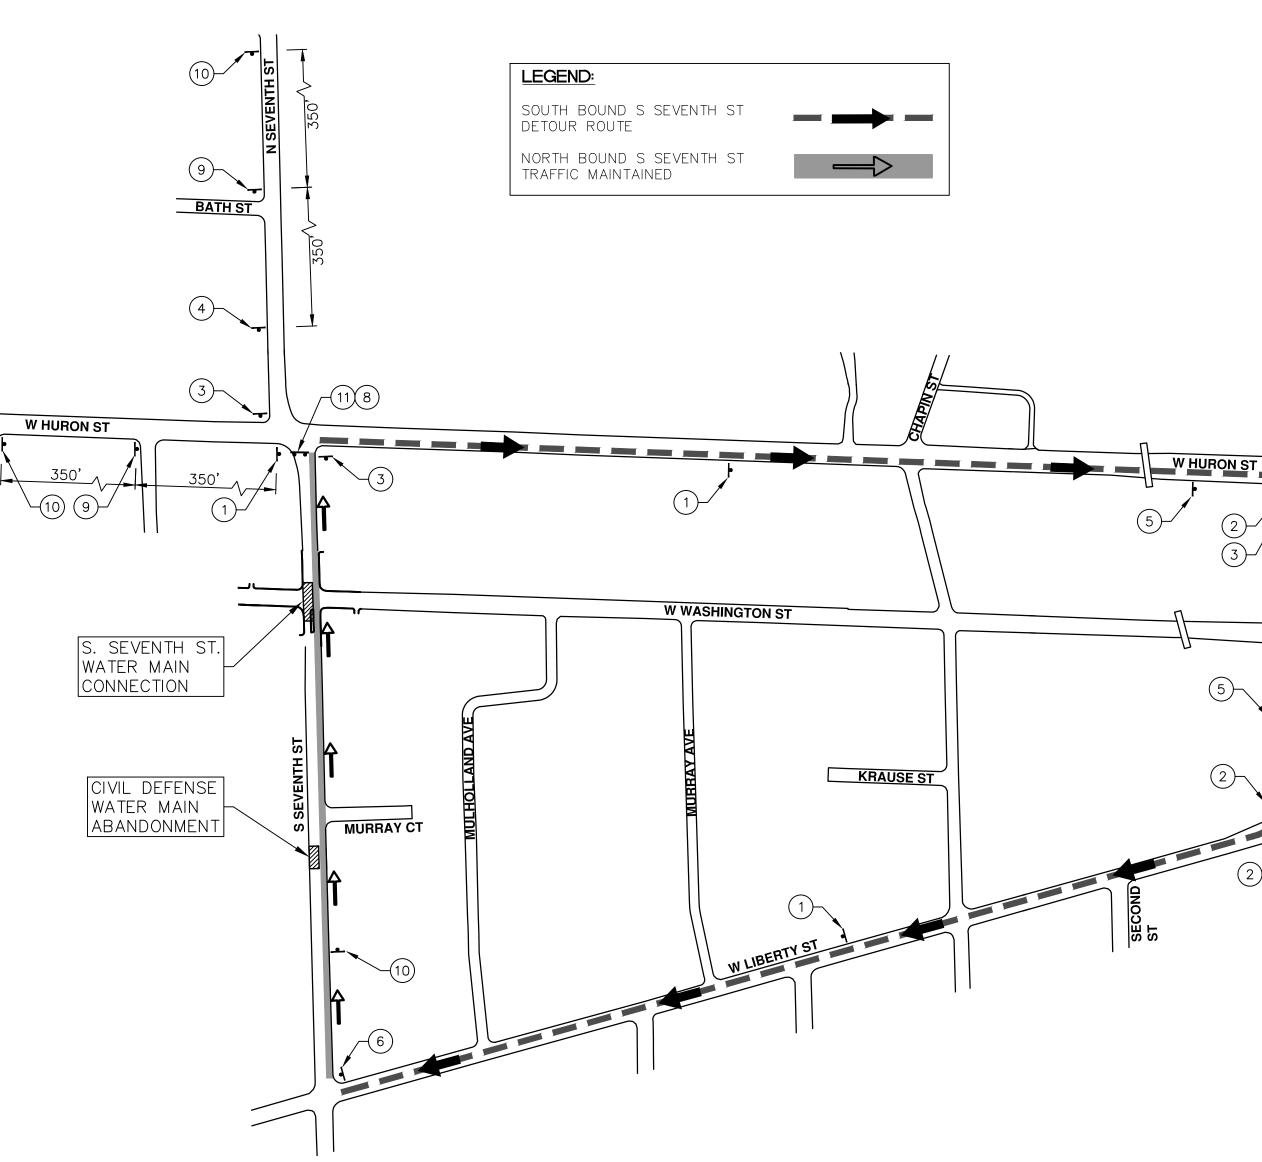
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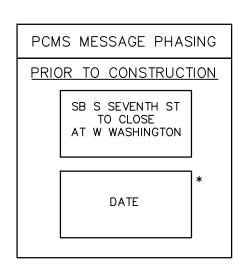
4

2

- 6. THE CONTRACTOR SHALL FURNISH, ERECT, AND MAINTAIN SIGNS AS SHOWN ON THE PLANS OR OTHERWISE DIRECTED BY THE ENGINEER.
- 7. CONSTRUCTION WARNING SIGNS SHALL HAVE AN ORANGE, HIGH-INTENSITY, REFLECTORIZED BACKGROUND.
- 8. SIGNS SHALL CONFORM TO THE 2011 MICHIGAN MANUAL OF UNIFORM TRAFFIC CONTROL DEVICES.
- 9. THE CONTRACTOR SHALL DRIVE ALL SIGNS INTO EXPOSED GROUND OR INSERT INTO A BORED HOLE IN PAVEMENT AS NECESSARY TO PERMANENTLY SECURE. ALL HOLES IN PAVEMENT SHALL BE FILLED WITH ENGINEER-APPROVED MORTAR WHEN THE SIGN IS REMOVED AND NO LONGER NEEDED. COSTS FOR THIS WORK SHALL BE INCLUDED IN THE PAY ITEM "MINOR TRAFFIC DEVICES, MAX \$15,000."
- 10. ADVANCE WARNING SIGNS SHALL BE PROVIDED WITH TWO (2) TYPE A FLASHING LIGHTS AND ONE (1) DAY-GLOW ORANGE FLAG.
- 11. CITY TO BE NOTIFIED A MINIMUM OF 7 DAYS PRIOR TO IMPLEMENTING NORTH BOUND S. SEVENTH STREET DETOUR. MESSAGE BOARDS TO BE PLACED 7 DAYS PRIOR TO IMPLEMENTATION OF DETOUR.

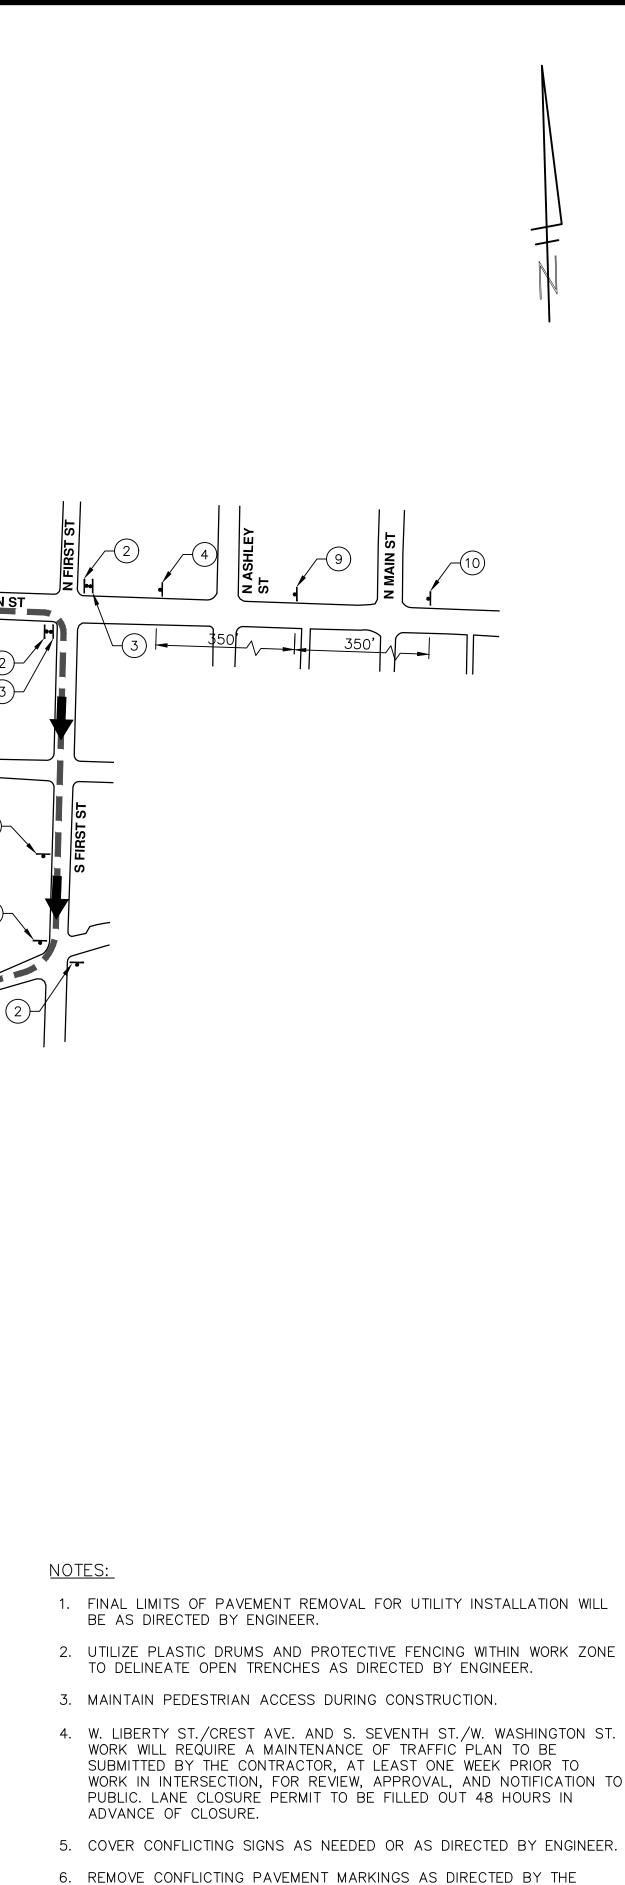







NOTE: PCMS LOCATIONS AND MESSAGES WILL BE AS DIRECTED BY THE ENGINEER. TO BE PLACED ONE WEEK PRIOR TO CONSTRUCTION.


\* THE CONTRACTOR SHALL PLACE THE APPROPRIATE DATE AS APPROVED BY THE ENGINEER.



- ENGINEER.
  7. CONTRACTOR SHALL PLACE PORTABLE, CHANGEABLE MESSAGE SIGNS A MINIMUM OF ONE (1) WEEK DRIOP TO THE START OF CONSTRUCTION IN
- MINIMUM OF ONE (1) WEEK PRIOR TO THE START OF CONSTRUCTION IN LOCATIONS INDICATED BY ENGINEER. MESSAGE TO BE PROVIDED BY THE ENGINEER.

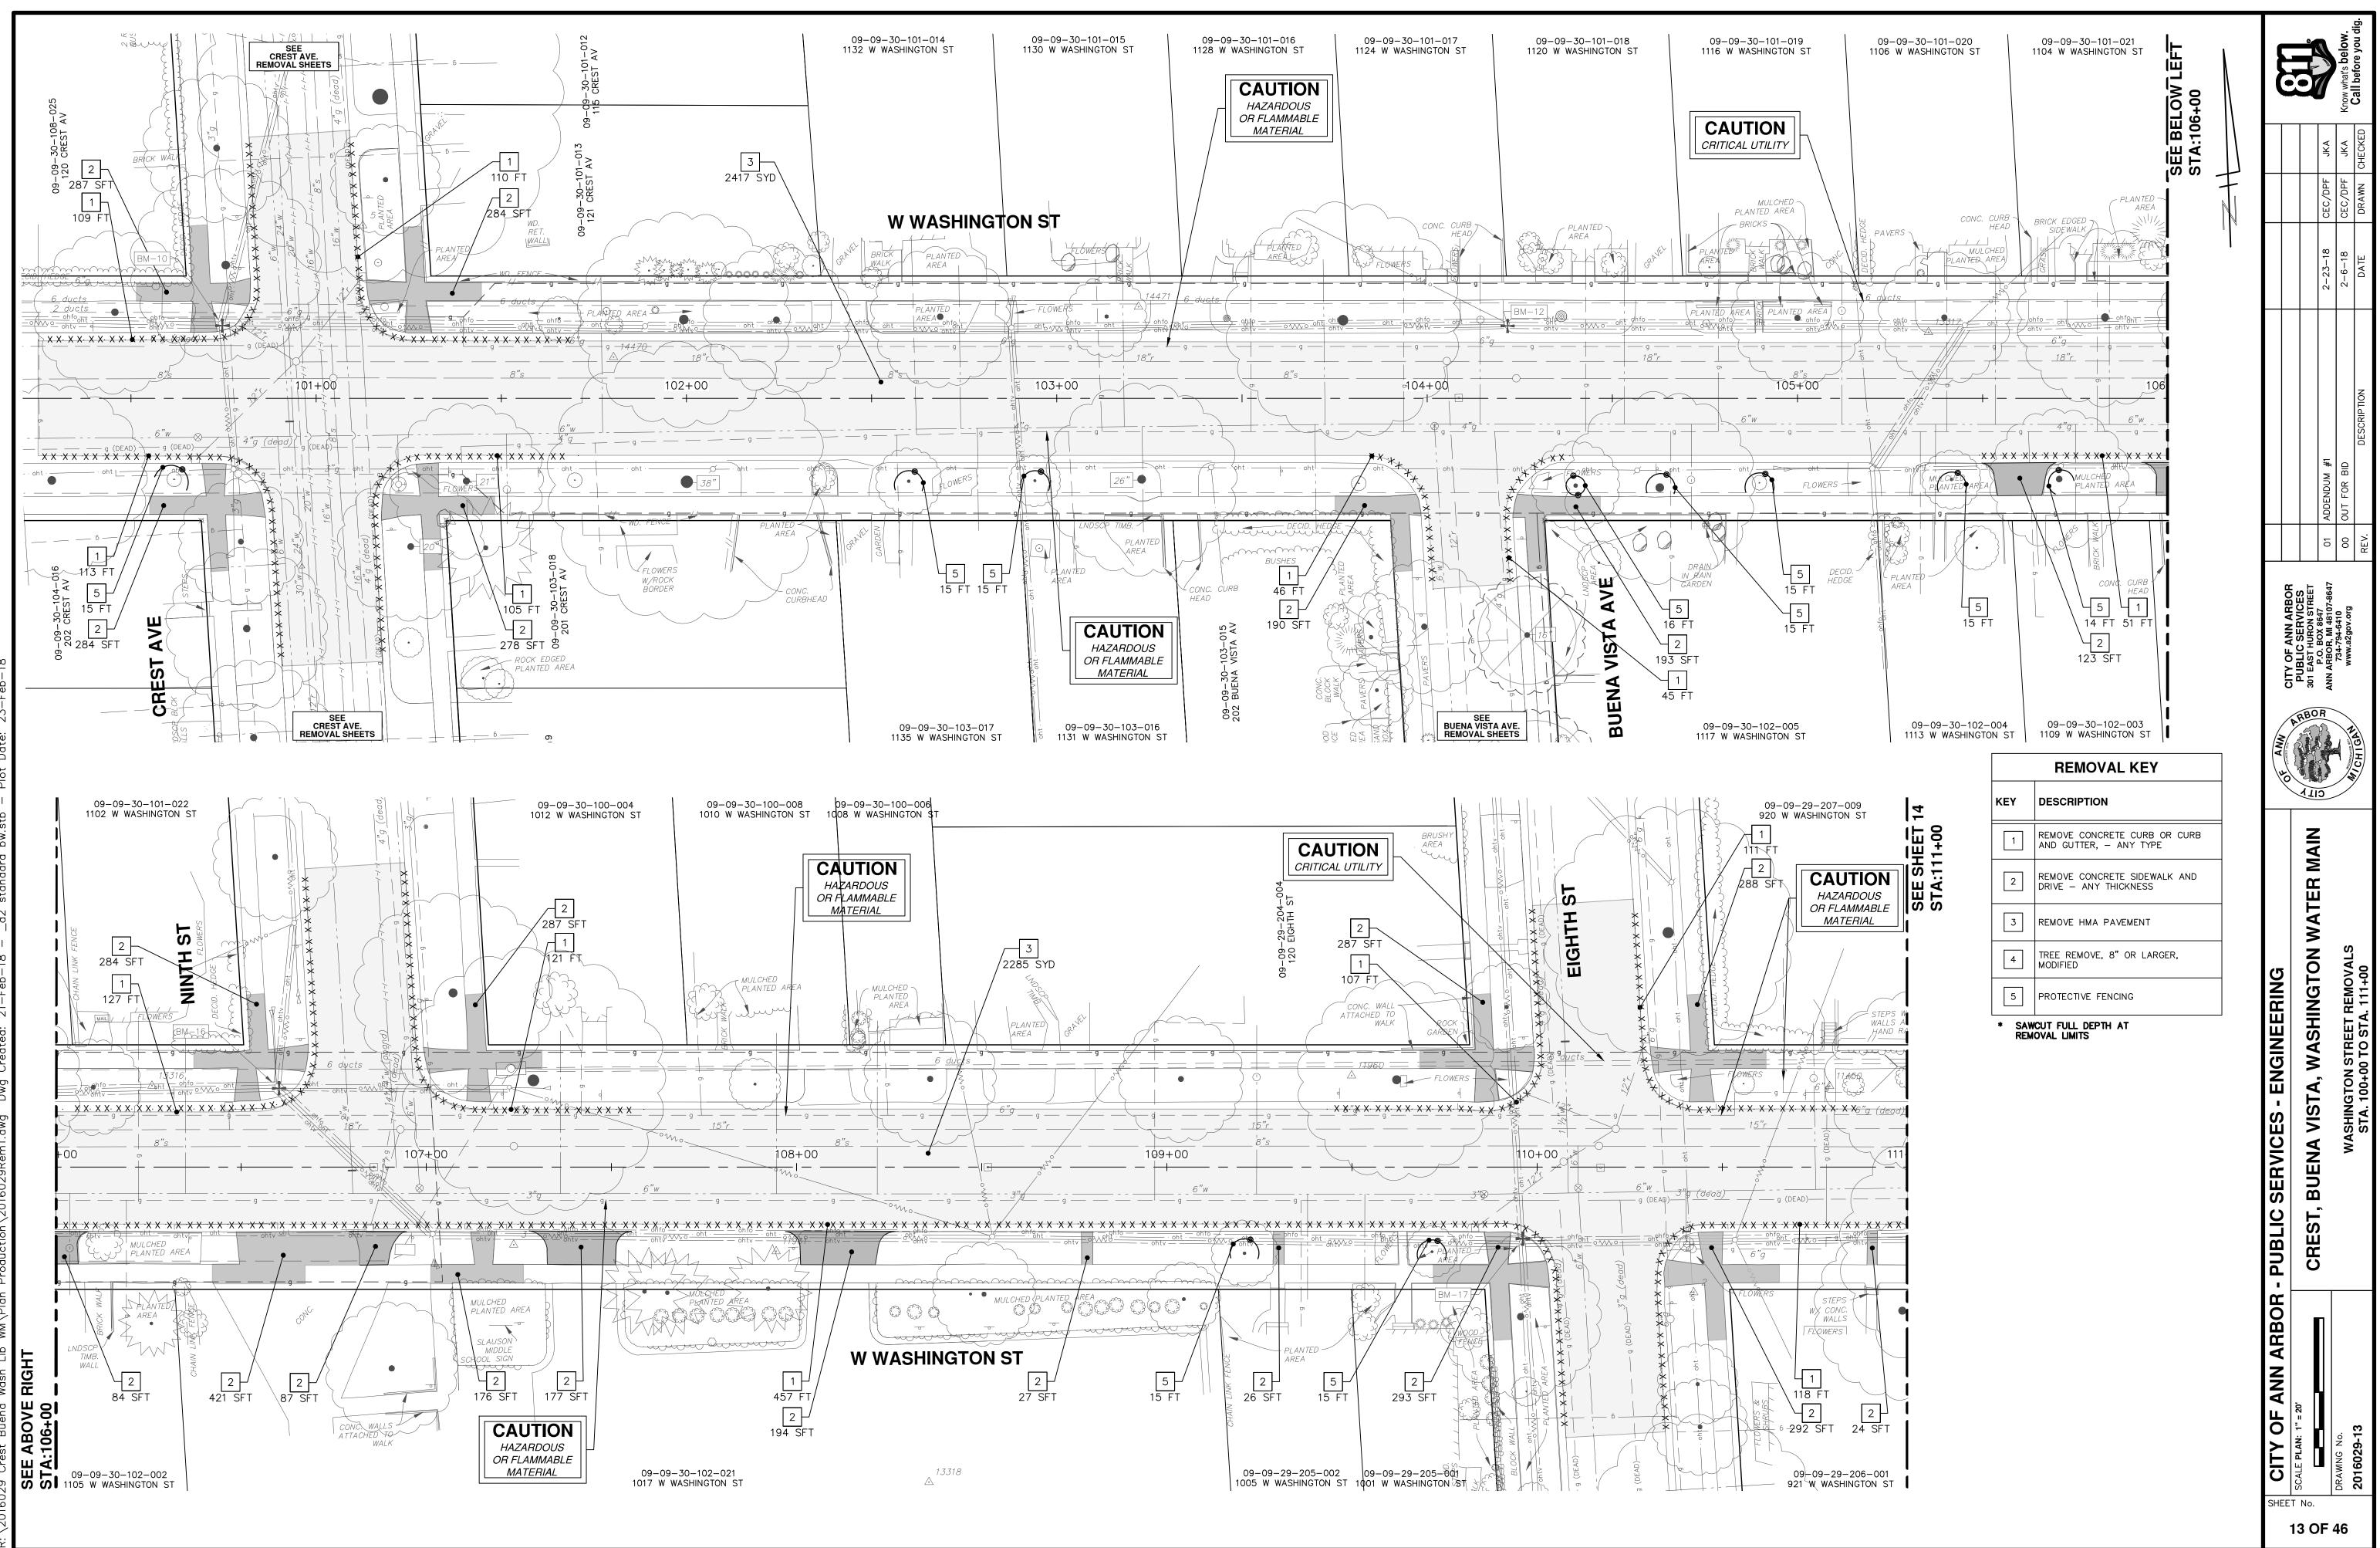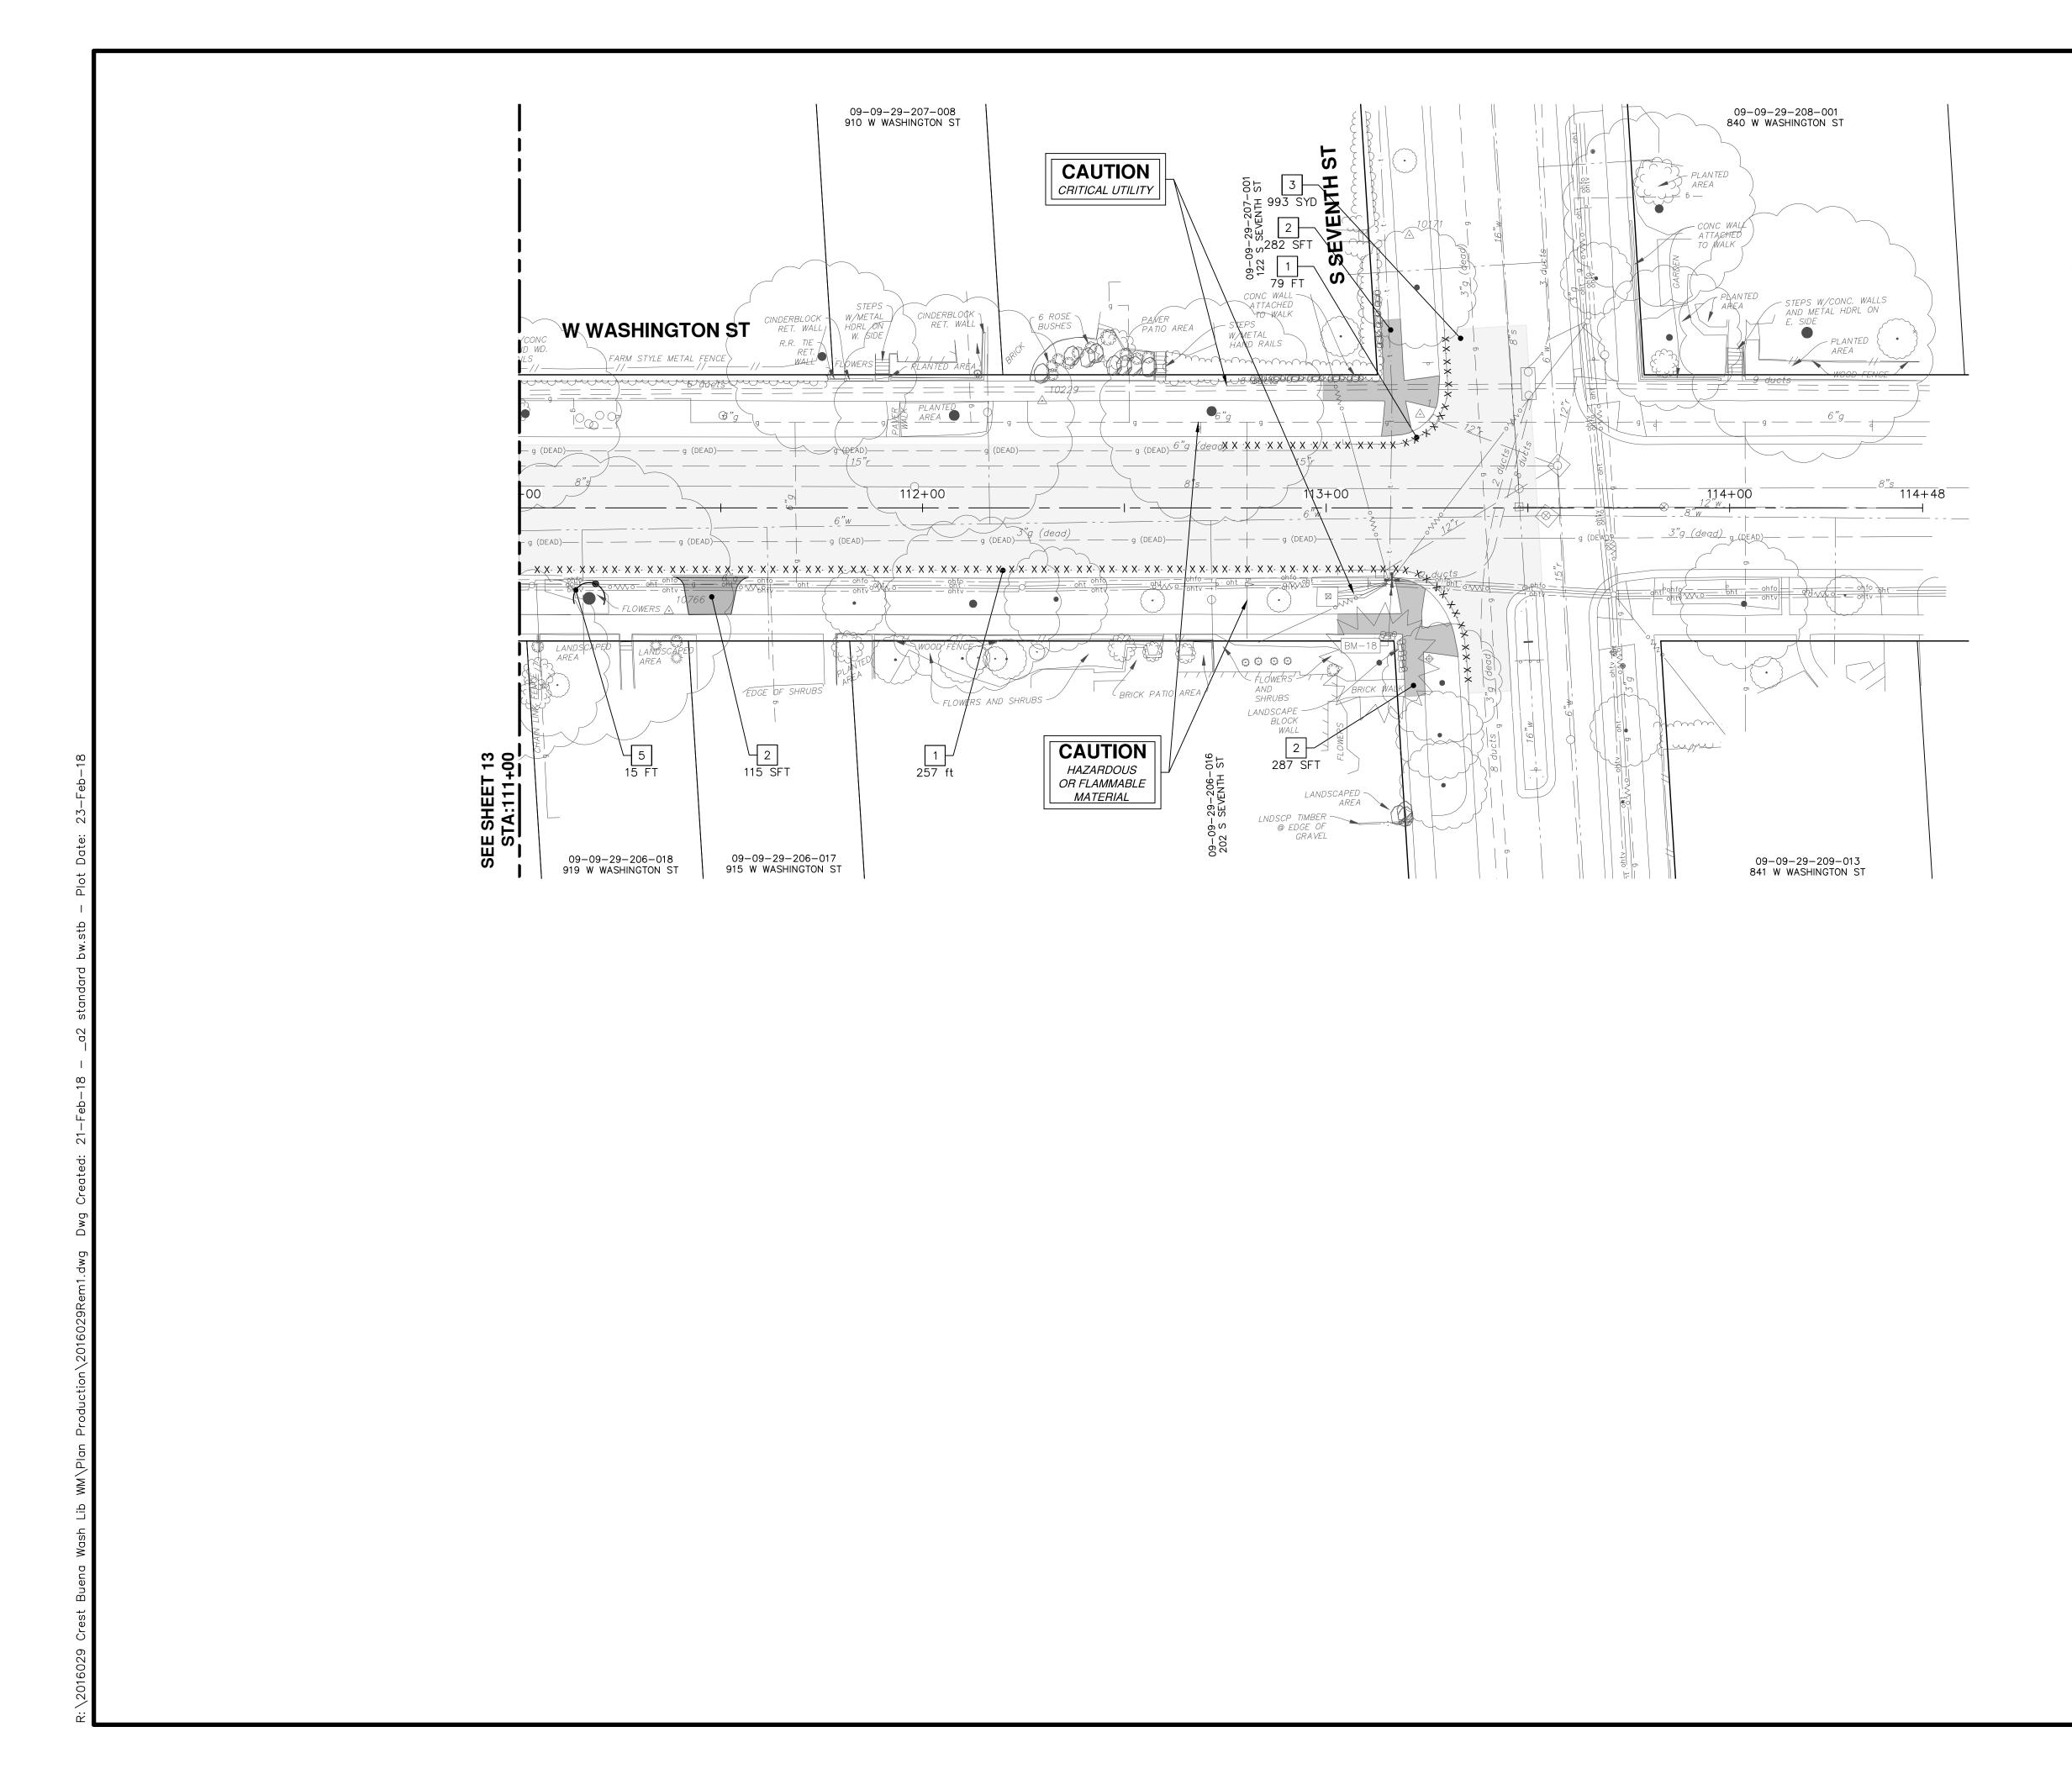
E E AIN Σ С 3 WASHINGTON - ENGINEERING OF TR. VISTA, N N SERVICES BUENA PUBLIC EST. CR 0 Ô AR ANN ≻ บ 20R/ SHEET No. 12 OF 46






	REMOVAL KEY
KEY	DESCRIPTION
1	REMOVE CONCRETE CURB OR CURB AND GUTTER, - ANY TYPE
2	REMOVE CONCRETE SIDEWALK AND DRIVE – ANY THICKNESS
3	REMOVE HMA PAVEMENT
4	TREE REMOVE, 8" OR LARGER, MODIFIED
5	PROTECTIVE FENCING
	CUT FULL DEPTH AT OVAL LIMITS


	CITY OF ANN ARBOR	<b>V ARBOR - PUBLIC SERVICES - ENGINEERING</b>	OF ANN CITY OF ANN ABOR						5
14 C	SCALE PLAN: 1" = 20'	CREST RIJENA VISTA WASHINGTON WATER MAIN	PUBLIC SERVICES						
)F 4			D (0) (10) (10) (10) (10) (10) (10) (10)	0	01 ADDENDUM #1	2-23-18	CEC/DPF	JKA	
46	DRAWING No.	WASHINGTON STREET REMOVALS	734-794-6410 Www.a2gov.org	00	00 OUT FOR BID	2-6-18	CEC/DPF	JKA	Know what's below.
	2016029-14	STA. 111+00 TO STA. 114+48	CHIGN.	REV.	DESCRIPTION	DATE	DRAWN	DRAWN CHECKED	Call before you dig.

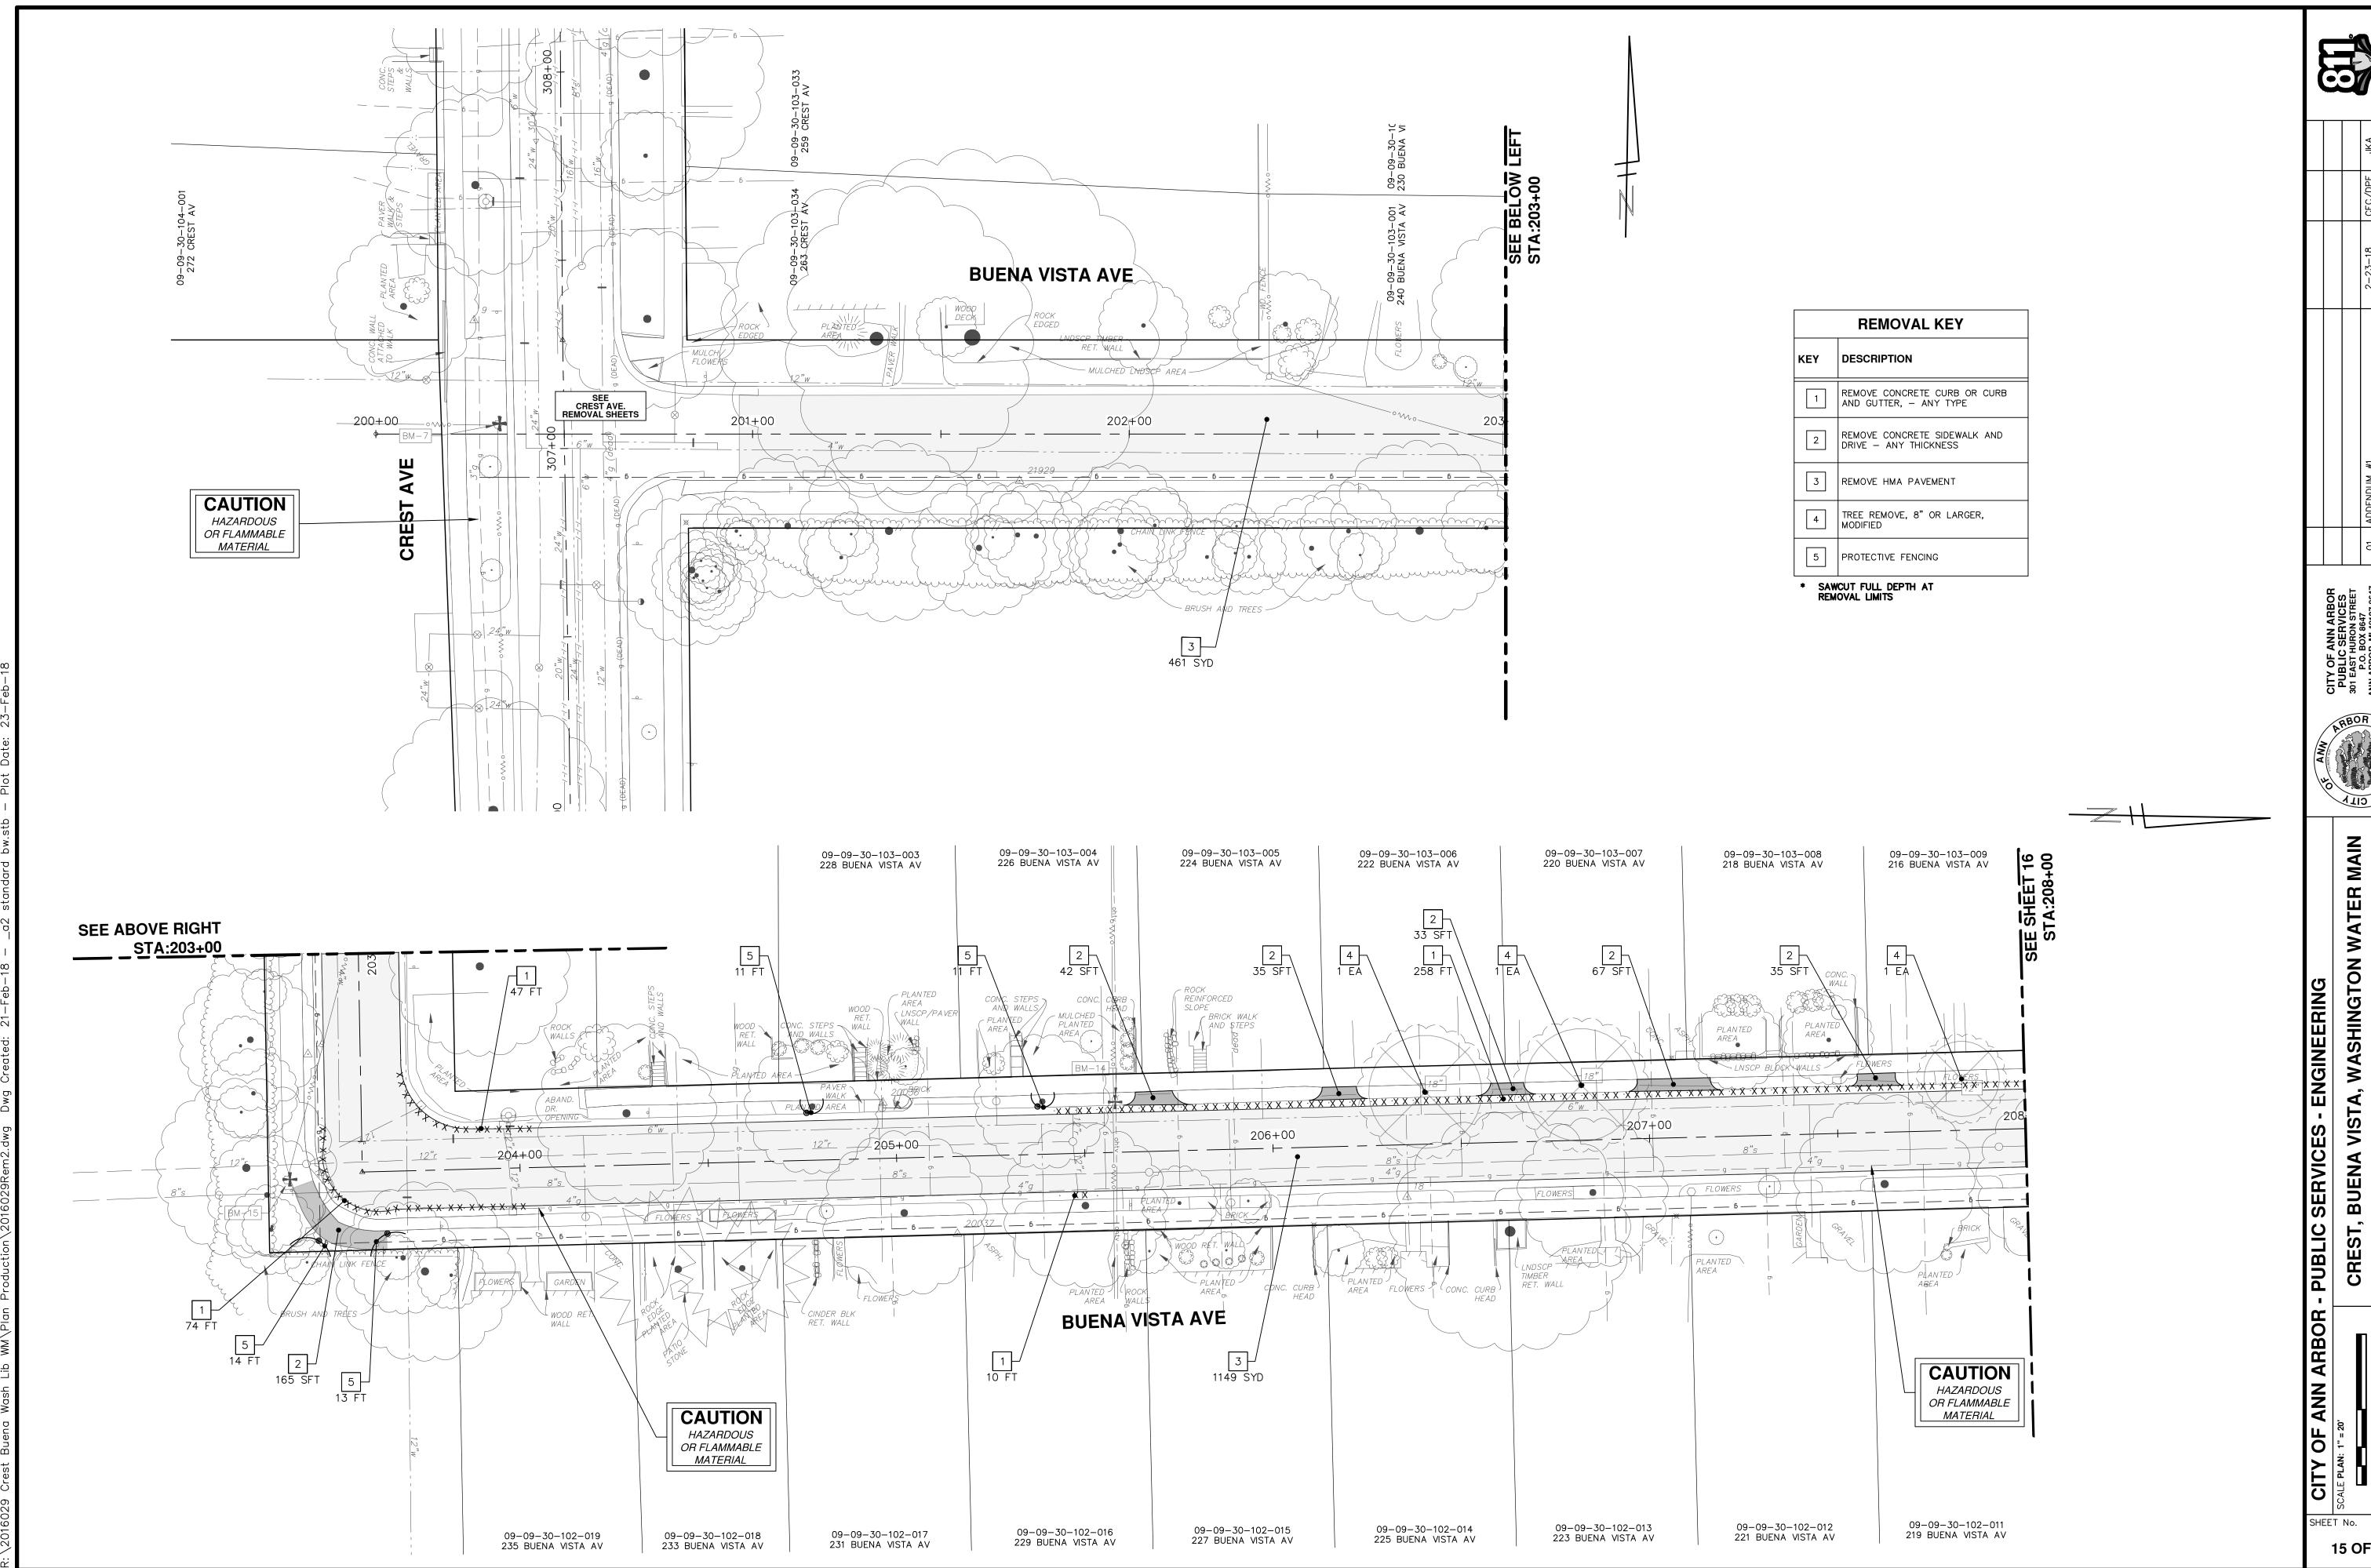


	REMOVAL KEY
KEY	DESCRIPTION
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5	PROTECTIVE FENCING
* SAW	CUT FULL DEPTH AT

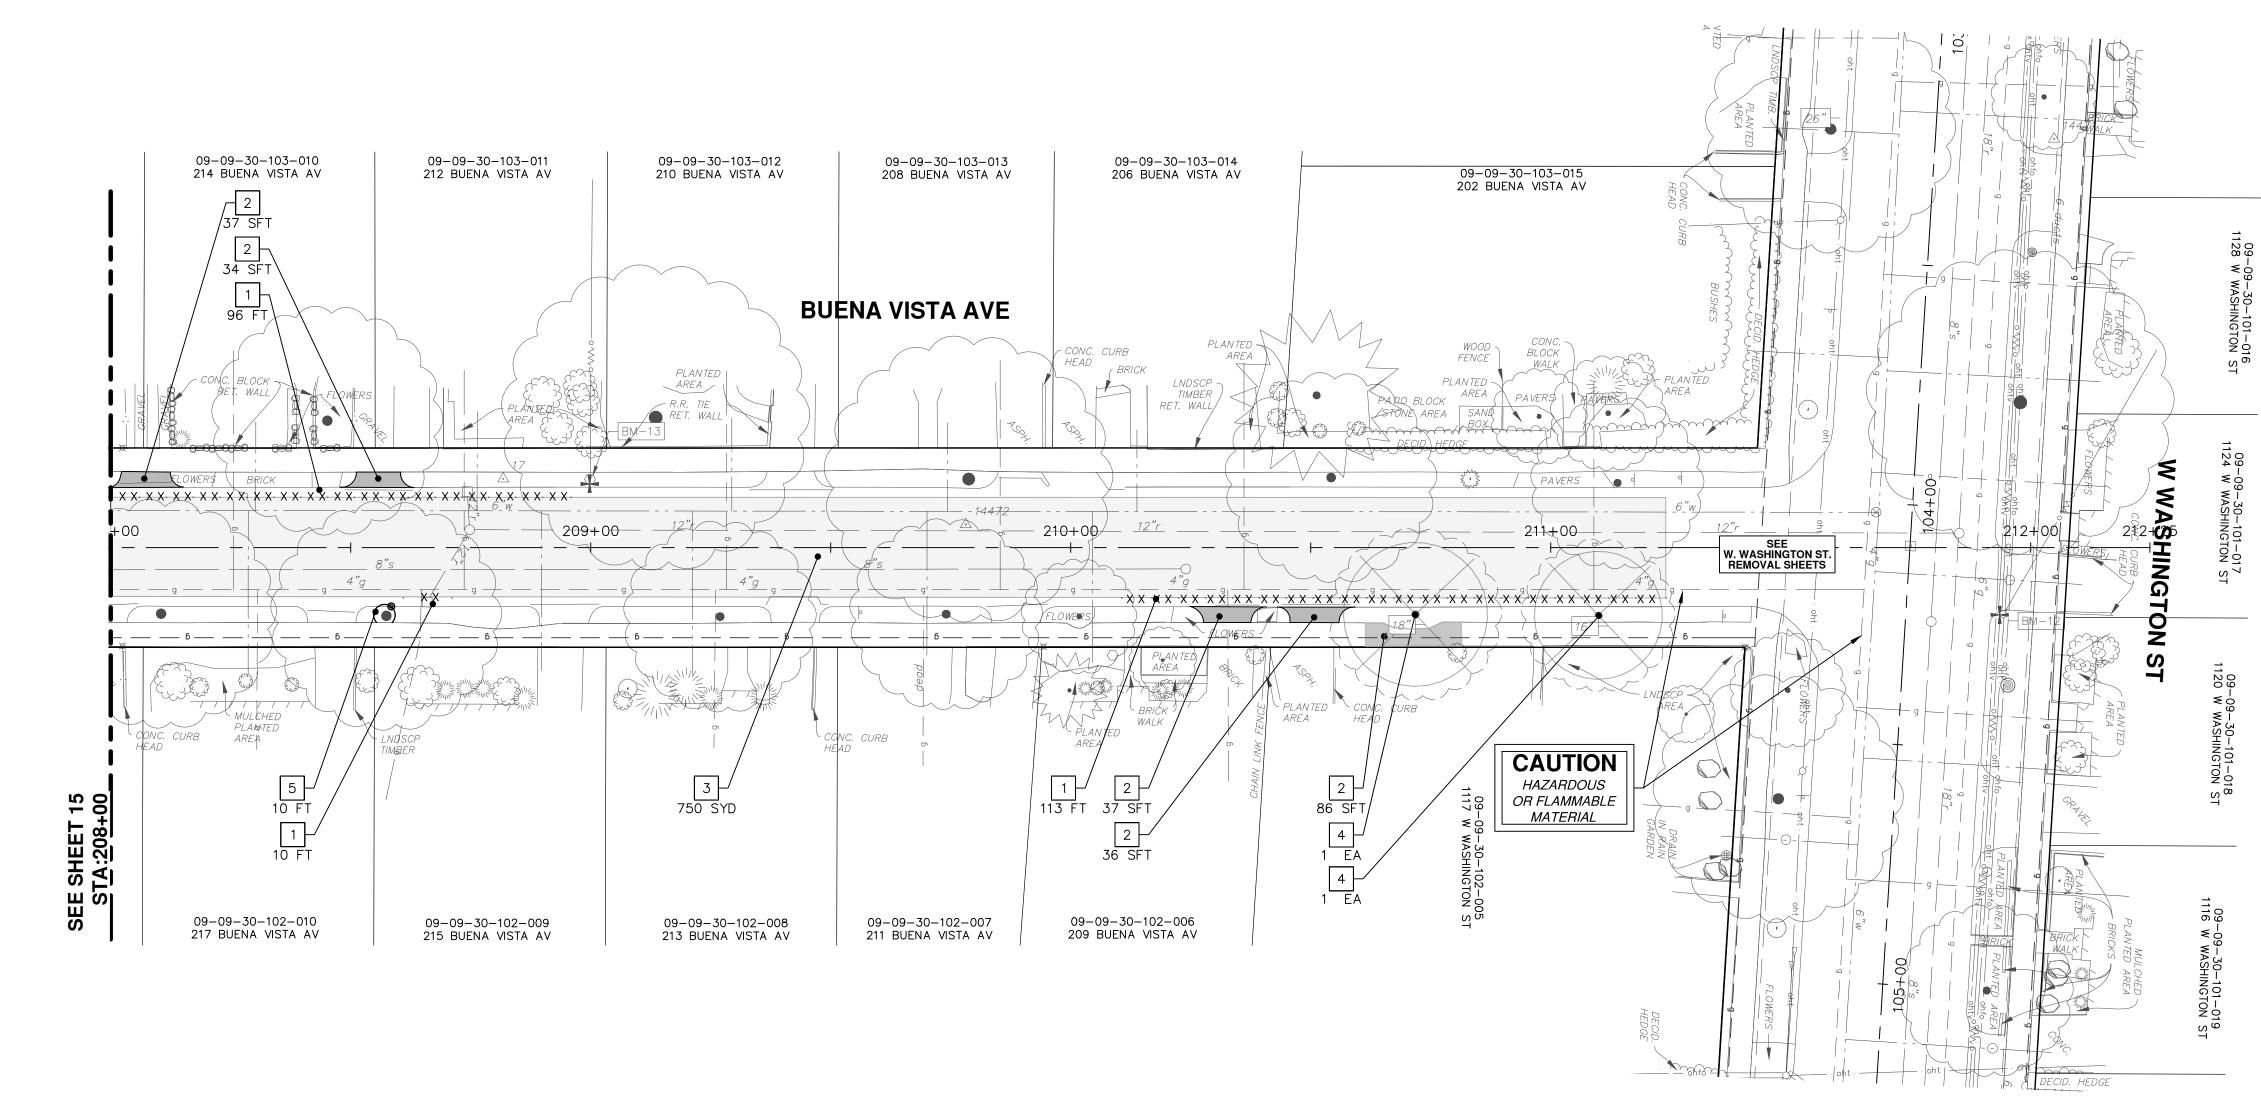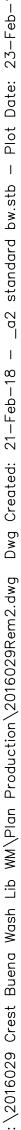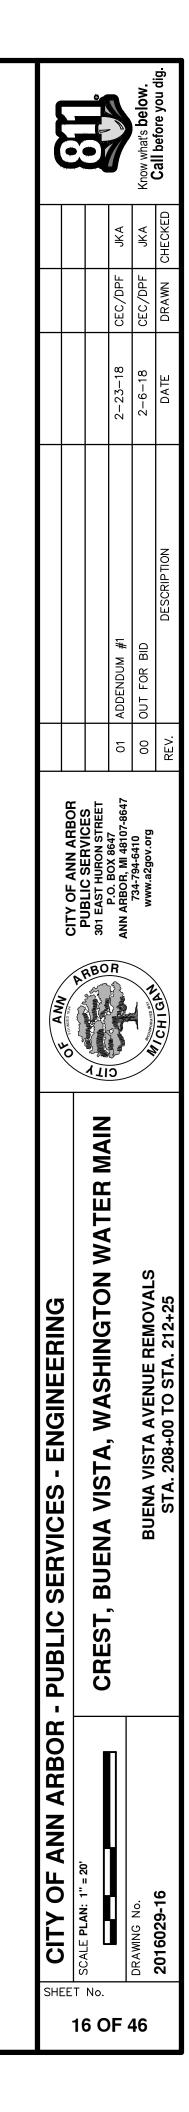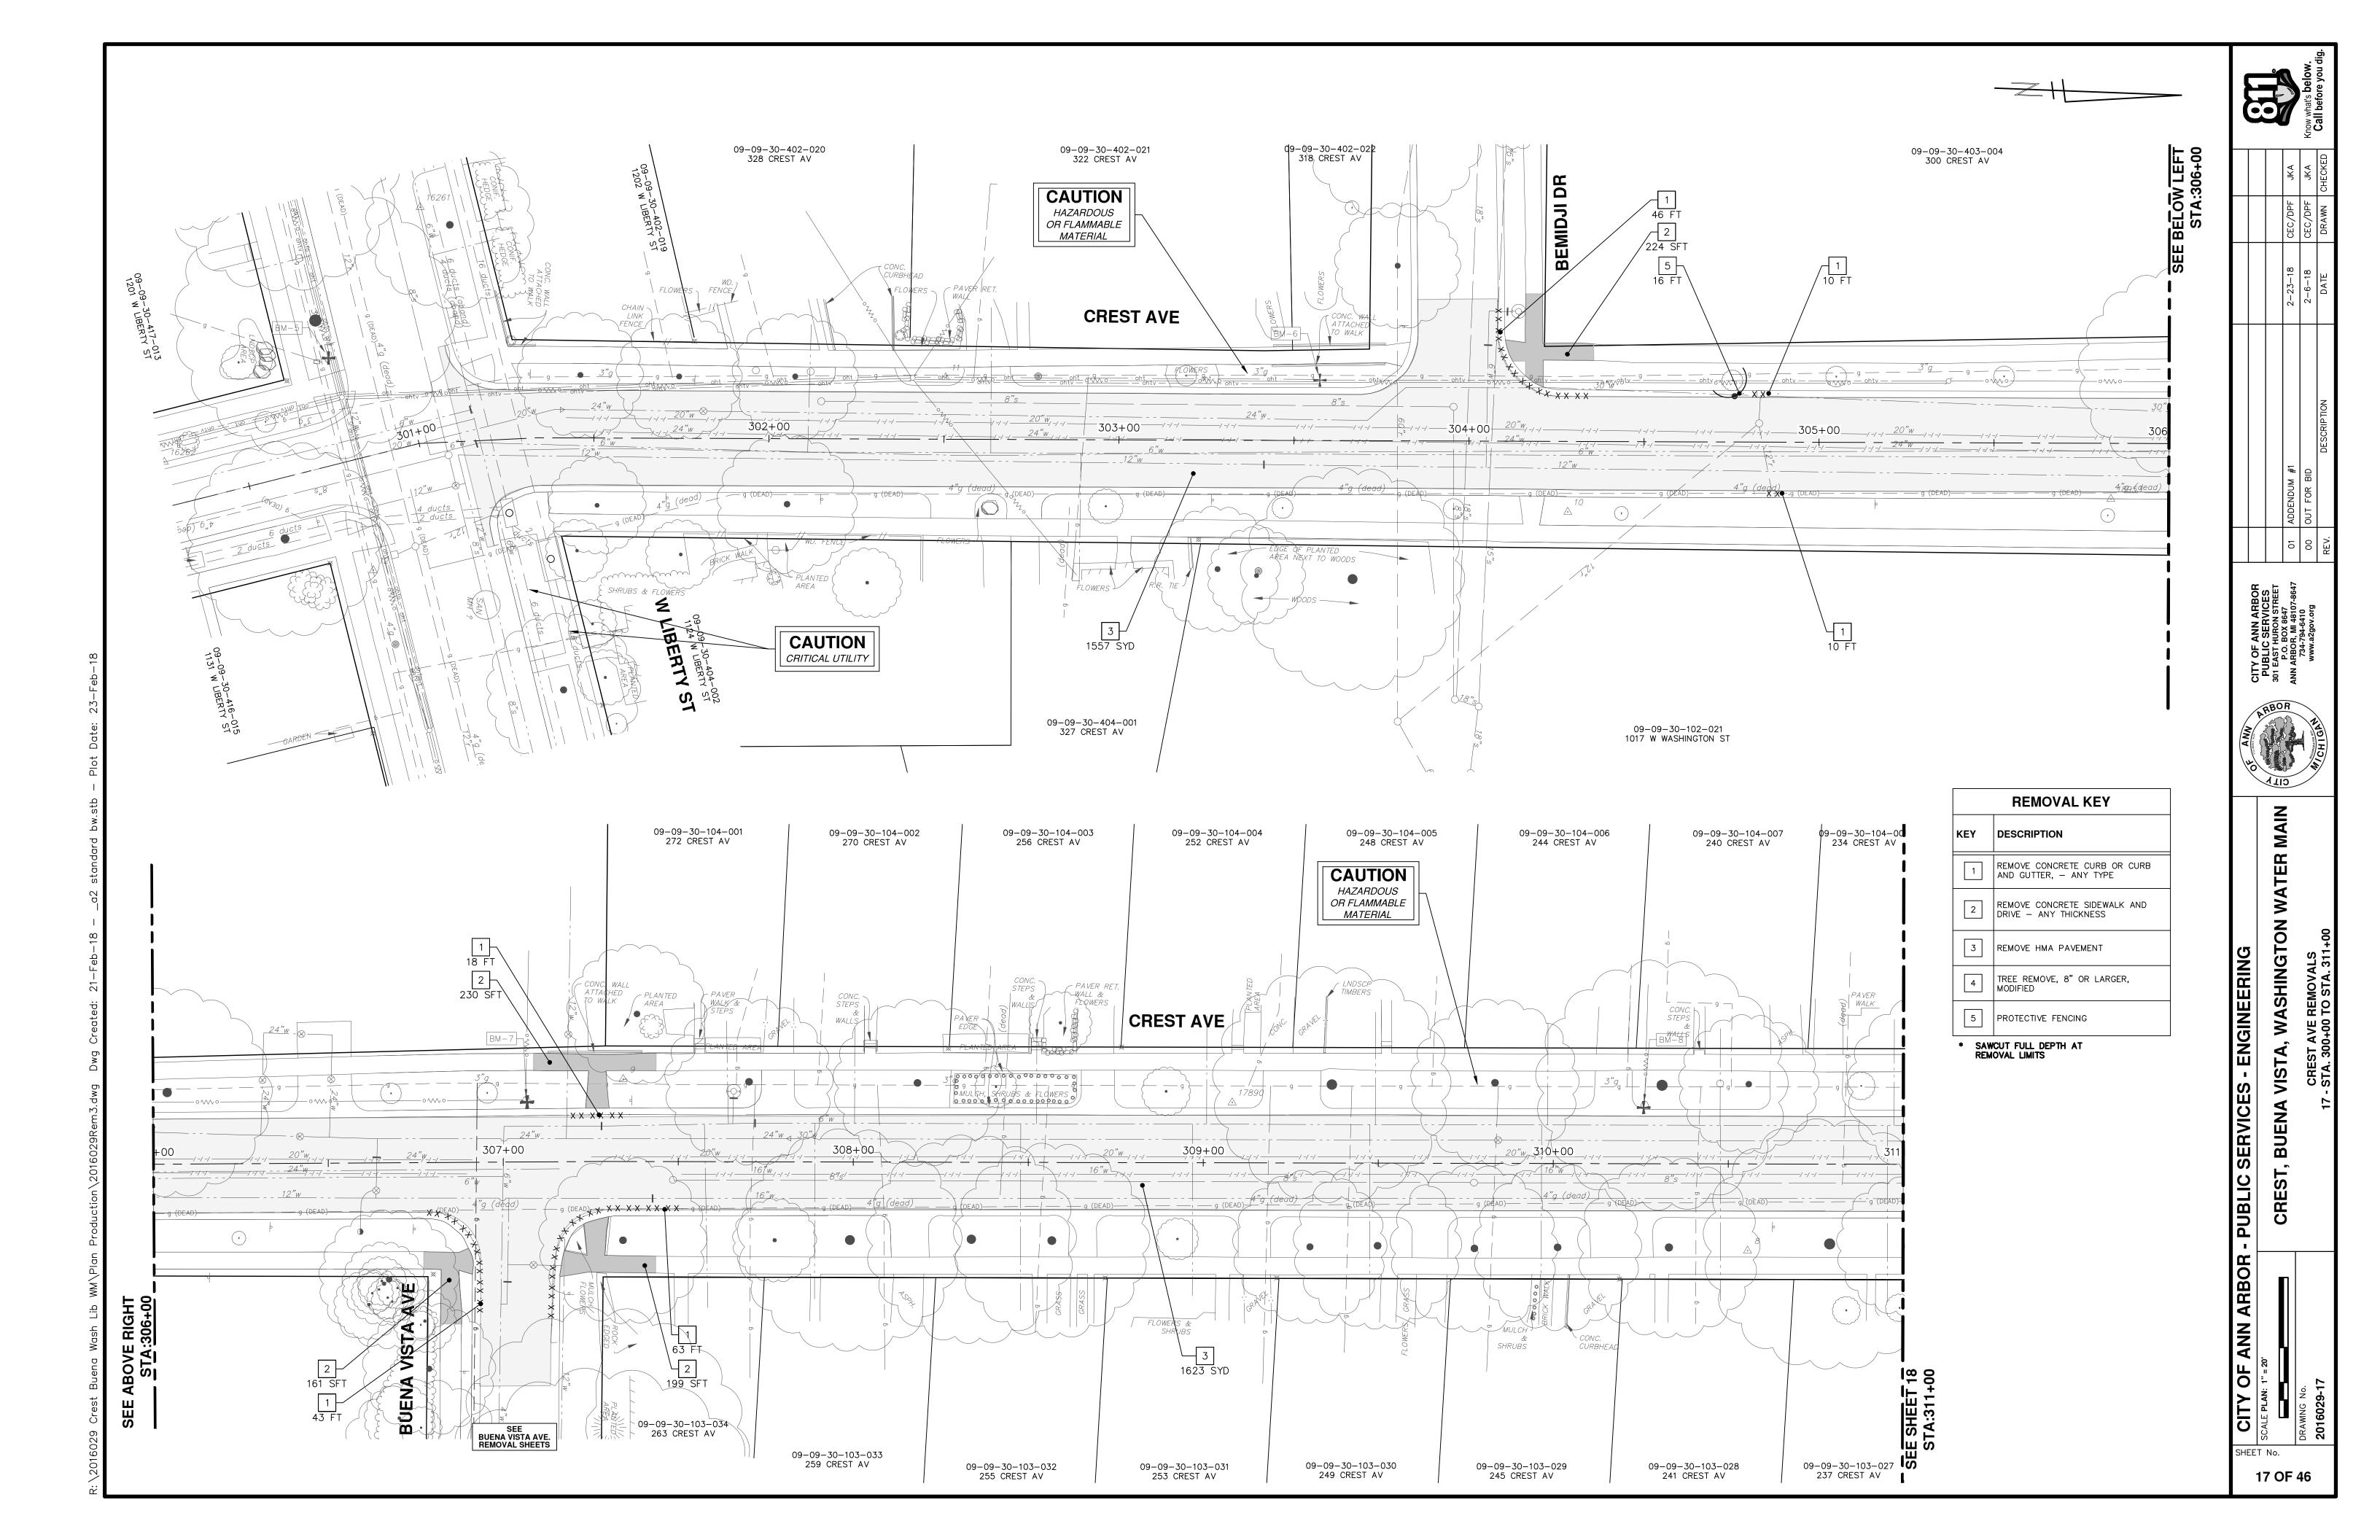
CITY OF ANN ARBOR - PUBLIC SERVICES - ENGINEERING         CITY OF ANN ARBOR - PUBLIC SERVICES - ENGINEERING         Scale Plan: 1" = 20         Scale Plan: 1" = 20         DRAWIG NO.         DRAWIG NO.	TER MAIN	CITY OF ANN ARBOR PUBLIC SERVICES 301 EAST HURON STREET P.O. BOX 8647 ANN ARBOR, MI 48107-8647 734-794-6410 www.a2gov.org REV.	01 ADDENDUM #1 00 OUT FOR BID EV. DESCRIPTION	2-23-18 2-6-18 DATE	CEC/DPF JKA CEC/DPF JKA CEC/DPF JKA DRAWN CHECKED	JK A JK A SHECKED	Know what's below.
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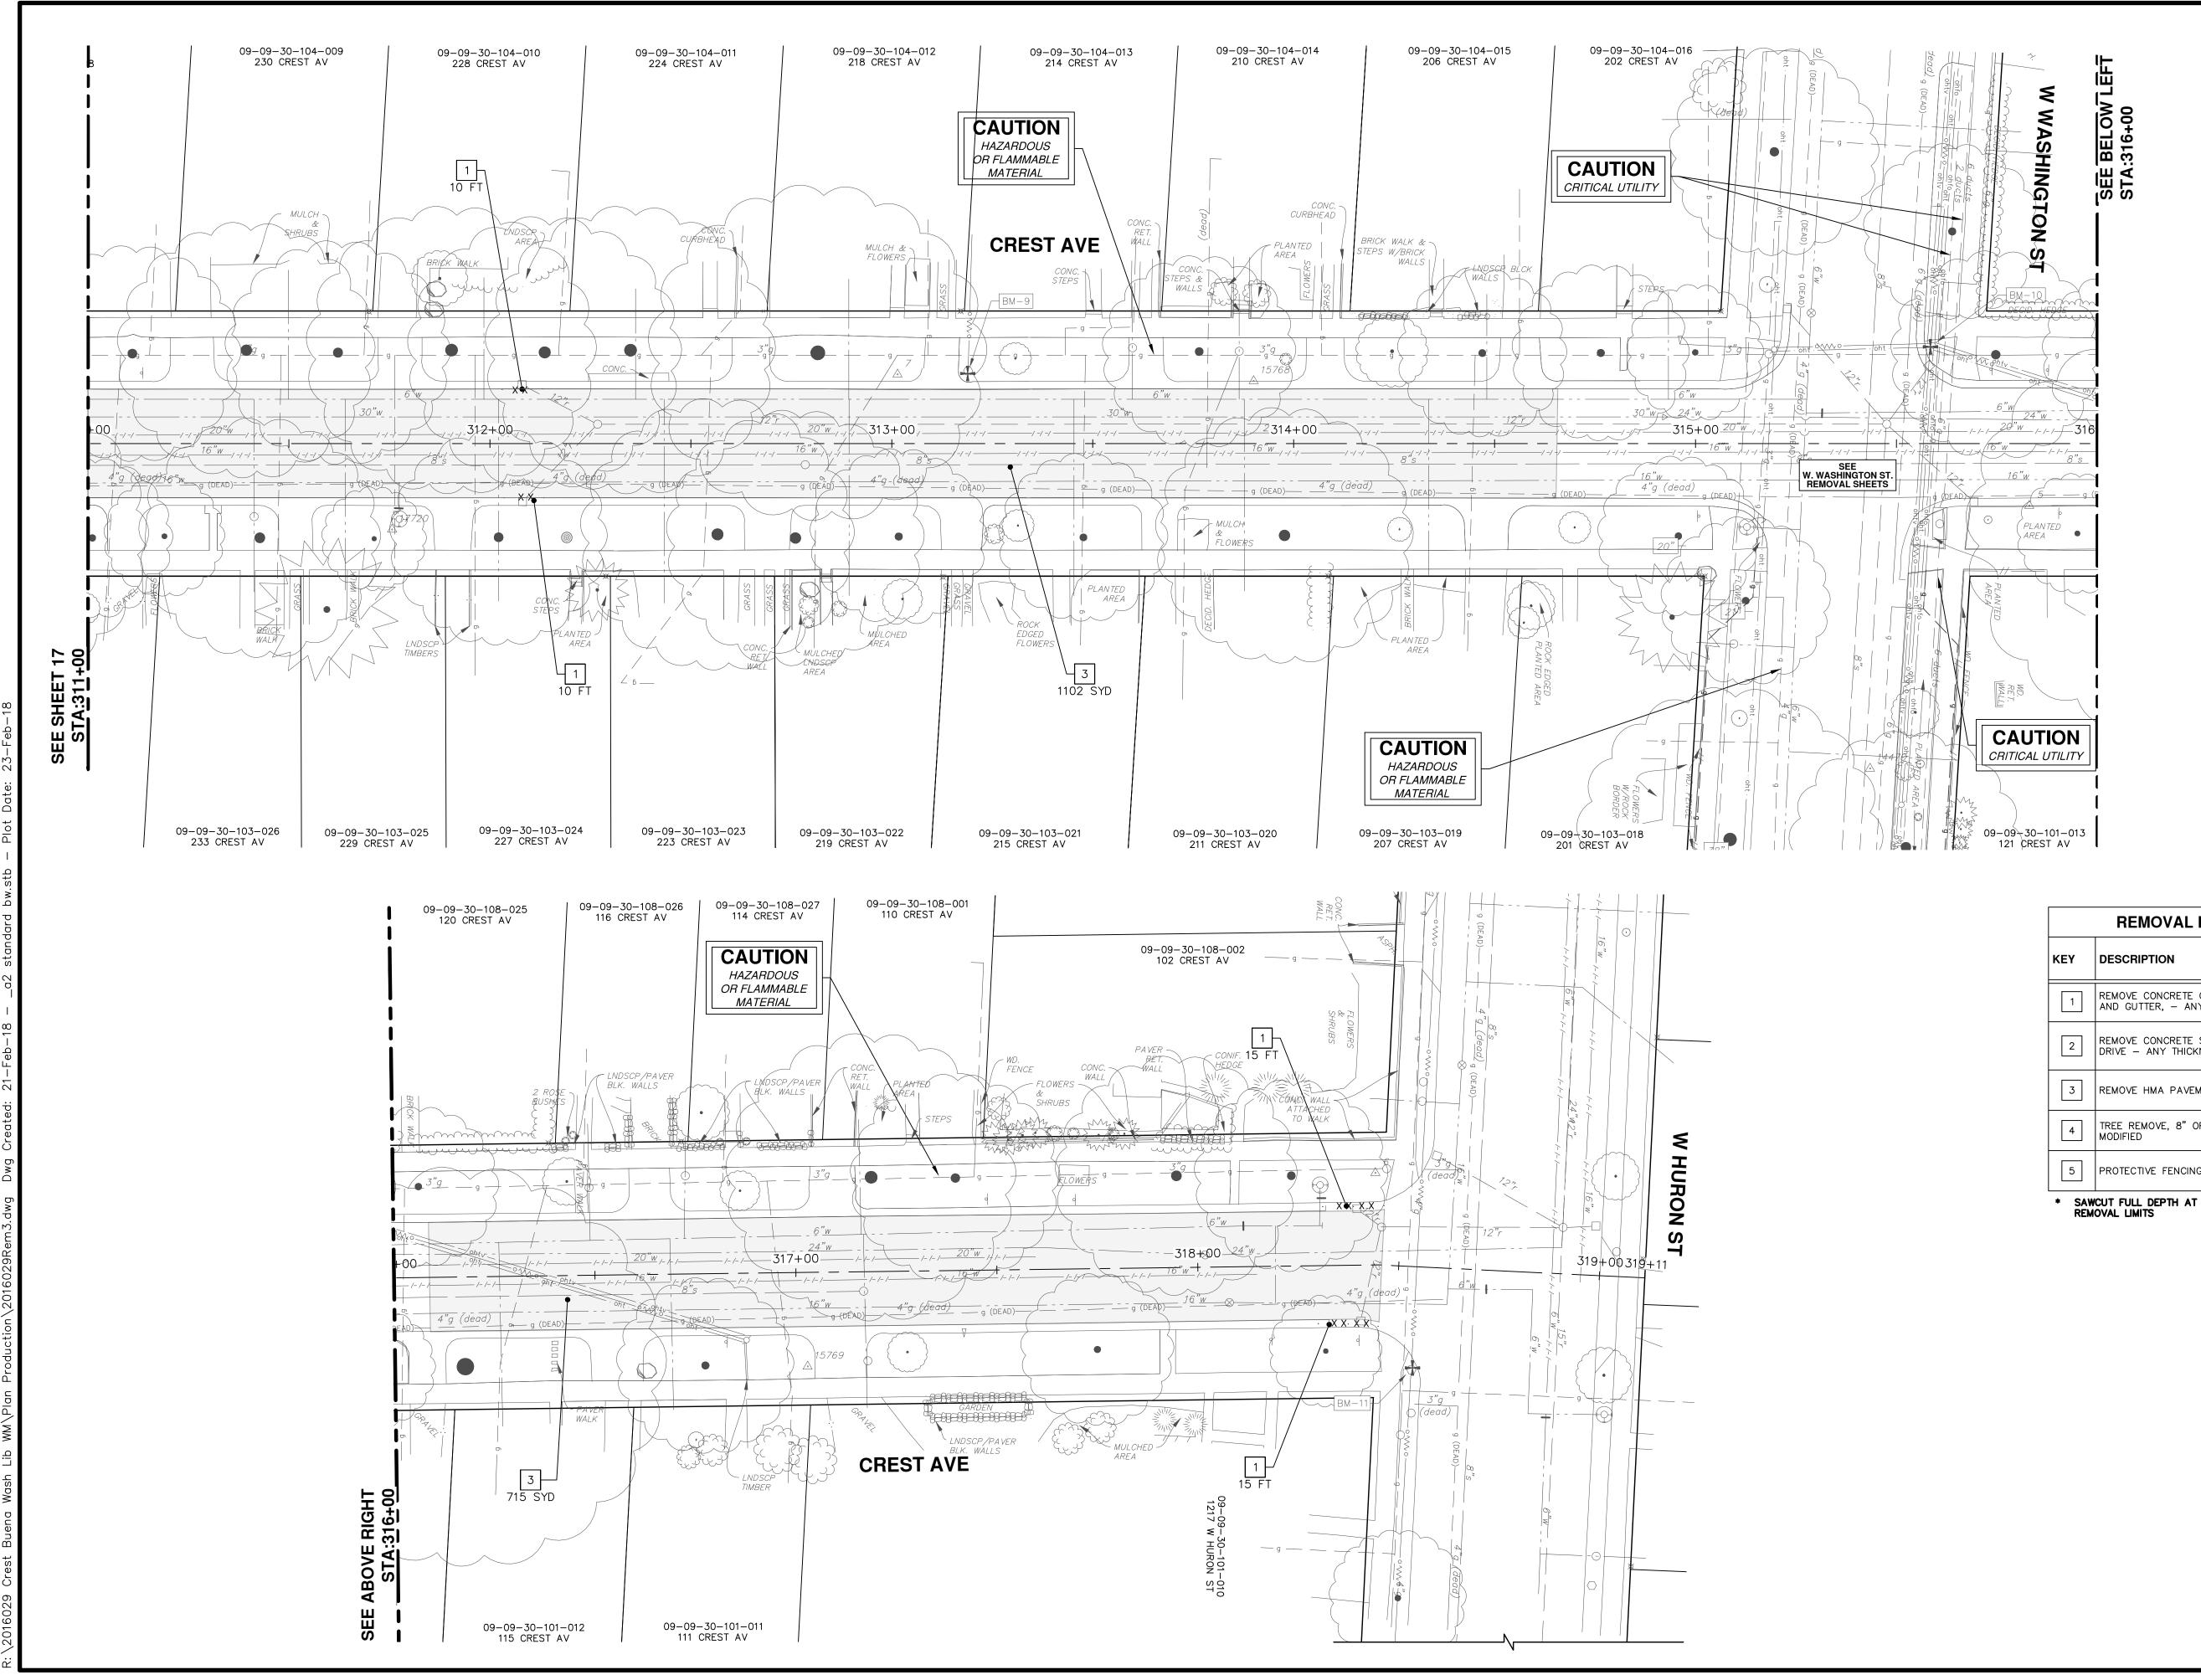




	REMOVAL KEY
KEY	DESCRIPTION
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	ICUT FULL DEPTH AT IOVAL LIMITS









	REMOVAL KEY
КЕҮ	DESCRIPTION
1	REMOVE CONCRETE CURB OR CURB AND GUTTER, – ANY TYPE
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4	TREE REMOVE, 8" OR LARGER, MODIFIED
5	PROTECTIVE FENCING

			CEC/DPF JKA	CEC/DPF JKA Know what's below.	DRAWN CHECKED Call before you dig.
			2-23-18	2-6-18	DATE
			01 ADDENDUM #1	00 OUT FOR BID	REV. DESCRIPTION
OF TOTAL ANN ABBOR	DIBLIC SERVICES	301 EAST HURON STREET	P.O. BOX 8647	734-794-6410 WWW 22000 DFD	W/CHIGAN
		NIAN CITAW WOTOWING WANNATION	CREST, BUENA VISTA, WASHINGTON WATER MAIN		CREST AVE REMOVALS STA. 311+00 TO STA. 319+11

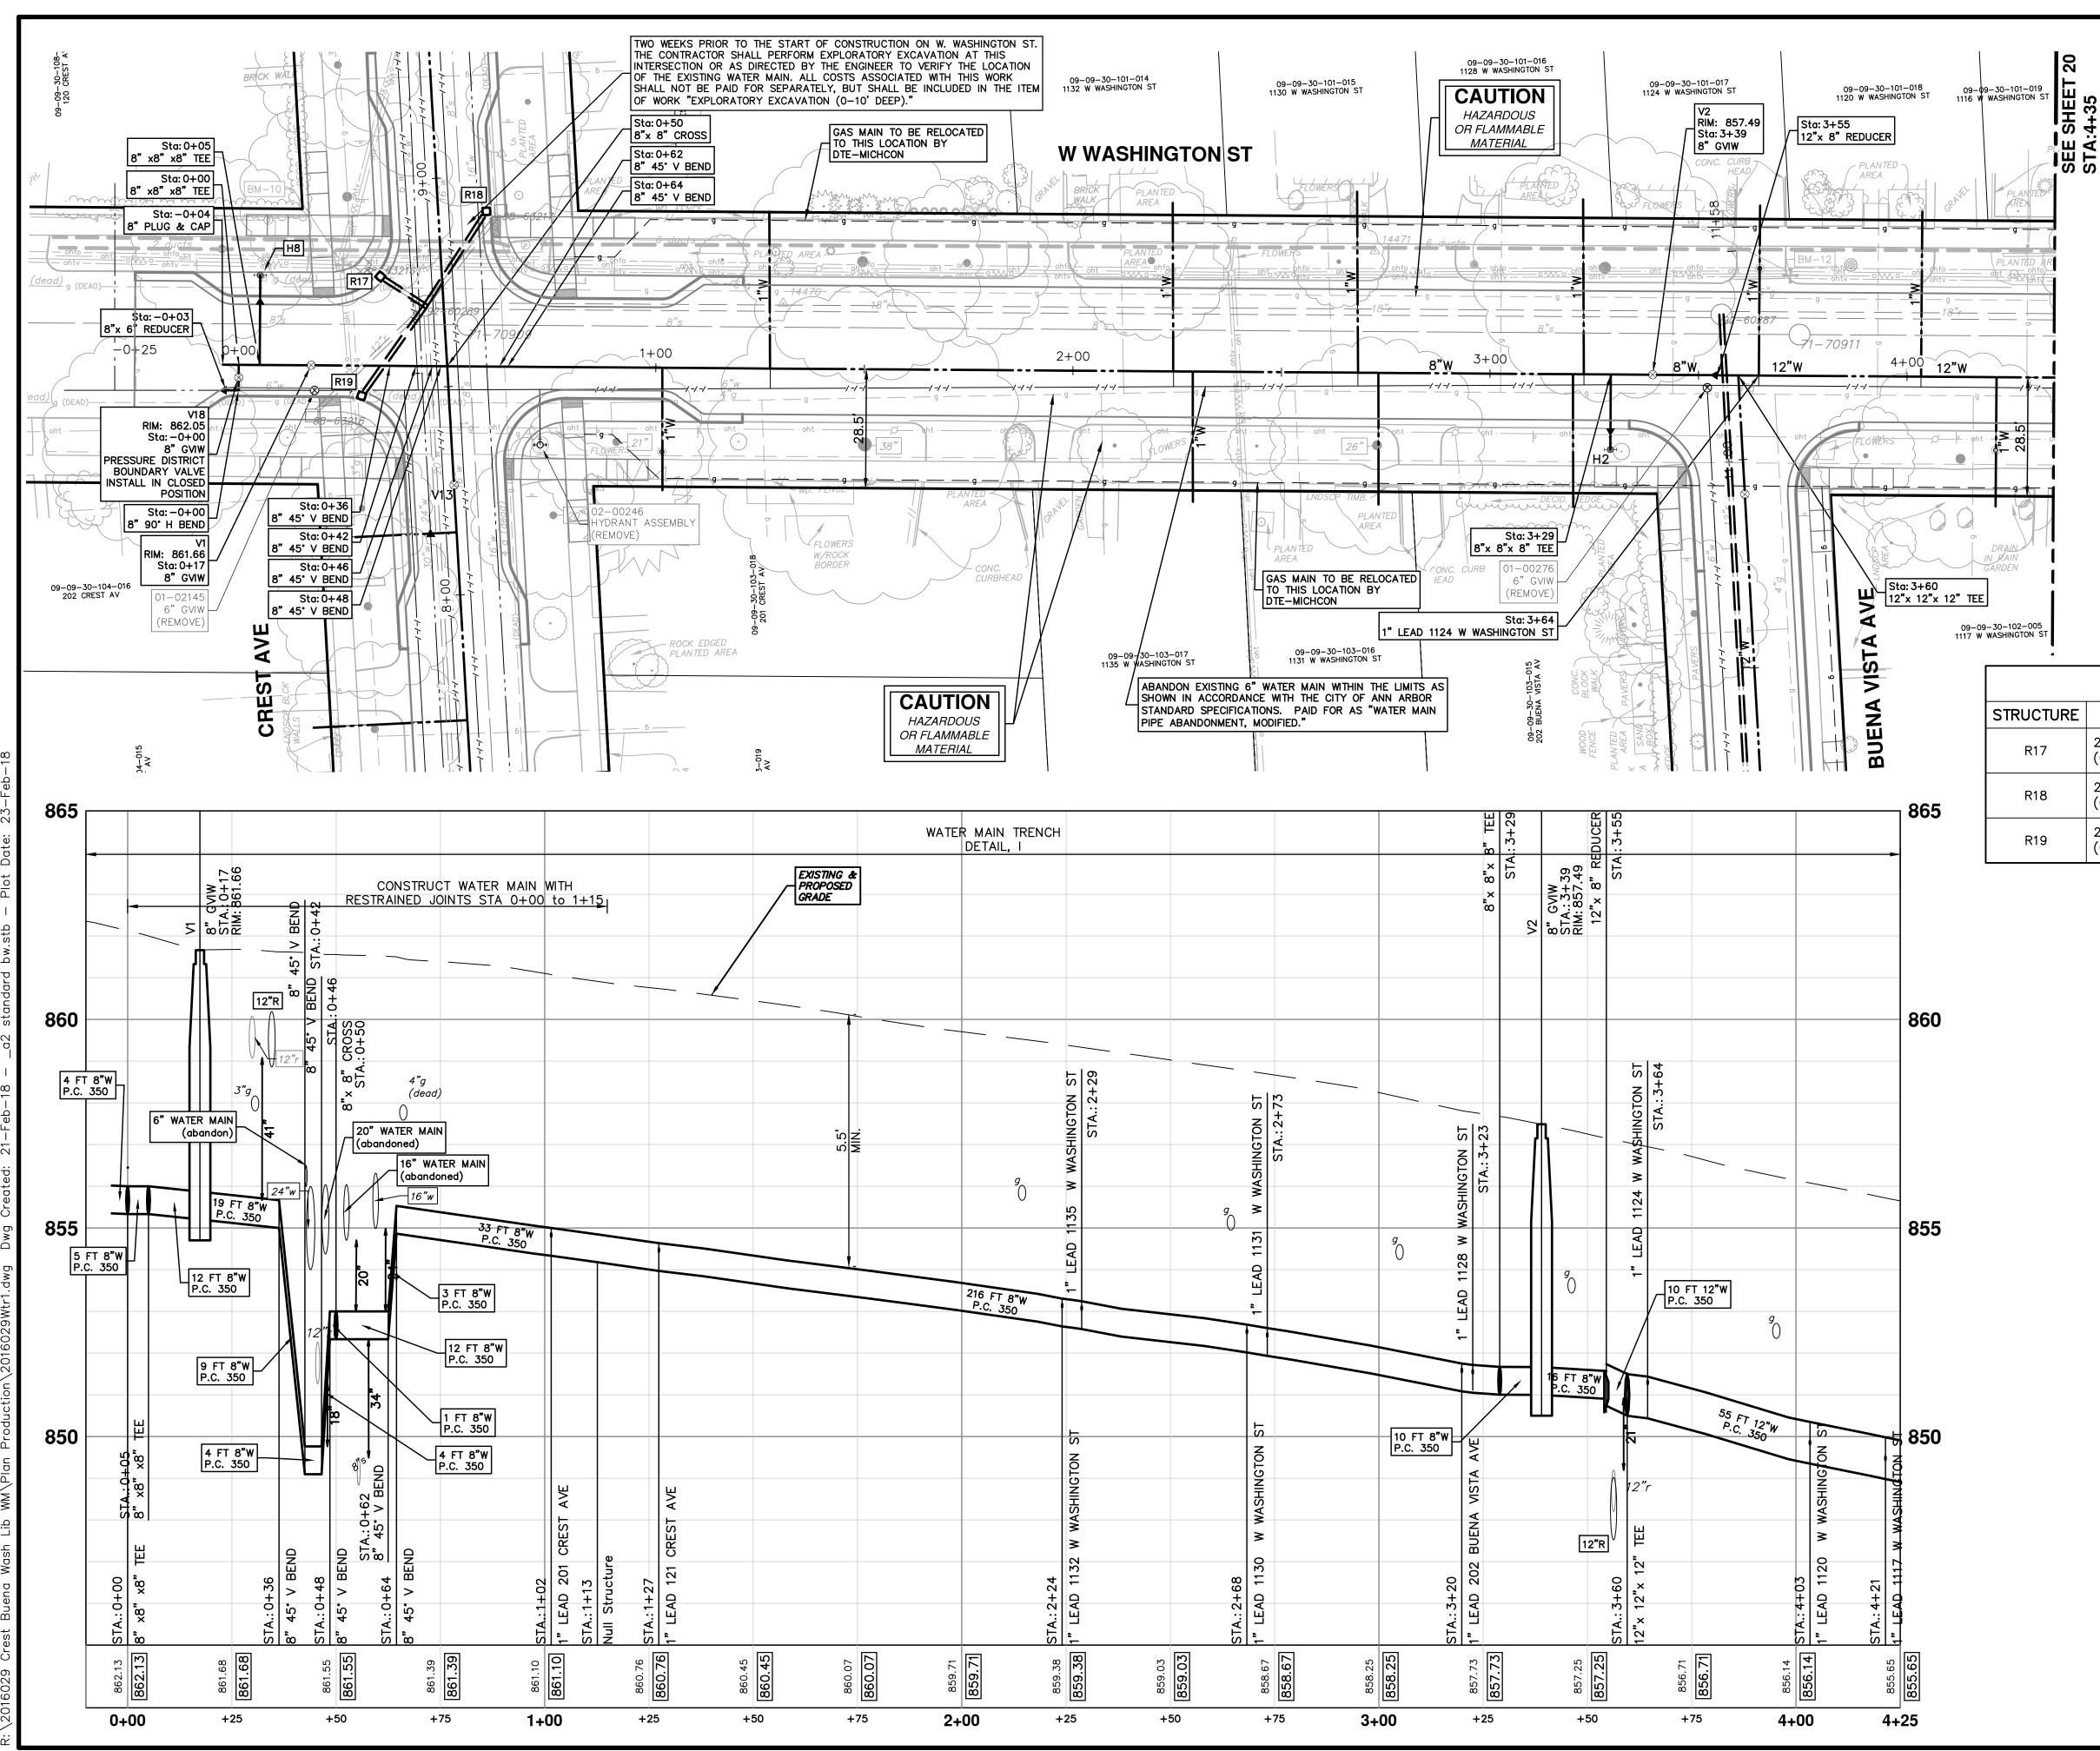

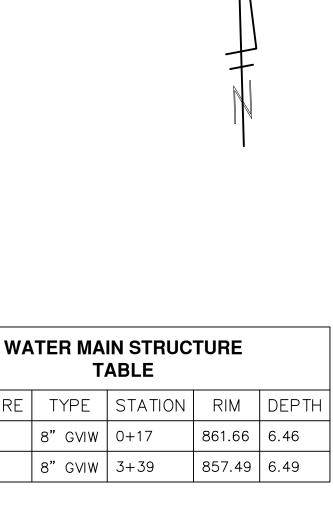

	STORM STRUCTURE TABLE					
STRUCTURE	TYPE	RIM	INVERTS	PIPE	SUMP	
R17	2' Inlet (Cover K)	861.31	12"SE 858.71	13 LF OF 12" @ 6.09%	2'	
R18	2' Inlet (Cover K)	861.10	12"SW 856.79	27 LF OF 12" @ 1.55%	2'	
R19	2' Inlet (Cover K)	861.47	12"NE 859.18	27 LF OF 12" @ 1.72%	2'	

STRUCTURE


V1

V2

		STORM SEWER REMOVAL TABLE
STRUCTURE	DEPTH (Feet)	REMOVE
88-63218	4.12	(Remove) 2' Inlet and 38' of 12" pipe
88-63217	6.05	(Remove) 2' Inlet and 30' of 12" pipe
88-63216	4.12	(Remove) 2' Inlet and 11' of 12" pipe


## WATER MAIN CONSTRUCTION NOTES:

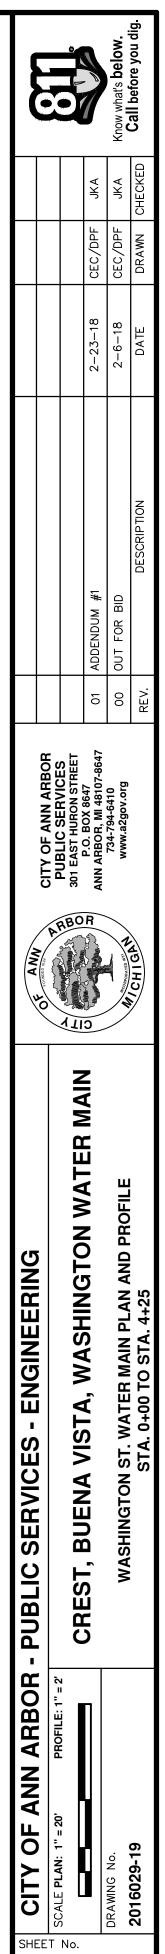- 1: ALL WATER MAIN WORK SHALL BE STAGED IN ACCORDANCE WITH THE SPECIAL PROVISION AND AS DIRECTED BY THE ENGINEER. THE CONTRACTOR SHALL BE RESPONSIBLE FOR COORDINATING ALL WORK, CONSTRUCTION METHODS, AND EQUIPMENT TO COMPLY WITH THE CONTRACT REQUIREMENTS.
- 2: THE CONTRACTOR SHALL CAREFULLY PROTECT FROM DAMAGE OR INJURY DURING CONSTRUCTION OPERATIONS, ALL UTILITIES NOT DESIGNATED FOR REMOVAL OR ABANDONMENT. EXISTING FACILITIES NOT DESIGNATED FOR REMOVAL OR ABANDONMENT WHICH ARE DAMAGED BY THE CONTRACTOR'S OPERATION SHALL BE REPAIRED OR REPLACED BY THE CONTRACTOR AT HIS SOLE EXPENSE, IN A MANNER THAT IS APPROVED BY THE ENGINEER.
- 3: THE EXISTING UTILITIES SHOWN ON THESE PLANS REPRESENT THE BEST INFORMATION AVAILABLE AS OBTAINED THROUGH SURVEYS AND/OR EXISTING PLANS. THIS INFORMATION DOES NOT RELIEVE THE CONTRACTOR OF THE RESPONSIBILITY TO BE SATISFIED AS TO ITS ACCURACY AND/OR THE LOCATION OF EXISTING UTILITIES. IF STORM, SANITARY, OR WATER MAINS CROSS WITH LESS THAN 18" CLEARANCE, THEY SHALL BE SADDLED. IF STORM, SANITARY, OR WATER MAINS CROSS OTHER UTILITIES, CONTACT THEIR RESPECTIVE OWNERS FOR INFORMATION ON HOW TO PROCEED. PAYMENT FOR THE COORDINATION EFFORTS, CONCRETE SADDLES, AND ANY OTHER ASSOCIATED ITEMS SHALL BE INCLUDED IN THE RELATED STORM, SANITARY, OR WATER MAIN ITEMS AND SHALL NOT BE PAID FOR SEPARATELY.
- 4: THE CONTRACTOR WILL ONLY BE ALLOWED TO SHUT DOWN THE EXISTING 12" WATER MAIN FOR A MAXIMUM DURATION OF 8 HOURS IN ANY ONE SHUTDOWN, IN ANY GIVEN 24 HOUR PERIOD. SHUTDOWN OF THE EXISTING WATERMAIN MUST BE SCHEDULED WITH THE ENGINEER A MINIMUM OF 3 WORKING DAYS IN ADVANCE OF THE INTENDED SHUTDOWN. THE SHUTDOWN OF THE WATER MAIN WILL NOT BE ALLOWED TO TAKE PLACE ON A SATURDAY OR A SUNDAY.
- 5: THE CONTRACTOR SHALL PROPOSE A METHOD(S) AND EQUIPMENT FOR THE REVIEW AND APPROVAL OF THE ENGINEER TO BE USED FOR THE FLUSHING OF CHLORINATED WATER FROM PROPOSED WATER MAIN INTO EXISTING SANITARY SEWERS. CHLORINATED WATER SHALL NOT BE ALLOWED IN STORM SEWERS. ANY AND ALL MEASURES NECESSARY TO COMPLY WITH THIS REQUIREMENT SHALL BE INCLUDED IN THE COST OF THE WATER MAIN INSTALLATION AND WILL NOT BE PAID FOR SEPARATELY.



19 OF 46



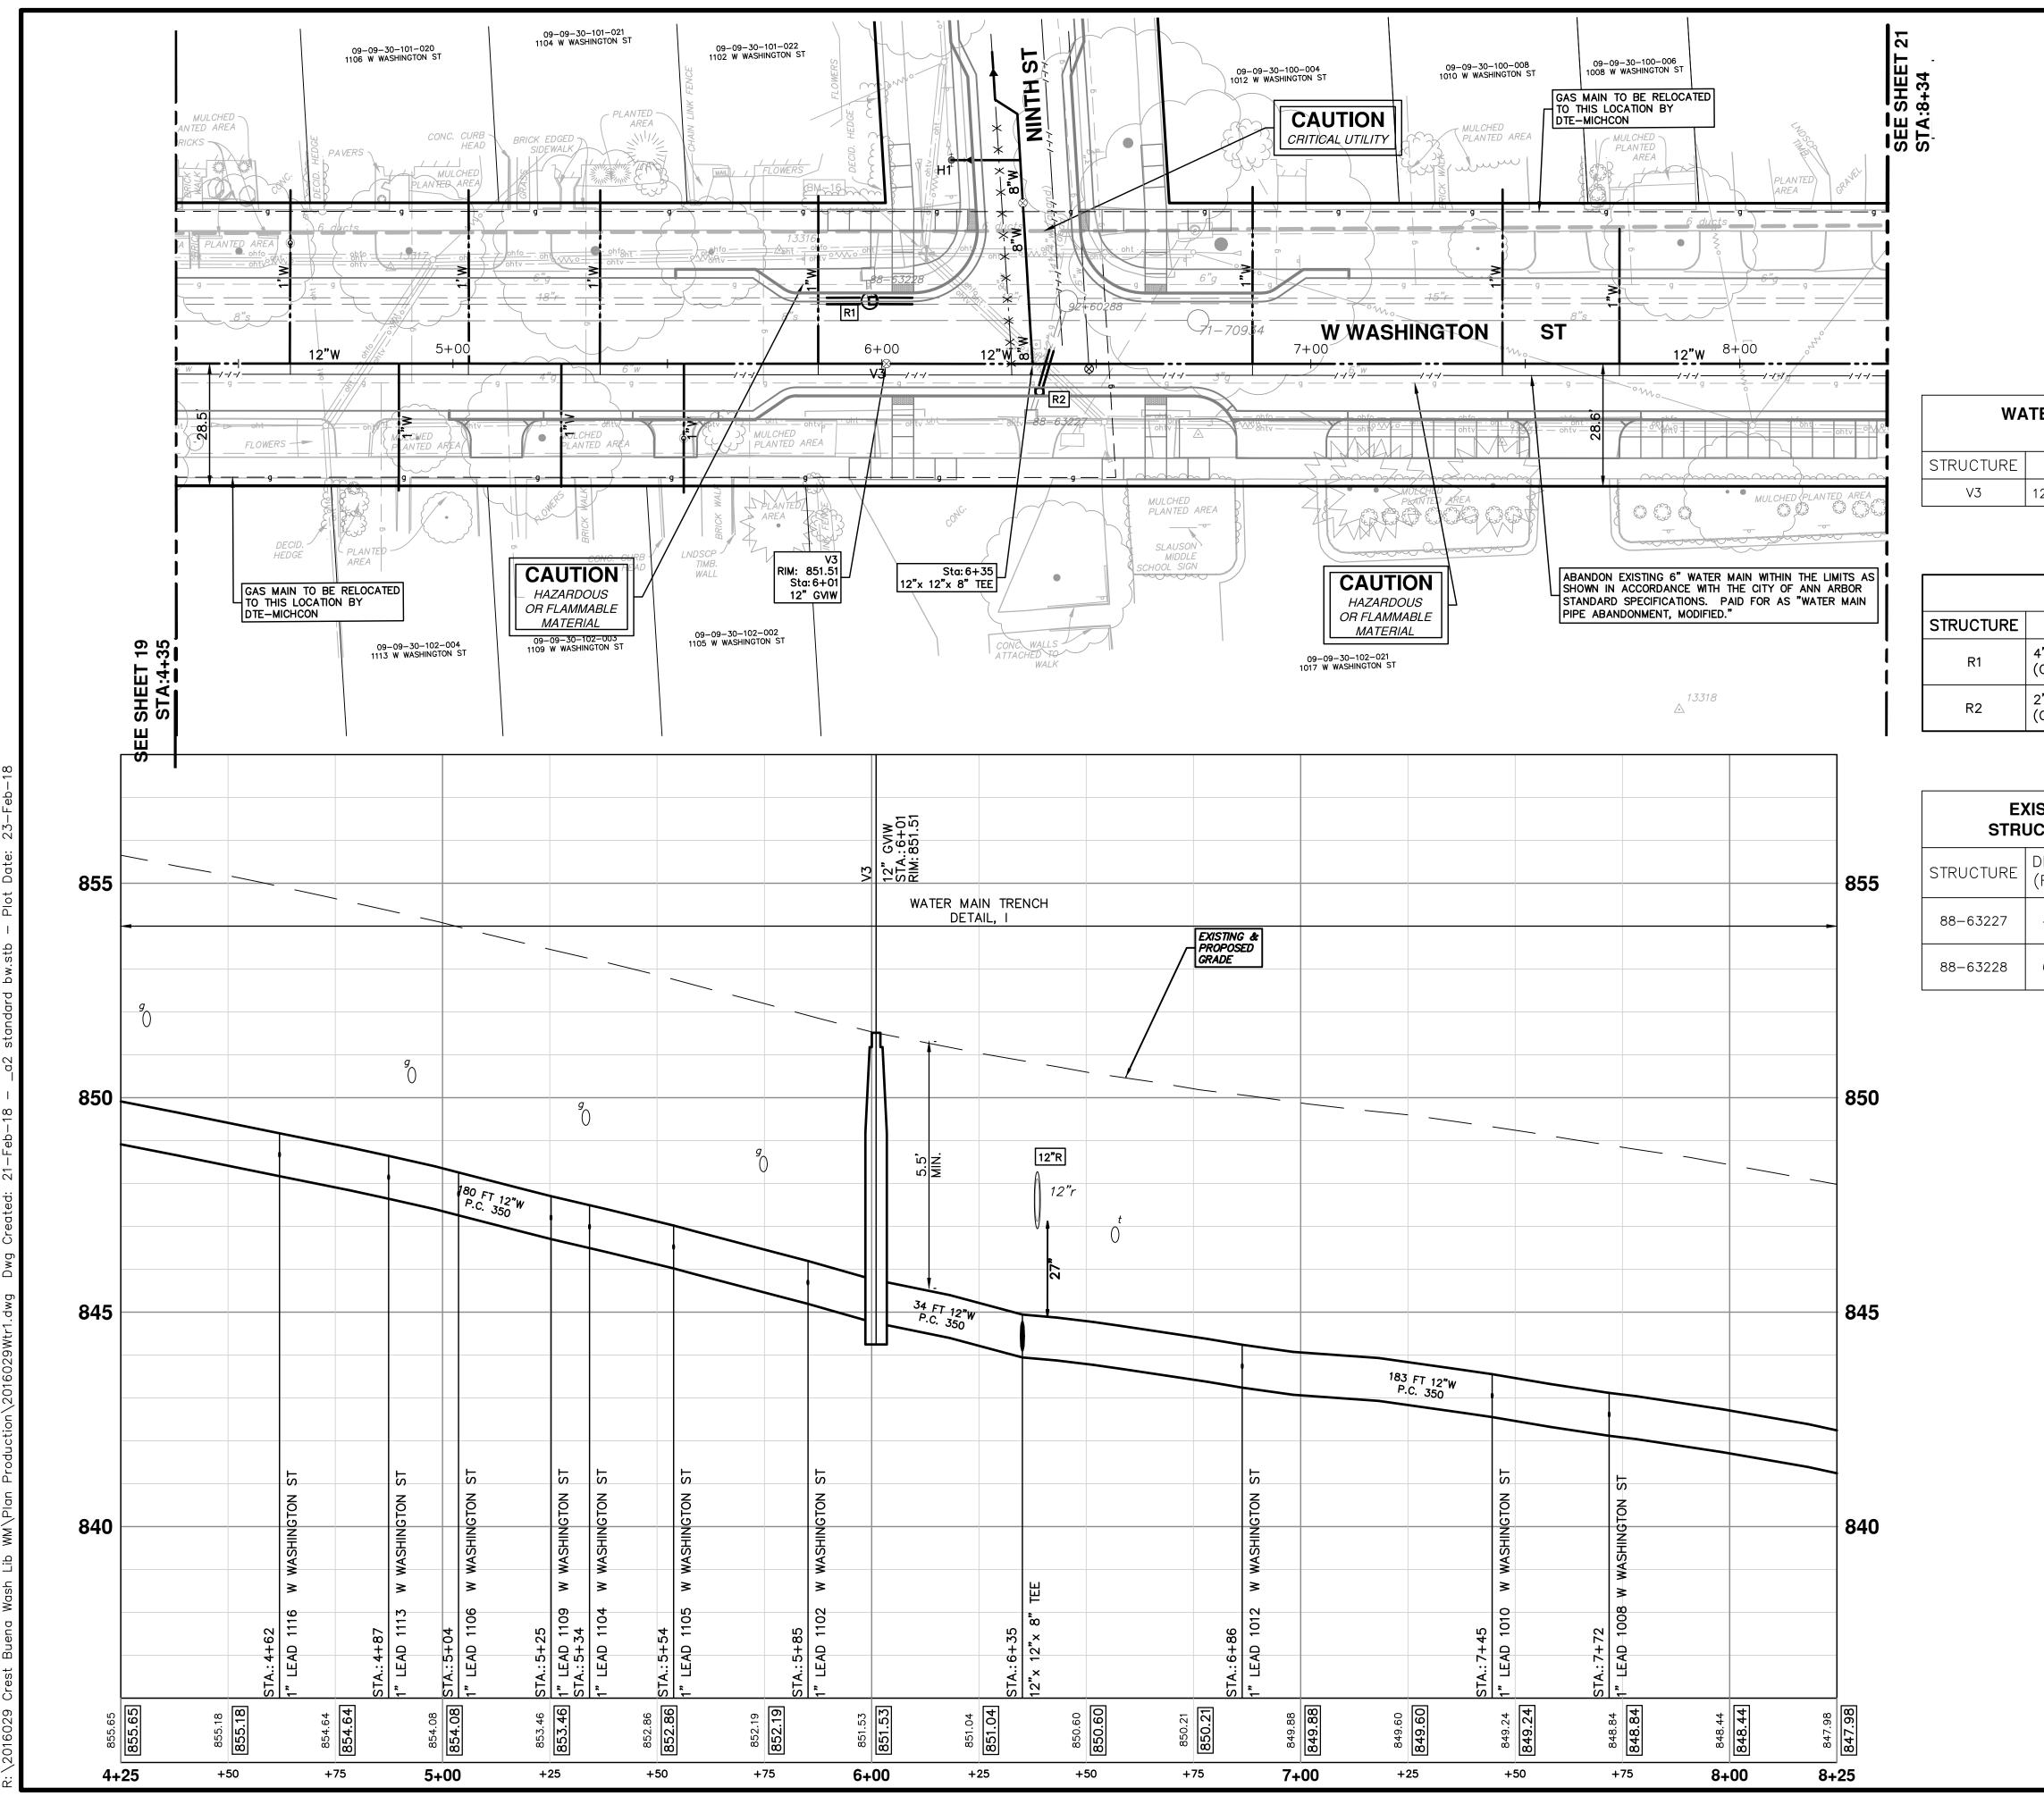



			Know what's below.	Call before you dig.
		ANU	ANU	DRAWN CHECKED
		CEC/DPF	CEC/DPF	DRAWN
		2-23-18	2-6-18	DATE
		ADDENDUM #1	OUT FOR BID	DESCRIPTION
		01	00	REV.
	ABO	R	~	GRY
		CITY OF ANN ARBOR PUBLIC SERVICES 301 EAST HURON STREET	01 ADDENDUM #1 2-23-18 CEC/DPF JKA	CITY OF ANN ARBOR         CITY OF ANN ARBOR

	N STRUCI	URE	
TYPE	STATION	RIM	DEPTH
2" G∨IW	6+01	851.51	6.76

STO	RM STR	UCTURE TA	BLE	
TYPE	RIM	INVERTS	PIPE	SUMP
4' Junction Inlet (Cover K)	851.44	18"E 844.85 18"W 844.85	10 LF OF 18"@ 1.16% 10 LF OF 18"@ 1.16%	2'
2' Inlet (Cover K)	850.51	12"N 847.48	10 LF OF 12" @ 5.48%	2'

	STORM SEWER
DEPTH (Feet)	REMOVE
4.25	(Remove) 2' Inlet and 16' of 12" pipe
6.70	(Remove) 2' Inlet and 7' of 12" pipe

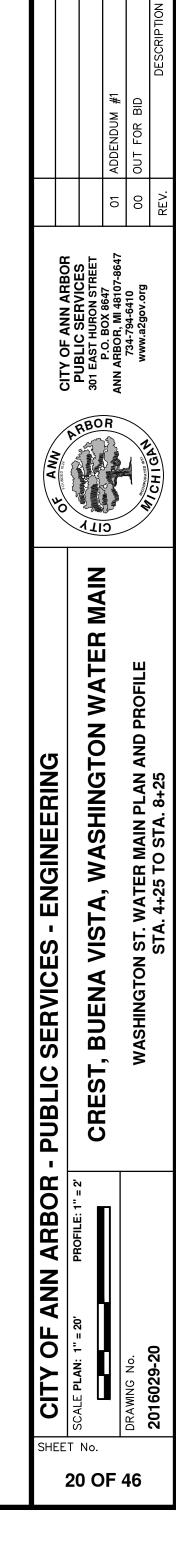

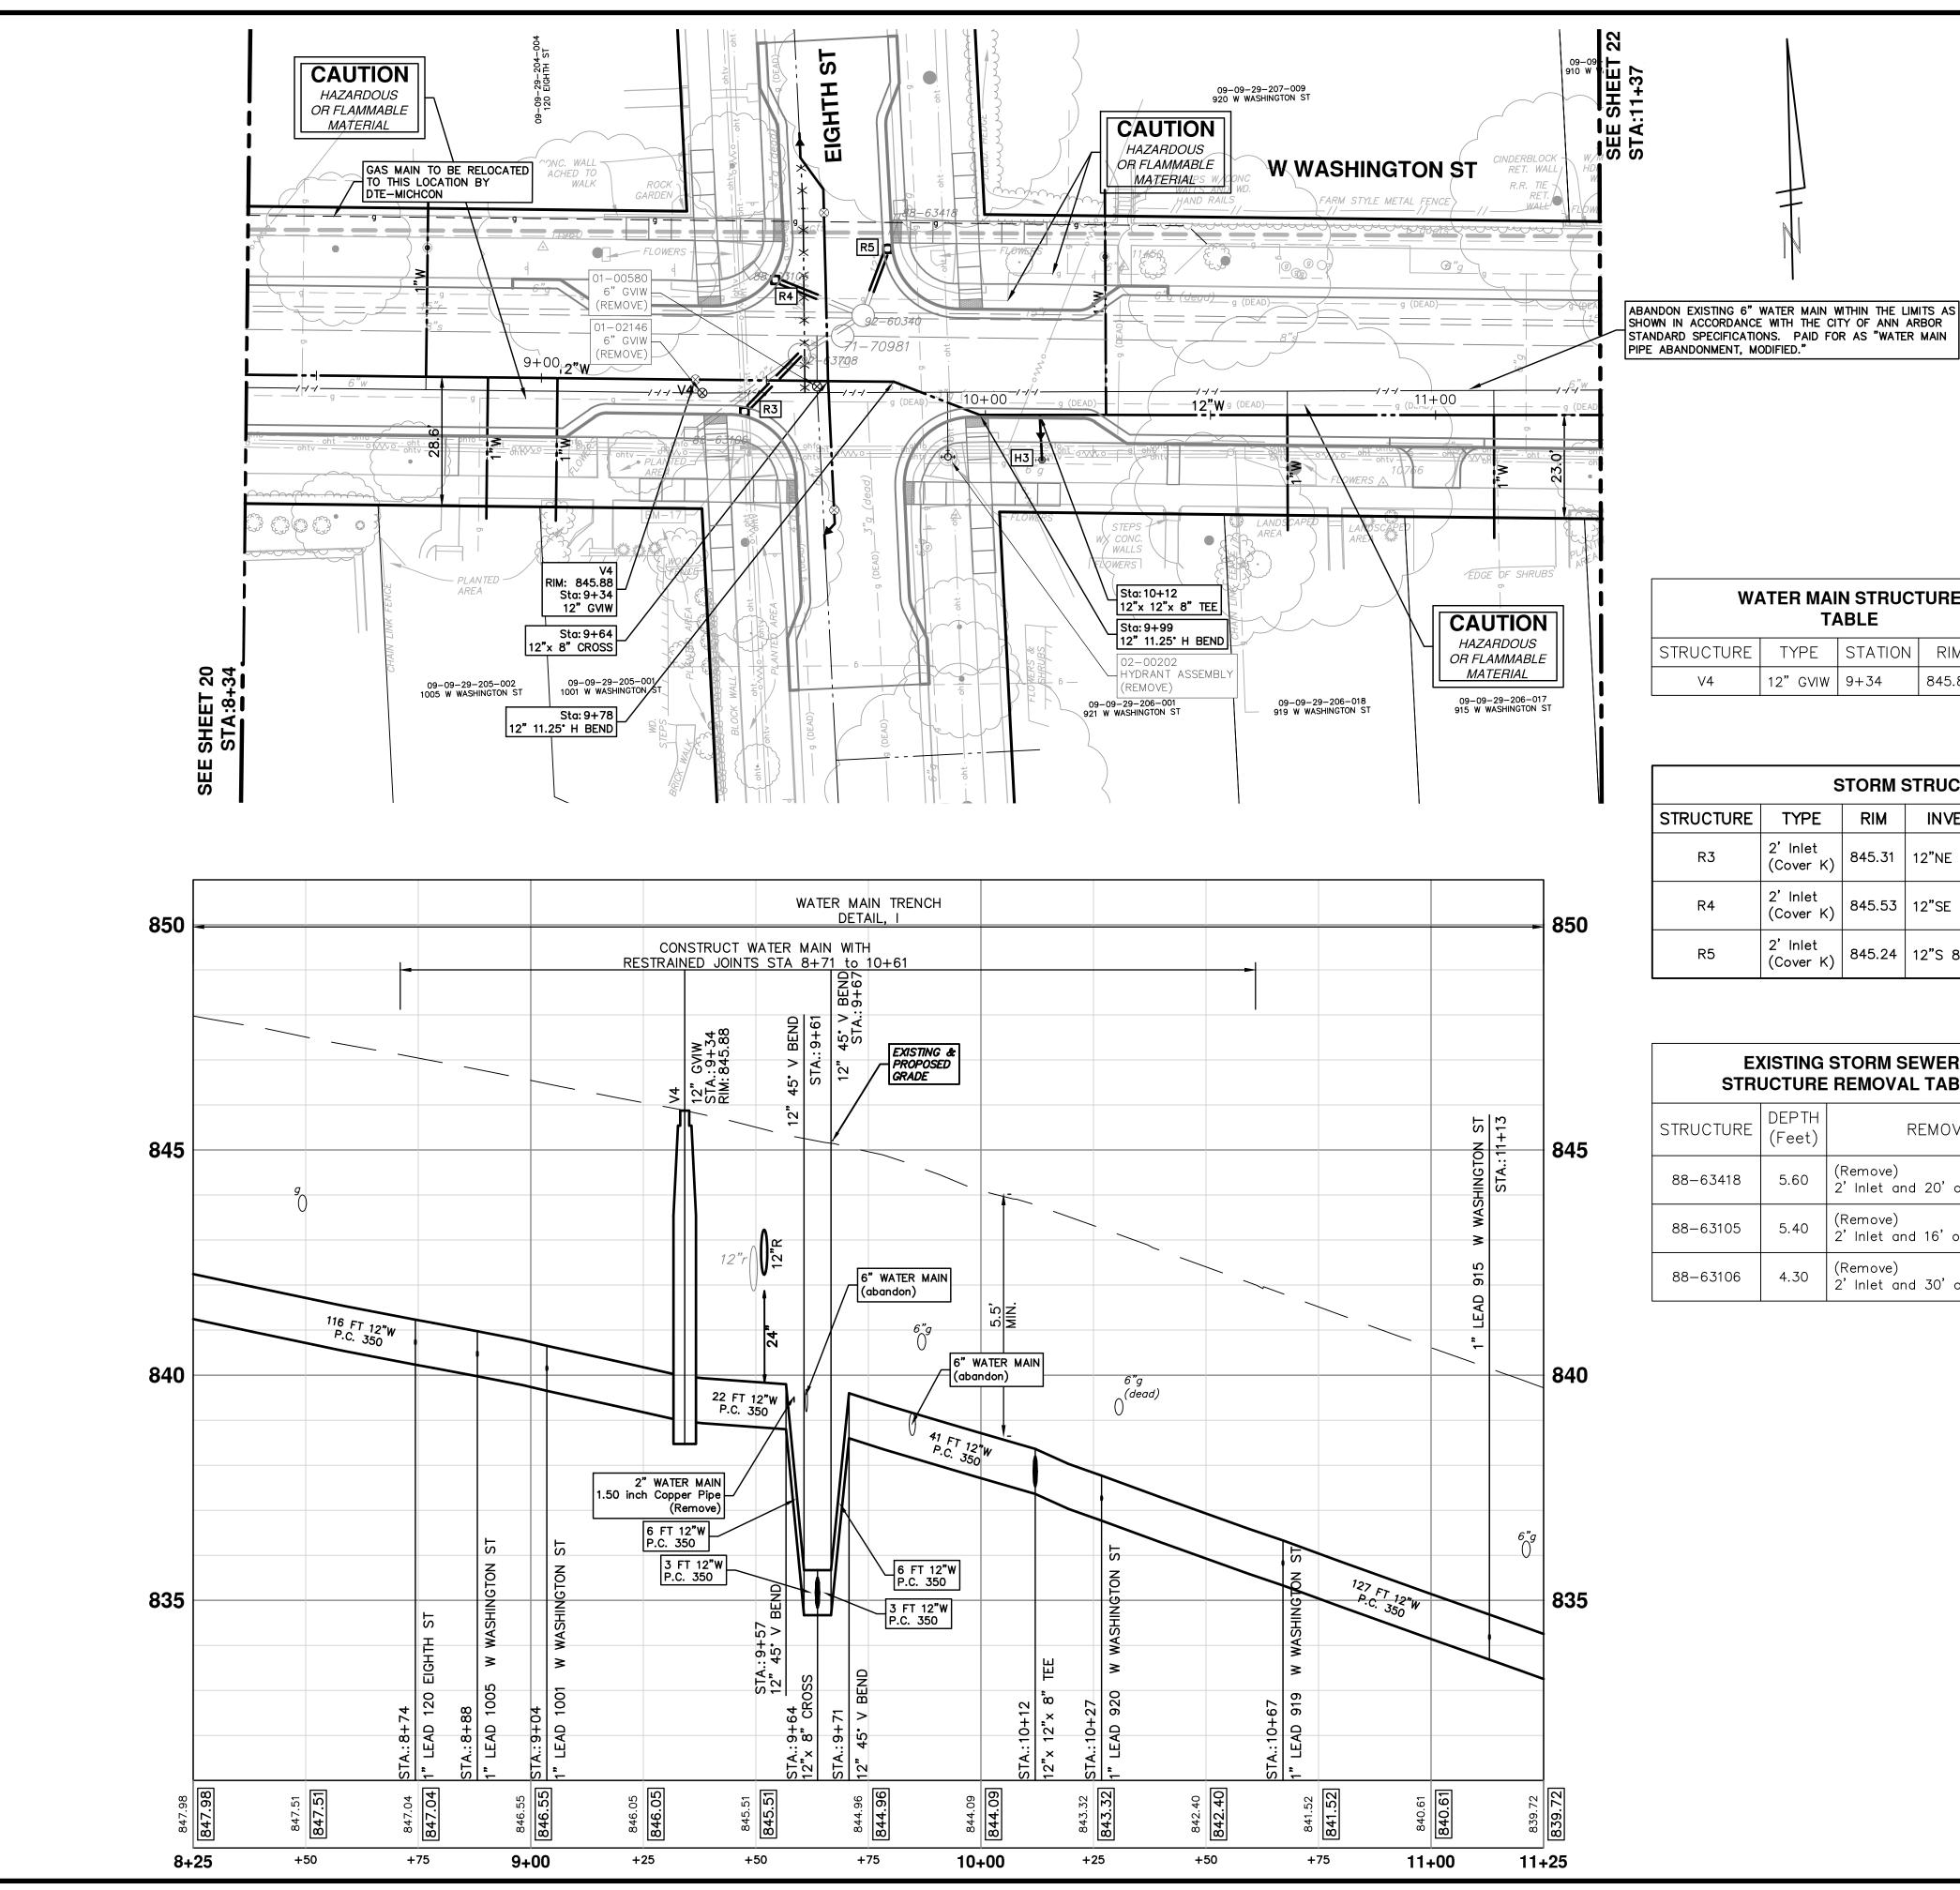


	N STRUC <sup>-</sup> Able	<b>FURE</b>	
TYPE	STATION	RIM	DEPTH
12" GVIW	9+34	845.88	6.91

S	TORM	STRUCTURE <sup>-</sup>	TABLE	
TYPE	RIM	INVERTS	PIPE	SUMP
2' Inlet (Cover K)	845.31	12"NE 842.33	18 LF OF 12" @ 1.03%	2'
2' Inlet (Cover K)	845.53	12"SE 841.21	10 LF OF 12" @ 6.48%	2'
2' Inlet (Cover K)	845.24	12"S 840.80	10 LF OF 12" @ 4.87%	2'

(ISTING STORM SEWER	
JCTURE REMOVAL TABLE	

Dł (F	EPTH Feet)	REMOVE
Ę	5.60	(Remove) 2' Inlet and 20' of 12" pipe
ŗ	5.40	(Remove) 2' Inlet and 16' of 12" pipe
4	4.30	(Remove) 2' Inlet and 30' of 12" pipe

	EITY OF ANN ARBOR	ARBOR - PUBLIC SERVICES - ENGINEERING	<u> </u>							<b>B</b>
21 (	SCALE PLAN: 1" = 20' PROFILE: 1" = 2'			CITY OF ANN ARBOR PUBLIC SERVICES 301 EAST HURON STREET						
DF 4		CREST, BUENA VISTA, WASHINGLON WALER MAIN	DR DR ID	P.O. BOX 8647 ANN ARBOR, MI 48107-8647	01 A	01 ADDENDUM #1	2-23-18	CEC/DPF	JKA	
46	DRAWING NO.	WASHINGTON ST. WATER MAIN PLAN AND PROFILE	A CONTROL OF CONTROL	734-794-6410 www.a2gov.org	00	00 OUT FOR BID	2-6-18	CEC/DPF	AXL	× 
	2016029-21	STA. 8+25 TO STA. 11+25	WICHIGH	<u> </u>	REV.	DESCRIPTION	DATE	DRAWN	DRAWN CHECKED	Call before you dig.

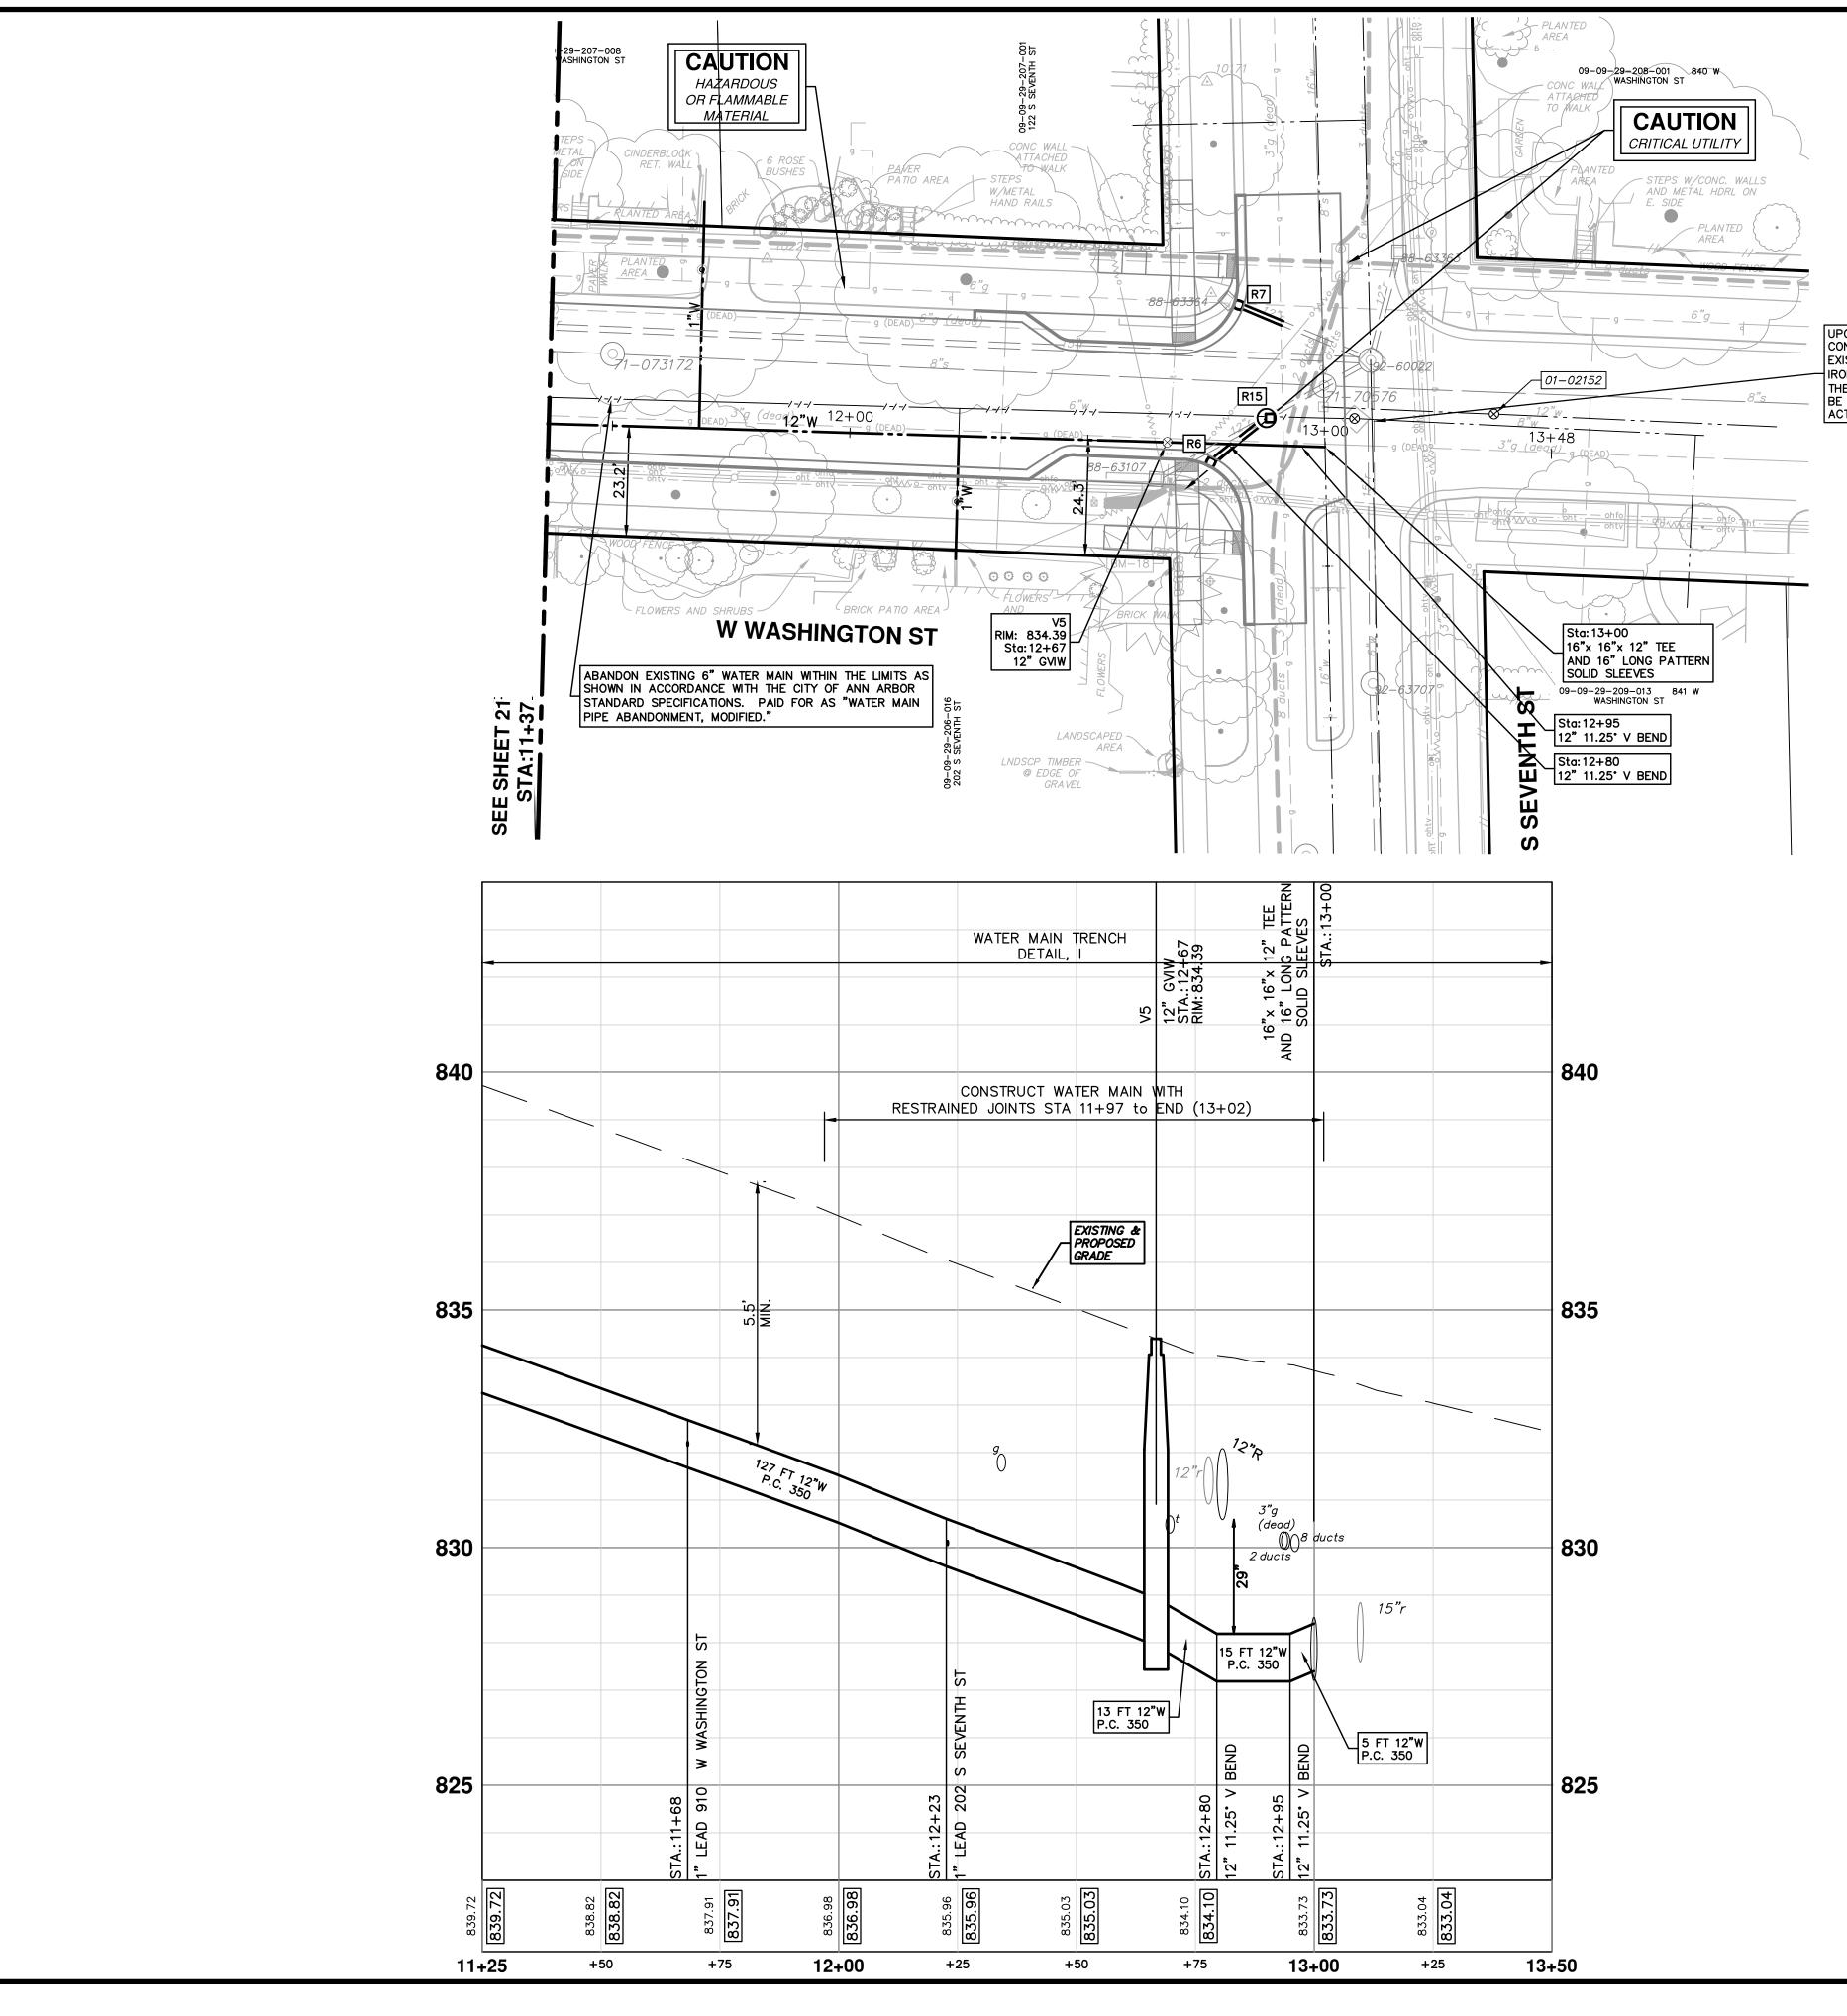


UPON COMPLETION OF THE WATER MAIN IN WASHINGTON STREET, THE CONTRACTOR SHALL REMOVE THE EXISTING CROSS, ABANDON THE EXISTING 6" WATER MAIN, AND PLACE AN 8"x 8" TEE, 8" DUCTILE IRON PIPE AND AN 8" LONG PATTERN SOLID SLEEVES TO RE-ESTABLISH THE 8" WATER MAIN EAST OF S. SEVENTH STREET. THE CONTRACTOR TO BE PAID AT THE CORRESPONDING CONTRACT UNIT PRICES FOR THE ACTUAL WORK PERFORMED.


WA		N STRUC <sup>-</sup> ABLE	<b>FURE</b>	
STRUCTURE	TYPE	STATION	RIM	DEPTH
V5	12" GVIW	12+67	834.39	6.46

	ST	ORM S	TRUCTURE T	ABLE	
STRUCTURE	TYPE	RIM	INVERTS	PIPE	SUMP
R6	2' Inlet (Cover K)	833.87	12"NE 831.08	15 LF OF 12" @ 3.96%	2'
R7	2' Inlet (Cover K)	835.10	12"E 832.13	10 LF OF 12" @ 5.90%	2'
R15	4'Storm MH (Cover B)	834.21	12"SW 830.49	15 LF OF 12" @ 3.96%	2'

	EXISTING STORM SEWER STRUCTURE REMOVAL TABLE					
STRUCTURE	DEPTH (Feet)	REMOVE				
88-63107	4.30	(Remove) 2' Inlet and 26' of 12" pipe				
88-63364	4.70	(Remove) 2' Inlet and 13' of 12" pipe				

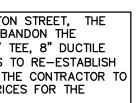

SHE	CITY OF ANN ARBOR	ARBOR - PUBLIC SERVICES - ENGINEERING	ANA							
				CITY OF ANN ARBOR						
「 № 22	SCALE PLAN: 1" = 20' PROFILE: 1" = 2'		PUBL	PUBLIC SERVICES						
10. 0		CDECT BIJENA VICTA WACHINGTON WATED MAIN	(E/ 301 EAS	301 EAST HURON STREET						
)F			C ANN ARE	P.O. BOX 8647 ANN ARBOR, MI 48107-8647	01 AL	01 ADDENDUM #1	2-23-18	CEC/DPF	JKA	
46	DRAWING No.	WASHINGTON ST. WATER MAIN PLAN AND PROFILE	22 MMM	734-794-6410 www.a2gov.org	00 01	00 OUT FOR BID	2-6-18	CEC/DPF	JKA	Know what's below
	2016029-22	STA. 11+25 TO STA. 13+80	W/CHIGA	1	REV.	DESCRIPTION	DATE	DRAWN	DRAWN CHECKED	Gall before you dig.

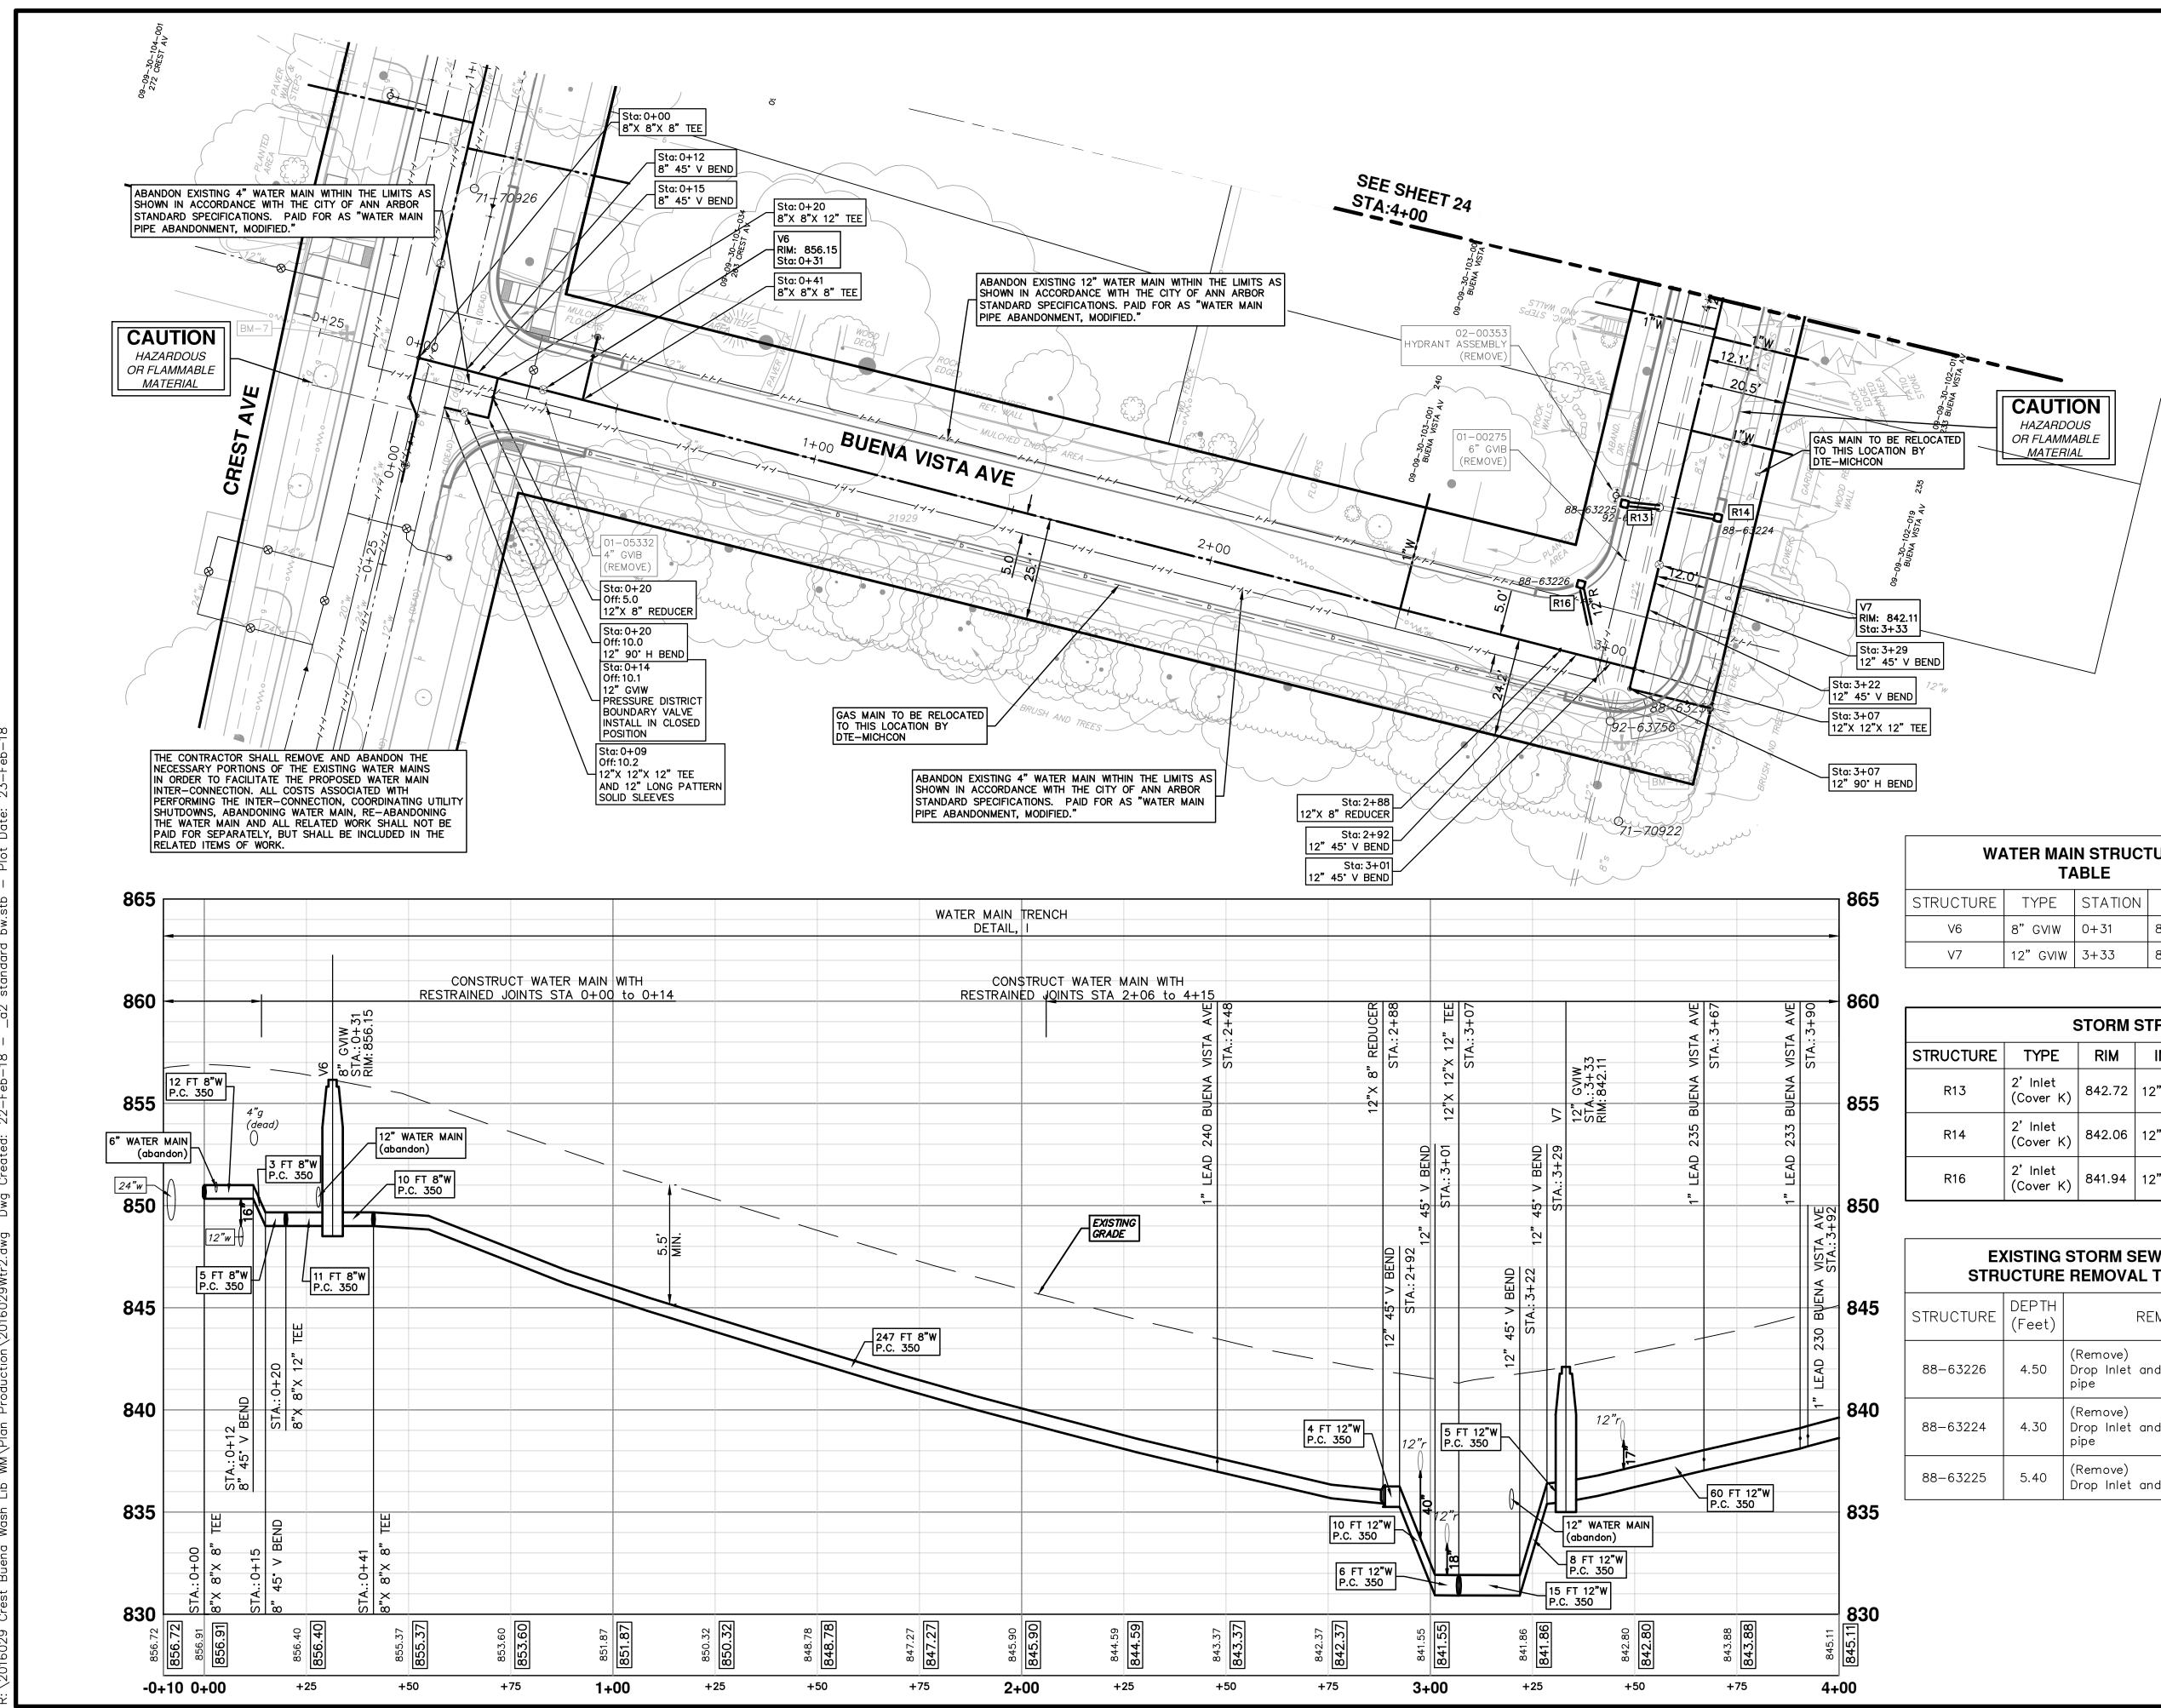

			'DPF JKA	JKA	DRAWN CHECKED Call before you dig.
			2-23-18 CEC/DPF	2-6-18 CEC/DPF	DATE DRA
			01 ADDENDUM #1	00 OUT FOR BID	DESCRIPTION
	BOB	rreet			REV.
ANN	OF FOUNDER NAME OF ANN ARBOR	E BOULD STREET	O P.O. BOX 8647 ANN ARBOR, MI 48107-8647	734-794-6410 Www.a2gov.org	CHIGA
		<b>NATER MAIN</b>		AD PROFILE	
<b>ARBOR - PUBLIC SERVICES - ENGINEERING</b>		<b>CREST. BUENA VISTA. WASHINGTON WATE</b>		RUFNA VISTA AVENUE WATER MAIN PLAN AND PROI	STA. 0+00 TO STA. 4+00


WATER MAIN STRUCTURE TABLE							
RUCTURE	TYPE	STATION	RIM	DEPTH			
V6	8" GVIW	0+31	856.15	7.15			
V7	V7 12" GVIW 3+33 842.11 6.61						

	STORM STRUCTURE TABLE							
RUCTURE	TYPE	RIM	INVERTS	PIPE	SUMP			
R13	2' Inlet (Cover K)	842.72	12"E 838.95	9 LF OF 12" @ 8.97%	2'			
R14	2' Inlet (Cover K)	842.06	12"W 839.50	10 LF OF 12" @ 9.06%	2'			
R16	2' Inlet (Cover K)	841.94	12"SE 838.92	10 LF OF 12" @ 10.23%	2'			

EXISTING STORM SEWER
STRUCTURE REMOVAL TABLE


RUCTURE	DEPTH (Feet)	REMOVE
3–63226	4.50	(Remove) Drop Inlet and 10' of 12" pipe
3–63224	4.30	(Remove) Drop Inlet and 10' of 12" pipe
3–63225	5.40	(Remove) Drop Inlet and 8' of 12" pipe

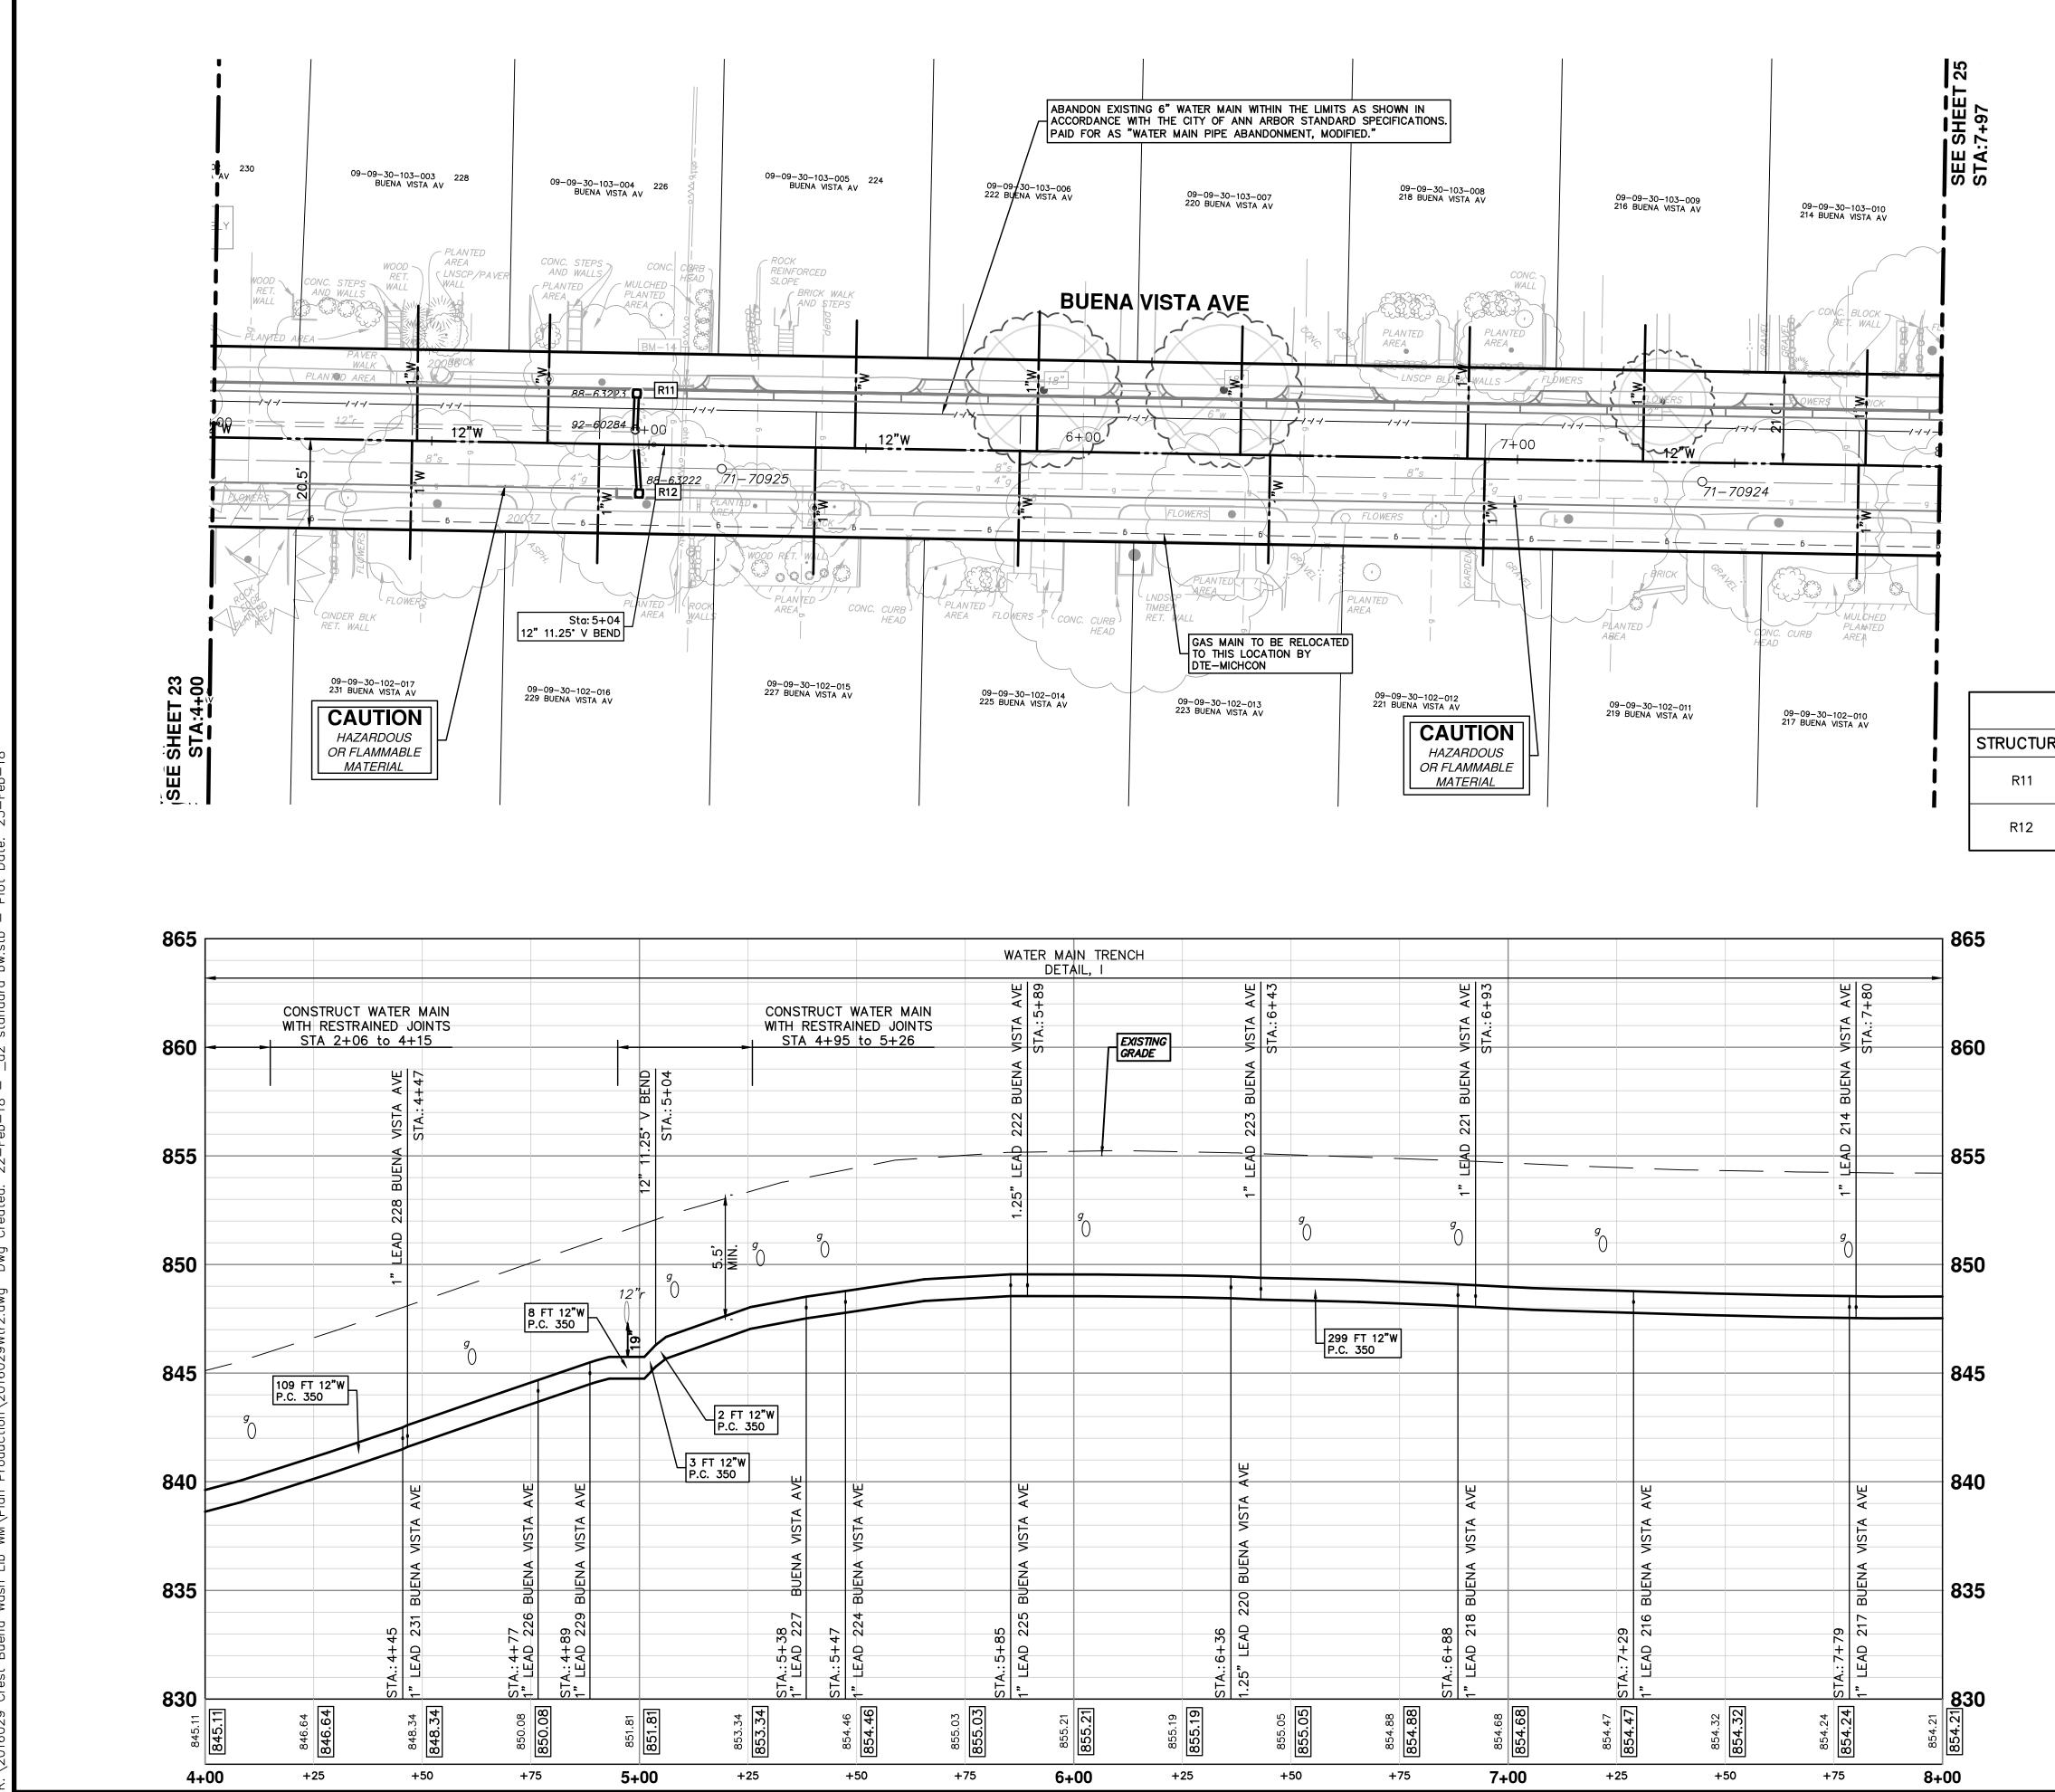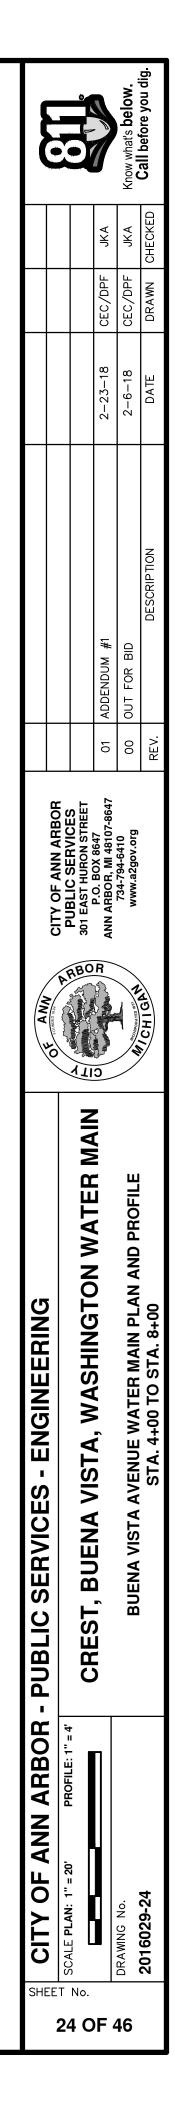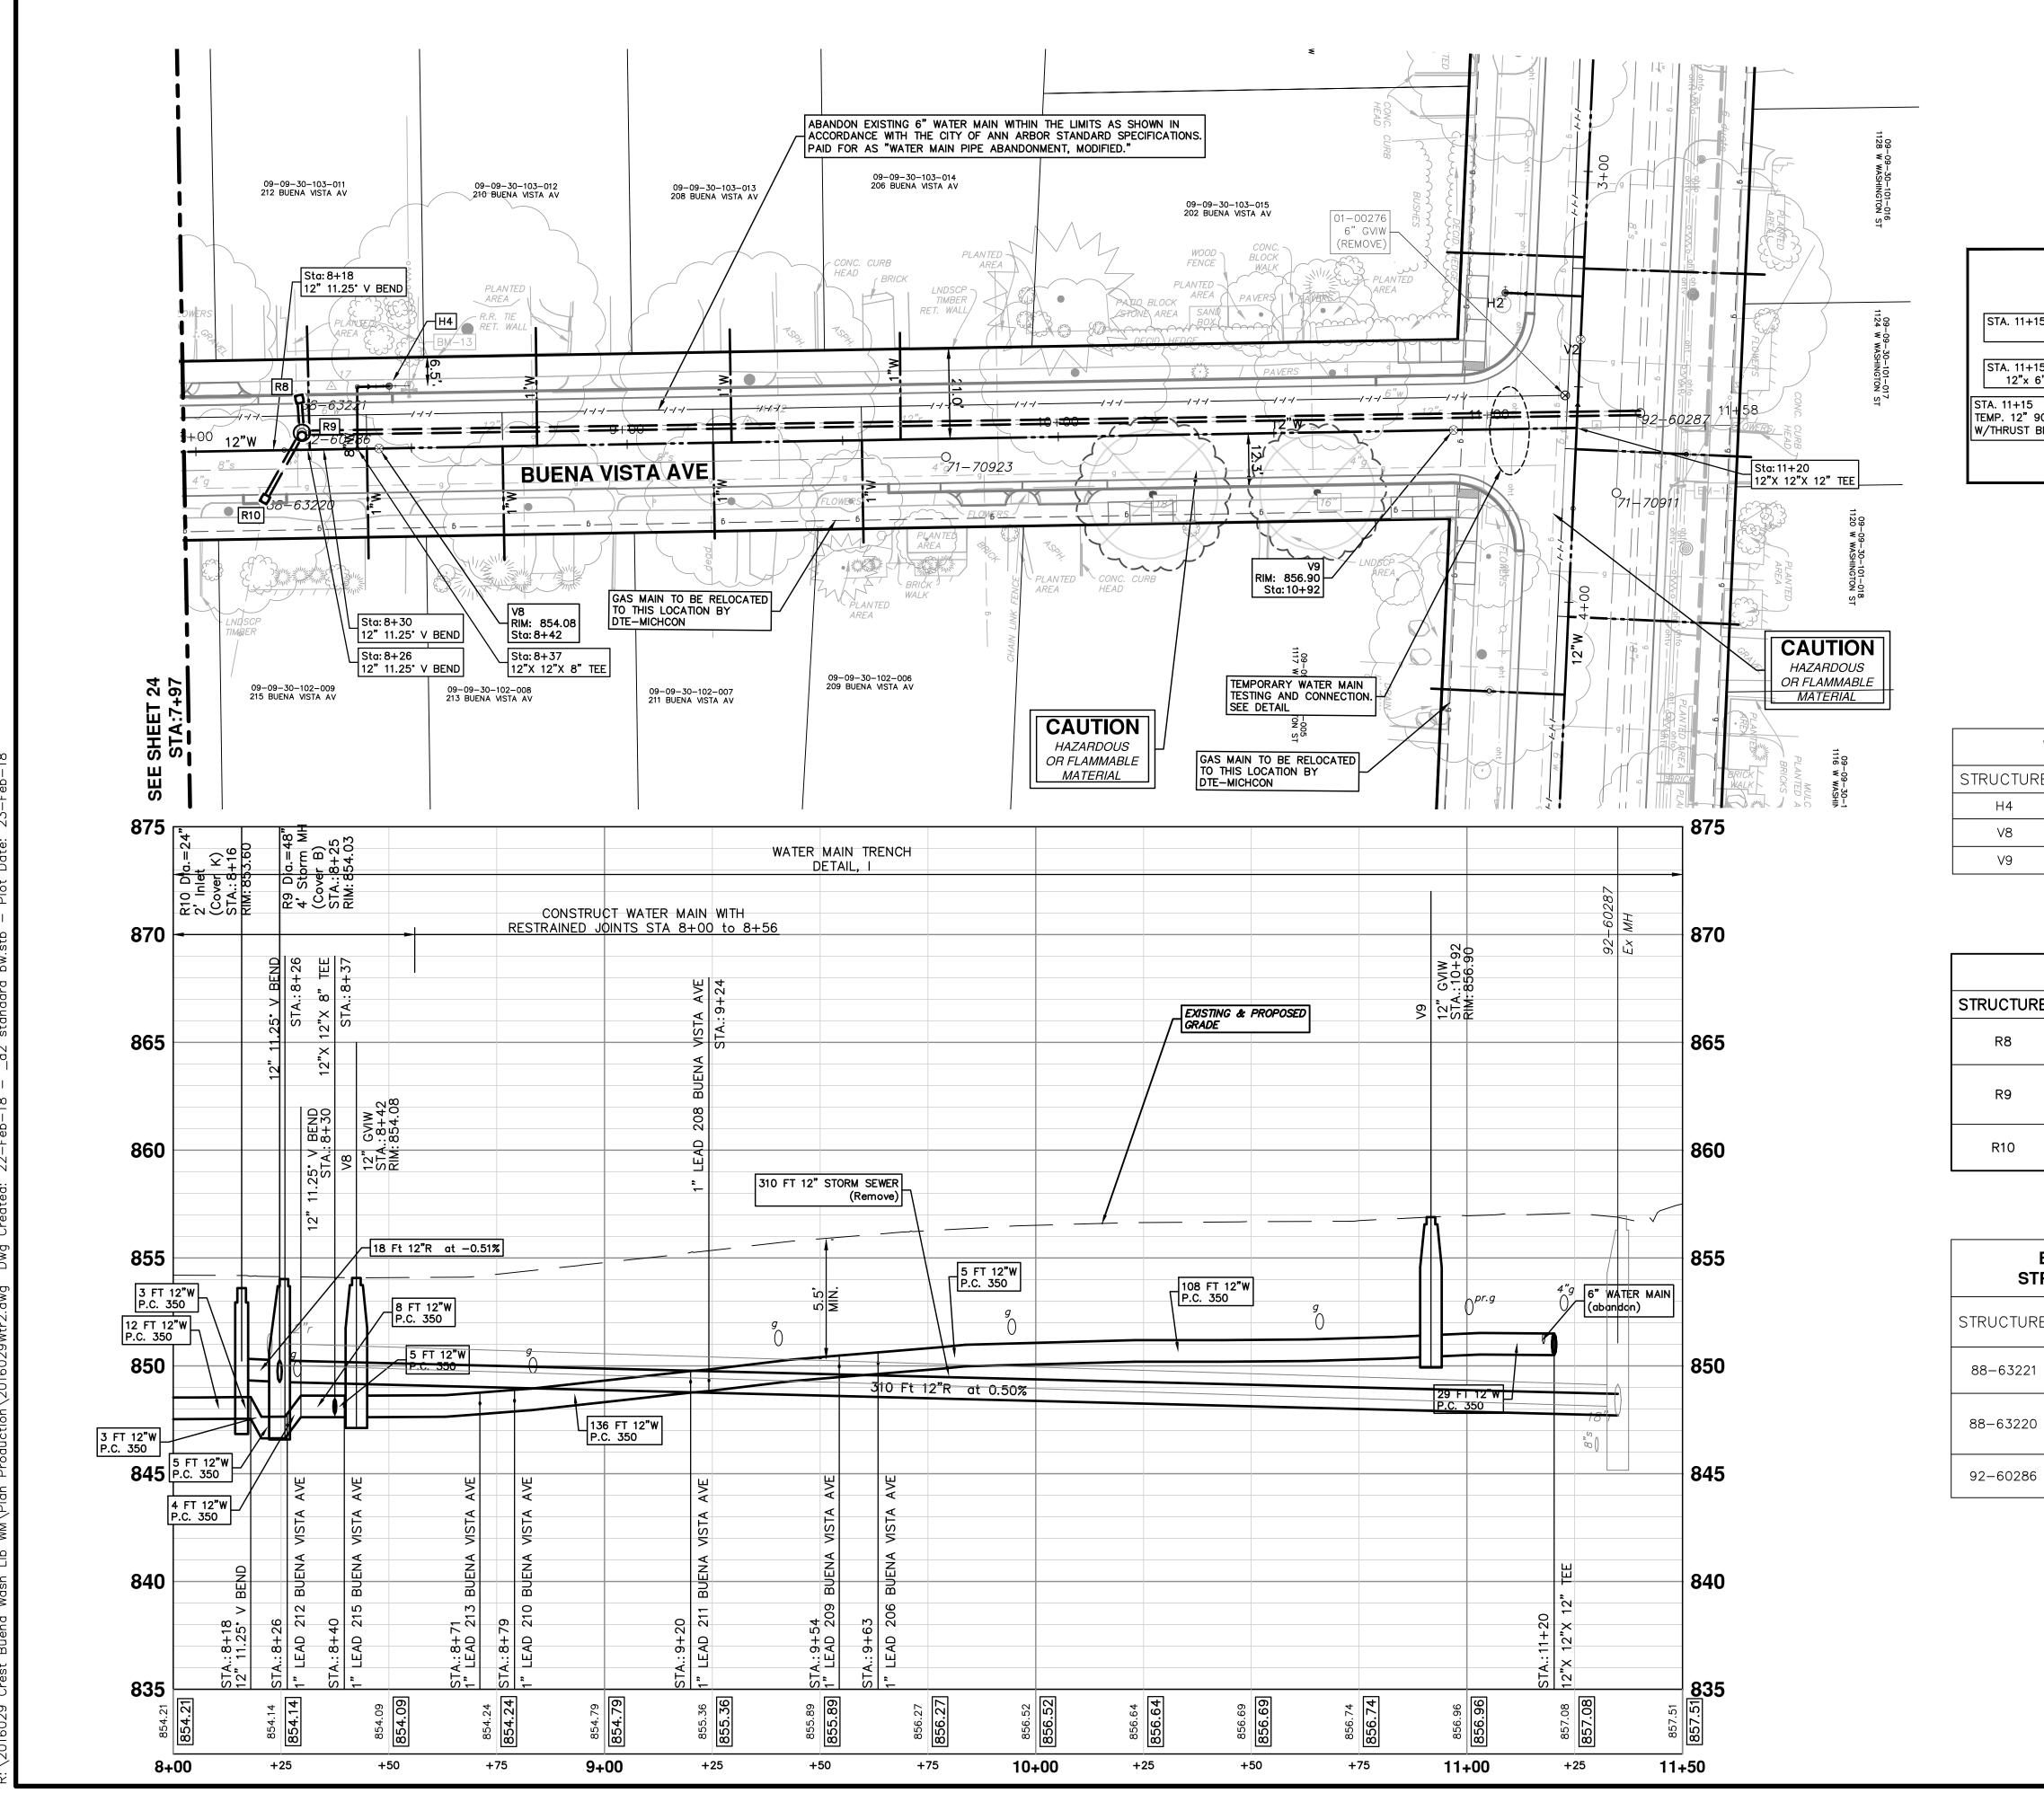
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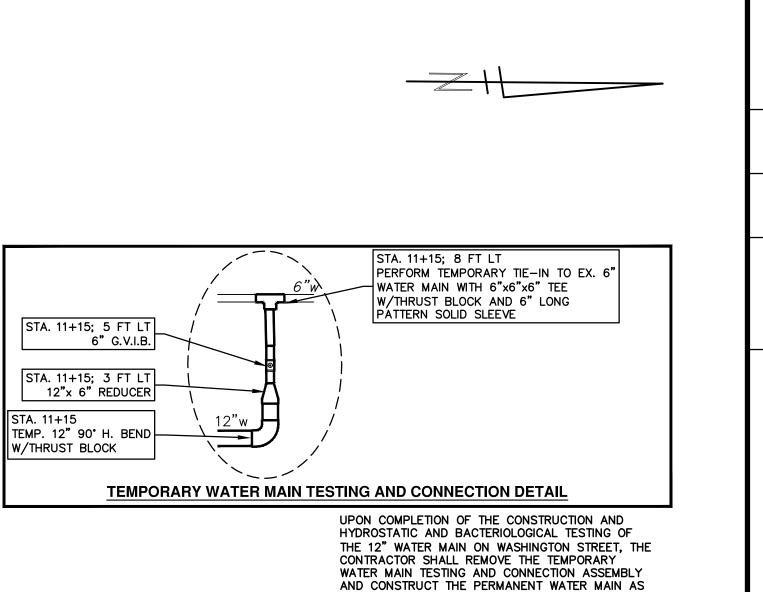


	STORM STRUCTURE TABLE							
RE	TYPE	RIM	INVERTS	PIPE	SUMP			
	2' Inlet (Cover K)	851.65	12"E 847.89	8 LF OF 12" @ 9.63%	2'			
	2' Inlet (Cover K)	851.11	12"W 847.97	10 LF OF 12" @ 6.03%	2'			

		STORM SEWER REMOVAL TABLE
STRUCTURE	DEPTH (Feet)	REMOVE
88-63222	5.10	(Remove) Drop Inlet and 10' of 12" pipe
88-63223	5.45	(Remove) Drop Inlet and 8' of 12" pipe







SHOWN. ALL WORK ASSOCIATED WITH REMOVING THE TEMPORARY TESTING CONNECTION AND CONSTRUCTING THE FINAL, PERMANENT, CONNECTION WILL NOT BE PAID FOR SEPARATELY, BUT SHALL BE INCLUDED IN THE RELATED ITEMS OF WORK.

W	WATER MAIN STRUCTURE TABLE							
E	TYPE	STATION	RIM	DEPTH				
	HYDRANT ASSEMBLY	0+22	854.18	6.00				
	12" GVIW	8+42	854.08	6.46				
	12" GVIW	10+92	856.90	6.47				

Η4

V8

V9


R8


R9


	S	TORM S	TRUCTURE T	ABLE	
RE	TYPE	RIM	INVERTS	PIPE	SUMP
	2' Inlet (Cover K)	853.66	12"E 849.29	8 LF OF 12" @ 0.51%	2'
	4'Storm MH (Cover B)	854.03	12"N 849.25 12"W 849.25 12"SE 849.25	310 LF OF 12" @ 0.50% 8 LF OF 12" @ 0.51% 18 LF OF 12" @ 0.51%	2'
	2' Inlet (Cover K)	853.60	12"NW 849.34	18 LF OF 12" @ 0.51%	2'

EXISTING STORM SEWER
STRUCTURE REMOVAL TABLE

	-	
E	DEPTH (Feet)	REMOVE
	4.50	(Remove) Drop Inlet and 8' of 12" pipe
	4.35	(Remove) Drop Inlet and 18' of 12" pipe
	6.10	(Remove) 4'MH

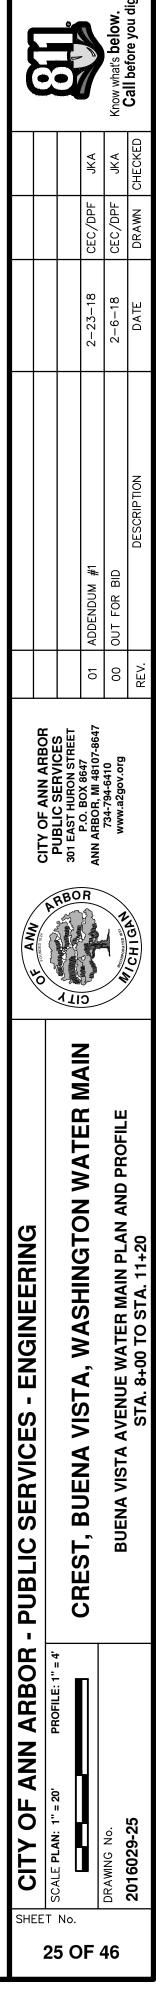

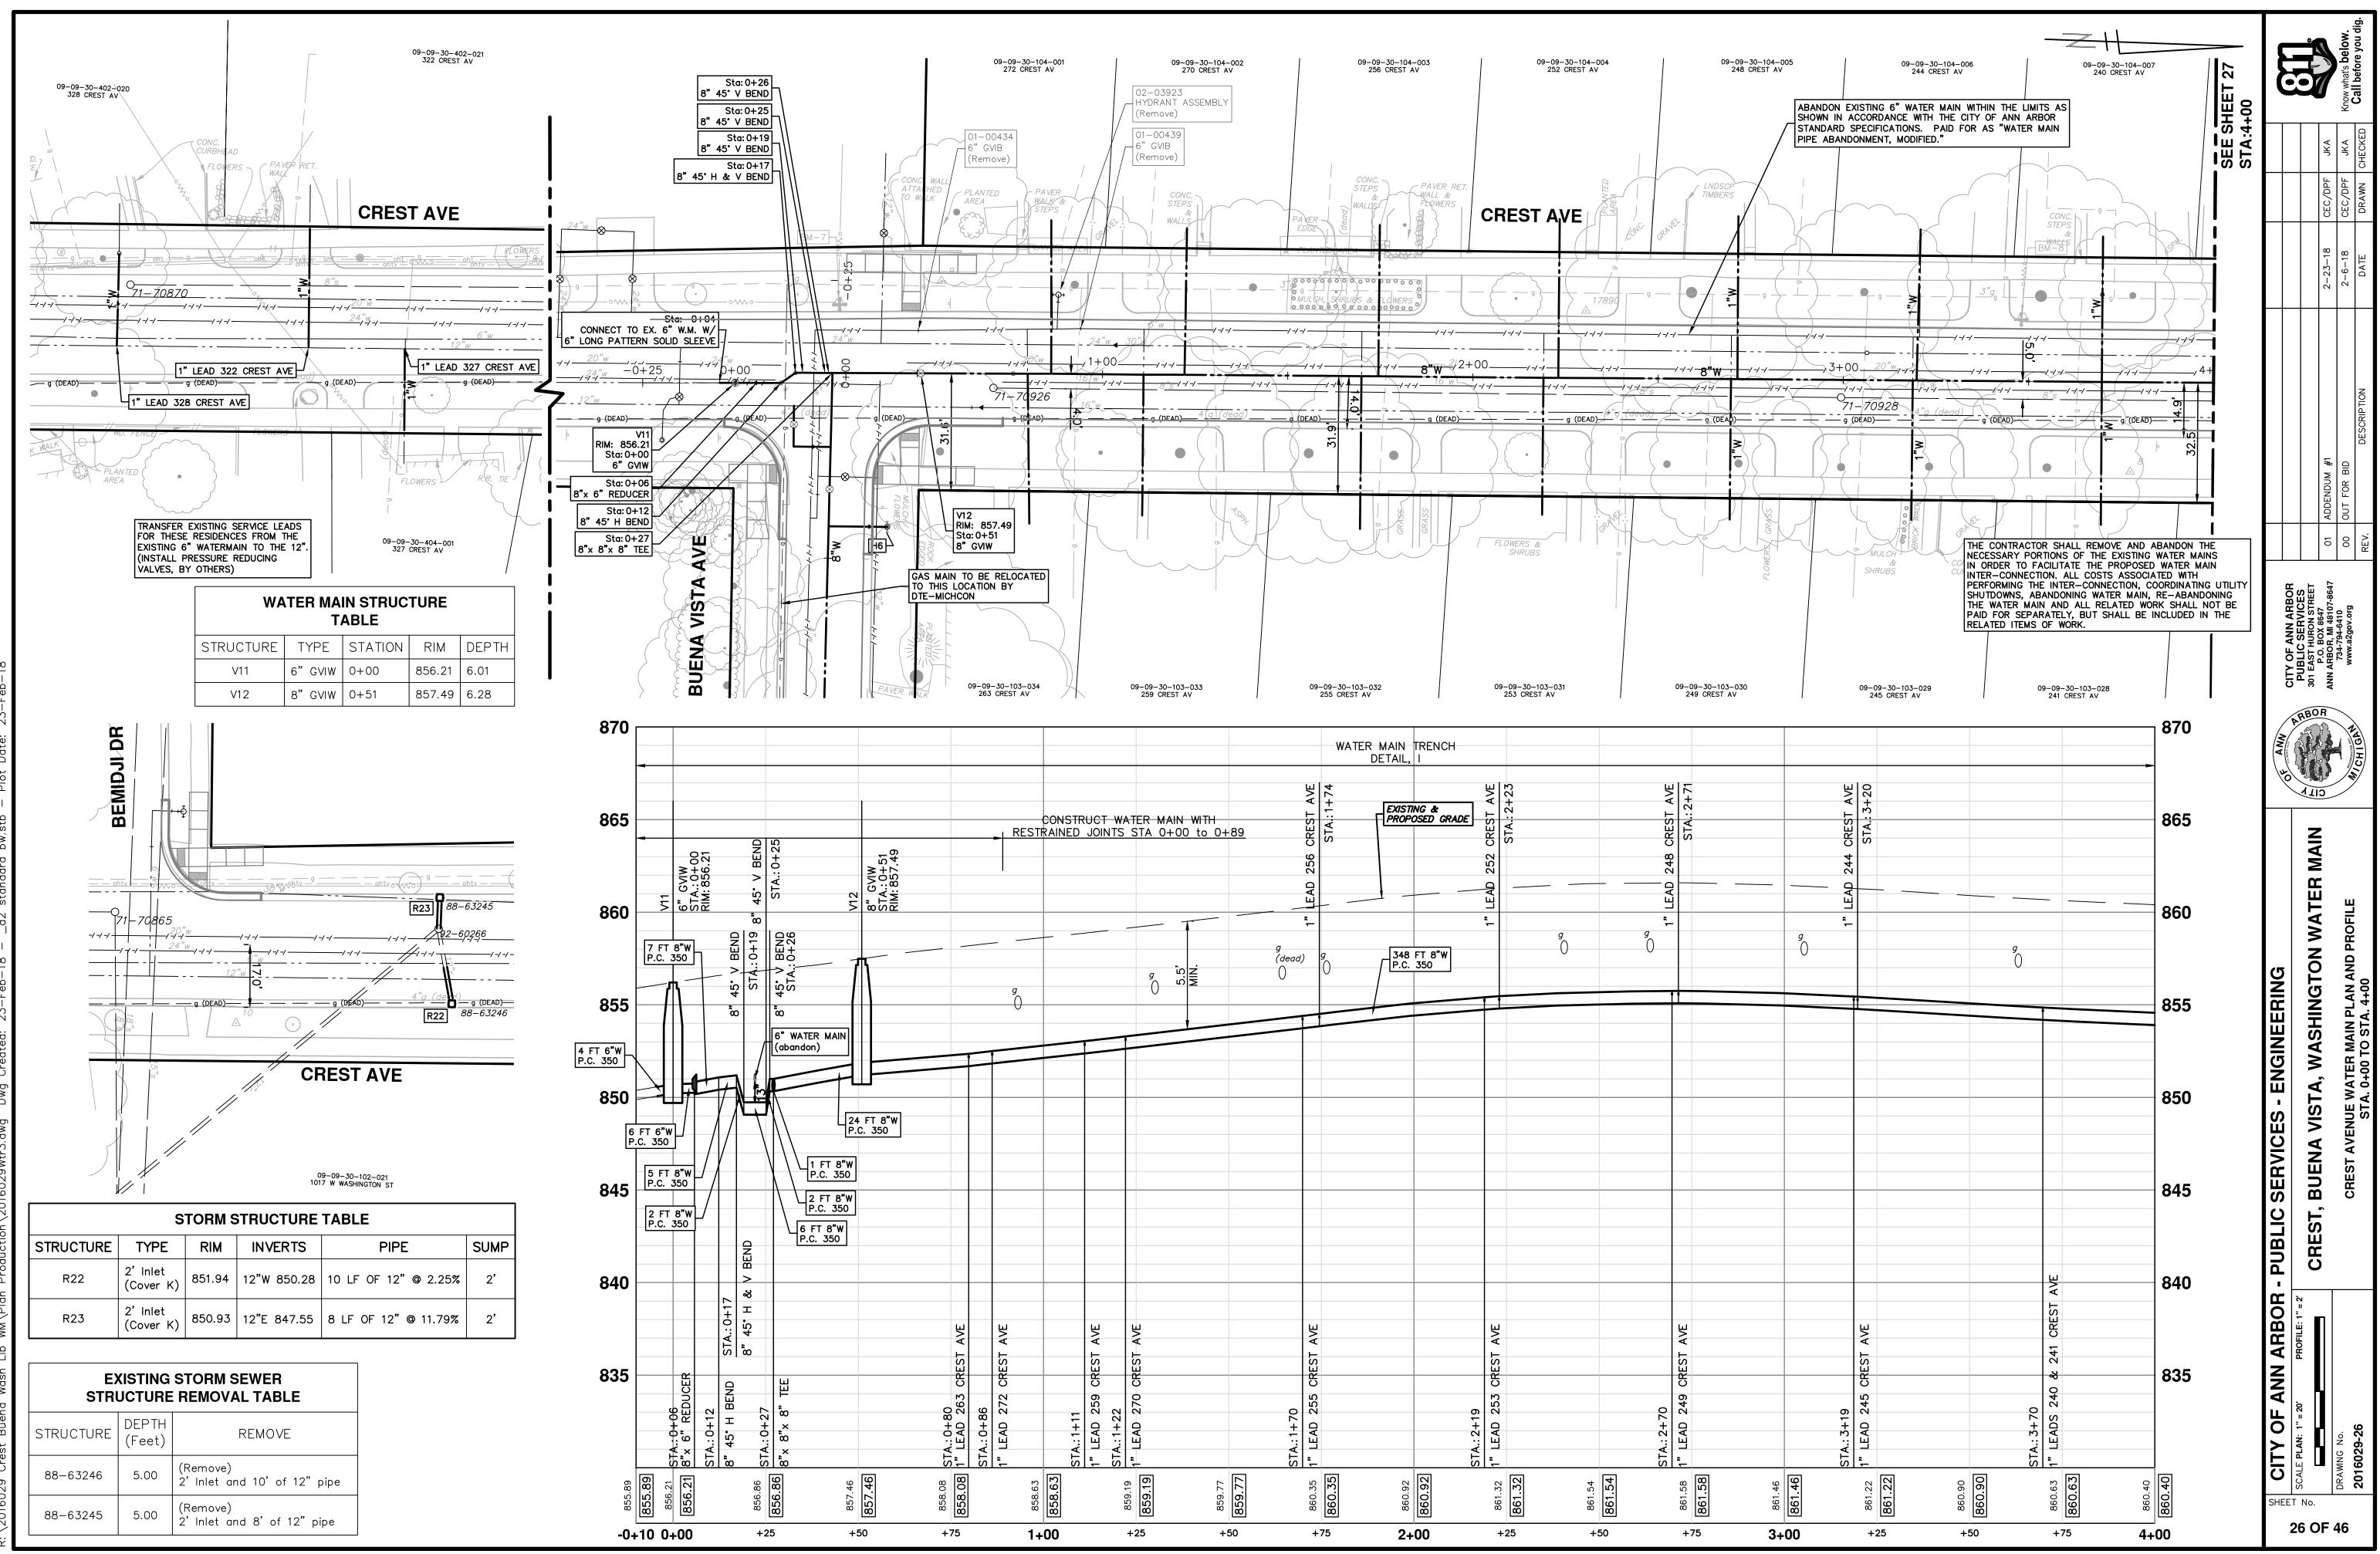

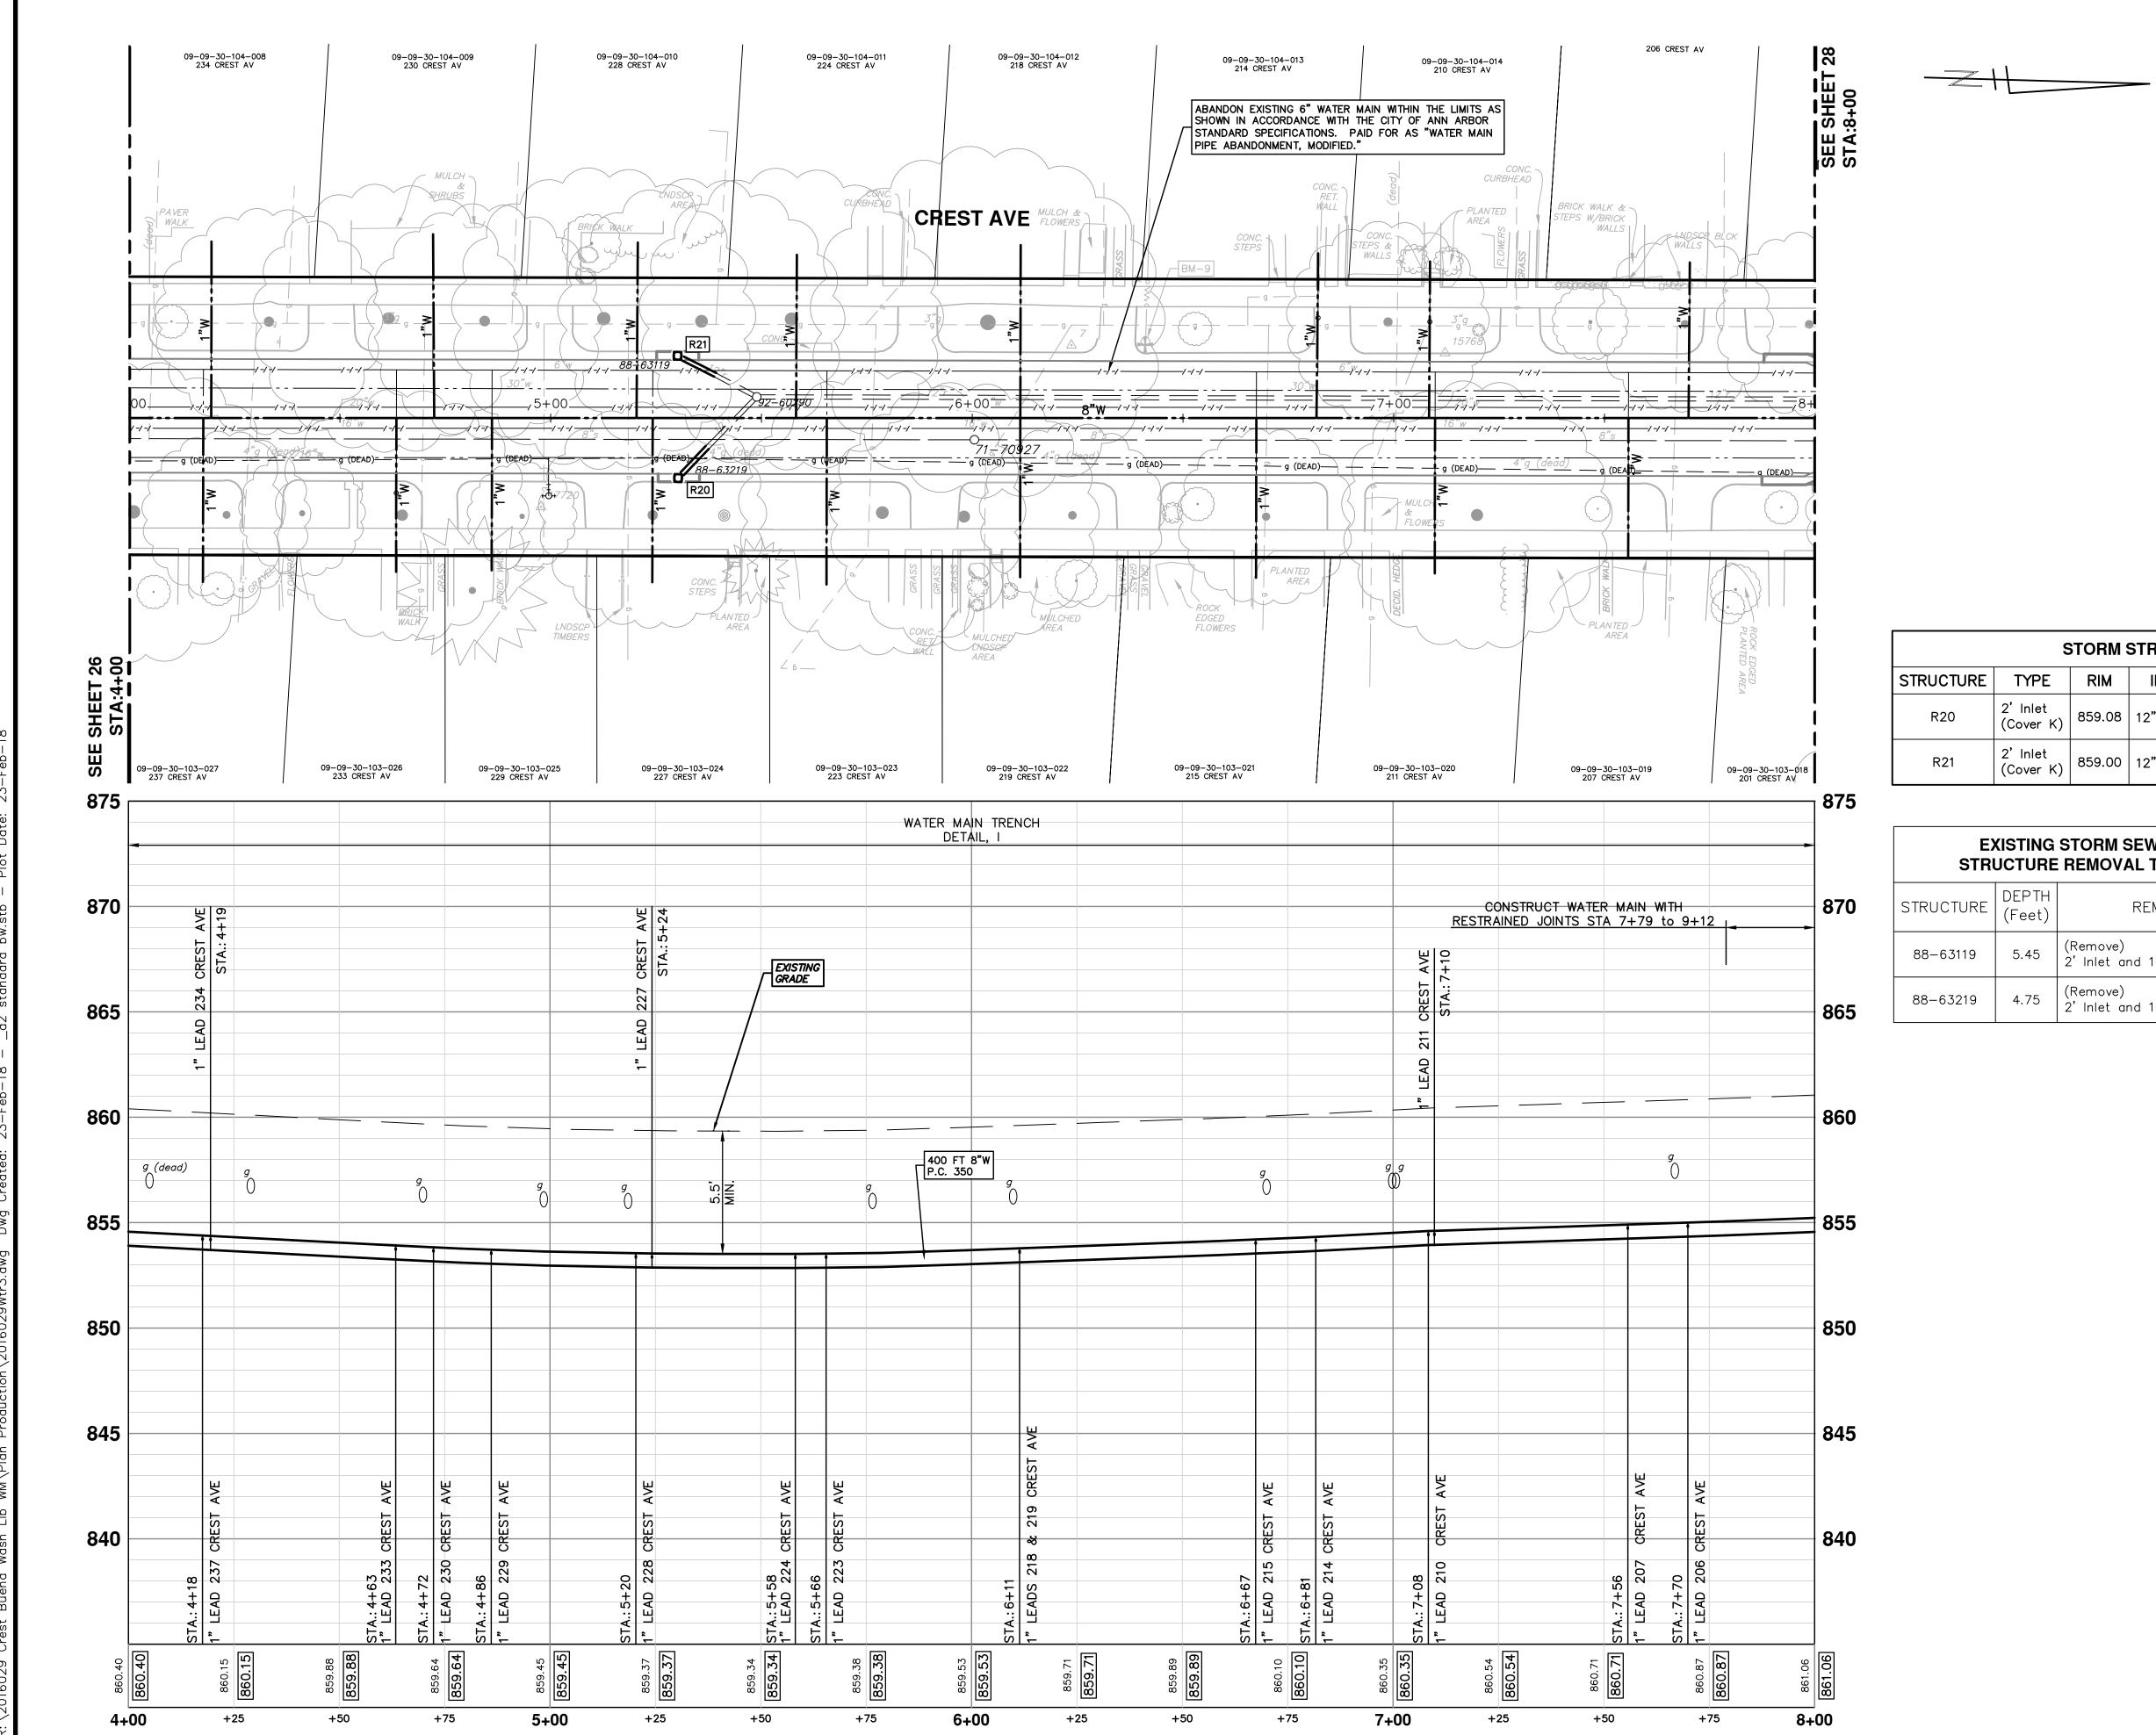


	<b>EXAMPLE CITY OF ANN ARBOR</b>	ARBOR - PUBLIC SERVICES - ENGINEERING	ANN						
			CITY OF ANN ARROR						
27									
		CREST, BUENA VISTA, WASHINGTON WATER MAIN	EVENT AND						
)F			O O S S S S S S S S S S S S S S S S S S		01 ADDENDUM #1	2-23-18	CEC/DPF	ЧКА	
46	DRAWING No.	CBEST AVENILE WATER MAIN PLAN AND BROFILE	734-794-6410 www.a2dov.org		00 OUT FOR BID	2-6-18	CEC/DPF	ЧКА	Know what's below.
	2016029-27	STA. 4+00 TO STA. 8+00	W/CHIGAR	REV.	DESCRIPTION	DATE	DRAWN	CHECKED	Call before you dig.

9	STORM STRUCTURE TABLE									
TYPE RIM INVERTS PIPE S										
2' Inlet (Cover K)	859.08	12"NW 856.06	10 LF OF 12" @ 0.49%	2'						
2' Inlet (Cover K)	859.00	12"NE 855.24	10 LF OF 12" @ 1.46%	2'						


## **EXISTING STORM SEWER** STRUCTURE REMOVAL TABLE

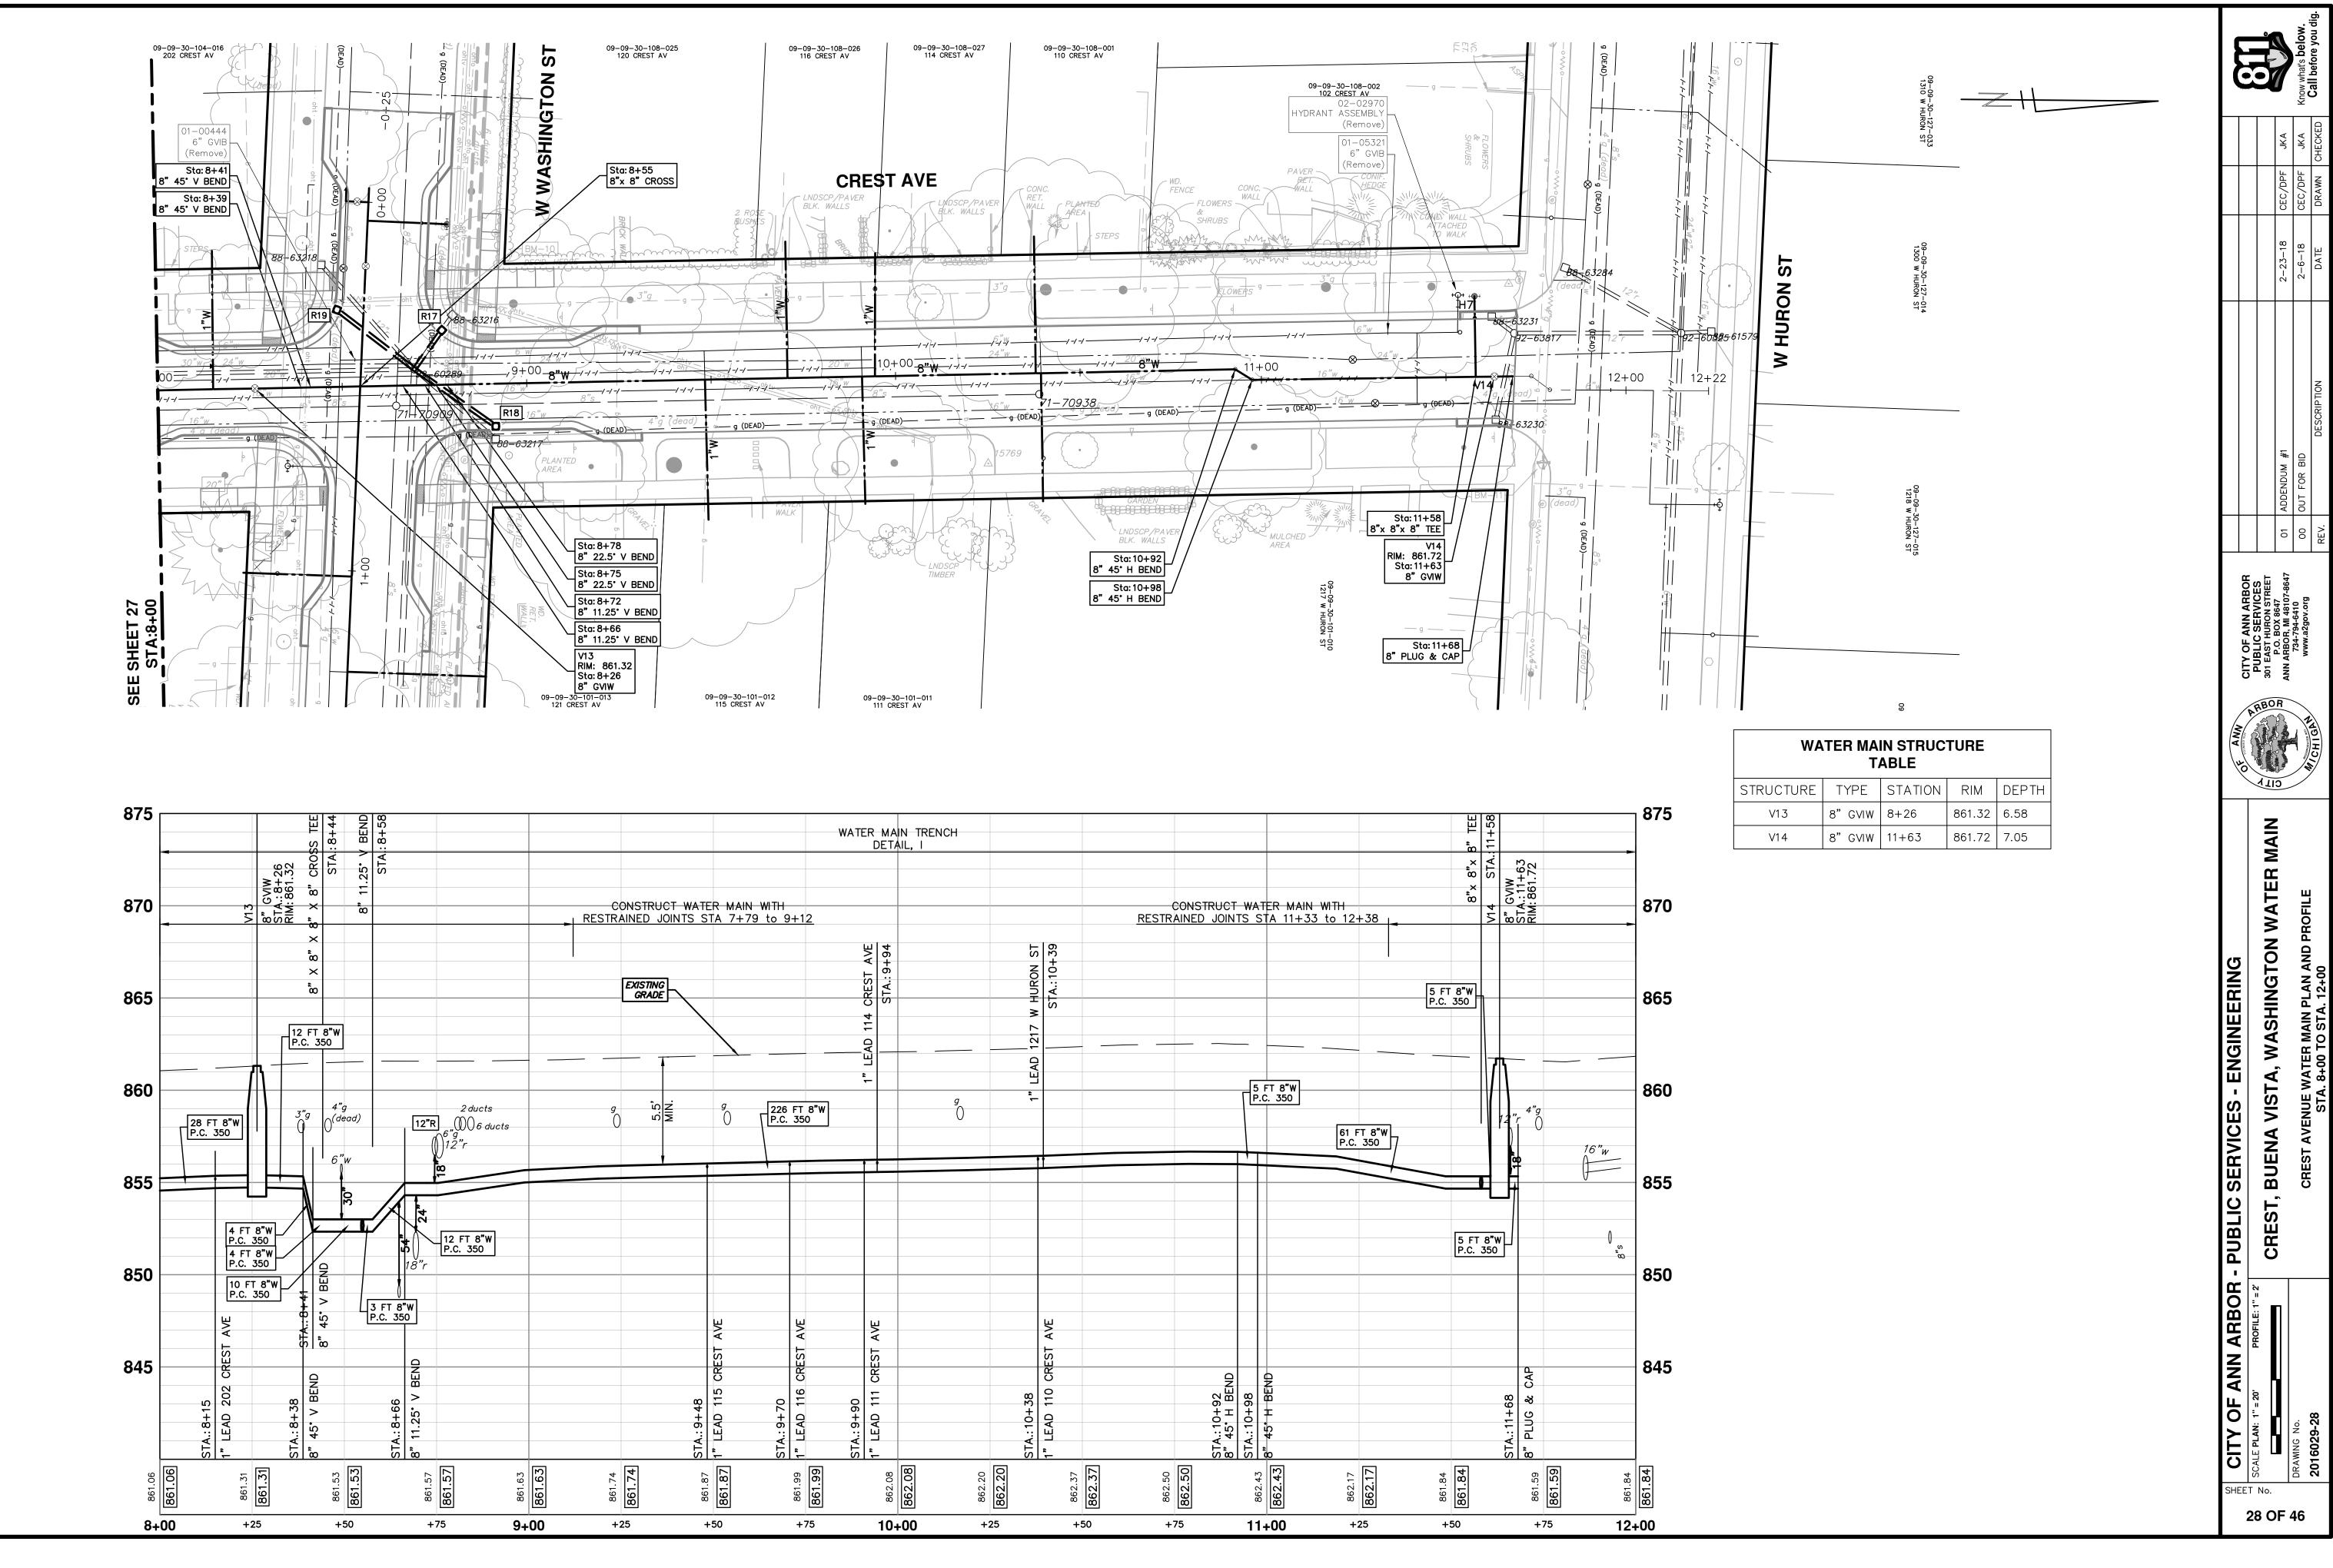
DEPTH (Feet)	REMOVE
5.45	(Remove) 2' Inlet and 10' of 12" pipe
4.75	(Remove) 2' Inlet and 10' of 12" pipe



861.99 <b>861.99</b>	1" LEAD 116 CREST AVE	5 FT 8"W 2 350		9+12	
	STA.: 9+90 1"   EAD 111 CBEST AVE	1" LEAD	114 CREST AVE		
			STA.: 9+94		) F I A
862.08		g ()			N TRENCH IL, I
862.20	STA.: 10+38	1	>		
862.37	1" LEAD 110 CREST AVE	) j			
862.37				RE	
862.50				( STR	
862.50	STA.:10+92 8" 45 H BEND			CONSTRUCT	
27 730	STA.: 10+98			WA	
862.43	8" 45°	FT 8"W .C. 350		T <del>ER MAIN</del> STA 11+33	
862.17		61 F P.C.		WITH to 12-	
<b>862.17</b> 861.84		FT 8"W 350 7	5 F P.C.	+38  -	
861.84	5 FT P.C.		г 8"W 350	8 * 8 * 8	, m
					11+58
861.59	CAP	, 4"g		STA.: 11+63 RIM: 861.72	
861.59		)			
861.84	\$ 8	76 "w			ł
861.84	85	860	865	870	

VV A		ABLE	IURE	
STRUCTURE	TYPE	STATION	RIM	DEPTH
V13	8" GVIW	8+26	861.32	6.58
V14	8" GVIW	11+63	861.72	7.05

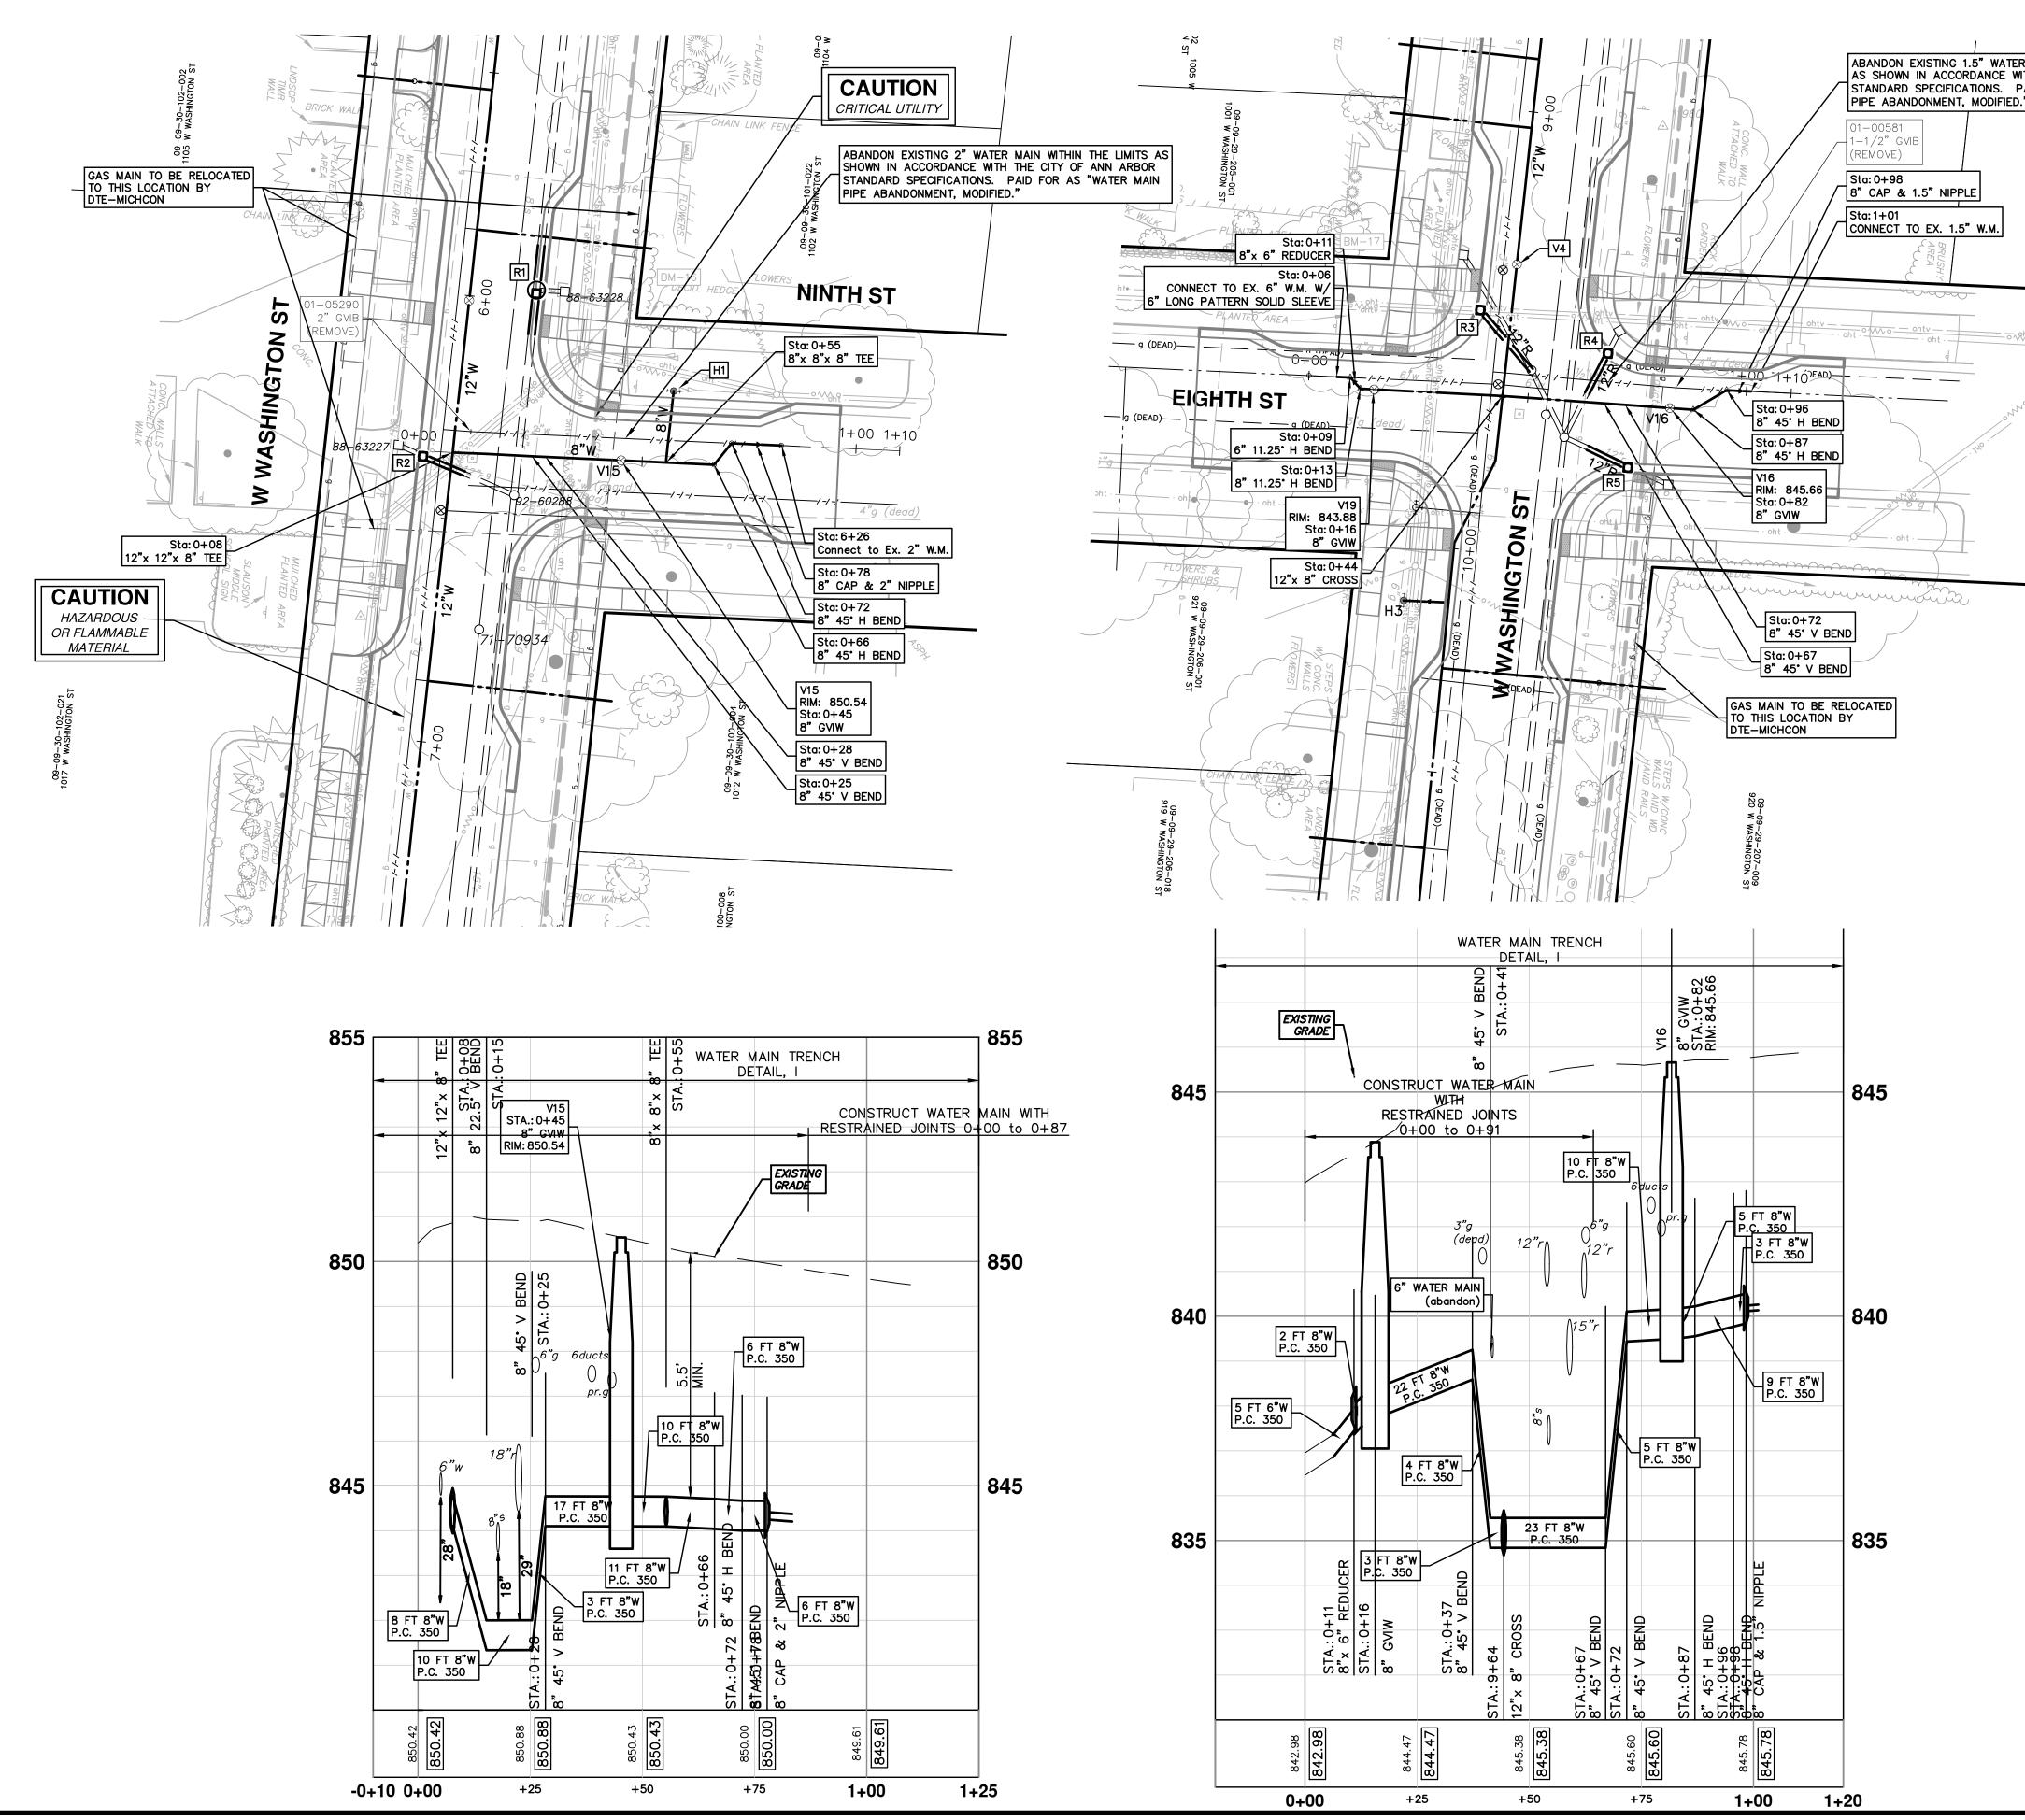


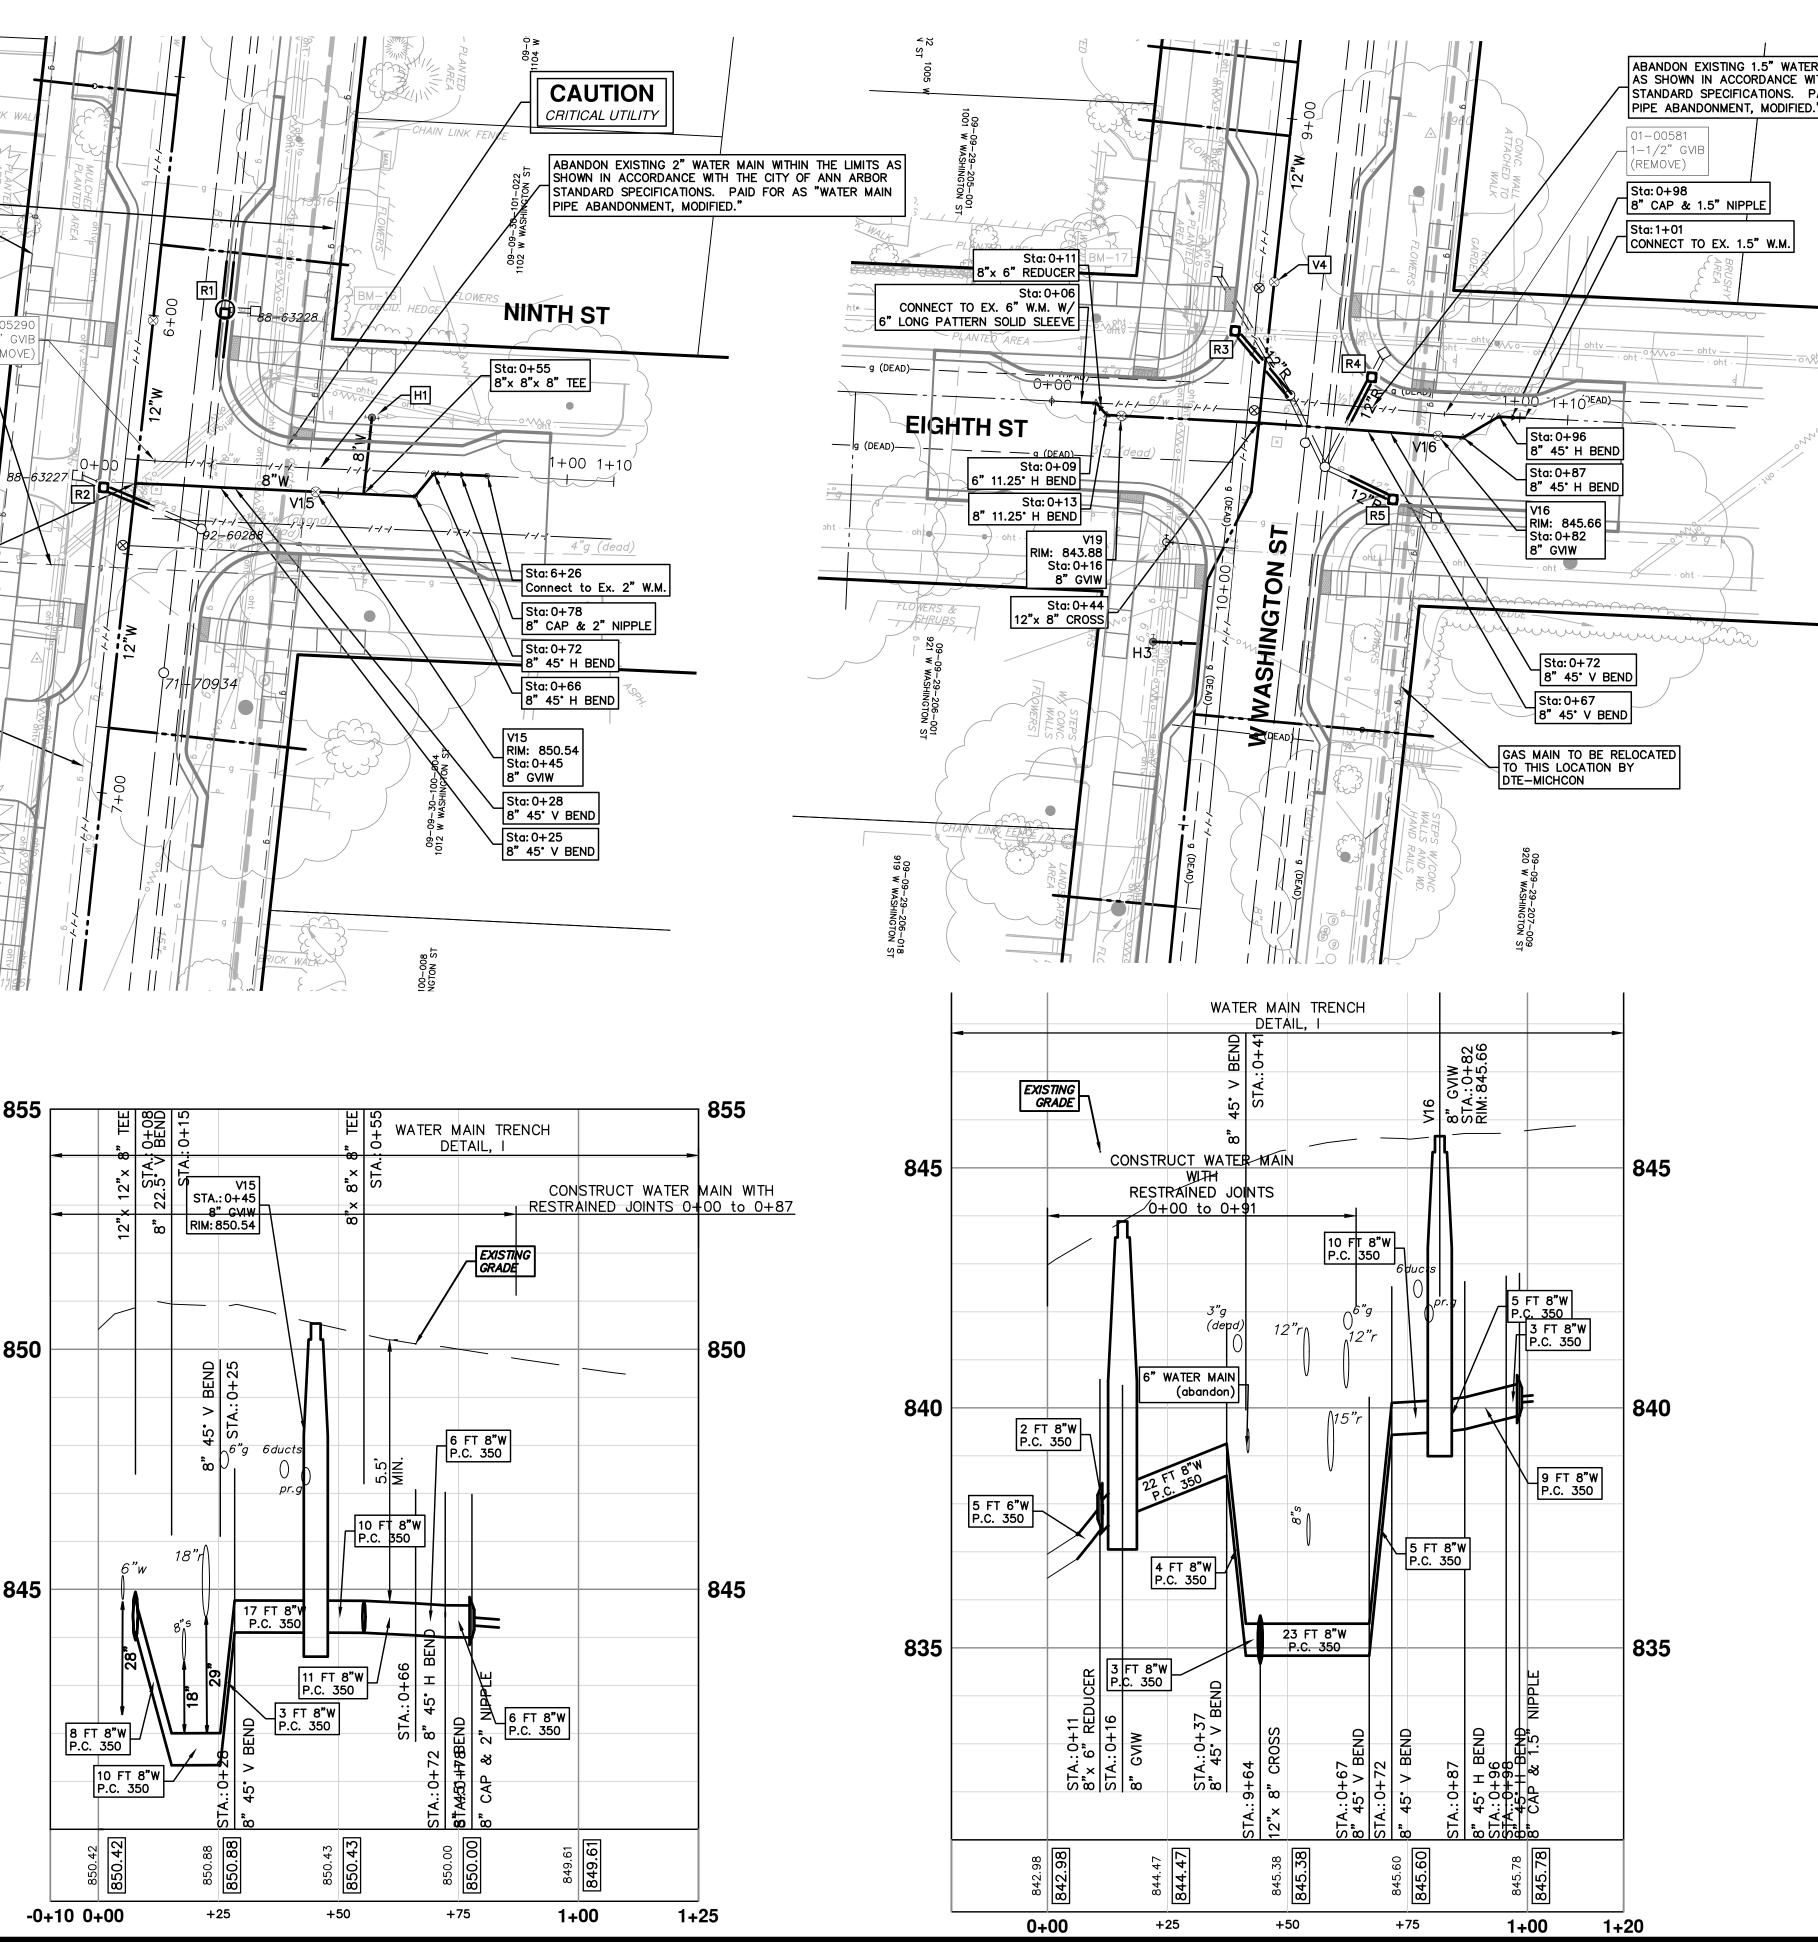

R MAIN WITHIN THE LIN WTH THE CITY OF ANN PAID FOR AS "WATER N	IITS ARBOR		=			3		Know what's below	Call before you dig.
)."								AXU AXI	CHECKED
09–09. 114	-29-204-003 EIGHTH ST							CEC/DPF	
								2-23-18 2-6-18	DA
14% =									NOL
0								ADDENDUM #1	
								01 ADDE	2
							PUBLIC SERVICES 301 EAST HURON STREET	R	M. CHIGAN WWW.a2gov.org
W		IN STRUC ABLE	TURE				ATER MAIN		
STRUCTURE V15 V16	TYPE 8" GVIW 8" GVIW	STATION 0+45 0+82	RIM 850.54 845.66	DEPTH 6.44 6.17		ENGINEERING	A, WASHINGTON WA		NINTH STREET AND EIGHTH STREET WATER MAIN PLAN AND PROFILE
						- PUBLIC SERVICES - ENGINEERING	CREST, BUENA VISTA, WASHINGTON W		NINTH STF WATER N
						CITY OF ANN ARBOR	SCALE PLAN: 1" = 20' PROFILE: 1" = 2'		2016029-29


29 OF 46

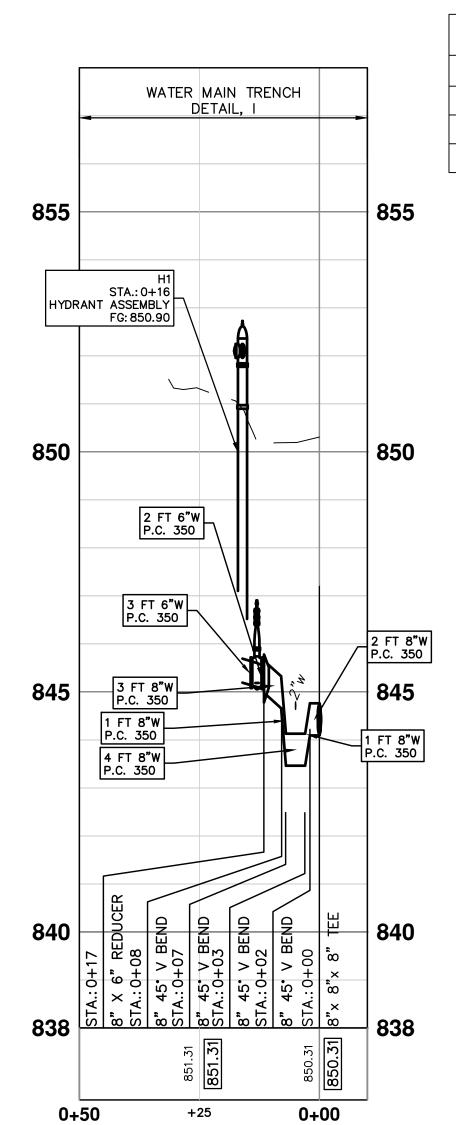
ST HLNIN Sta: 0+08 8"45° V BEND Sta: 0+07 8" 45" V BEND Sta: 0+03 Sta: 0+11 8"x 6" REDUCER 8" 45° V BEND Sta: 0+02 8"45° V BEND FG: 850.90 Sta: 0+16 Off: 0.0 Sta: 0+00 8"x 8"x 8" TEE \_\_\_\_\_ W WASHINGTON ST. 6+00 7+00 +\_\_\_\_\_R2 





W	ATER MAIN STRUC	CTURE TA	BLE
STRUCTURE	TYPE	STATION	RIM
H1	HYDRANT ASSEMBLY	???	850.90
H2	HYDRANT ASSEMBLY	???	857.67
Н3	HYDRANT ASSEMBLY	???	844.06




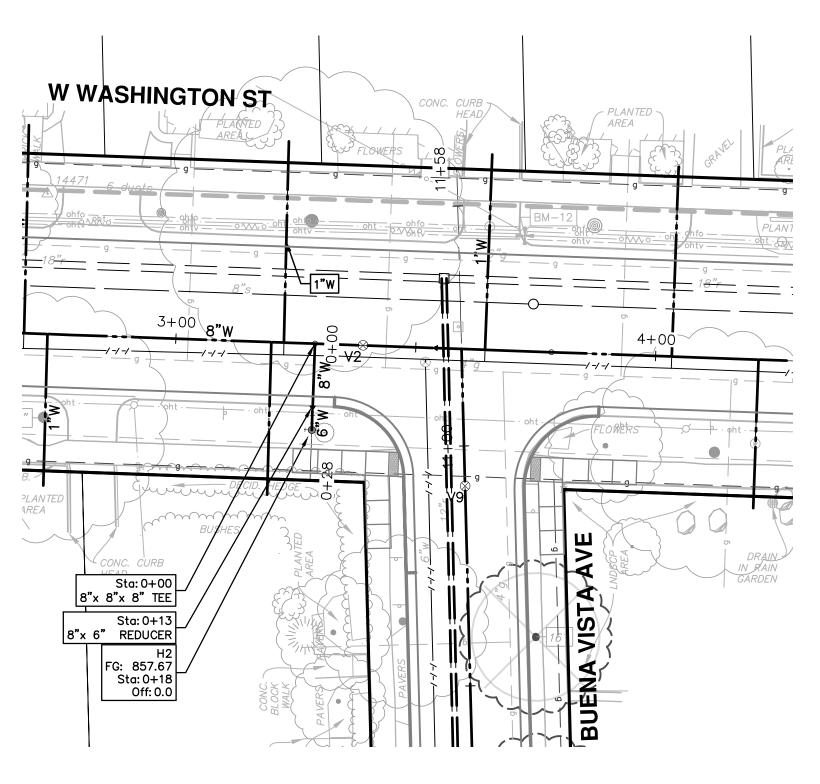


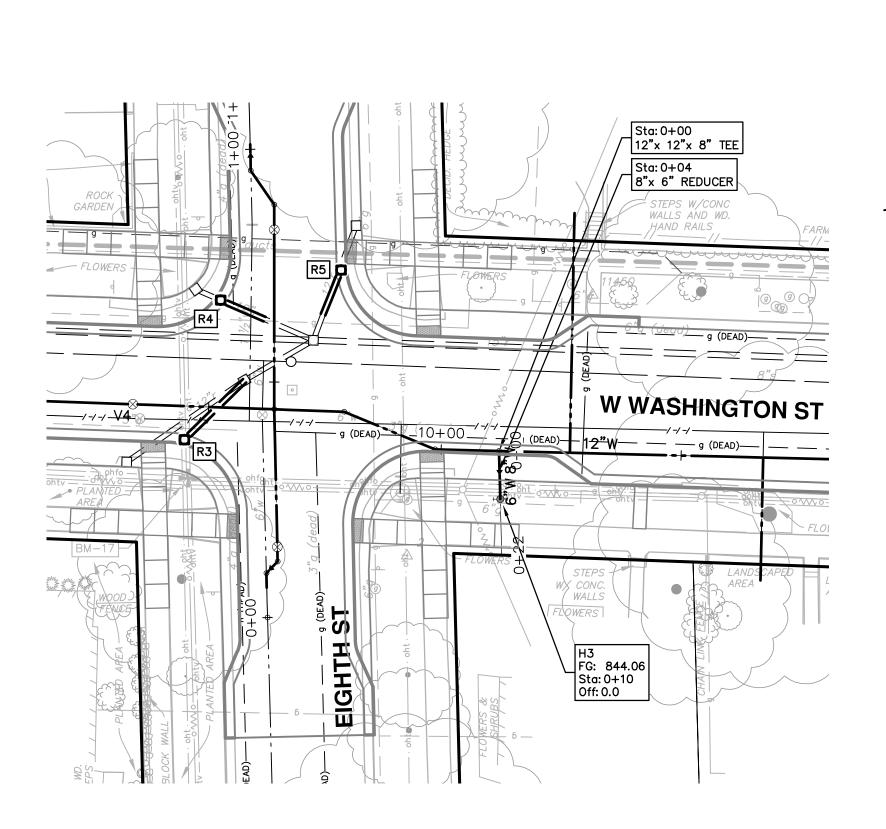


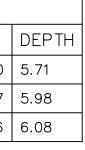


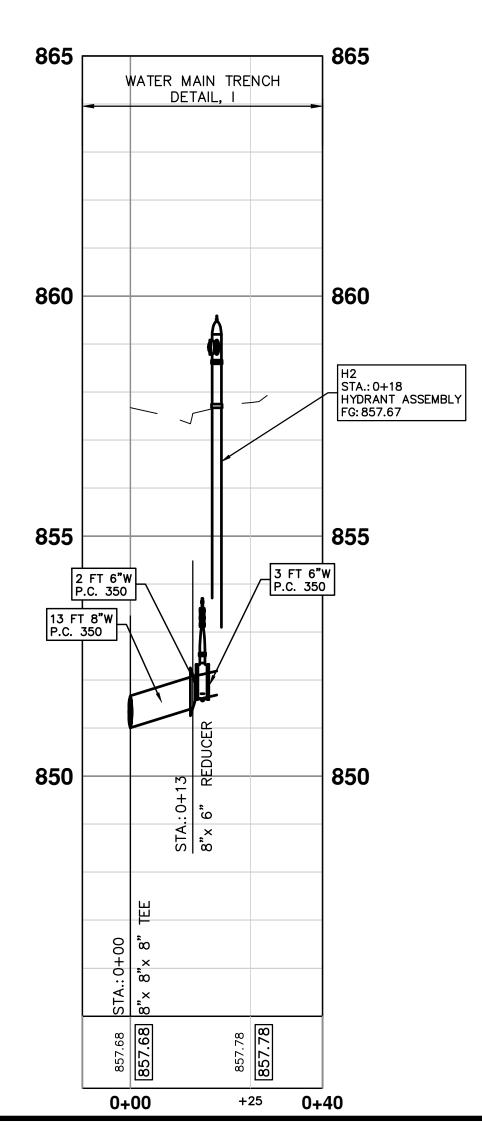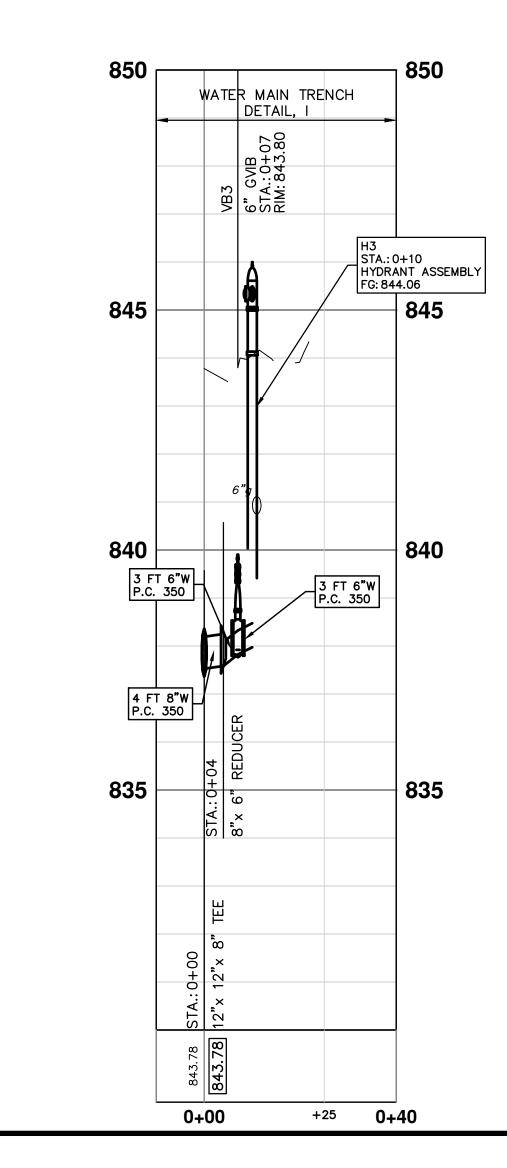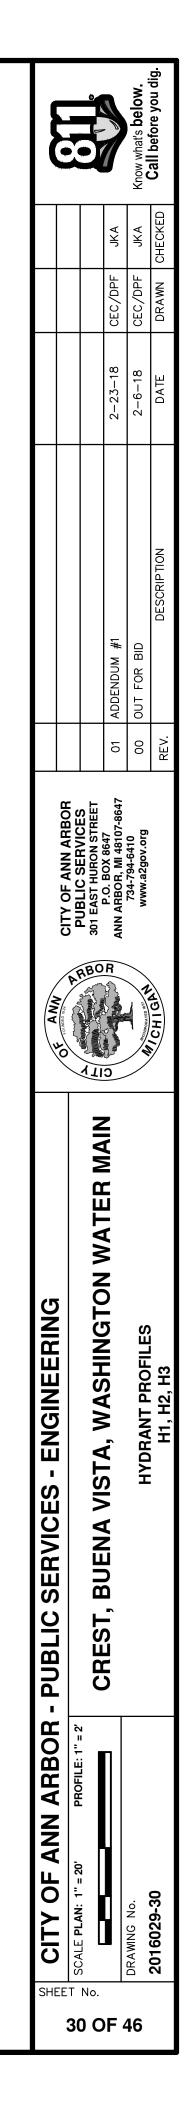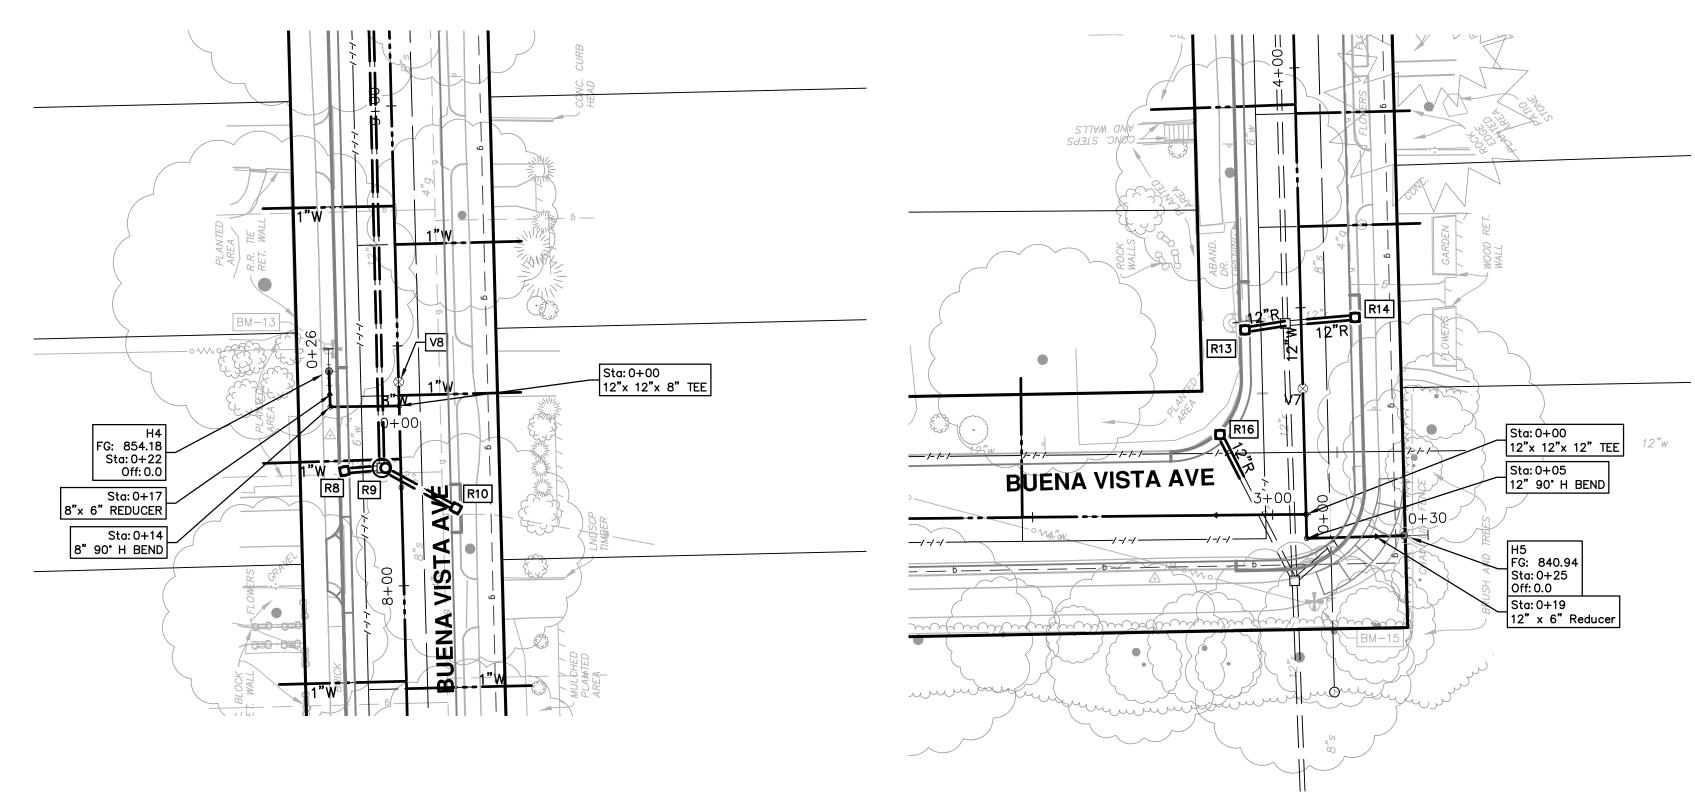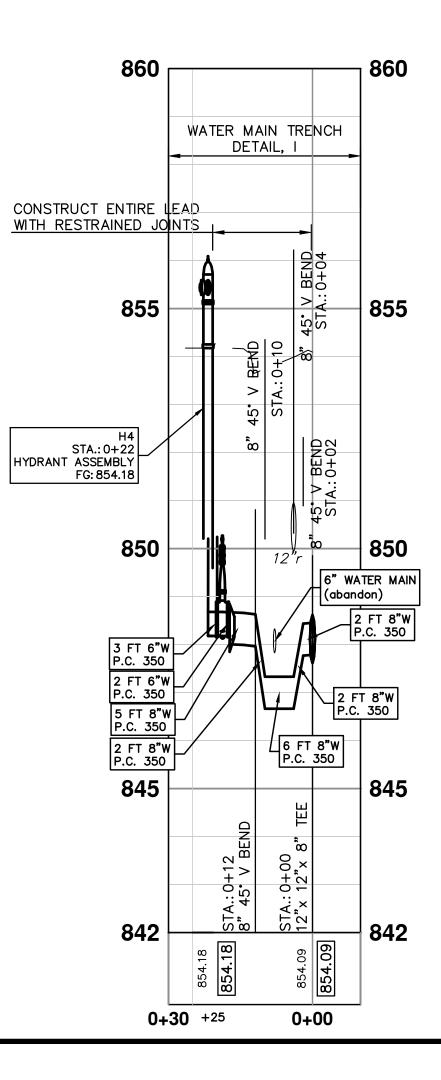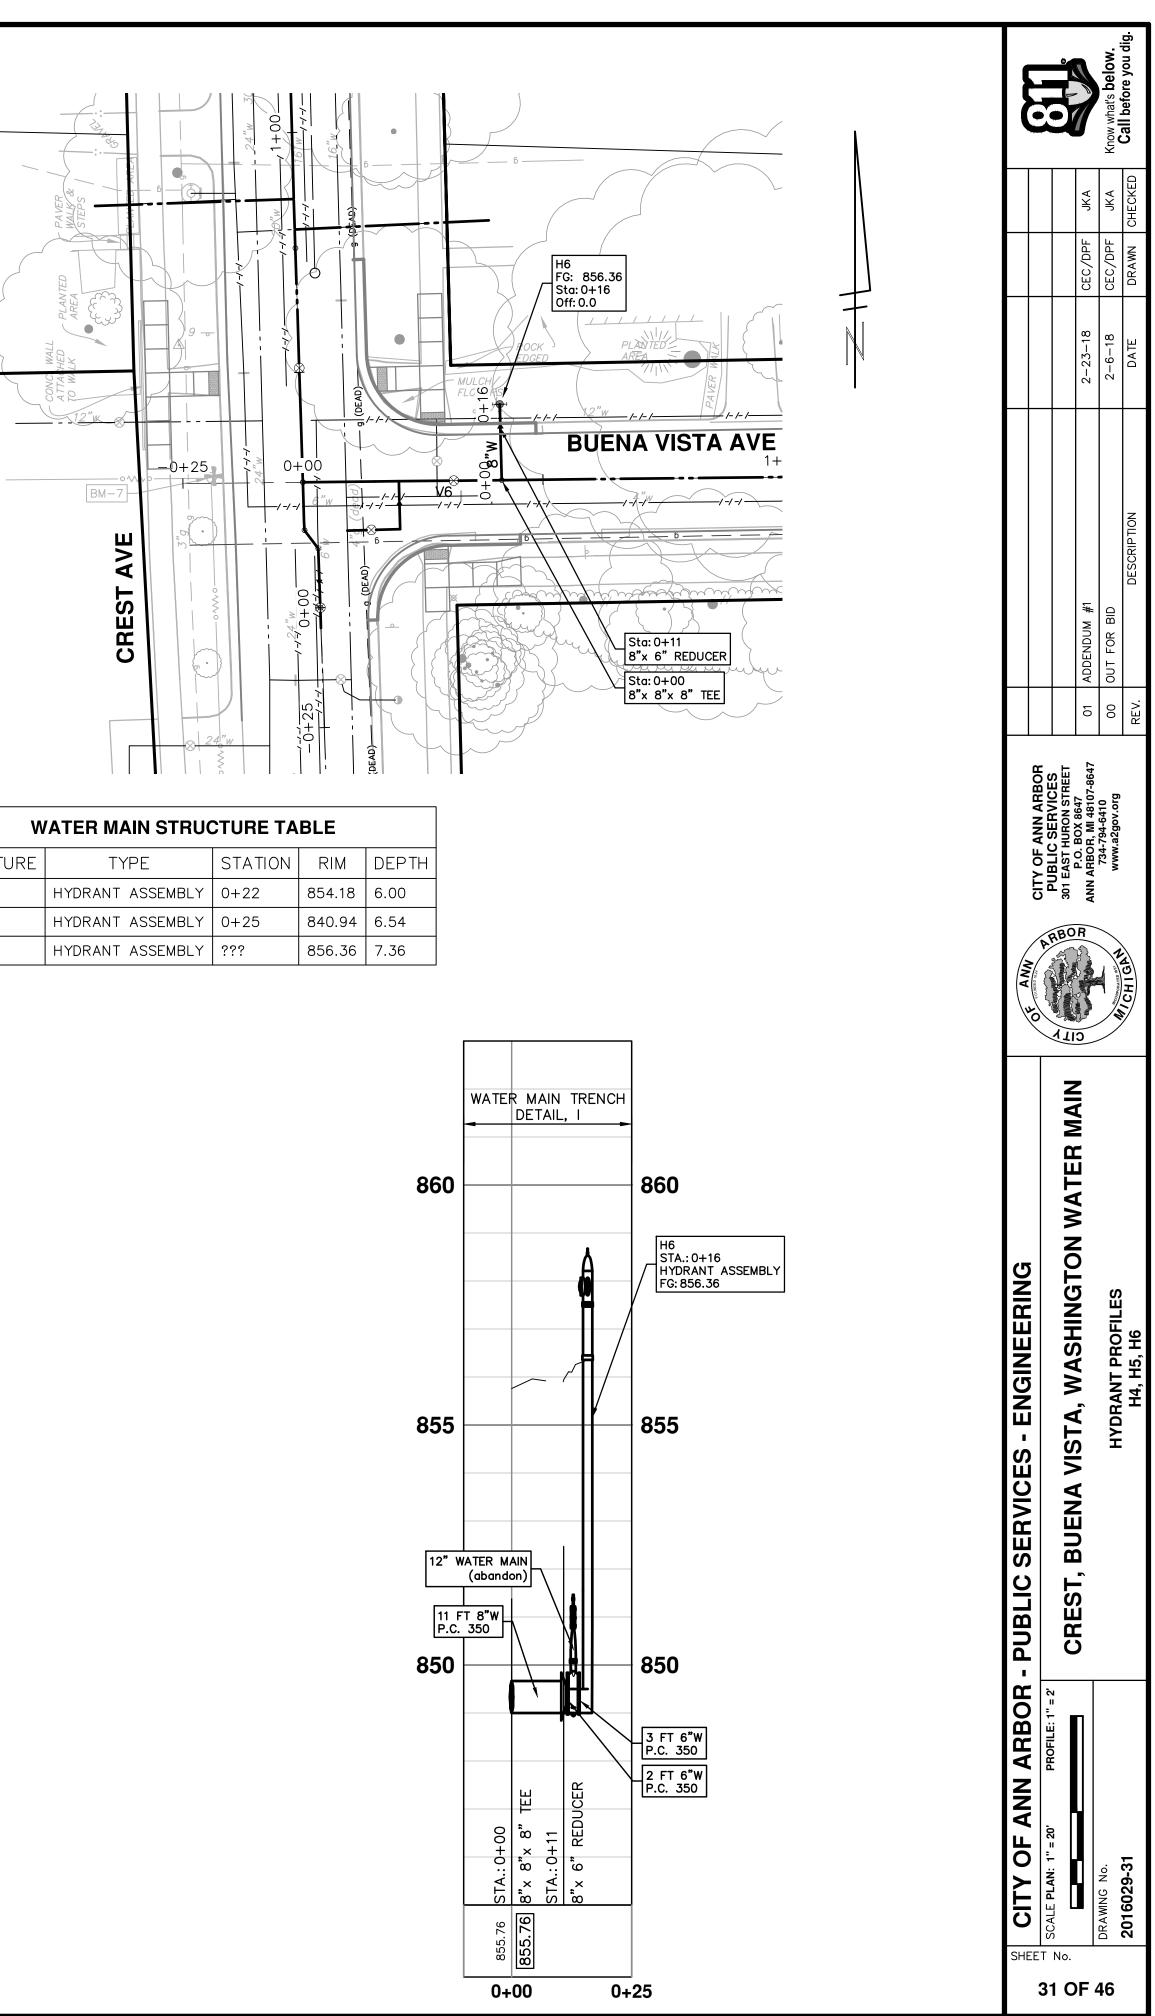
















W	ATER MAIN STRUC	CTURE TA	BLE
STRUCTURE	TYPE	STATION	RIM
H4	HYDRANT ASSEMBLY	0+22	854.1
H5	HYDRANT ASSEMBLY	0+25	840.9
H6	HYDRANT ASSEMBLY	???	856.3

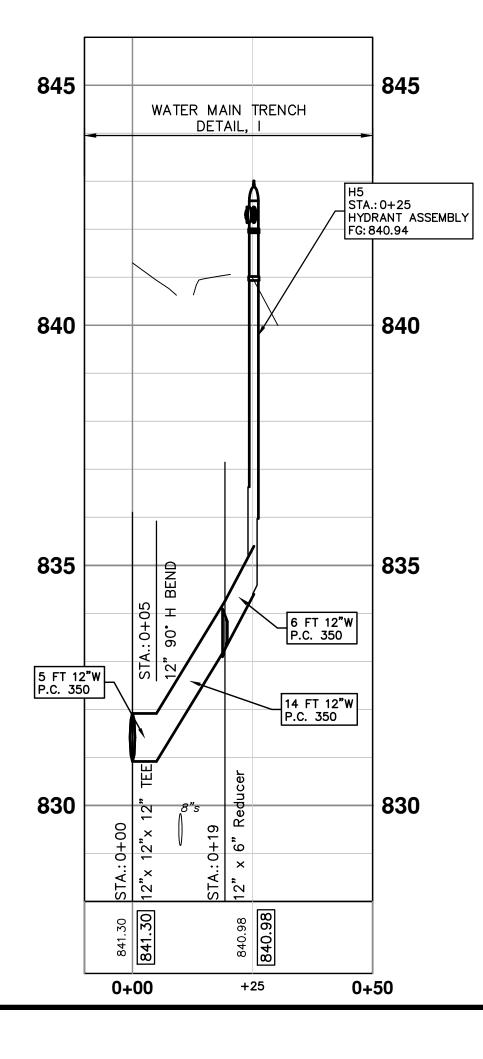

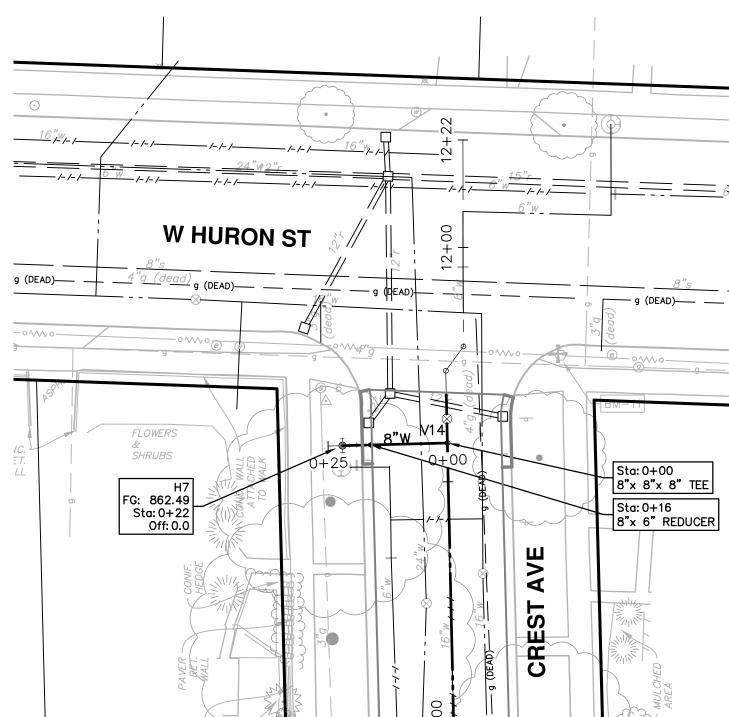

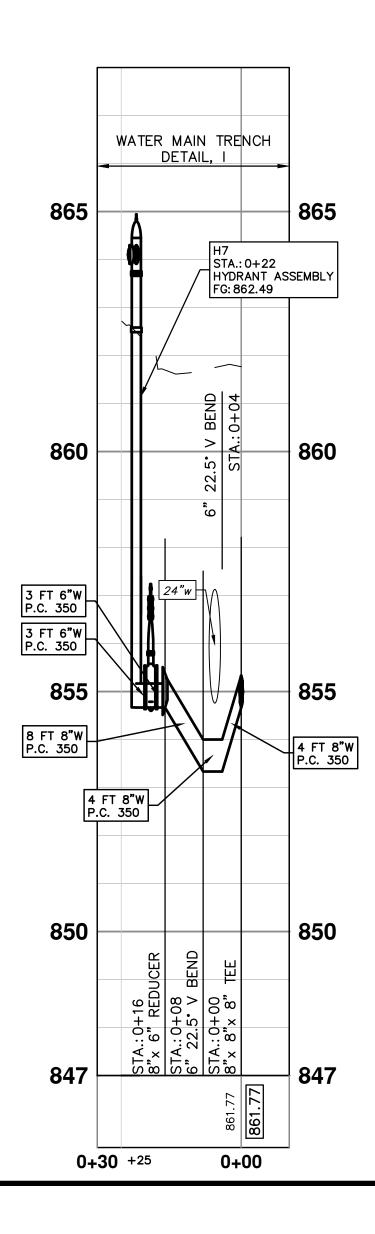





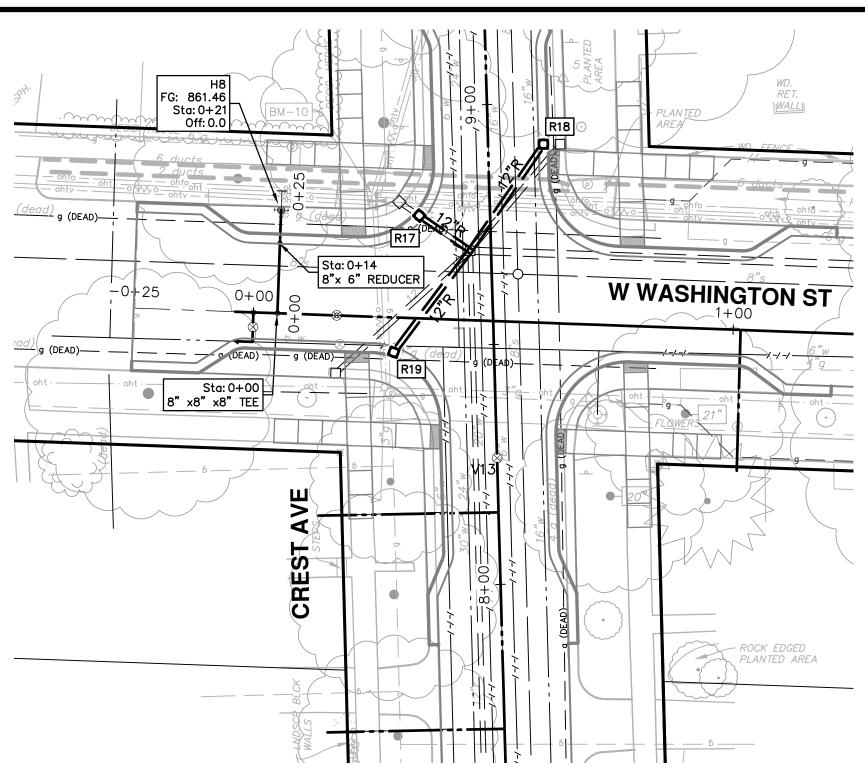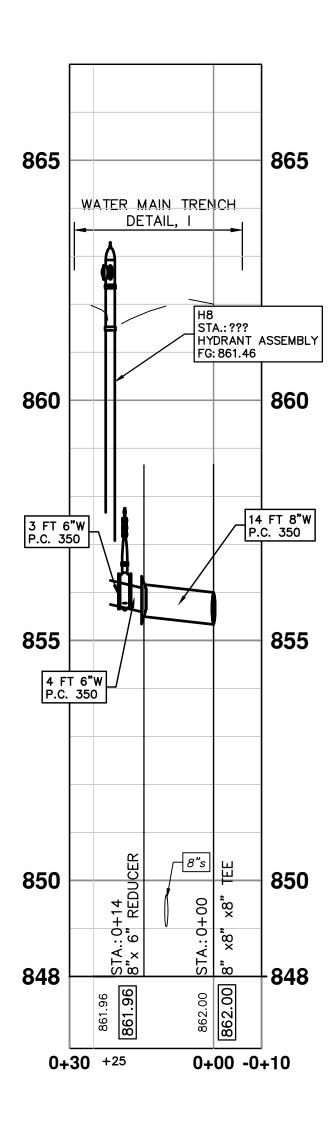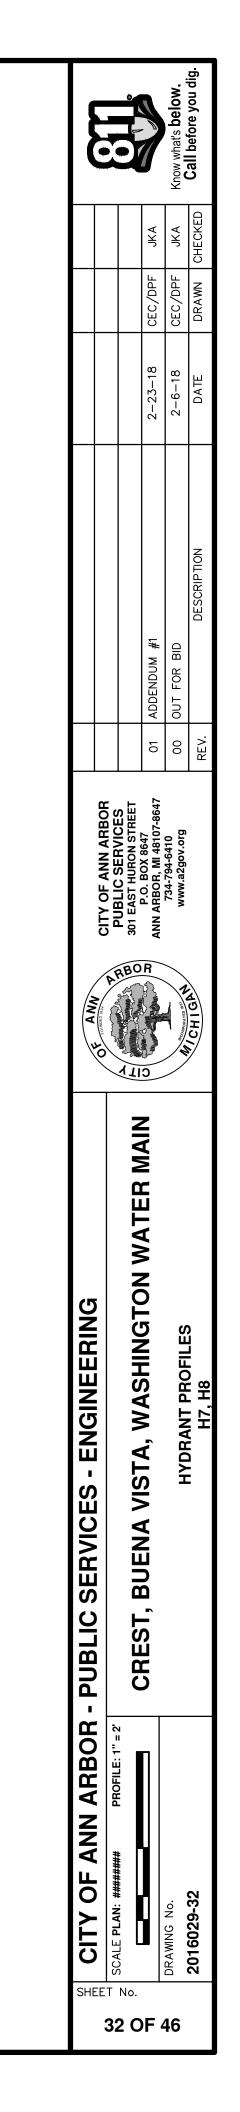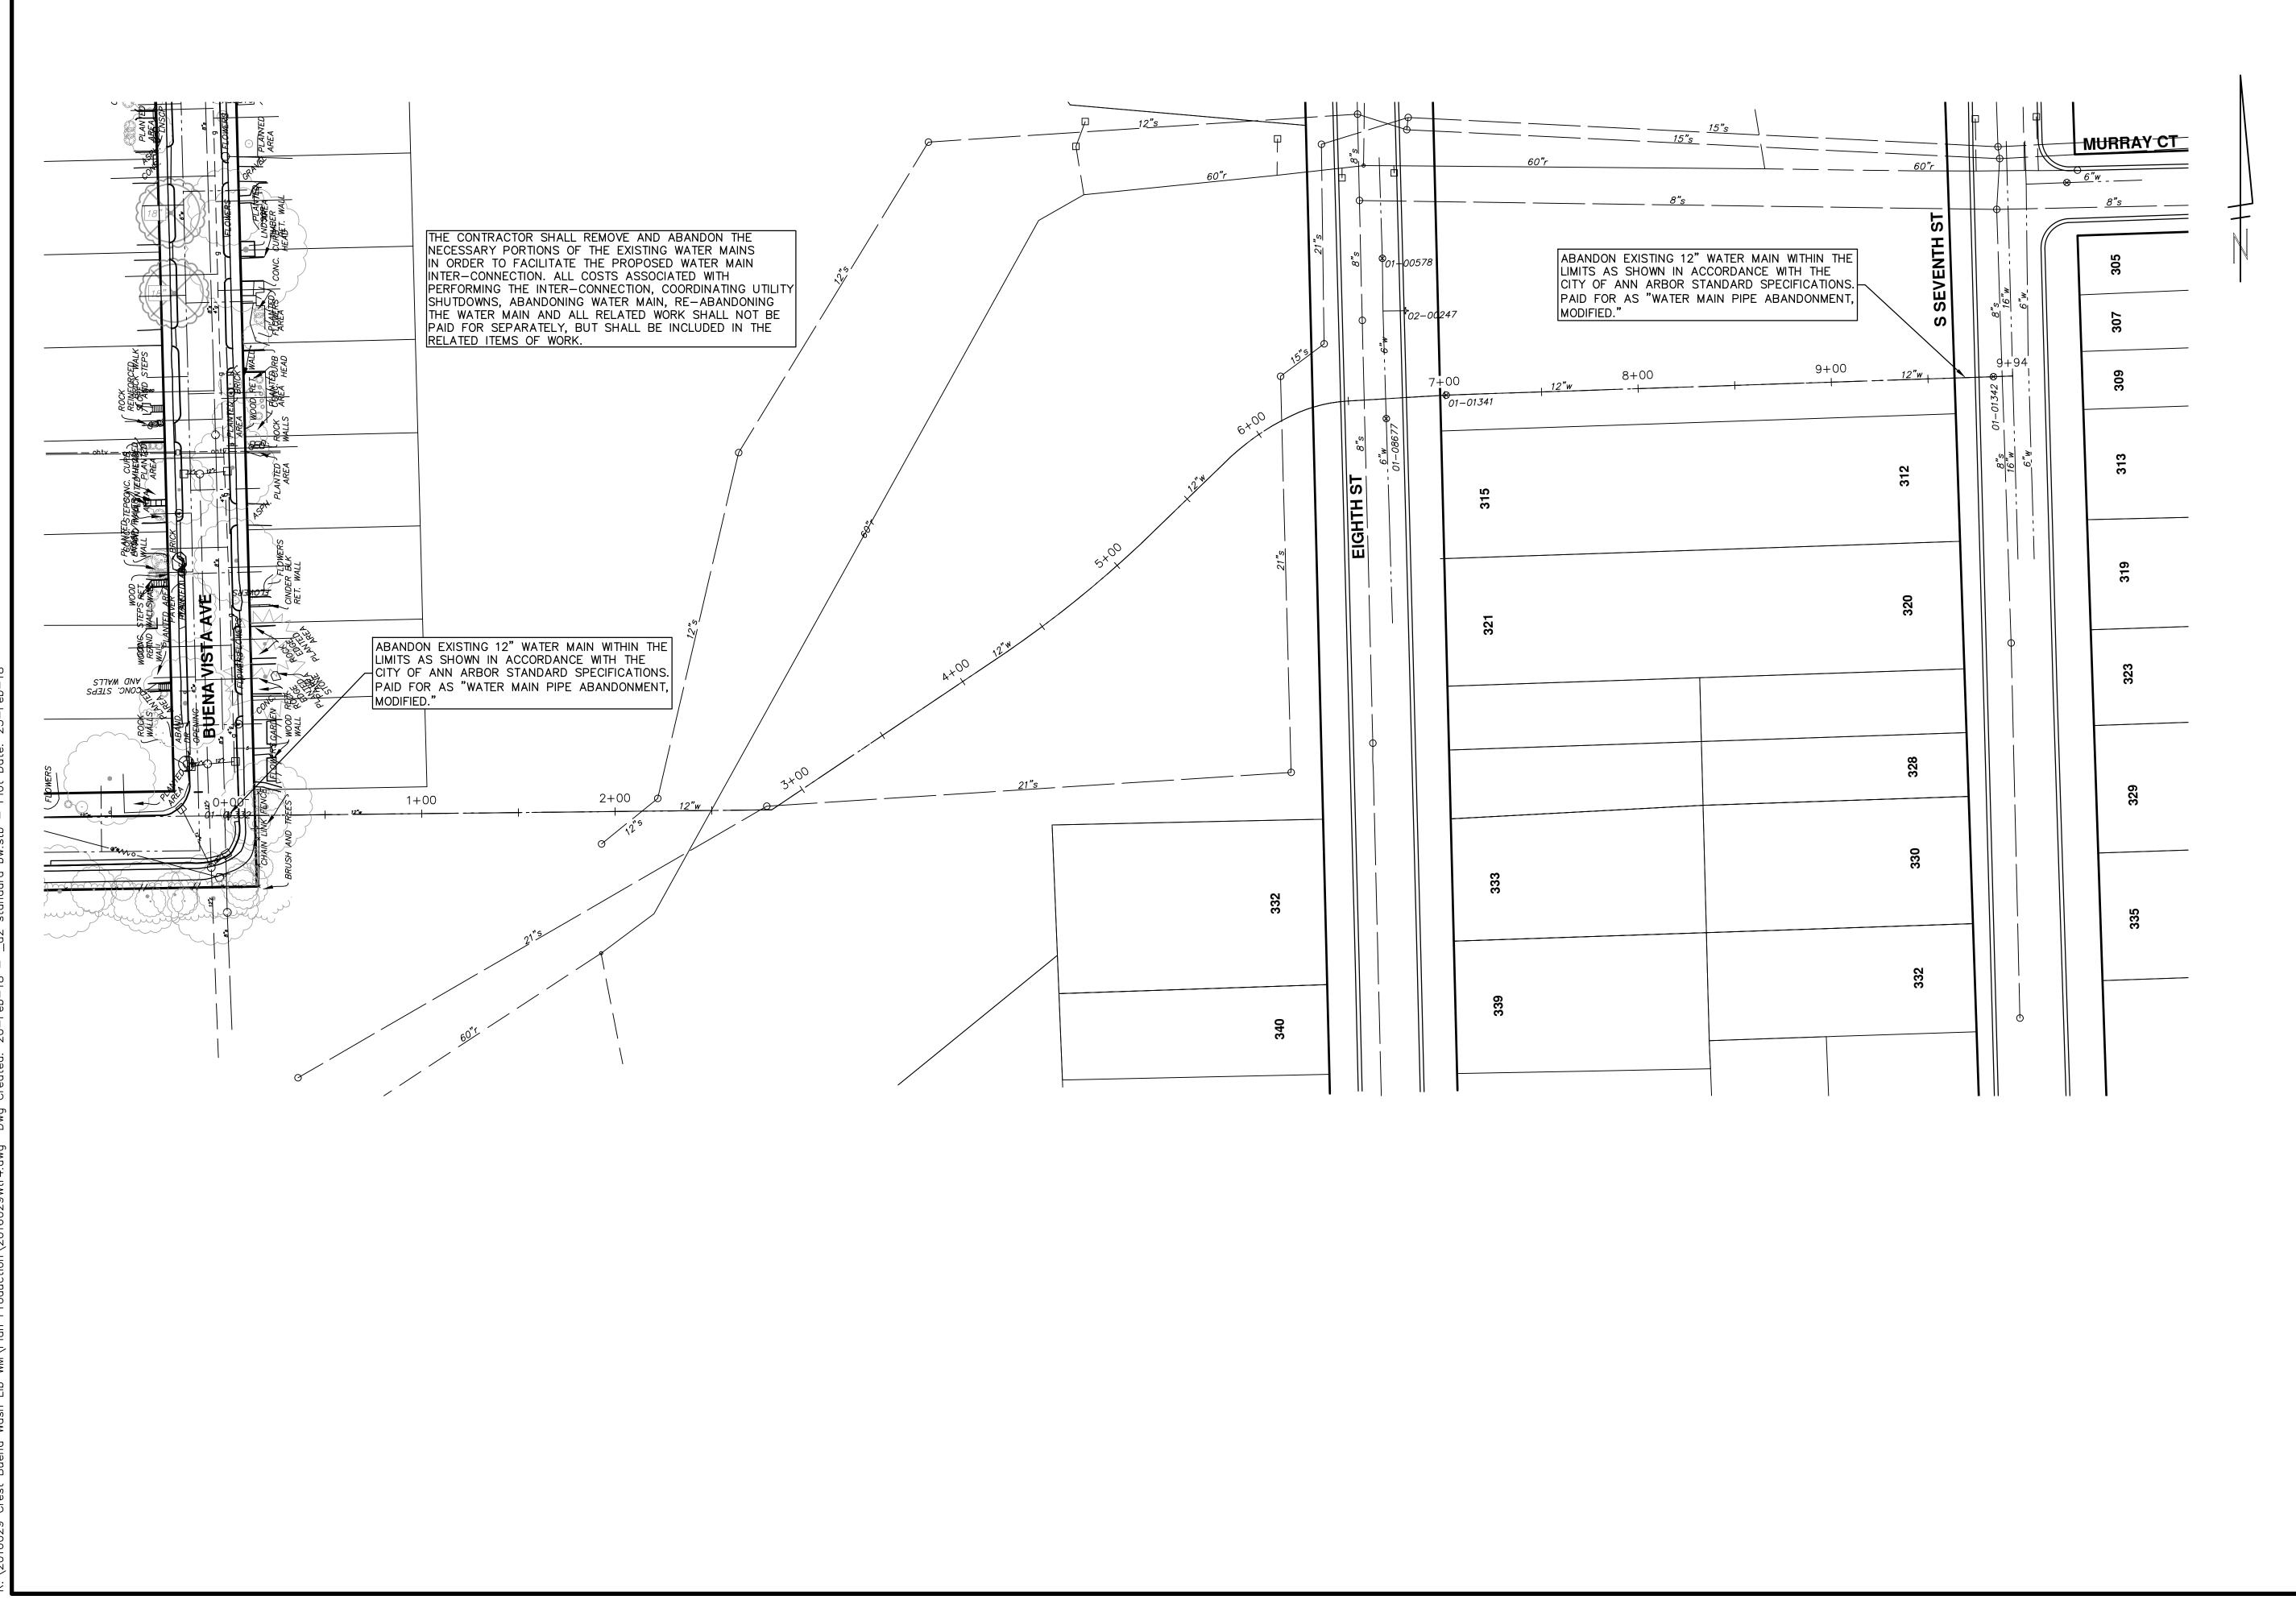


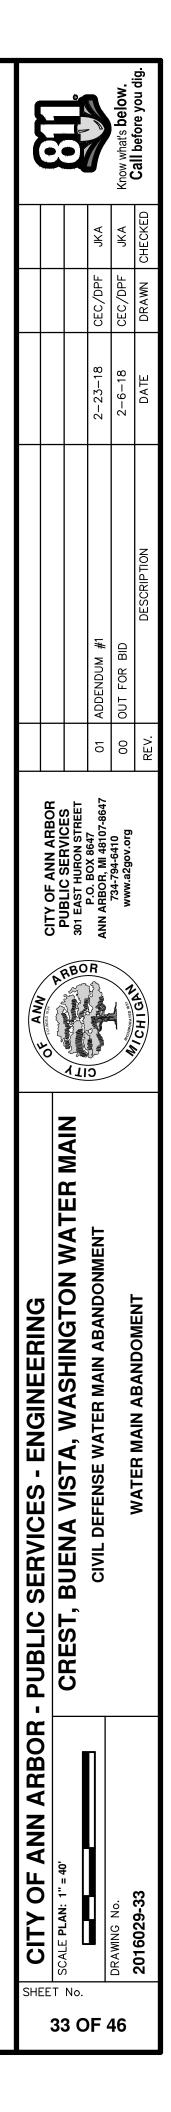
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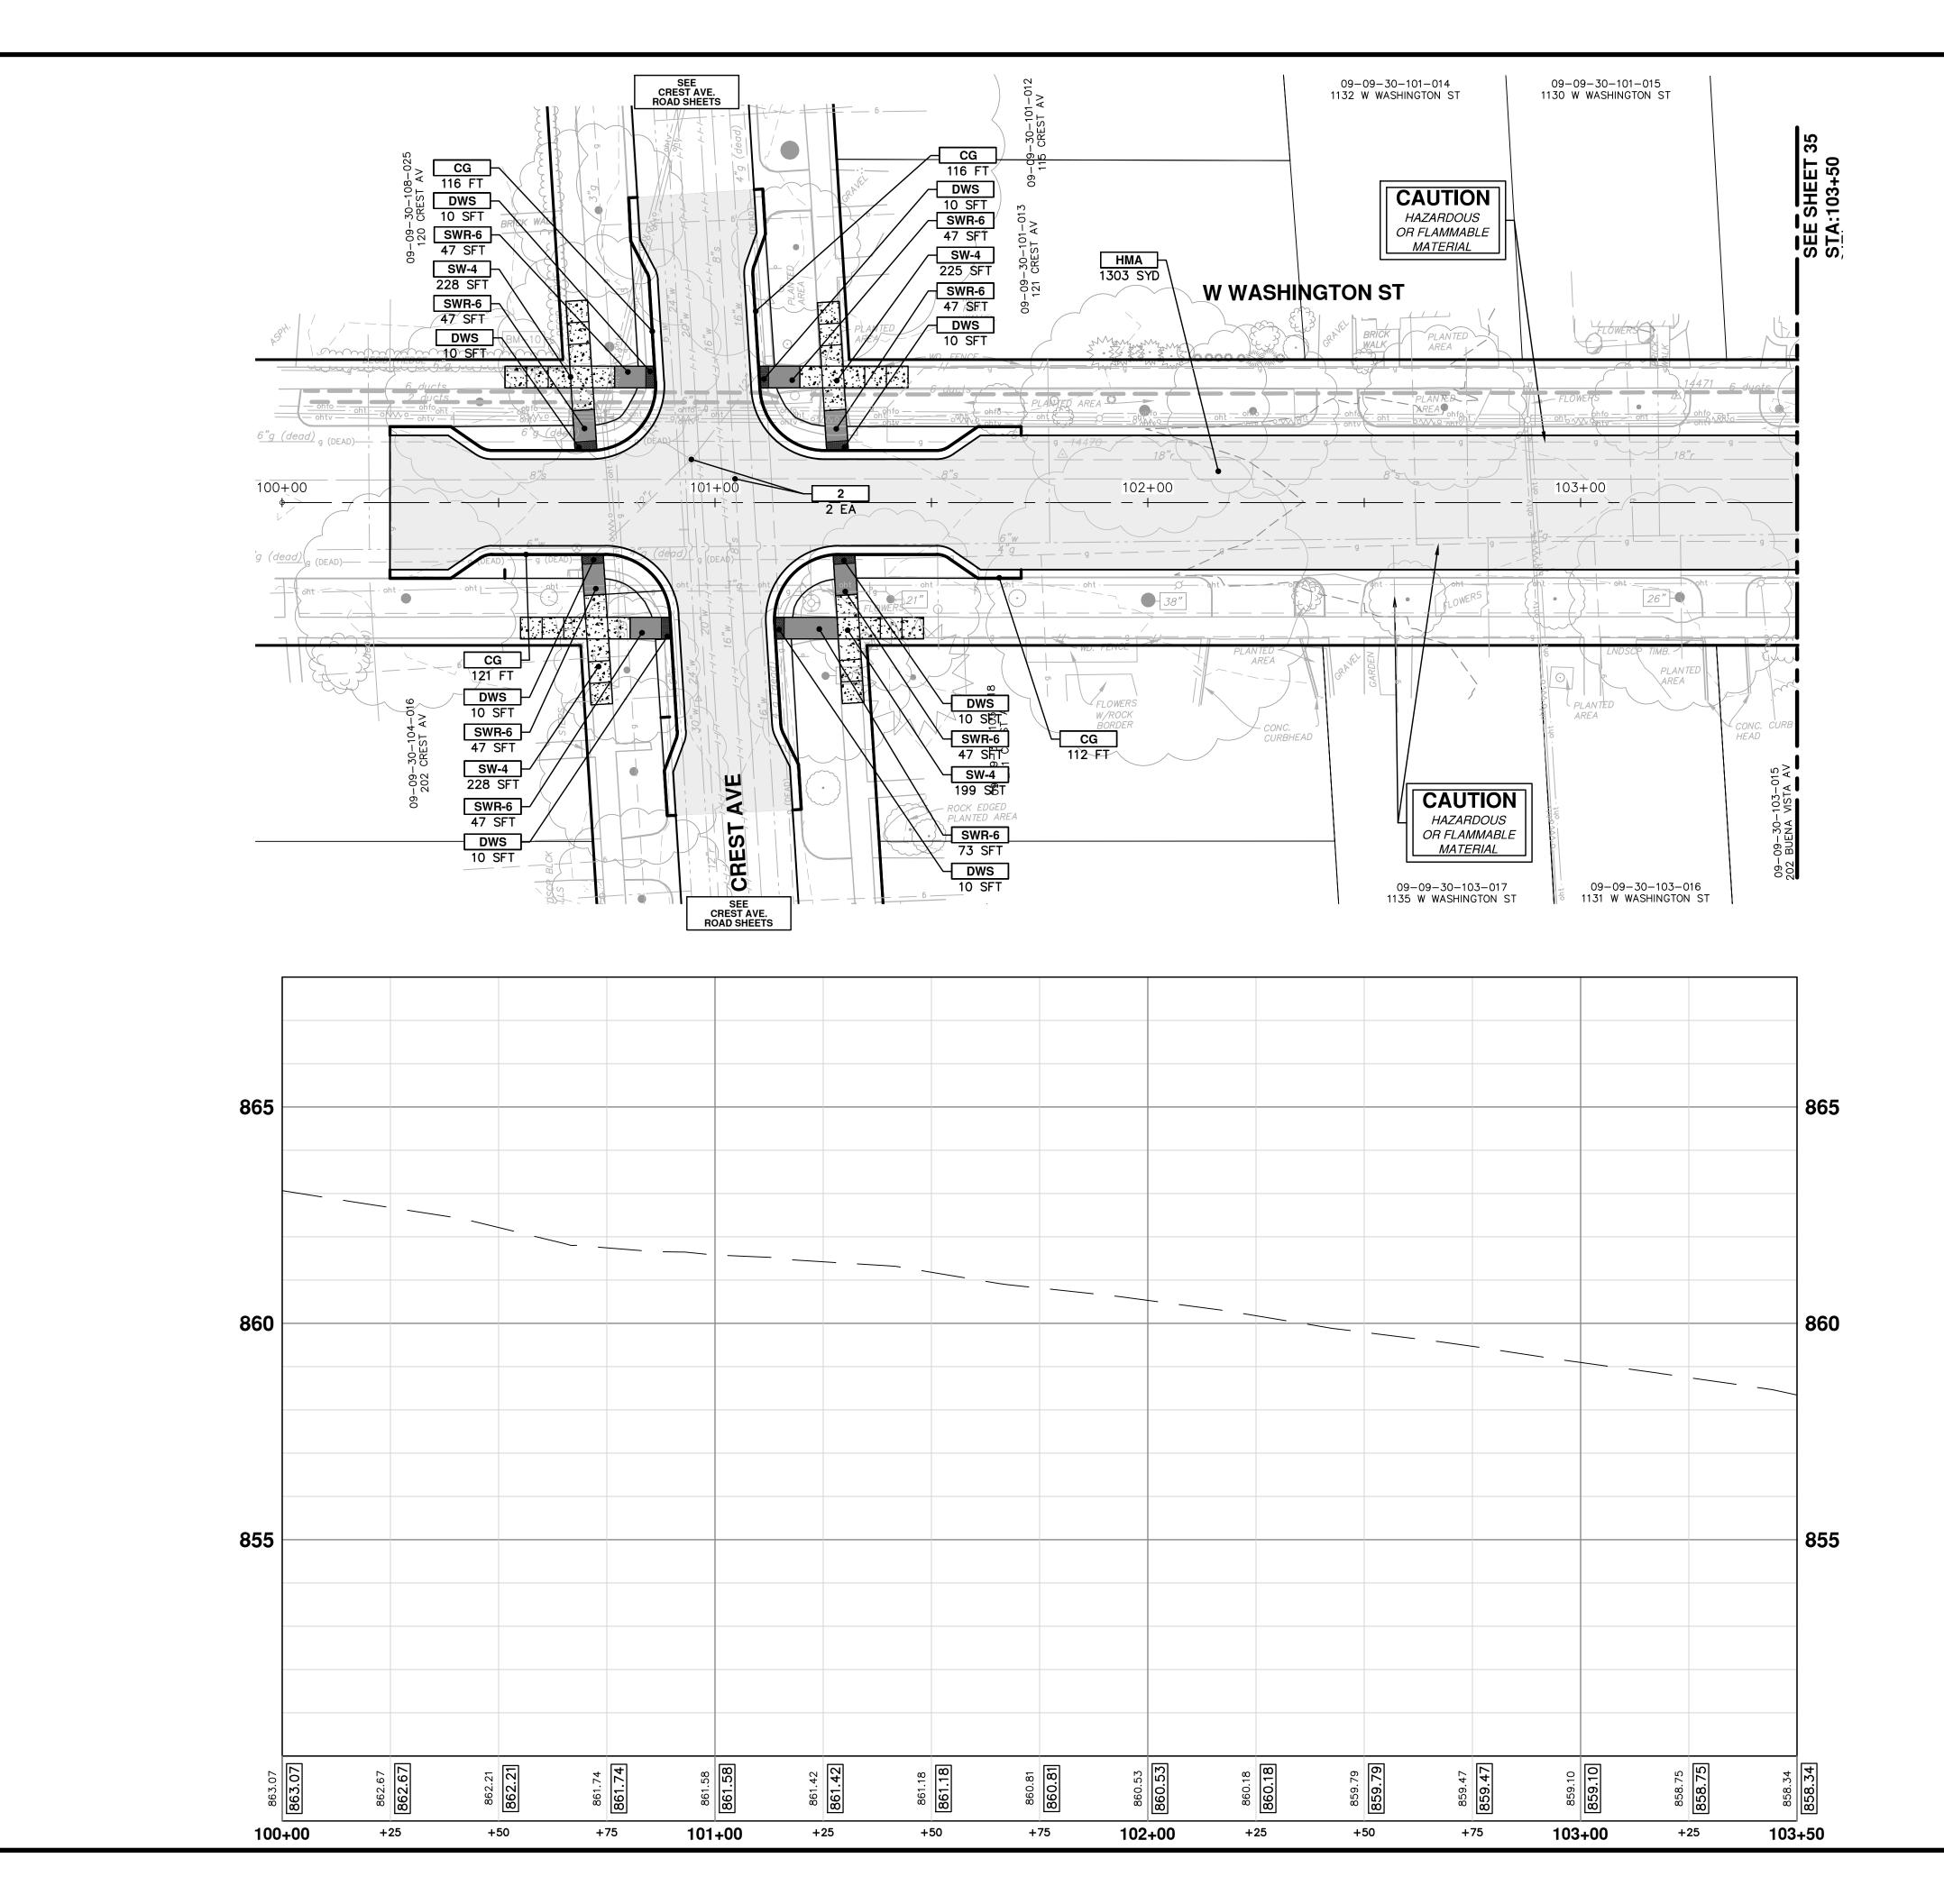
WATER MAIN STRUCTURE TABLE									
STRUCTURE	TYPE	STATION	RIM	DEPTH					
Н7	HYDRANT ASSEMBLY	???	862.49	7.82					
H8	HYDRANT ASSEMBLY	???	861.46	5.71					













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CC	INSTRUCTION KEY
KEY	DESCRIPTION
НМА	PLACE HMA, LVSP. PLACE MATERIAL IN LIFTS ACCORDING TO THE TYPICAL SECTION AND AS DIRECTED BY THE ENGINEER.
CG	PLACE CURB AND GUTTER, CONC, F4, SPECIAL
DO-M	PLACE DRIVEWAY OPENING, CONC, DETAIL M, P-NC
DC-6	PLACE CONC, DRIVE APPROACH, NON-REINFORCED, P-NC, 6 INCH. PLACE AND COMPACT 6 INCH SUBBASE, CIP, CLASS II GRANULAR MATERIAL, MODIFIED.
SW-4	PLACE SIDEWALK, CONC, 4 INCH, MODIFIED
SWR-6	PLACE SIDEWALK RAMP, CONC, 6 INCH, MODIFIED
DWS	DETECTABLE WARNING, CAST IN PLACE
ABO	ADJUST BY OTHERS
1	ADJUST GATE VALVE BOX, MONUMENT BOX, OR GAS BOX.
2	ADJUST STRUCTURE COVER




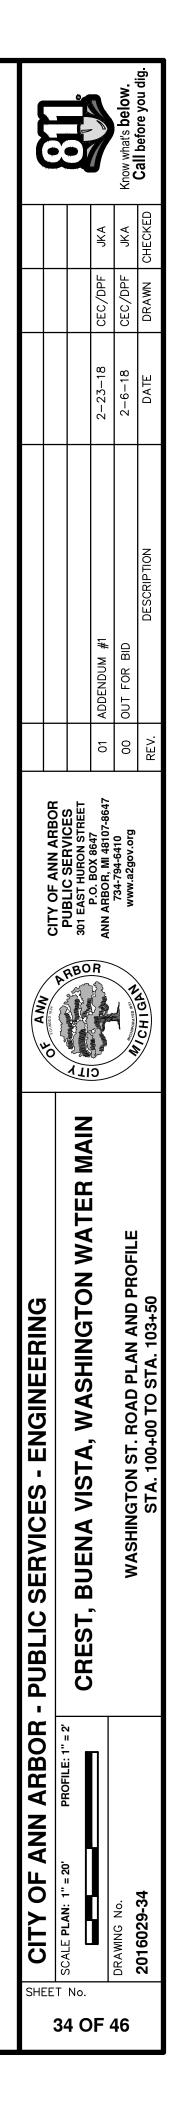

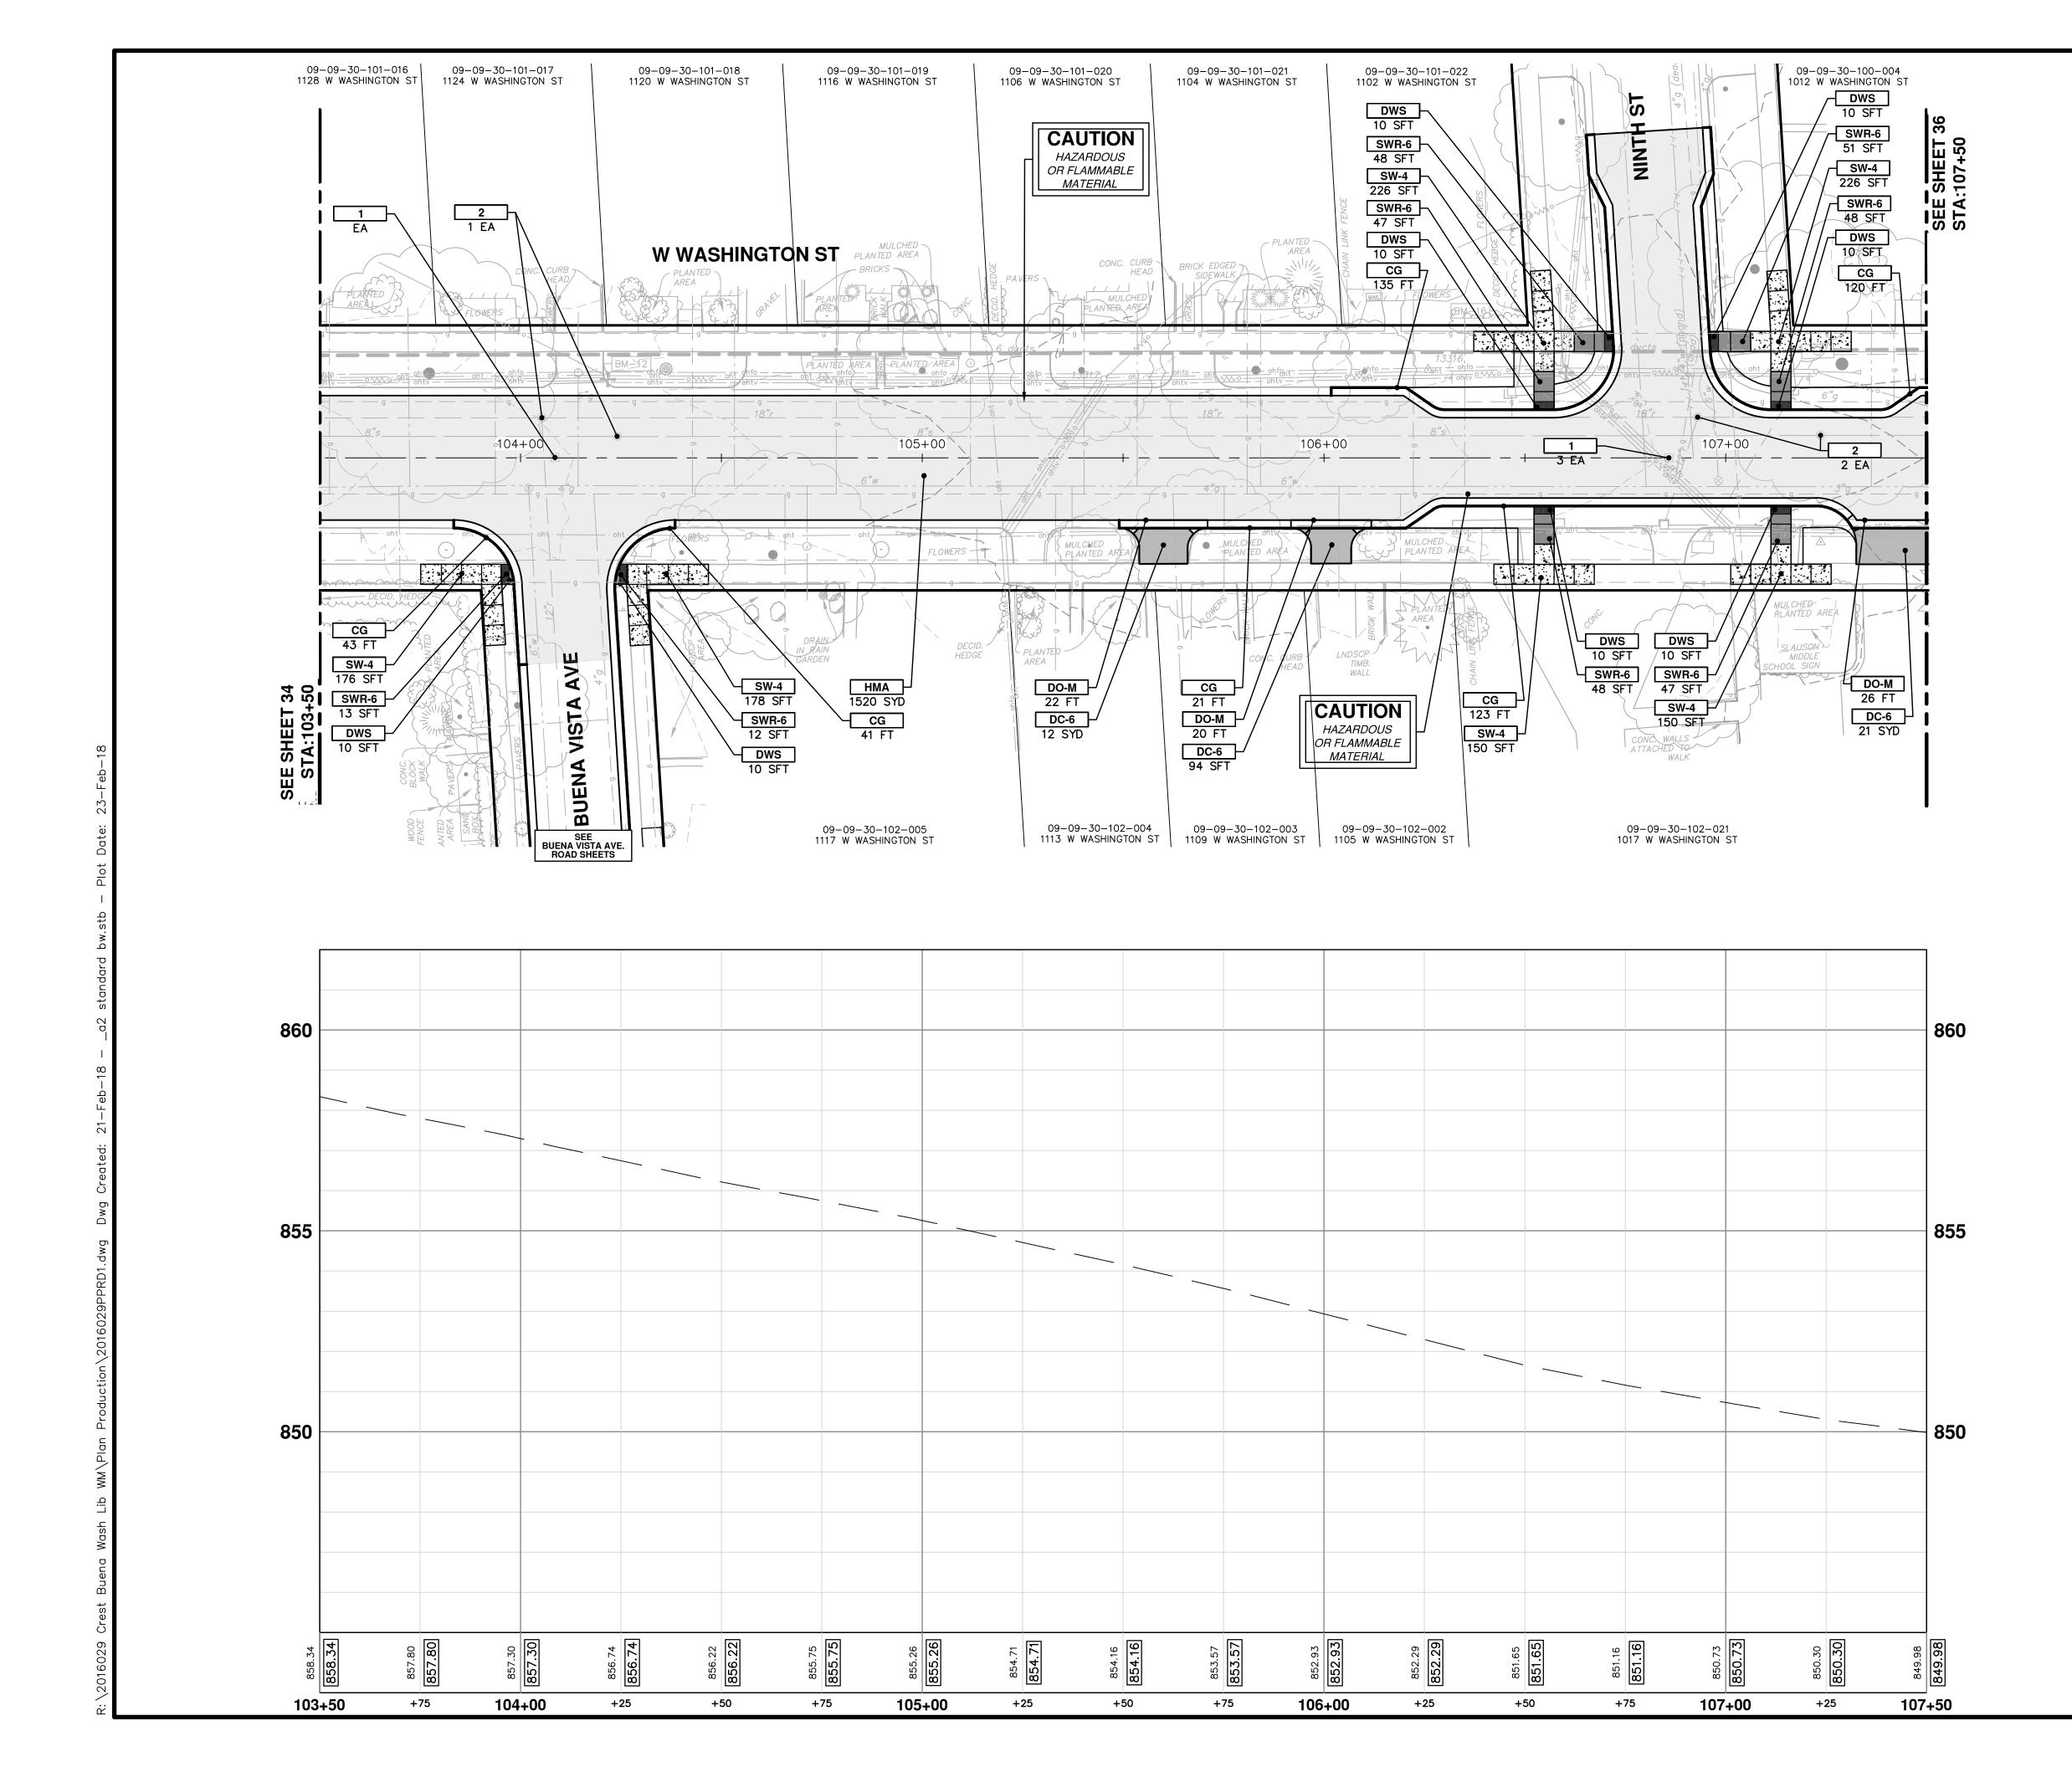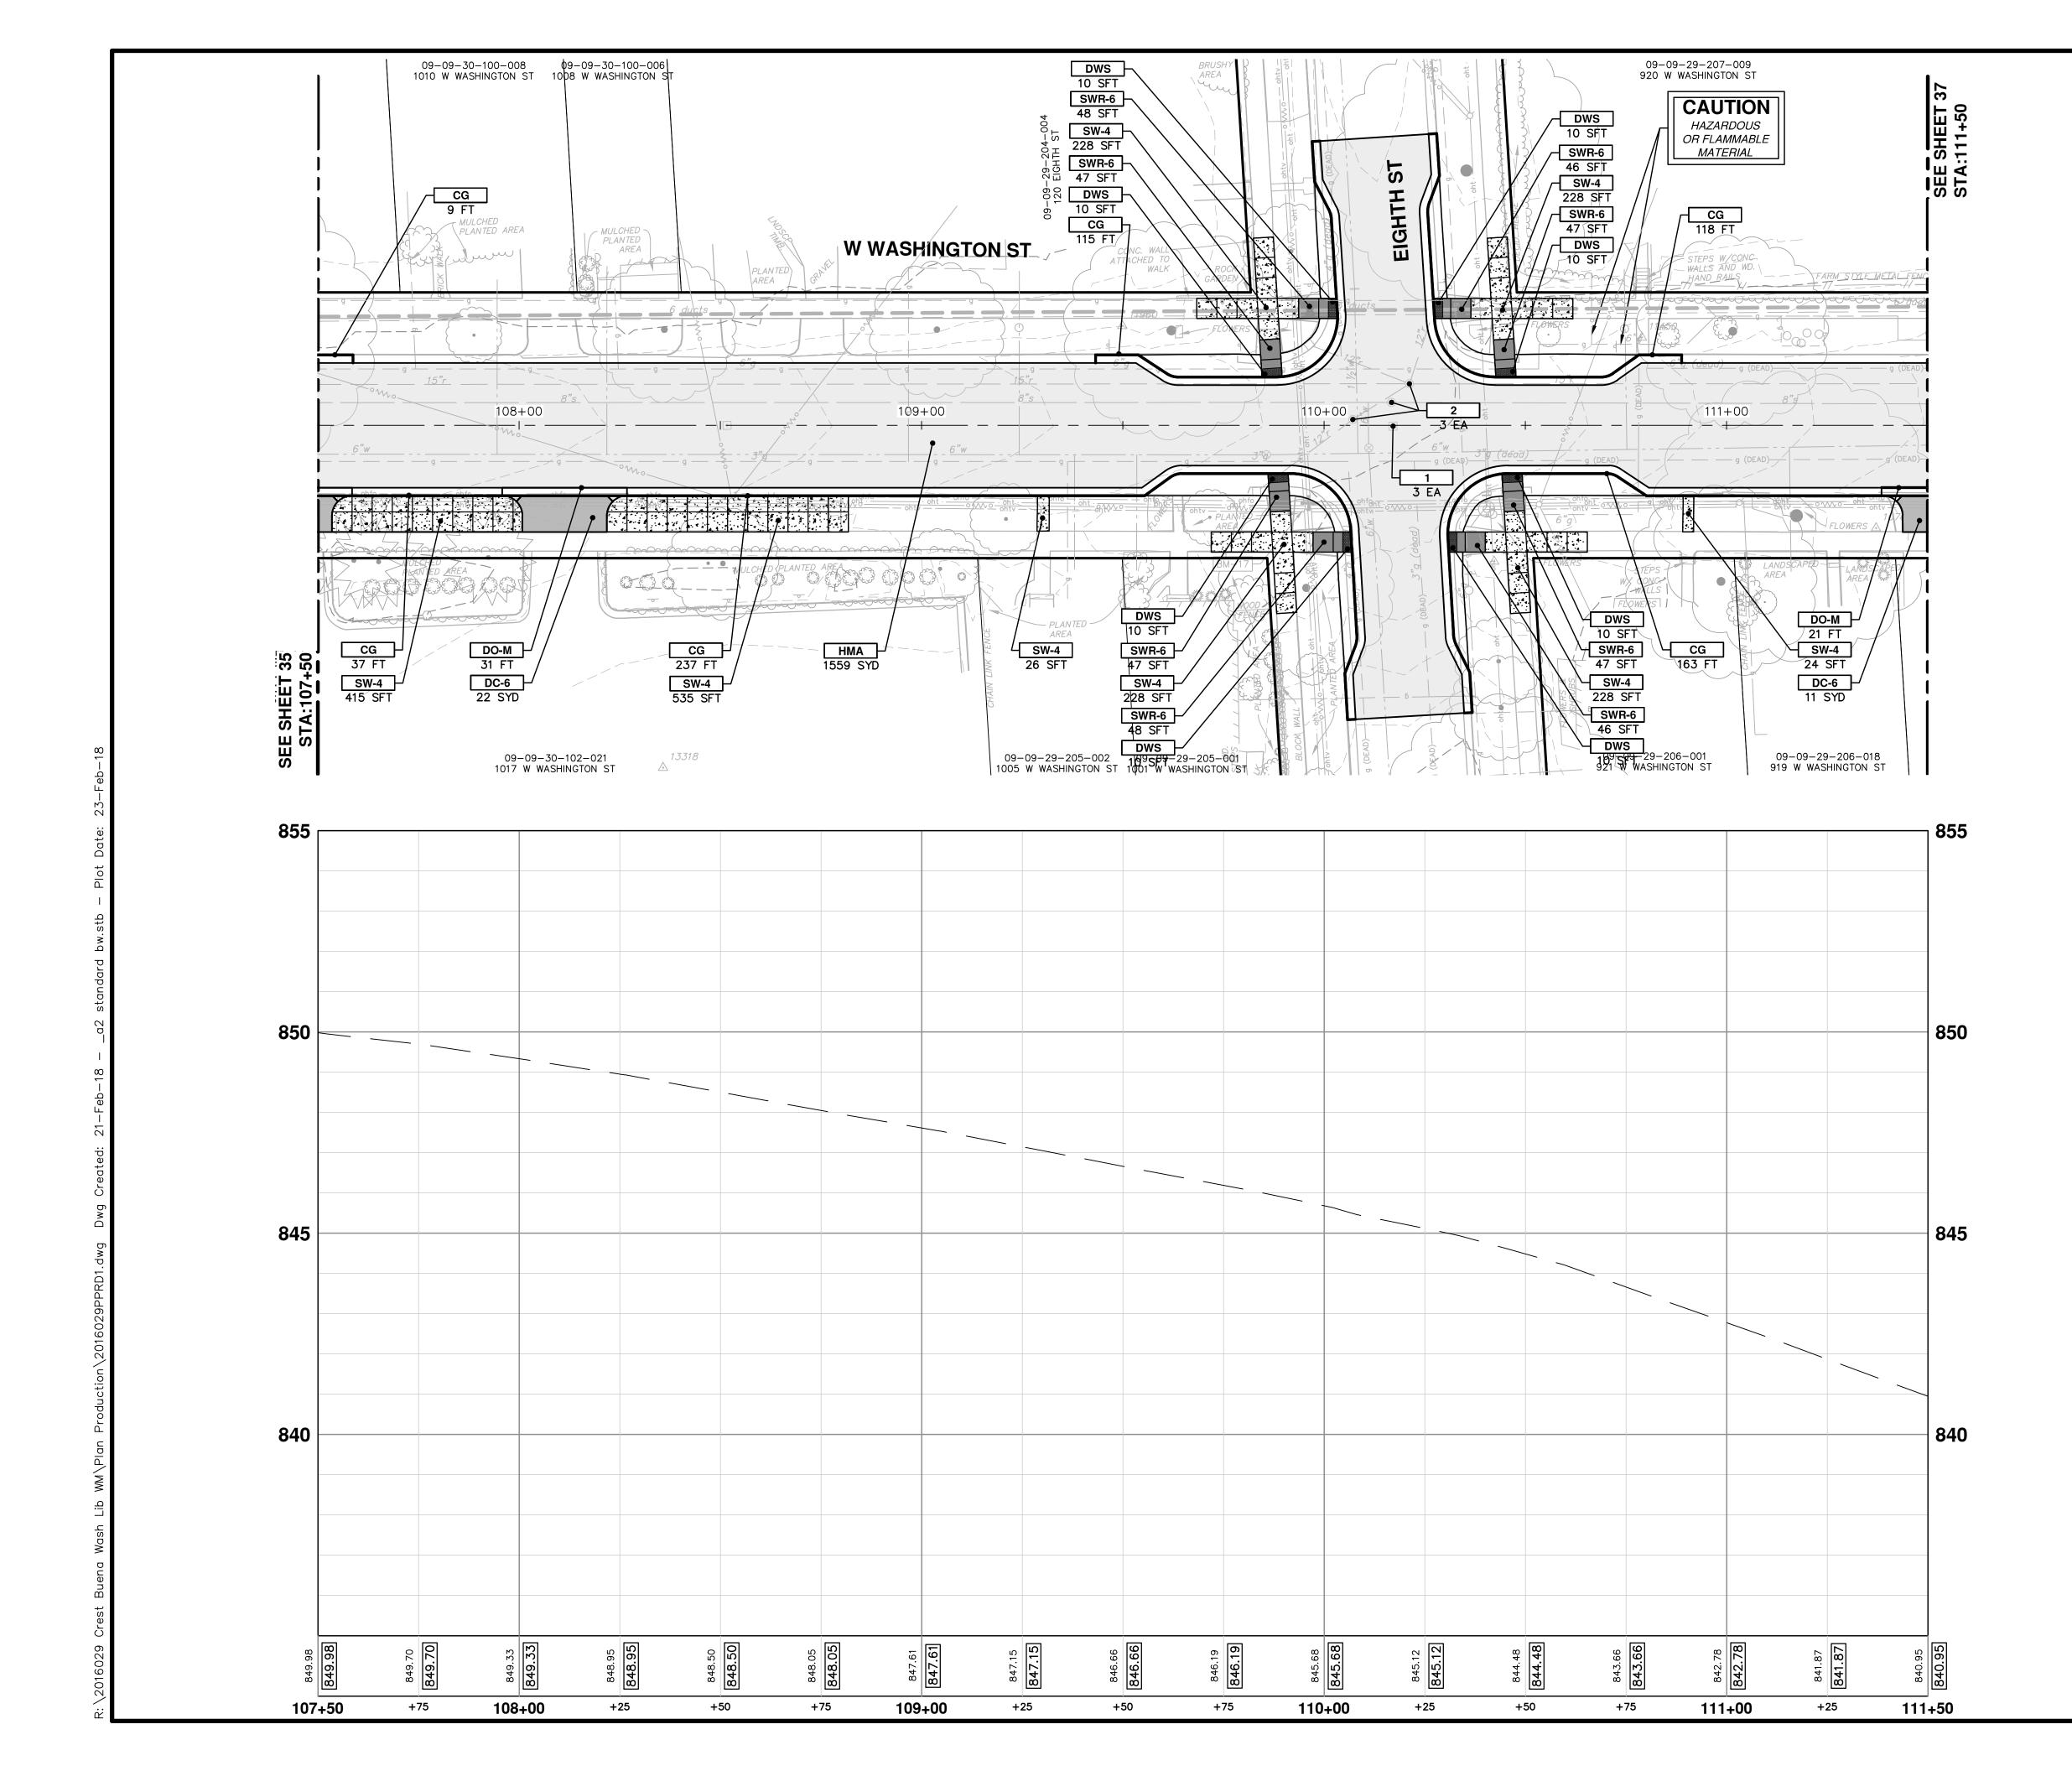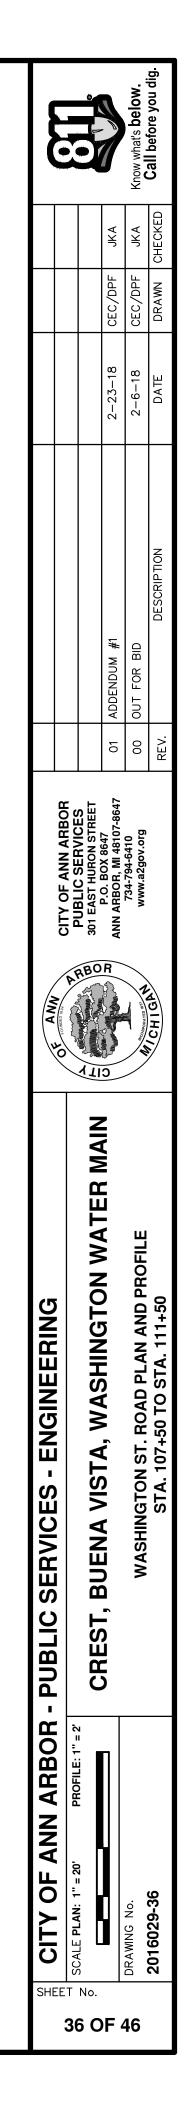
CC	INSTRUCTION KEY
KEY	DESCRIPTION
НМА	PLACE HMA, LVSP. PLACE MATERIAL IN LIFTS ACCORDING TO THE TYPICAL SECTION AND AS DIRECTED BY THE ENGINEER.
CG	PLACE CURB AND GUTTER, CONC, F4, SPECIAL
DO-M	PLACE DRIVEWAY OPENING, CONC, DETAIL M, P-NC
DC-6	PLACE CONC, DRIVE APPROACH, NON-REINFORCED, P-NC, 6 INCH. PLACE AND COMPACT 6 INCH SUBBASE, CIP, CLASS II GRANULAR MATERIAL, MODIFIED.
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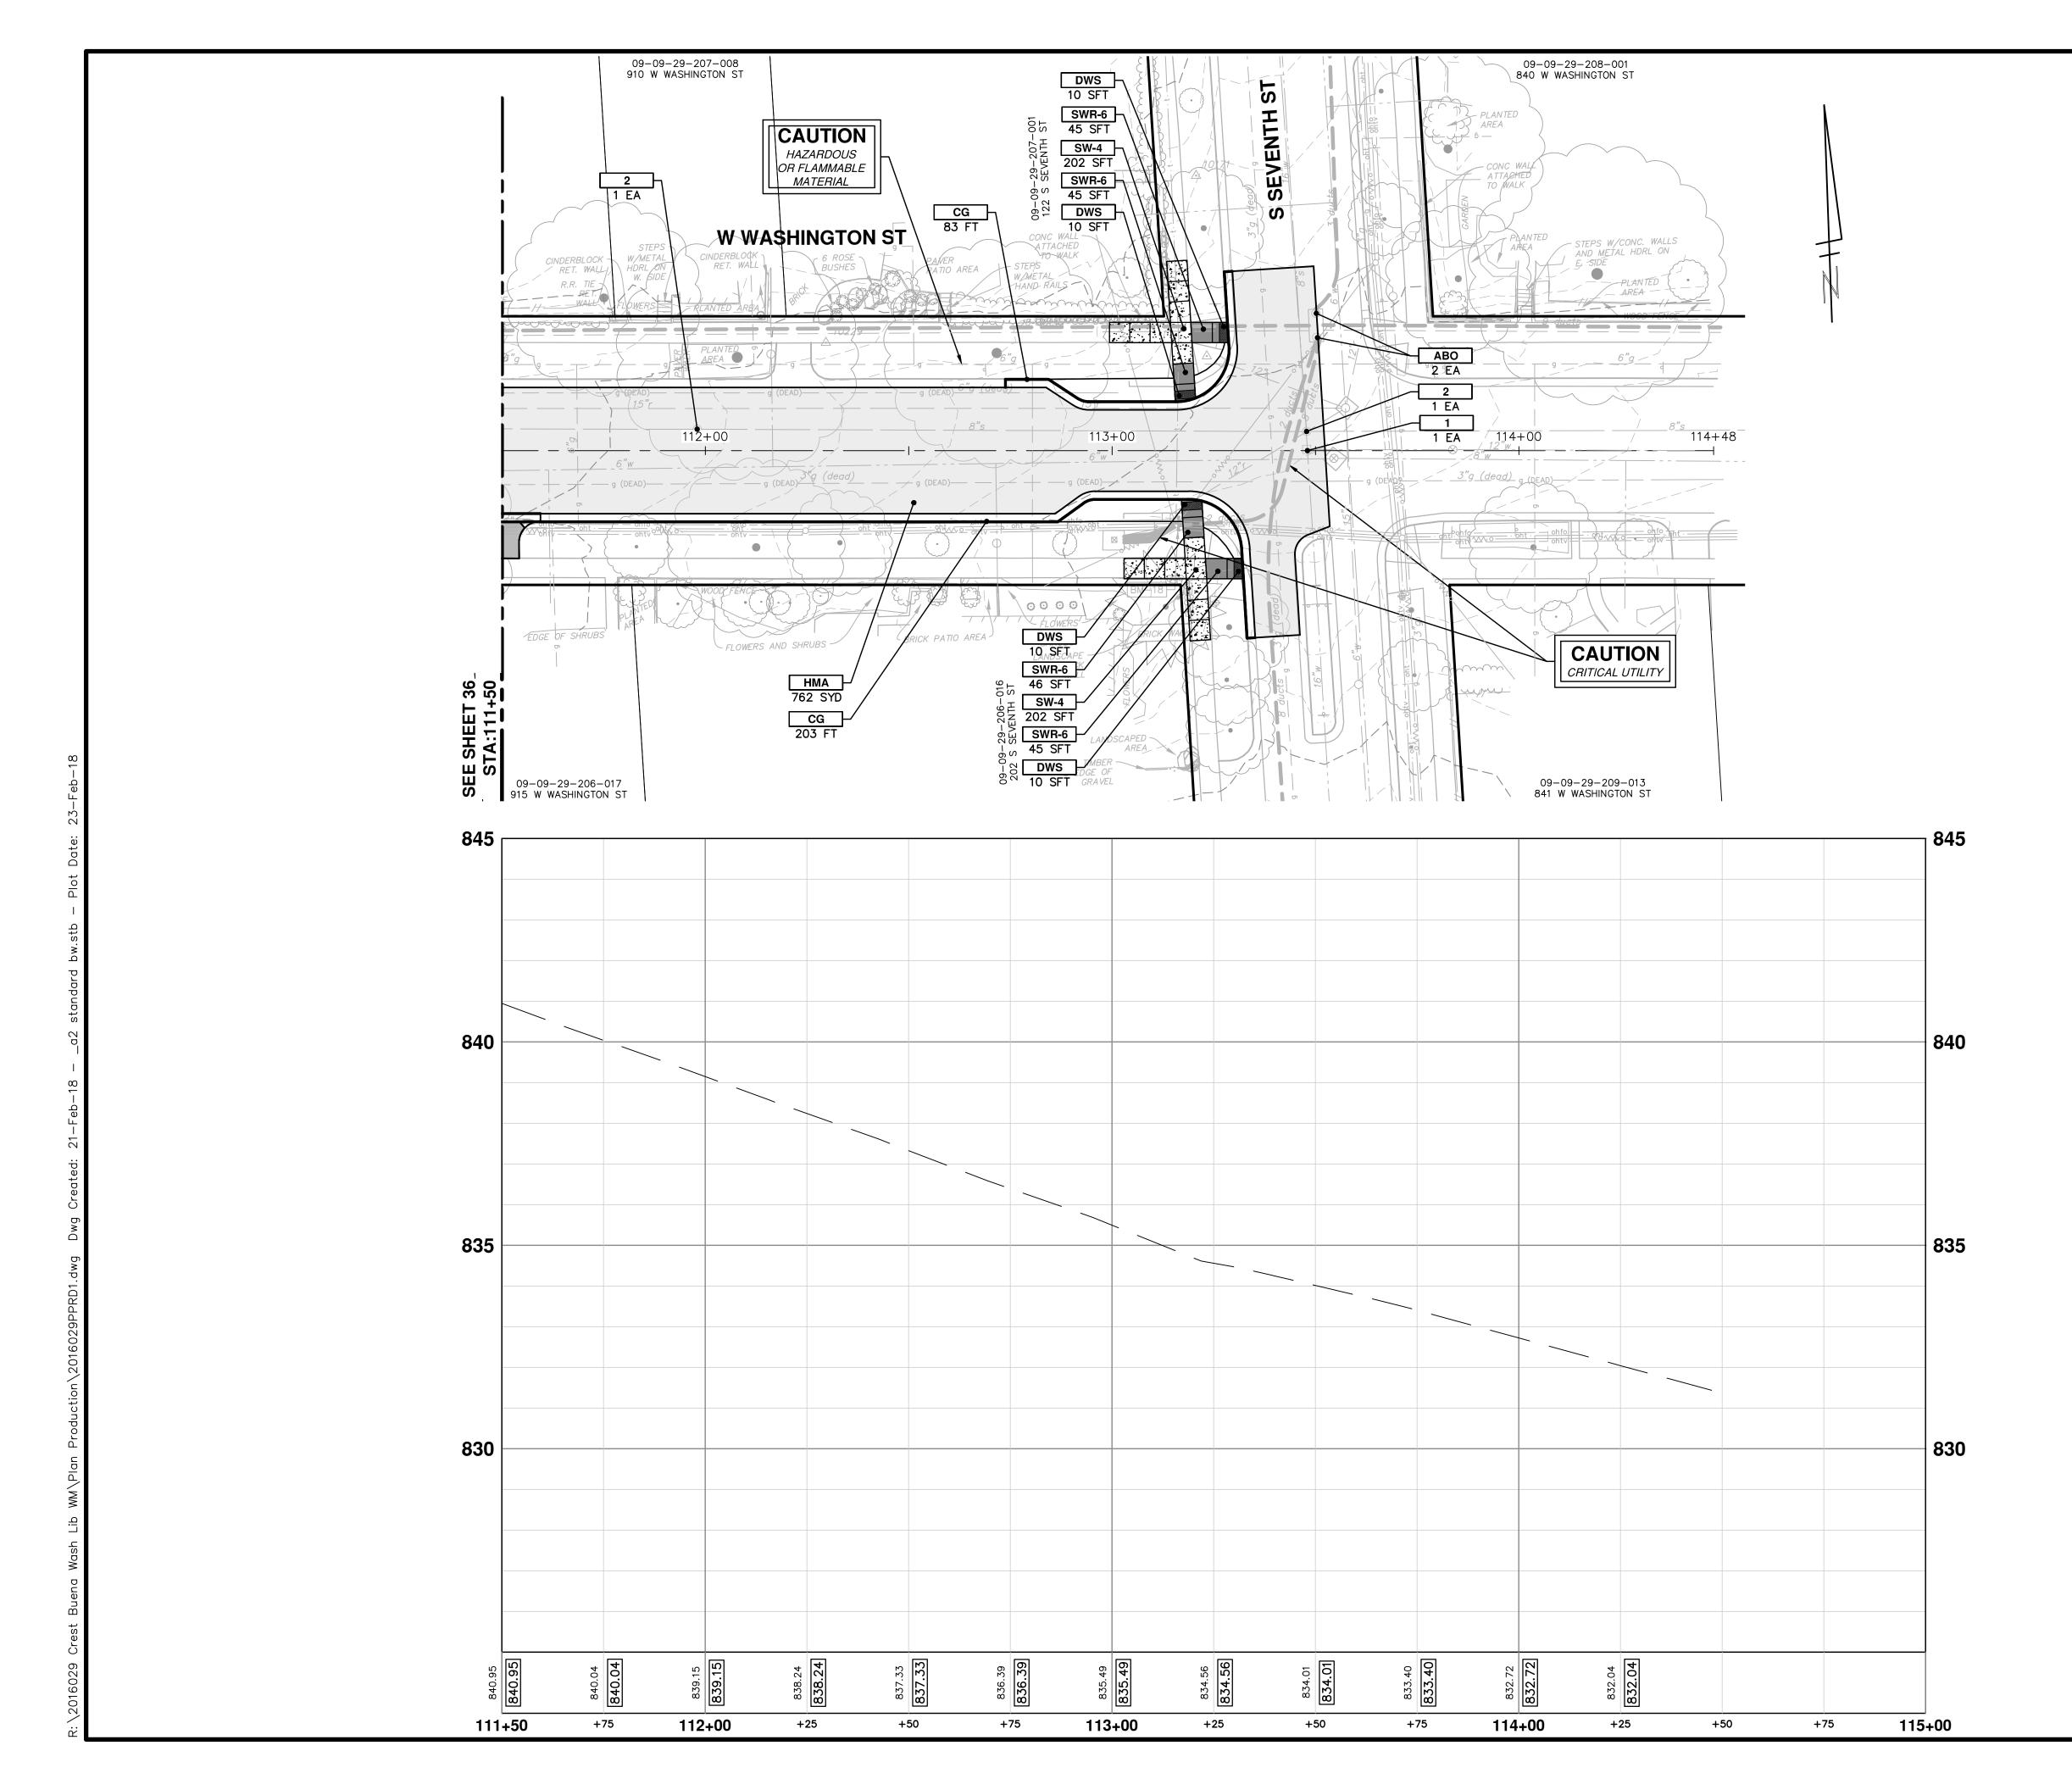
	E CITY OF ANN ARBOR	NN ARROR - PUBLIC SERVICES - ENGINEERING	AND					
		CDECT DIJENIA VICTA WACUINCTON WATED MAIN	1 /2 / 2 / 2 / 2 / 2 / 2 / 2 / 2 / 2 / 2					
)F				01 ADDENDUM #1	2-23-18	CEC/DPF	JKA	
4						`		
16	URAWING NO.	WASHINGTON ST. ROAD PLAN AND PROFILE	734-794-6410 WWW.a2gov.org	00 OUT FOR BID	2-6-18	CEC/DPF	JKA	Know what's below.
	2016029-35	STA. 103+50 TO STA. 107+50	MCHIGAN	REV. DESCRIPTION	DATE	DRAWN CHECKED	CHECKED	Call before you dig.

35 OF 46




CC	<b>DNSTRUCTION KEY</b>
KEY	DESCRIPTION
НМА	PLACE HMA, LVSP. PLACE MATERIAL IN LIFTS ACCORDING TO THE TYPICAL SECTION AND AS DIRECTED BY THE ENGINEER.
CG	PLACE CURB AND GUTTER, CONC, F4, SPECIAL
DO-M	PLACE DRIVEWAY OPENING, CONC, DETAIL M, P-NC
DC-6	PLACE CONC, DRIVE APPROACH, NON-REINFORCED, P-NC, 6 INCH. PLACE AND COMPACT 6 INCH SUBBASE, CIP, CLASS II GRANULAR MATERIAL, MODIFIED.
SW-4	PLACE SIDEWALK, CONC, 4 INCH, MODIFIED
SWR-6	PLACE SIDEWALK RAMP, CONC, 6 INCH, MODIFIED
DWS	DETECTABLE WARNING, CAST IN PLACE
ABO	ADJUST BY OTHERS
1	ADJUST GATE VALVE BOX, MONUMENT BOX, OR GAS BOX.
2	ADJUST STRUCTURE COVER






ARBOR	ARBOR - PUBLIC SERVICES - ENGINEERING	AM						
		O FOUNDE BAS						
PROFILE: 1" = 2'								
	CREST, BUFNA VISTA, WASHINGTON WATER MAIN	1 1 1 1 201 EAST HURON STREET						
		- C ( こうしょう ) 辺 ANN ARBOR, MI 48107-8647	10	01 ADDENDUM #1	2-23-18	CEC/DPF	AXL	
	WASHINGTON ST BOAD BLAN DEOFILE	734-794-6410 www a2ddv ofd	8	00 OUT FOR BID	2-6-18	CEC/DPF	- AXD	Know what's below.
	STA. 111+50 TO STA. 114+48	M/CHIGAN	REV.	DESCRIPTION	DATE	DRAWN	DRAWN CHECKED	Call before you dig.


CC	ONSTRUCTION KEY
KEY	DESCRIPTION
НМА	PLACE HMA, LVSP. PLACE MATERIAL IN LIFTS ACCORDING TO THE TYPICAL SECTION AND AS DIRECTED BY THE ENGINEER.
CG	PLACE CURB AND GUTTER, CONC, F4, SPECIAL
DO-M	PLACE DRIVEWAY OPENING, CONC, DETAIL M, P-NC
DC-6	PLACE CONC, DRIVE APPROACH, NON-REINFORCED, P-NC, 6 INCH. PLACE AND COMPACT 6 INCH SUBBASE, CIP, CLASS II GRANULAR MATERIAL, MODIFIED.
SW-4	PLACE SIDEWALK, CONC, 4 INCH, MODIFIED
SWR-6	PLACE SIDEWALK RAMP, CONC, 6 INCH, MODIFIED
DWS	DETECTABLE WARNING, CAST IN PLACE
ABO	ADJUST BY OTHERS
1	ADJUST GATE VALVE BOX, MONUMENT BOX, OR GAS BOX.
2	ADJUST STRUCTURE COVER

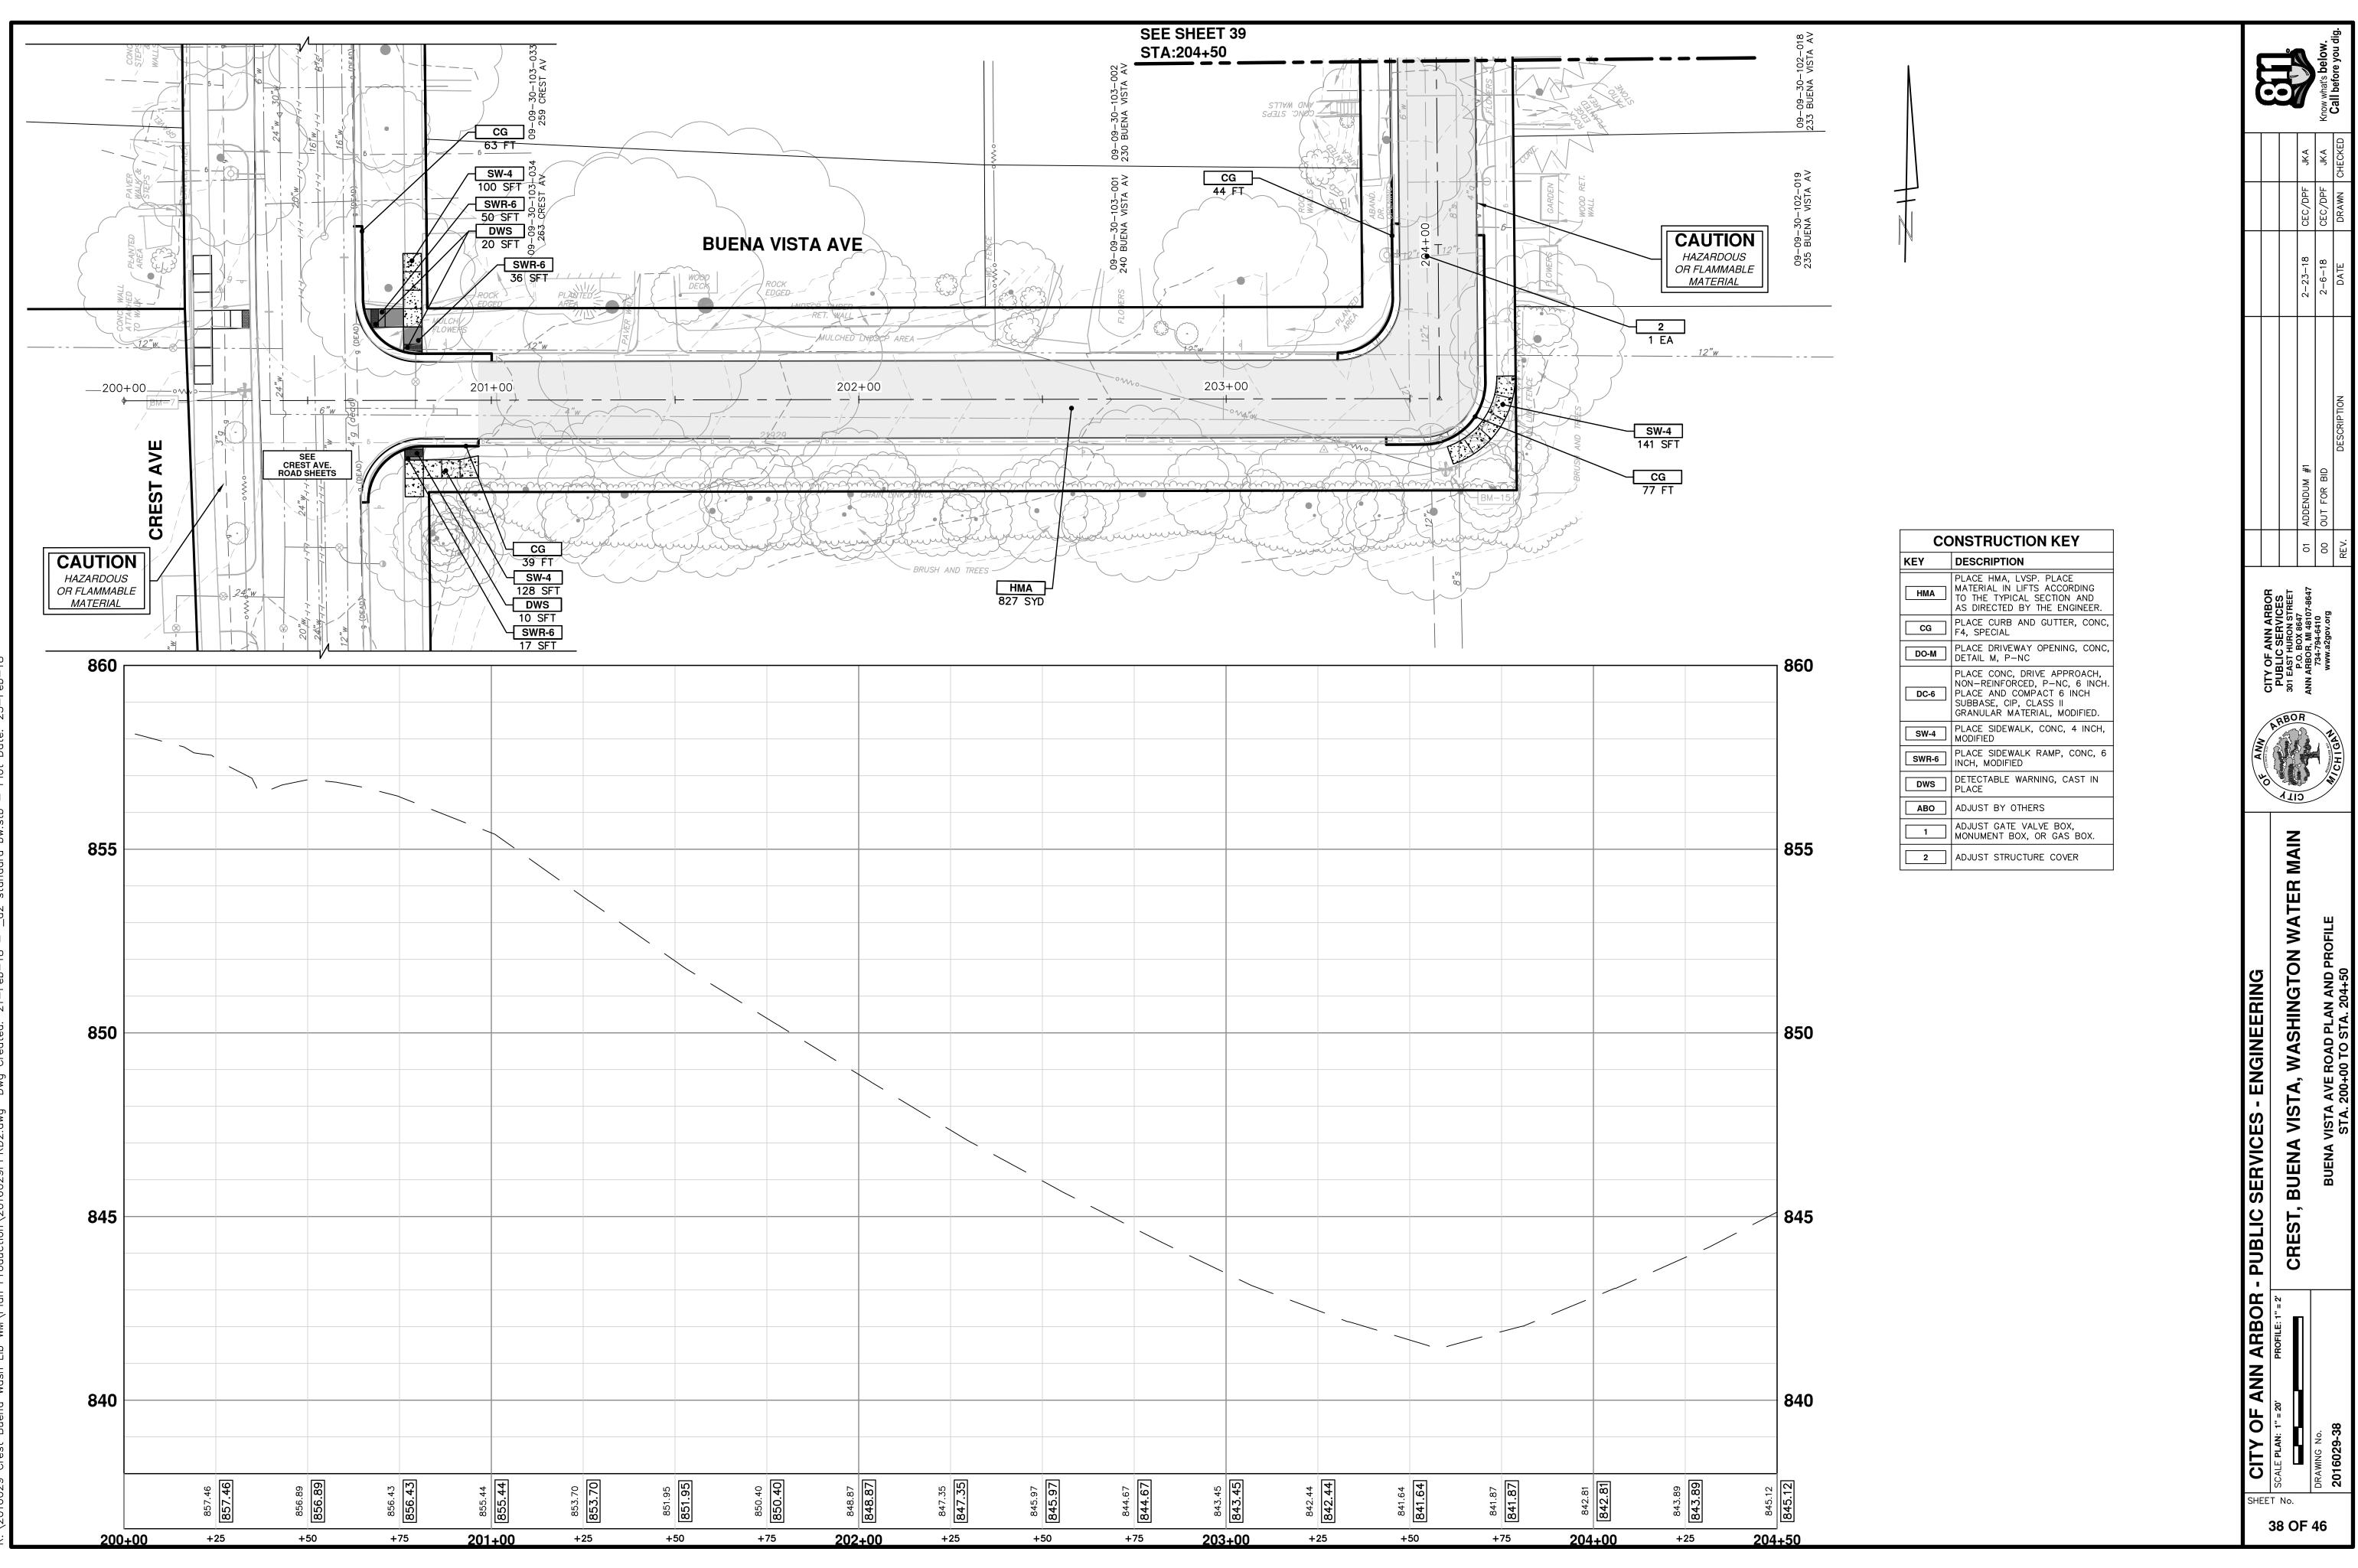

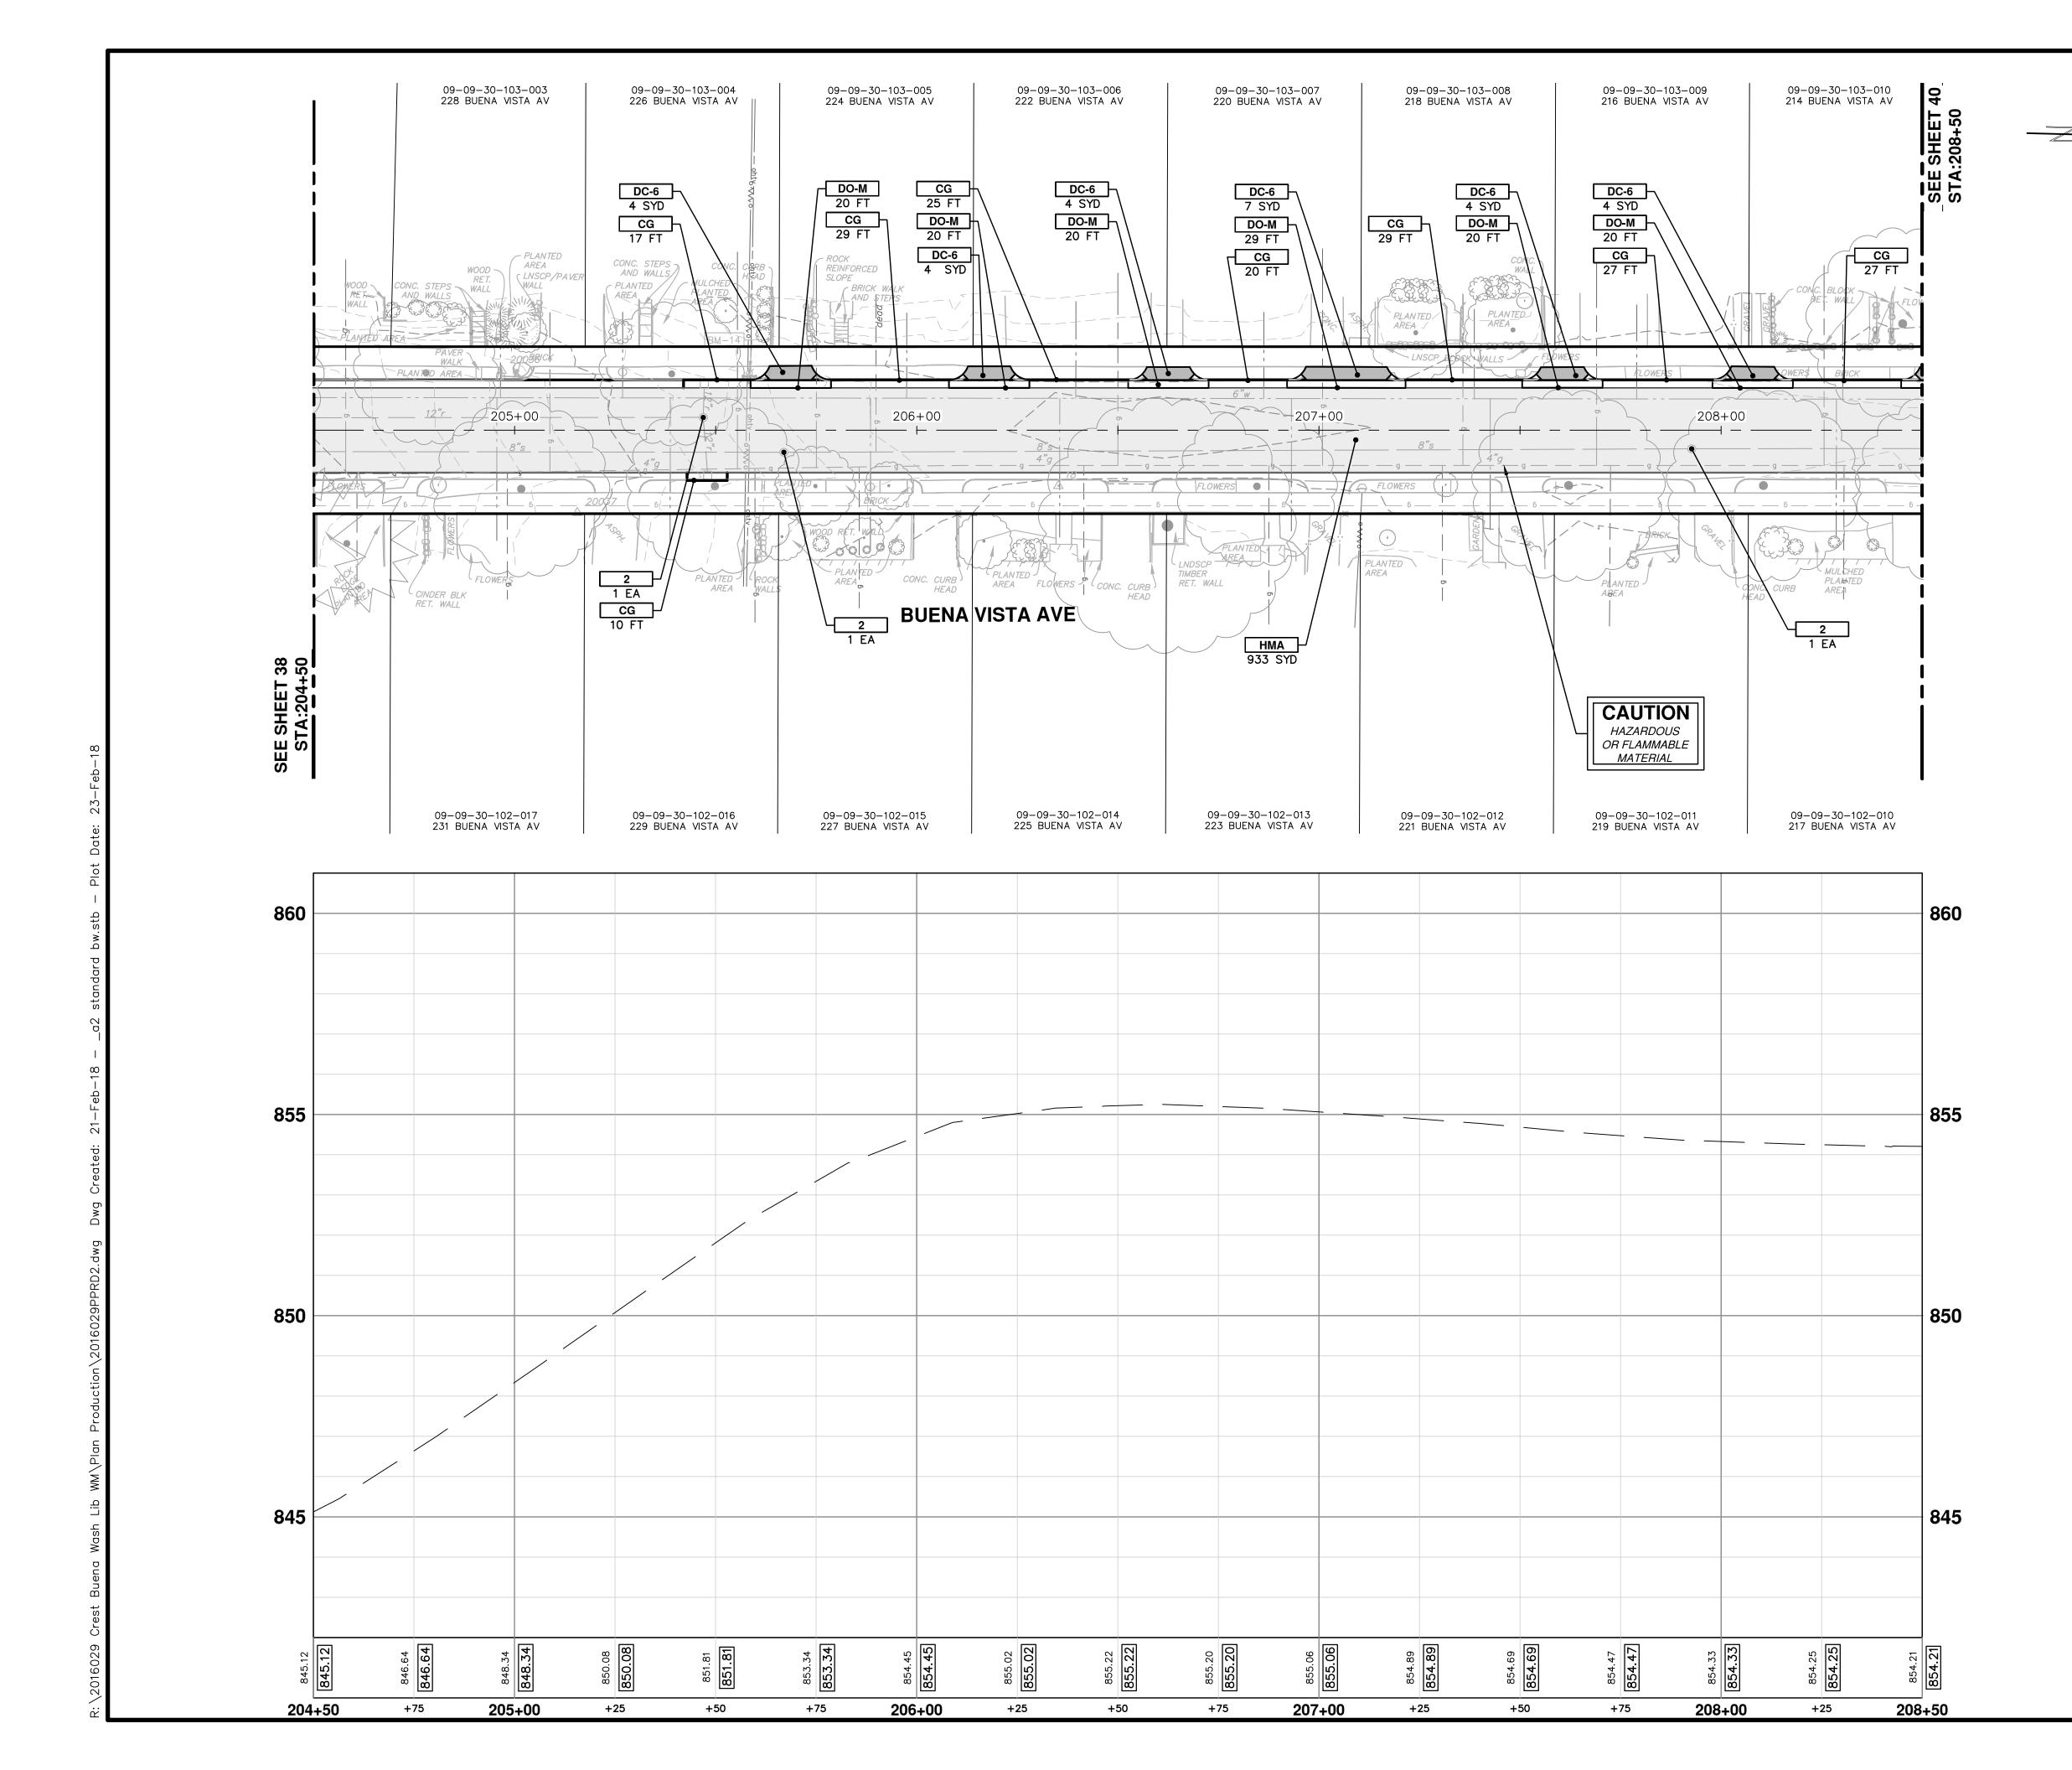

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				CEC/DPF ,			DRAWN CHECKED
				2-23-18 C	2-6-18 C		DATE
				ADDENDUM #1			DESCRIPTION
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ANN	Normal Control	RE Superior / V				M. MCORPORATED WE'N	CHIGH
ARBOR - PUBLIC SERVICES - ENGINEERING			CREST. BUENA VISTA. WASHINGTON WATER MAIN			BUENA VISTA AVE KOAD PLAN AND PROFILE	STA. 204+50 TO STA. 208+50
<b>CITY OF ANN ARBOR -</b>		SCALE PLAN: 1" = 20' PROFILE: 1" = 2'			DRAWING No.		2016029-39
SHE			o.			•	. •

CC	<b>INSTRUCTION KEY</b>
KEY	DESCRIPTION
НМА	PLACE HMA, LVSP. PLACE MATERIAL IN LIFTS ACCORDING TO THE TYPICAL SECTION AND AS DIRECTED BY THE ENGINEER.
CG	PLACE CURB AND GUTTER, CONC, F4, SPECIAL
DO-M	PLACE DRIVEWAY OPENING, CONC, DETAIL M, P-NC
DC-6	PLACE CONC, DRIVE APPROACH, NON-REINFORCED, P-NC, 6 INCH. PLACE AND COMPACT 6 INCH SUBBASE, CIP, CLASS II GRANULAR MATERIAL, MODIFIED.
SW-4	PLACE SIDEWALK, CONC, 4 INCH, MODIFIED
SWR-6	PLACE SIDEWALK RAMP, CONC, 6 INCH, MODIFIED
DWS	DETECTABLE WARNING, CAST IN PLACE
ABO	ADJUST BY OTHERS
1	ADJUST GATE VALVE BOX, MONUMENT BOX, OR GAS BOX.
2	ADJUST STRUCTURE COVER

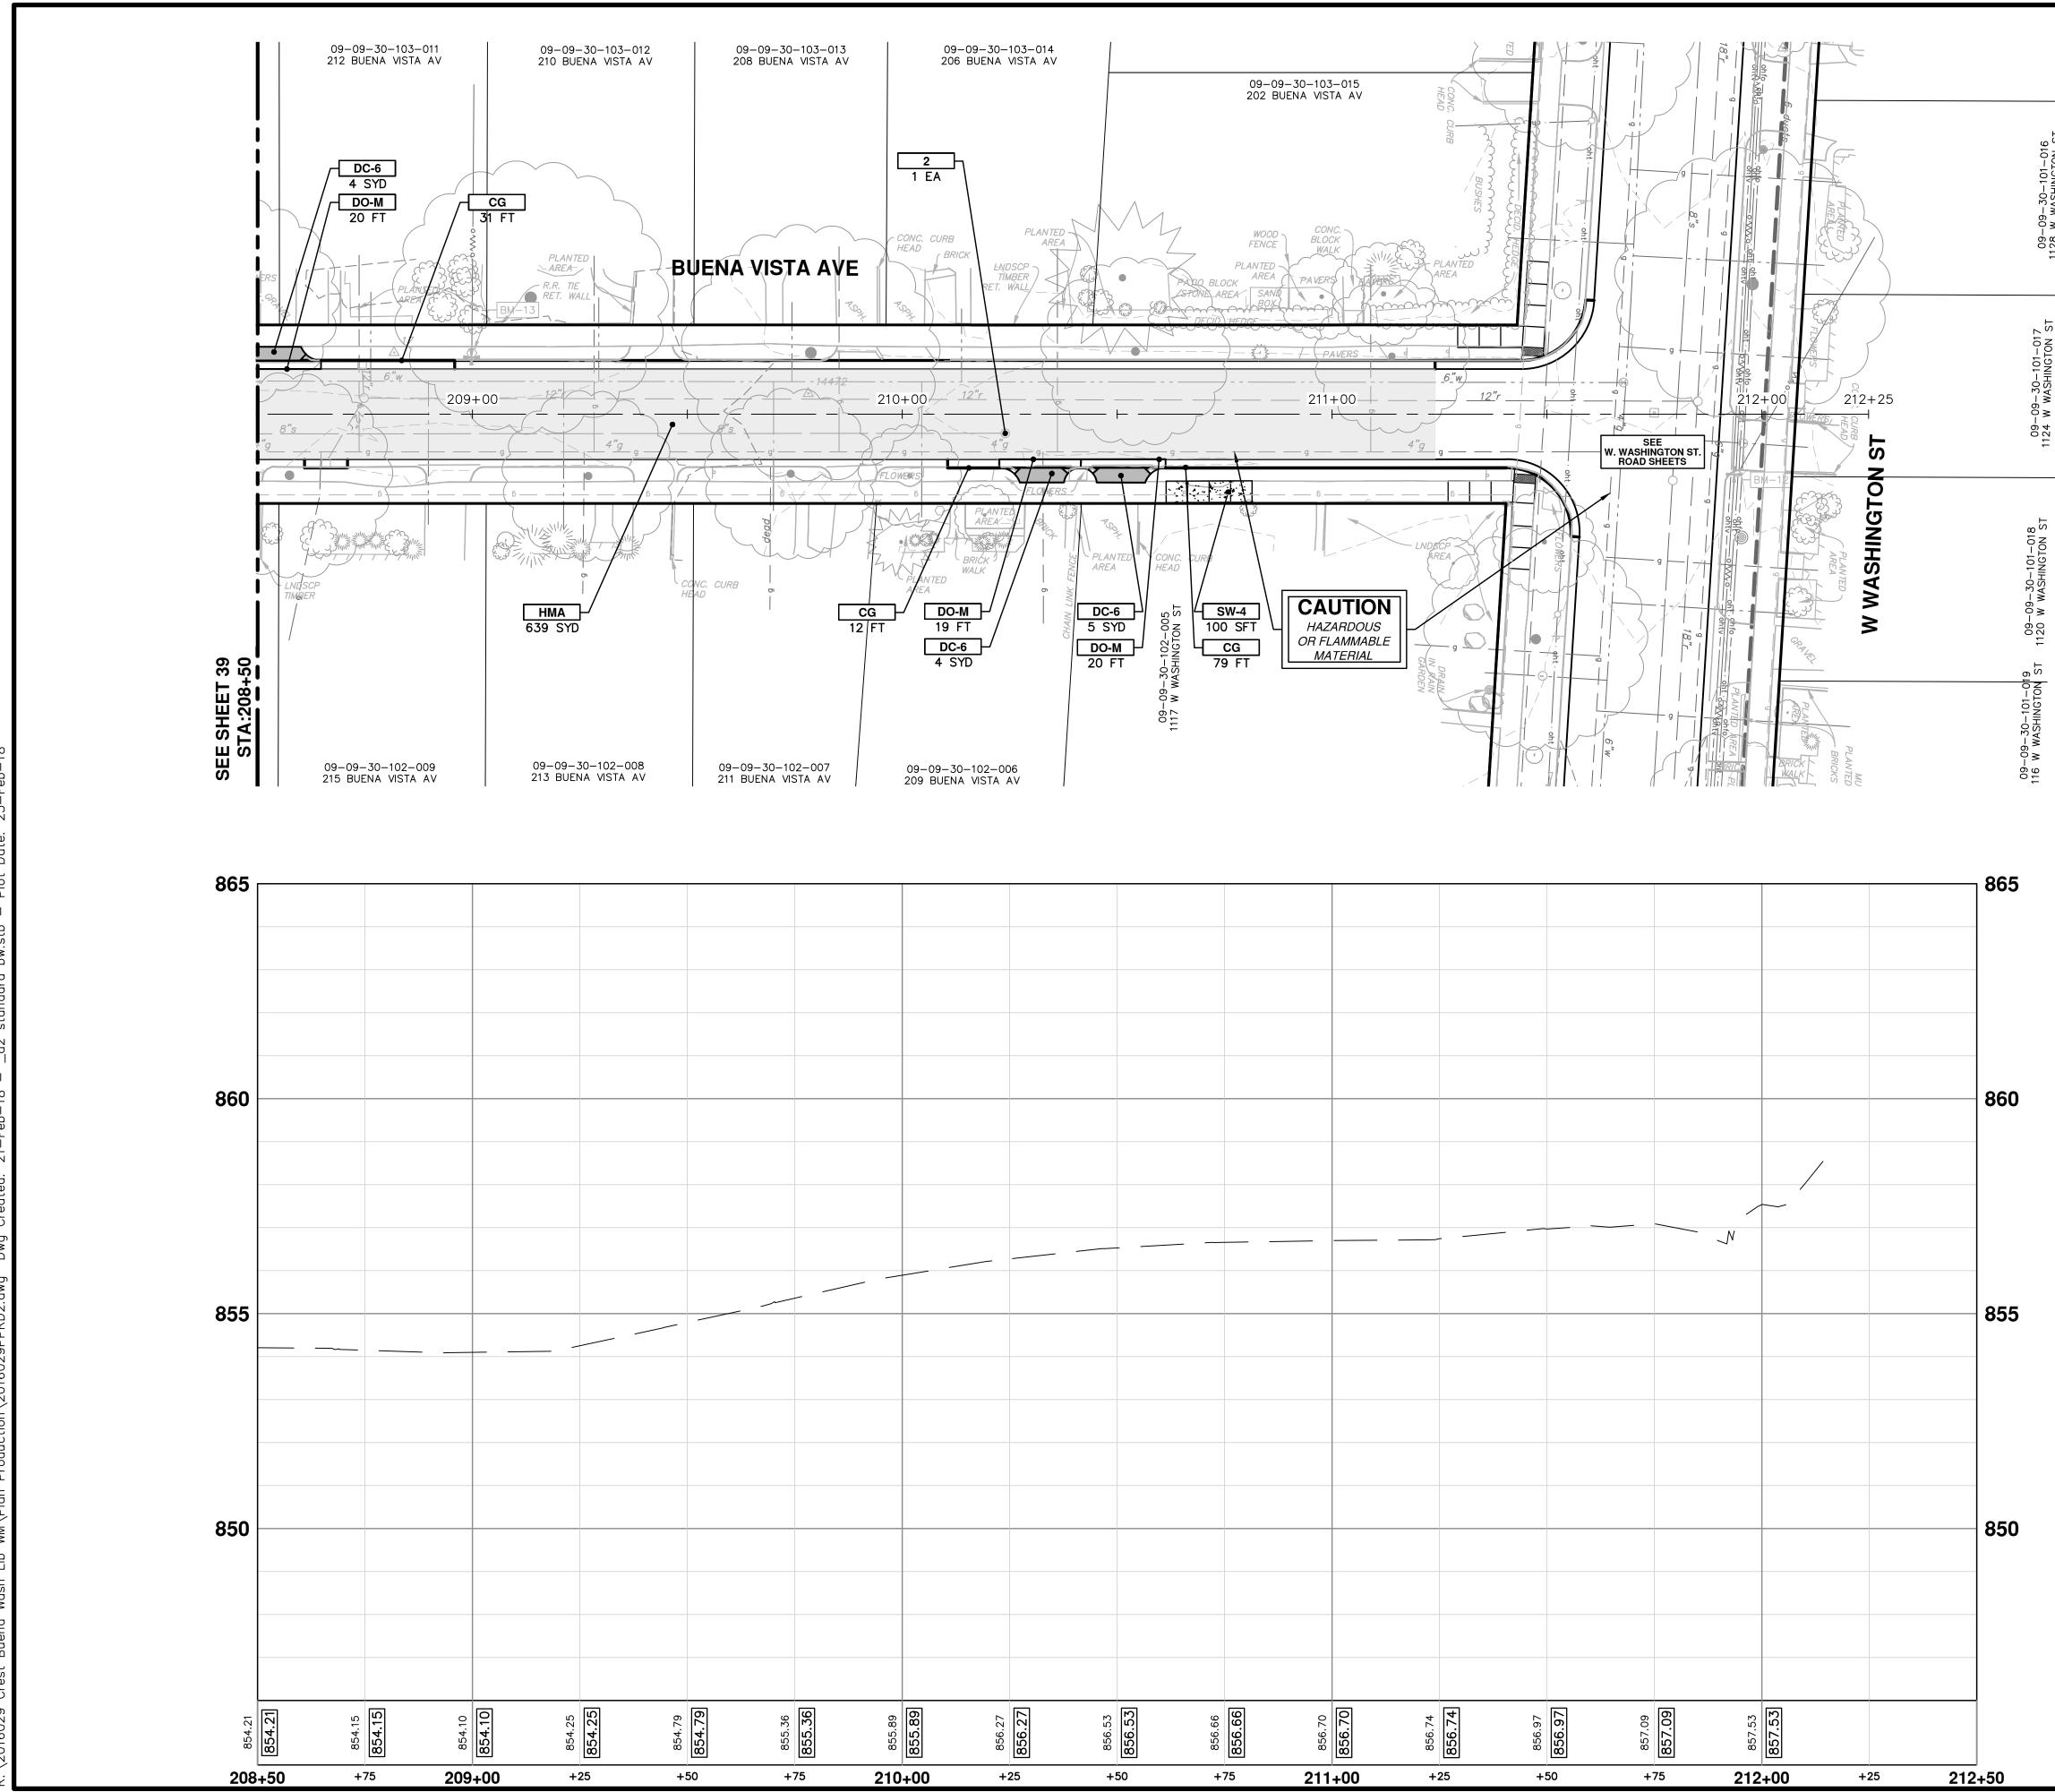

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CONSTRUCTION KEY       KEY     DESCRIPTION       PLACE     HMA, LVSP. PLACE			
HMA MATERIAL IN LIFTS ACCORDING TO THE TYPICAL SECTION AND AS DIRECTED BY THE ENGINEER.			ICES STREET
CG     PLACE CURB AND GUTTER, CONC,       F4, SPECIAL       PLACE DRIVEWAY OPENING, CONC,       DO-M			HURON S
PLACE CONC, DRIVE APPROACH, NON-REINFORCED, P-NC, 6 INCH.		CITY OF	PUBLIC SERVICES 301 EAST HURON STREET P.O. BOX 8647
SUBBASE, CIP, CLASS II GRANULAR MATERIAL, MODIFIED.			ABOF
sw-4     PLACE SIDEWALK, CONC, 4 INCH, MODIFIED       swR-6     PLACE SIDEWALK RAMP, CONC, 6 INCH, MODIFIED	ANA		
DWS DETECTABLE WARNING, CAST IN PLACE	/4	10	
ABO ADJUST BY OTHERS ADJUST GATE VALVE BOX, MONUMENT BOX, OR GAS BOX.	F	Τ	z
2 ADJUST STRUCTURE COVER			MAIN
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			<b>CREST, BUENA VISTA, WASHINGTON WAT</b>
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ADDENDUM #1 OUT FOR BID

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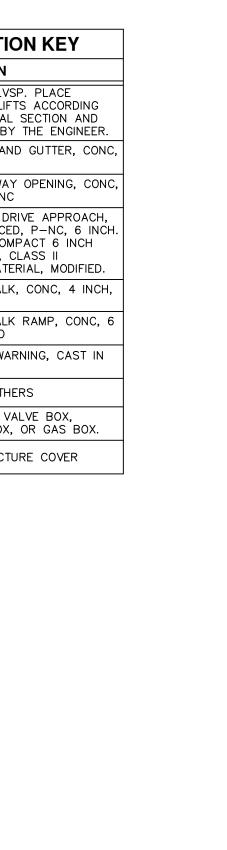
CITY OF ANN ARBOR PUBLIC SERVICES 301 EAST HURON STREET P.O. BOX 8647 734-794-6410 www.a2gov.org

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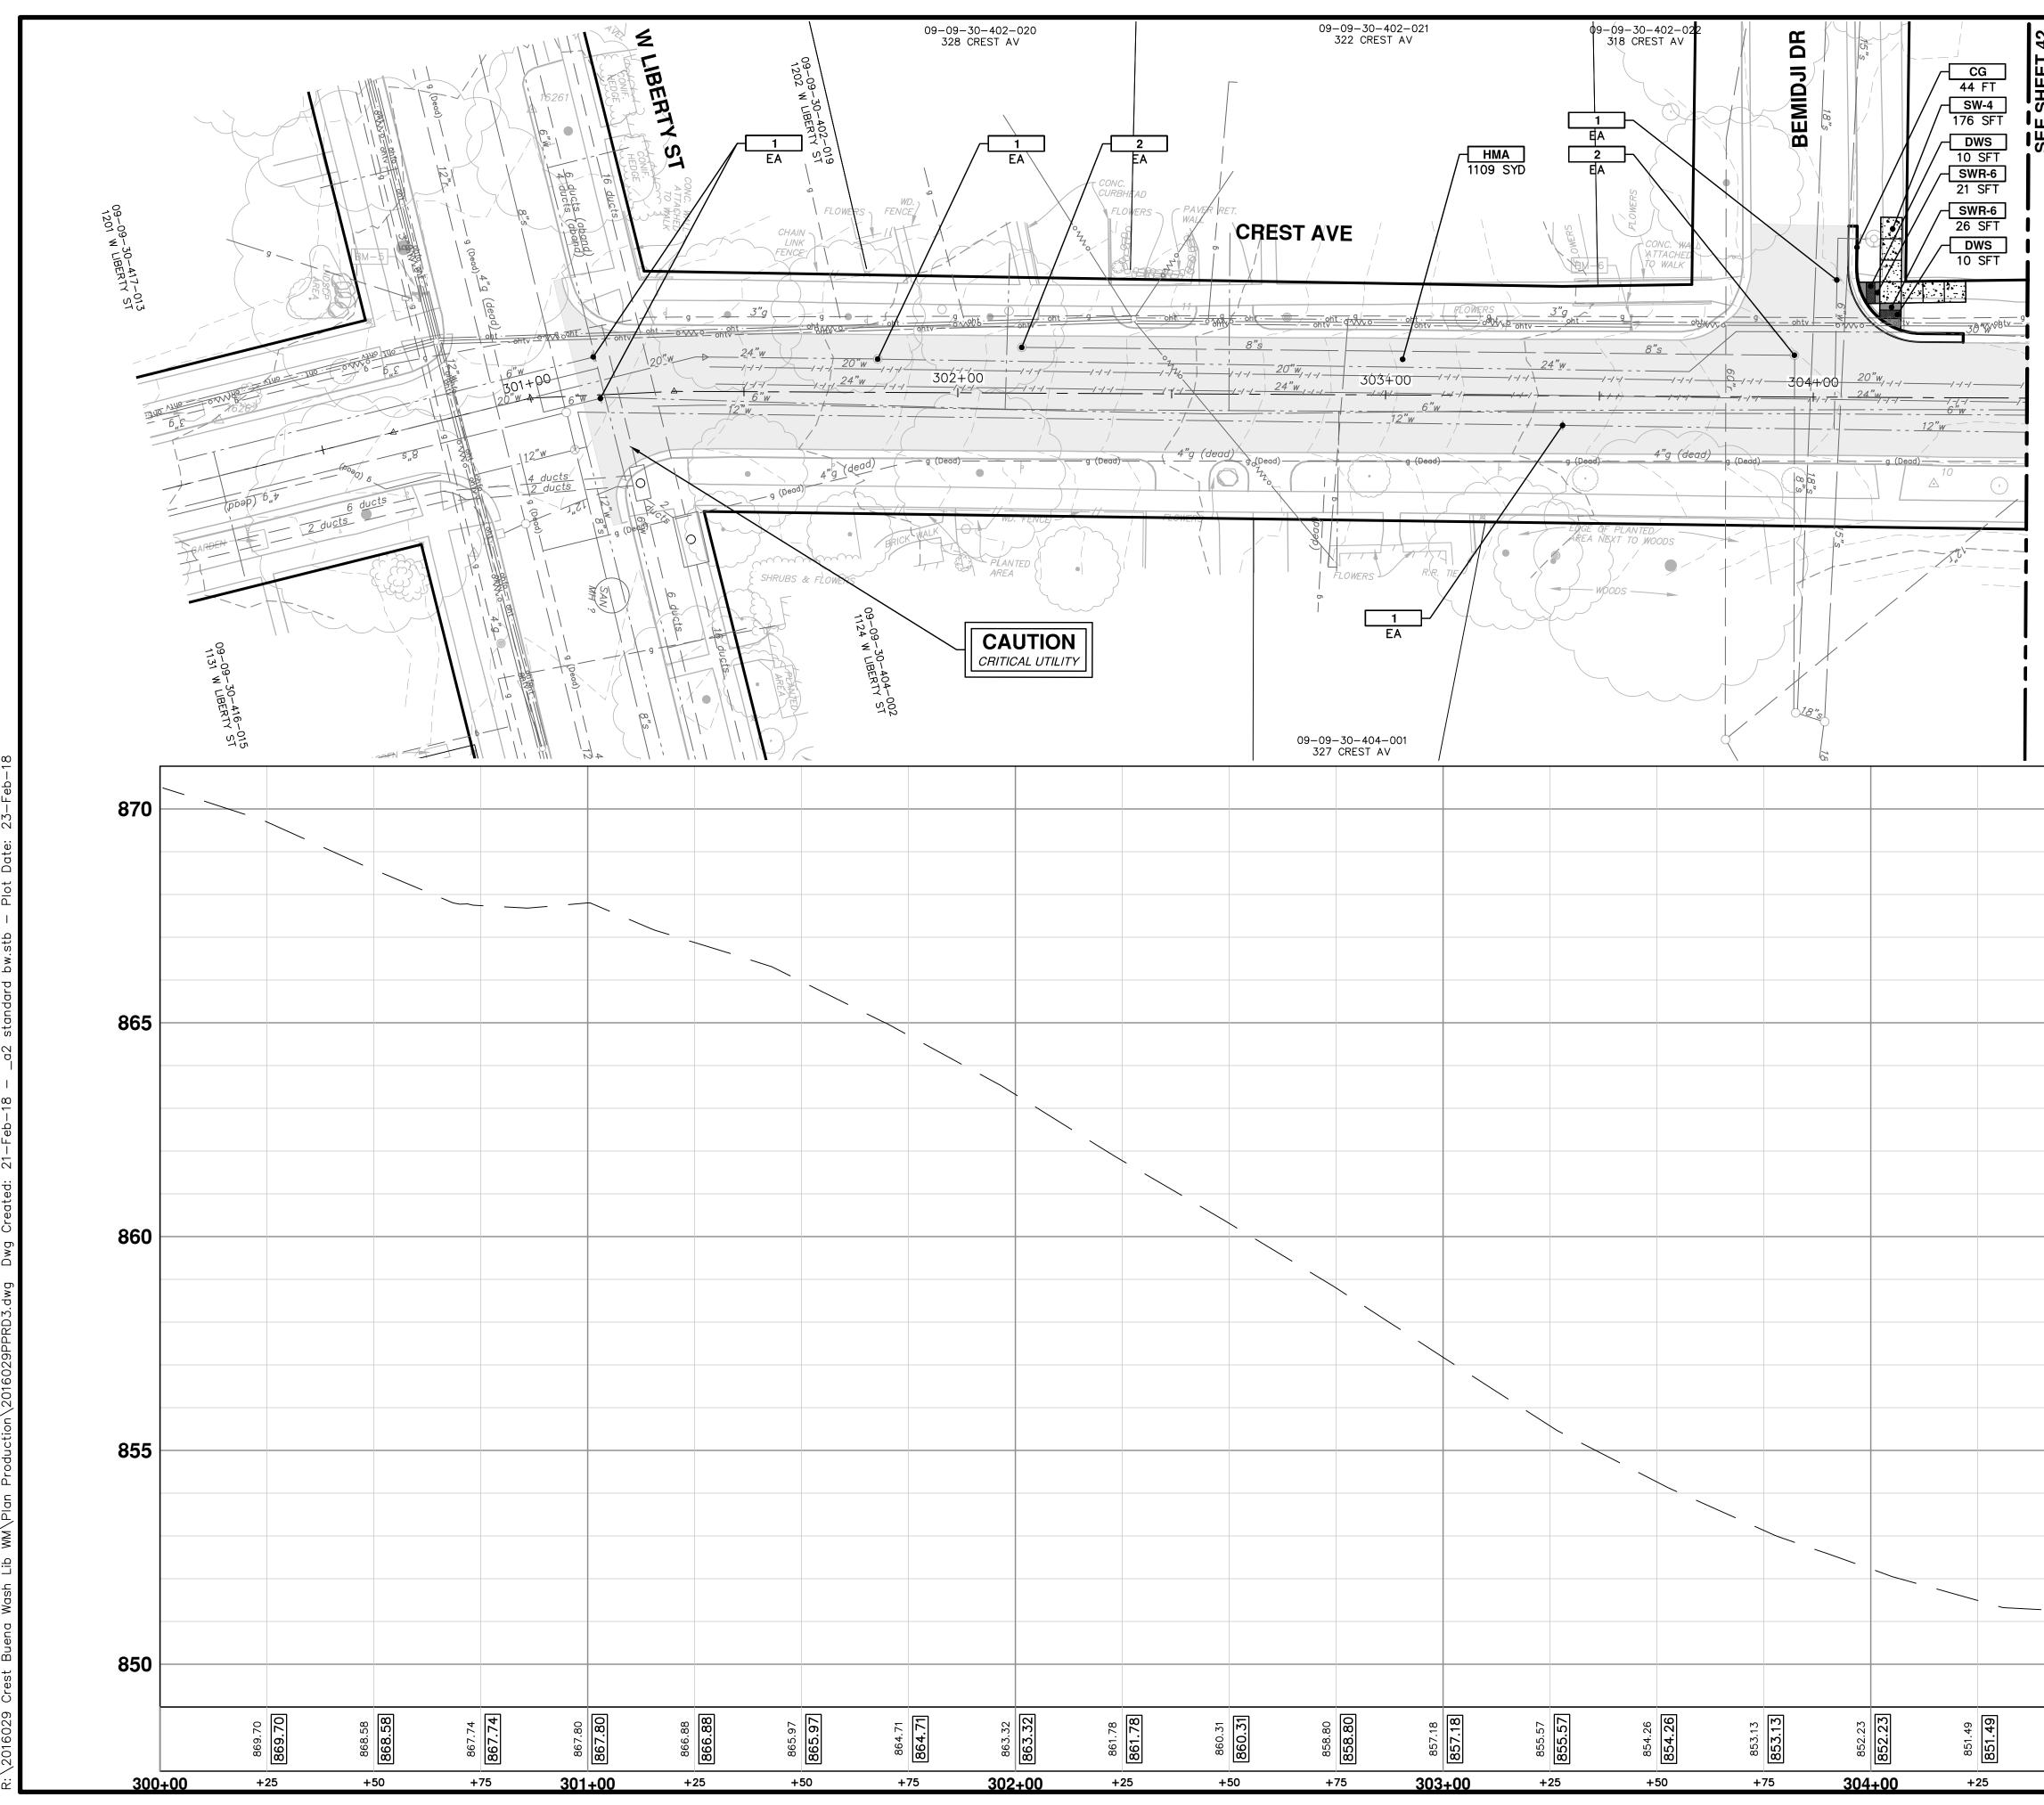
CREST, BUENA VISTA, WASHINGTON WATE

BUENA VISTA AVE ROAD PLAN AND PROFILE STA. 208+50 TO STA. 212+50




40 OF 46


DRA 201




42 SEE SHEET STA:304+50

CC	INSTRUCTION KEY
KEY	DESCRIPTION
НМА	PLACE HMA, LVSP. PLACE MATERIAL IN LIFTS ACCORDING TO THE TYPICAL SECTION AND AS DIRECTED BY THE ENGINEER.
CG	PLACE CURB AND GUTTER, CONC, F4, SPECIAL
DO-M	PLACE DRIVEWAY OPENING, CONC, DETAIL M, P-NC
DC-6	PLACE CONC, DRIVE APPROACH, NON-REINFORCED, P-NC, 6 INCH. PLACE AND COMPACT 6 INCH SUBBASE, CIP, CLASS II GRANULAR MATERIAL, MODIFIED.
SW-4	PLACE SIDEWALK, CONC, 4 INCH, MODIFIED
SWR-6	PLACE SIDEWALK RAMP, CONC, 6 INCH, MODIFIED
DWS	DETECTABLE WARNING, CAST IN PLACE
ABO	ADJUST BY OTHERS
1	ADJUST GATE VALVE BOX, MONUMENT BOX, OR GAS BOX.
2	ADJUST STRUCTURE COVER

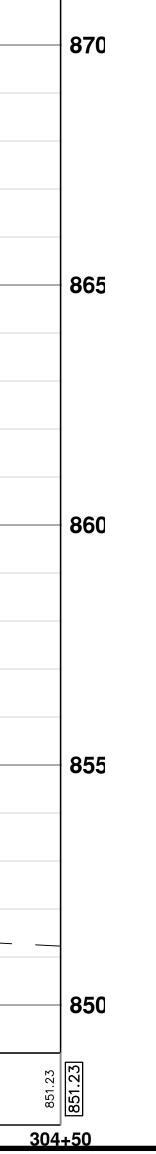

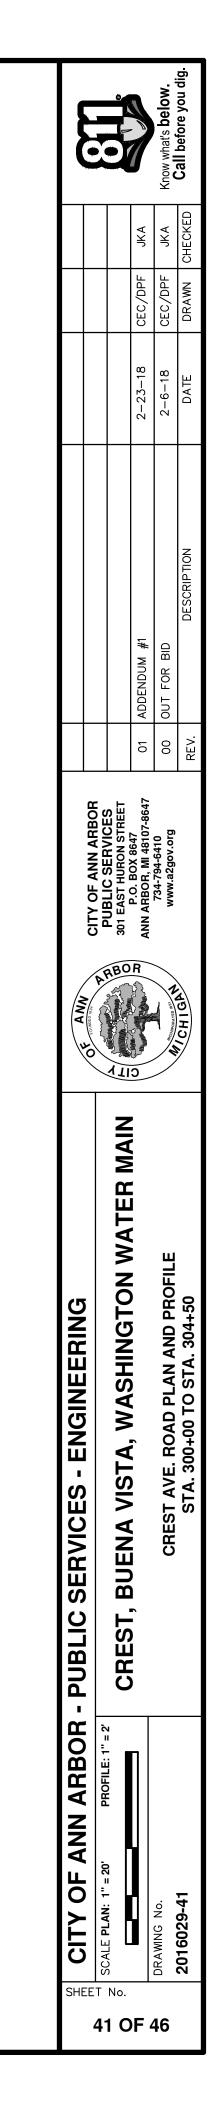


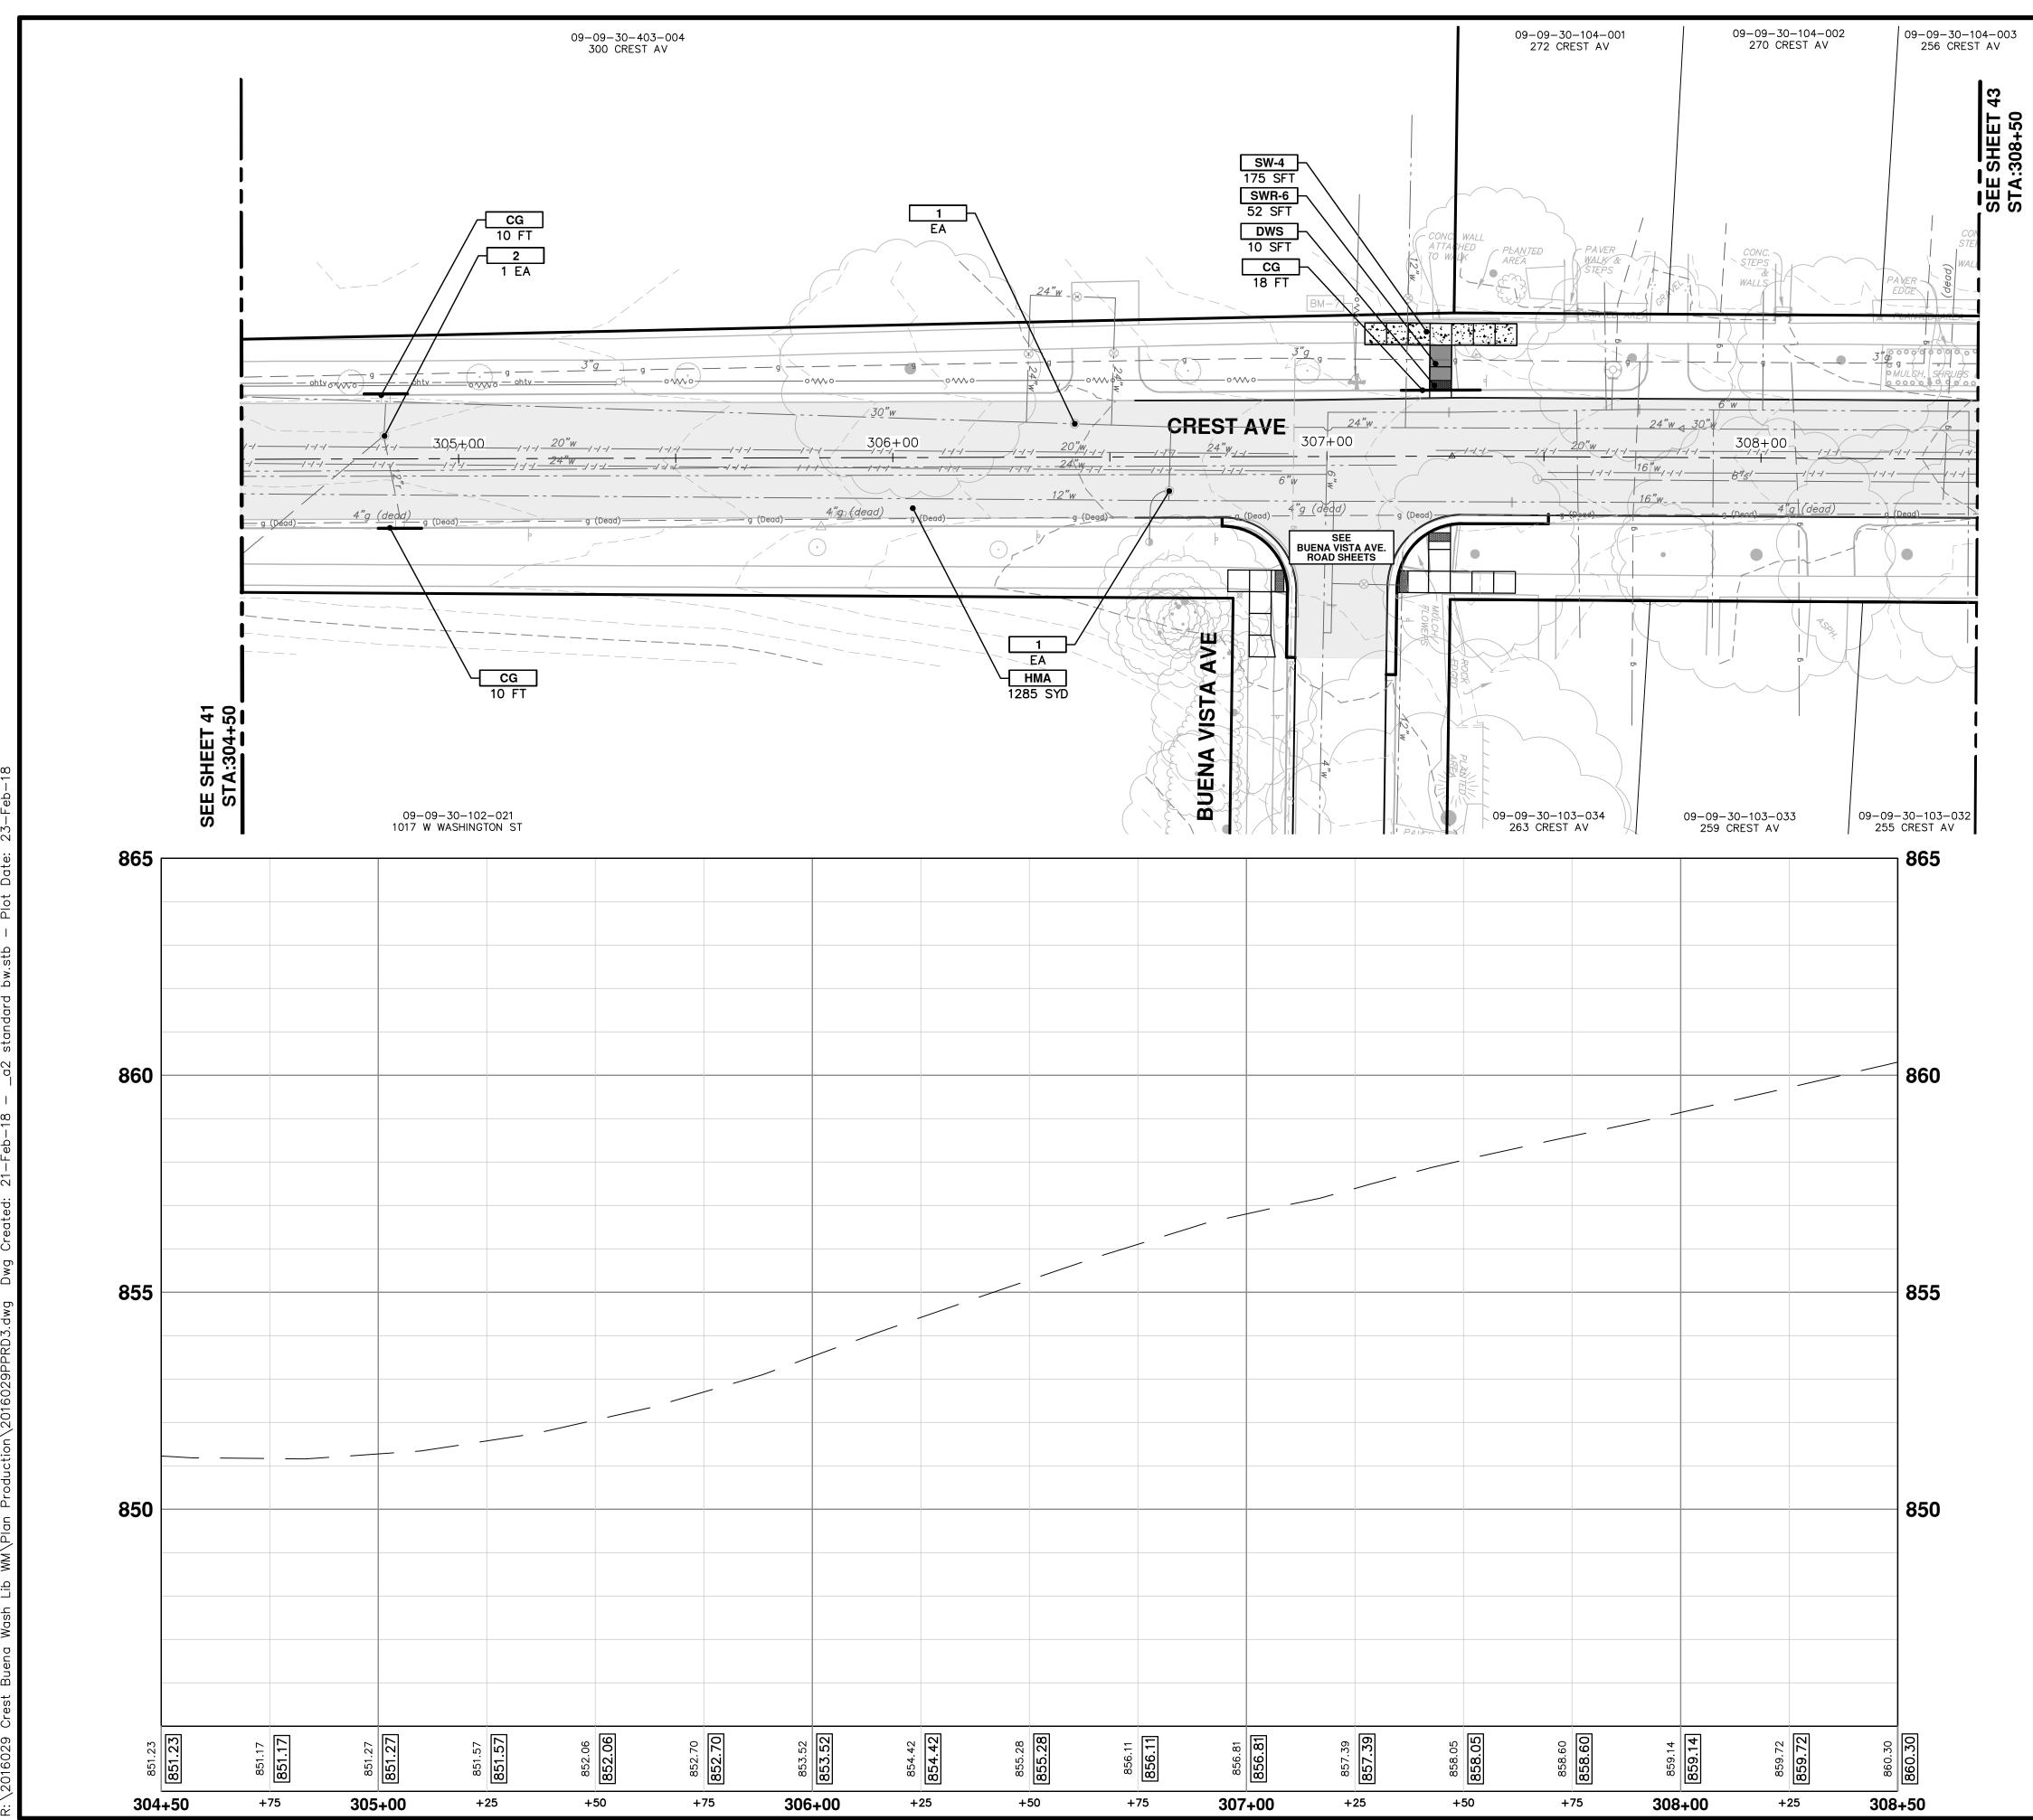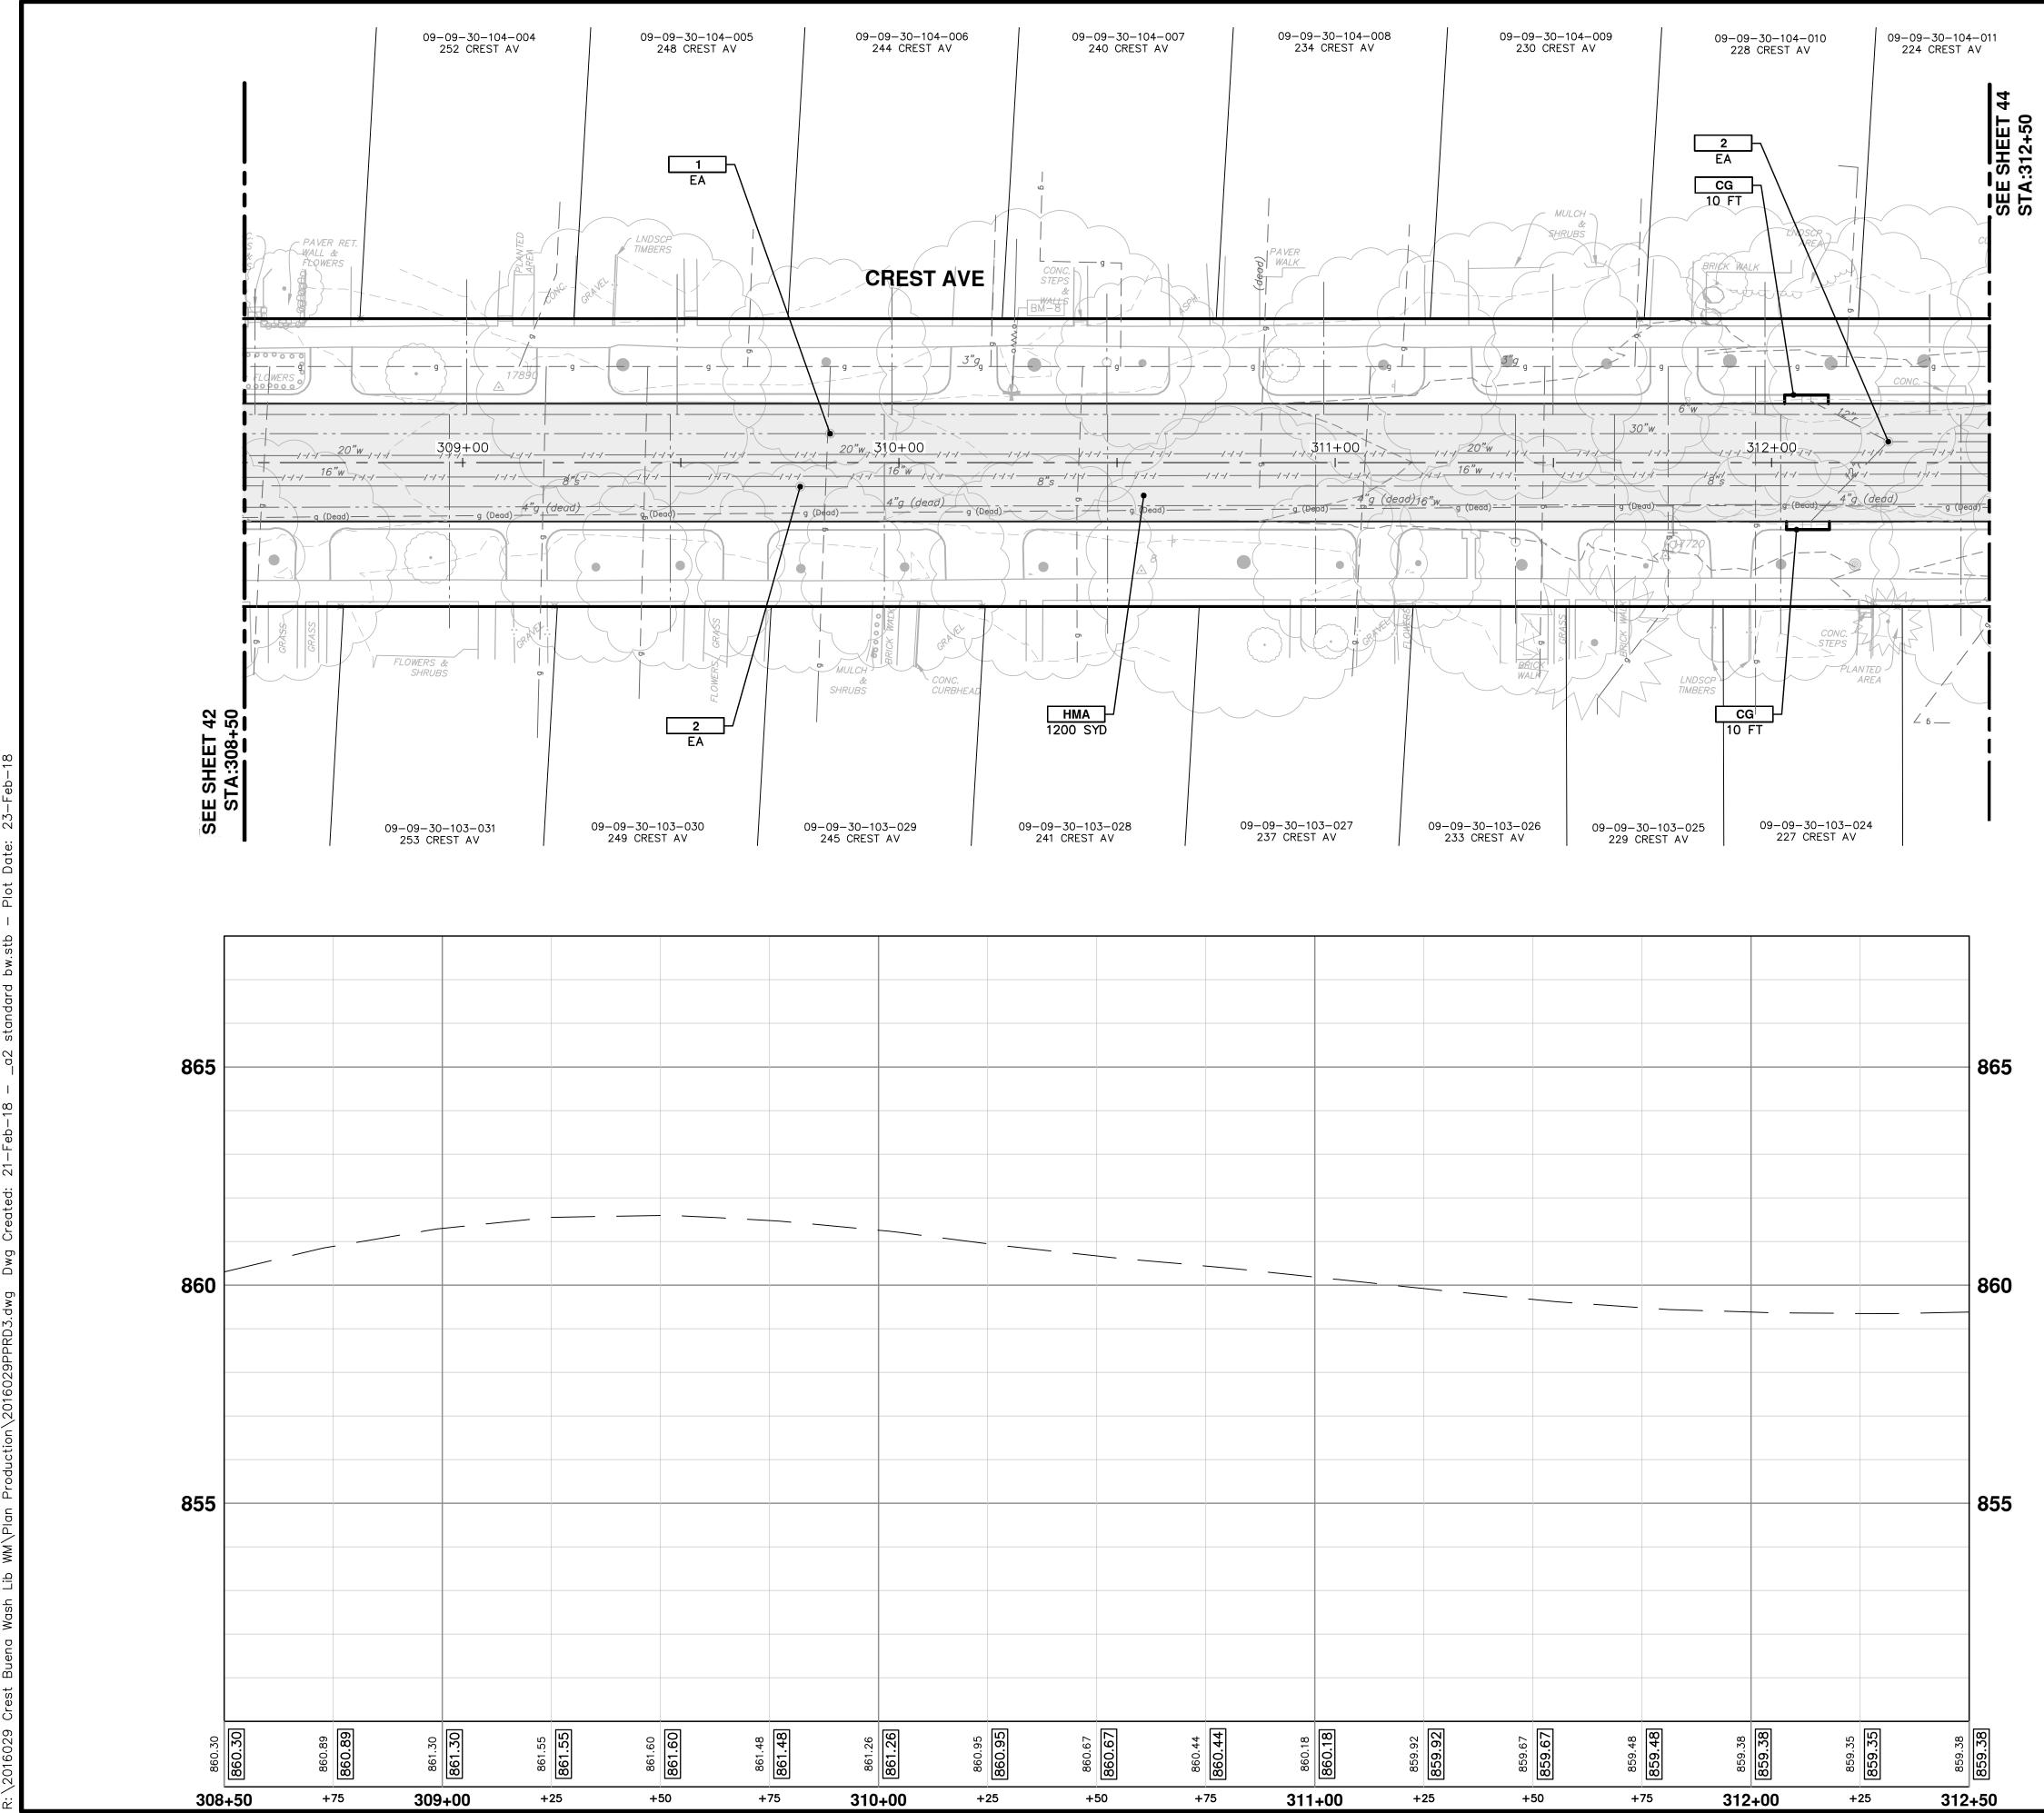

CITY OF ANN ARBOR	ARBOR - PUBLIC SERVICES - ENGINEERING	ANN						
			ao					
PROFILE: 1" = 2'		PIIRIC SERVICES						
	CREST RIJENA VISTA WASHINGTON WATER MAIN	EV 201 EAST HURON STREET	ET					
		U C C C C C C C C C C C C C C C C C C C		01 ADDENDUM #1	2-23-18	CEC/DPF	- JKA	
	CDECT AVE DOAD BLAN AND DDOELLE	734-794-6410		ON DUT FOR BID	2-6-18	CEC /DPF	- JKA	Know what's below.
		WWW.4290V.019	2					Call before vou dia.
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CC	<b>INSTRUCTION KEY</b>		
KEY	DESCRIPTION		
НМА	PLACE HMA, LVSP. PLACE MATERIAL IN LIFTS ACCORDING TO THE TYPICAL SECTION AND AS DIRECTED BY THE ENGINEER.		
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SW-4	PLACE SIDEWALK, CONC, 4 INCH, MODIFIED		
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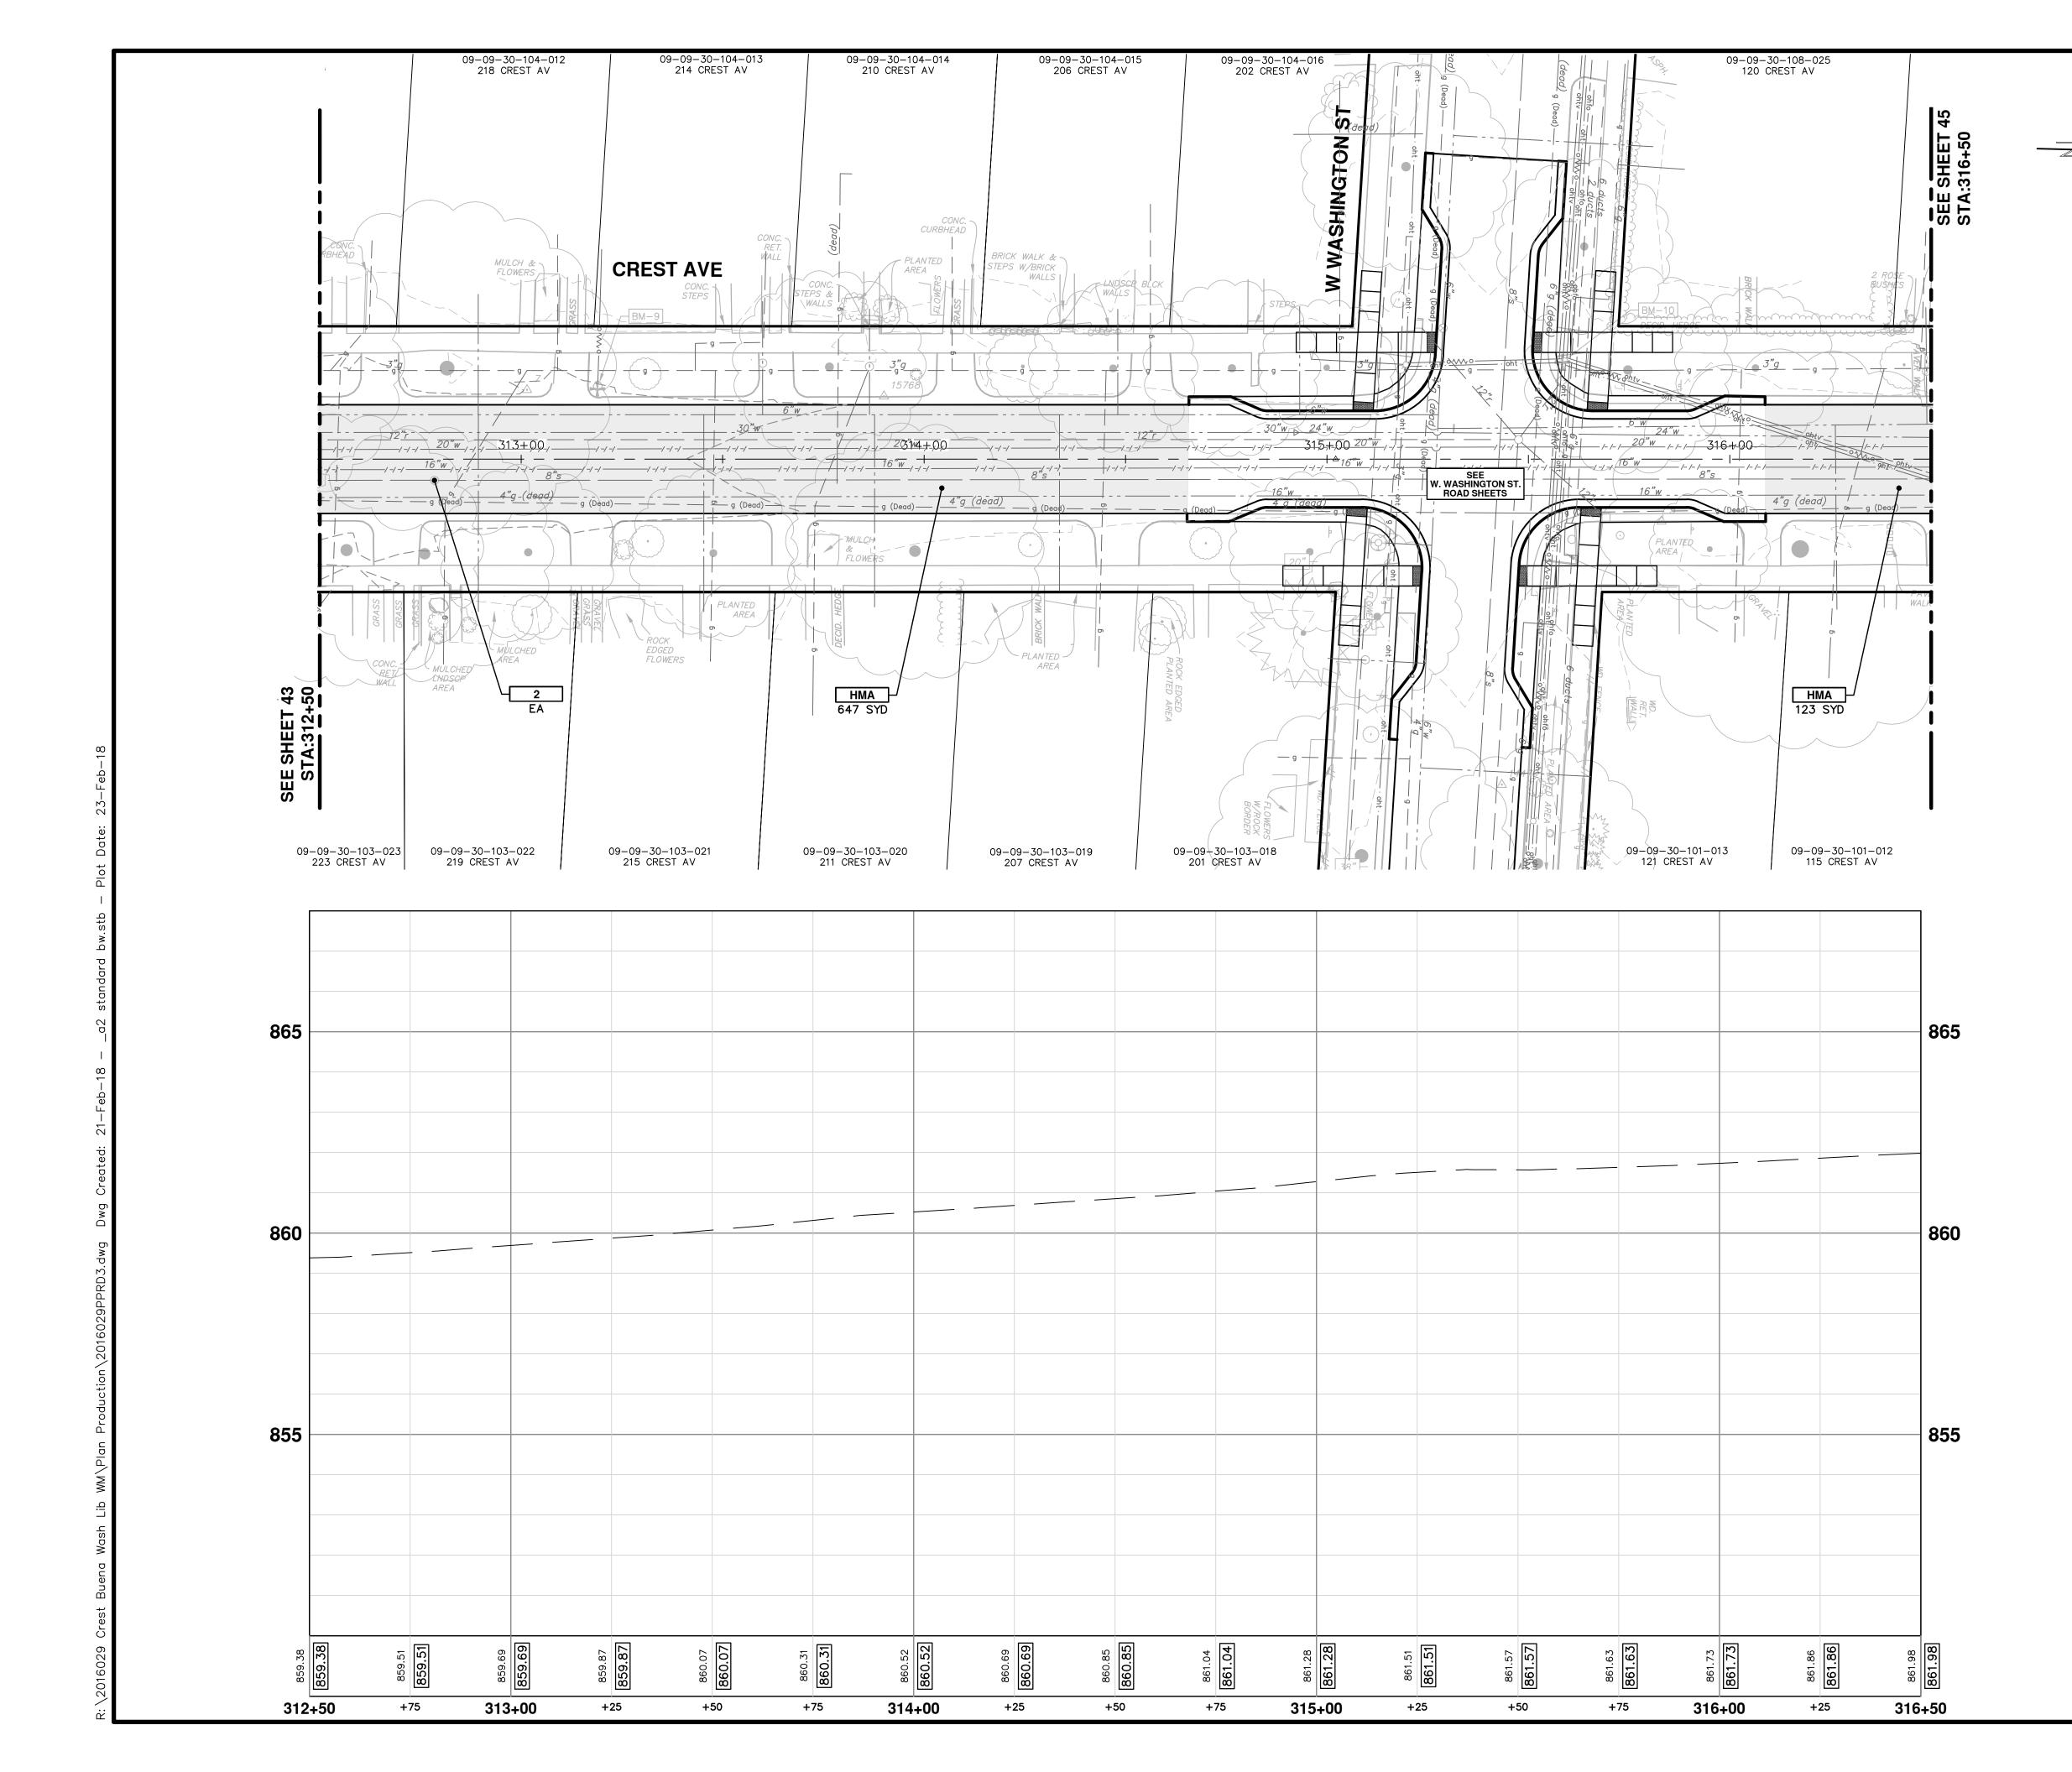
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<b>ARBOR</b> -	ARBOR - PUBLIC SERVICES - ENGINEERING	ANN						
PROFILE: 1" = 2'								
	CREST RIJENA VISTA WASHINGTON WATER MAIN	1/2/ 10/201 EAST HURON STREET						
		D. BOX 8647 ANN ARBOR, MI 48107-8647	6	01 ADDENDUM #1	2-23-18	CEC/DPF	- JKA	
	CREST AVE, ROAD PI AN AND PROFILE	734-794-6410 WWW.a2gov.org	8	00 OUT FOR BID	2-6-18	CEC/DPF	- JKA	Know what's below
	STA. 308+50 TO STA. 312+50	CHIGN	REV.	DESCRIPTION	DATE	DRAWN	DRAWN CHECKED	Call before you dig.


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CITY OF ANN ARBOR PUBLIC SERVICES 301 FAST HIJRON STRFET
P.O. BOX 8647 ANN ARBOR, MI 48107-8647
734-794-6410 www.a2gov.org

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<b>CITY OF ANN ARBOR -</b>	ARBOR - PUBLIC SERVICES - ENGINEERING	E ANN						8
PROFILE: 1" = 2'		PUBLIC SERVICES						
	CREST. BUENA VISTA. WASHINGTON WATER MAIN	E 301 EAST HURON STREET						
		C 20 8647 ANN ARBOR, MI 48107-8647	01	01 ADDENDUM #1	2-23-18	CEC/DPF	JKA	
	CREST AVE ROAD PLAN AND PROFILE	734-794-6410 WWW 2200V orth	00	00 OUT FOR BID	2-6-18	CEC/DPF	ЛКА	Know what's below.
	STA. 316+50 TO STA. 319+11	M/CHIGA	REV.	DESCRIPTION	DATE	DRAWN CHECKED	CHECKED	Call before you dig.
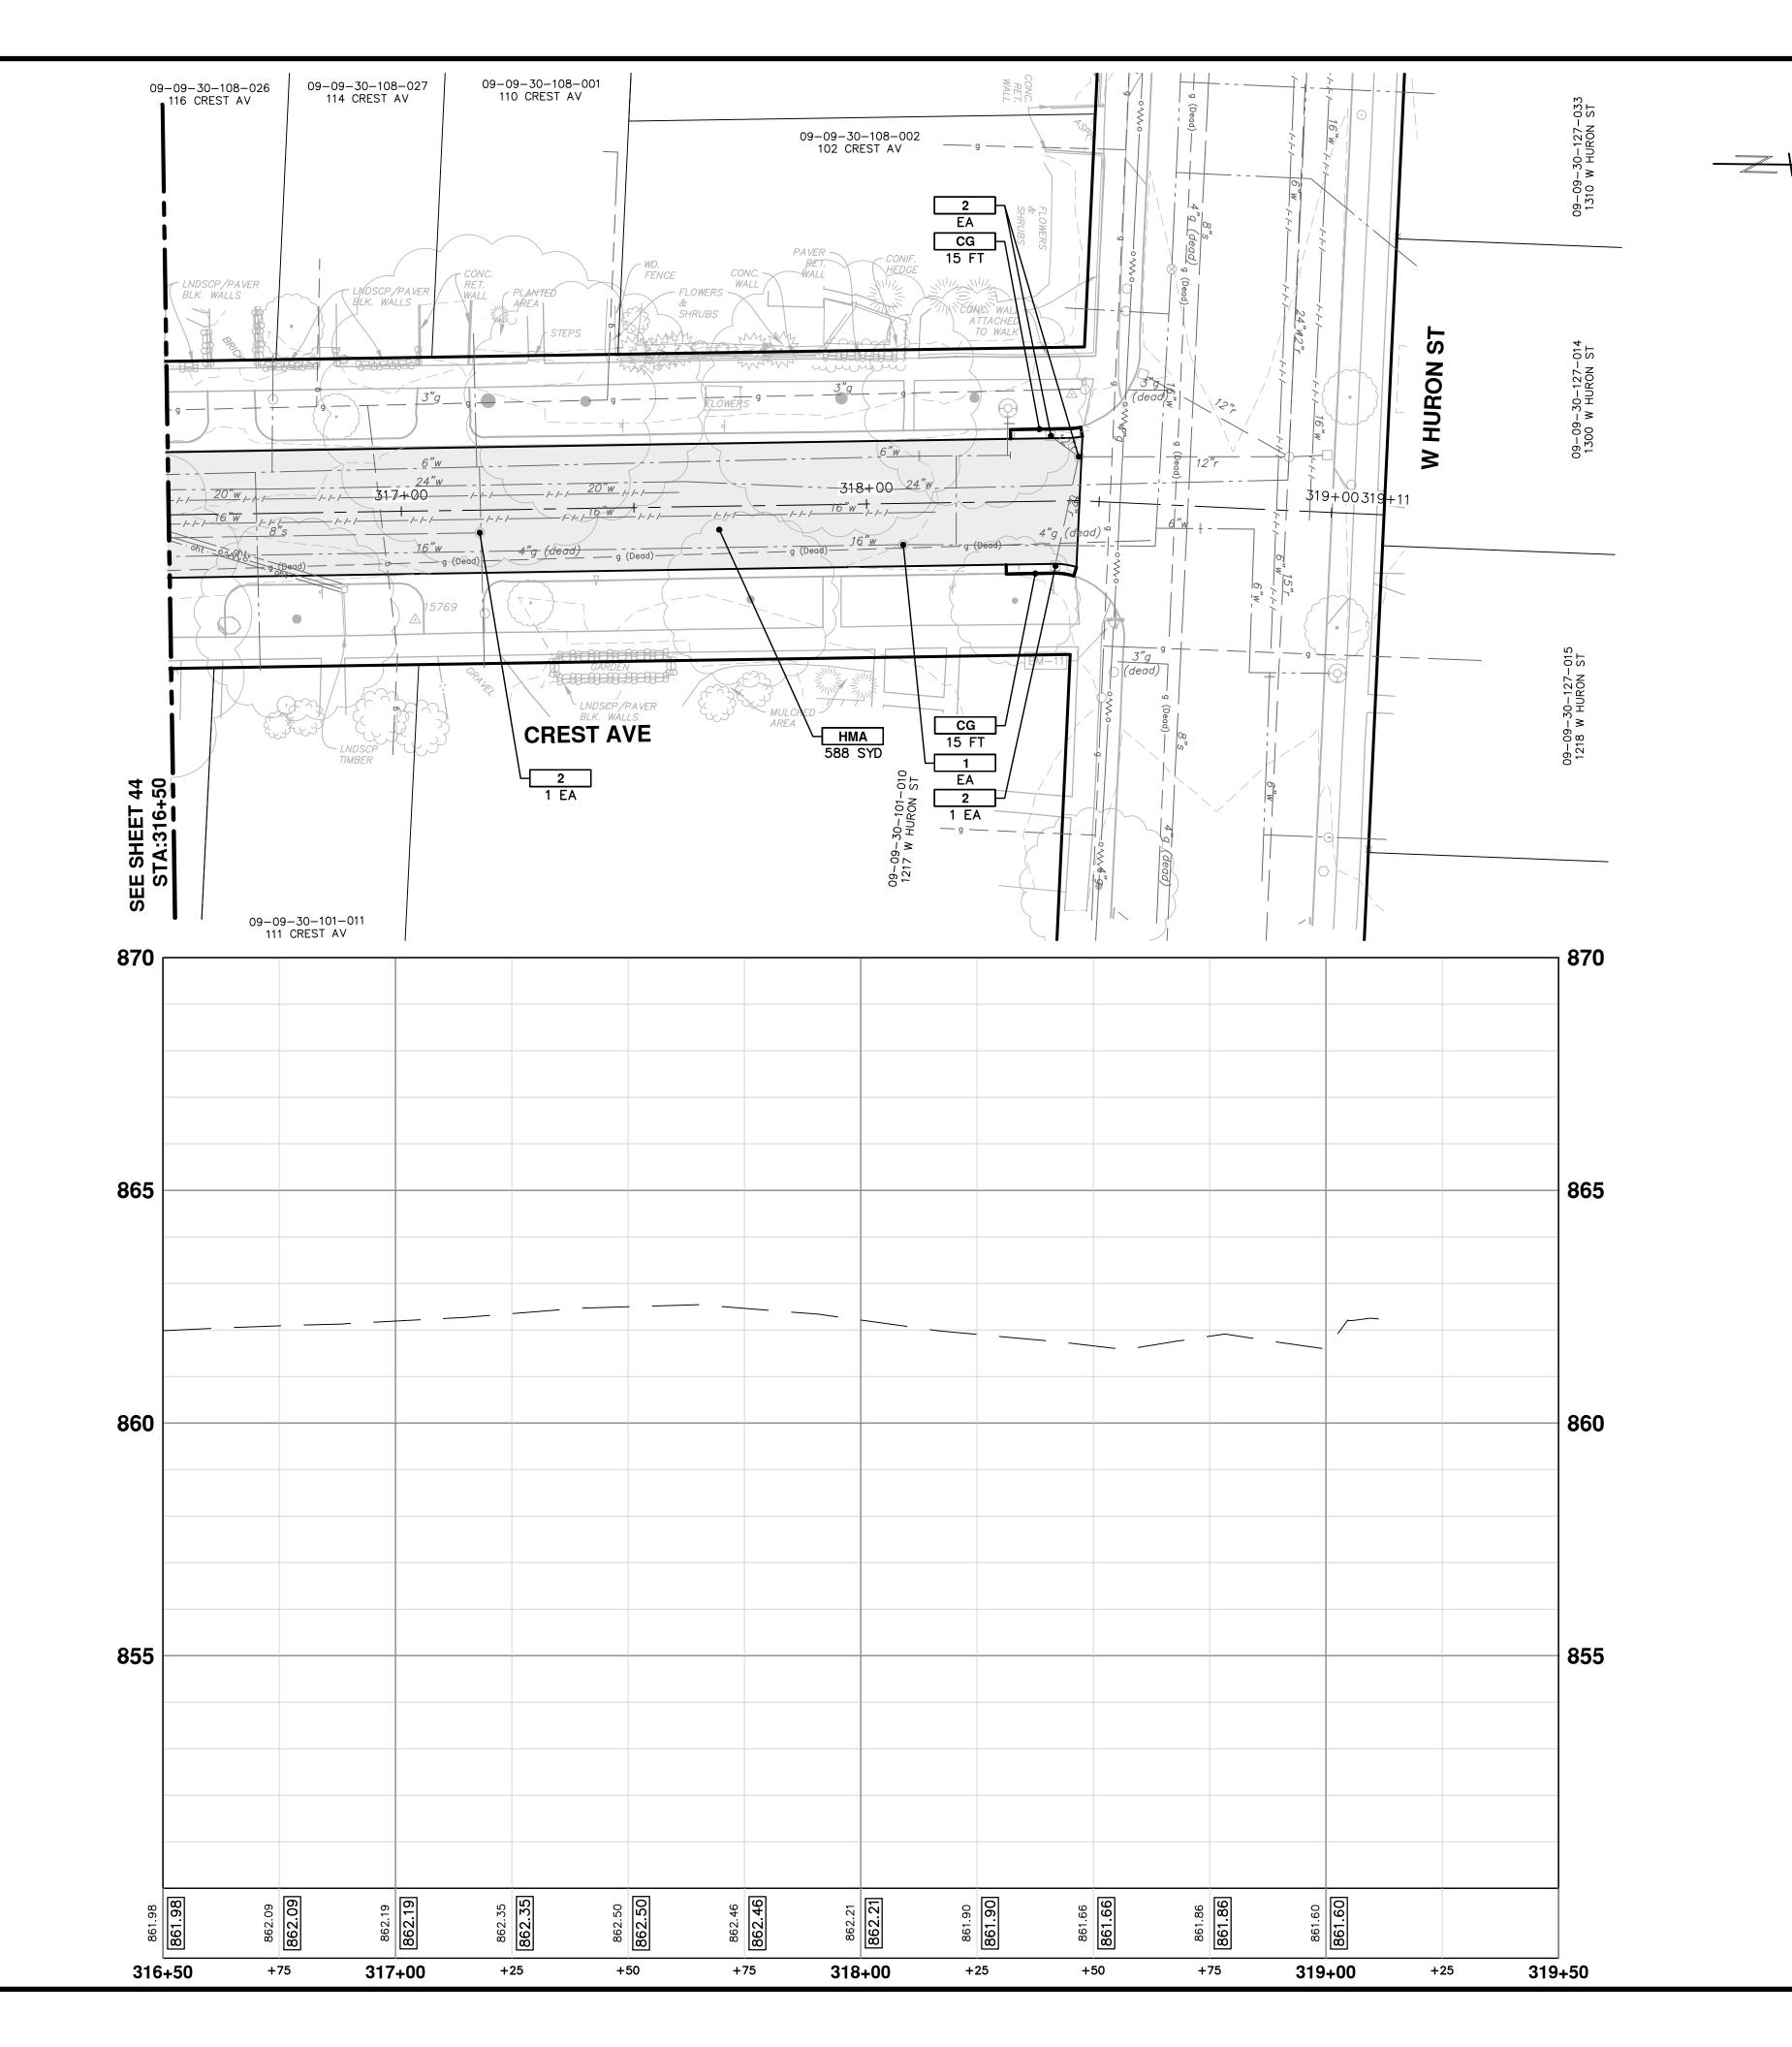
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