

CITY OF ANN ARBOR PROJECT MANAGEMENT

PUBLIC ACT 174 OF 2013, THE CONTRACTOR SHALL CALL 811 OR


ELECTRICAL POWER, CABLE TV AND FIBER OPTIC LINES ARE


STANDARD SPECIFICATIONS, IT'S DETAILS, WHICH ARE INCLUDED BY REFERENCE, AND THIS PROJECT'S CONTRACT DOCUMENTS. THE OMISSION OF ANY CURRENT STANDARD DETAIL DOES NOT RELIEVE THE CONTRACTOR

WEST LIBERTY STREET RECONSTRUCTION S. FIRST ST. - N. MAIN ST.

BID No. ITB# 4496, FILE No. 2015034

	SHEET LIST TABLE
SHEET NUMBER	SHEET TITLE
1	COVER SHEET
2	LEGEND & NOTES
3	SESC NOTES AND DETAILS
4 - 7	TYPICAL PROPOSED ROAD SECTION
8 - 10	STORMWATER TREE TRENCH DETAIL
11	STORM SEWER AND TRENCH DETAILS
12	WATER MAIN DETAILS
13	TRAFFIC CONTROL, STREET LIGHT AND ELECTRICAL DETAILS
14 - 15	DDA DETAILS
16 - 19	ALTERNATE PEDESTRIAN ROUTE DETAILS
20 - 21	CONSTRUCTION PHASING
22	OVERALL DETOUR PLAN - PHASE I
23	S. MAIN ST. DETOUR PLAN - PHASE I
24	OVERALL DETOUR PLAN - PHASE II
25 - 28	MAINTENANCE OF TRAFFIC - PHASE I
29 - 30	MAINTENANCE OF TRAFFIC - PHASE II
31 - 32	REMOVALS
33 - 38	STORM SEWER PLAN & PROFILE
39 - 43	WATER MAIN PLAN & PROFILE
44 - 46	ROAD PLANS
47 - 49	ROAD PROFILES
50 - 52	INTERSECTION GRADES
53 - 56	TRAFFIC SIGNAL AND STREET LIGHTING
57 - 58	TREE PLANTING
59 - 60	PAVEMENT MARKINGS
61 - 63	PERMANENT SIGNAGE (DONE BY OTHERS)

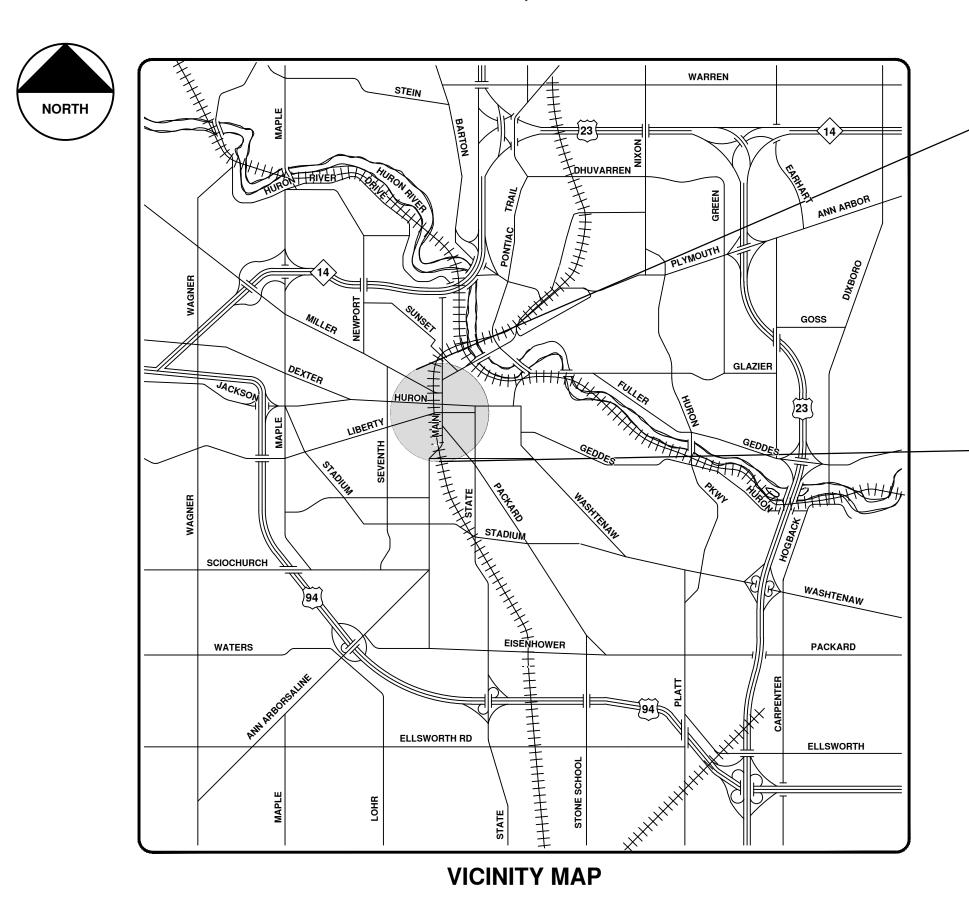

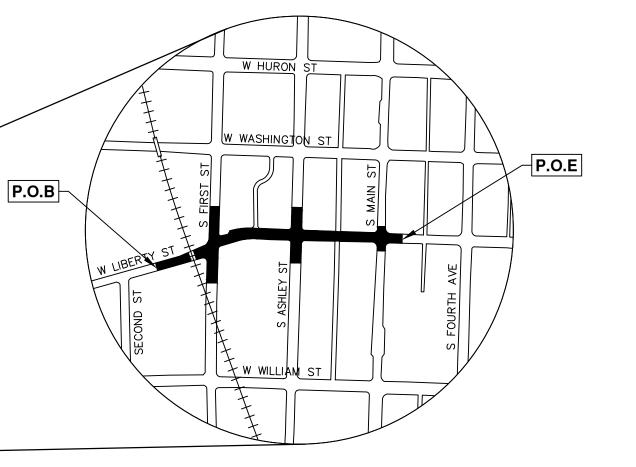

PROJECT MANAGEMENT SERVICE UNIT PREPARED UNDER THE SUPERVISION OF JENNIFER A. NELSON, P.E. - MI LICENSE No. 48125 / /2017

CONSTRUCTION NOTES:

- Driveways and entrances to buildings, real property, and the like shall not be blocked except for short durations and only when approved by the Engineer. Vehicular and pedestrian access shall be maintained at all times. It shall be the Contractor's responsibility to coordinate all necessary driveway closures with the property owner(s) and resident(s) in the areas of construction.
- . The location and depth of all existing utilities and service leads are to be field verified by the Contractor prior to construction.
- . Location and depth of utilities as depicted on the plans is approximate and shown according to the best information available. It is the Contractor's responsibility to excavate ahead and adjust depth of conflict utilities accordingly. Any damage to utilities is the Contractor's responsibility to avoid and/or repair as necessary.
- . The Contractor is to take special care to protect the existing water main and be responsible for maintaining consistent water service.
- . During non-working hours no trench shall remain open; any open trench shall be properly secured with protective fencing. This work shall be included in the item of work "General Conditions".
- 6. Trenches for new water services shall be excavated to MIOSHA and City of Ann Arbor Field Services requirements.
- City of Ann Arbor Field Services will install the corporation and copper service lead(s) to transfer the connection(s). If an existing water service is found to be failing or is not copper, the lead will be replaced to the curb box by Field Services.
- For the installation of corporations, or any other related activities, the Contractor shall not receive additional compensation for delays due to the scheduling of or coordination with the City of Ann Arbor Field Services.
- The Contractor shall backfill trenches in accordance with Trench Detail specified on plans. This work shall be included in the item of work "Excavate and Backfill for Water Service Tap and Lead". All concrete removals and replacements required for this work will be paid for separately.

- 10. All ductile iron pipe and fittings shall be polyethylene wrapped per ANSI/AWWA C105/A21.5.
- 11. Cor-blue bolts to be used at all mechanical water main joints at hydrants and Megalug fittings
- 12. The Contractor shall construct, flush, and bacteriologically test the water main per Detailed Specification "Water Main Installation and Testina" and as approved by the Engineer. All chlorinated water shall be discharged directly into an approved sanitary sewer. The Contractor shall supply all necessary hoses, fittings and the like to accomplish this work.
- 13. Water main fittings, other than those specifically listed as separate pay items, which are required to complete the work, such as blow-off assemblies, concrete thrust blocks, solid sleeves and mechanical plugs, shall not be paid for separately, but shall be included in the pipe pay items.
- 14. "No Parking" signs shall be installed by the Contractor at locations as approved or directed by the Engineer. All signs shall be installed in accordance with the detailed specifications.
- 15. Postal delivery and refuse pickup service shall be maintained at all times by the Contractor.
- 16. All fittings, hydrants, valves and castings removed during construction are the property of the City of Ann Arbor. The Contractor within 48 hours shall deliver to City of Ann Arbor Field Operations and Maintenance Facility at the W.R. Wheeler Service Center located at 4251 Stone School Road.
- 17. Where street curbs are undermined due to construction activities, they shall be removed and replaced as directed by the Engineer.
- 18. The Contractor shall be responsible for the continuous maintenance of the temporary road surface and soil erosion control measures within the construction area until the full completion of the project. This work shall be included in the item of work "General Conditions".
- 19. All curb, sidewalk, driveway approach removals shall be approved by Engineer before the work is done.
- 20. Sawed sewer pipe connections shall be coupled with a Fernco flexible coupling and a stainless steel

21. The location of material stock piles and on-site staging areas to be approved by the Engineer.

- 22. For mainline paving, the width of the mat for each pass of the paver shall be not less than 10.5' or greater than 15', as directed by the Engineer. The Engineer will direct the layout of the longitudinal joints during construction.
- 23. All structures shall receive new castings as directed by the Engineer, as specified on the standard casting schedule. The existing castings are the property of the City of Ann Arbor. The Contractor shall deliver to City of Ann Arbor Field Operations and Maintenance Facility at the W.R. Wheeler Service Center located at 4251 Stone School Road.
- 24. Payment for drainage structure sumps, where specified, shall be included in the payment for the various drainage structure sizes and or types.
- 25. Where sewer pipes of different sizes or materials are joined, Fernco flexible couplings with stainless steel shear rings shall be used. The Contractor's purchase price for these devices, including shipping, shall be paid as an extra. Prior to payment for this item, the Contractor shall submit receipts for the Engineer's review and approval. All other costs associated with the installation of these devices shall be included in the payment for the sewer.
- 26. Where sewer and water main are to be removed & replaced or added, all pipe shall be installed using the trench detail detailed in the specifications or shown on Plans. Backfill for sewer and water construction shall be MDOT Granular Material. Class
- 27. Existing street name, guide, and regulatory signs, and mailboxes which conflict with the proposed construction shall be removed prior to construction, stored in a manner which will prevent damage, and re—set in locations as directed by the Engineer. This work will not be paid for separately, but shall be included in "Machine Grading, Modified"
- 28. In areas where edge drain cannot be installed in accordance with City of Ann Arbor Detail SD-TD-11, the edge drain shall be installed at the depth as indicated on the plans, or as directed by Engineer. In no case shall the edge drain be installed at a grade less than 0.50% or at a depth of less than 2' below top of proposed pavement.

EXISTING LEGEND ♦+ FIRE HYDRANT I GATE VALVE IN BOX ⊗ GATE VALVE IN WELL STOP BOX W WATER VAULT **₩** WELL ☐ CATCH BASIN (SQ) ⊕ CATCH BASIN (RD) O STORM MANHOLE ☐ NON-CURB CATCH BASIN (SQ)) END SECTION O SANITARY MANHOLE O CLEAN-OUT POST ₱ PEDESTRIAN SIGNAL

▶ SIGN ☐ HAND HOLE ORNAMENTAL LIGHT

① UNKNOWN MANHOLE TELEPHONE MANHOLE TELEPHONE RISER

O GAS VENT ⊞ GAS BOX ⊠ ELECTRICAL RISER

Ø UTILITY POLE

O LAMP POLE □ GUY ANCHOR Q GUY POLE

MONITORING WELL **■** MAILBOX

> SOIL BORING

+ BENCH MARK

• IRON PIPE ■ MON BOX


		PI	ROPOSED LEGEND		
	WATER MAIN	+ +	HYDRANT (PLAN)	w	WATER MAIN
/-/-/	WATER MAIN ABANDONED	8	WATER GATE WELL		STORM SEWER
	STORM SEWER	•	REDUCER	s	SANITARY SEWER
//	STORM SEWER ABANDONED	1	WATER GATE VALVE	——F0—	FIBER OPTIC
<i>S</i>	SANITARY SEWER	(1)	WATER STOP BOX	——Е	ELECTRICAL
//	SANITARY SEWER ABANDONED	W	WATER VAULT		CENTERLINE OF DITCH
g	GAS MAIN	•	INLET		CENTERLINE OF ROAD
— g (DEAD)—— —— —— ——	GAS MAIN (DEAD)		DOUBLE INLET	////	FENCE
o\\\\o	ELECTRICAL OVER HEAD	•	INLET JUNCTION CHAMBER	::	GRAVEL
	ELECTRICAL UNDER GROUND		ROUND CATCH BASIN		SILT FENCE
e duct bank	ELECTRICAL DUCT BANK		STORM MANHOLE		PROTECTIVE FENCE
— · oht · ———	TELEPHONE OVER HEAD	•	DRAIN ARROW	. • • • • • • • •	GUARDRAIL
	TELEPHONE UNDER GROUND		FLARED END SECTION		LOT/UNIT
t duct bank	TELEPHONE DUCT BANK		SANITARY MANHOLE		CURB
		©	CLEAN-OUT		TEMPORARY GRADING PERMIT
——————————————————————————————————————	CABLE TV OVER HEAD	•	BARREL	 800	CONTOUR MAJOR
	CABLE TV UNDER GROUND	•	SIGN	 799 	CONTOUR MINOR
fo <u>fo_duct_bank</u>	FIBER OPTIC		PUSH BUTTON		WATER EASMENT
	FIBER OPTIC DUCT BANK		HAND HOLE		STORM EASEMENT
	BOUNDARY				SANITARY EASEMENT
	BUILDING				R.O.W.
	CENTERLINE OF DITCH				LIMITS OF CONSTRUCTION
	CENTERLINE/CROWN OF ROAD				LIMIT OF GRADING
	CONTOUR MAJOR			احراحراحراحراحراحراحراحراحراحراحراحراحرا	STONE WALL
799	CONTOUR MINOR			00000000000000000000000000000000000000	DETECT D. E. W. D. W. O.
	EDGE OF WATER			00000000000000000000000000000000000000	DETECTABLE WARNING
////	FLOODPLAIN FENCE				ASPHALT
—:·——:·—	GRAVEL				
· · · · · · · · · · · · · · · · · · ·	GUARDRAIL				CONCRETE
·	STONE WALL			- 4 J . J 4 4	
	R.O.W.				SIDEWALK
	TREELINE				
	WETLAND				
	EDGE OF BRUSH				TREE (DECIDUOUS)
	EDGL OF BINDSH				
	HEDGE			. ^	
				ZVVZ	
				\$ • \$	TREE (CONIFEROUS)
	TREE (DECIDUOUS)			21.15	
5				W ³	


PERMIT	ISSUING A	AUTHORITY
LANE CLOSURE PERMIT*	CITY OF ANN ARBOR PROJECT MANAGEMENT	UNIT
"NO PARKING" SIGNS PERMIT*	CITY OF ANN ARBOR PROJECT MANAGEMENT	UNIT
GRADING/SOIL EROSION & SEDIMENT CONTROL PERMIT*	NTATION CITY OF ANN ARBOR CUSTOMER SERVICE	
RIGHT-OF-WAY PERMIT*	CITY OF ANN ARBOR CUSTOMER SERVICE	
*	NO COST TO CONTRACTOR	
	O BE OBTAINED BY THE BEGINNING OF CONSTI	
PERMIT	ISSUING A	AUTHORITY
M.D.E.Q. WATER MAIN CONSTRUCTION PERMIT	ON MICHIGAN DEPARTMENTENVIRONMENTAL QUALI	
M.D.E.Q. SANITARY SEWER CONSTR PERMIT	MICHIGAN DEPARTMENT ENVIRONMENTAL QUALI	
CONTACT INFORMATION	ON	
PUBLIC UTILITIES	OWNER	CONTACT

PERMITS REQUIRED TO BE OBTAINED BY THE CONTRACTOR

PRIOR TO THE BEGINNING OF CONSTRUCTION.


WATER		
SANITARY		
STORM	CITY OF ANN ARBOR PUBLIC WORKS W.R. WHEELER SERVICE CENTER	(734) 794–6350
FORESTRY	4251 STONE SCHOOL ROAD ANN ARBOR, MI 48108	
SIGNS SIGNALS STREET LIGHTS		(734) 794–6361
PRIVATE UTILITIES	OWNER	CONTACT
GAS	DTE ENERGY 3150 E. MICHIGAN AVE, YPSILANTI TOWNSHIP, MI 48198	ROBERT CZAPIEWSKI (734) 544–7818
ELECTRIC	DTE ENERGY WESTERN WAYNE SERVICE CENTER 8001 HAGGERTY ROAD BELLEVILLE, MI 48111	CLAY COMBEE (734) 397-4112
CABLE	COMCAST 27800 FRANKLIN ROAD SOUTHFIELD, MI 48034	RON SUTHERLAND (313) 999-8300
PHONE	AT&T 550 S. MAPLE ROAD ANN ARBOR, MI 48103	(734) 996–2135
FIBER OPTIC	MCI 2800 N. GLENFILLE ROAD RICHARDSON, TX 75082	DEAN BOYERS (972) 729-6016
FIBER OPTIC	ZAYO BANDWIDTH MIDWEST, LLC 1060 HARDNESS DR. STE H ABERDEEN, MD 21001	GEORGE HUSS (443) 403-2023

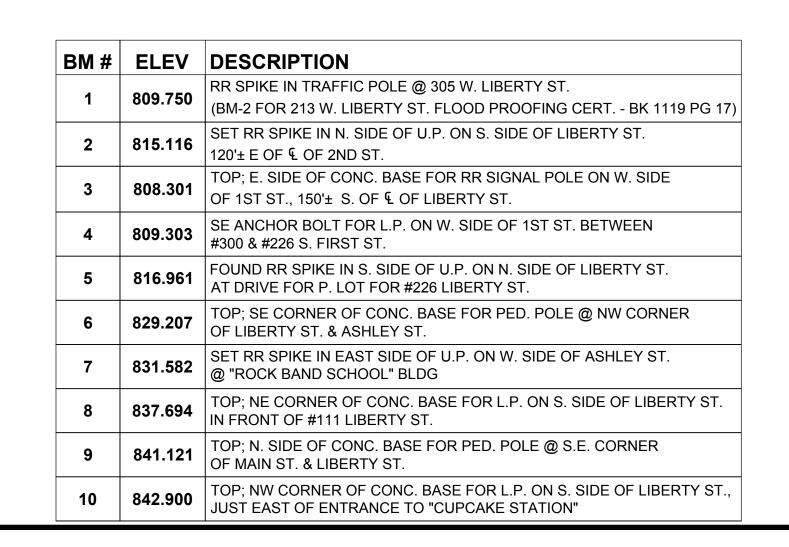

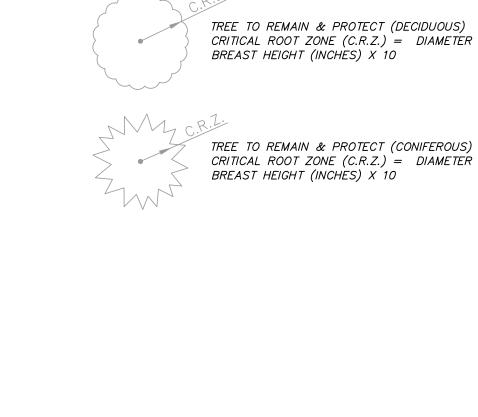

TREE (CONIFEROUS)

SHRUB (DECIDUOUS)

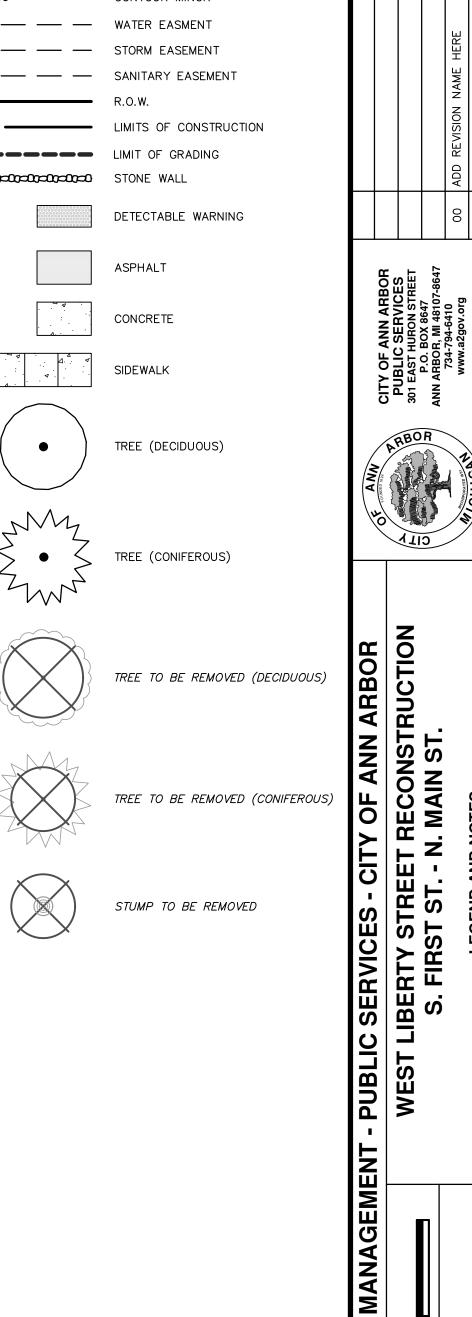

SHEET No.

NOTIFY THE CITY OF ANN ARBOR SOIL EROSION CONTROL OFFICE 48 HOURS PRIOR TO BEGINNING WORK ON THE PROJECT. PHONE: 734-794-6265.

- 1. THE CONTRACTOR SHALL IMPLEMENT AND MAINTAIN THE SOIL EROSION CONTROL MEASURES AS SHOWN ON THE PLANS AND AS DIRECTED BY THE ENGINEER AT ALL TIMES DURING CONSTRUCTION. ANY MODIFICATIONS OR ADDITIONS TO THE SOIL EROSION CONTROL MEASURES DUE TO CONSTRUCTION OR CHANGED CONDITIONS SHALL BE AS DIRECTED AND APPROVED BY THE ENGINEER.
- 2. ALL SOIL EROSION AND SEDIMENTATION CONTROL WORK SHALL CONFORM TO THE PERMIT REQUIREMENTS OF THE CITY OF ANN ARBOR, CITY ORDINANCE CHAPTER 63, CITY OF ANN ARBOR STANDARDS DIVISION VII, THE LAWS OF THE STATE OF MICHIGAN, AND THE REQUIREMENTS OF THE CONTRACT DOCUMENTS.
- 3. DAILY, OR AFTER ANY STORM EVENT, INSPECTIONS OF EROSION CONTROL MEASURES SHALL BE MADE BY THE CONTRACTOR. PERIODIC INSPECTIONS MAY BE MADE BY THE ENGINEER TO DETERMINE THE EFFECTIVENESS OF EROSION AND SEDIMENTATION CONTROL MEASURES. ANY NECESSARY CORRECTIONS SHALL BE MADE WITHOUT DELAY, AND WITHOUT ADDITIONAL COST TO THE CITY OF ANN ARBOR.
- 4. EROSION AND SEDIMENTATION FROM WORK ON THE SITE SHALL BE CONTAINED ON THE SITE AND NOT BE ALLOWED TO COLLECT ON ANY OFF-SITE AREAS, ROADWAYS OR WATERWAYS.
- 5. ALL MUD/SOIL TRACKED ONTO ROADWAYS FROM THE SITE DUE TO CONSTRUCTION, SHALL BE PROMPTLY REMOVED BY THE CONTRACTOR. IF SO ORDERED, THE CONTRACTOR SHALL PROVIDE AND OPERATE A VACUUM-TYPE STREET SWEEPER, AT NO ADDITIONAL COST TO THE CITY OF ANN ARBOR, WITHIN FOUR (4) HOURS OF BEING SO ORDERED.
- 6. RESTORATION OF ALL DISTURBED AREAS, INCLUDING PLACEMENT OF TOPSOIL, SEED, FERTILIZER AND MULCH AND/OR SOD SHALL BE PERFORMED WITHIN FIVE (5) DAYS OF THE COMPLETION OF FINAL GRADE.
- 7. CONSTRUCTION OPERATIONS SHALL BE SCHEDULED AND PERFORMED SO THAT PREVENTATIVE SOIL EROSION CONTROL MEASURES ARE IN PLACE PRIOR TO

- EXCAVATION IN CRITICAL AREAS AND TEMPORARY STABILIZATION MEASURES ARE IN PLACE IMMEDIATELY FOLLOWING BACKFILLING OPERATIONS.
- 8. SPECIAL PRECAUTIONS WILL BE TAKEN IN THE USE OF CONSTRUCTION EQUIPMENT TO PREVENT SITUATIONS THAT PROMOTE EROSION.
- 9. PROPER DUST CONTROL SHALL BE MAINTAINED DURING CONSTRUCTION BY USE OF WATER TRUCKS AND/OR DUST PALLATIVE AS REQUIRED.
- 10. THE CONTRACTOR SHALL BE RESPONSIBLE FOR MAINTAINING ALL TEMPORARY SOIL EROSION CONTROL MEASURES AND REMOVAL OF SOME MEASURES UPON AUTHORIZED COMPLETION OF THE PROJECT. FINAL COMPLETION OF PROJECT WILL NOT BE AUTHORIZED UNTIL ALL SITE WORK AND UTILITY CONSTRUCTION IS COMPLETE AND ALL SOILS ARE STABILIZED.
- 11. THE CONTRACTOR SHALL NOT GRADE INTO ADJACENT PROPERTIES. SILT AND PROTECTIVE FENCE SHALL BE INSTALLED AND MAINTAINED TO PREVENT GRADING, EROSION AND SEDIMENTATION INTO THE ADJACENT PROPERTIES.
- 12. TREE PROTECTION FENCING MUST REMAIN INTACT UNTIL RESTORATION OF THE

SEQUENCE OF EROSION CONTROL MEASURES:

SITE IS COMPLETE.

1. THE CONTRACTOR IS TO SUBMIT TO THE ENGINEER, A SEQUENCE OF CONSTRUCTION WITH RESPECT TO THE SOIL EROSION CONTROL MEASURES FOR REVIEW, COMMENT AND APPROVAL. THIS SCHEDULE IS TO INCLUDE INSPECTION AND REPAIR OF ALL TEMPORARY EROSION CONTROL MEASURES DAILY AND WITHIN 24 HOURS OF A STORM EVENT.

SAMPLE SOIL EROSION AND SEDIMENTATION CONTROL INSTALLATION MINIMUM

- **REQUIREMENTS:** 1.1. INSTALL SILT FENCE, TREE PROTECTION FENCING, MUD MATS, INLET FILTERS ON EXISTING DRAINAGE FEATURES. AND ALL OTHER TEMPORARY SOIL EROSION CONTROLS, PRIOR TO ANY CLEARING OR EARTH MOVING OPERATION.
- 1.2. STRIP AND STOCKPILE TOPSOIL. STABILIZE STOCKPILE AS REQUIRED.

- INSTALL WATER MAINS, STORM AND SANITARY SEWERS, AND OTHER ENCLOSED DRAINAGE FEATURES. NEW INLET FILTERS SHALL BE INSTALLED IMMEDIATELY FOLLOWING INSTALLATION OF NEW DRAINAGE INLETS.
- 1.4. PERFORM MACHINE GRADING OPERATIONS AND CONSTRUCT PAVEMENTS (MAINLINE, SIDEWALKS, DRIVES, ETC.).
- 1.5. COMPLETE WORK OPERATIONS IN ACCORDANCE WITH CONSTRUCTION SEQUENCE CONTAINED WITHIN THE SPECIAL PROVISION ENTITLED "MAINTAINING TRAFFIC AND CONSTRUCTION METHOD AND SEQUENCING" CONTAINED IN THE CONTRACT PROPOSAL.
- CONTINUALLY MAINTAIN EROSION AND SEDIMENTATION CONTROL MEASURES, AS REQUIRED TO ALLOW DRAINAGE AND SEDIMENT REMOVAL. REMOVE ANY ACCUMULATED SEDIMENT IMMEDIATELY.
- 1.7. COMPLETE ALL BIORETENTION GRADING AND FINE GRADING.
- 1.8. TEMPORARY SEED AND INSTALL EROSION CONTROL BLANKET IN ALL DISTURBED AREAS.
- 1.9. REFER TO LANDSCAPE PLANTING PLANS FOR PERMANENT SITE STABILIZATION.
- 1.10. CLEAN OUT STORM SEWER SYSTEMS.
- 1.11. REMEDY ANY NOTED DEFECTS TO THE SATISFACTION OF THE CITY OF ANN ARBOR'S SOIL EROSION AND SEDIMENTATION CONTROL OFFICIAL.
- 1.12. ALL TEMP. SOIL EROSION CONTROL MEASURES MUST BE REMOVED, WITH ENGINEERS APPROVAL, PRIOR TO FINAL INSPECTION

NOTE: THIS SEQUENCE IS FOR INFORMATION ONLY. IT IS INTENDED TO SHOW THE SEQUENCE OF CONSTRUCTION WITH RESPECT TO THE SOIL EROSION AND SEDIMENTATION CONTROL MEASURES. THE CONTRACTOR IS RESPONSIBLE FOR SUBMITTING THEIR OWN DETAILED CONSTRUCTION SEQUENCE AND SCHEDULE TO THE ENGINEER FOR REVIEW, COMMENT, AND APPROVAL.

TEMPORARY SEEDING:

- SEED IN ACCORDANCE WITH PROJECT DRAWINGS AND SPECIFICATIONS.
- 2. ANY DISTURBED AREA NOT PAVED, SEEDED, MULCHED, SODDED OR BUILT UPON BY NOVEMBER 15TH OR JUNE 30TH IS TO BE TEMPORARILY STABILIZED PER SPECIFICATIONS.


THE ESTIMATED COST OF SOIL EROSION AND SEDIMENTATION CONTROL MEASURES. TOPSOIL, SEEDING, AND MULCH = \$xxx,xxx

ESTIMATE OF EXCAVATION AND FILL FROM EXISTING TO FINAL GRADE:

ON SITE SOILS PER THE USDA SOIL SURVEY OF WASHTENAW COUNTY, MICHIGAN: • FoB - FOX SANDY LOAM, 2% TO 6% SLOPES - IN UPLAND AREAS AND ON OUT WASH PLAINS, KAMES, VALLEY TRAINS, TERRACES, AND MORAINES. SLOPES

- FOB FOX SANDY LOAM, 6% TO 12% SLOPES ON OUT WASH PLAINS, KAMES, VALLEY TRAINS, TERRACES, AND MORAINES. SLOPES ARE UNIFORM OR
- MdA MATHERTON SANDY LOAM IN DEPRESSION AREAS, BROAD LOW-LYING

TOTAL AREA OF PROPOSED DISTURBANCE = 1.54 AC IMPERVIOUS ROAD AREA: 57,634 ft2 - PRE = 1.33 AC47,302 ft2 - POST = 1.08 AC

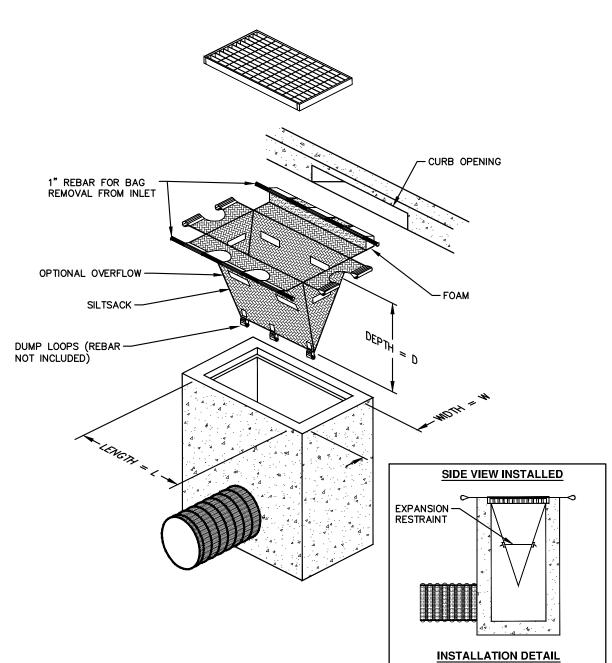

SILTSACK DETAIL

NOTE: THE SILTSACK WILL BE MANUFACTURED FROM A WOVEN POLYPROPYLENE FABRIC THAT MEETS OR EXCEEDS THE FOLLOWING SPECIFICATIONS.

REGULAR FLOW SILTSACK

(FOR AREAS OF LOW TO MODERATE PRECIPITATION AND RUN-OFF)

<u>PROPERTIES</u>	REQUIRED VALUE	TEST METHOD
AB TENSILE STRENGTH AB TENSILE ELONGATION NCTURE LLEN BURST APEZOID TEAR RESISTANCE PARENT OPENING SIZE DW RATE RMITTIVITY	ASTM D-4632 ASTM D-4632 ASTM D-4833 ASTM D-3786 ASTM D-4533 ASTM D-4535 ASTM D-4751 ASTM D-4491 ASTM D-4491	300 LBS 20% 120 LBS 800 PSI 120 LBS 80% 40 US SIEVE 40 GAL/MIN/SQ FT 0.55 SEC -1

HI-FLOW SILTSACK


(FOR AREAS OF MODERATE TO HEAVY PRECIPITATION AND RUN-OFF)

FOR AREAS OF MODERATE TO	HEAVY PRECIPITATION A	ND RUN-OFF)
PROPERTIES.	REQUIRED VALUE	TEST METHOD
GRAB TENSILE STRENGTH GRAB TENSILE ELONGATION PUNCTURE MULLEN BURST TRAPEZOID TEAR UV RESISTANCE APPARENT OPENING SIZE FLOW RATE PERMITTIVITY	ASTM D-4632 ASTM D-4833 ASTM D-3786 ASTM D-4533 ASTM D-4355	420 PSI 45 LBS 90%


OIL-ABSORBANT SILTSACK

(FOR AREAS WHERE THERE IS A CONCERN FOR OIL RUN-OFF OR SPILLS)

IT IS THE INTENT OF THE PLANS AND SPECIFICATIONS THAT THE CONTRACTOR INSTALL THE REBAR AS SHOWN IN THIS DETAIL TO PROVIDE A FULLY FUNCTIONING UNIT. ALL COSTS ASSOCIATED WITH FURNISHING, CLEANING AS MANY TIMES AS REQUIRED, DISPOSAL OF SEDIMENT, AND REMOVING THE INLET FILTER WHEN NO LONGER NEEDED IS INCLUDED IN THE ITEM OF WORK AND WILL NOT BE PAID FOR SEPARATELY.

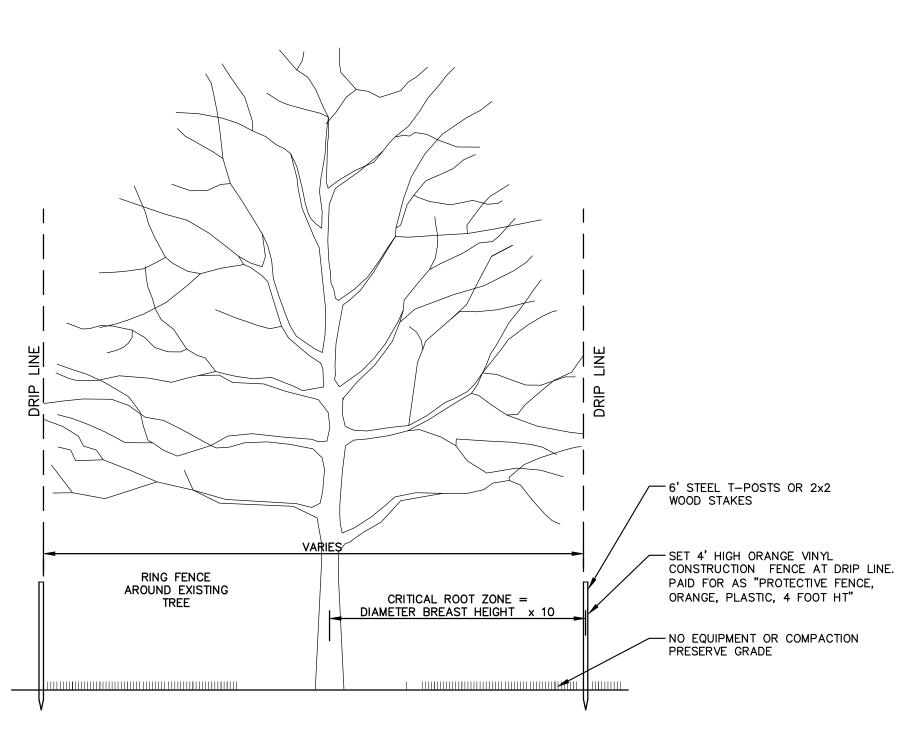

TREE PROTECTION DETAIL

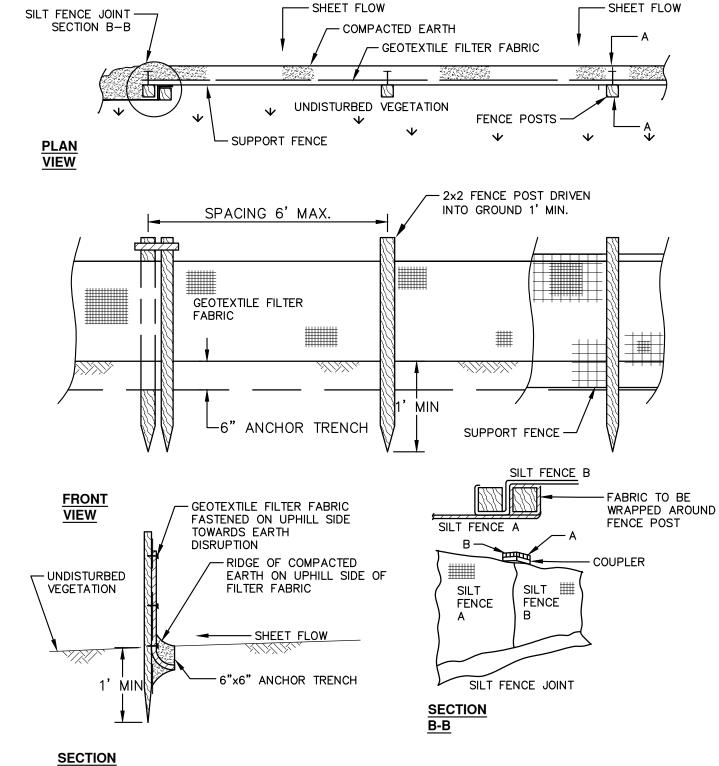


SILT FENCE SD-EC-3

• EXCAVATION = 6240 CY, FILL = 6799 CY

ARE UNIFORM OR SHORT AND COMPLEX. SHORT AND COMPLEX.

AREAS, AND ALONG DRAINAGEWAYS, OUTWASH PLAINS, VALLEY TRAINS, AND TERRACES. NEARLY LEVEL TO GENTLY SLOPING.

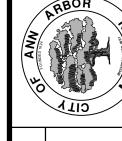



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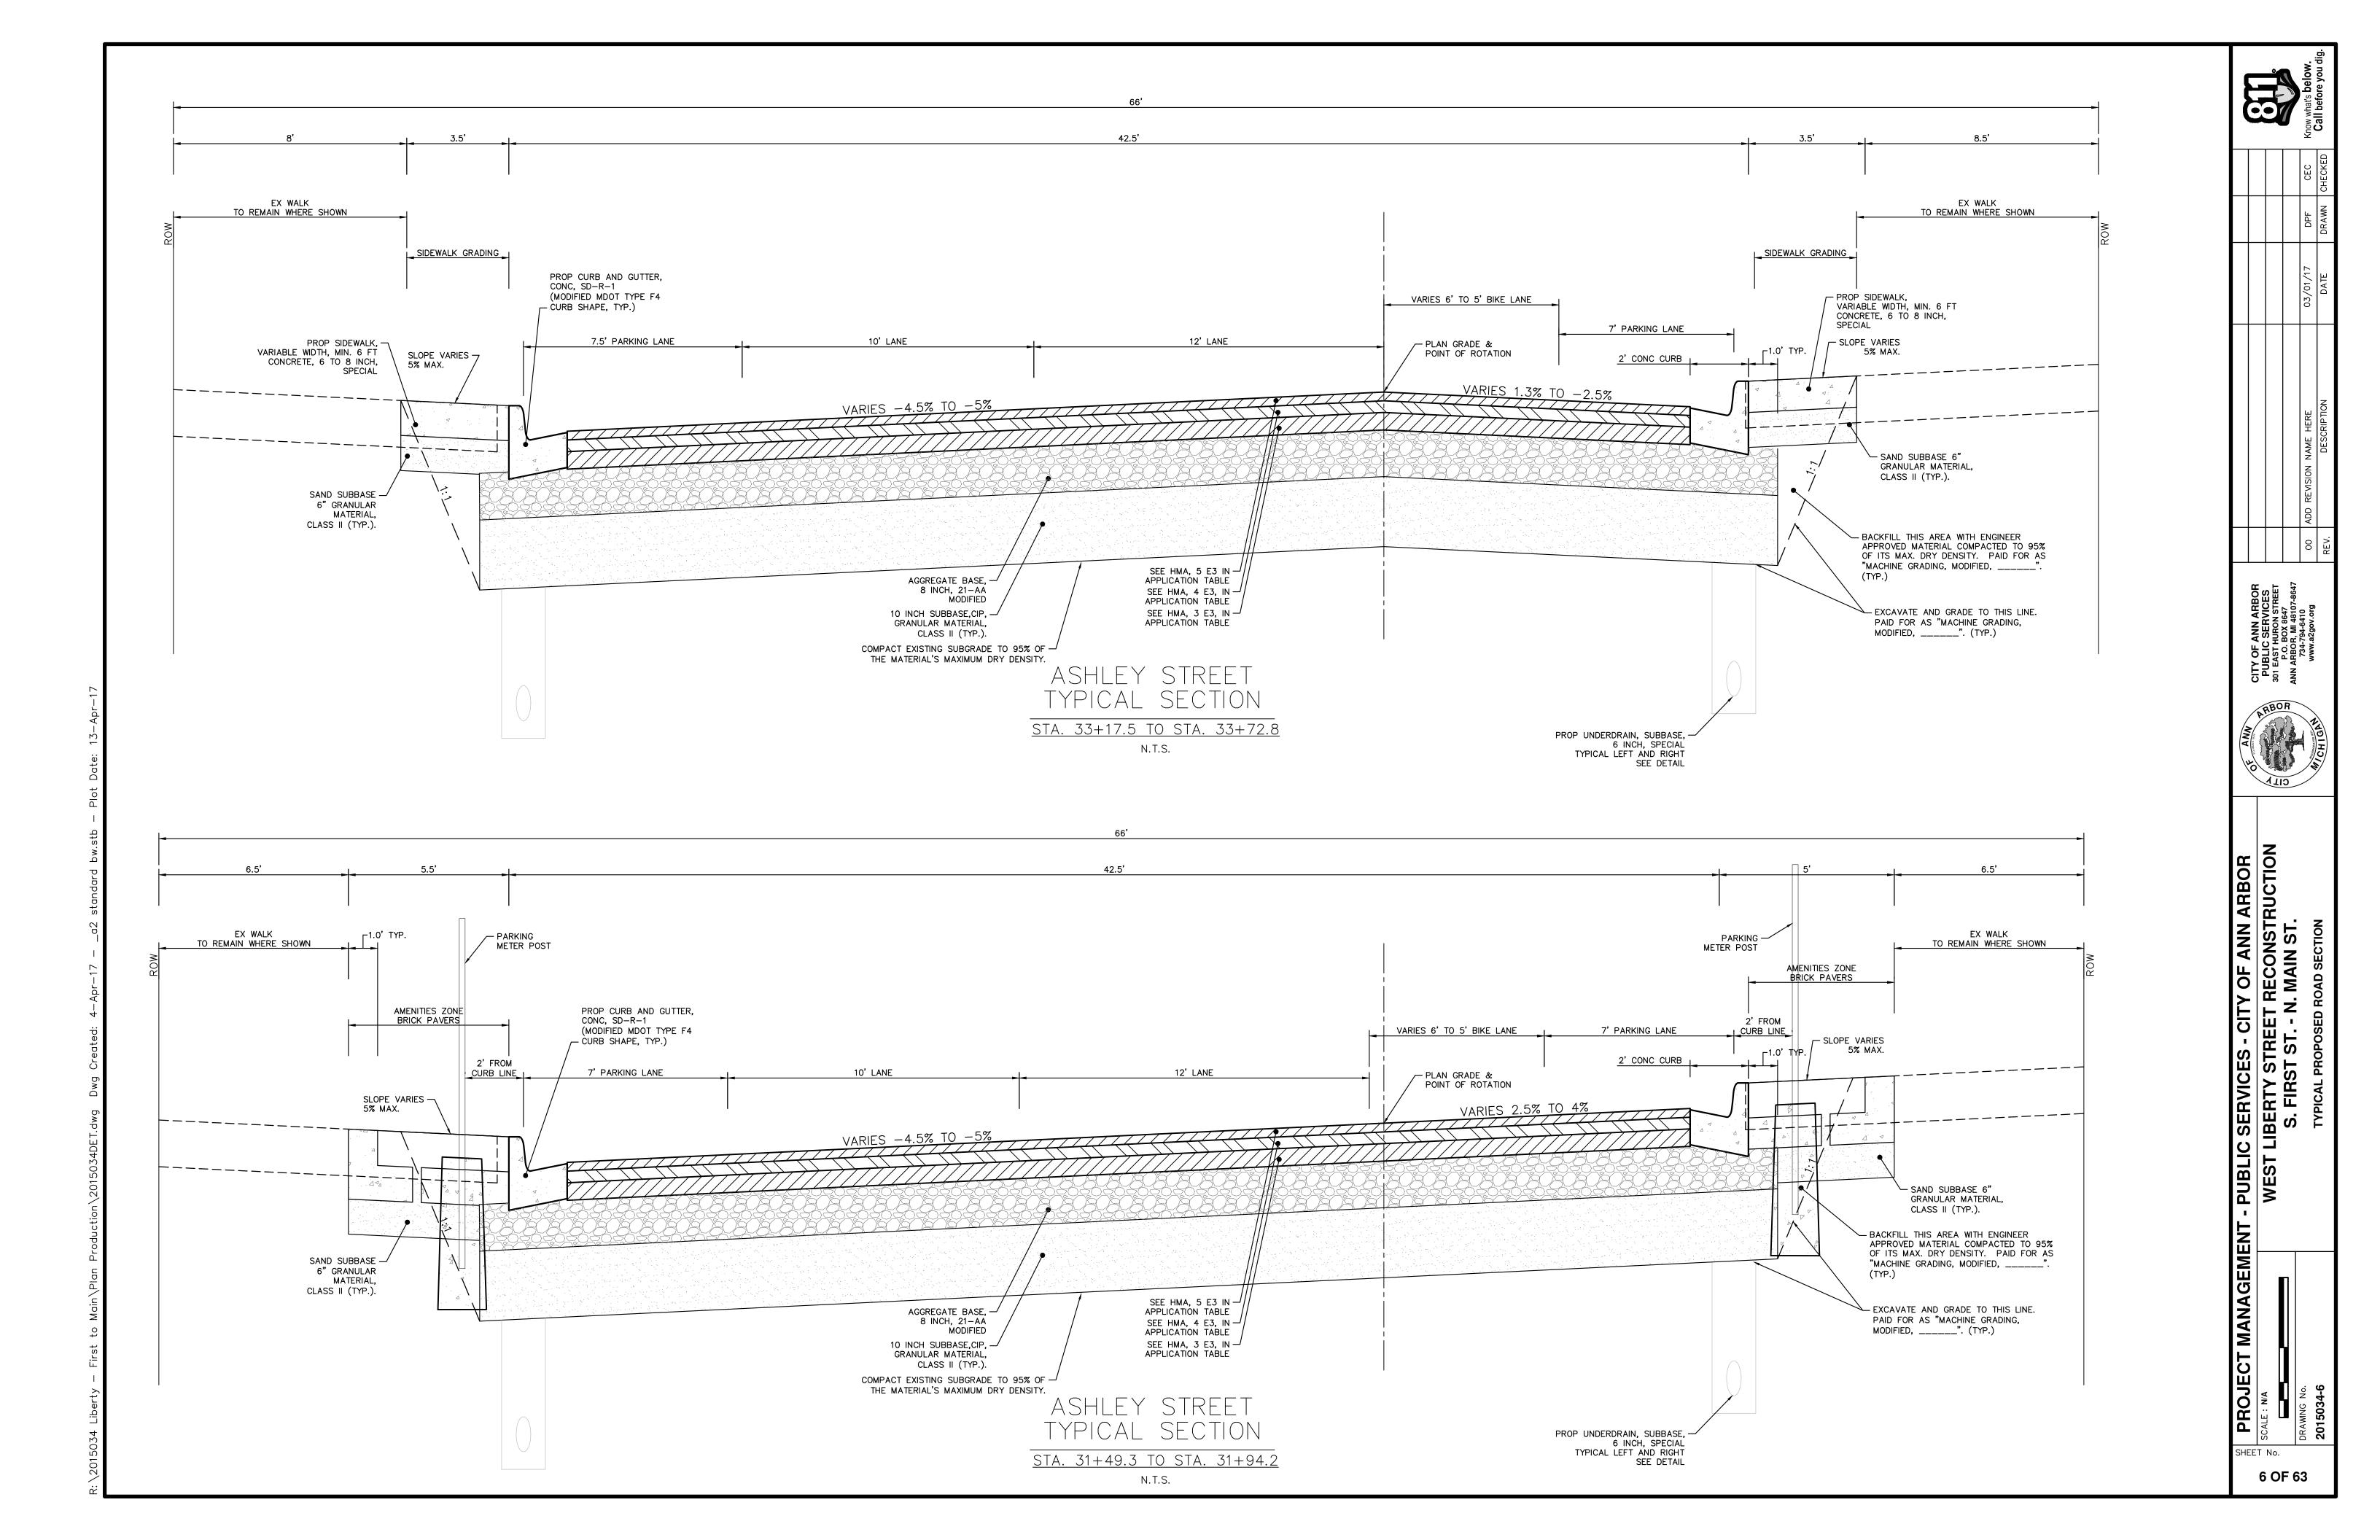
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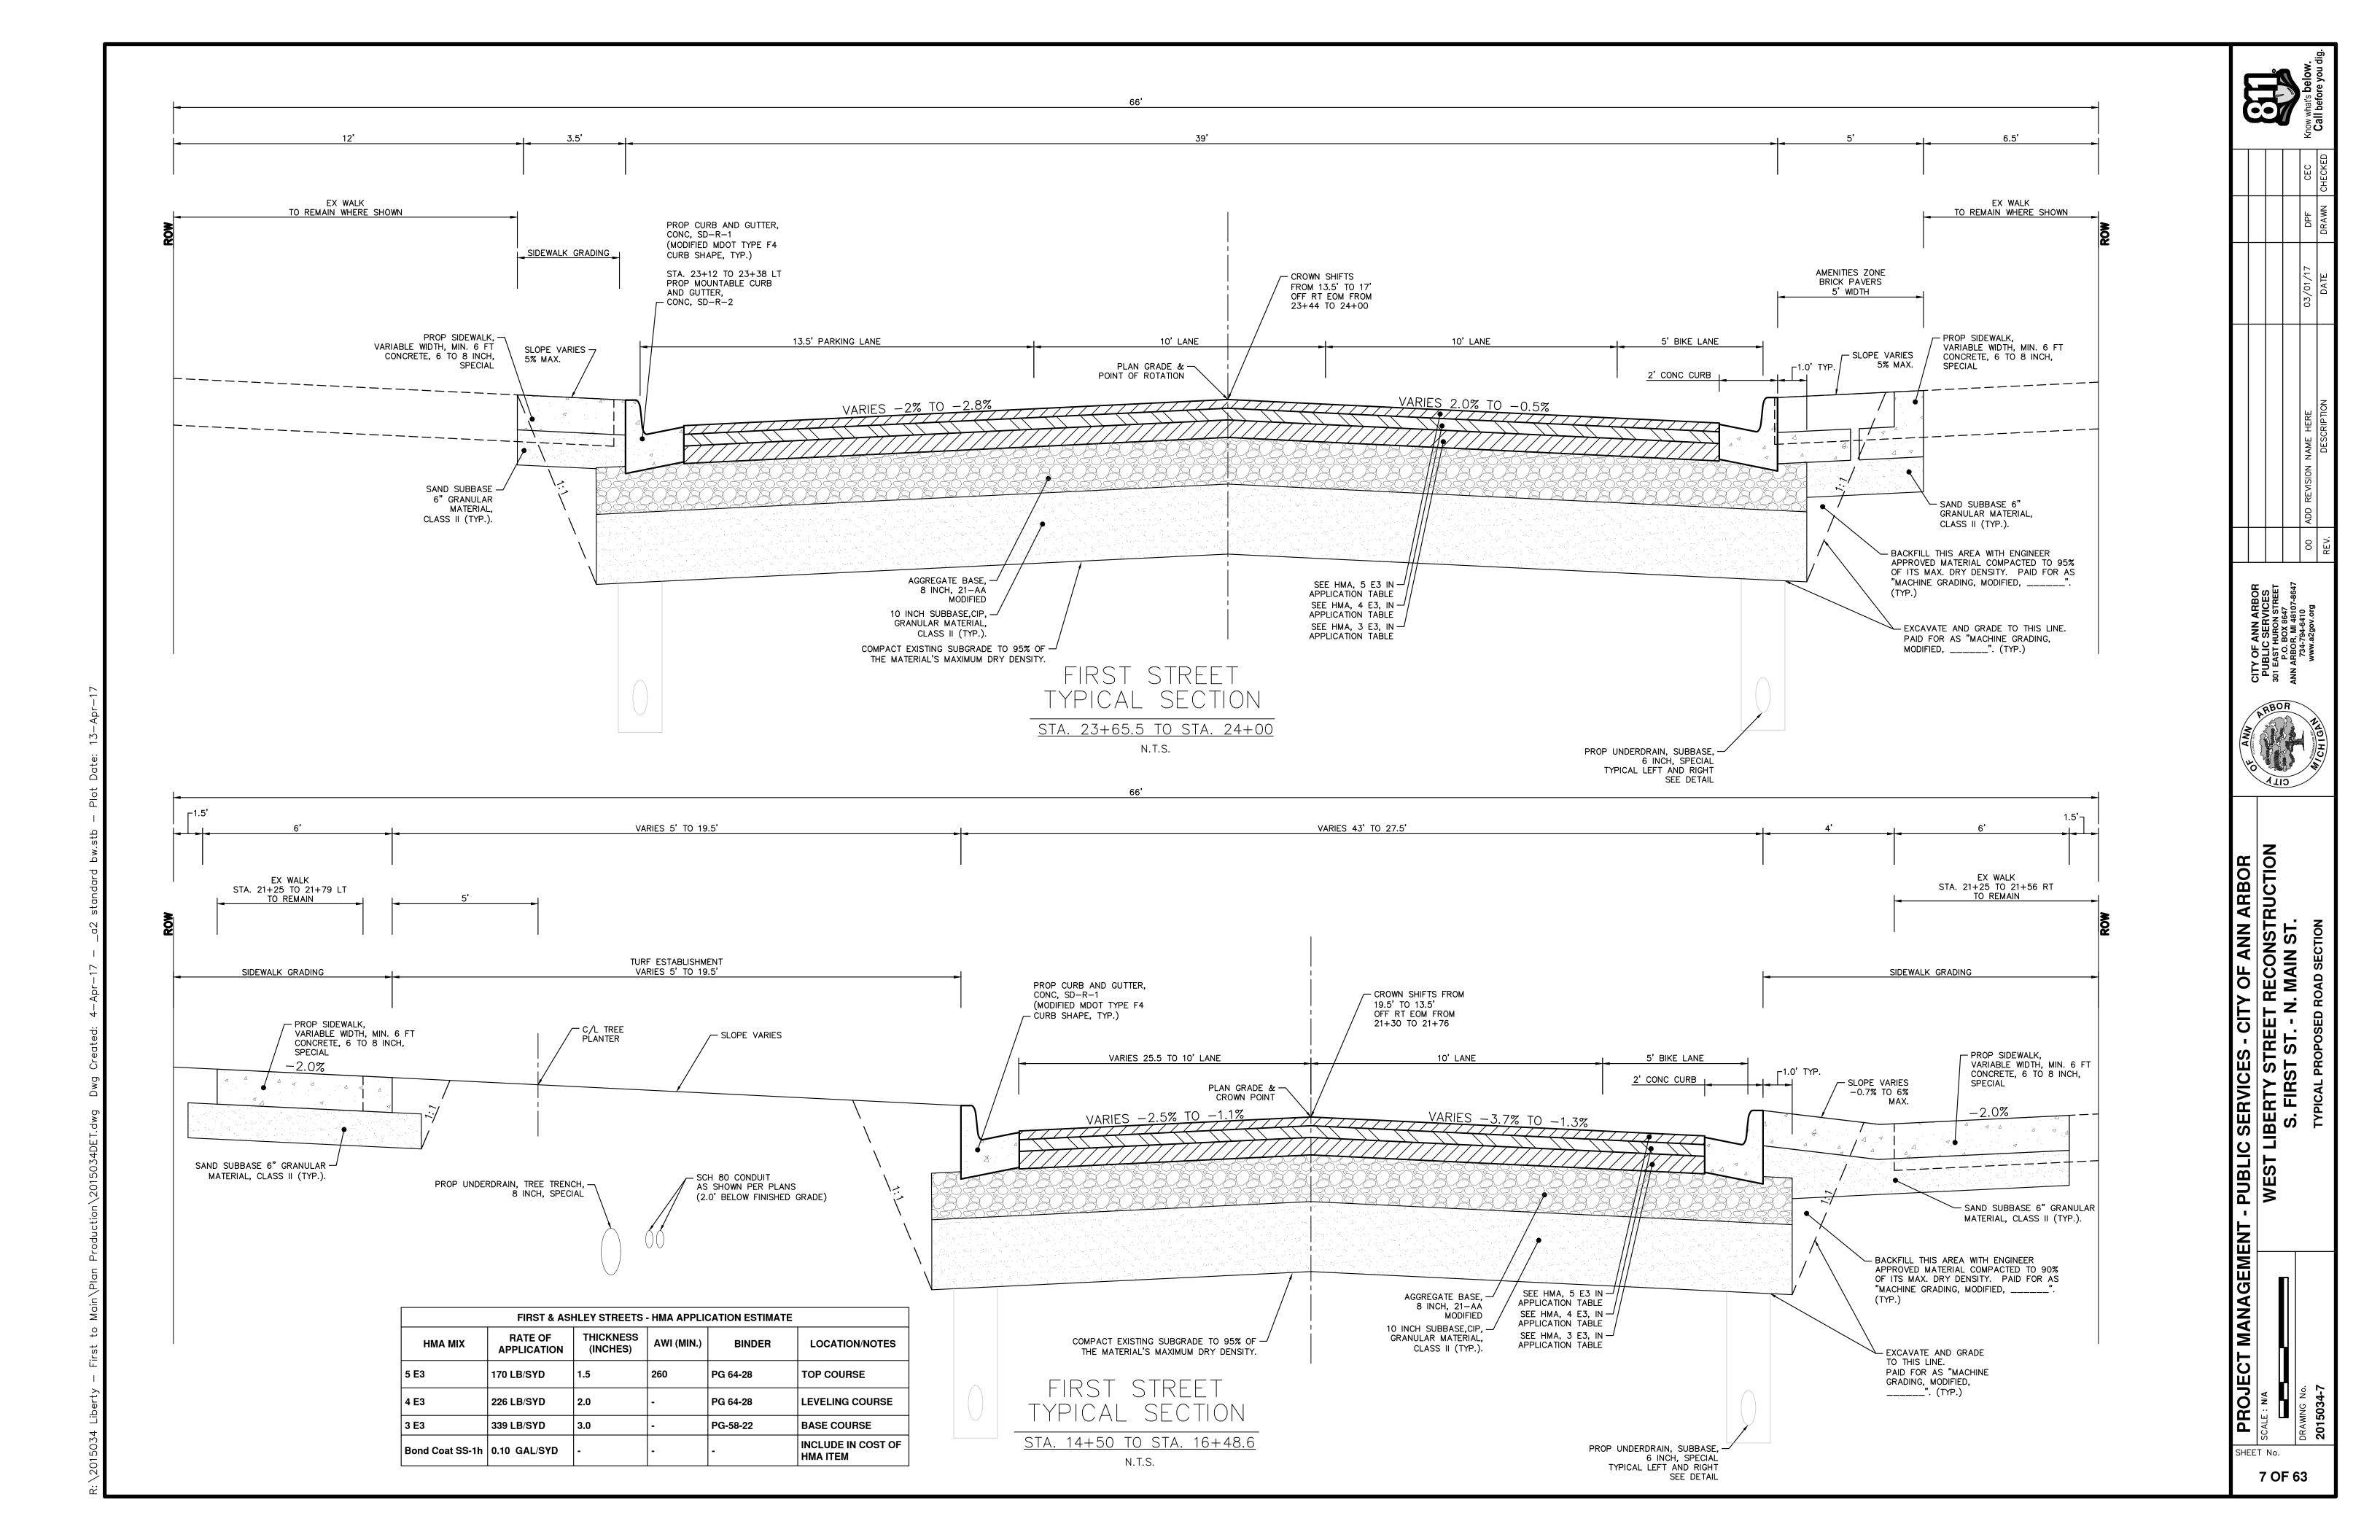
MANAGEM


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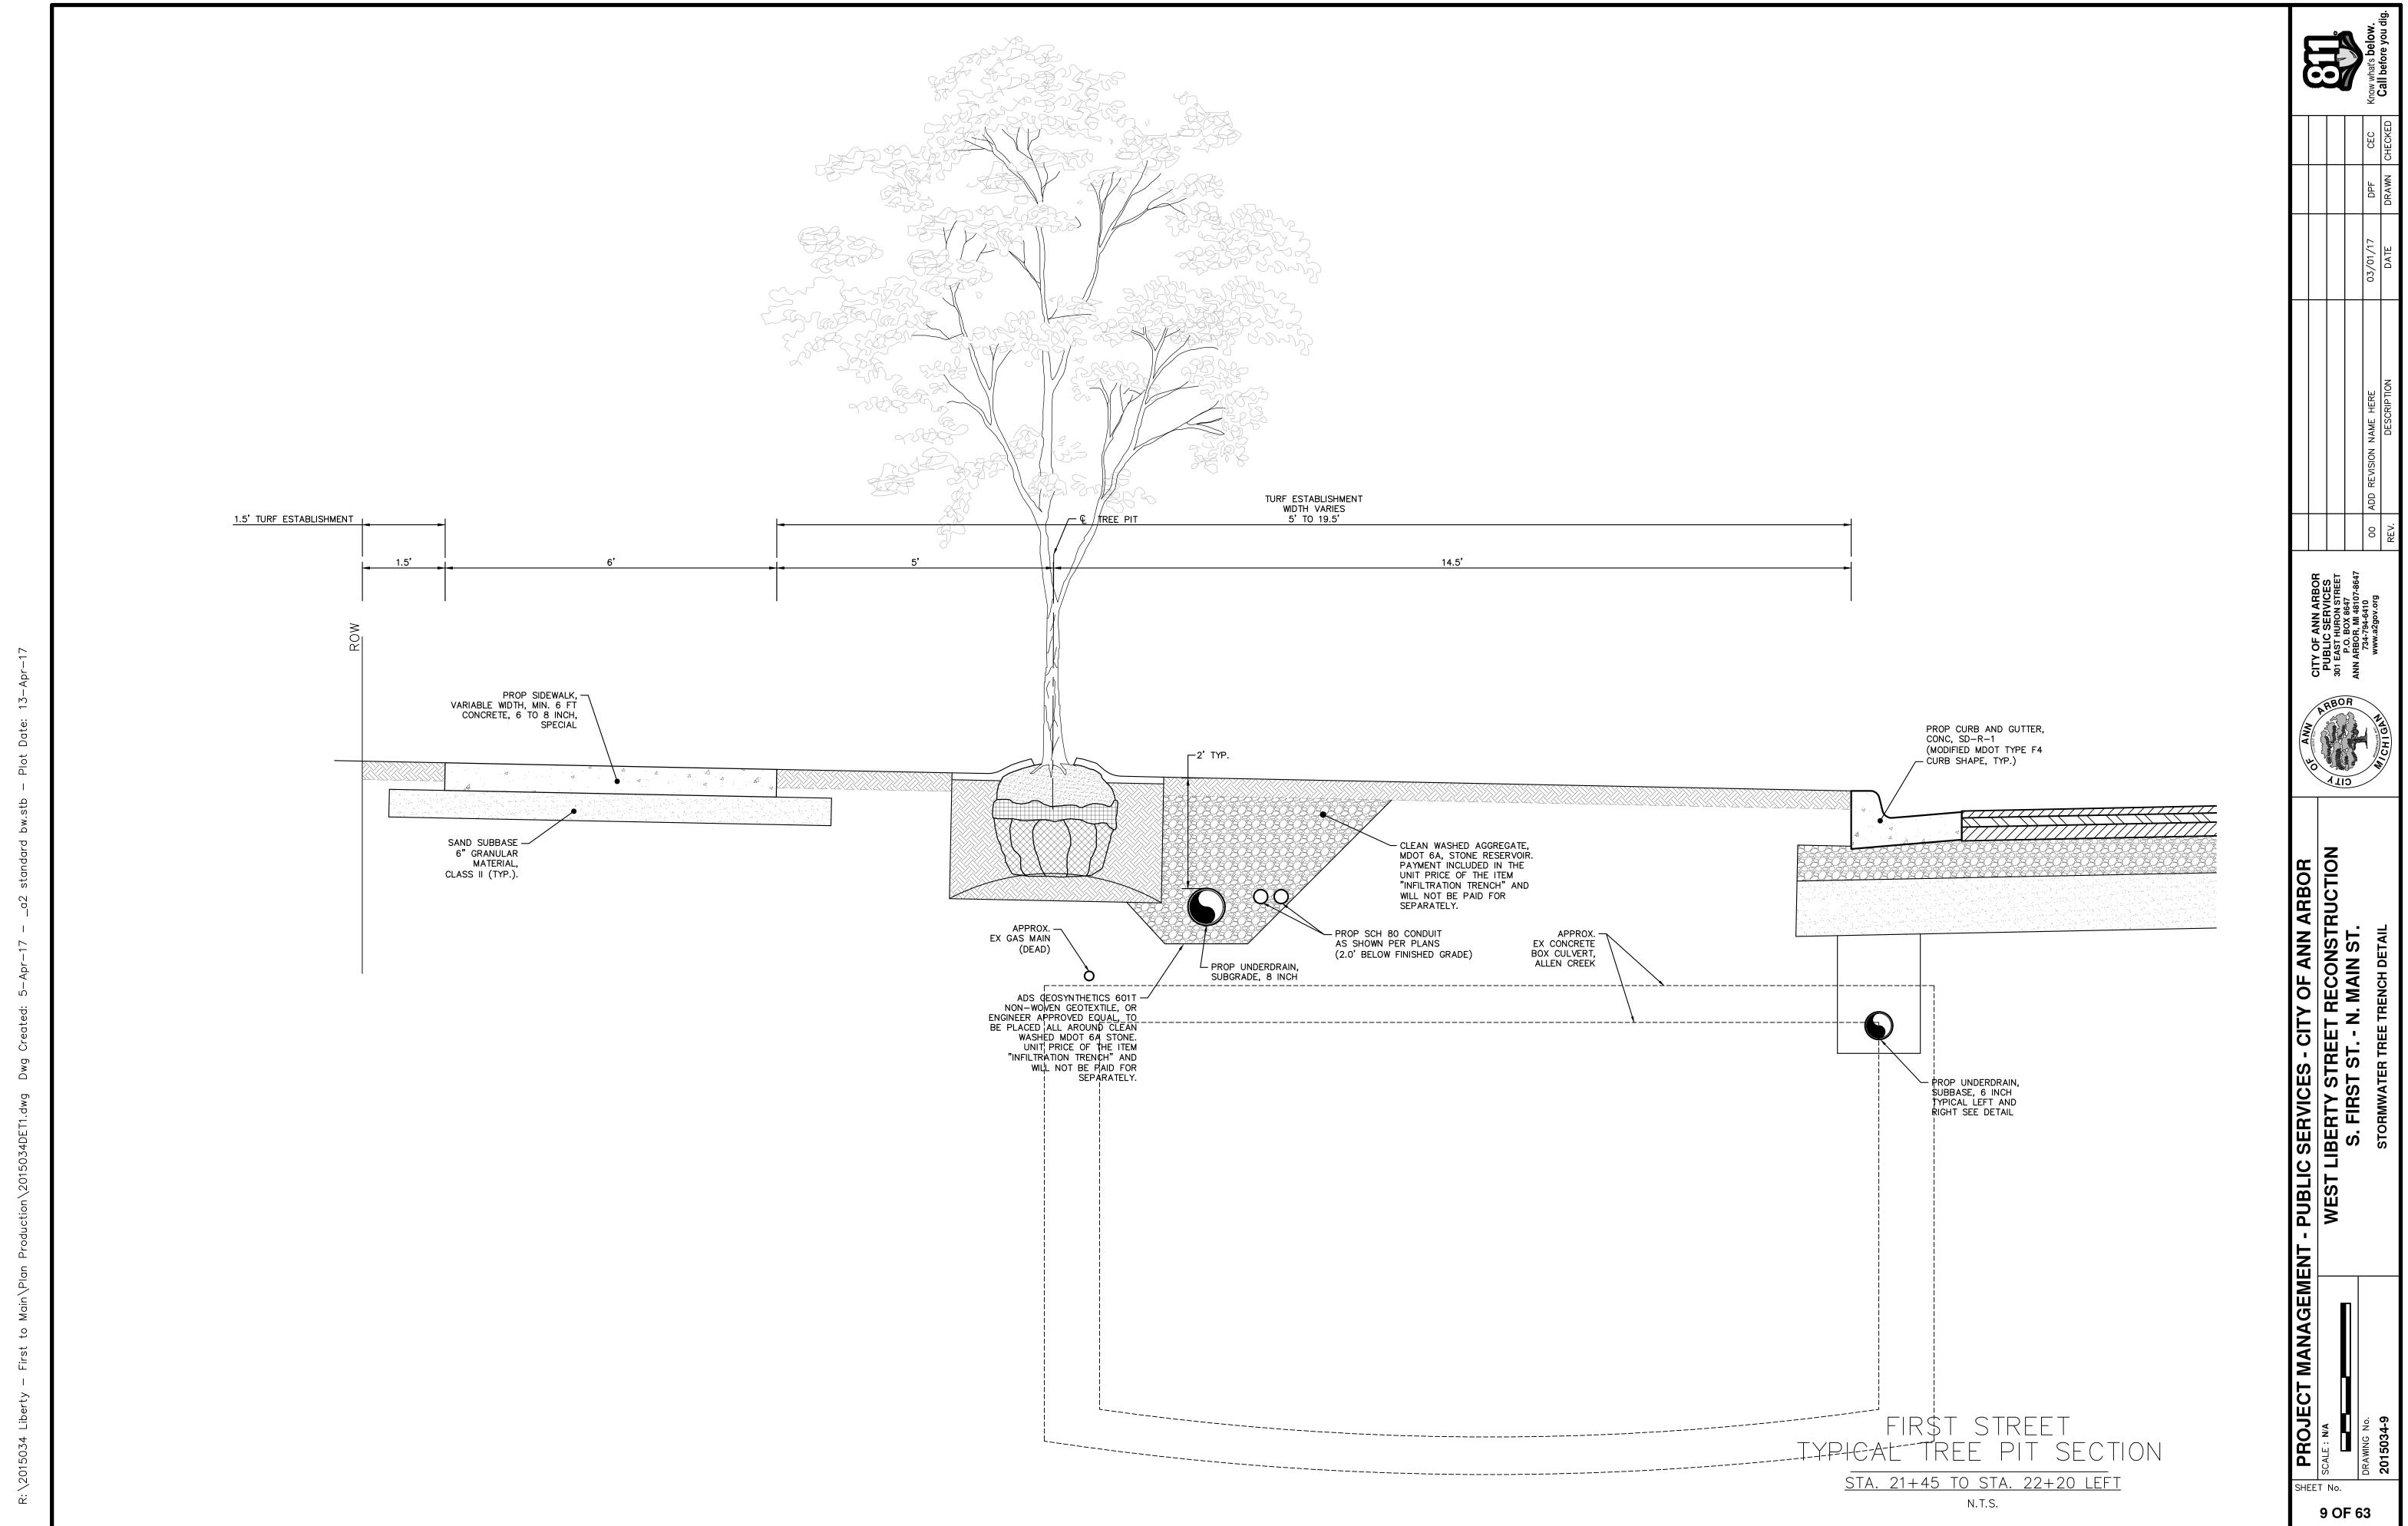







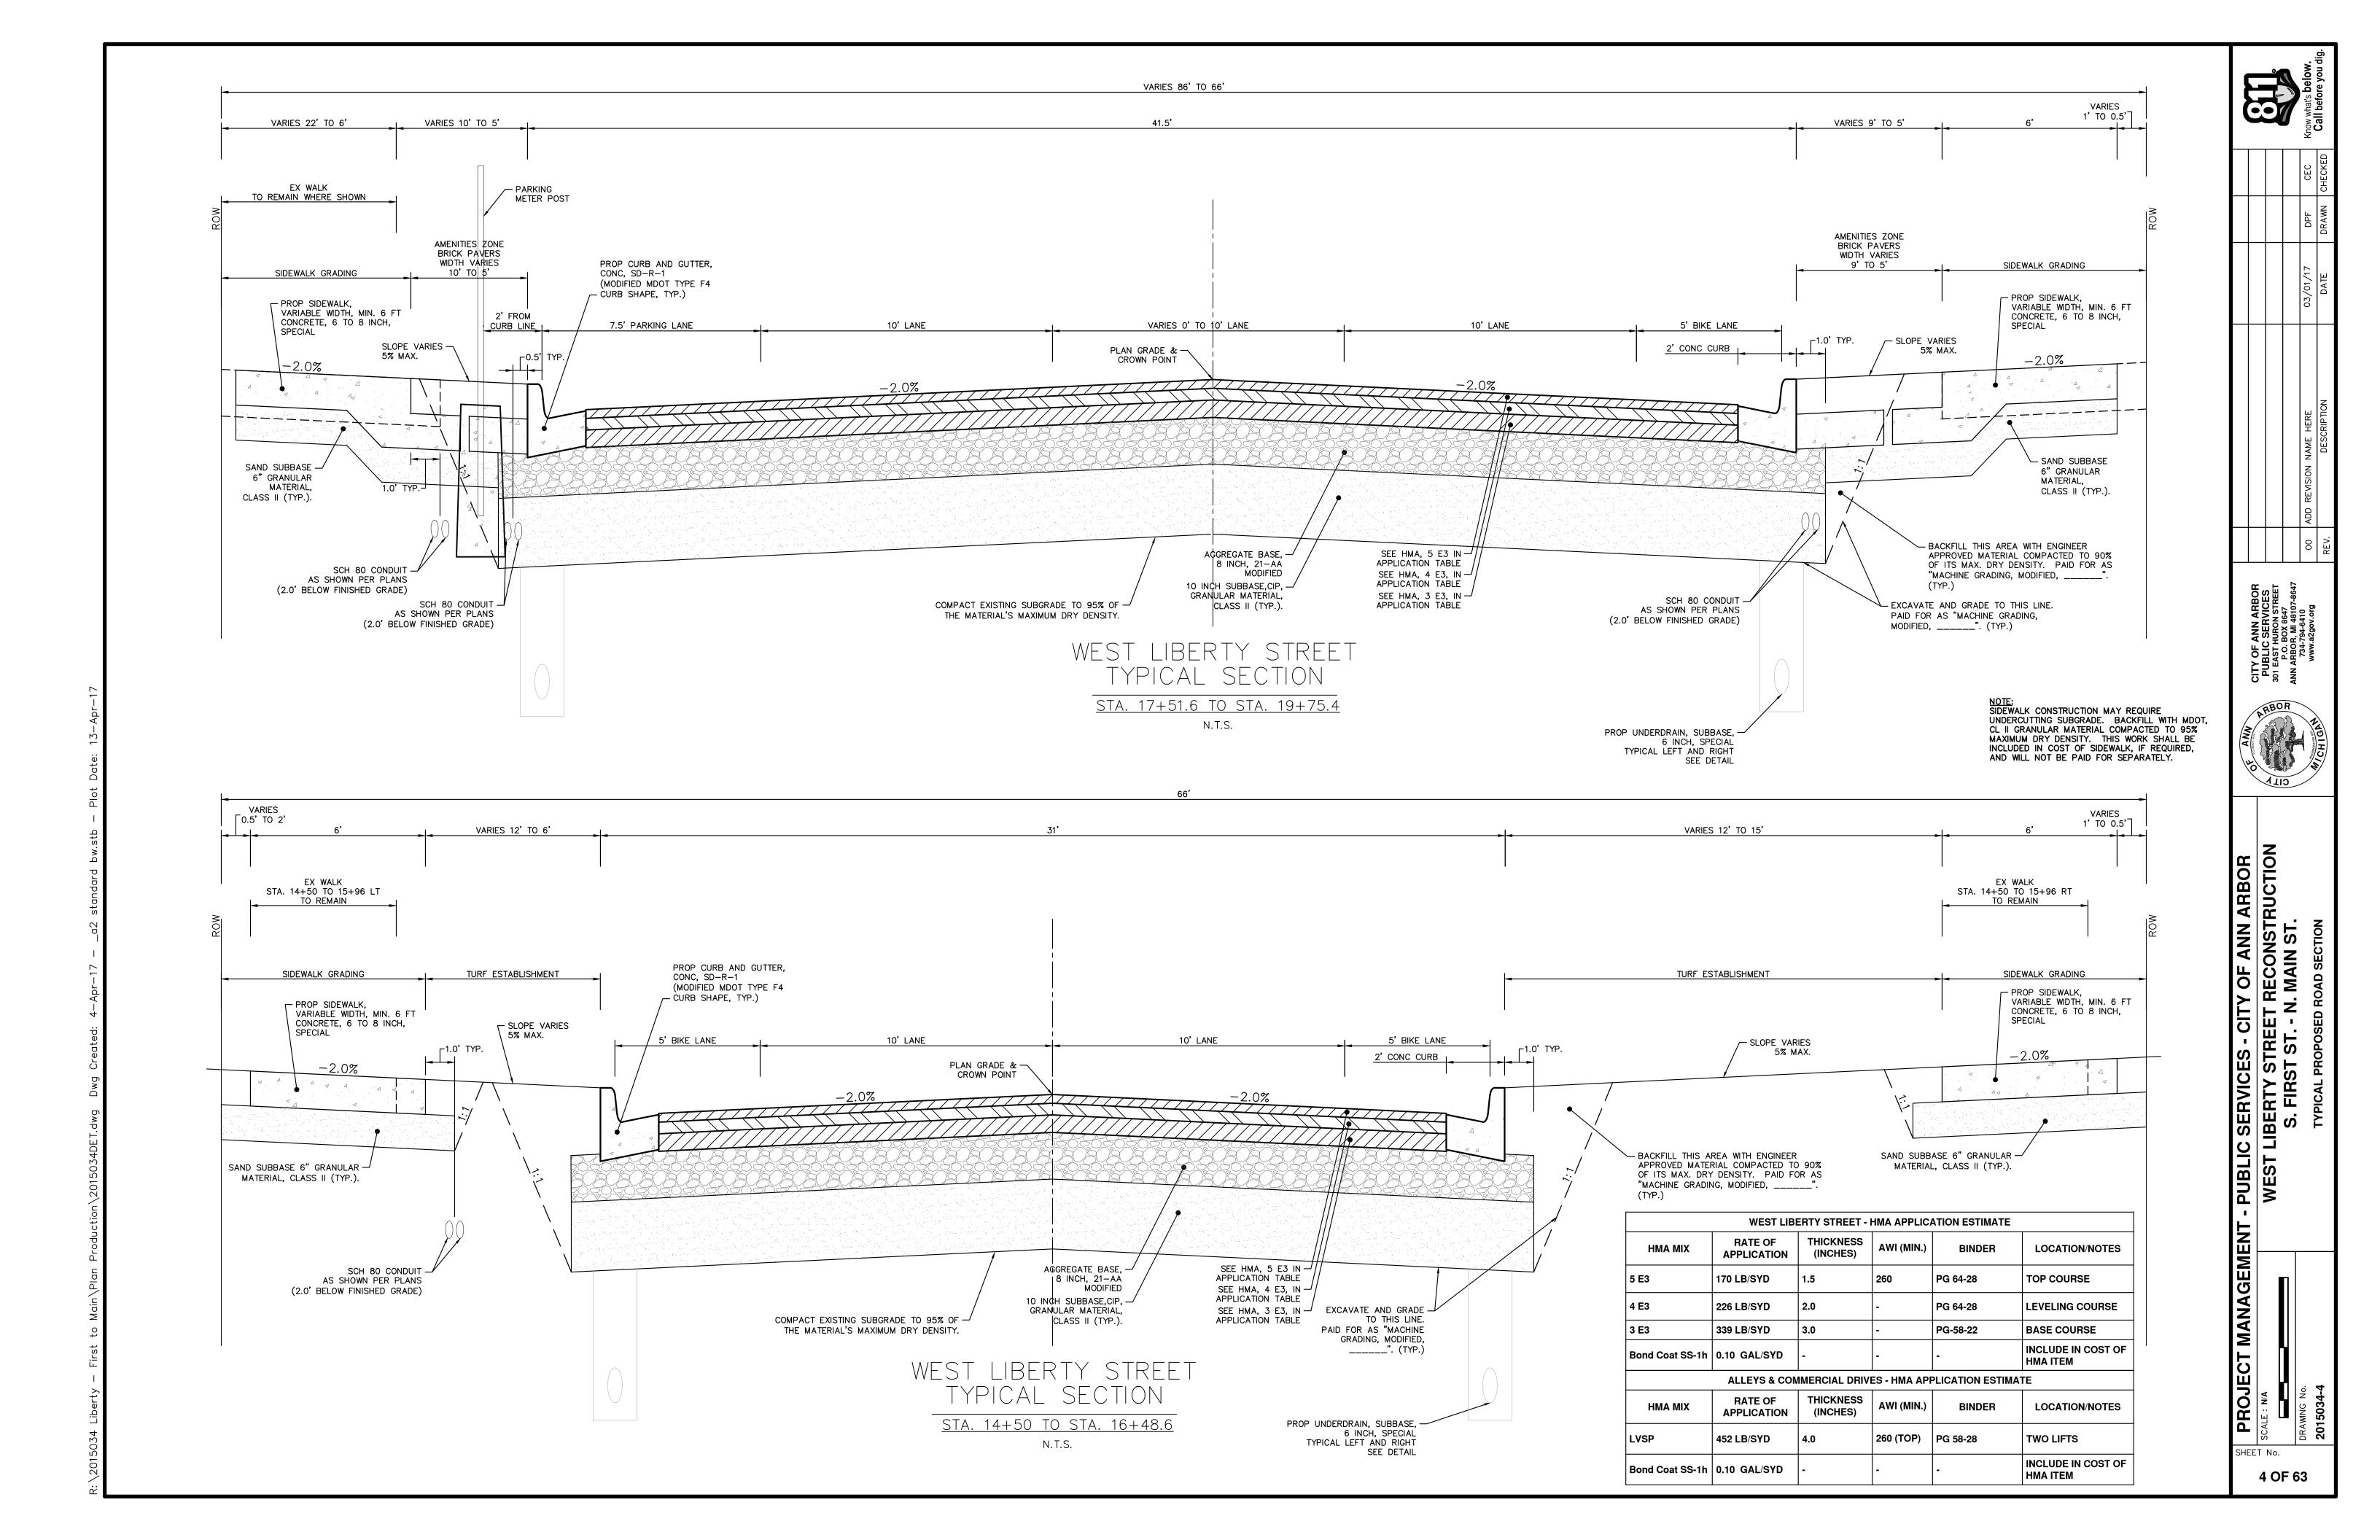


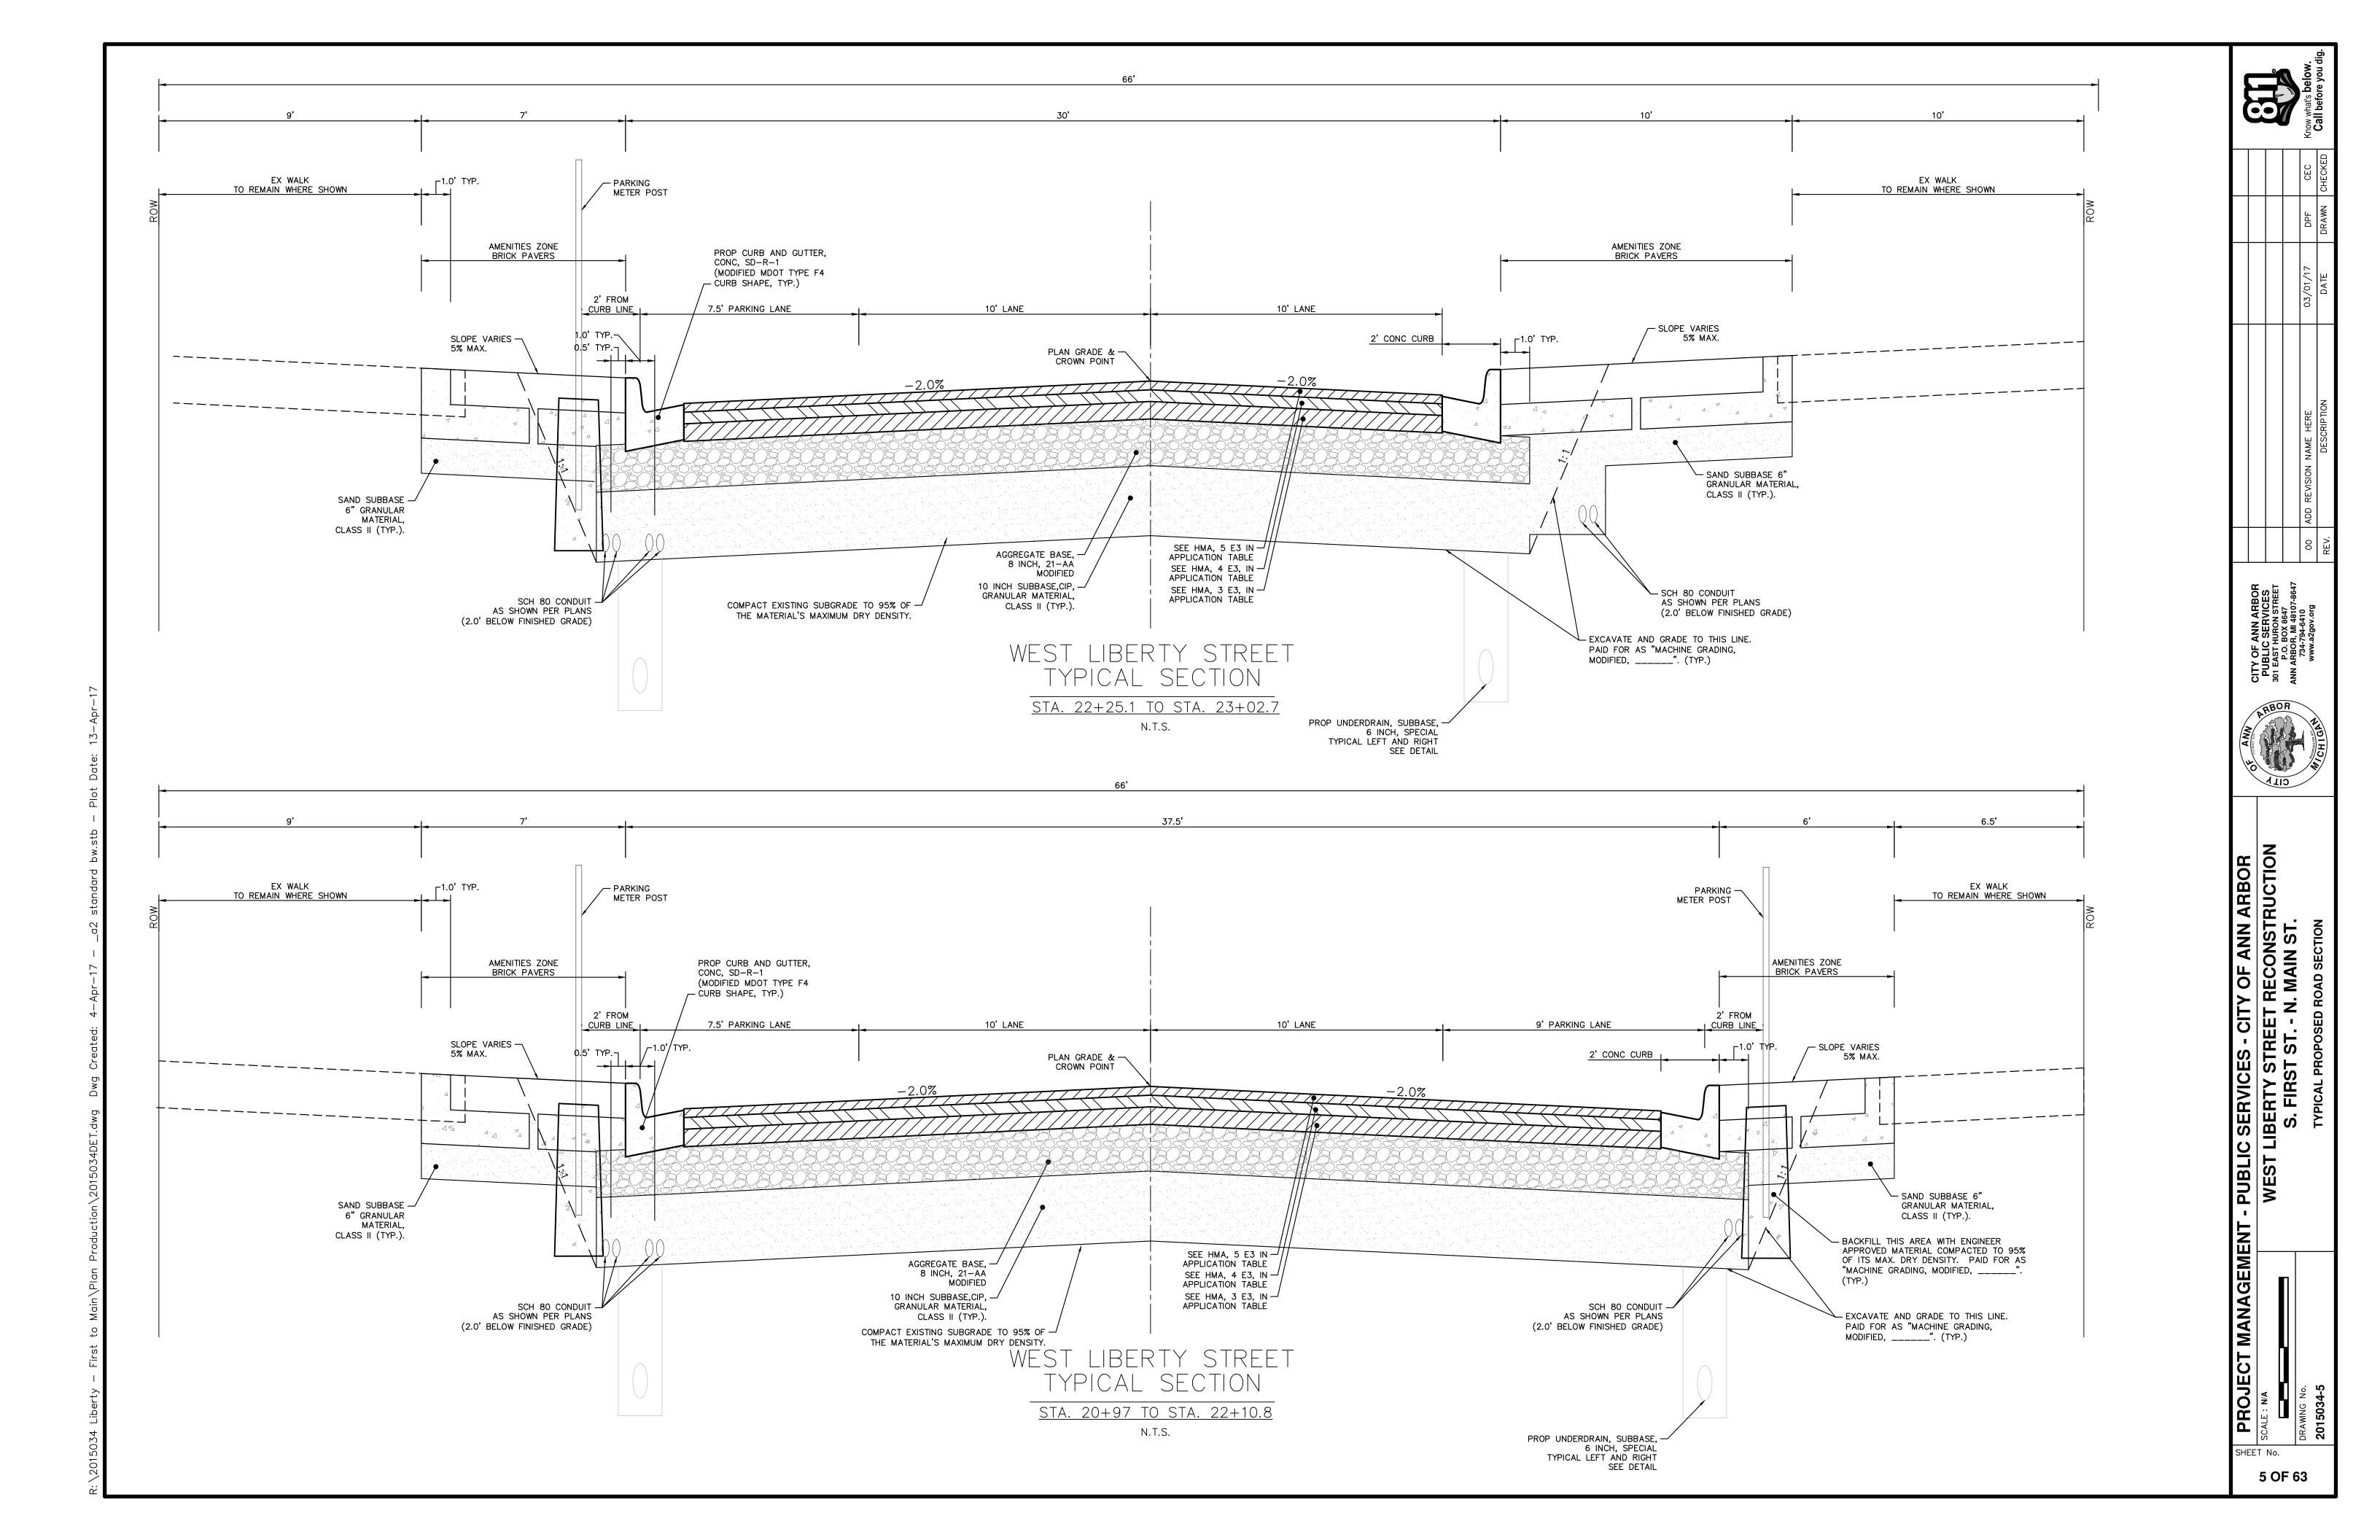

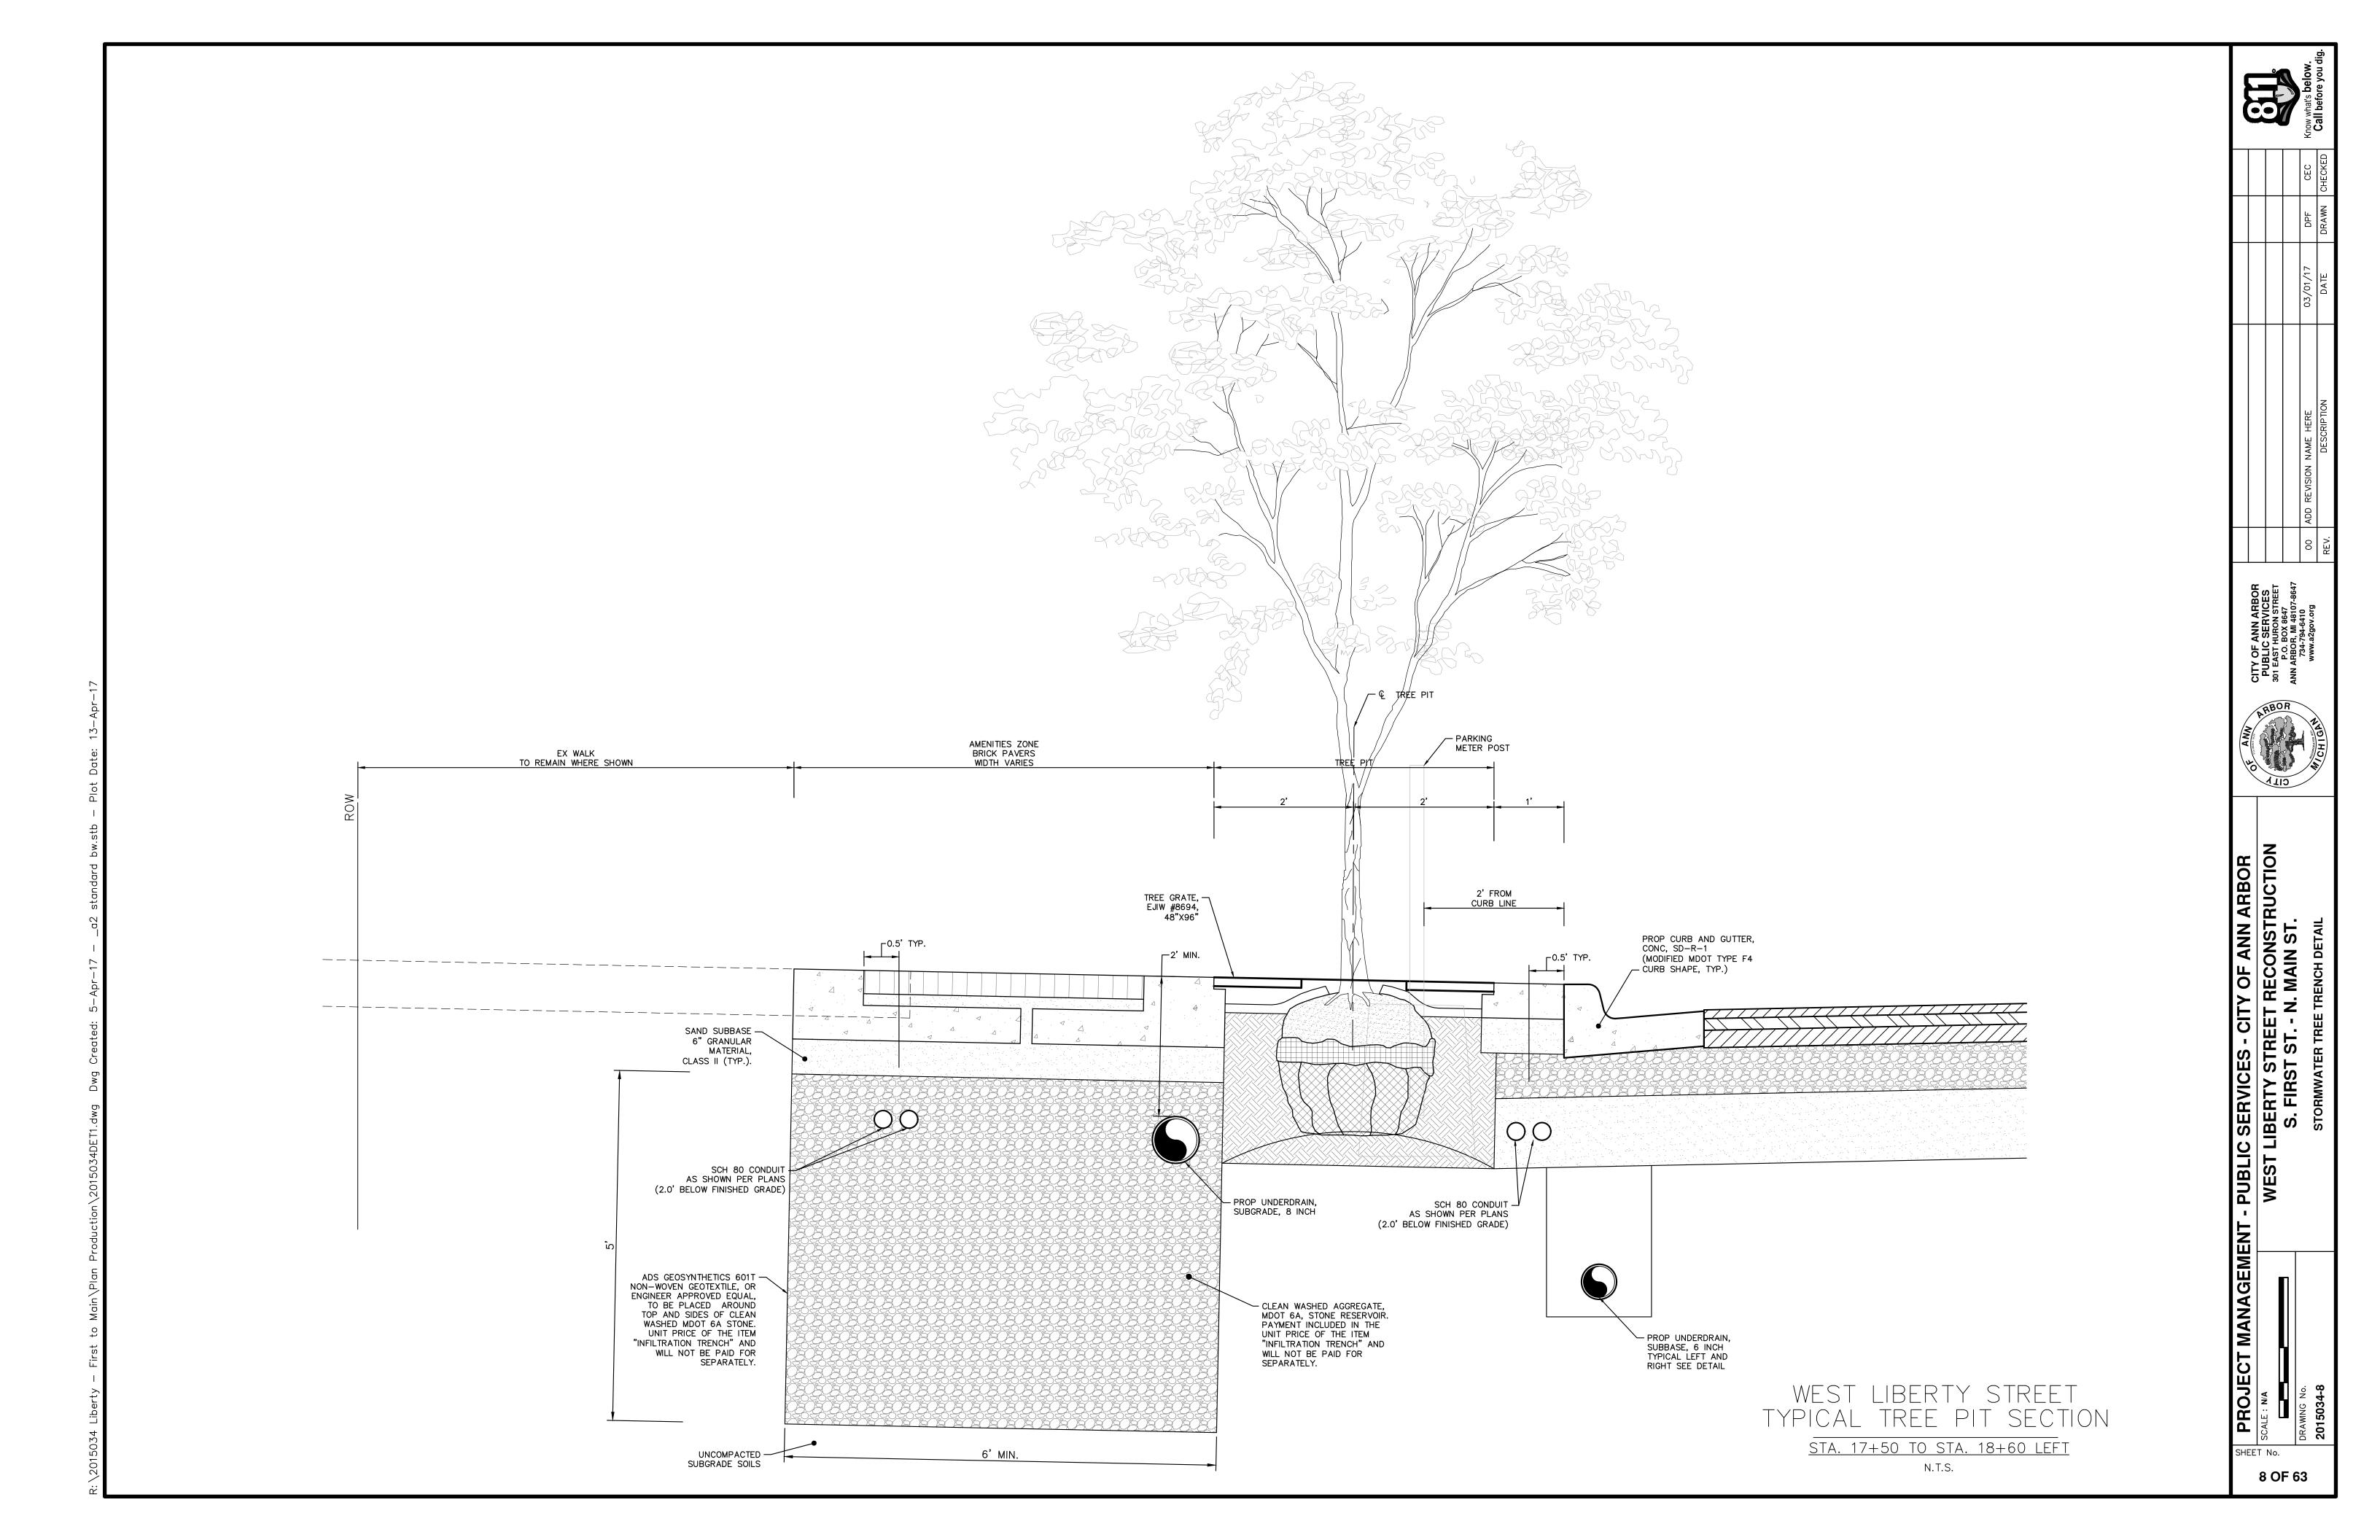


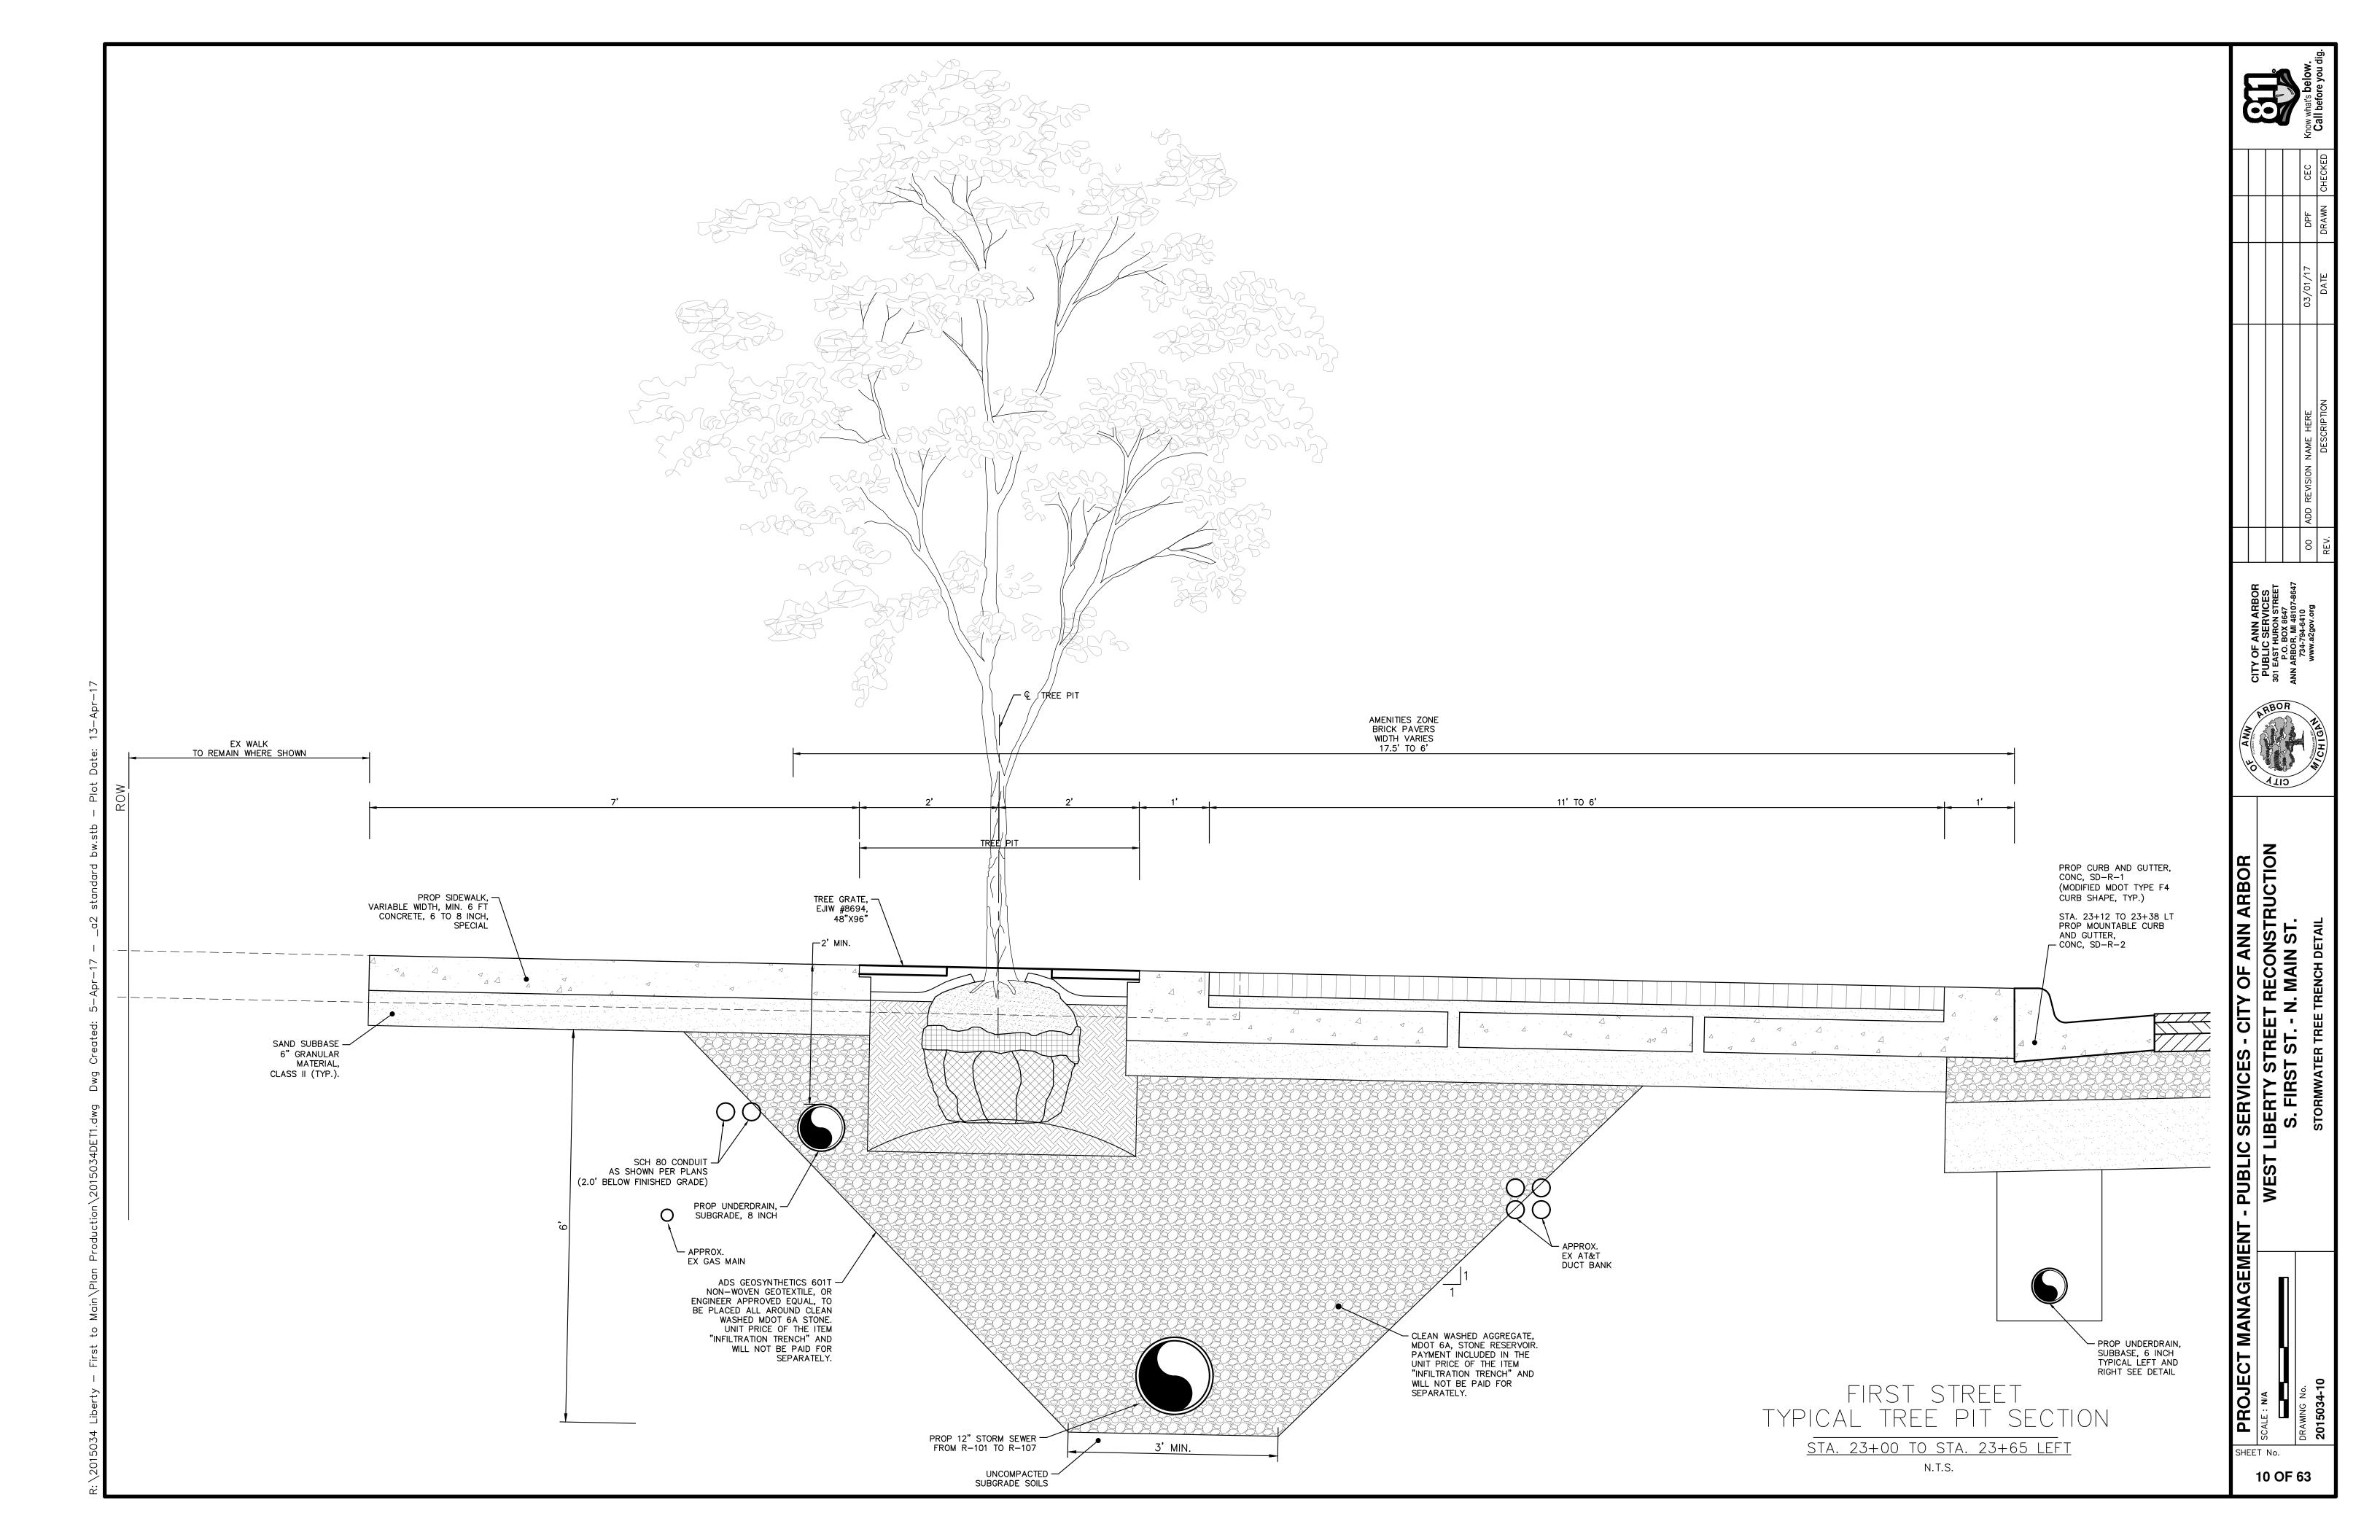


TRENCH DETAIL IA

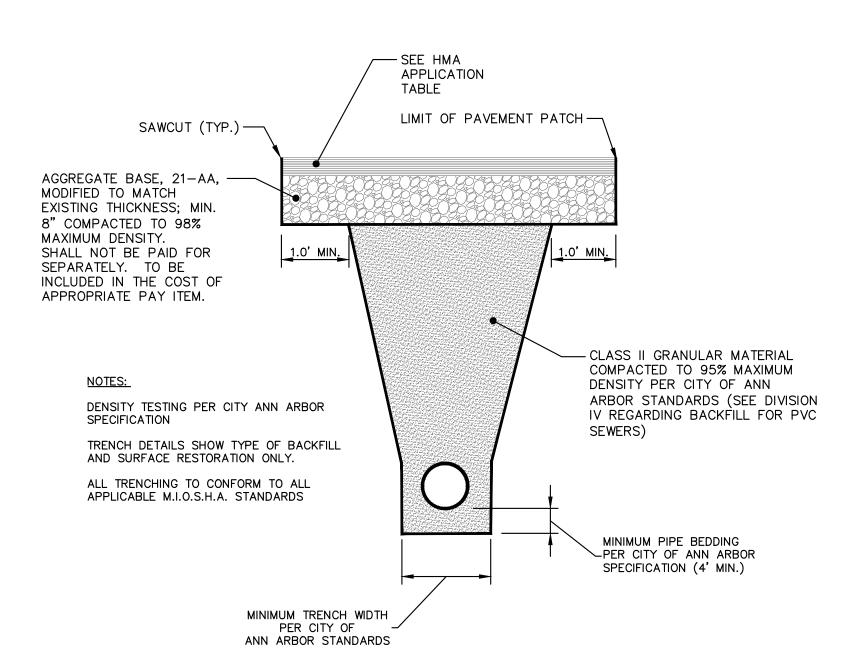


UTILITY TRENCH-TYPE I SD-TD-1 (MODIFIED) (UNDER HMA PAVEMENT)

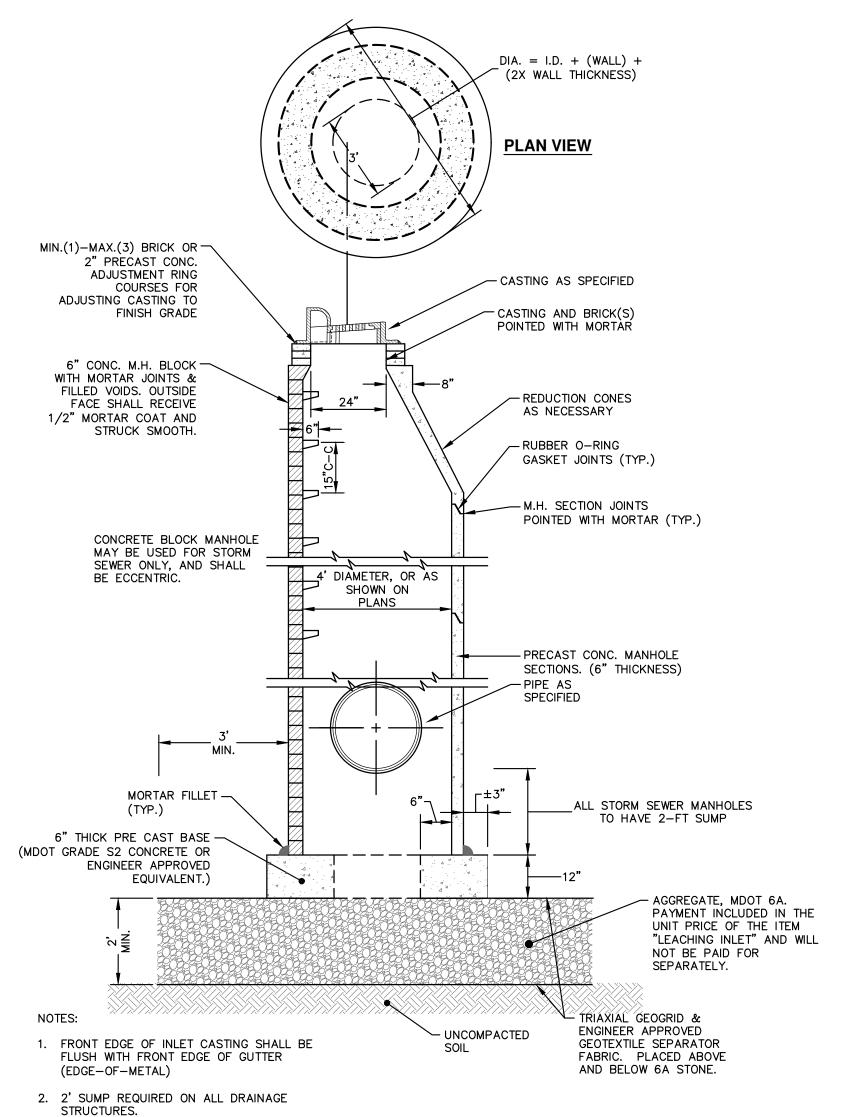

LEACHING INLET STRUCTURE

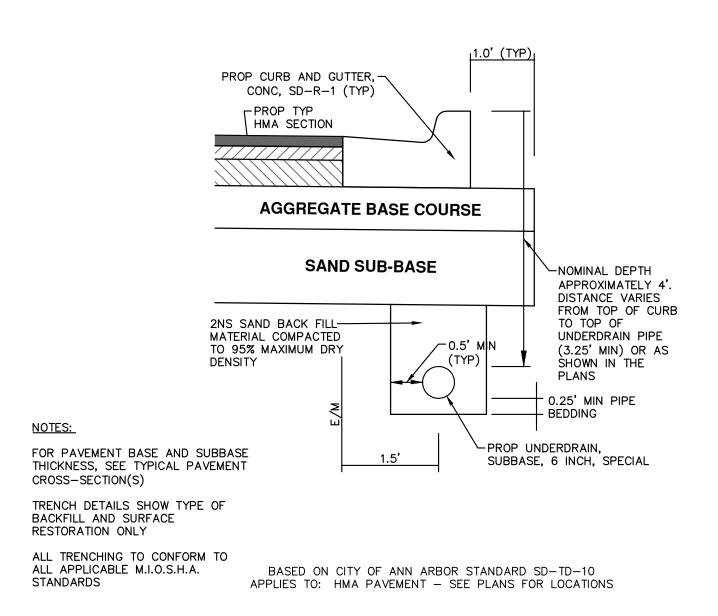

TRENCH DETAIL FOR UNDER DRAIN (UNDER HMA PAVEMENT)

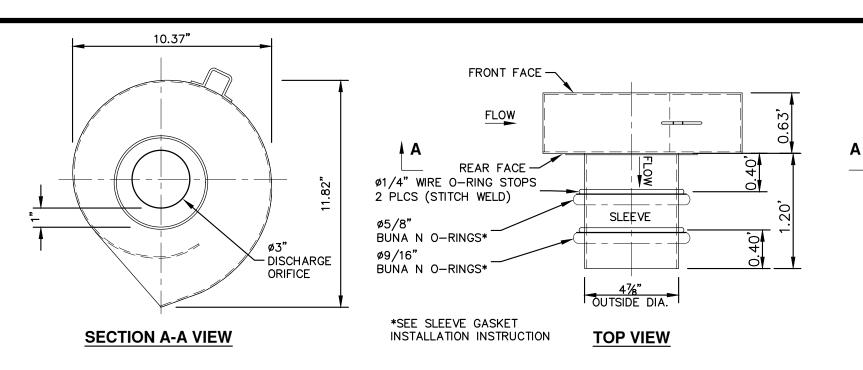



NOTES:

- 1. ALL WELDS CONTINUOUS UNLESS NOTED OTHERWISE.
- 2. MATERIALS:12 GA. 304L STAINLESS STEEL • (1) ø5/8" AND (1) ø9/16"
- BUNA N, 50 DUROMETER O-RINGS. 3. MANUFACTURE HOUSING AND BYPASS DOOR
- AND ASSEMBLE PER DRAWING "2 mm FLUIDIC-AMP FABRICATION DETAILS FA1012-FA2023 HOUSING AND INLET"
- 4. DISCHARGE ORIFICE LOCATED REAR FACE. ø4" BYPASS OPENING LOCATED FRONT FACE.
- 5. INCLUDES 20' BYPASS DOOR PULL CABLE.

FLUIDIC-AMP VORTEX VALVE MODEL FA1012 WITH SLEEVE ATTACHMENT FOR Ø6" OPENING

FABRICATION DRAWING

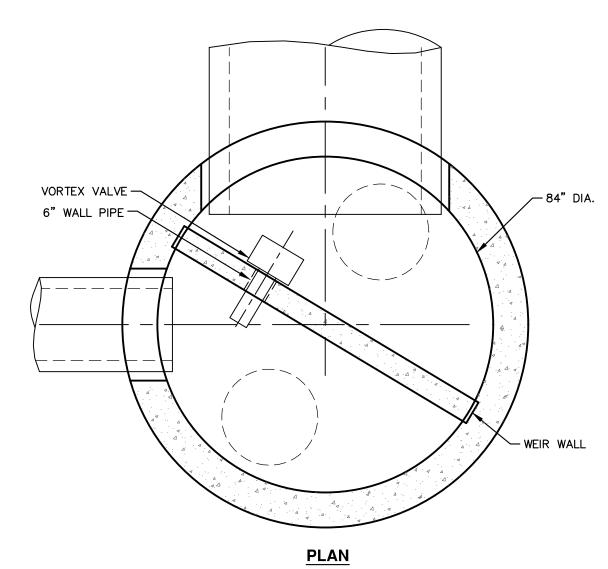

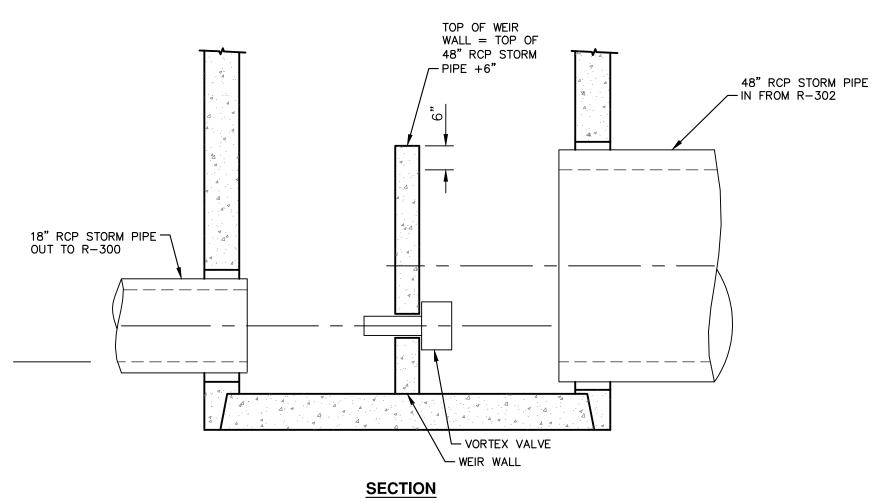

UNDERGROUND STORMWATER STORAGE CONTROL STRUCTURE, R-301



SERVICES - CITY OF ANN ARBC BERTY STREET RECONSTRUCT S. FIRST ST. - N. MAIN ST.

PROJECT MANAGEMENT

SHEET No.

NOTES:

- 1. ALL LIFT HOLES AND JOINTS SHALL BE MORTARED BOTH INSIDE AND OUTSIDE
- 2. ALL JOINTS SHALL BE MADE WATER TIGHT WITH RUBBER GASKET JOINTS
- 3. NO STEPS ARE PERMITTED
- 4. MANHOLE SECTIONS SHALL MEET ASTM C-478

RAISE MANHOLE CASTING TO PROPOSED

FINISH STREET GRADE AFTER PLACEMENT

OF LEVELING COURSE(S) AND PRIOR TO

PLACING FINAL SURFACE COURSE.

MORTAR BED (TYP.) —

GATE WELL FOR MAIN 16" & SMALLER SD-W-3

POINTED SMOOTH OR

FINE BRUSH FINISH

CONCRETE, GRADE P-NC TO BE

PLACED TO UNDISTURBED ROAD BASE.

- PAVEMENT TOP COURSE

— PAVEMENT

COURSE

BASE

PAVEMENT LEVELING COURSE

(D)

MINIMUM STANDARDS

THE MDOT GRADE PI OR P-NC CONCRETE AT THE FITTING FACE SHALL EXTEND TO WITHIN 2 INCHES OF THE BELL AND SHALL EXTEND FROM THE FITTING FACE A MINIMUM OF 2 FEET TO THE UNDISTURBED SOLID GROUND.


THE DIMENSIONS OF THE THRUST BLOCK AT THE FACE OF THE UNDISTURBED SOLID GROUND SHALL BE AS SHOWN IN THE TABLE BELOW.

IF THERE ISN'T SUFFICIENT SPACE FOR THE INSTALLATION OF THE THRUST BLOCK WITHOUT INTERFERENCE WITH OTHER SERVICES, ANOTHER ARRANGEMENT SATISFACTORY TO THE ENGINEER SHALL BE USED.

FITTINGS	PL	UG				BEN	NDS					
I.D.		EE DSS	9	0°	4	5°	22	2 <u>1</u> °	11	<u>1</u> ∙ 4	HYDF	RANT
INCHES	W	I	W	Н	W	Τ	W	Ι	W	Н	W	I
4	1.0	1.0	1.0	1.0	1.0	1.0						
6	2.0	1.5	2.0	2.0	2.0	1.0	1.0	1.0	1.0	1.0	2.0	1.5
8	2.5	2.0	3.5	2.0	2.0	2.0	2.0	1.0	1.0	1.0	2.5	2.0
12	3.5	3.0	5.5	3.0	3.5	2.5	2.0	2.0	2.0	1.0		
16	6.0	3.5	6.0	4.0	5.0	3.0	3.5	2.5	2.0	2.0		

FOR FITTING SIZES LARGER THAN 16", THRUST BLOCK DIMENSIONS SHALL BE AS SPECIFIED BY ENGINEER.


W = WIDTH IN FEETH = HEIGHT IN FEET

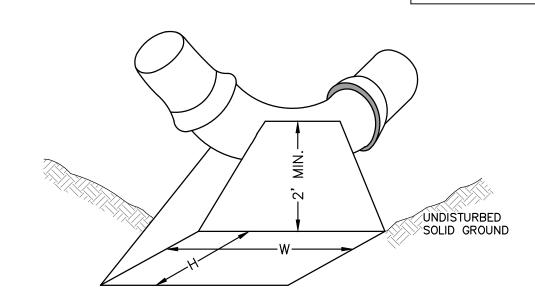


NOTE:

THESE ARE MINIMUM STANDARDS. WHERE SOIL CONDITIONS DICTATE, ADJUSTMENTS IN SIZE SHALL BE MADE AS DIRECTED BY THE PUBLIC SERVICES AREA ADMINISTRATOR.

THRUST BLOCK SD-W-2

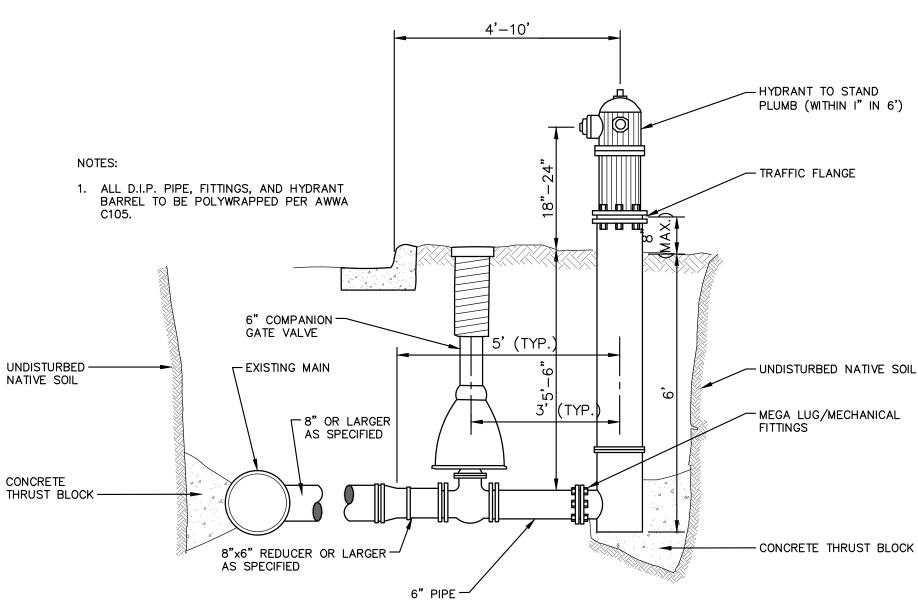


FIRE HYDRANT ASSEMBLY

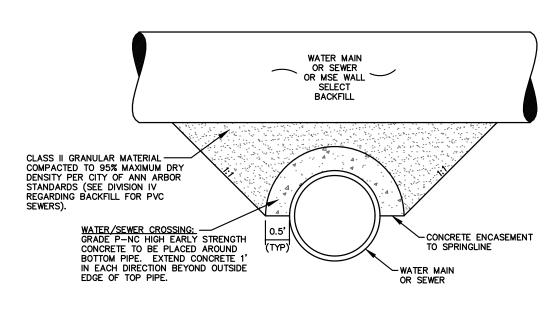


APPLIES TO: WATER AND/OR SEWER CROSSINGS WITH LESS THAN 1.5' OF VERTICAL CLEARANCE - SEE PLANS FOR LOCATIONS

CONCRETE UTILITY SADDLE

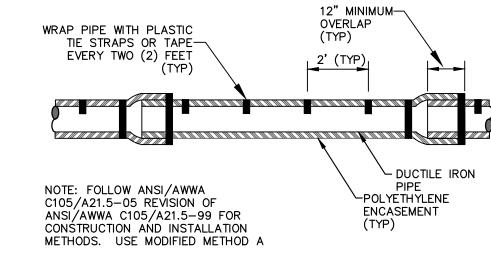

APPLIES TO: POLYETHYLENE WRAPPED D.I. WATERMAIN SEE PLANS FOR LOCATIONS

POLYETHYLENE ENCASEMENT (DRY INSTALLATION)

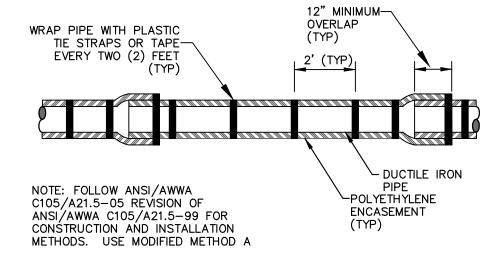

APPLIES TO: POLYETHYLENE WRAPPED D.I. WATERMAIN SEE PLANS FOR LOCATIONS


POLYETHYLENE ENCASEMENT (WET INSTALLATION)

CONCRETE, GRADE P-NC, TO BE PLACED TO UNDISTURBED

LEVELING-COURSE

STREET BASE

ROAD BASE.

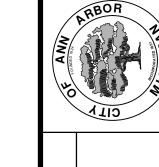

ANN A ANNOTO TO	VIIO

	OF ANN ARBOR	ECONSTRUCTION MAIN ST.	
— FINISH GRADE OF PROPOSED WEARING COURSE	ES - CITY O	STREET RE	

PROJECT MANAGEMENT

WATER VALVE BOX ADJUSTMENT

NOTE: RAISE CASTING TO PROPOSED FINISH STREET

GRADE AFTER PLACEMENT

OF LEVELING COURSE(S)

AND PRIOR TO PLACING


FINAL SURFACE COURSE

PLACE -

CONCRETE TO

UNDISTURBED ROAD BASE

-CONCRETE BRICK OR 2" PRE-CAST CONCRETE ADJUSTMENT RING SET IN MORTAR--MIN.(1)-MAX.(3) COURSES NOTE:
IF MANHOLE WILL BE PLACED IN GRAVEL ROAD, CASTING TO BE SET 6" TO 8" BELOW ROADWAY GRADE. ALL CONSTRUCTION METHODS SHALL REMAIN AS SHOWN ABOVE. MANHOLE CASTING ADJUSTMENT SD-GU-6

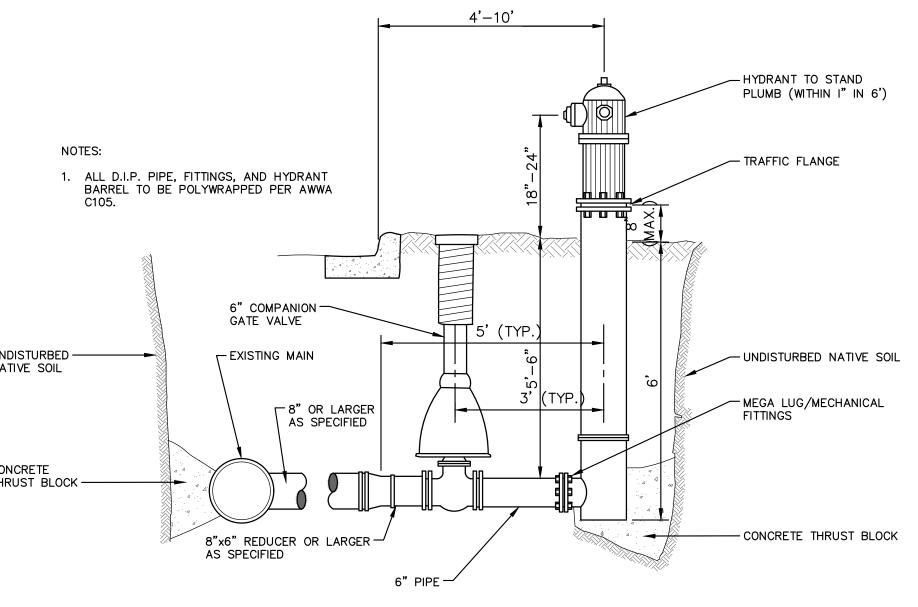

STRUCTURE PLATE SD-GU-8


1/4" MIN. THICKNESS AND SUFFICIENT TO CARRY THE CONSTRUCTION LOAD.

NOTE: PLATE MAY BE CIRCULAR, SQUARE OR RECTANGULAR


SECTION A - A

MIN. 6" LARGER THAN O.D. OF STRUCTURE


> SHEET No. 12 OF 63

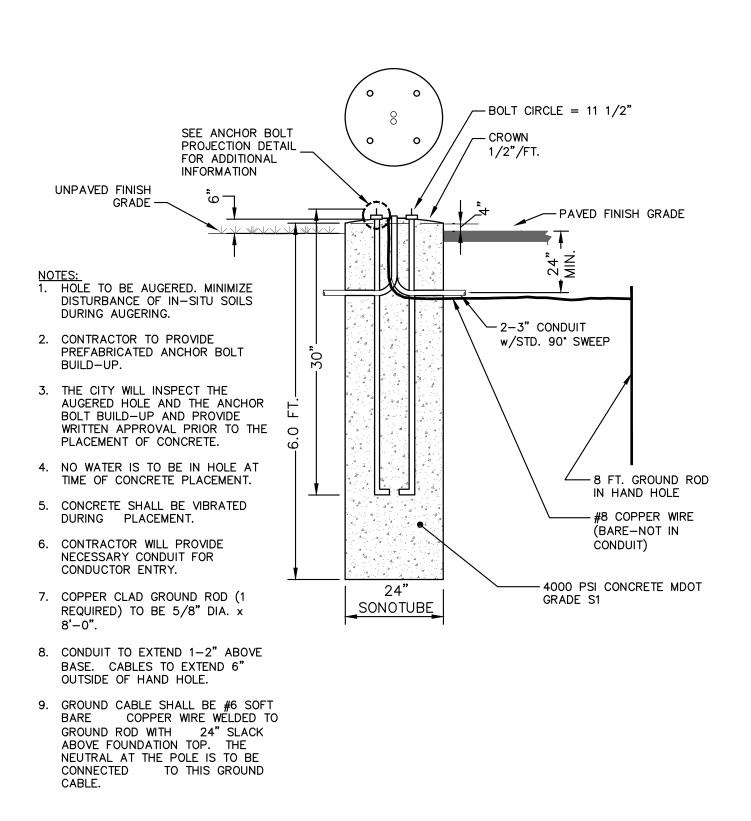


STREETLIGHT FOUNDATION SD-SL-1

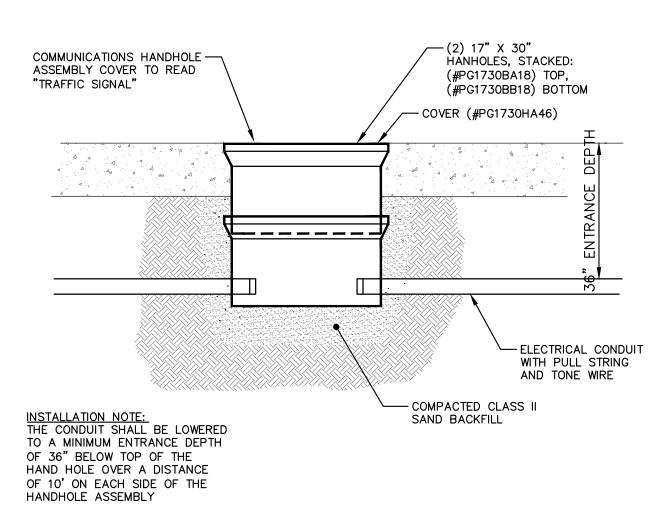


COMMUNICATIONS HANDHOLE ASSEMBLY

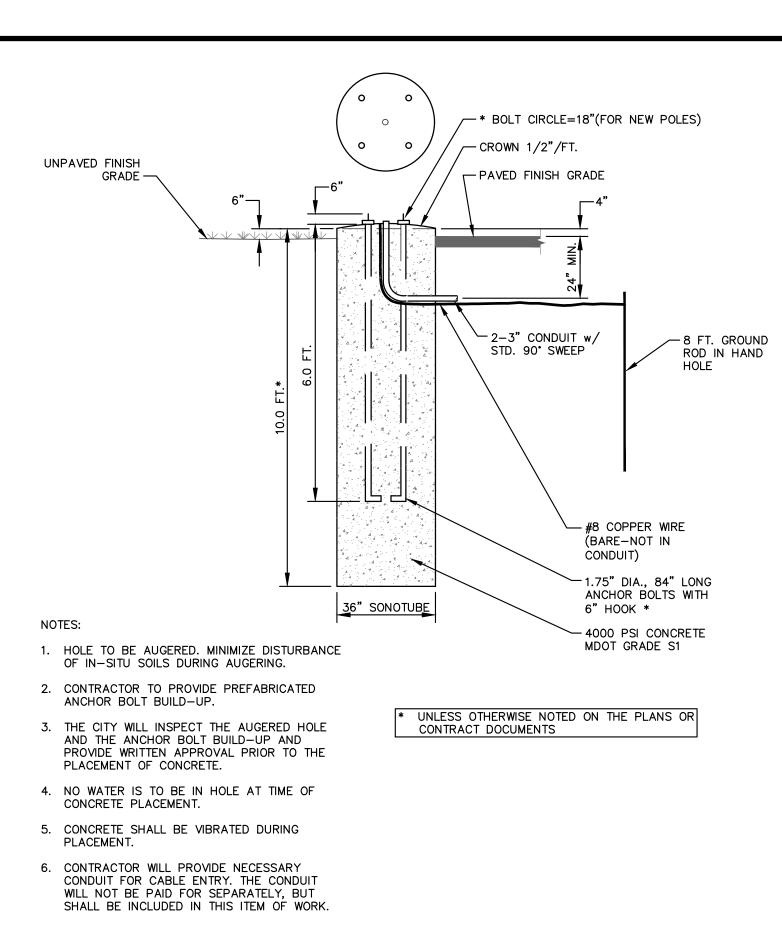


TRAFFIC SIGNAL POLE FOUNDATION SD-SL-2

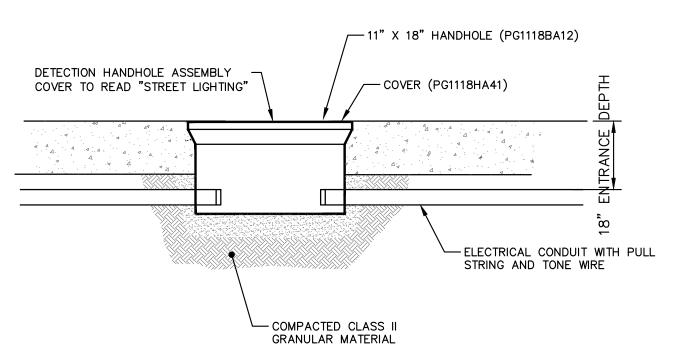

ELECTRICAL HANDHOLE ASSEMBLY

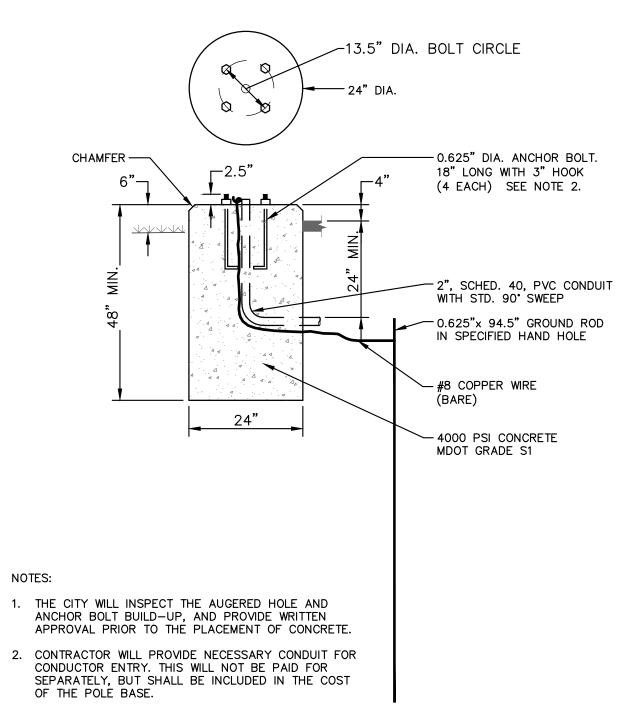


PEDESTRIAN SIGNAL POLE FOUNDATION SD-SL-3

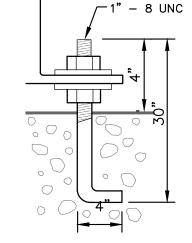

ALSO PROVIDE SHAKESPEARE OPAB-2035 ANCHOR BOLT KIT FOR EACH LIGHT POLE. ANCHOR BOLTS TO BE HOT-DIPPED GALVANIZED, 30" LONG, WITH 4" HOOK, AND A 4" PROJECTION ABOVE FOUNDATION.

ANCHOR BOLT PROJECTION DETAIL

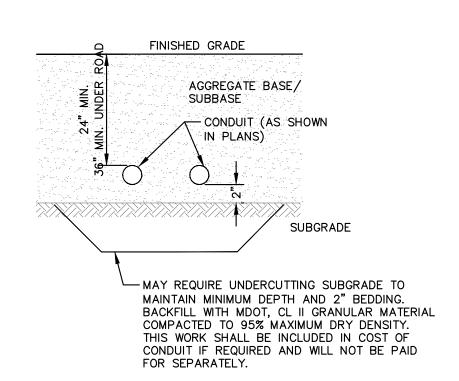

CONDUIT PLACEMENT DETAIL

ICES - CITY OF ANN ARBOR CONTACT CEC CEC CALL Before you dignown and arrow
--

EMENT - PUBLIC SERVICES - CITY OF ANN AR


WEST LIBERTY STREET RECONSTRU

S. FIRST ST. - N. MAIN ST.

PROJECT MANAGEMENT
CALE: N/A
TAWING No.



- 1. REFER TO SITE PLAN FOR PROJECT SPECIFIC TYPES & LIMITS OF SURFACE MATERIALS.
- 2. CROSS SLOPES IN AMENITIES ZONE SHALL NOT EXCEED 5% WITHOUT APPROVAL OF ENGINEER.

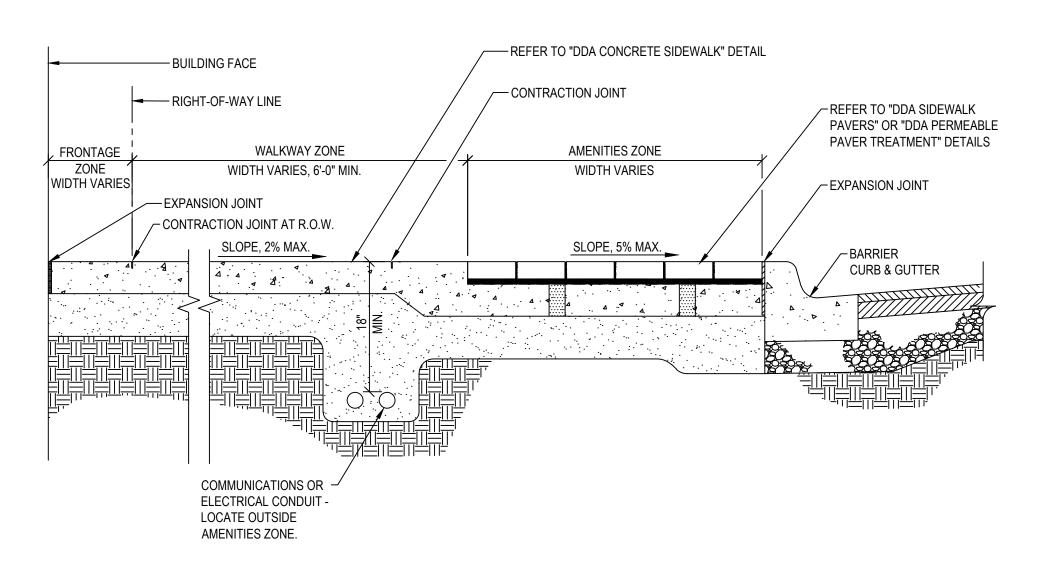


DDA SIDEWALK CROSS SECTION

SD-DDA-1A


NOTES

- 1. DRY LAID PAVERS MUST BE INSTALLED PER MANUFACTURER'S RECOMMENDATIONS
- A MOCK-UP OF PAVERS SHALL BE BUILT TO ESTABLISH THE ACTUAL WIDTH OF PAVER BAND TO AVOID SLIVERS OF PAVERS; APPROVAL BY DDA
- 3. ALL PAVERS SHALL BE RATED FOR HEAVY VEHICULAR TRAFFIC

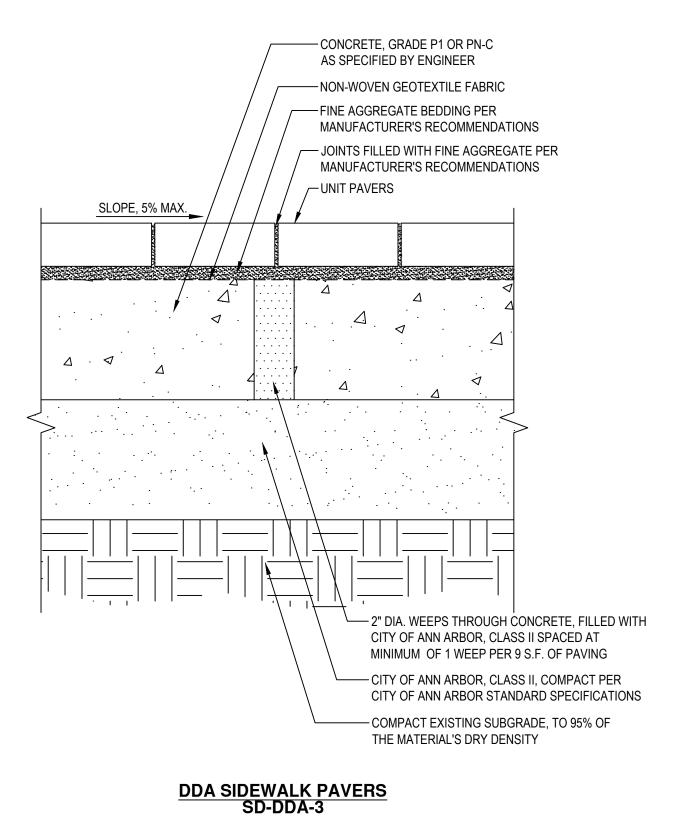

NOTES:


- DRY LAID PAVERS MUST BE INSTALLED PER MANUFACTURERS RECOMMENDATIONS
- 2. A MOCK-UP OF PAVERS SHALL BE BUILT TO ESTABLISH THE ACTUAL WIDTH OF PAVER BAND TO AVOID SLIVERS OF PAVERS; APPROVAL BY ENGINEER OR DDA, AS APPROPRIATE.
- 3. ALL PAVERS SHALL BE RATED FOR HEAVY VEHICULAR TRAFFIC

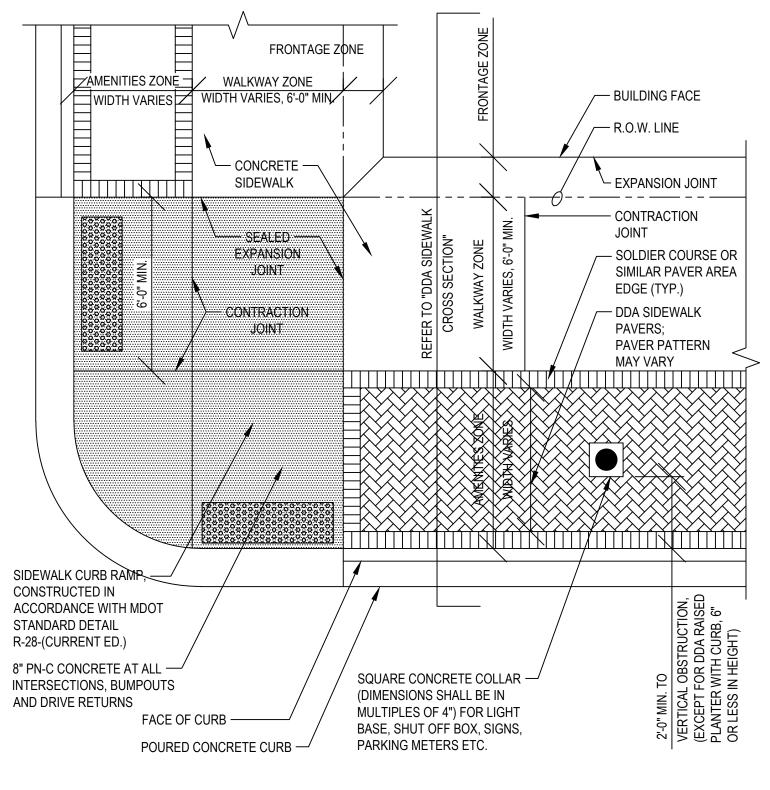


DDA SIDEWALK WITH UNIT PAVER IN AMENITY ZONE SD-DDA-1B

NOTES:


- 1. DRY LAID PAVERS MUST BE INSTALLED PER MANUFACTURER'S RECOMMENDATIONS
- 2. A MOCK-UP OF PAVERS SHALL BE BUILT TO ESTABLISH THE ACTUAL WIDTH OF PAVER BAND TO AVOID SLIVERS OF PAVERS; APPROVAL BY ENGINEER
- 3. ALL PAVERS SHALL BE RATED FOR HEAVY VEHICULAR TRAFFIC
- 4. DRAINAGE AGGREGATE LAYER MAY BE THICKER TO ACCOMMODATE ADDITIONAL STORM WATER STORAGE OR VEHICULAR DESIGN LOADS

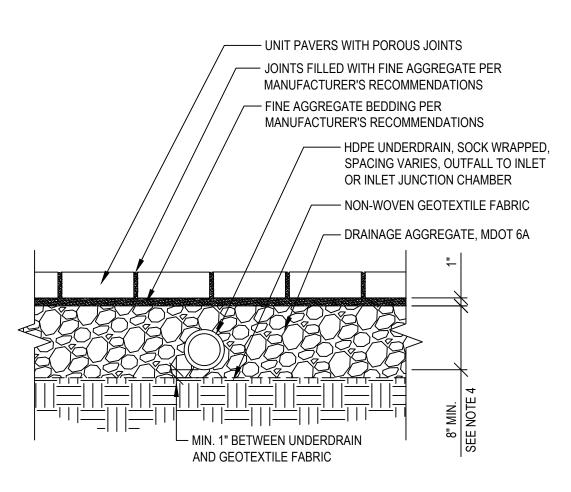

DDA PERMEABLE PAVER TREATMENT SD-DDA-4

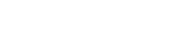

1. THIS DETAIL IS INTENDED AS A DESIGN GUIDELINE ONLY.

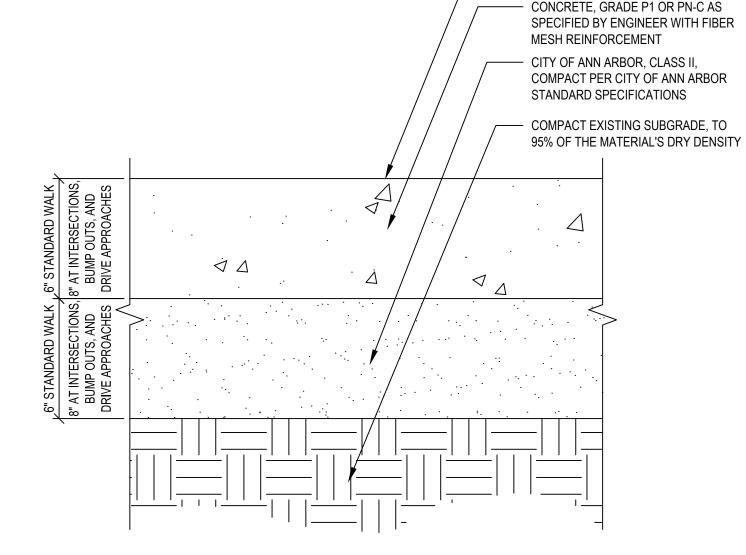

- LIGHT BROOM FINISH

NOTES:

- 1. CONTRACTOR TO CONSTRUCT ALL SIDEWALKS, SIDEWALK RAMPS, CURBS, AND ALL OTHER CONCRETE ITEMS WITHIN A.D.A.A.G. COMPLIANCE.
- 2. ALL SIDEWALK CURB RAMPS SHALL BE CONSTRUCTED IN ACCORDANCE WITH MDOT STANDARD DETAIL R-28-I.

DDA CONCRETE SIDEWALK SD-DDA-2

NOTES:

FINAL DESIGN TO BE DETERMINED BASED ON FIELD CONDITIONS AND APPROVED BY ENGINEER. TIES MAY BE REQUIRED -PER ENGINEER CONCRETE PAVEMENT EXISTING BUILDING FACE -REFER TO SITE PLAN -AND SUPPORT PER LIMIT FOR EDGE OF 1/3"JOINT FILLER AND SEALANT STRUCTURAL ENGINEER CONCRETE WORK ─ BUILDING — METAL DECKING/ SUPPORT AND WATERPROOFING AS - EXISTING VAULT -REQUIRED \ OR AREAWAY TO REMAIN - EXISTING VAULT WALL CITY OF ANN ARBOR, CLASS II -OR SUPPORT COMPACTED PER CITY OF UNDER WALK ANN ARBOR STANDARD SPECIFICATIONS COMPACTED BACKFILL OR -EXISTING SUBGRADE 4 MIL VAPOR BARRIER -WATERPROOF LINER EXTENDS TO 6" BELOW VAULT FLOOR

DDA PERMEABLE PAVER TREATMENT @ VAULTS OR AREAWAY SD-DDA-5

CEC Know what's below.
CAII before you dig.

ADD REVISION NAME HERE

DESCRIPTION

DESCRIPTION

DATE


DRAWN

CHECKED

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Km.

CITY OF ANN ARBOR PUBLIC SERVICES 301 EAST HURON STREET P.O. BOX 8647 ANN ARBOR, MI 48107-8647 734-794-6410 www.a2gov.org

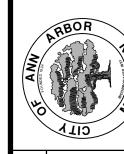


ENT - PUBLIC SERVICES - CITY OF ANN ARBOR
WEST LIBERTY STREET RECONSTRUCTION
S. FIRST ST. - N. MAIN ST.

3OJECT MANAGEMENT
:: N/A

NG No.

SHEET No.

14 OF 63

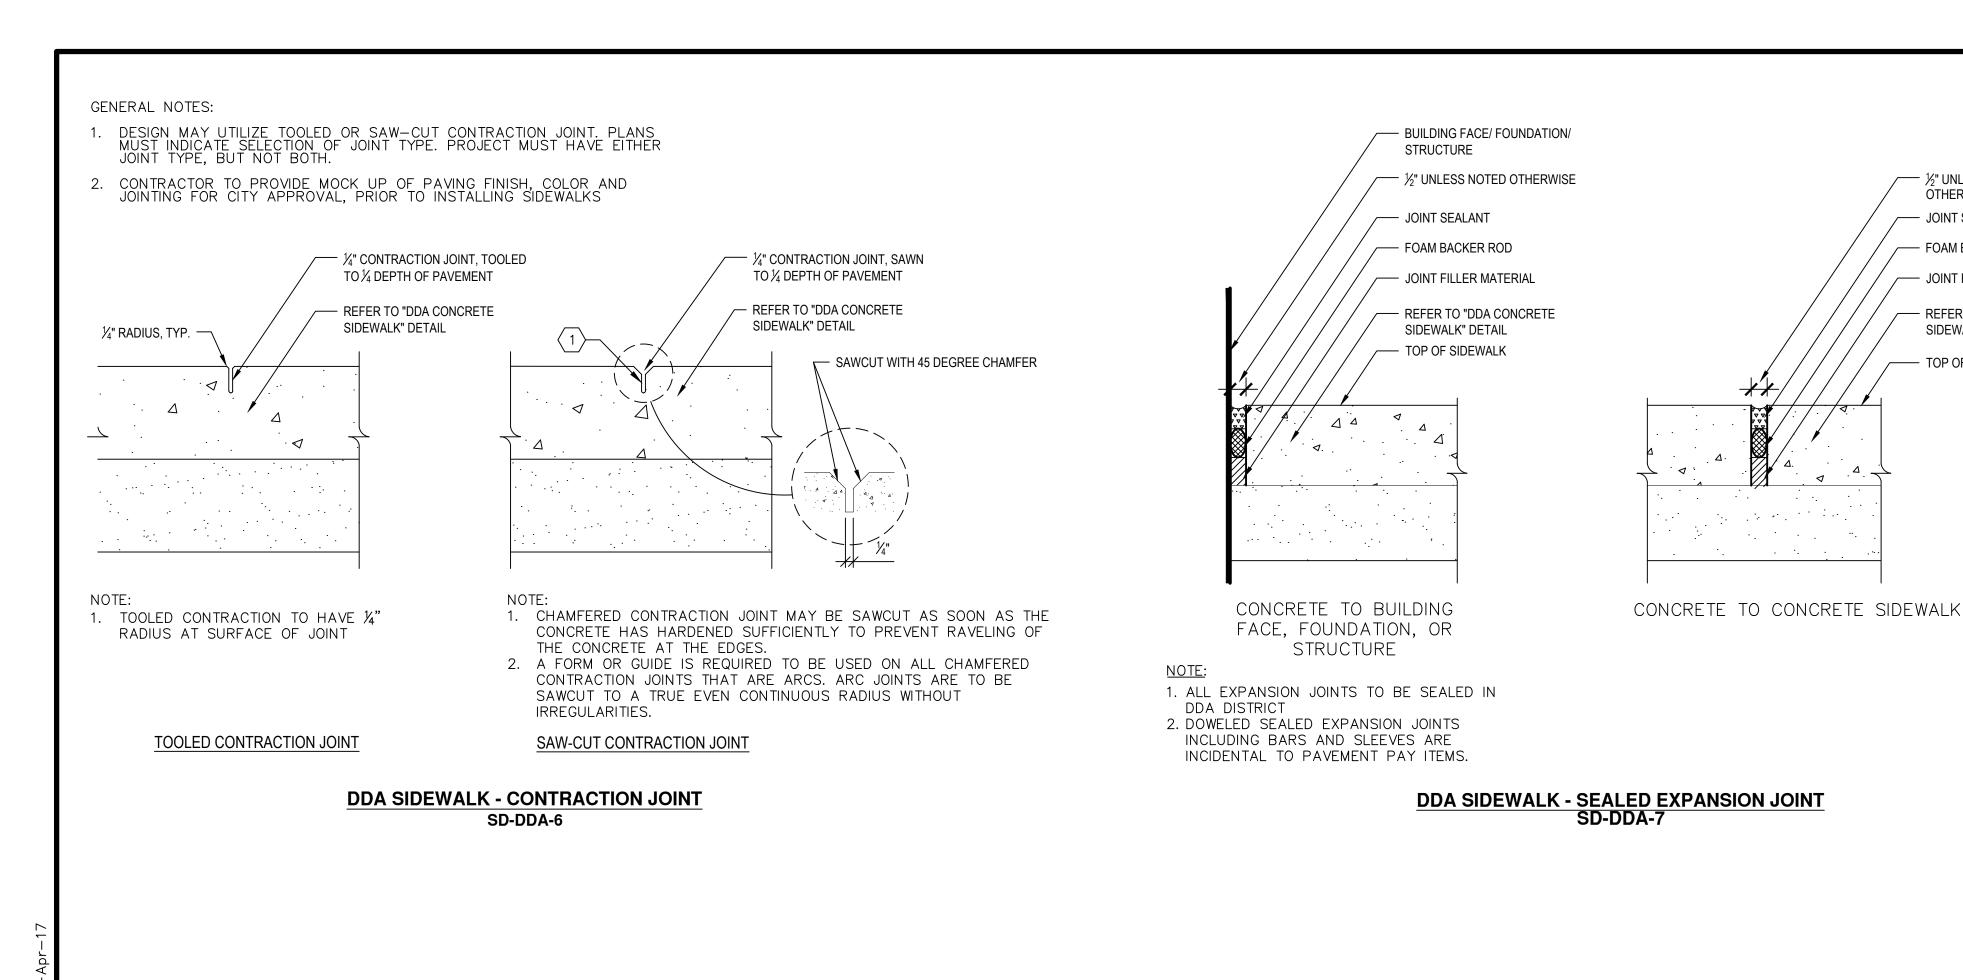

BICYCLE HOOP:

SET PLUMB.

WITH WASHER

SIDEWALK" DETAIL

SURFACE MOUNT UNIT -

½"x 4" STAINLESS STEEL

REFER TO "DDA CONCRETE


3 ½"x 36"x ¾" STAINLESS (OR

GALVANIZED POWDER COATED) PLATE

TAMPER PROOF ANCHOR BOLT

STAINLESS STEEL (OR GALVANIZED

AND POWDER COATED) PIPE 2" O.D.

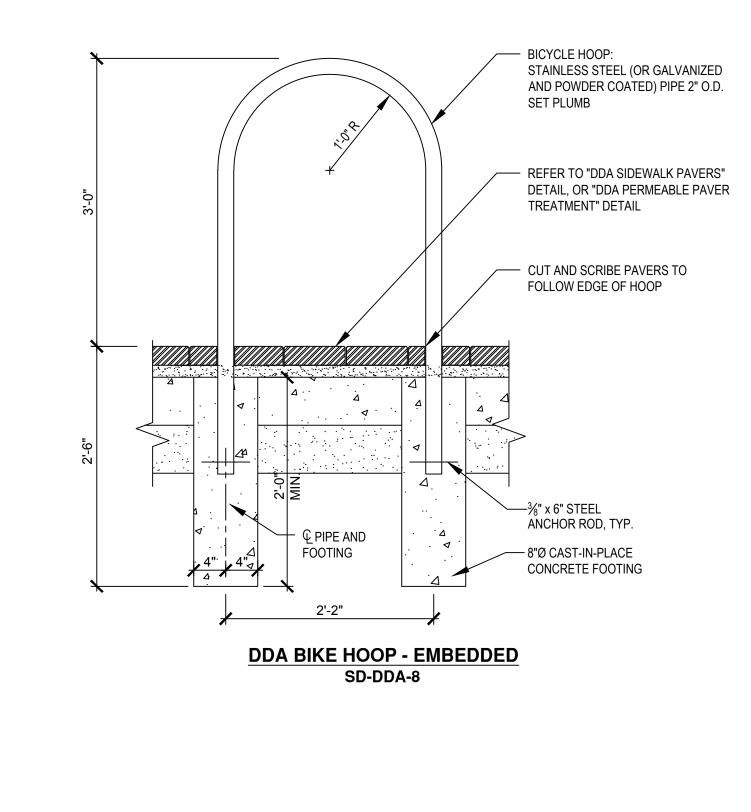

BICYCLE HOOP NOTES:

1/3" UNLESS NOTED

OTHERWISE

- JOINT SEALANT

— FOAM BACKER ROD

— JOINT FILLER MATERIAL

SIDEWALK" DETAIL

TOP OF SIDEWALK

REFER TO "DDA CONCRETE

PAVER TREATMENTS

ADDITIONAL LAYOUT GUIDELINES.


TO BE USED ONLY FOR DDA SIDEWALK PAVERS OR DDA PERMEABLE


3. BIKE HOOPS TO BE A MINIMUM OF 2'-10" FROM BACK OF CURB WHEN


4. REFER TO ANN ARBOR DOWNTOWN STREET DESIGN MANUAL FOR

2. LOCATE AND GROUP BICYCLE HOOPS IN THE AMENITY ZONE.

PERPENDICULAR TO CURB, AND 2'-0" WHEN PARALLEL.

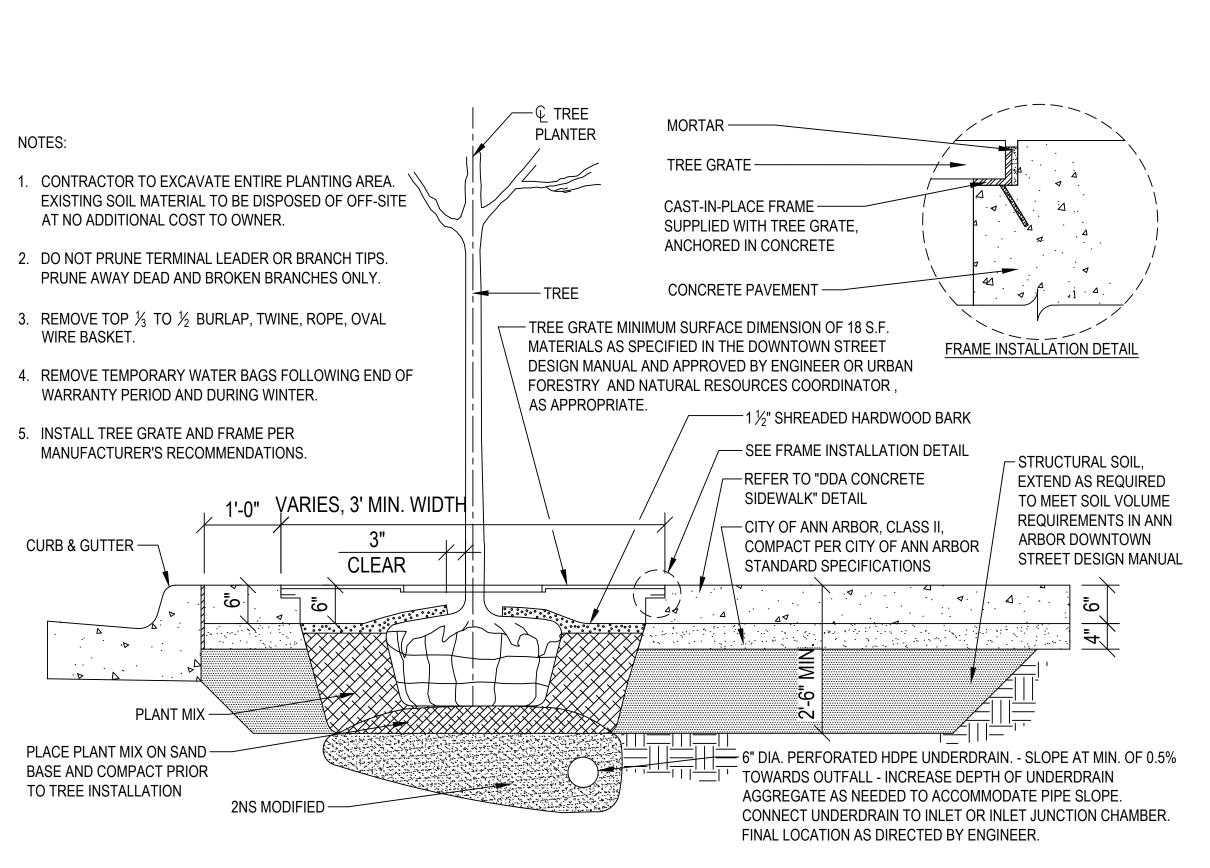

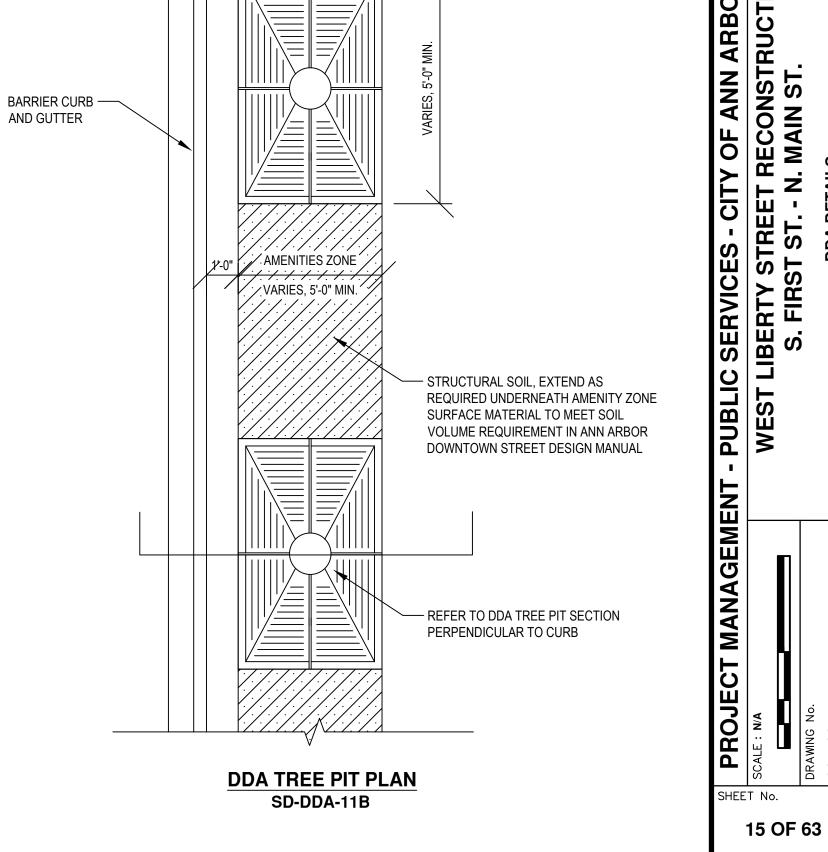

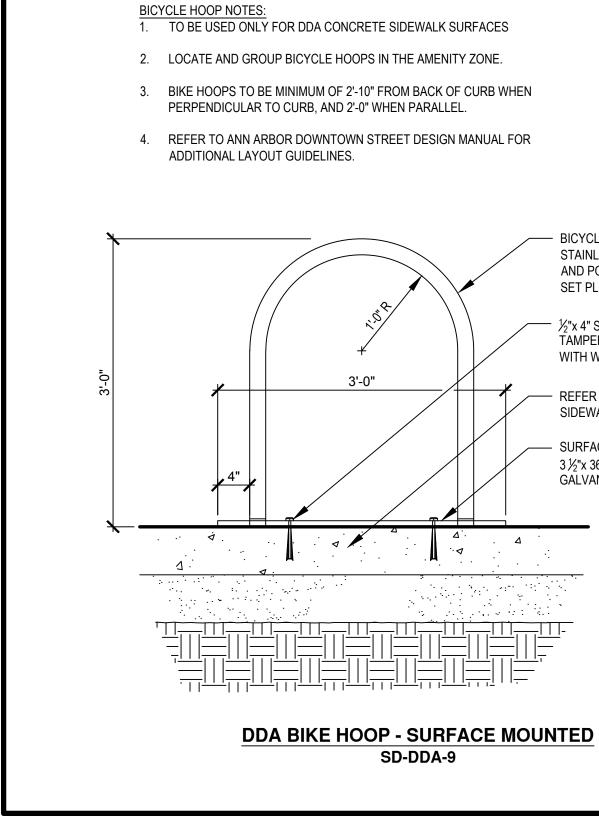

3'-0"

SD-DDA-9

DDA TREE PIT SECTION PERPENDICULAR TO CURB SD-DDA-11A

OTHER SIDE OF STREET DETOUR (FOR MID-BLOCK CLOSURE)

W11-2 30"x30" W16-7PL 24"x12" R9-11AR 24"x12" (3) ENDS OCT 20XX CONTACT 734-XXX-XXXX W11-2 30"x30" W16-7PL 24"x12" SIDEWALK CLOSED AHEAD SIDEWALK CLOSED SIDEWALK CLOSED CROSS HERE CROSS HERE CROSS HERE 24"x12" 24"x12" 24"x12" ENDS OCT 20XX CONTACT 734-XXX-XXXX ENDS OCT 20XX CONTACT 734-XXX-XXXX ENDS OCT 20XX CONTACT 734-XXX-XXXX SIDEWALK CLOSED R9-9 24"x12" M4−9BL 30"x24" CROSS HERE (3) ENDS OCT 20XX CONTACT 734-XXX-XXXX

OTHER SIDE OF STREET DETOUR OR DETOUR WITH TRAILBLAZING SIGNS (FOR CORNER SIDEWALK CLOSURE WITH OPTIONAL TEMPORARY CROSSWALK)

GENERAL NOTES

WHEN CLOSING OR RELOCATING CROSSWALKS OR SIDEWALKS, PROVIDE DETECTABLE TEMPORARY FACILITIES AND INCLUDE ACCESSIBILITY FEATURES CONSISTENT WITH EXISTING PEDESTRIAN FACILITIES.

TEMPORARY TRAFFIC CONTROL DEVICES FOR PEDESTRIANS ARE SHOWN. OTHER DEVICES MAY BE NECESSARY TO CONTROL VEHICULAR TRAFFIC. STAGE WORK, AS NECESSARY, TO PROVIDE AN ALTERNATE PEDESTRIAN ROUTE (APR) AT ALL TIMES. FOR ROADWAYS WITH NO AVAILABLE DETOURS, MAINTAIN ONE OPEN SIDEWALK AT ALL TIMES.

PROVIDE A SMOOTH, CONTINUOUS, HARD SURFACE THROUGH THE LENGTH OF THE APR. PROVIDE A FIRM, STABLE, AND SLIP RESISTANT TEMPORARY WALKWAY SURFACE TO COVER SHORT SEGMENTS OF ROUGH, SOFT, OR UNEVEN GROUND.

THE PEDESTRIAN TRAFFIC SIGNALS CONTROLLING CLOSED CROSSWALKS SHALL BE COVERED OR DEACTIVATED.

POST MOUNTED SIGNS LOCATED ADJACENT TO A SIDEWALK SHALL HAVE A 7 FOOT MINIMUM CLEARANCE FROM THE BOTTOM OF THE SIGN TO THE SIDEWALK SURFACE.

WHEN A SIGN OR BARRICADE IS ORIENTED SUCH THAT VISIBILITY TO TRAFFIC (BIKES, PEDESTRIANS) IS REDUCED ENOUGH TO CAUSE HAZARD, DELINEATE THE SIGN/BARRICADE WITH APPROPRIATE DEVICES.

MINIMIZE DISRUPTION TO PEDESTRIANS TO THE MAXIMUM EXTENT FEASIBLE BY PROVIDING AN APR IN THE FOLLOWING ORDER OF PREFERENCE:

- 1. PROVIDE THE APR ON THE SAME SIDE OF THE STREET AS THE DISRUPTED ROUTE UTILIZING BYPASSES.
- 2. WHERE IT IS NOT FEASIBLE TO PROVIDE A SAME SIDE APR, PROVIDE A DETOUR ON THE OTHER SIDE OF THE STREET.
- 3. WHERE IT IS NOT FEASIBLE TO PROVIDE AN APR ON THE OTHER SIDE OF THE ROADWAY, PROVIDE AN APR DETOUR WITH TRAILBLAZING SIGNS.


SPECIFIC NOTES

- 1) TEMPORARY CURB RAMPS WITH DETECTABLE WARNINGS.
- (2) TEMPORARY PAVEMENT MARKING FOR CROSSWALK LINES.
- 3 TYPICAL SIGN MESSAGE FOR A TEMPORARY PEDESTRIAN DETOUR SHOULD INCLUDE INFORMATION SUCH AS THE DURATION OF THE WALKWAY RESTRICTIONS (BEGINNING AND/OR END DATES) AND A PROJECT CONTACT NUMBER FOR 24 / 7 QUESTIONS OR REPORTING HAZARDS.
- 4) PEDESTRIAN DETOUR TRAILBLAZING SIGNS SHOULD BE USED IF THE PEDESTRIAN DETOUR IS LOCATED SOMEPLACE OTHER THAN ACROSS THE STREET FROM THE SIDEWALK CLOSURE.

PEDESTRIAN TEMPORARY TRAFFIC CONTROL NOTES

CROSS HERE

- 1. THE CONTRACTOR SHALL MAINTAIN PEDESTRIAN THROUGH MOVEMENTS FROM ONE END OF THE CONSTRUCTION AREA TO THE OTHER, ON AT LEAST ONE SIDE OF THE STREET DURING CONSTRUCTION. ANY SIDEWALK CLOSURES SHALL MEET THE REQUIREMENTS OF THE MMUTCD, PART 6.
- 2. PEDESTRIAN ACCESS SHALL BE PROVIDED TO ALL ADJACENT PROPERTIES, BUILDINGS, RESIDENCES AND COMMERCIAL PROPERTIES AT ALL TIMES. THIS MAY INCLUDE TEMPORARY WALKWAYS SPANNING THE CONSTRUCTION AREA.
- 3. IF SIDEWALKS ARE CLOSED, A TEMPORARY PEDESTRIAN ACCESS ROUTE (TPAR) SHALL BE PROVIDED ON THE SAME SIDE OF THE ROAD AS THE CLOSED SIDEWALK, IF POSSIBLE. SIGNS AND BARRICADES SHALL BE USED TO PROVIDE ADVANCE NOTICE OF THE CLOSURE AND THE ROUTE OF ANY PEDESTRIAN DETOURS. THE TPAR SHALL HAVE A MINIMUM UNOBSTRUCTED WIDTH OF 4 FEET. IF THE TPAR IS LESS THAN 5 FEET IN WIDTH, A 5 FOOT BY 5 FOOT PASSING SPACE SHOULD BE PROVIDED AT LEAST EVERY 200 FEET. THE SURFACE OF THE TPAR SHALL BE SMOOTH AND CONTINUOUS FOR THE LENGTH OF THE TPAR. THE TPAR SHALL MAINTAIN THE SAME LEVEL OF ACCESSIBILITY AND DETECTABILITY AS THE FACILITY THAT IS BEING CLOSED. THE TPAR SHALL NOT LEAD PEDESTRIANS INTO CONFLICTS WITH VEHICLES, EQUIPMENT, OR CONSTRUCTION OPERATIONS.
- 4. IF THE TPAR IS ADJACENT TO MOVING TRAFFIC, CONSTRUCTION OPERATIONS/EQUIPMENT, OR DROP-OFFS, THEN CRASH WORTHY CHANNELIZING DEVICES THAT MEET THE REQUIREMENTS OF THE MMUTCD SHALL BE USED.
- 5. THE CONTRACTOR SHALL NOT STORE OR PLACE ANY CONSTRUCTION MATERIALS, EQUIPMENT OR SIGNS IN THE PEDESTRIAN PATH OF TRAVEL.
- 6. THE CONTRACTOR'S OPERATIONS SHALL NOT OCCUPY SIDEWALKS EXCEPT WHERE PROPER PROTECTION AND A TPAR HAVE BEEN PROVIDED.
- 7. THE CONTRACTOR SHALL PROVIDE A TEMPORARY PEDESTRIAN TRAFFIC CONTROL PLAN FOR REVIEW AND WRITTEN APPROVAL BY THE ENGINEER A MINIMUM OF THREE WEEKS BEFORE SUCH PLAN IS IMPLEMENTED. THIS PLAN SHALL DETAIL THE CONSTRUCTION PHASING AND SCHEDULE AND THE SPECIFIC METHODS OF MAINTAINING SAFE PEDESTRIAN ACCESS THROUGHOUT THE CONSTRUCTION AREA. THIS PLAN SHALL PROVIDE THE LOCATION AND DETAILS OF TEMPORARY CONSTRUCTION SIGNING, MARKINGS, BARRICADES, CHANNELIZING DEVICES, TPARS AND METHODS TO MAINTAIN ACCESS TO ADJACENT PROPERTIES, BUSINESSES, RESIDENCES, ETC.
- 8. PROVISION OF THE TPAR AND ALL OF ITS ELEMENTS, INCLUDING BUT NOT LIMITED TO SIGNS, CHANNELIZING DEVICES, BARRICADES, TEMPORARY PAVEMENT MARKINGS AND OTHER TRAFFIC CONTROL DEVICES IS TO BE PAID FOR INCIDENTAL TO TRAFFIC CONTROL.

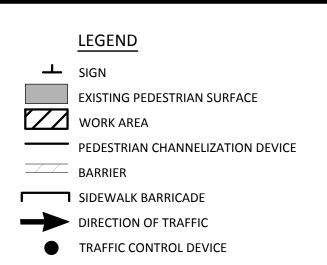

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S - CIT TREET PUBLIC SEHVI.
WEST LIBERTY STI
S. FIRST S


MANAGEM

BYPASS ON ADJACENT AVAILABLE

RIGHT OF WAY


BYPASS TYPE A

NOTE: MAY ONLY BE USED ON ROADWAY WITH POSTED SPEED OF 45 MPH OR LESS.

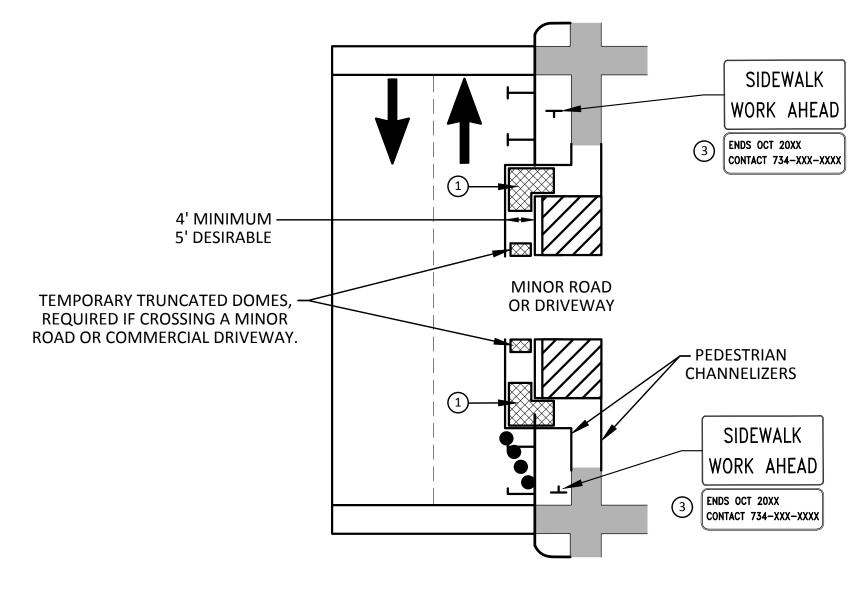

SIDEWALK BYPASS USING PARKING OR SHOULDER ON LOW SPEED ROADWAY

BYPASS TYPE B

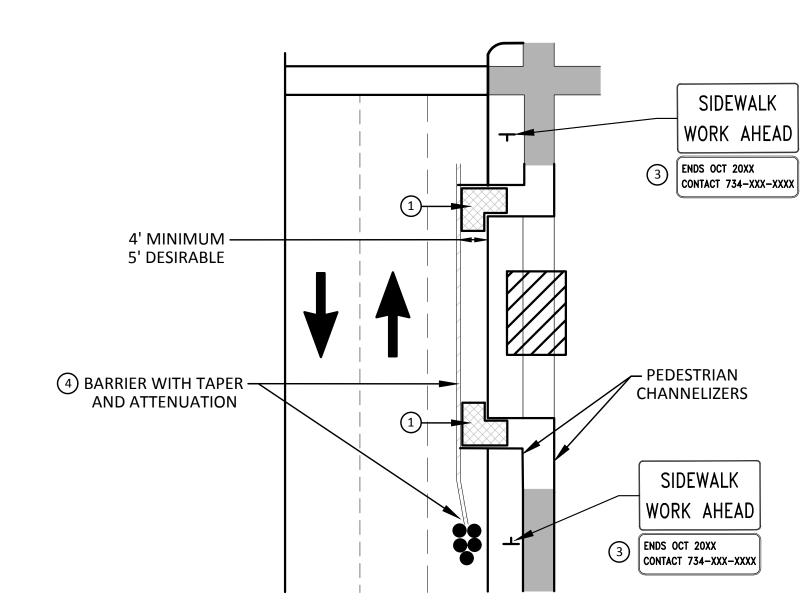

SIDEWALK BYPASS USING
SHOULDER ON OR PARKING LANE
HIGH SPEED ROADWAY

BYPASS TYPE C

GENERAL NOTES

WHEN CLOSING OR RELOCATING CROSSWALKS OR SIDEWALKS, PROVIDE DETECTABLE TEMPORARY FACILITIES AND INCLUDE ACCESSIBILITY FEATURES CONSISTENT WITH EXISTING PEDESTRIAN FACILITIES.

TEMPORARY TRAFFIC CONTROL DEVICES FOR PEDESTRIANS ARE SHOWN. OTHER DEVICES MAY BE NECESSARY TO CONTROL VEHICULAR TRAFFIC. STAGE WORK, AS NECESSARY, TO PROVIDE AN ALTERNATE PEDESTRIAN ROUTE (APR) AT ALL TIMES. FOR ROADWAYS WITH NO AVAILABLE DETOURS, MAINTAIN ONE OPEN SIDEWALK AT ALL TIMES.

PROVIDE A SMOOTH, CONTINUOUS, HARD SURFACE THROUGH THE LENGTH OF THE APR. PROVIDE A FIRM, STABLE, AND SLIP RESISTANT TEMPORARY WALKWAY SURFACE TO COVER SHORT SEGMENTS OF ROUGH, SOFT, OR UNEVEN GROUND.

THE PEDESTRIAN TRAFFIC SIGNALS CONTROLLING CLOSED CROSSWALKS SHALL BE COVERED OR DEACTIVATED.

POST MOUNTED SIGNS LOCATED ADJACENT TO A SIDEWALK SHALL HAVE A 7 FOOT MINIMUM CLEARANCE FROM THE BOTTOM OF THE SIGN TO THE SIDEWALK SURFACE.

WHEN A SIGN OR BARRICADE IS ORIENTED SUCH THAT VISIBILITY TO TRAFFIC (BIKES, PEDESTRIANS) IS REDUCED ENOUGH TO CAUSE HAZARD, DELINEATE THE SIGN/BARRICADE WITH APPROPRIATE DEVICES.

MINIMIZE DISRUPTION TO PEDESTRIANS TO THE MAXIMUM EXTENT FEASIBLE BY PROVIDING AN APR IN THE FOLLOWING ORDER OF PREFERENCE:

- PROVIDE THE APR ON THE SAME SIDE OF THE STREET AS THE DISRUPTED ROUTE UTILIZING BYPASSES.
- 2. WHERE IT IS NOT FEASIBLE TO PROVIDE A SAME SIDE APR, PROVIDE A DETOUR ON THE OTHER SIDE OF THE STREET.
- 3. WHERE IT IS NOT FEASIBLE TO PROVIDE AN APR ON THE OTHER SIDE OF THE ROADWAY, PROVIDE AN APR DETOUR WITH TRAILBLAZING SIGNS.

SPECIFIC NOTES

- (1) TEMPORARY CURB RAMPS WITH DETECTABLE WARNINGS.
- 5 DEVICE TAPER 25 FEET LONG, RECOMMENDED WHEN THE CLOSED AREA WAS USED AS AN INTERMITTENT TRAFFIC LANE OR BYPASS LANE. STREET PARKING SHALL BE PROHIBITED FOR AT LEAST 50 FEET IN ADVANCE OF THE MID-BLOCK CROSSWALK.
- 3 TYPICAL SIGN MESSAGE FOR A TEMPORARY PEDESTRIAN DETOUR SHOULD INCLUDE INFORMATION SUCH AS THE DURATION OF THE WALKWAY RESTRICTIONS (BEGINNING AND/OR END DATES) AND A PROJECT CONTACT NUMBER FOR 24 / 7 QUESTIONS OR REPORTING HAZARDS.
- (4) SEE MMUTCD FOR GUIDANCE ON PLACEMENT AND USAGE OF BARRIER.

LEGEND

→ SIGN

EXISTING PEDESTRIAN SURFACE
WORK AREA

PEDESTRIAN CHANNELIZATION DEVICE

PEDESTRIAN CHANNELIZATION DEVICE

BARRIER

SIDEWALK BARRICADE

DIRECTION OF TRAFFIC

TRAFFIC CONTROL DEVICE

ES - CITY OF ANN ARBO STREET RECONSTRUCTI T ST. - N. MAIN ST. PUBLIC SEHVIL WEST LIBERTY STE S. FIRST S PROJECT MANAGEMENT




PROJECT MANAGEMENT - PUBLIC SERVICES - CITY OF ANN ARBC


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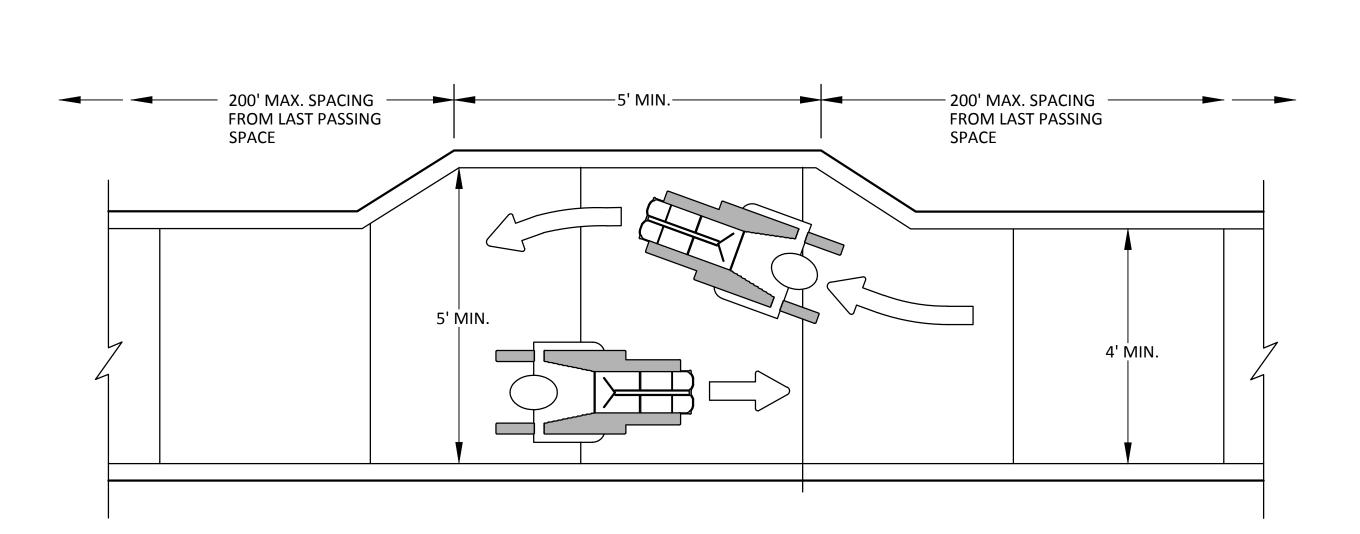
WEST LIBERTY STREET RECONSTRUCT

S. FIRST ST. - N. MAIN ST.


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NARROW TEMPORARY PEDESTRIAN ACCESS ROUTE PASSING DETAIL

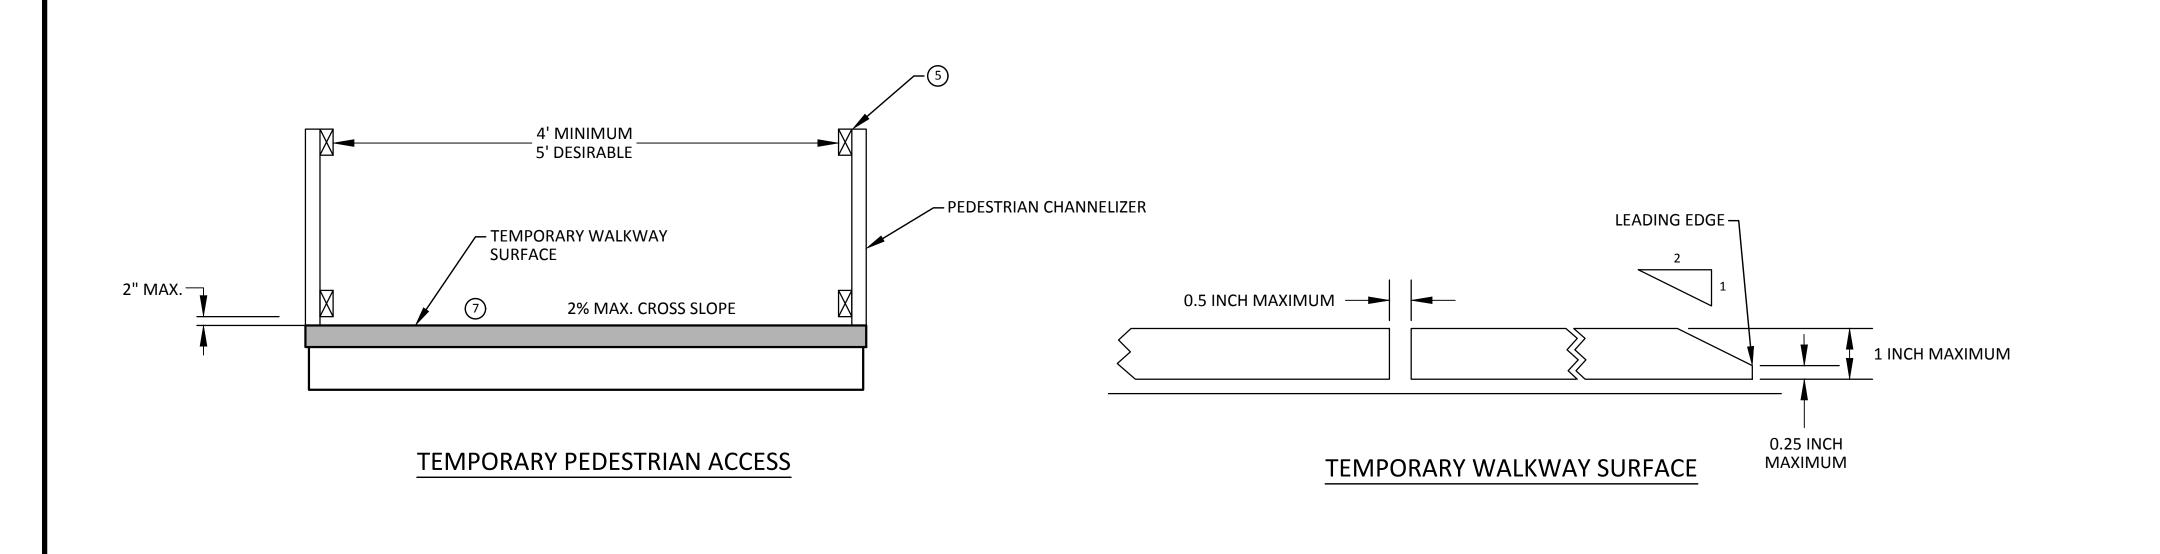

32" MIN. (8)

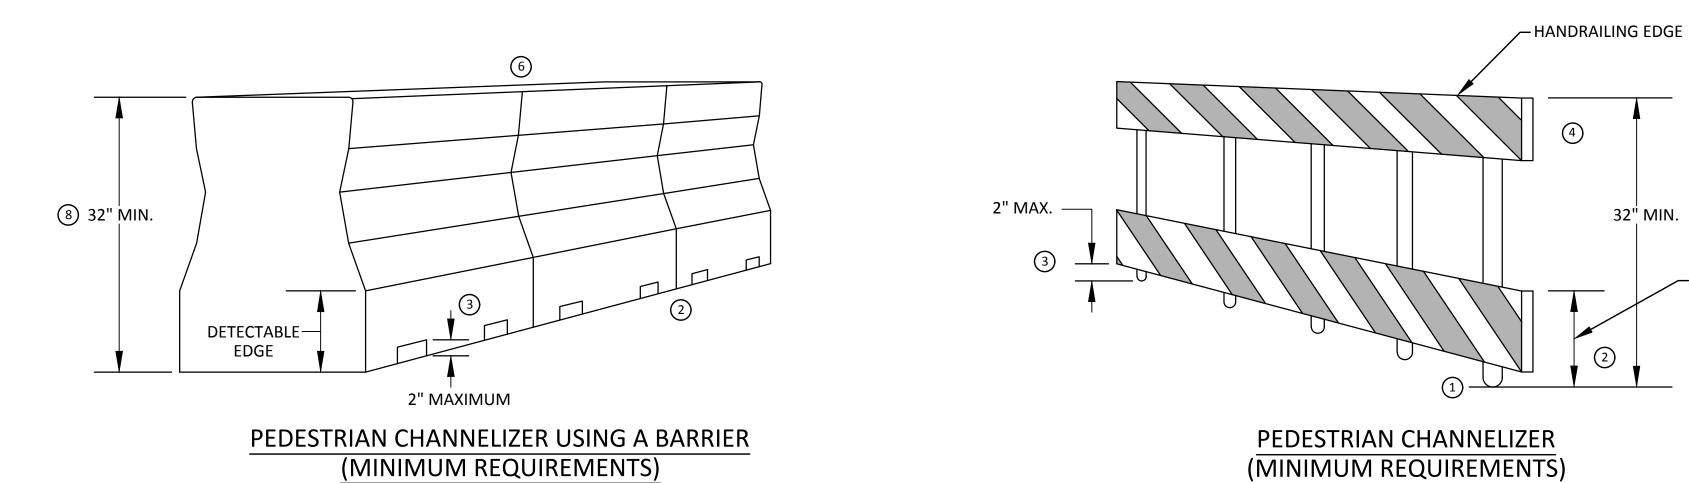— DETECTABLE EDGE SHALL BE CONTINUOUS AND A MINIMUM OF 6 INCHES HIGH ABOVE THE

WALKWAY SURFACE

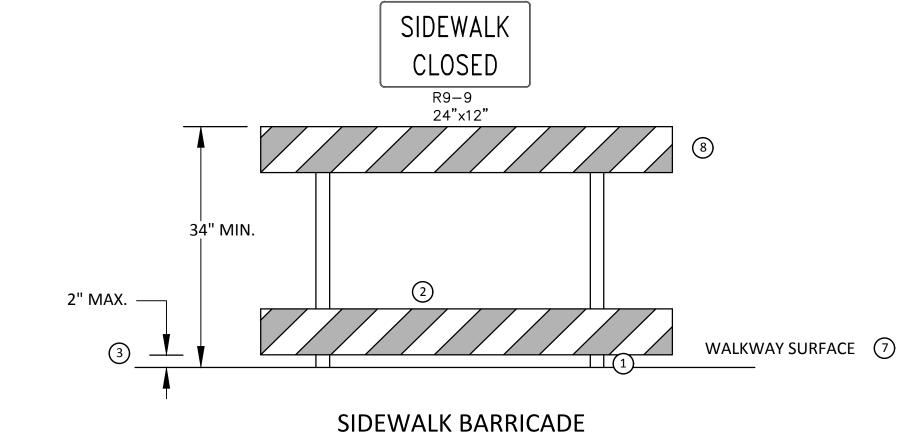GENERAL NOTES

RAILINGS OR OTHER OBJECTS MAY PROTRUDE A MAXIMUM OF 4 INCHES INTO THE WALKWAY CLEAR SPACE WHEN LOCATED A MINIMUM OF 27 INCHES ABOVE THE WALKWAY SURFACE.

ANY PEDESTRIAN DEVICES USED TO PROVIDE POSITIVE PROTECTION FOR PEDESTRIANS OR WORKERS SHALL MEET CRASHWORTHY REQUIREMENTS APPROPRIATE FOR THE BARRIERS APPLICATION.

BARRICADES SHALL BE PLACED ACROSS THE ENTIRE WIDTH OF THE WALKWAY SURFACE.

SPECIFIC NOTES


- (1) ANY TRIPPING HAZARD IN THE WALKWAY NEEDS A DETECTABLE EDGE. BALLAST SHALL BE LOCATED BEHIND OR INTERNAL TO THE DEVICE. ANY SUPPORT ON THE FRONT OF THE DEVICE SHALL NOT EXTEND INTO THE 48 INCH MINIMUM WALKWAY CLEAR SPACE AND SHALL NOT EXCEED 0.5 INCHES IN HEIGHT ABOVE THE WALKWAY SURFACE.
- 2 DETECTABLE EDGES SHALL BE CONTINUOUS AND 6 INCHES MIN. HIGH ABOVE WALKWAY SURFACE AND HAVE COLOR MARKINGS CONTRASTING WITH THE WALKWAY SURFACE.
- 3 DEVICES SHALL NOT BLOCK WATER DRAINAGE FROM THE WALKWAY. A GAP HEIGHT OR OPENING FROM THE WALKWAY SURFACE UP TO A MAXIMUM OF 2 INCHES IS ALLOWED FOR DRAINAGE
- 4 WHEN HAND GUIDANCE IS REQUIRED, THE TOP RAIL OR TOP SURFACE SHALL: - BE IN A VERTICAL PLANE PERPENDICULAR TO THE WALKWAY ABOVE THE DETECTABLE EDGE. - BE CONTINUOUS AT A HEIGHT OF 34 TO 38 INCHES ABOVE THE WALKWAY SURFACE, AND
- (5) ALL DEVICES SHALL BE FREE OF SHARP OR ROUGH EDGES, AND FASTENERS (BOLTS) SHALL BE ROUNDED TO PREVENT HARM TO HANDS, ARMS OR CLOTHING OF PEDESTRIANS.
- (6) ALL DEVICES USED TO CHANNELIZE PEDESTRIAN FLOW SHOULD INTERLOCK SUCH THAT GAPS DO NOT ALLOW PEDESTRIANS TO STRAY FROM THE CHANNELIZED PATH.


- BE SUPPORTED WITH MINIMAL INTERFERENCE TO THE PEDESTRIAN'S HANDS OR FINGERS.


- 7) A WALKWAY SURFACE SHALL BE FIRM, STABLE, AND SLIP RESISTANT.
- (8) LONGITUDINAL CHANNELIZING DEVICES FOR PEDESTRIANS SHALL BE 32 INCHES HIGH OR GREATER.

PUBLIC SERVICES - CITY OF ANN ARBC WEST LIBERTY STREET RECONSTRUCT S. FIRST ST. - N. MAIN ST.

PROJECT MANAGEMENT -

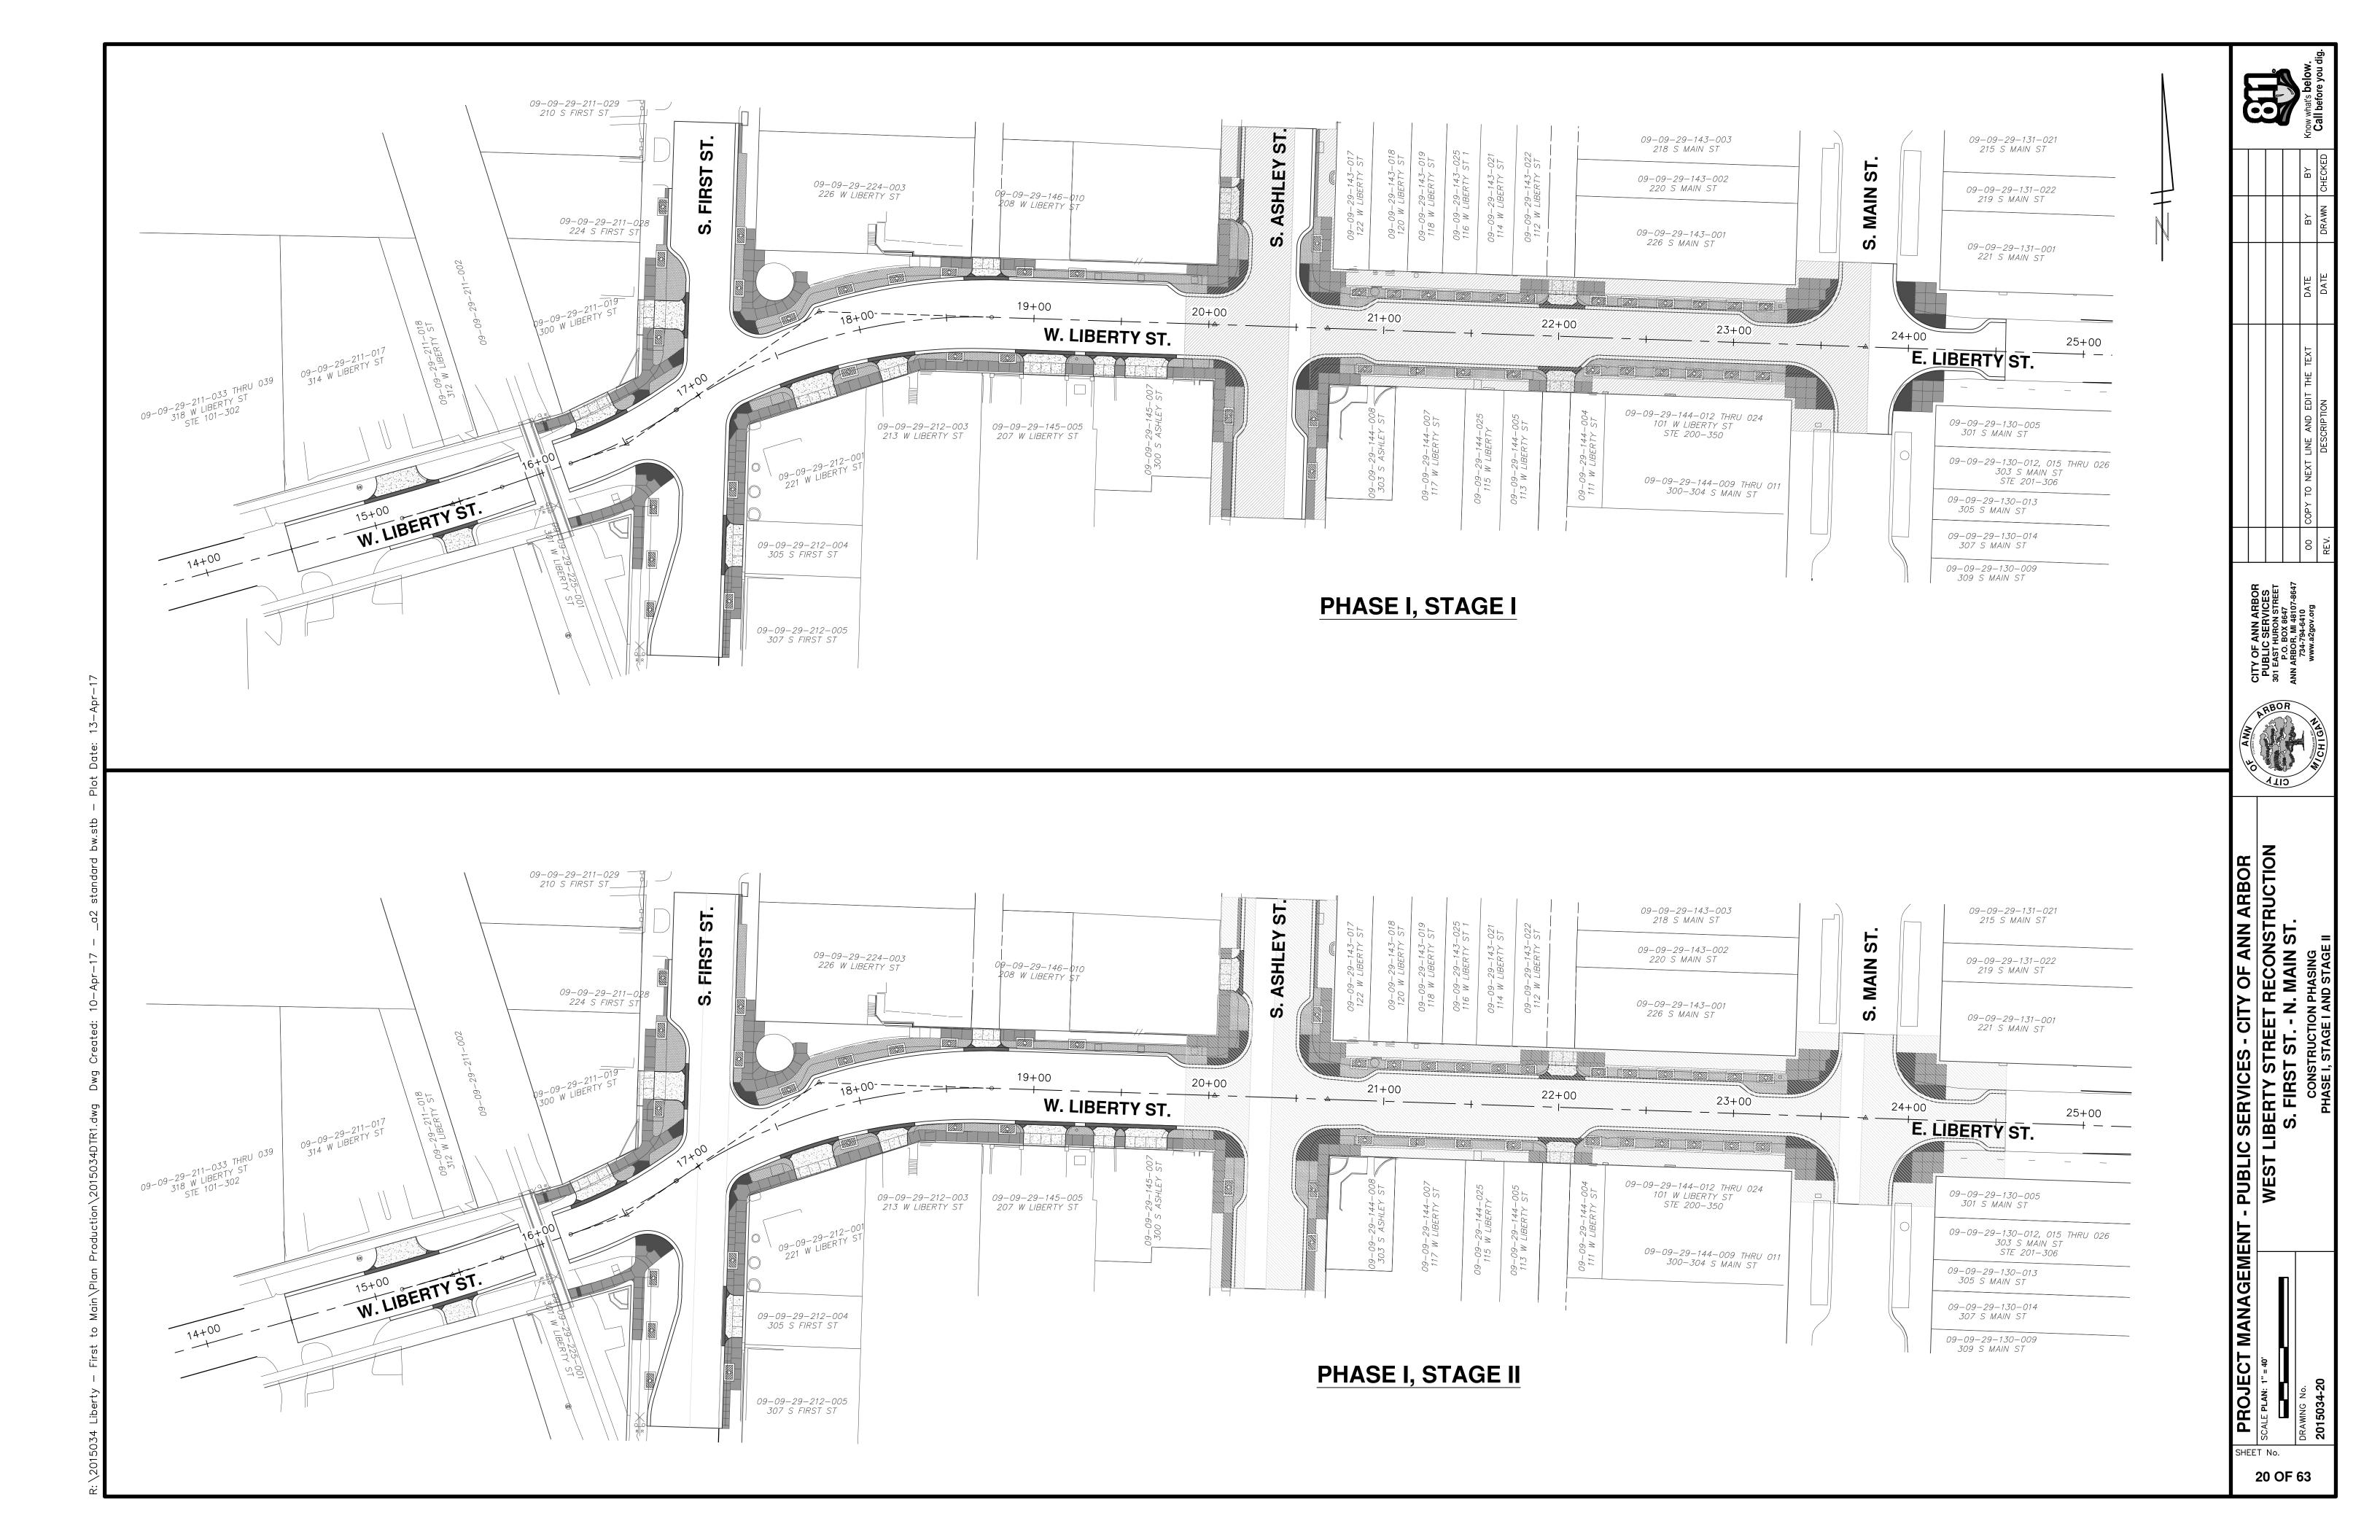

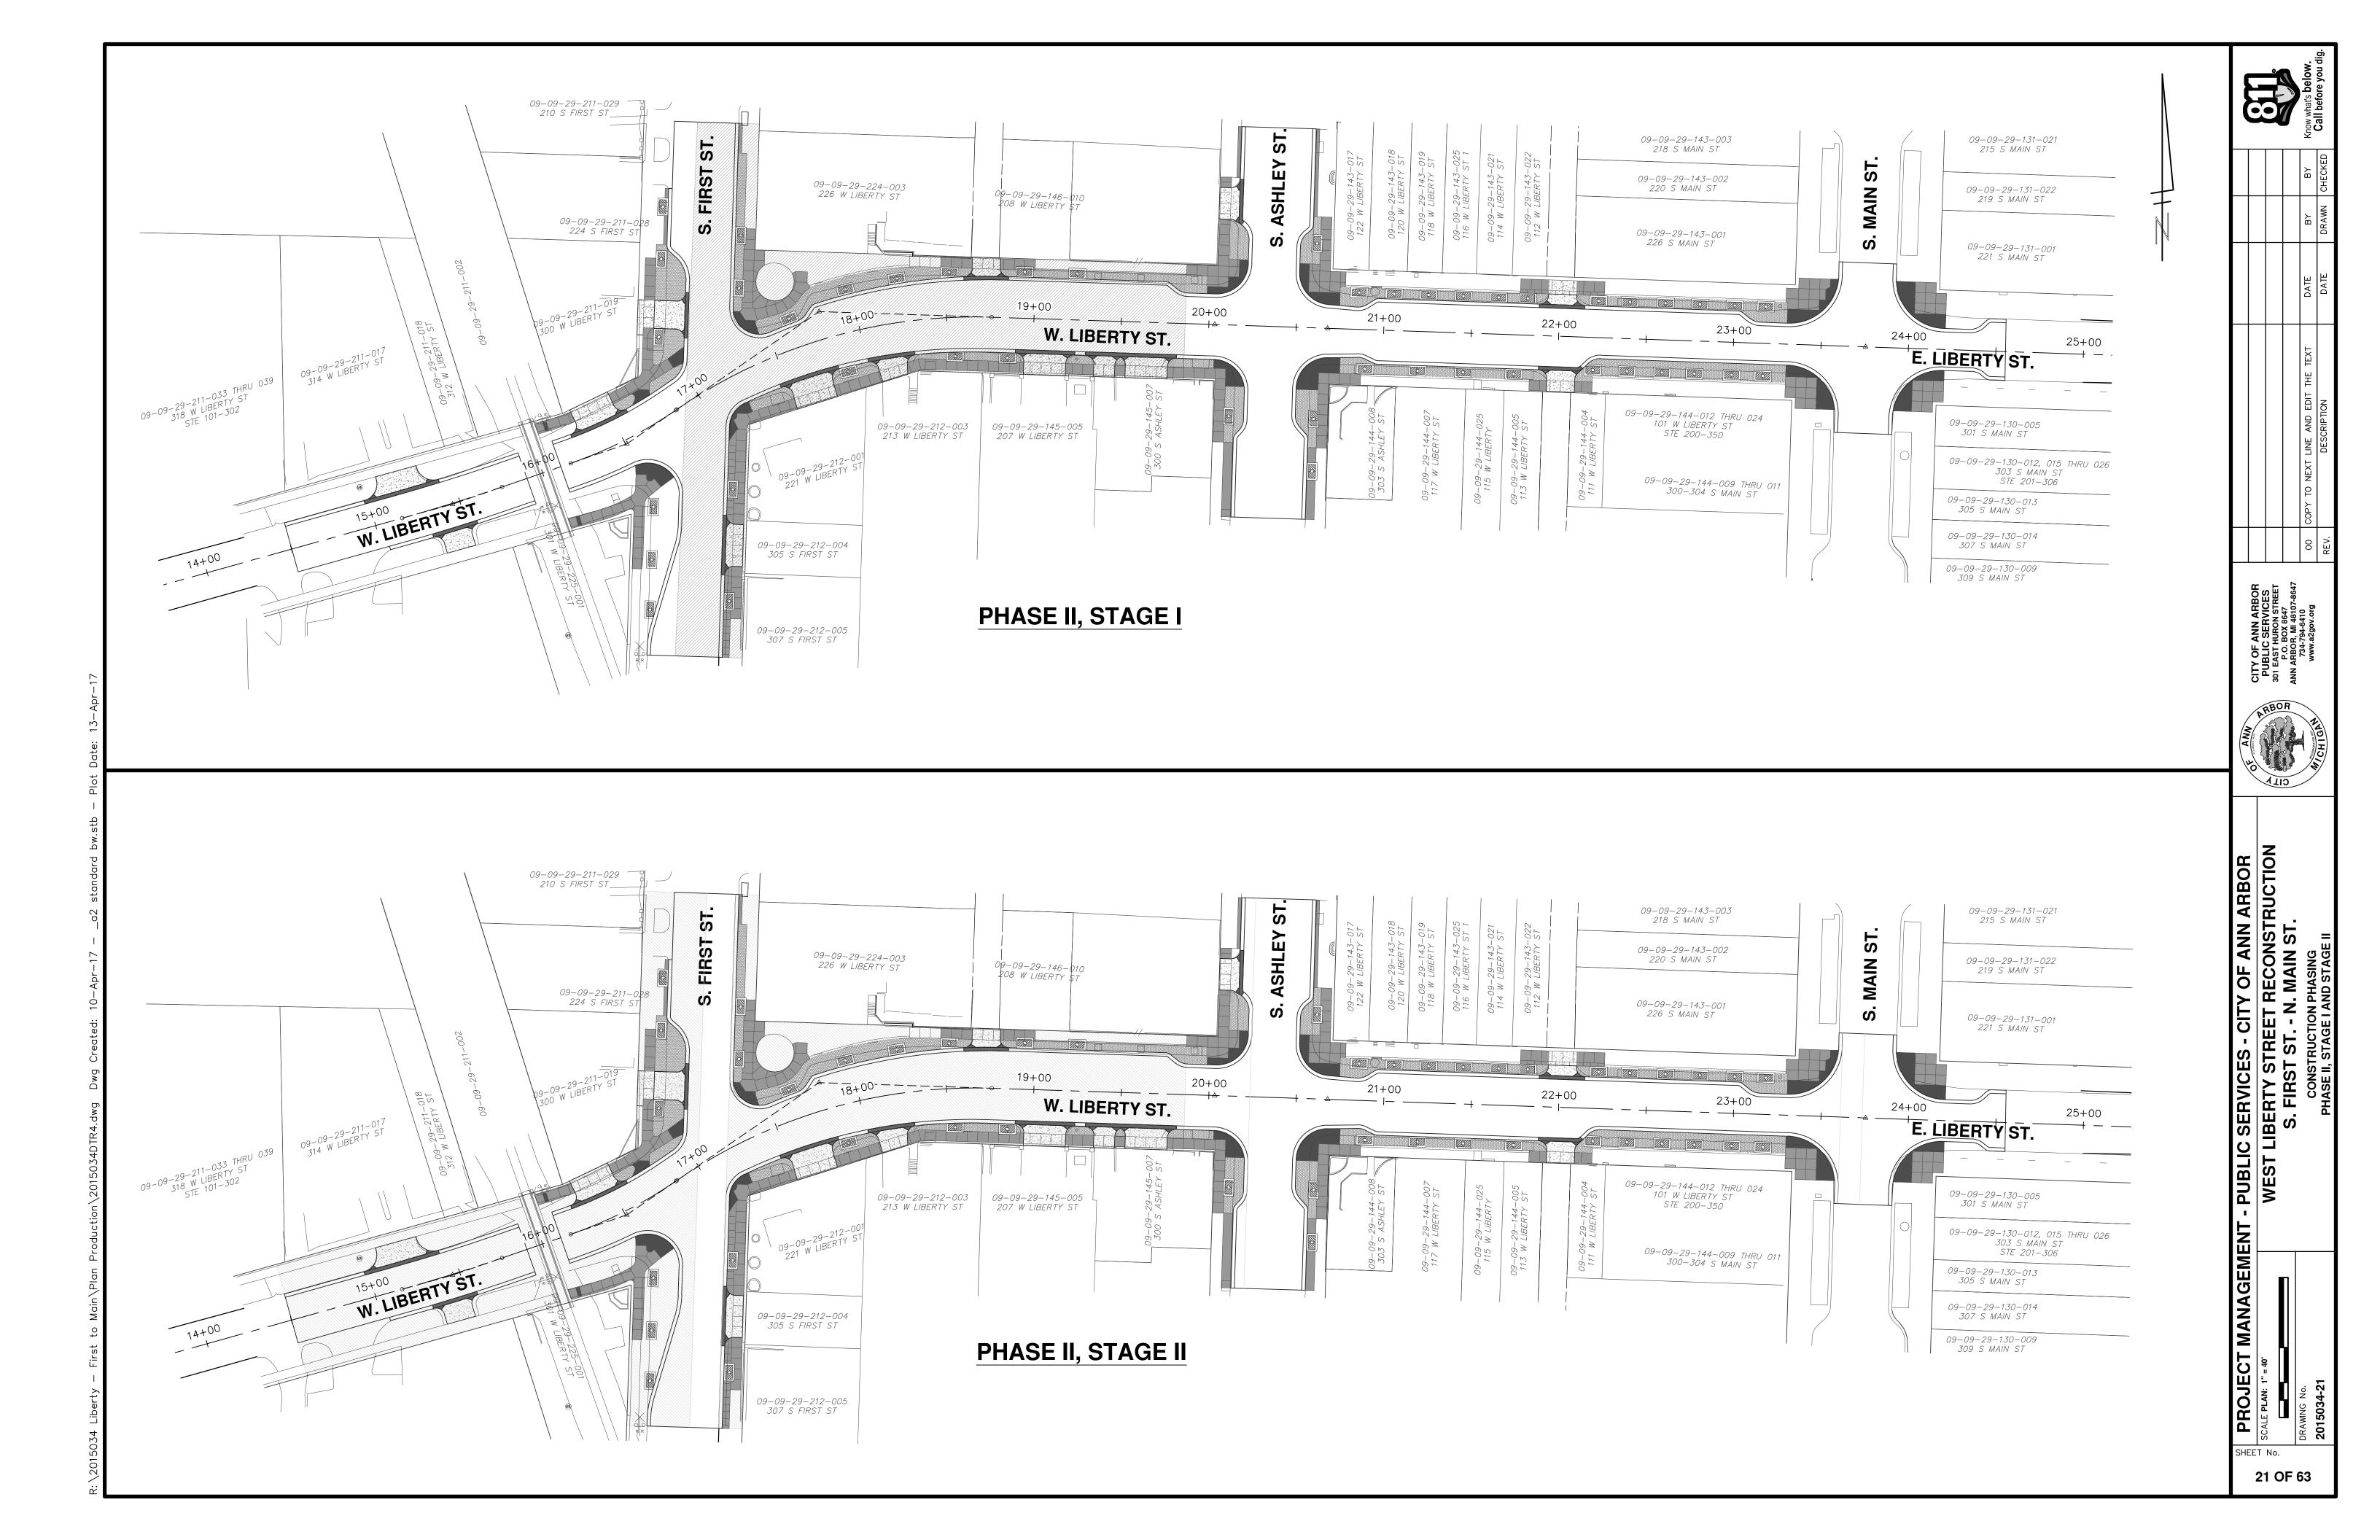


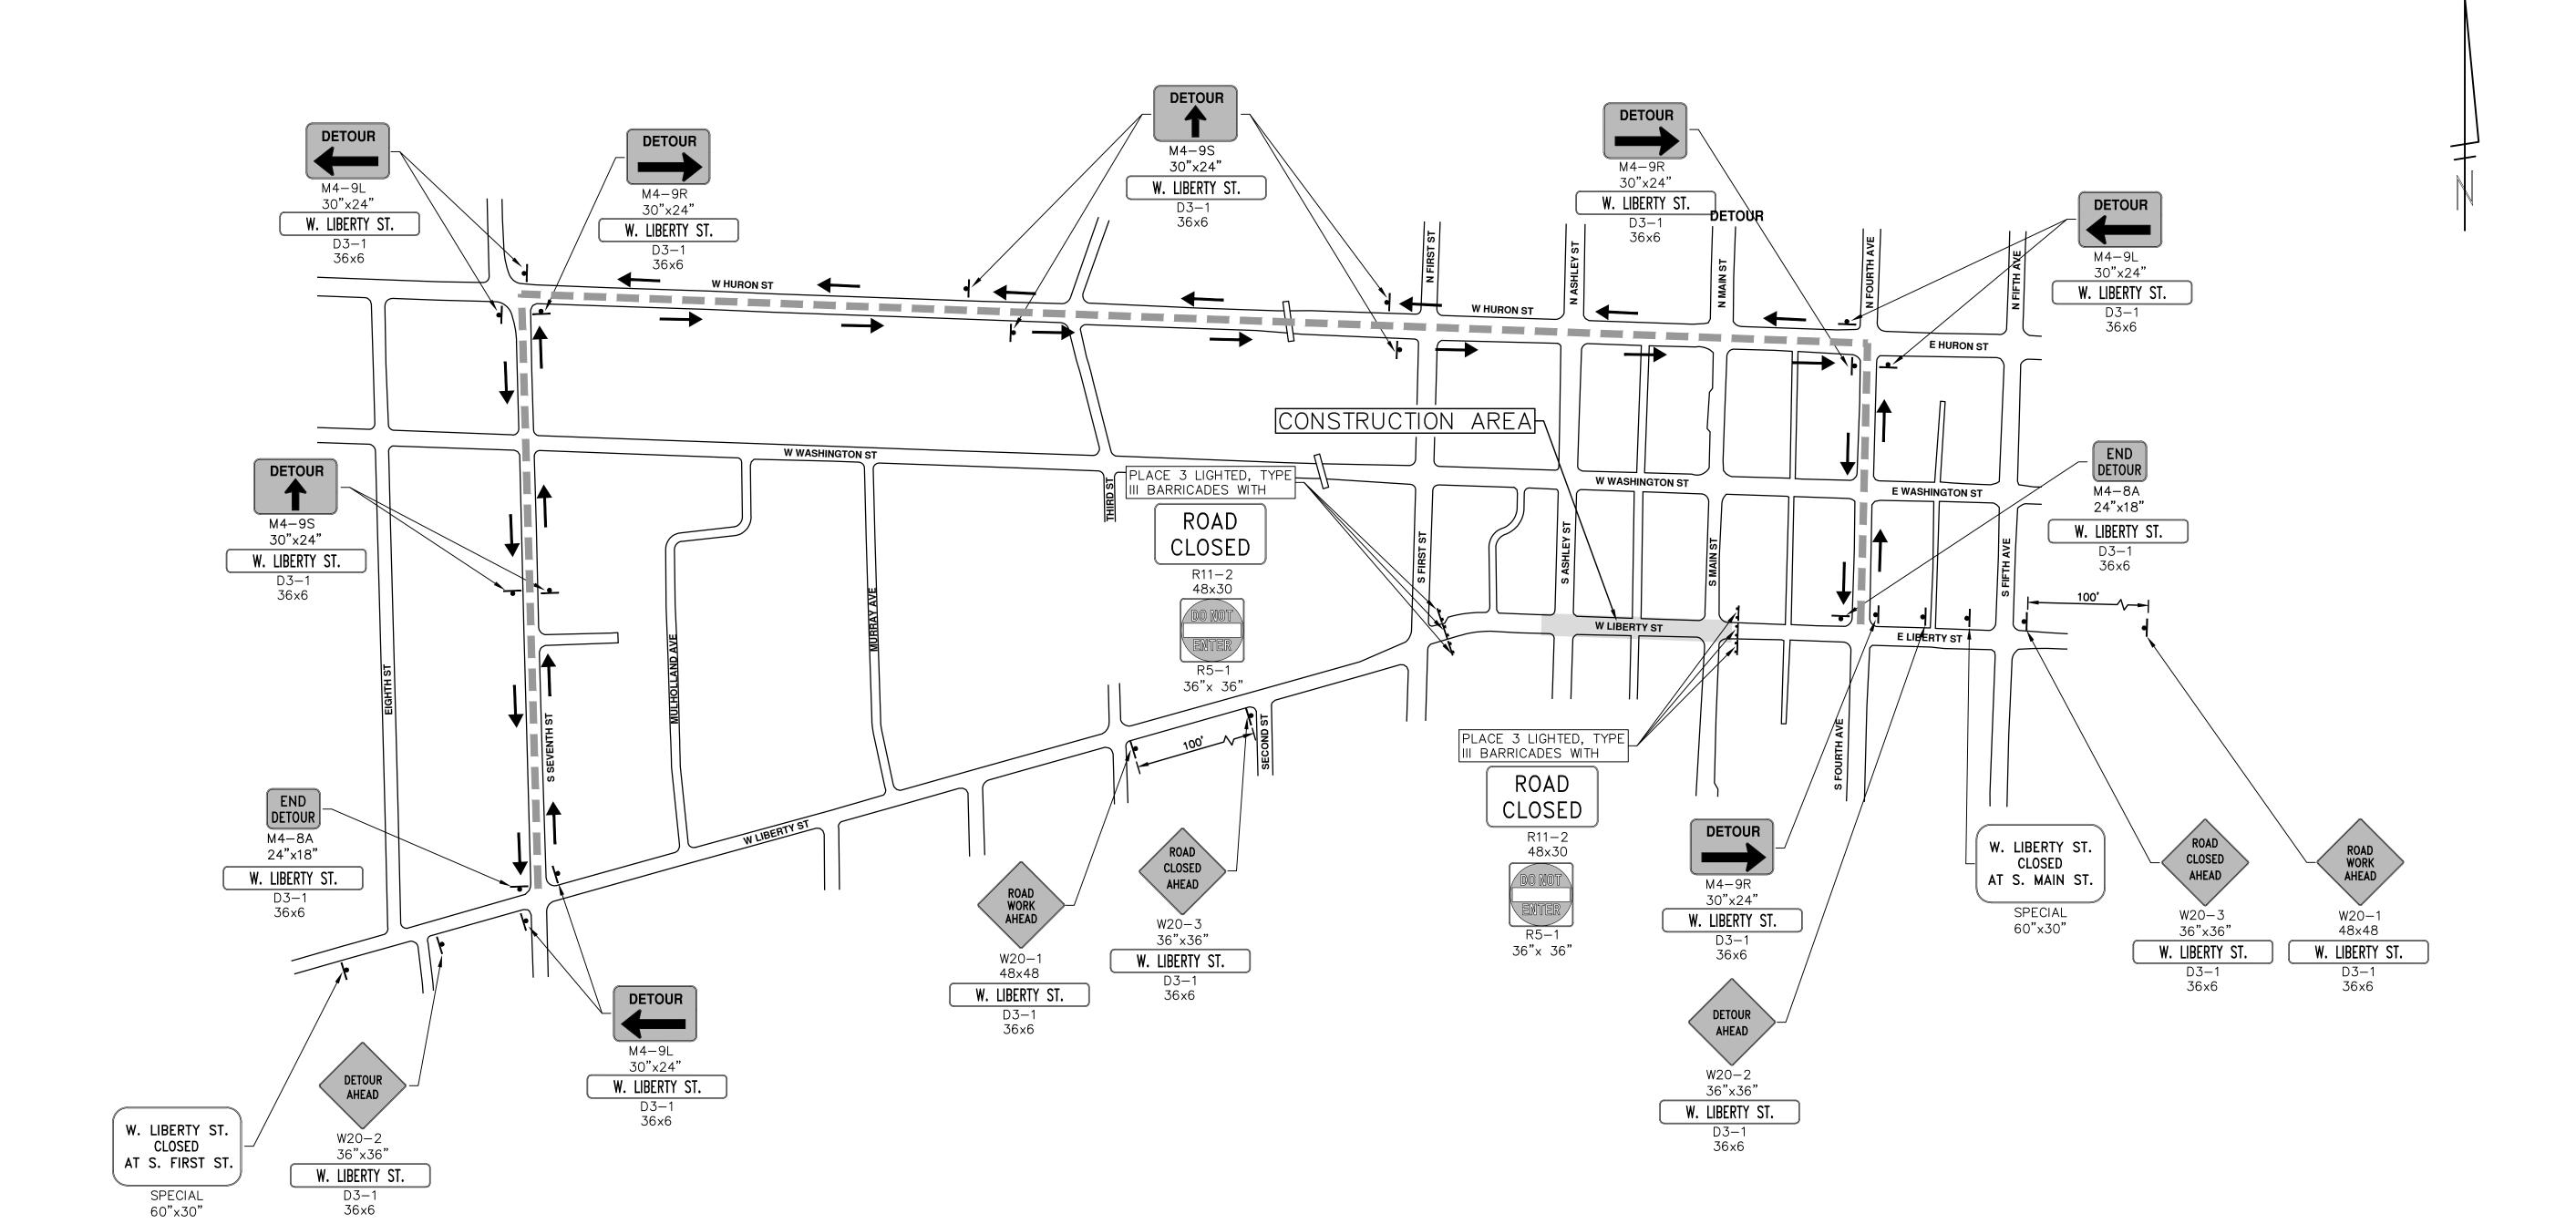

DETOUR CONSTRUCTION NOTES:

- 1. DEPENDING ON THE DETOUR ROUTES THAT ARE PUT IN PLACE, CONFLICTING SIGNS MAY BE PRESENT. PRIOR TO THE ORDERING OR PLACEMENT OF ANY SIGNS, MEET WITH THE ENGINEER TO VERIFY THE EXACT NUMBER AND LOCATION OF THE SIGNS TO BE PLACED. THE ENGINEER AND THE CONTRACTOR SHALL WORK TOGETHER TO ELIMINATE ALL CONFLICTS.
- INTO SERVICE IN ORDER TO SAFELY MAINTAIN TRAFFIC. ADJUSTMENTS IN THE UNIT PRICE FOR THESE ITEMS OF WORK SHALL NOT BE ALLOWED FOR THESE OCCURRENCES.
- 3. THE CONTRACTOR SHALL COORDINATE HIS OPERATIONS WITH THOSE OF THE CITY OF ANN ARBOR'S SIGNS AND SIGNALS UNIT DURING THE COURSE OF THE DETOUR ROUTE ESTABLISHMENT TO EFFECTIVELY AND SAFELY MAINTAIN TRAFFIC. DO NOT ERECT ANY SIGNS UNTIL ITS LOCATION AND PROPOSED DATE OF INSTALLATION IS APPROVED BY THE ENGINEER.
- 4. THESE DETOURS ARE TO BE IN PLACE DURING W. LIBERTY ST. RECONSTRUCTION. AS DIRECTED BY THE ENGINEER, THE CONTRACTOR WILL CLOSE AND DETOUR WEST AND EAST BOUND W. LIBERTY ST. TRAFFIC. SEE "SPECIAL PROVISION FOR MAINTAINING TRAFFIC AND CONSTRUCTION SEQUENCING" FOR DETAILS ON CONSTRUCTION STAGING, SEQUENCING, CLOSURE AND DETOUR LIMITATIONS, AND OTHER DETAILS.
- 5. REFERENCE THE "SPECIAL PROVISION FOR MAINTAINING TRAFFIC AND CONSTRUCTION SEQUENCING" FOR ADDITIONAL PROJECT REQUIREMENTS. THE CONTRACTOR'S ATTENTION IS SPECIFICALLY DIRECTED TO THE SECTION OF SAME SPECIAL PROVISION REGARDING COORDINATION WITH THE CITY SIGNS AND SIGNALS UNIT FOR THE SEVERAL DETOUR ROUTE MODIFICATIONS AND THE MODIFICATIONS TO TRAFFIC SIGNALS FOR THE DETOUR.

- 6. THE CONTRACTOR SHALL FURNISH, ERECT, AND MAINTAIN SIGNS AS SHOWN ON THE PLANS OR OTHERWISE DIRECTED BY THE ENGINEER.
- 7. CONSTRUCTION WARNING SIGNS SHALL HAVE AN ORANGE, HIGH-INTENSITY, REFLECTORIZED BACKGROUND.
- 2. THE CITY RESERVES THE RIGHT TO ORDER ADDITIONAL SIGNS AND PLACE THEM 8. SIGNS SHALL CONFORM TO THE 2011 MICHIGAN MANUAL OF UNIFORM TRAFFIC CONTROL DEVICES.
 - 9. THE CONTRACTOR SHALL DRIVE ALL SIGNS INTO EXPOSED GROUND OR INSERT INTO A BORED HOLE IN PAVEMENT AS NECESSARY TO PERMANENTLY SECURE. ALL HOLES IN PAVEMENT SHALL BE FILLED WITH ENGINEER-APPROVED MORTAR WHEN THE SIGN IS REMOVED AND NO LONGER NEEDED. COSTS FOR THIS WORK SHALL BE INCLUDED IN THE PAY ITEM "SIGN, TYPE B, TEMP, PRISMATIC, FURN" OR "SIGN, TYPE B, TEMP, PRISMATIC, FURN, SPECIAL"
 - 10. ADVANCE WARNING SIGNS SHALL BE PROVIDED WITH TWO (2) TYPE A FLASHING LIGHTS AND ONE (1) DAY-GLOW ORANGE FLAG.

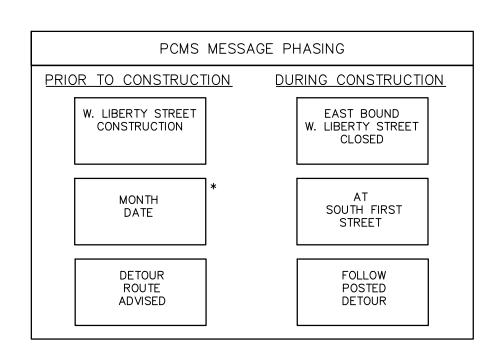


NOTE: PCMS LOCATIONS AND MESSAGES WILL BE AS DIRECTED BY THE ENGINEER.


*THE CONTRACTOR SHALL PLACE THE APPROPRIATE DATE AS APPROVED BY THE ENGINEER.

S SERVICES - CITY OF ANN A LIBERTY STREET RECONSTRIS. S. FIRST ST. - N. MAIN ST. DETOUR PLAN PHASE I - OVERALL MANAGEMENT


SHEET No. 22 OF 63

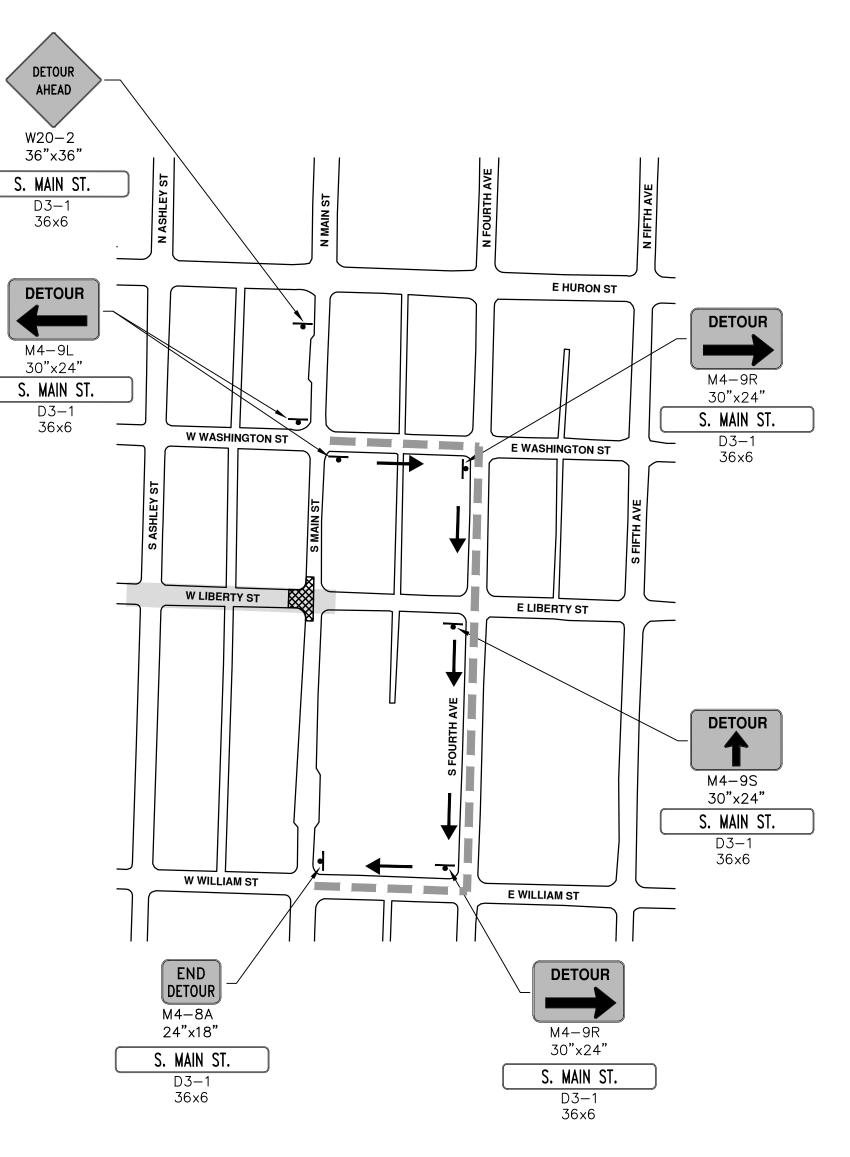


SOUTHBOUND S. MAIN ST. DETOUR PHASE I, STAGE I

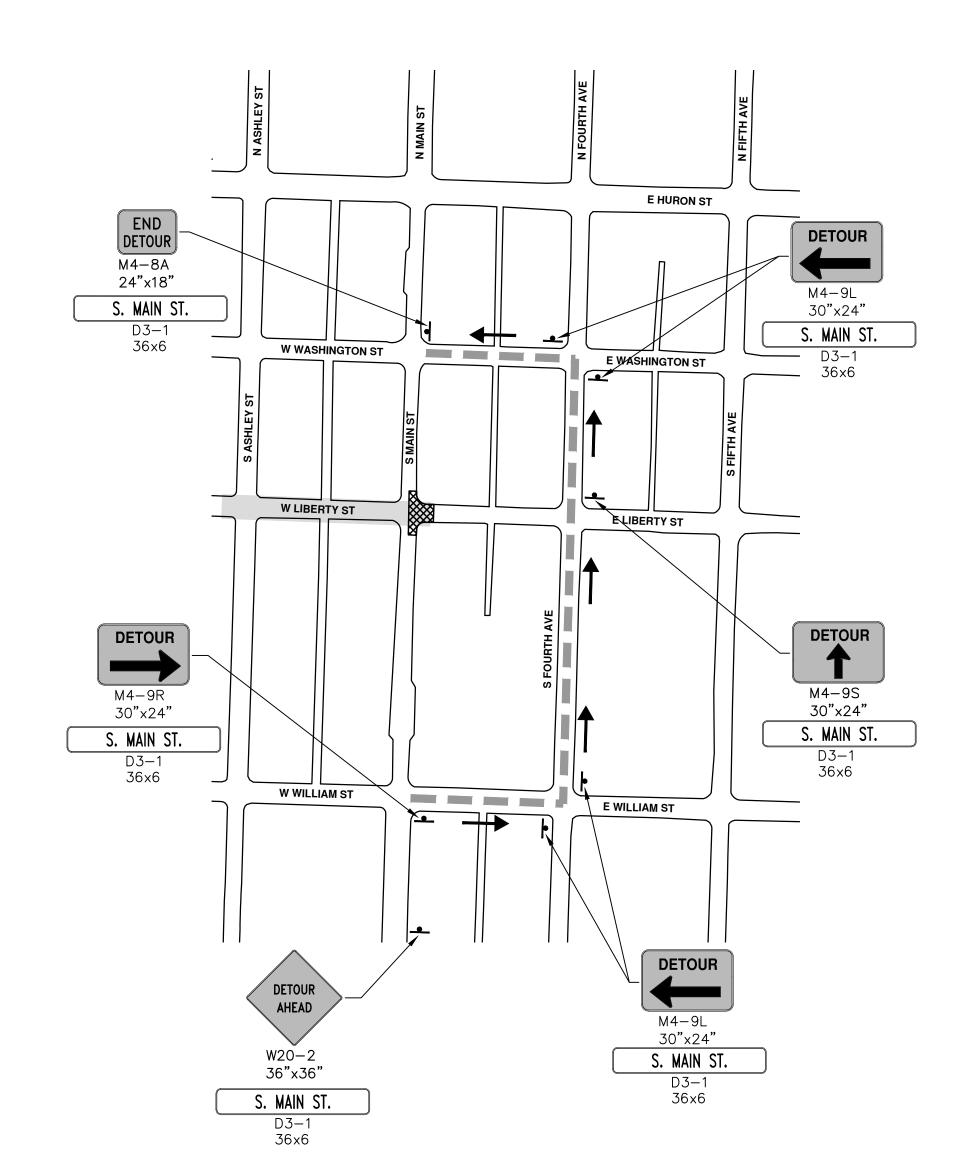



NORTHBOUND S. MAIN ST. DETOUR PHASE I, STAGE II

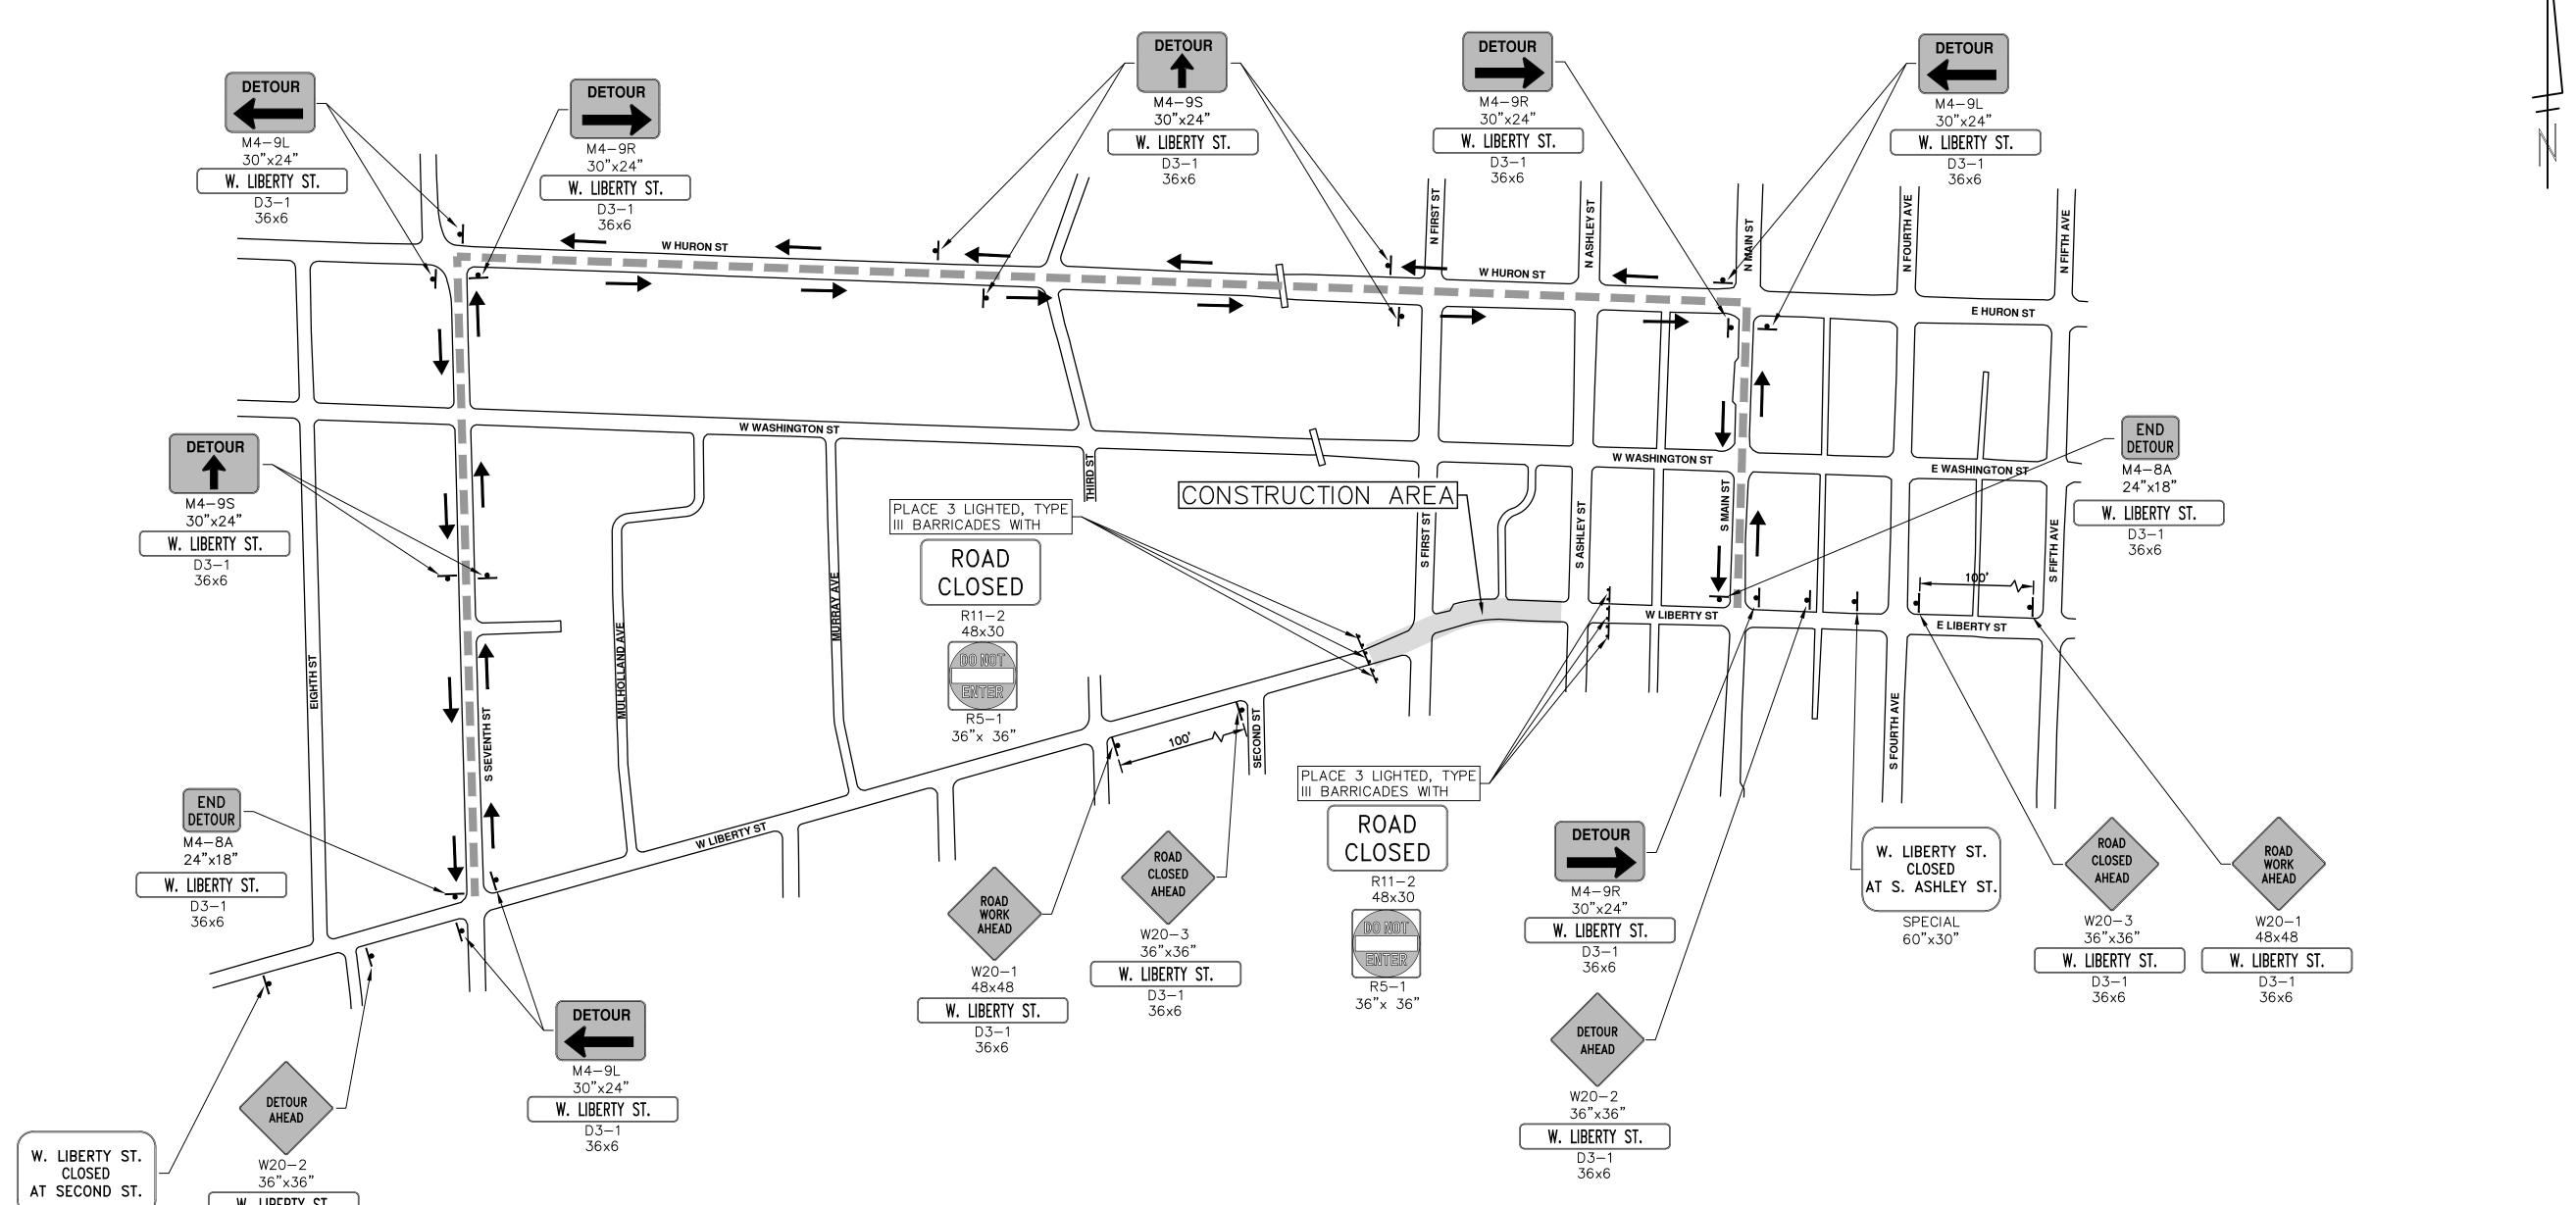

FY OF ANN / RECONSTE N. MAIN ST. SERVICES - CIT IBERTY STREET S. FIRST ST. - N W. LIBERTY ST. SPECIAL 36x6 60"x30" DETOUR CONSTRUCTION NOTES: PCMS MESSAGE PHASING 1. DEPENDING ON THE DETOUR ROUTES THAT ARE PUT IN PLACE, CONFLICTING 6. THE CONTRACTOR SHALL FURNISH, ERECT, AND MAINTAIN SIGNS AS SHOWN ON SIGNS MAY BE PRESENT. PRIOR TO THE ORDERING OR PLACEMENT OF ANY THE PLANS OR OTHERWISE DIRECTED BY THE ENGINEER. PRIOR TO CONSTRUCTION DURING CONSTRUCTION SIGNS, MEET WITH THE ENGINEER TO VERIFY THE EXACT NUMBER AND 7. CONSTRUCTION WARNING SIGNS SHALL HAVE AN ORANGE, HIGH-INTENSITY, LOCATION OF THE SIGNS TO BE PLACED. THE ENGINEER AND THE EAST BOUND W. LIBERTY STREET CONTRACTOR SHALL WORK TOGETHER TO ELIMINATE ALL CONFLICTS. REFLECTORIZED BACKGROUND. W. LIBERTY STREET CONSTRUCTION CLOSED 2. THE CITY RESERVES THE RIGHT TO ORDER ADDITIONAL SIGNS AND PLACE THEM 8. SIGNS SHALL CONFORM TO THE 2011 MICHIGAN MANUAL OF UNIFORM TRAFFIC INTO SERVICE IN ORDER TO SAFELY MAINTAIN TRAFFIC. ADJUSTMENTS IN THE CONTROL DEVICES. MANAGEMENT UNIT PRICE FOR THESE ITEMS OF WORK SHALL NOT BE ALLOWED FOR THESE OCCURRENCES. 9. THE CONTRACTOR SHALL DRIVE ALL SIGNS INTO EXPOSED GROUND OR INSERT MONTH SECOND DATE INTO A BORED HOLE IN PAVEMENT AS NECESSARY TO PERMANENTLY SECURE. STREET 3. THE CONTRACTOR SHALL COORDINATE HIS OPERATIONS WITH THOSE OF THE ALL HOLES IN PAVEMENT SHALL BE FILLED WITH ENGINEER-APPROVED MORTAR CITY OF ANN ARBOR'S SIGNS AND SIGNALS UNIT DURING THE COURSE OF THE WHEN THE SIGN IS REMOVED AND NO LONGER NEEDED. COSTS FOR THIS WORK SHALL BE INCLUDED IN THE PAY ITEM "SIGN, TYPE B, TEMP, PRISMATIC, FURN" DETOUR ROUTE ESTABLISHMENT TO EFFECTIVELY AND SAFELY MAINTAIN DETOUR FOLLOW TRAFFIC. DO NOT ERECT ANY SIGNS UNTIL ITS LOCATION AND PROPOSED OR "SIGN, TYPE B, TEMP, PRISMATIC, FURN, SPECIAL" ROUTE POSTED DATE OF INSTALLATION IS APPROVED BY THE ENGINEER. DETOUR ADVISED 10. ADVANCE WARNING SIGNS SHALL BE PROVIDED WITH TWO (2) TYPE A 4. THESE DETOURS ARE TO BE IN PLACE DURING W. LIBERTY ST. FLASHING LIGHTS AND ONE (1) DAY-GLOW ORANGE FLAG. RECONSTRUCTION. AS DIRECTED BY THE ENGINEER, THE CONTRACTOR WILL CLOSE AND DETOUR WEST AND EAST BOUND W. LIBERTY ST. TRAFFIC. SEE NOTE: PCMS LOCATIONS AND MESSAGES WILL BE "SPECIAL PROVISION FOR MAINTAINING TRAFFIC AND CONSTRUCTION AS DIRECTED BY THE ENGINEER. SEQUENCING" FOR DETAILS ON CONSTRUCTION STAGING, SEQUENCING, CLOSURE AND DETOUR LIMITATIONS, AND OTHER DETAILS. *THE CONTRACTOR SHALL PLACE THE APPROPRIATE DATE AS APPROVED BY THE ENGINEER. 5. REFERENCE THE "SPECIAL PROVISION FOR MAINTAINING TRAFFIC AND CONSTRUCTION SEQUENCING" FOR ADDITIONAL PROJECT REQUIREMENTS. THE CONTRACTOR'S ATTENTION IS SPECIFICALLY DIRECTED TO THE SECTION OF SAME SPECIAL PROVISION REGARDING COORDINATION WITH THE CITY SIGNS AND SHEET No. SIGNALS UNIT FOR THE SEVERAL DETOUR ROUTE MODIFICATIONS AND THE MODIFICATIONS TO TRAFFIC SIGNALS FOR THE DETOUR. 24 OF 63

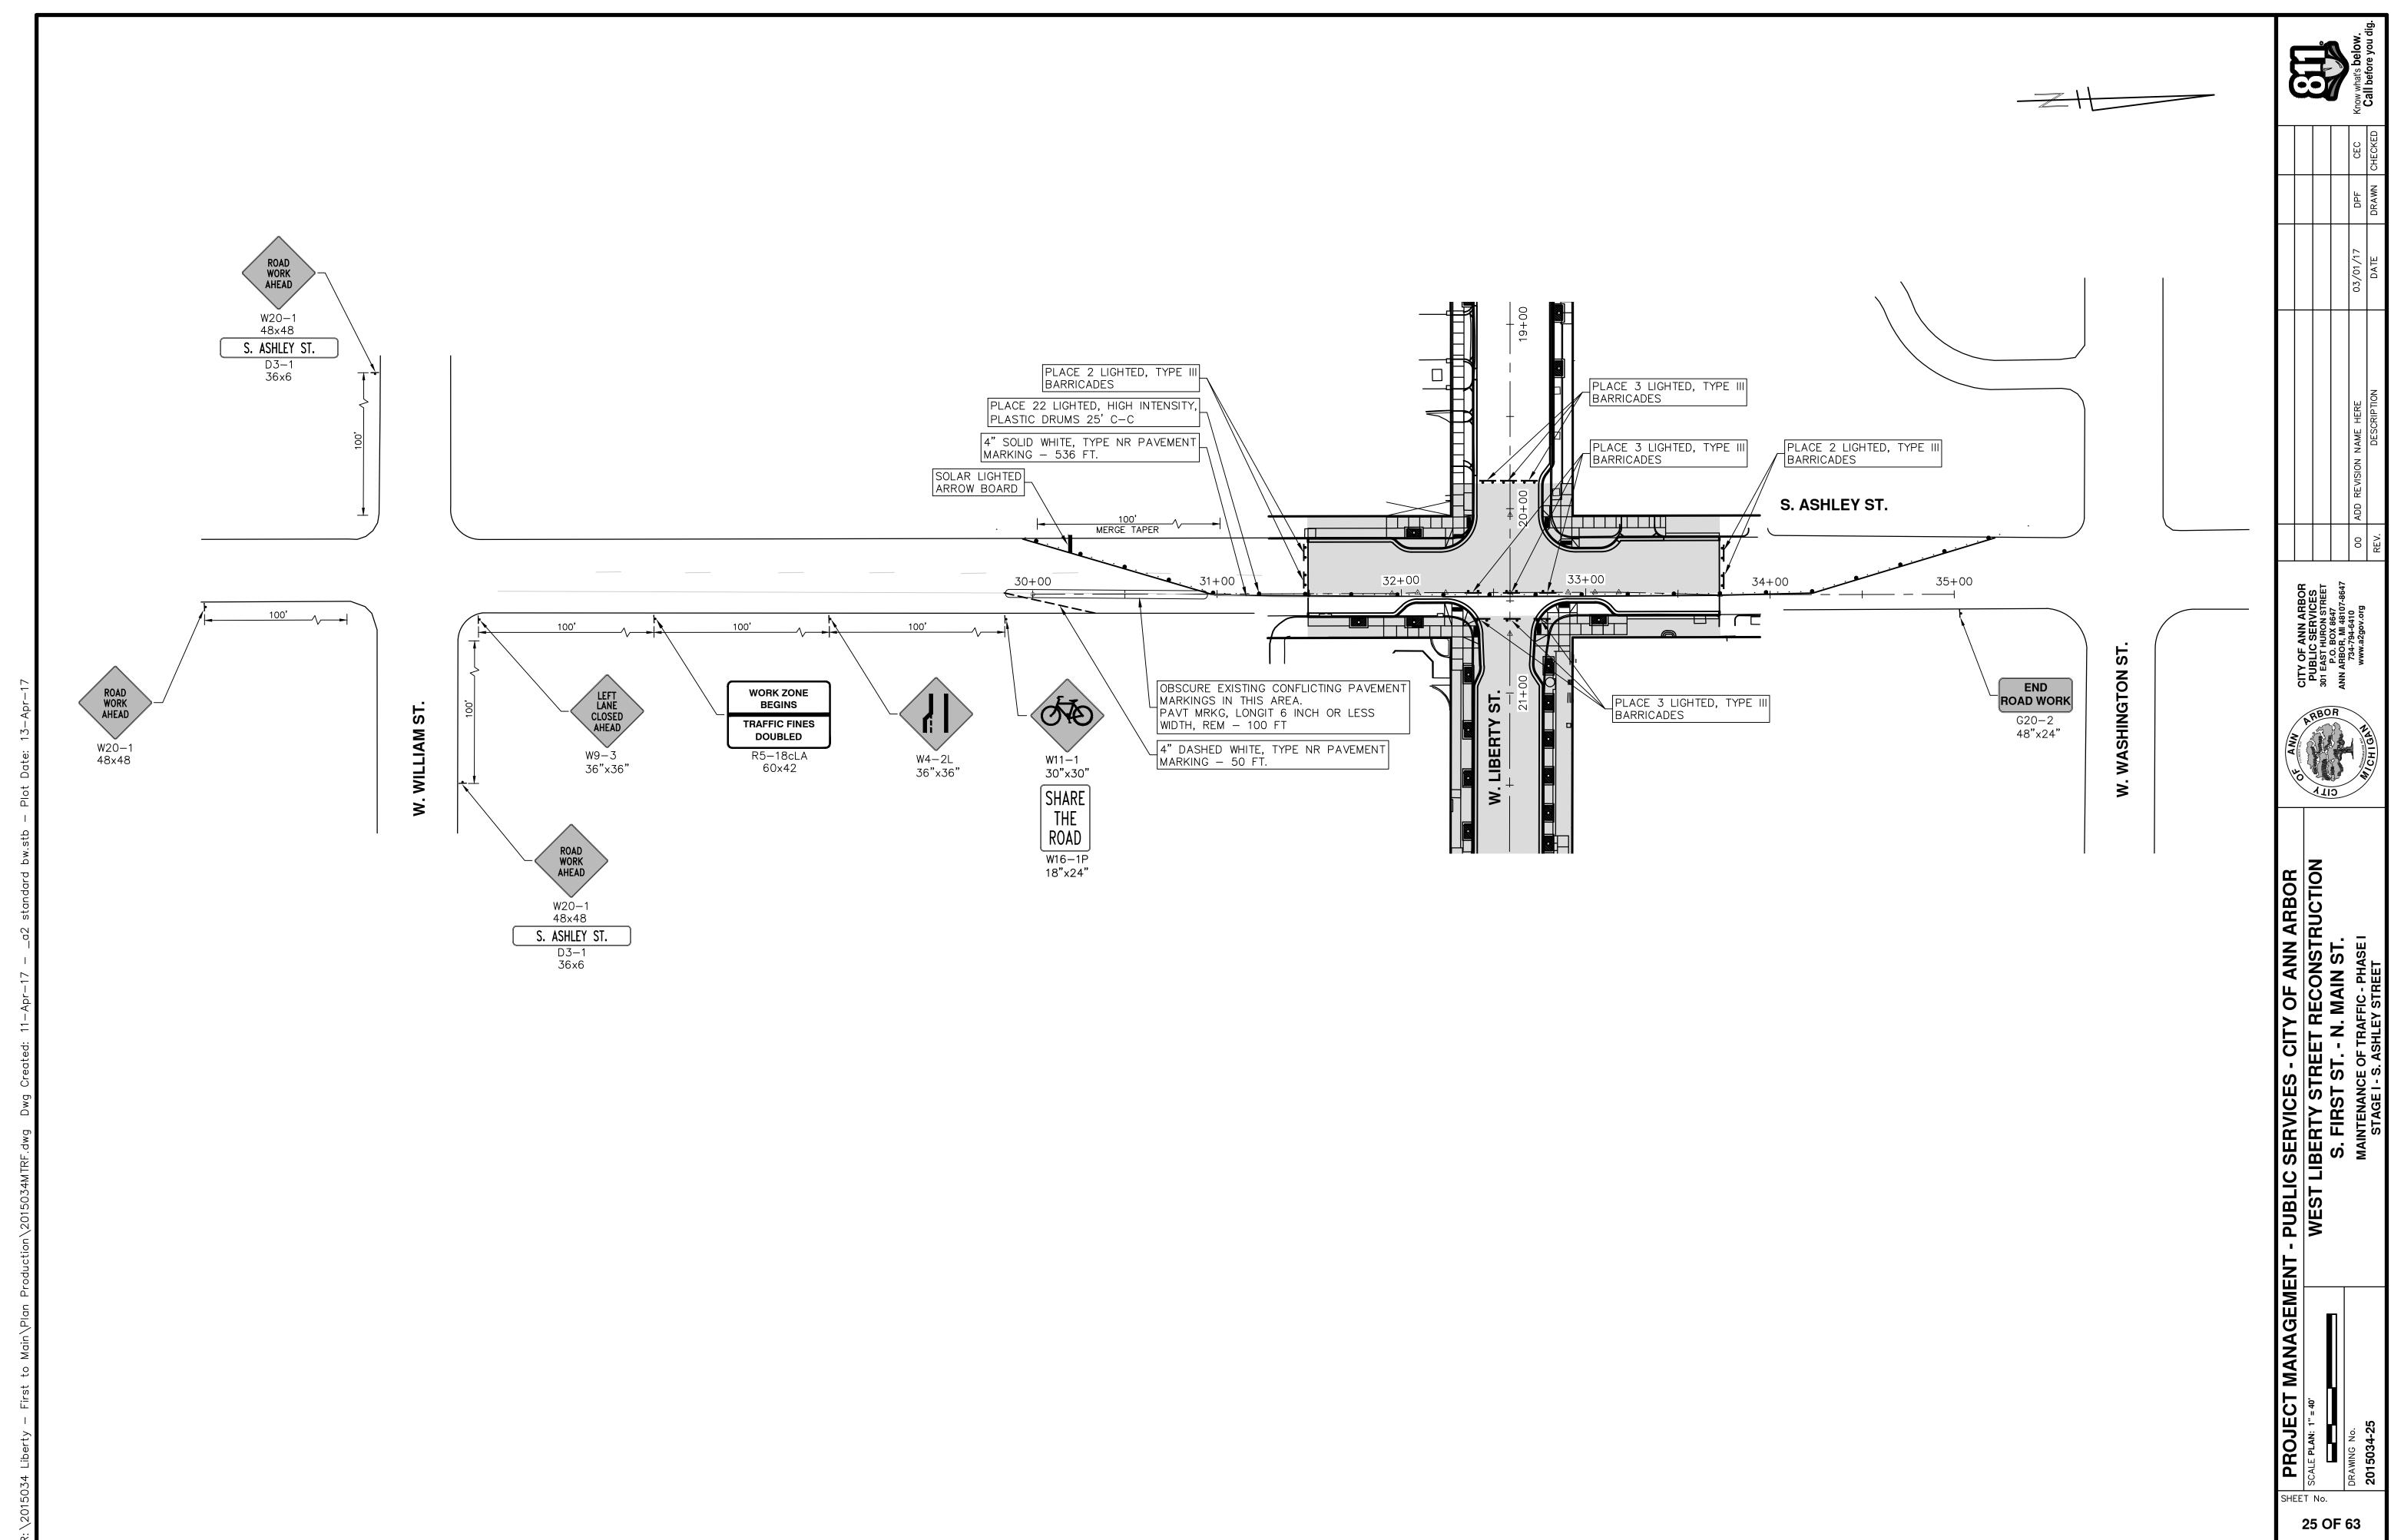

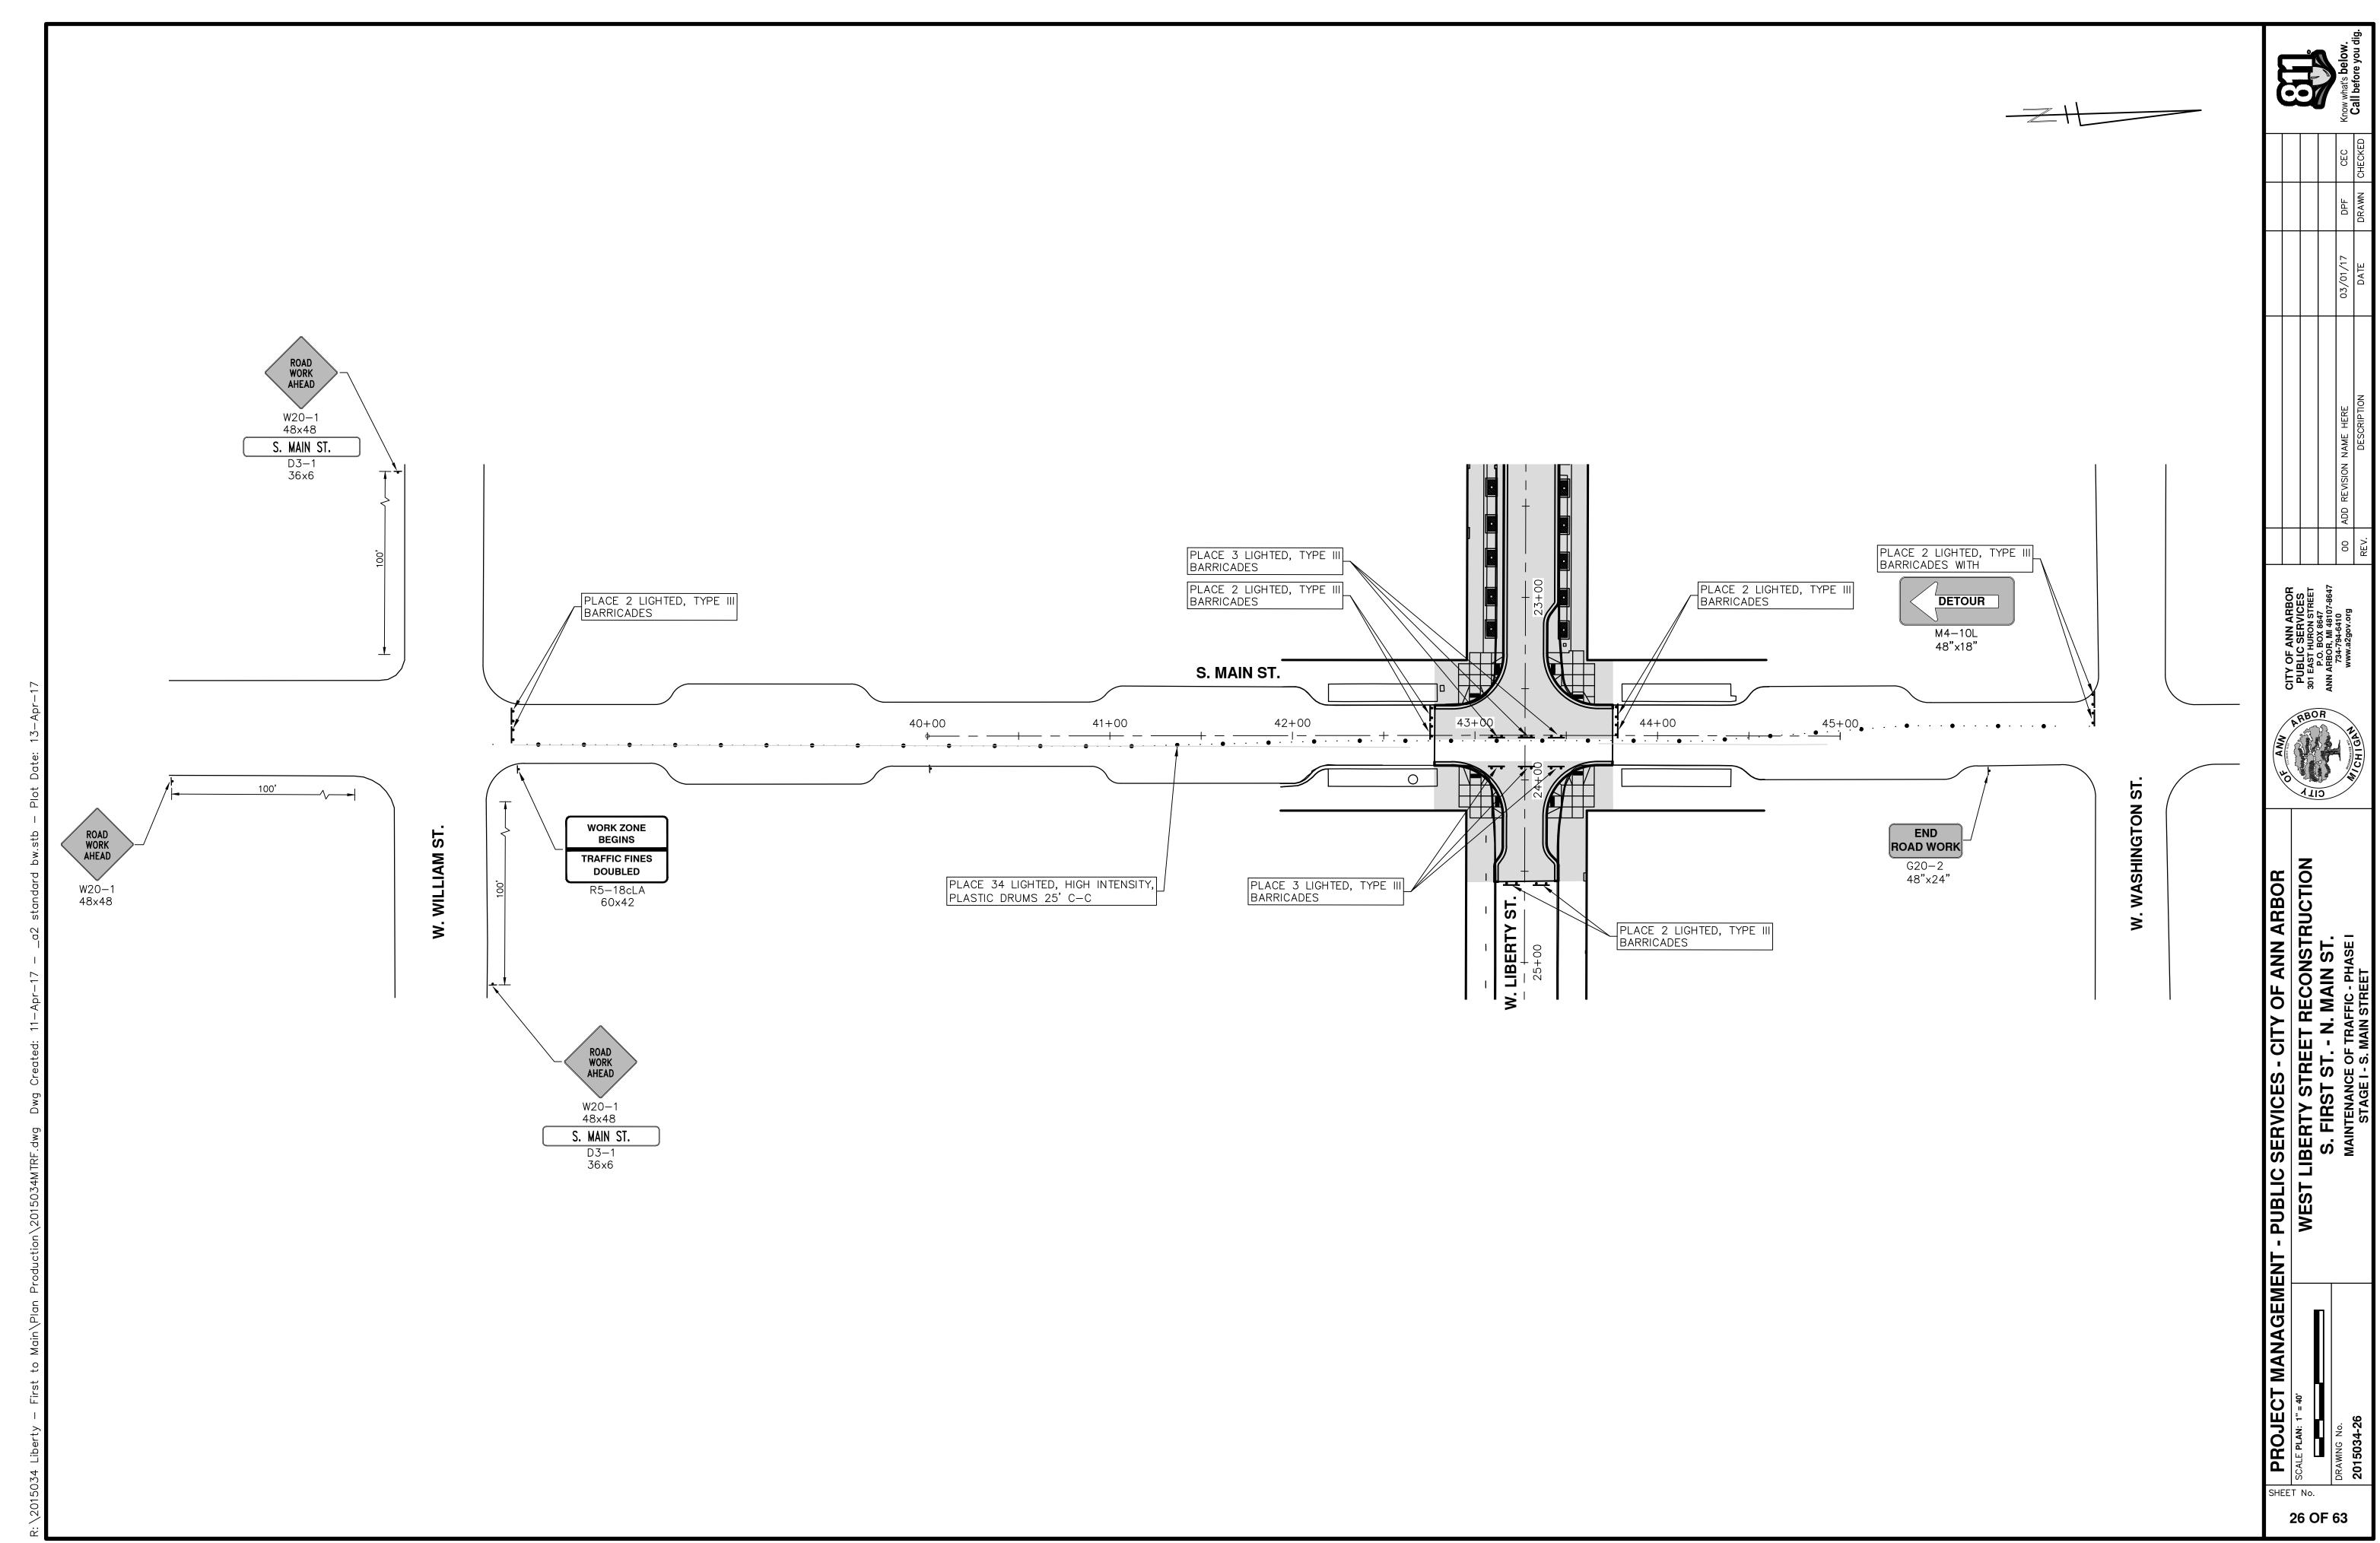

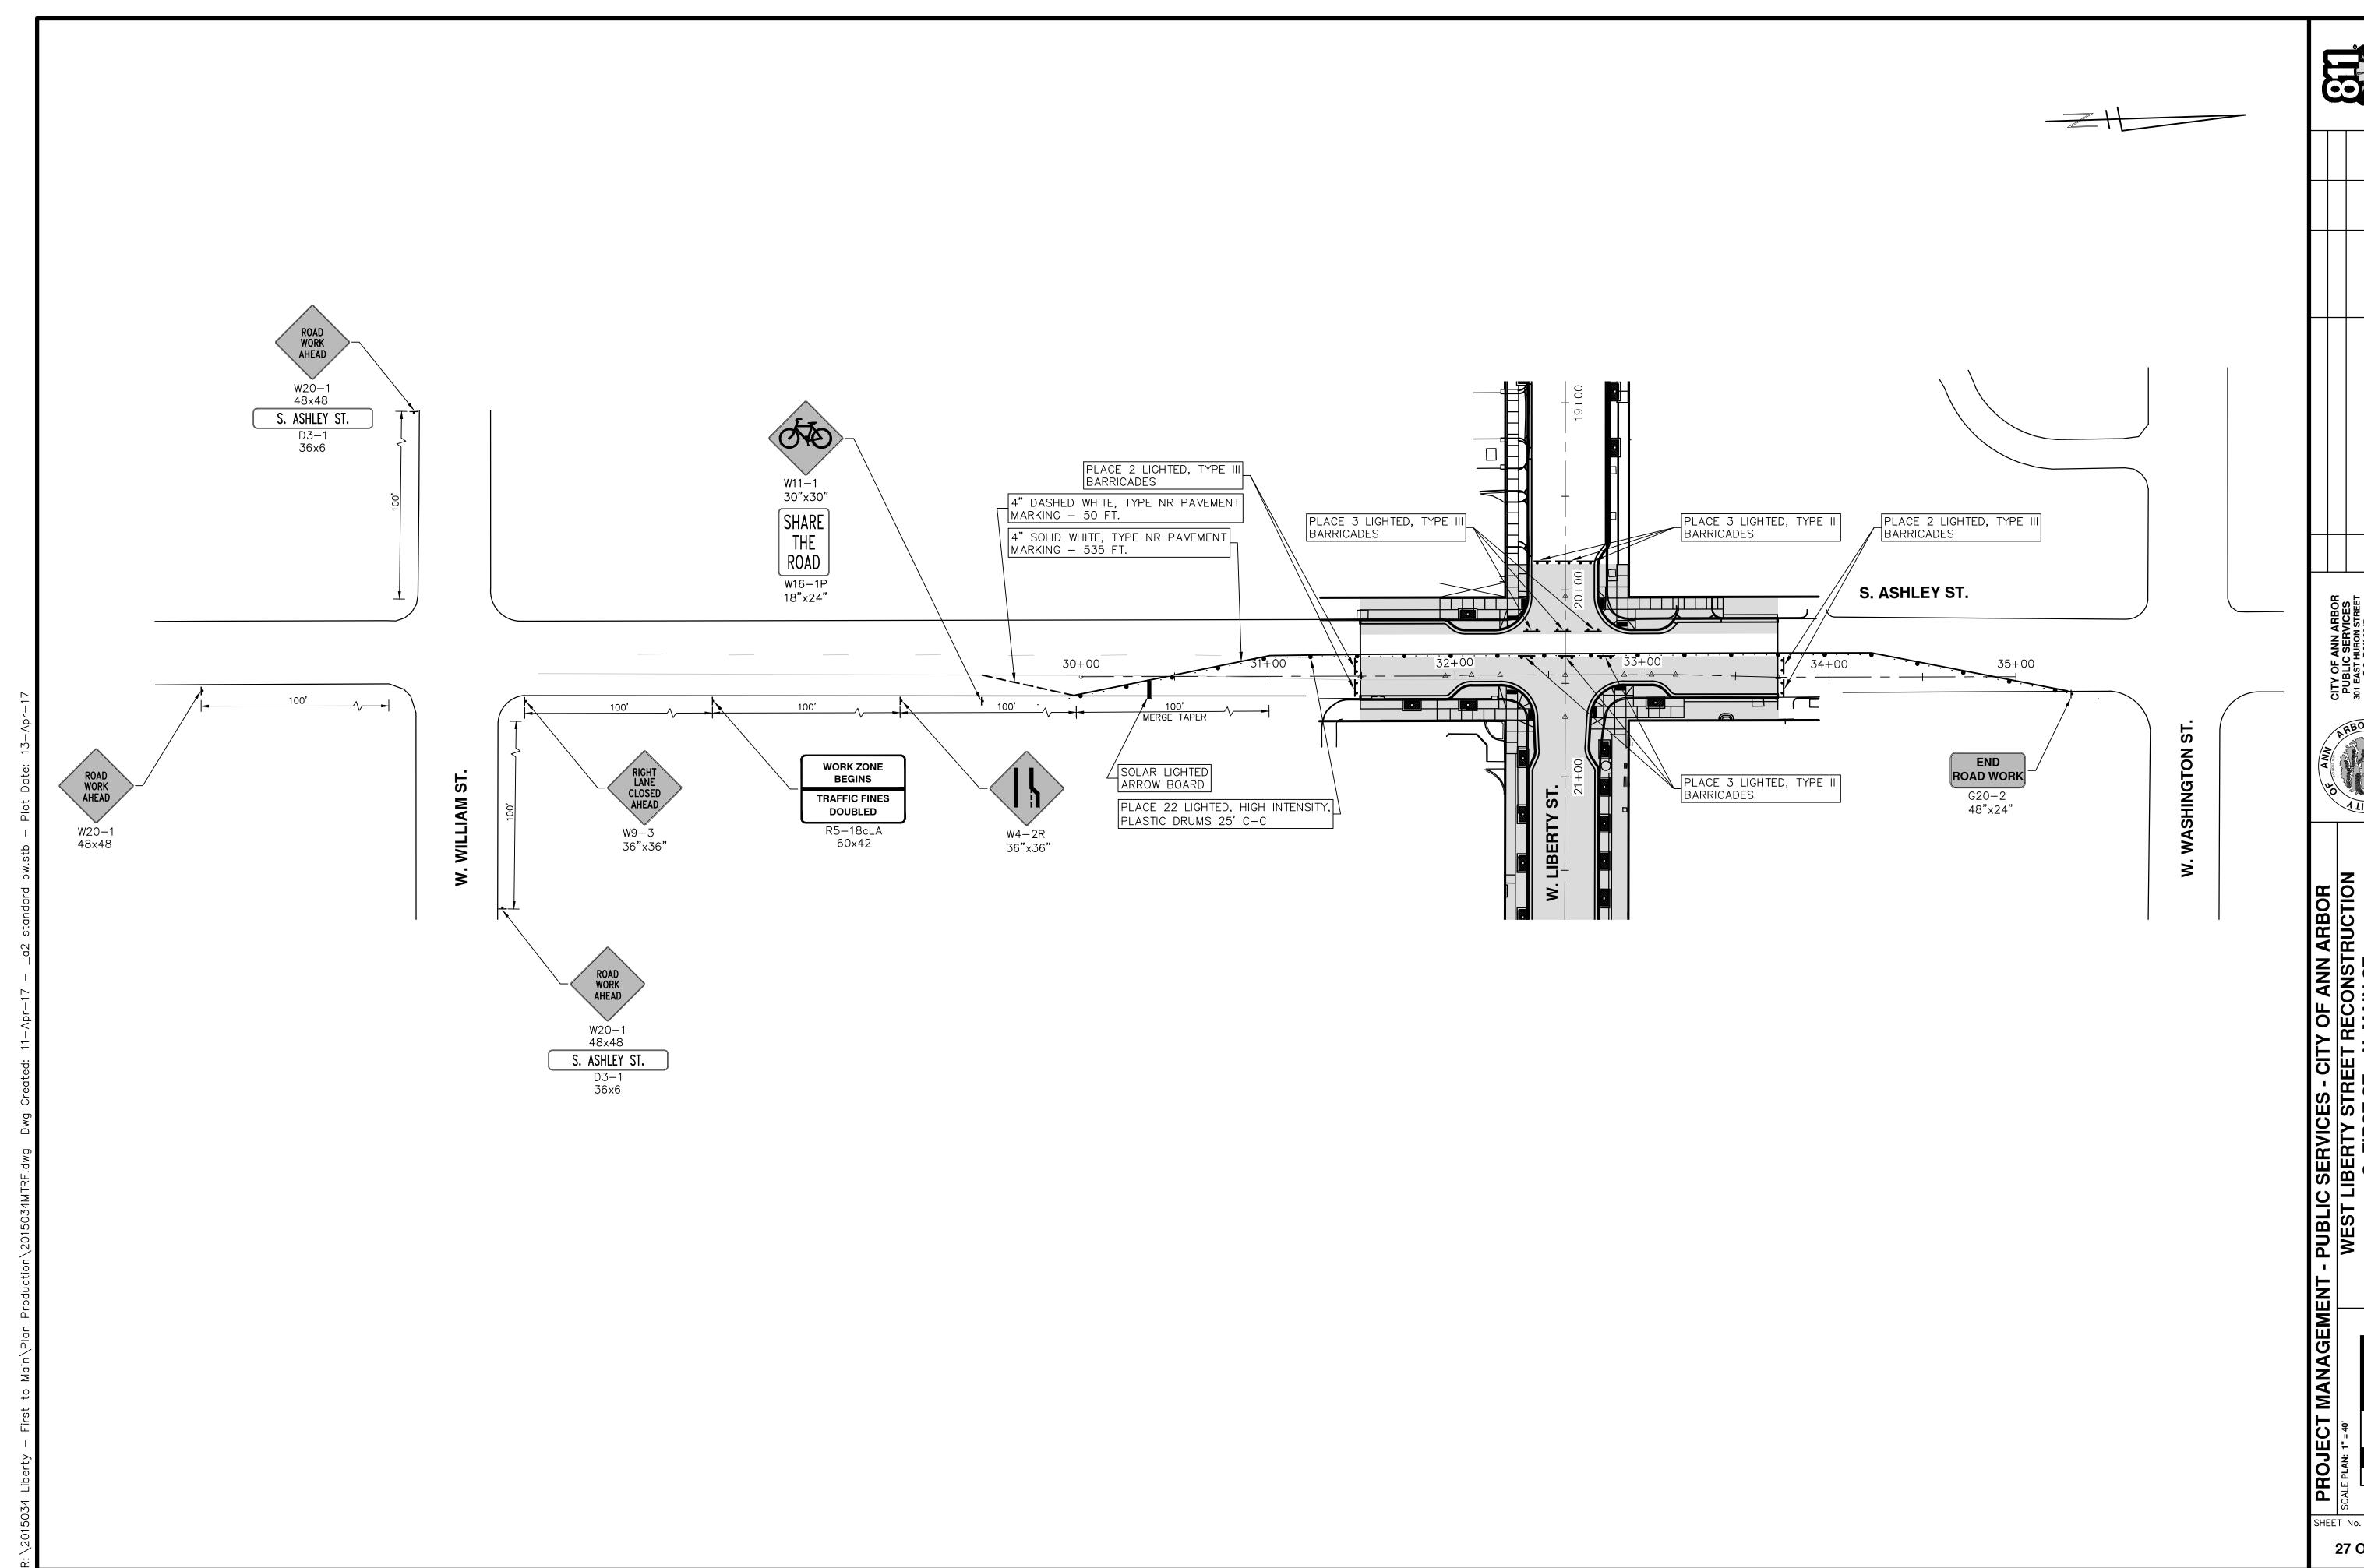

PROJECT MANAGEMENT - PUBLIC SERVICES - CITY OF ANN ARBC

SCALE PLAN: 1" = 40'

DRAWING NO.

DRAWING NO.


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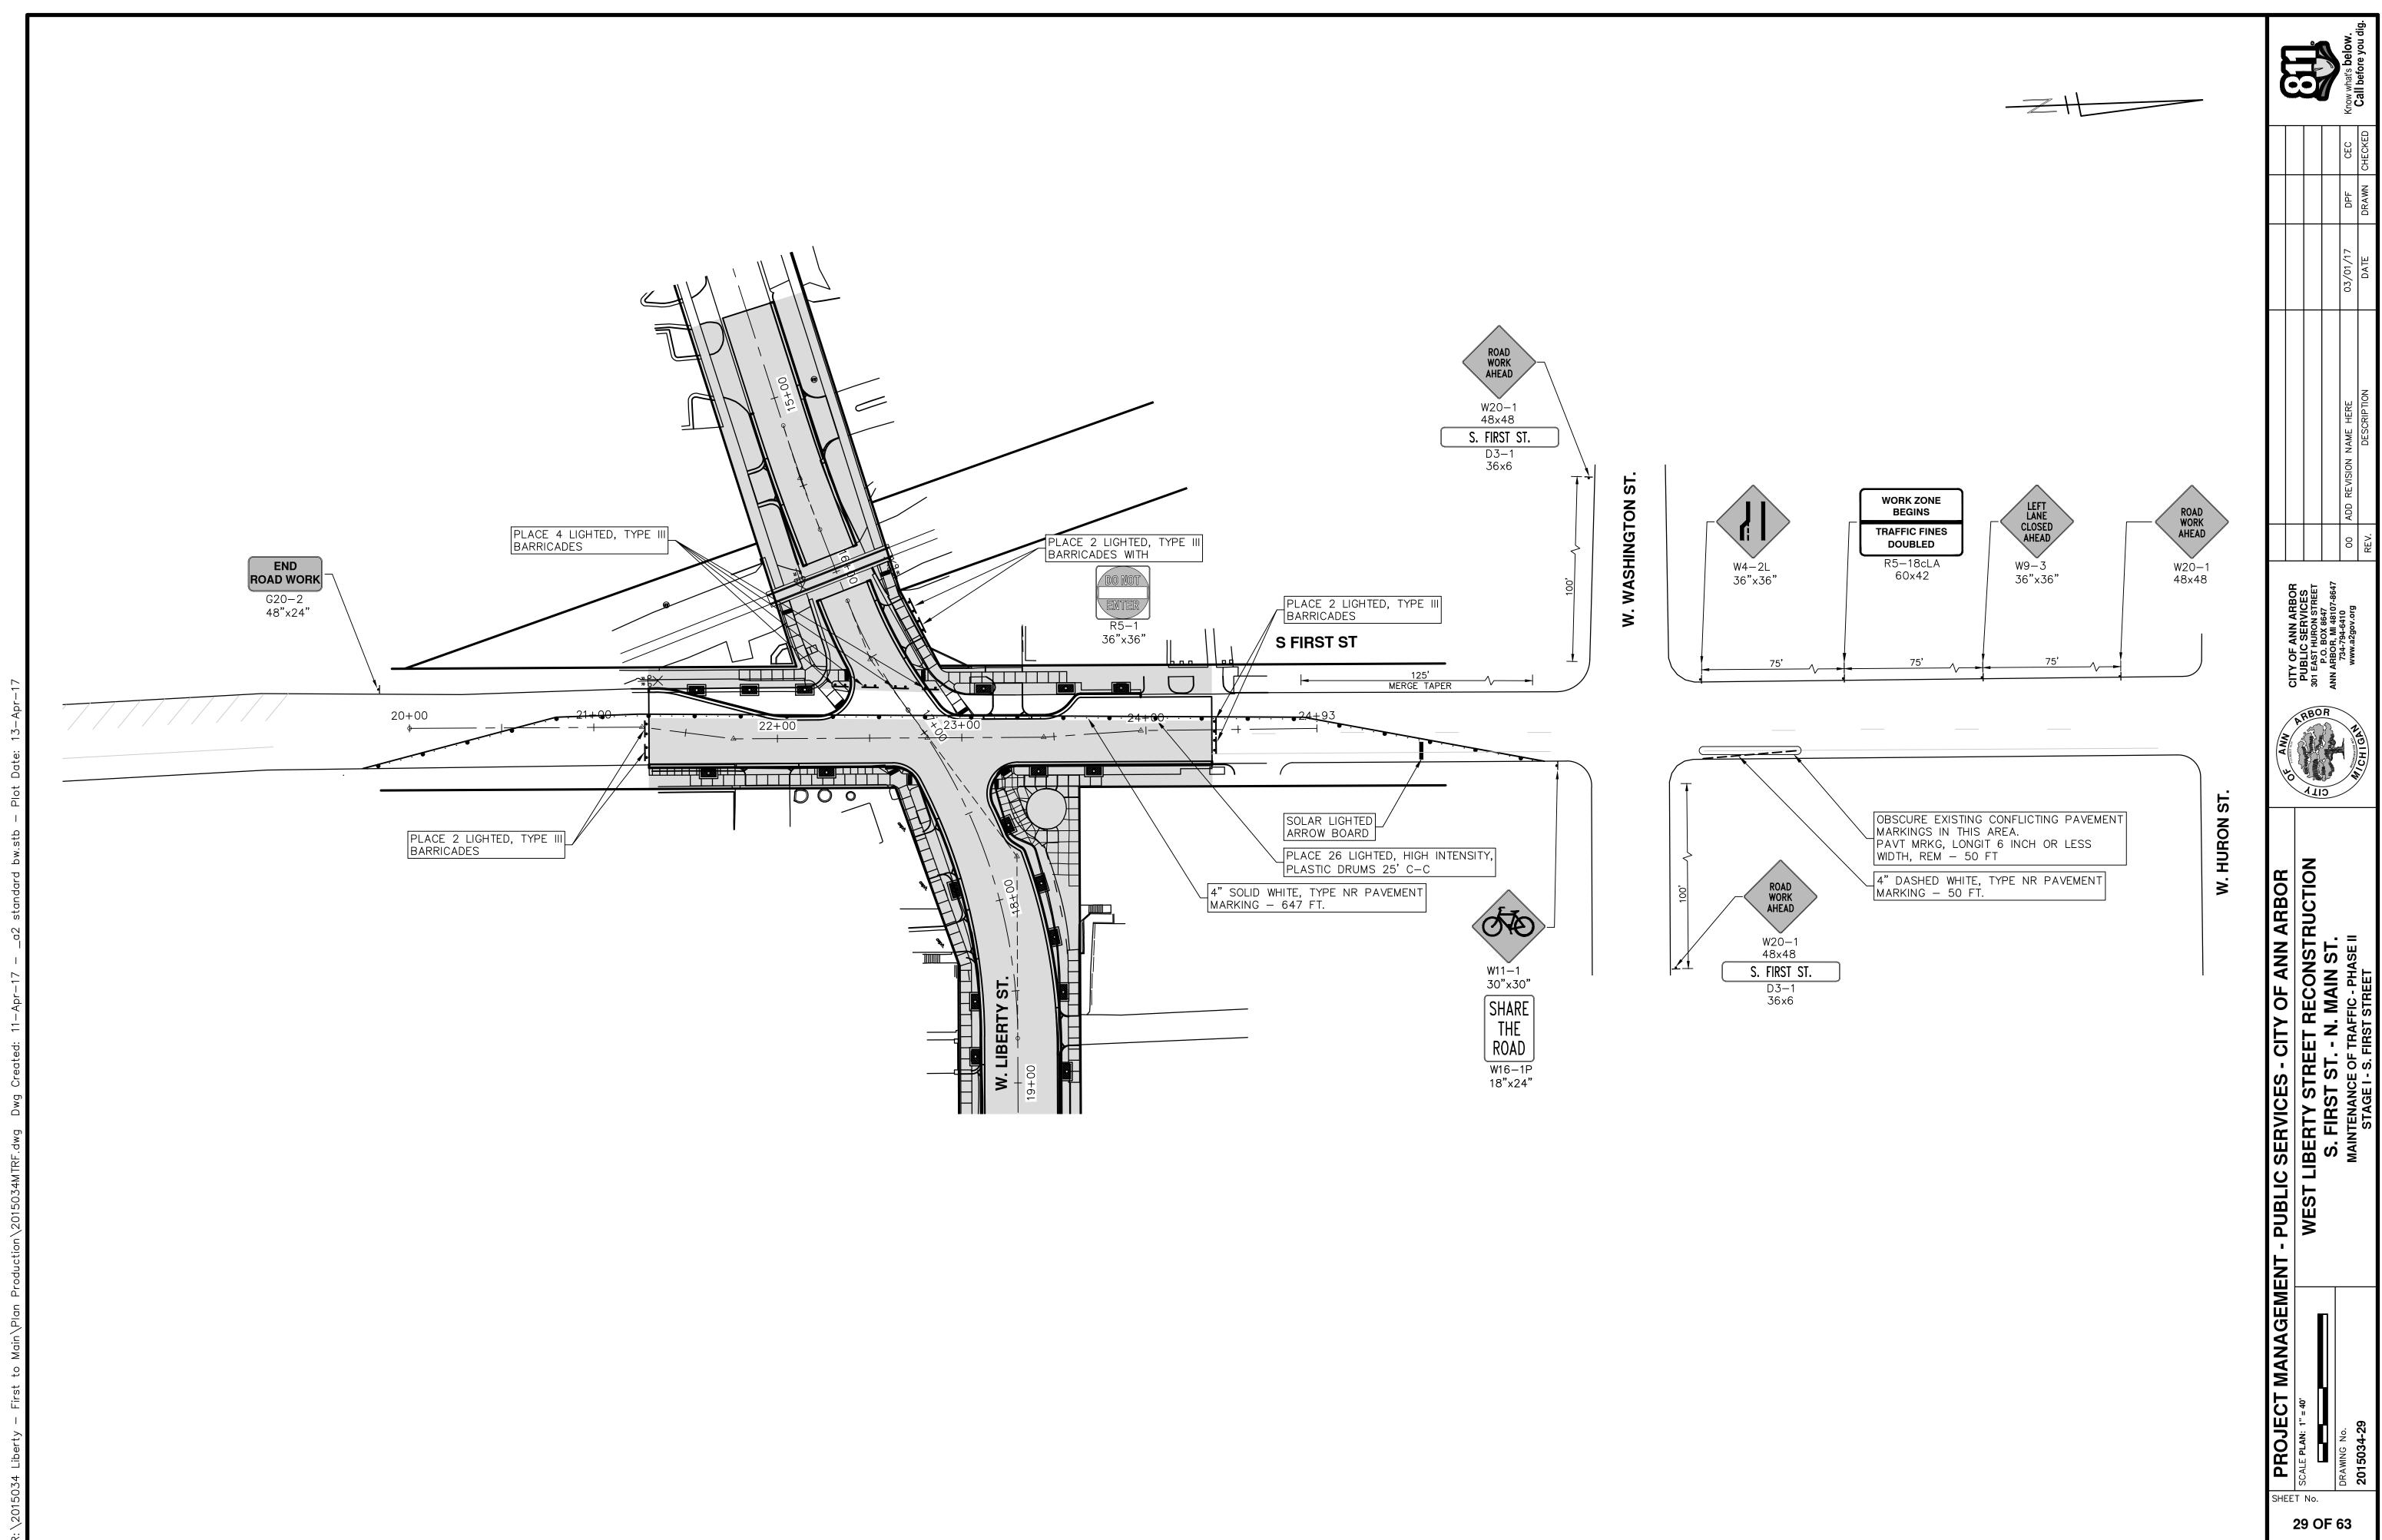
PROJECT MANAGEMENT - PUBLIC SERVICES - CITY OF ANN ARBC


WEST LIBERTY STREET RECONSTRUCT


S. FIRST ST. - N. MAIN ST.


MAINTENANCE OF TRAFFIC - PHASE I STAGE II - S. ASHLEY STREET




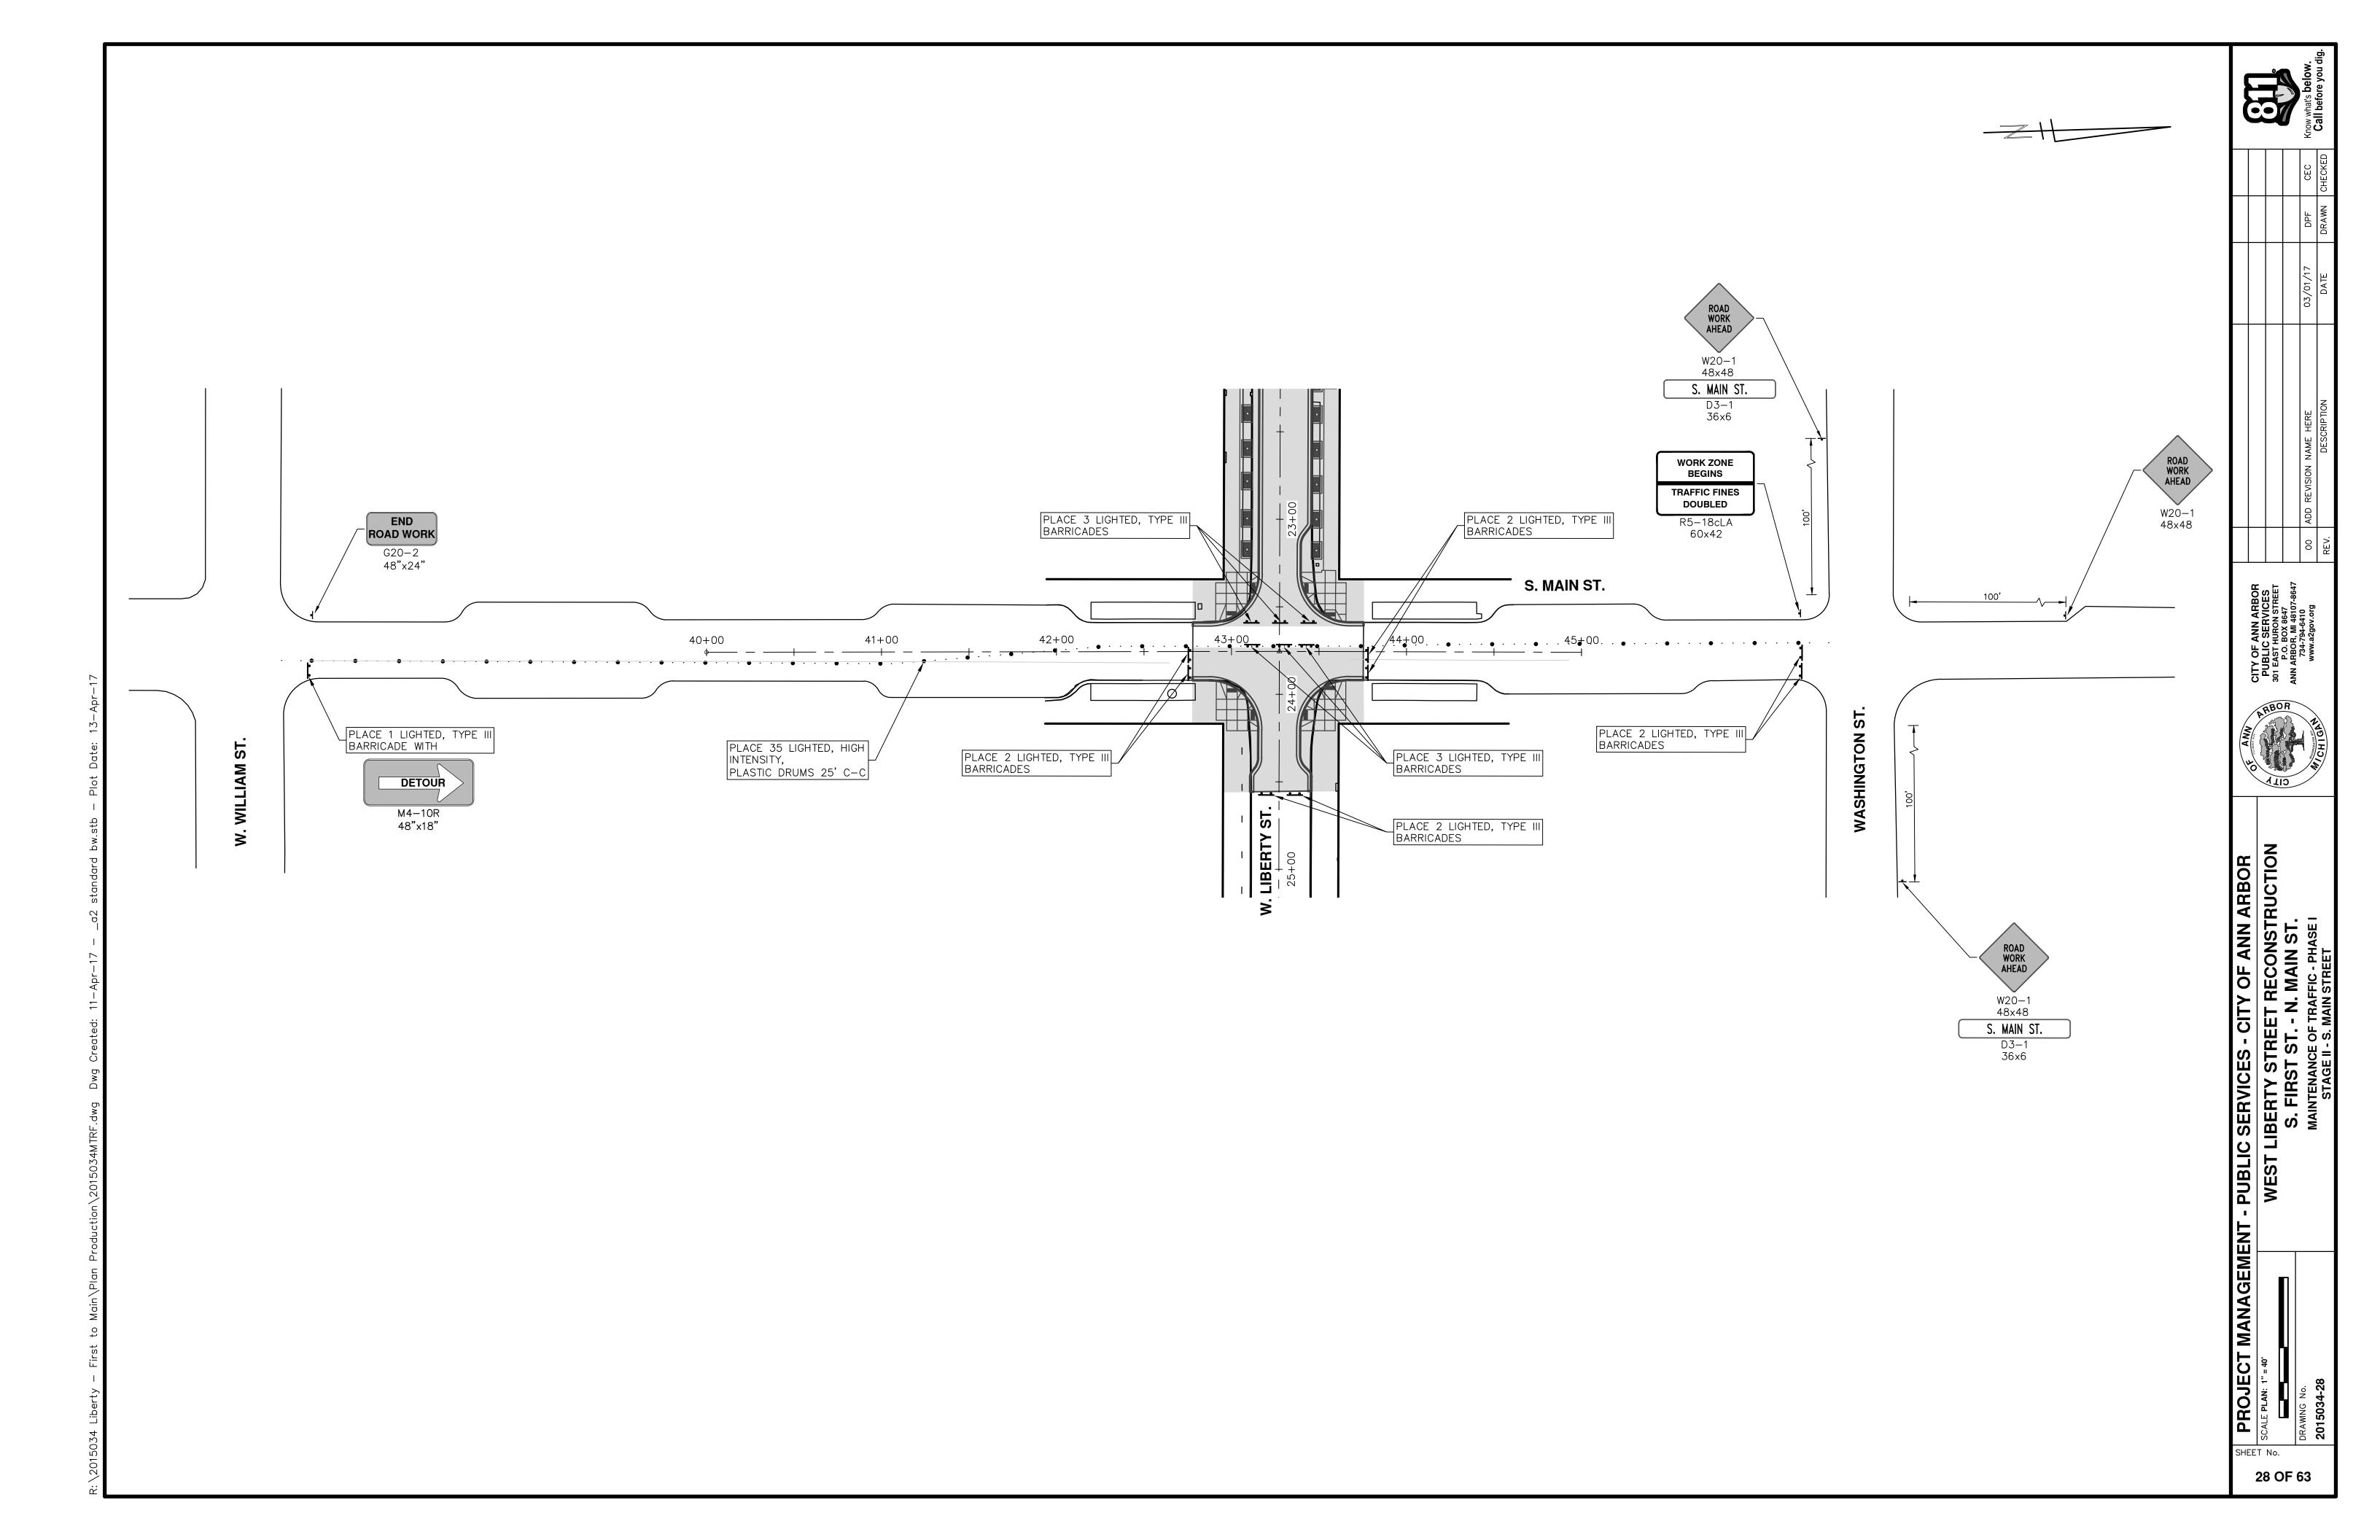

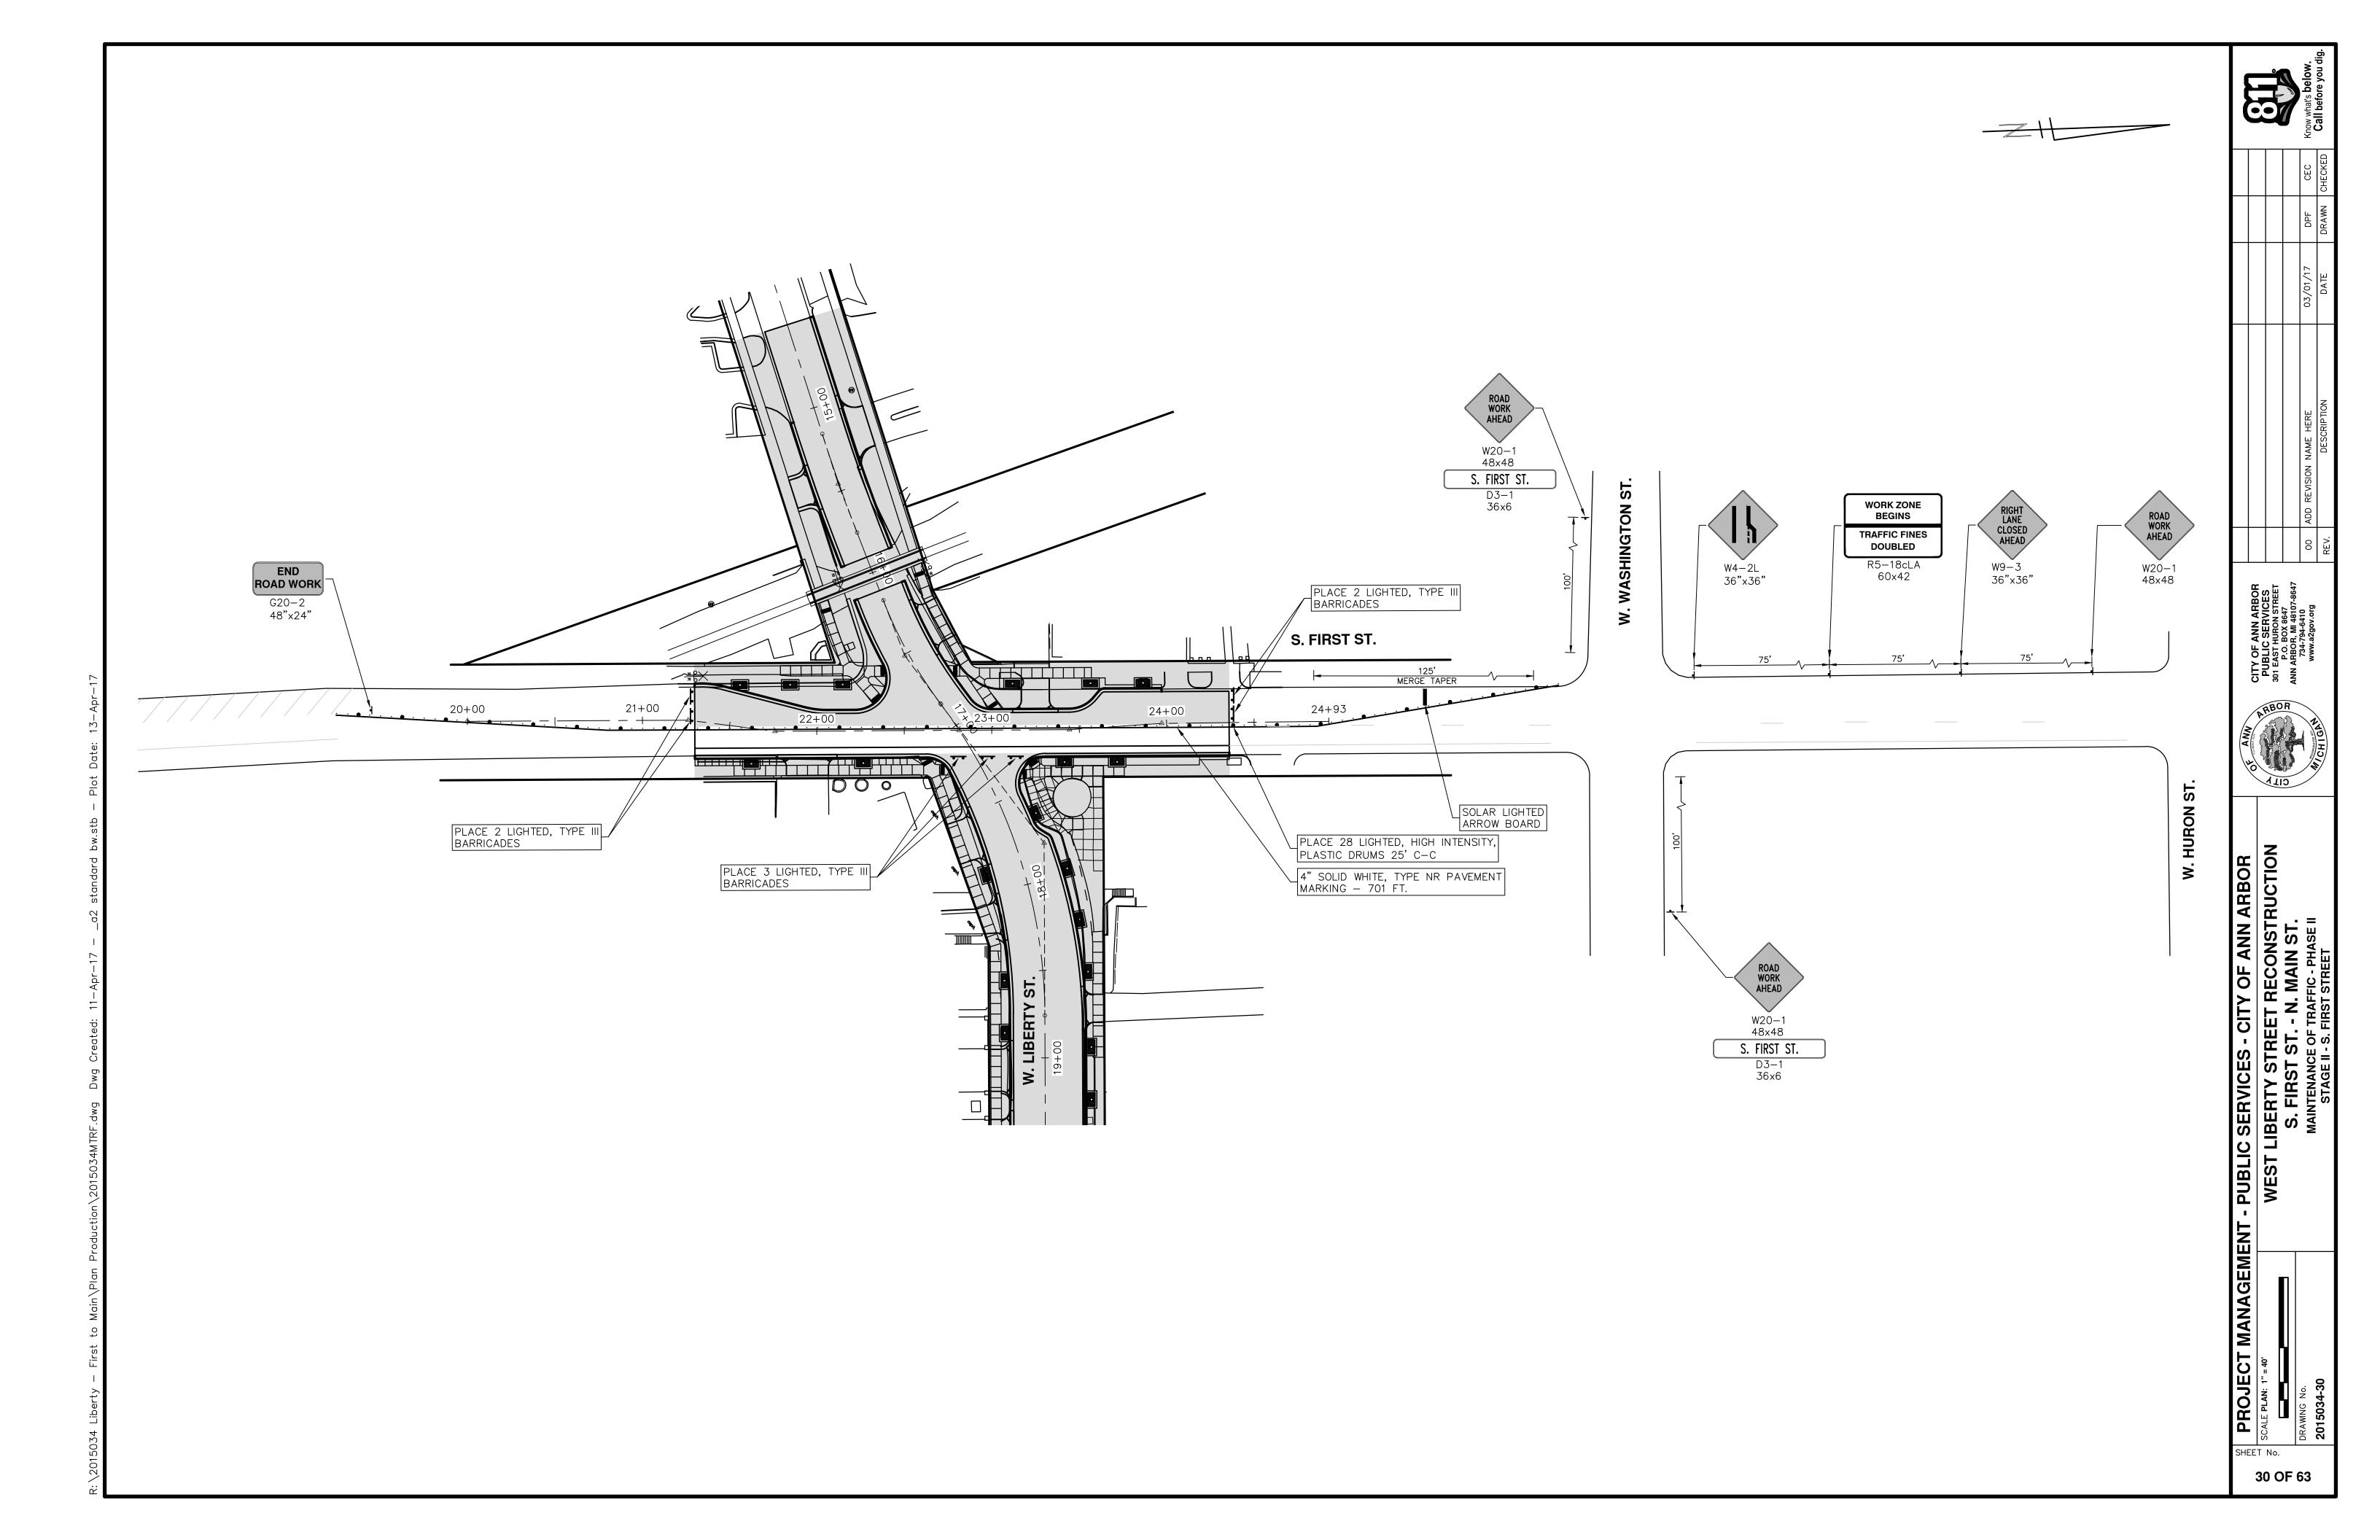

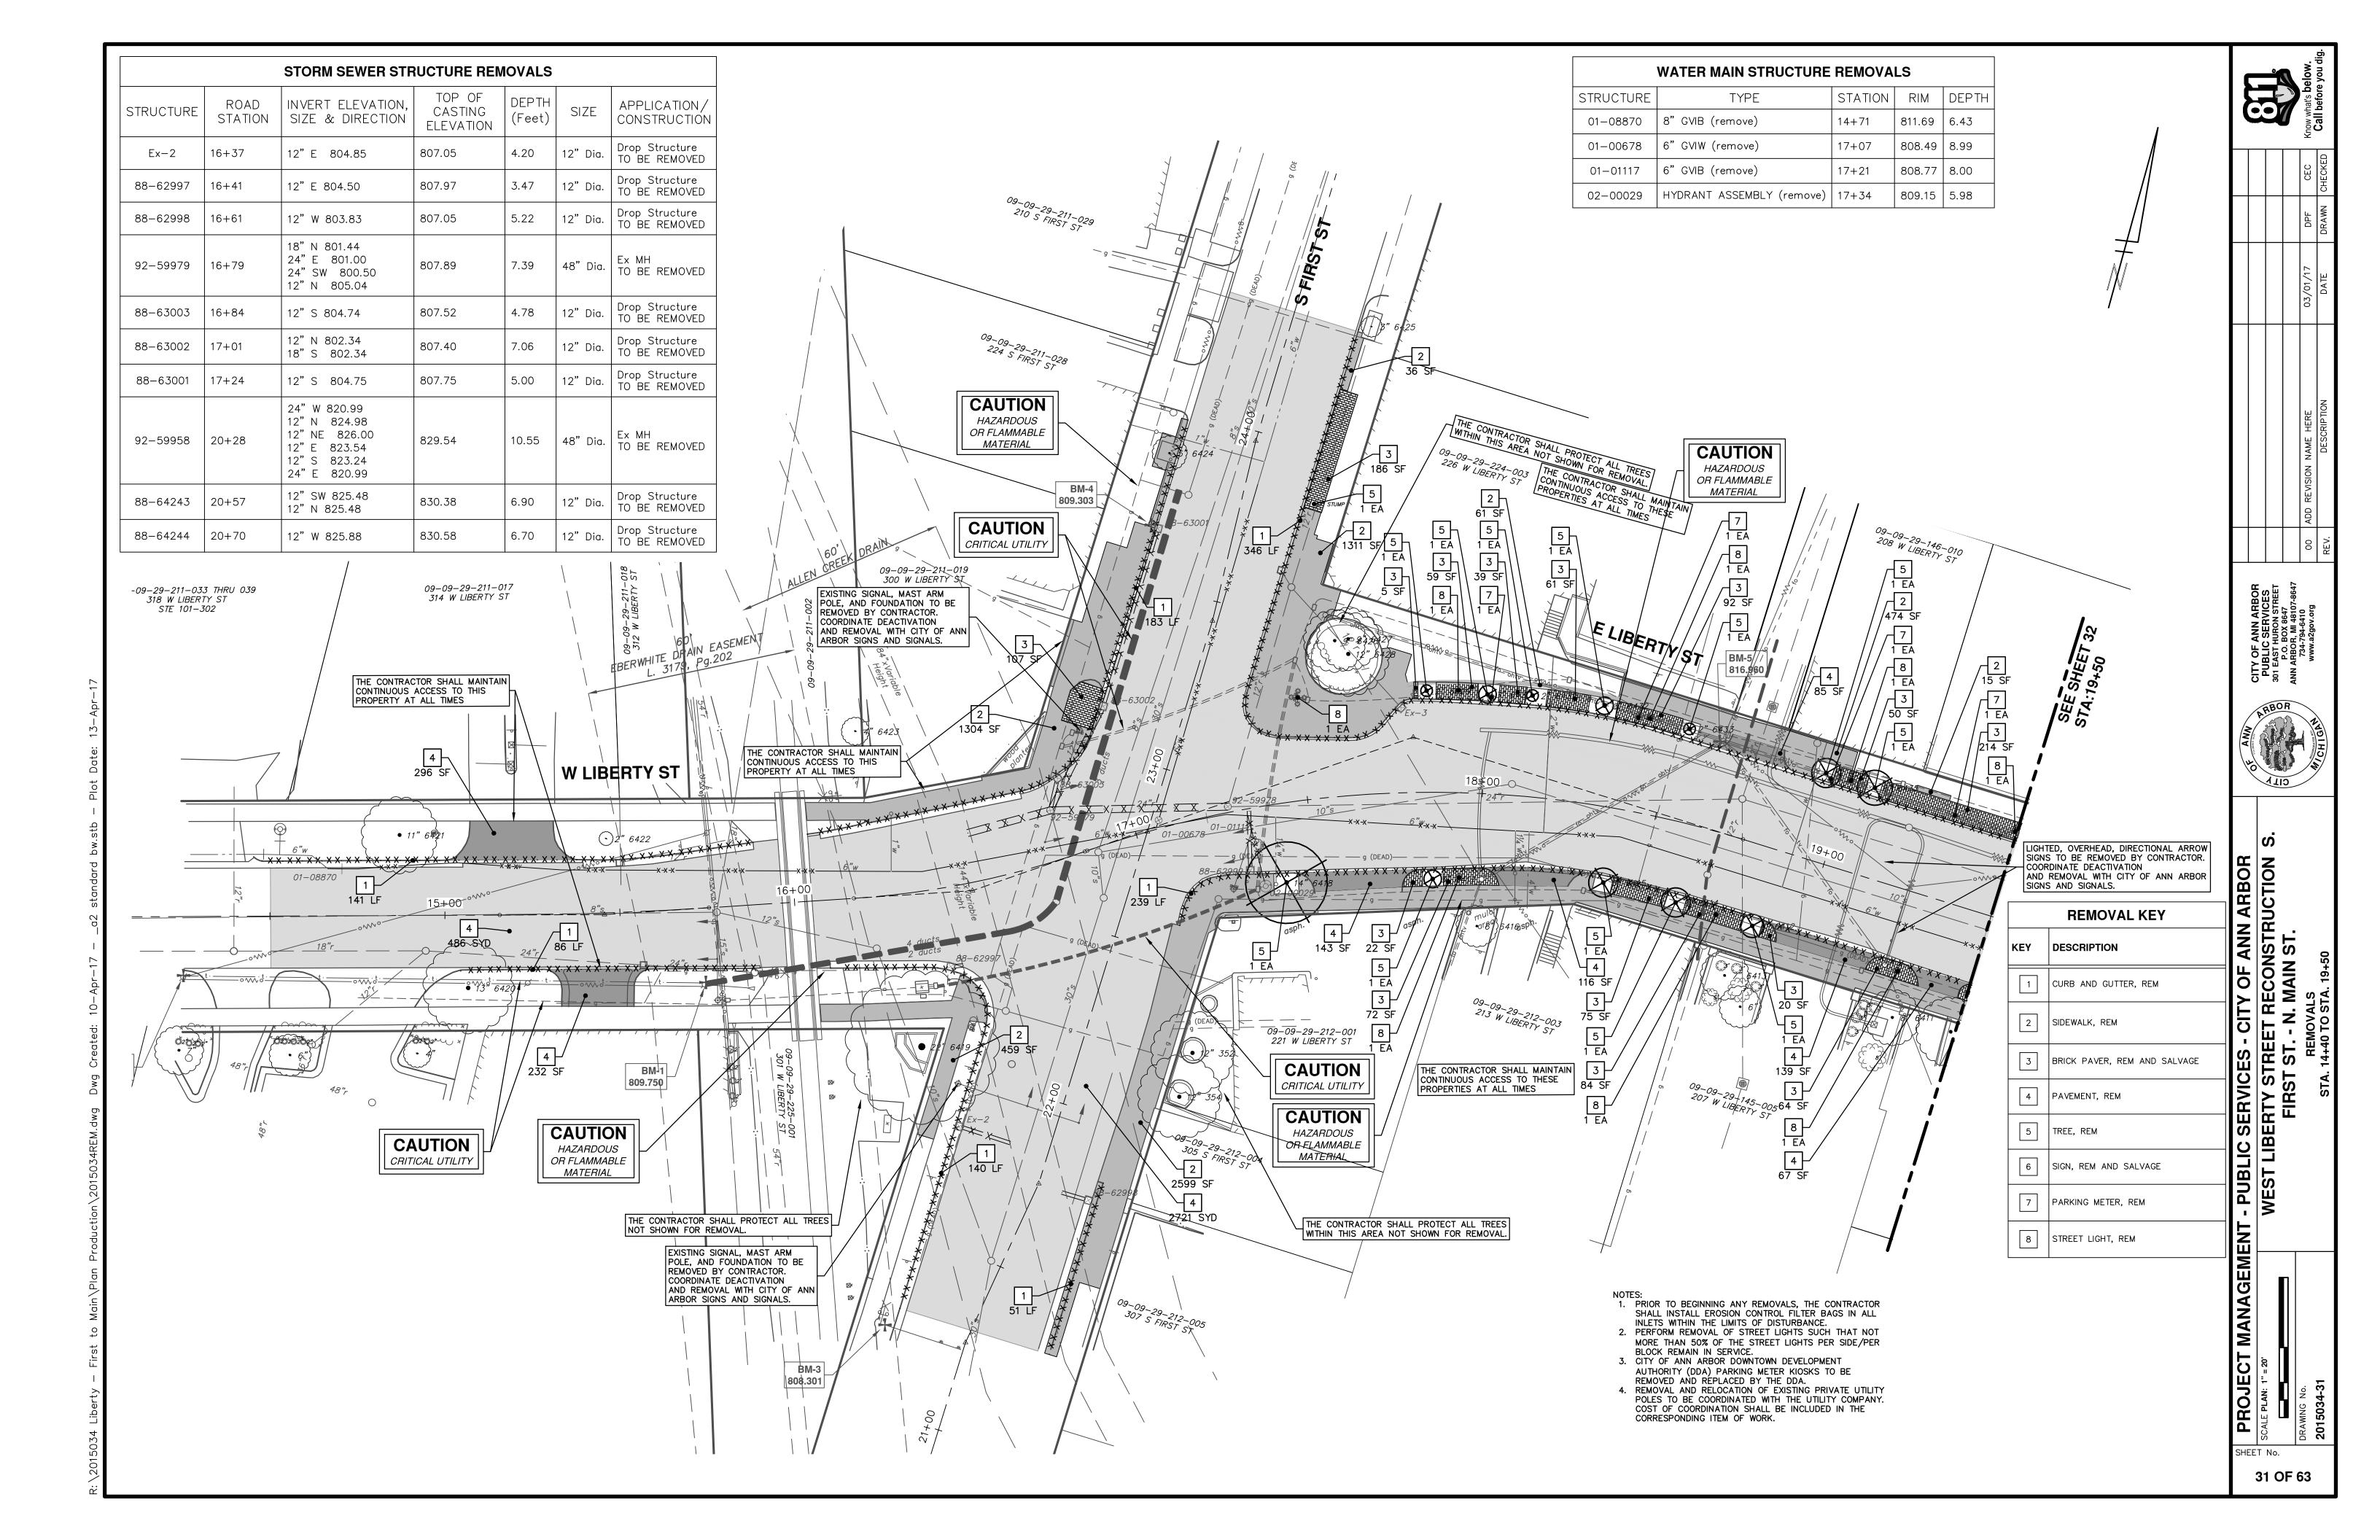

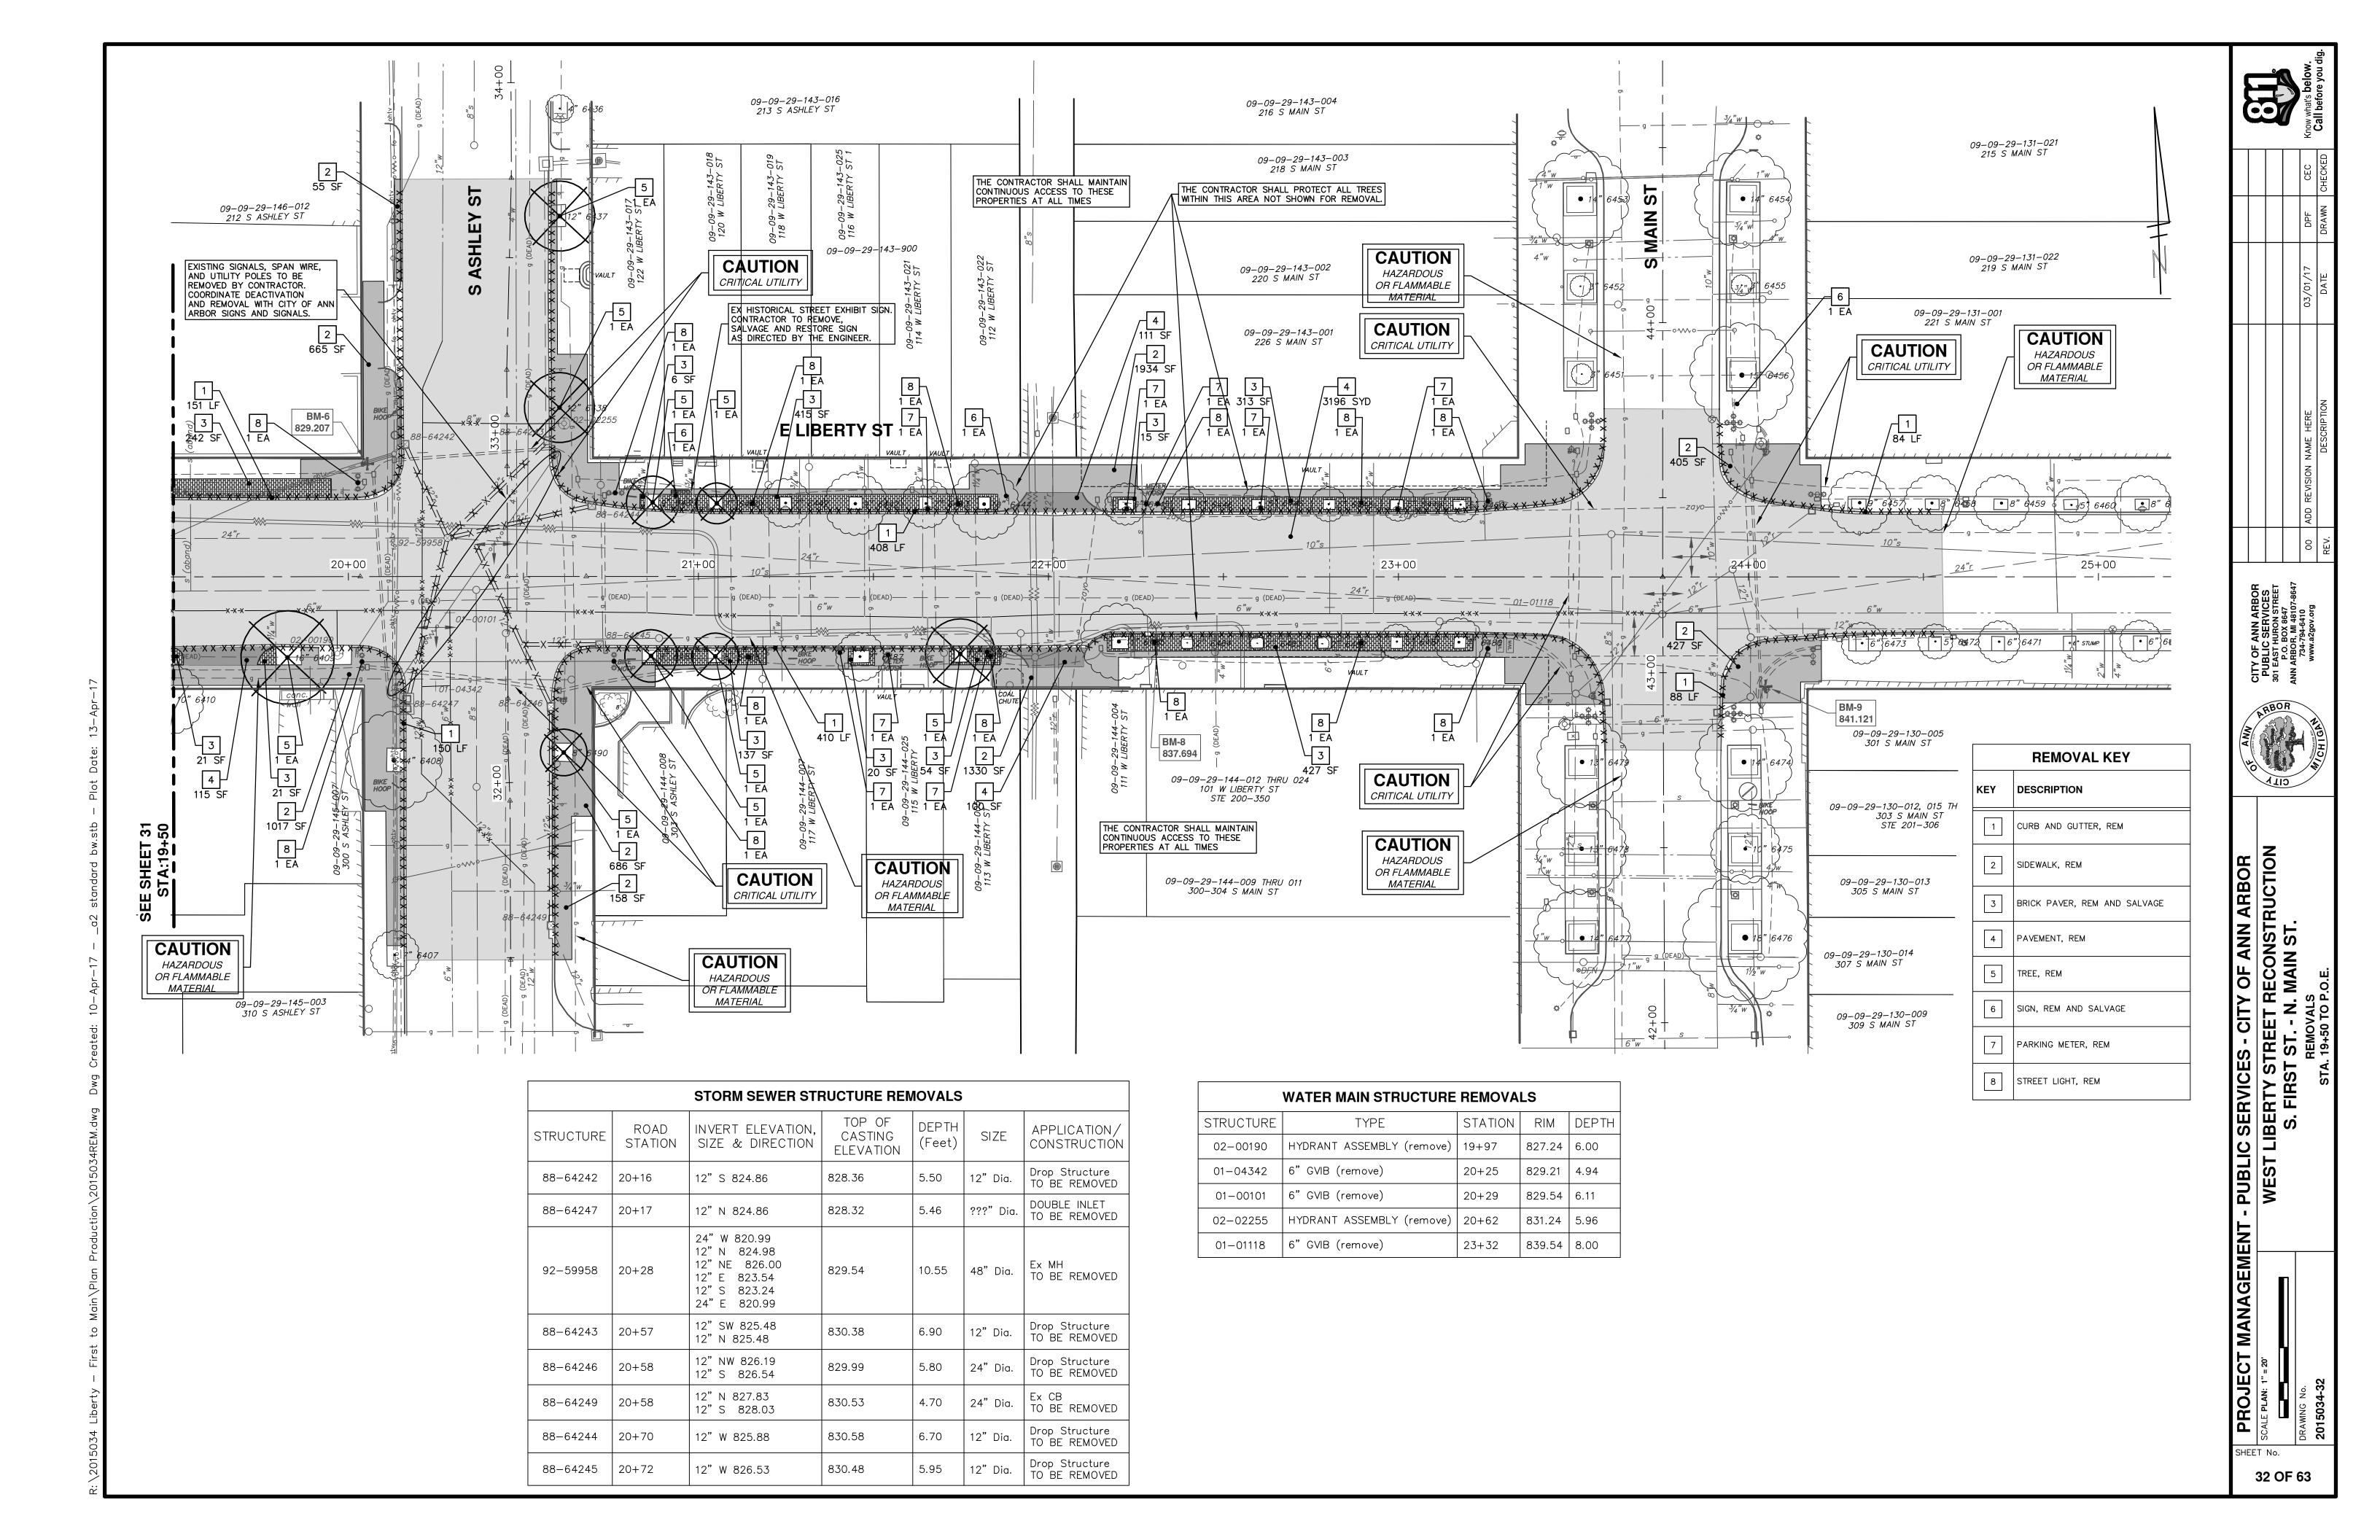

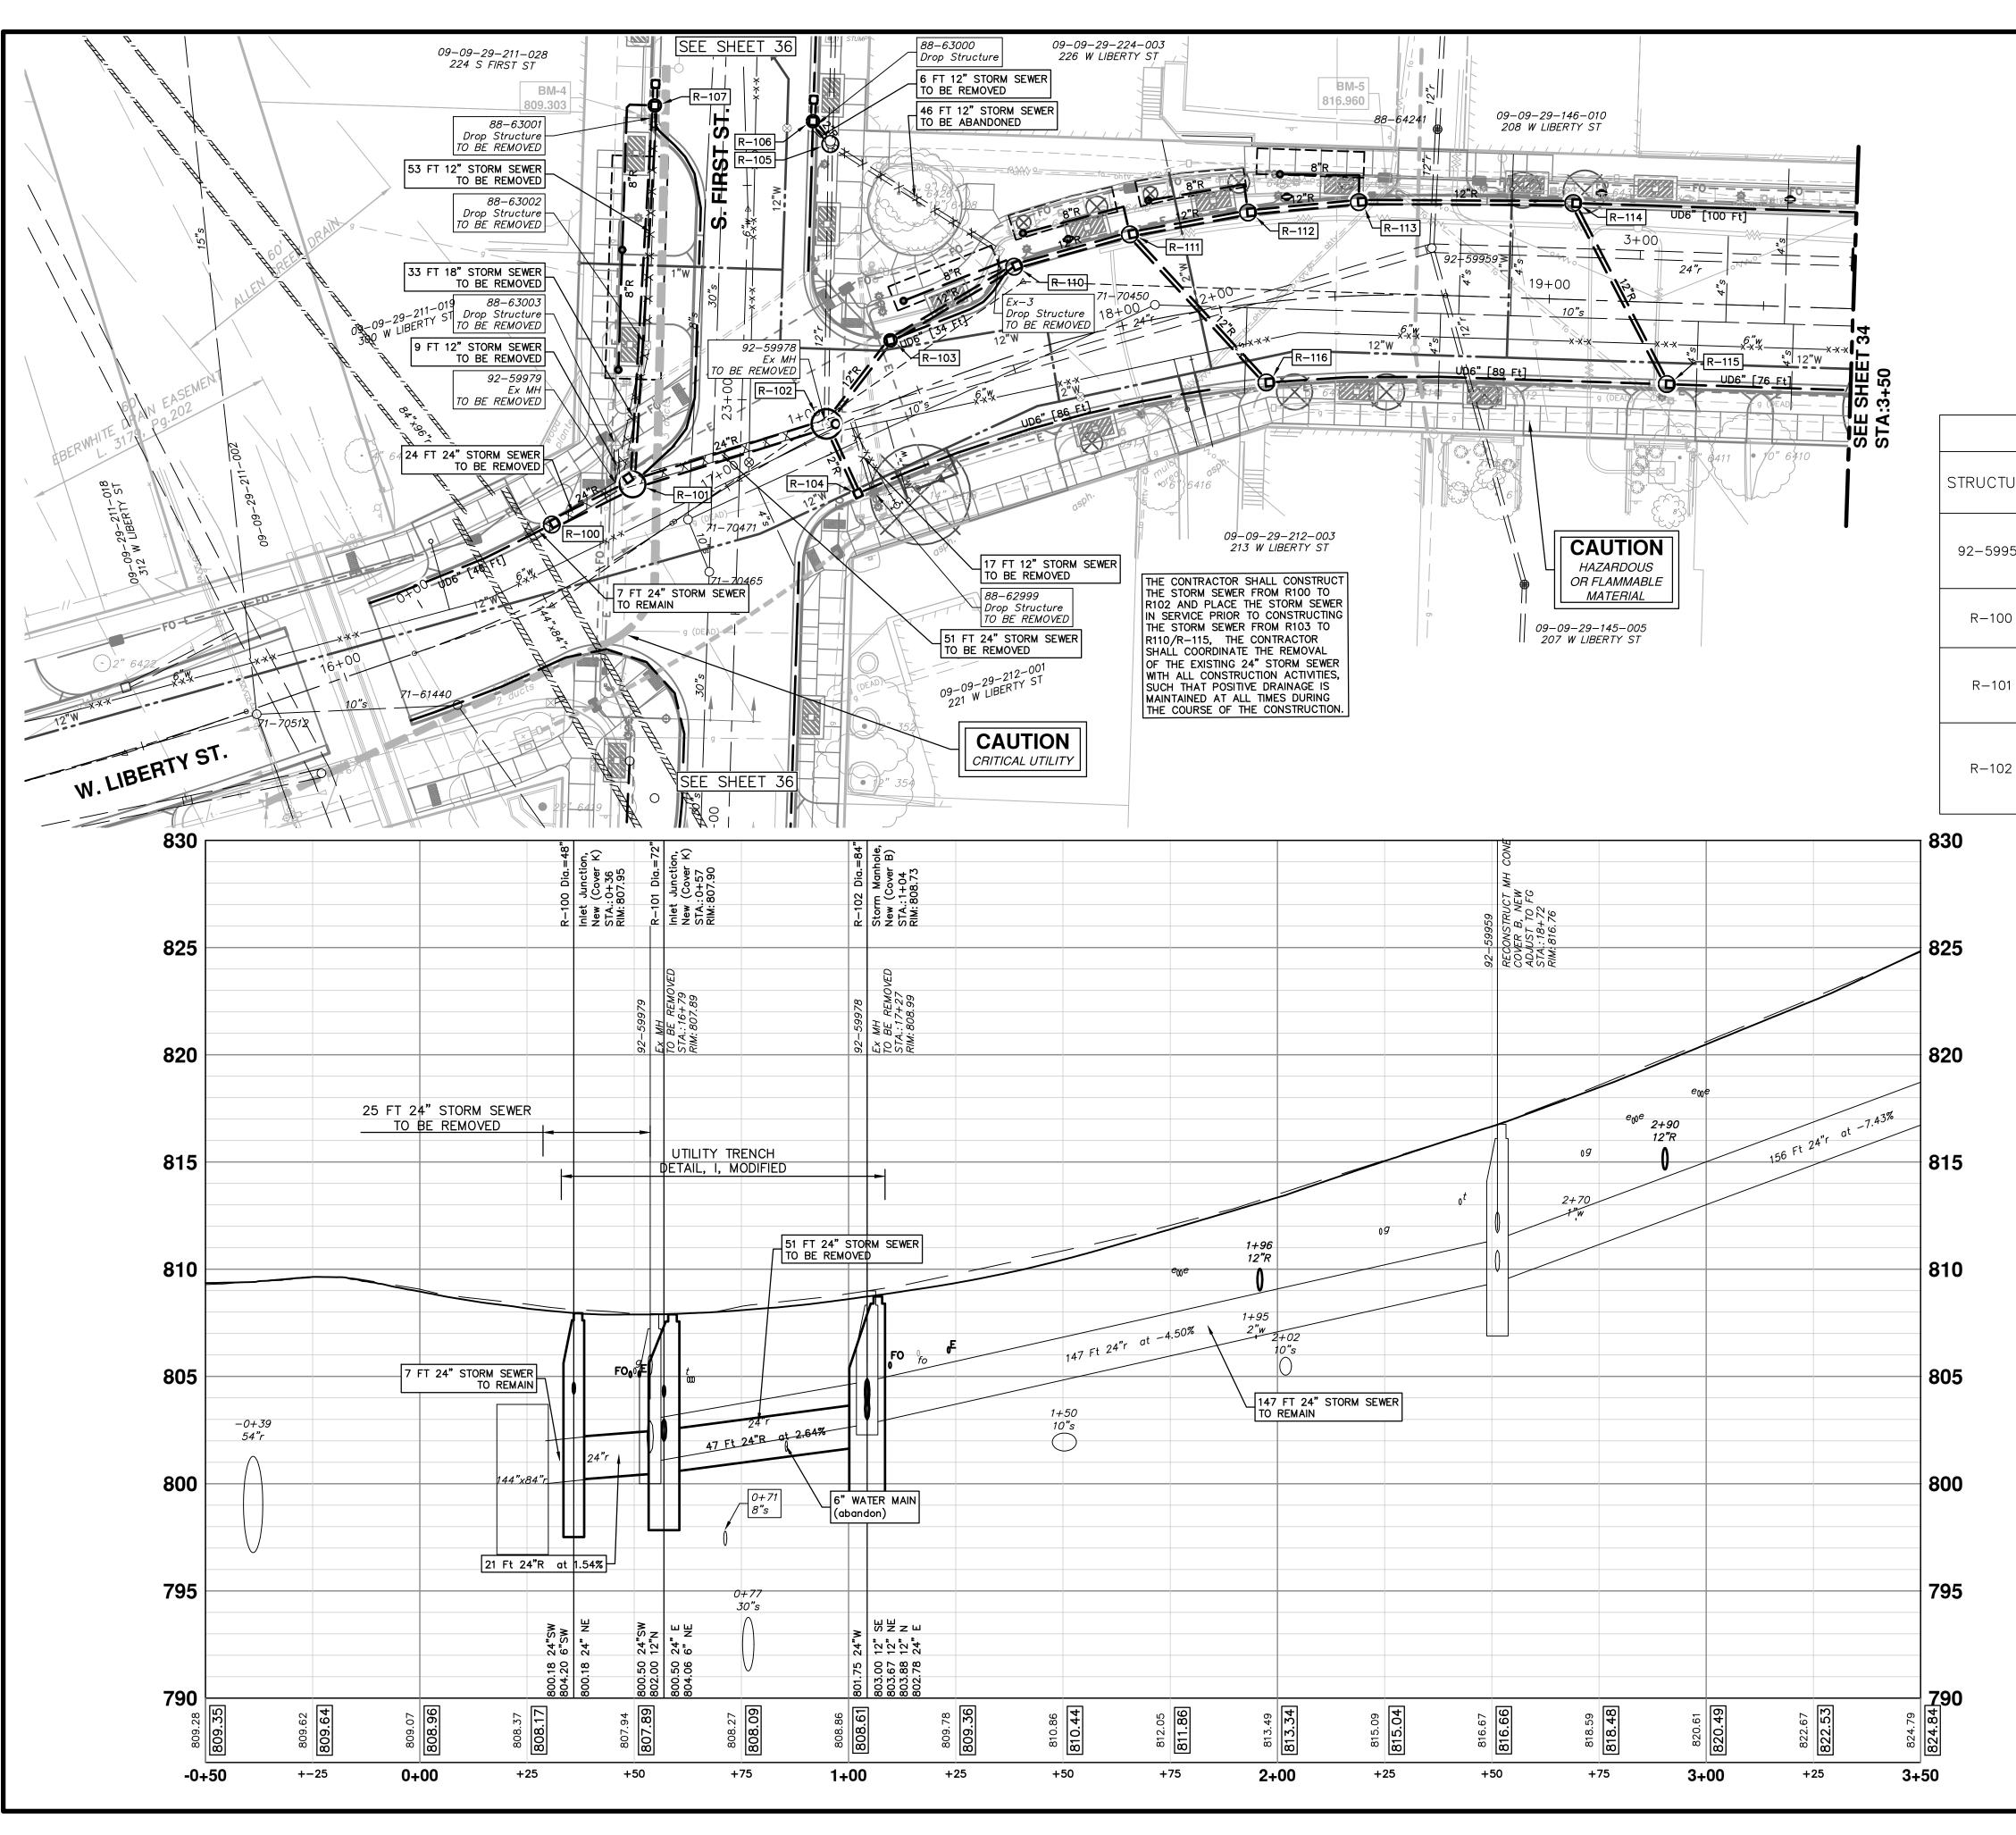

	STORM SEV	WER STRUCTU	JRE TAE	BLE	
STRUCTURE	INVERT ELEVATION, SIZE & DIRECTION	TOP OF CASTING ELEVATION	DEPTH (Feet)	SIZE	APPLICATION/ CONSTRUCTION
92-59959	24" W 809.39 12" S 809.89 24" E 809.39 12" N 811.69	816.76	9.37	48" Dia.	RECONSTRUCT MH CONE COVER B, NEW ADJUST TO FG
R-100	24" NE 800.18 24" SW 800.18 6" SW 804.20	807.95	9.78	48" Dia.	Inlet Junction, New (Cover K)
R-101	24" E 800.50 6" NE 804.06 24" SW 800.50 12" N 802.00	807.90	9.40	72" Dia.	Inlet Junction, New (Cover K)
R-102	12" SE 803.00 12" NE 803.67 12" N 803.88 24" E 802.78 24" W 801.75	808.73	8.98	84" Dia.	Storm Manhole, New (Cover B)

NOTE:
AN APPROPRIATE METHOD OF STORM WATER DIVERSION AND TEMPORARY
CONTROL FOR RE-ALIGNING THE 24-INCH STORM SEWER AS SHOWN IN THE
PLANS SHALL BE PROPOSED BY THE CONTRACTOR AND APPROVED BY THE

THE CONTRACTOR SHALL SUBMIT TO THE ENGINEER A PLAN CONTAINING CONSTRUCTION SEQUENCES AND SHOP DRAWINGS FOR MAINTAINING STORM FLOW AND FOR INSTALLING, MAINTAINING, AND REMOVING CONTROL ITEMS FOR THE 24" STORM SEWER WHILE CONSTRUCTING THE REALIGNED STORM SEWER.

FOR EACH SUBMITTAL OR RESUBMITTAL, THE CONTRACTOR SHALL ALLOW AT LEAST 14 CALENDAR DAYS FROM THE DATE OF THE SUBMITTAL TO RECEIVE THE ENGINEER'S ACCEPTANCE OR REQUEST FOR REVISIONS. THE ENGINEER'S COMMENTS SHALL BE INCORPORATED INTO THE SUBMITTED PLANS, CALCULATIONS, AND DESCRIPTIONS. THE ENGINEER'S ACCEPTANCE IS REQUIRED BEFORE BEGINNING THE WORK. RESUBMITTALS MAY TAKE LESS THAN 14 CALENDAR DAYS DEPENDING ON THE MAGNITUDE OF REVISIONS REQUESTED. REQUIRED REVISIONS WILL NOT BE A BASIS OF PAYMENT FOR ADDITIONAL COMPENSATION, EXTRA WORK, OR AN EXTENSION OF CONTRACT TIME. THE CONTRACTOR SHALL INCLUDE TIME FOR THIS ENTIRE REVIEW PROCESS IN THEIR CPM NETWORK.

Know what's below.


ADD REVISION NAME HERE

DESCRIPTION

DATE

DRAWN

CILY OF ANN ARBOR
PUBLIC SERVICES
301 EAST HURON STREET
P.O. BOX 8647
ANN ARBOR, MI 48107-8647
734-794-6410
www.a2gov.org

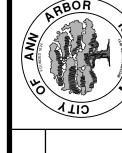


- PUBLIC SERVICES - CITY OF ANN ARBOF
WEST LIBERTY STREET RECONSTRUCTION
FIRST ST. - N. MAIN ST.
STORM SEWER PLAN AND PROFILE
W LIBERTY STORM - STA. 0+00 - STA. 3+50


B SCALE PLAN: 1" = 20' PROFILE: 1" = 2' WEST LIBE


SCALE PLAN: 1" = 20' PROFILE: 1" = 2' WEST LIBE


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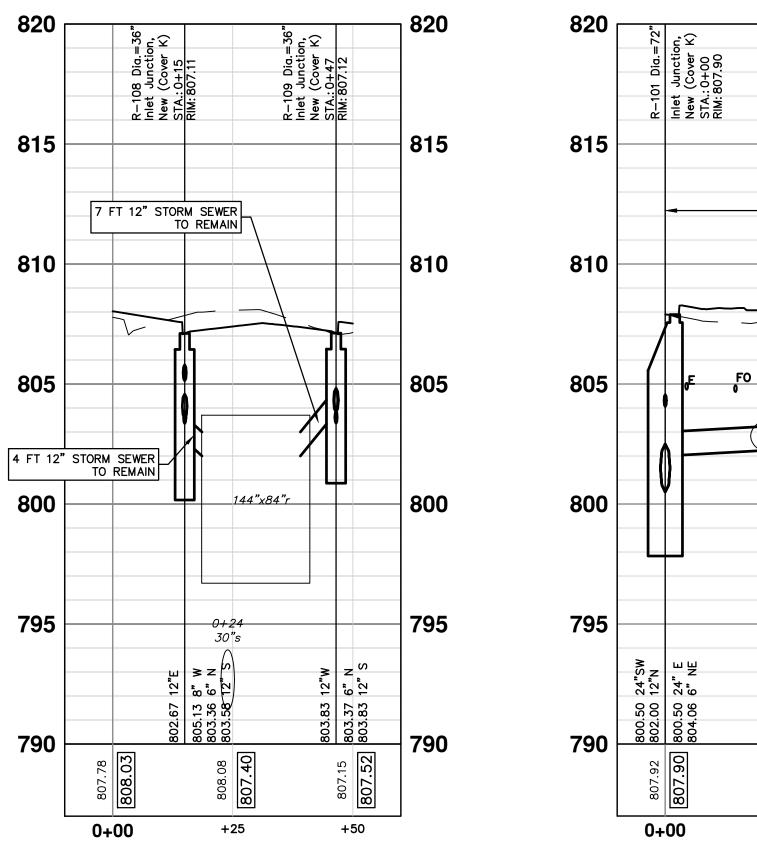
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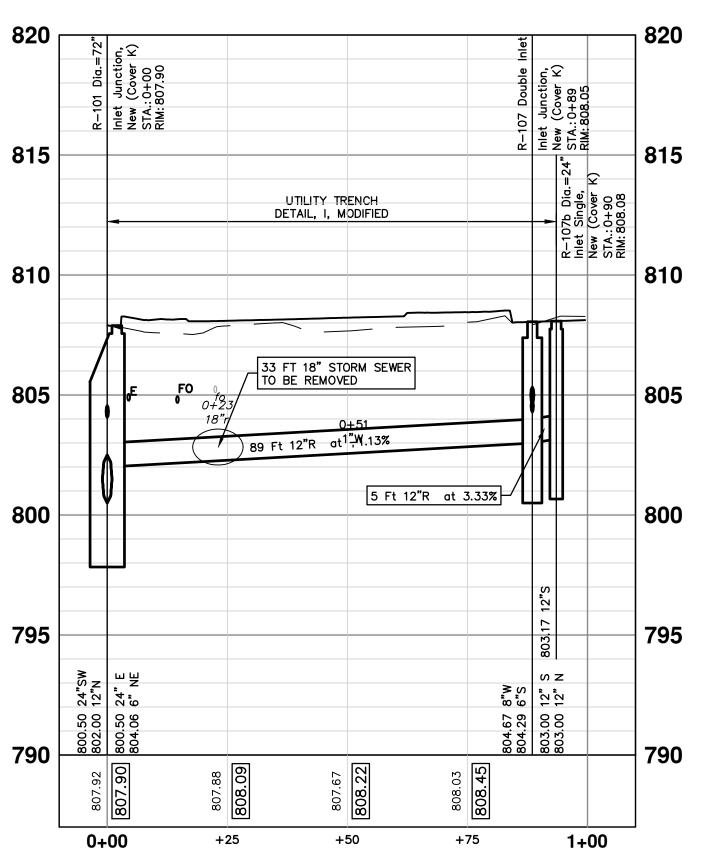





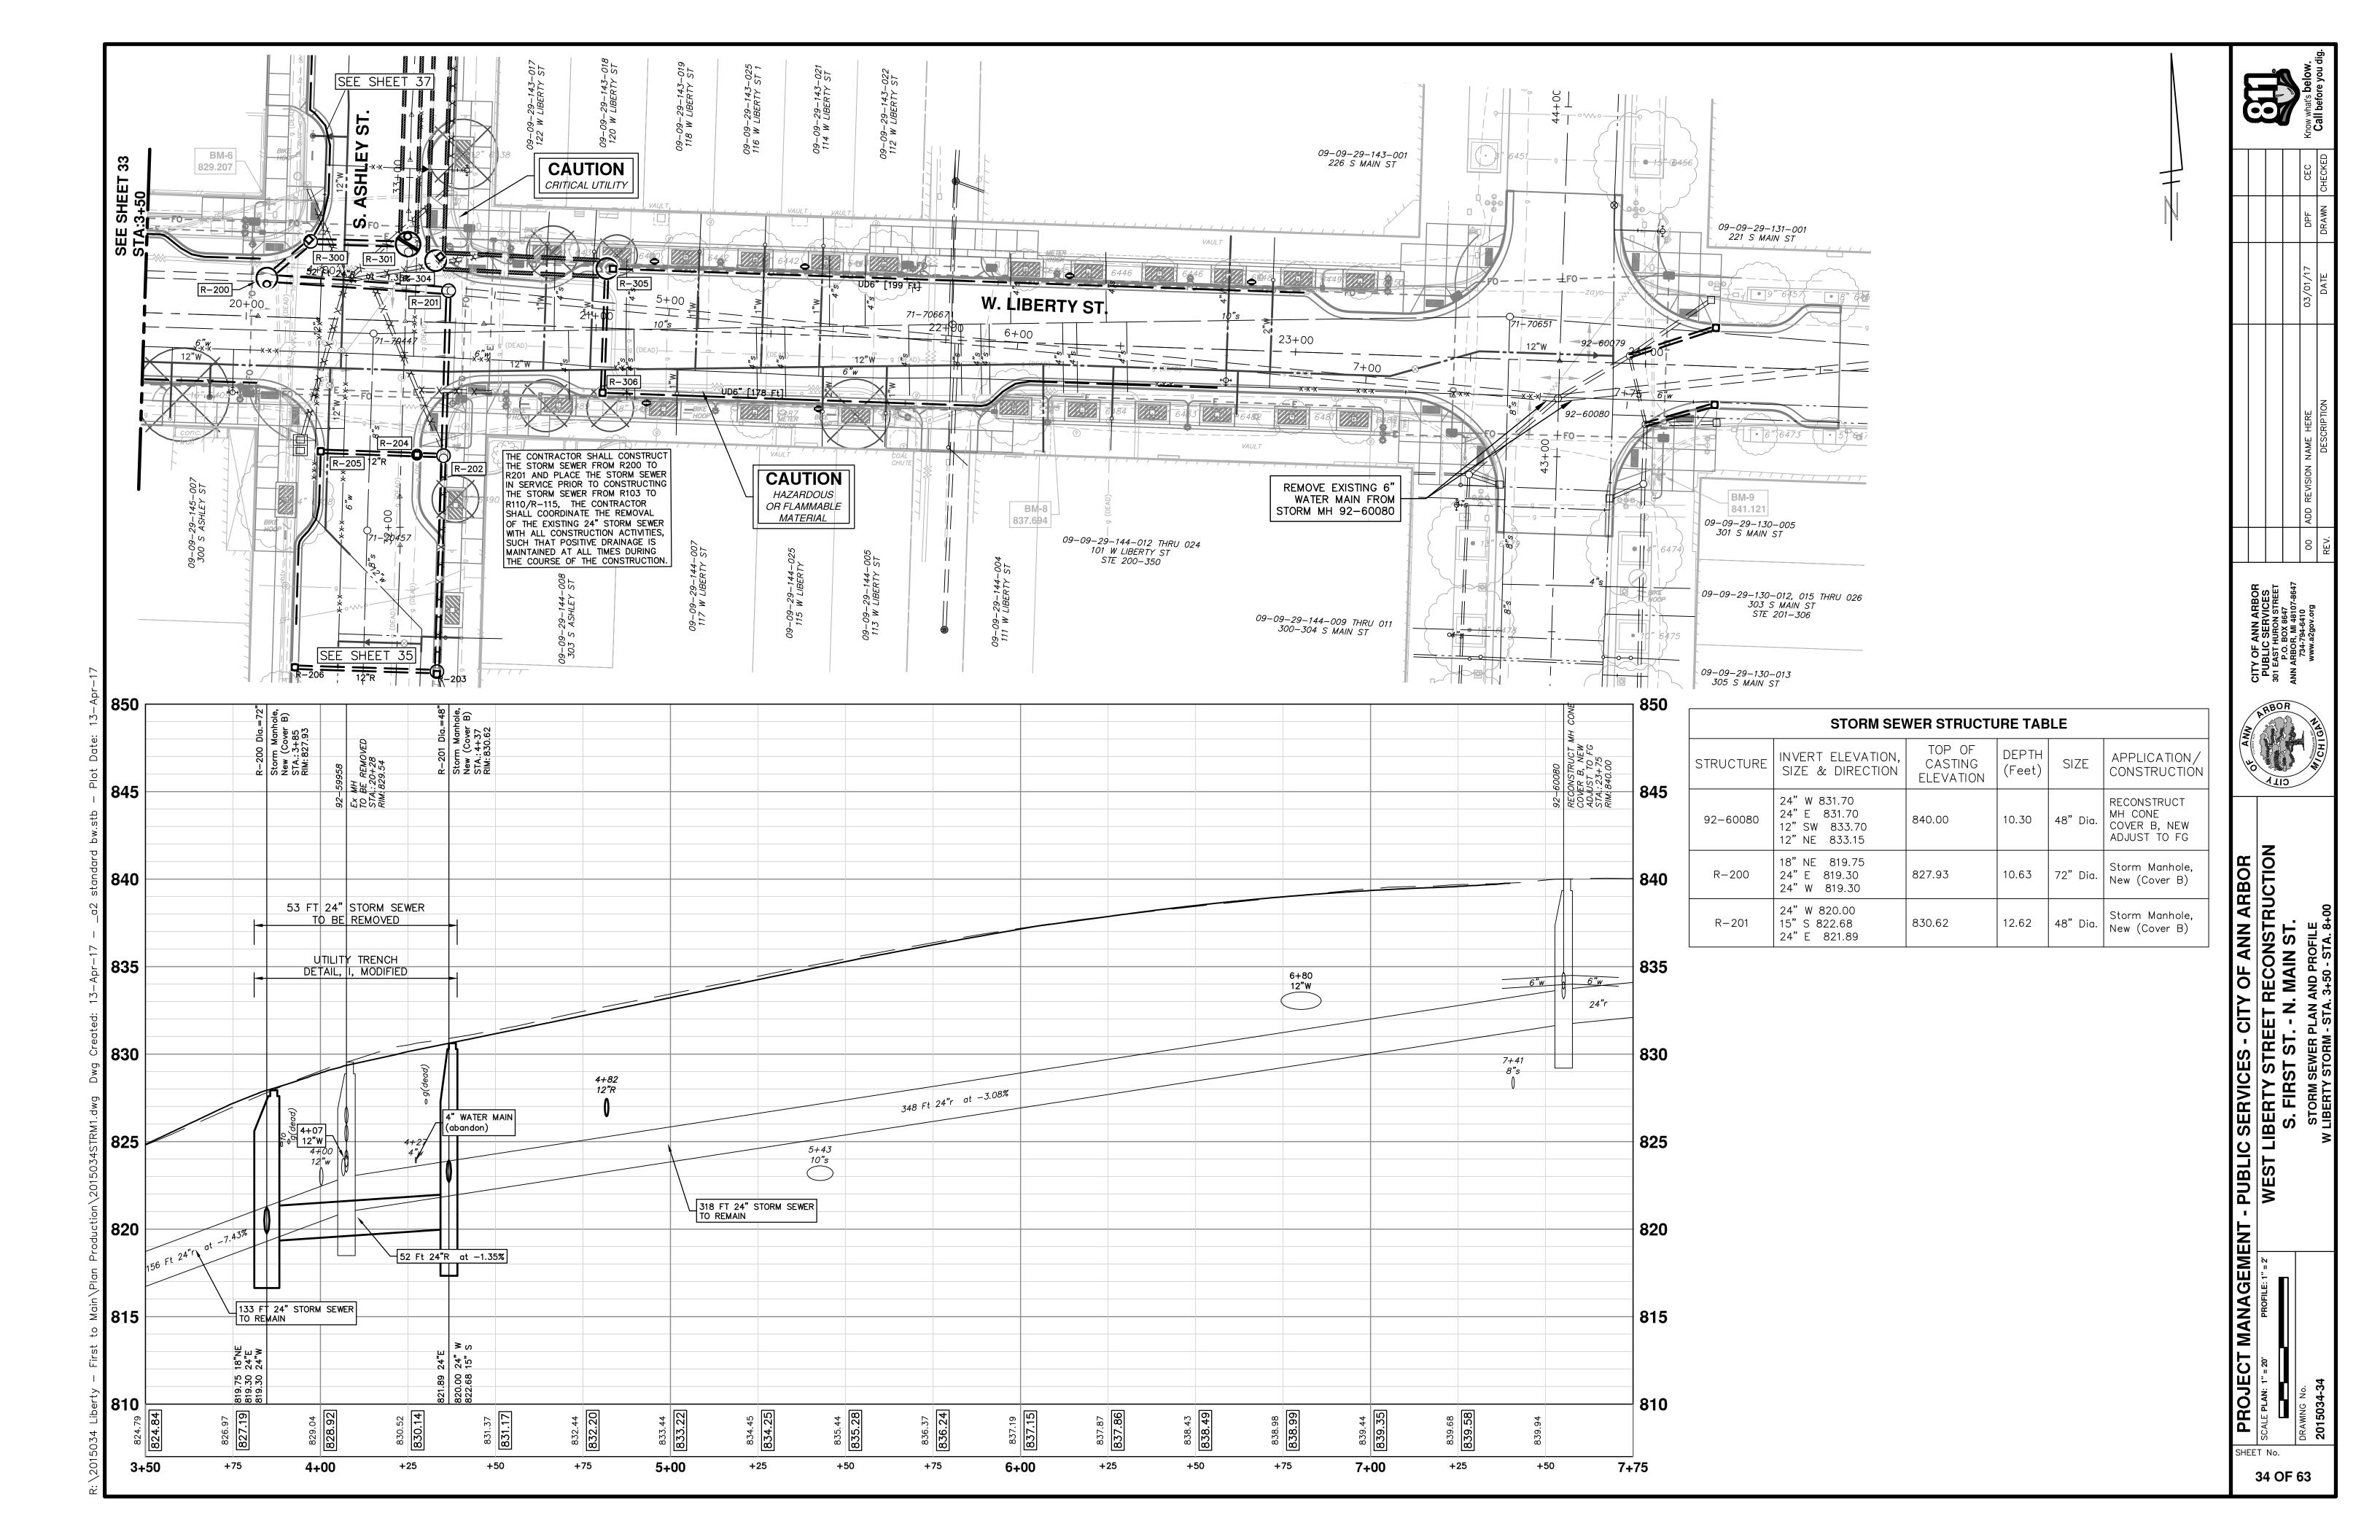

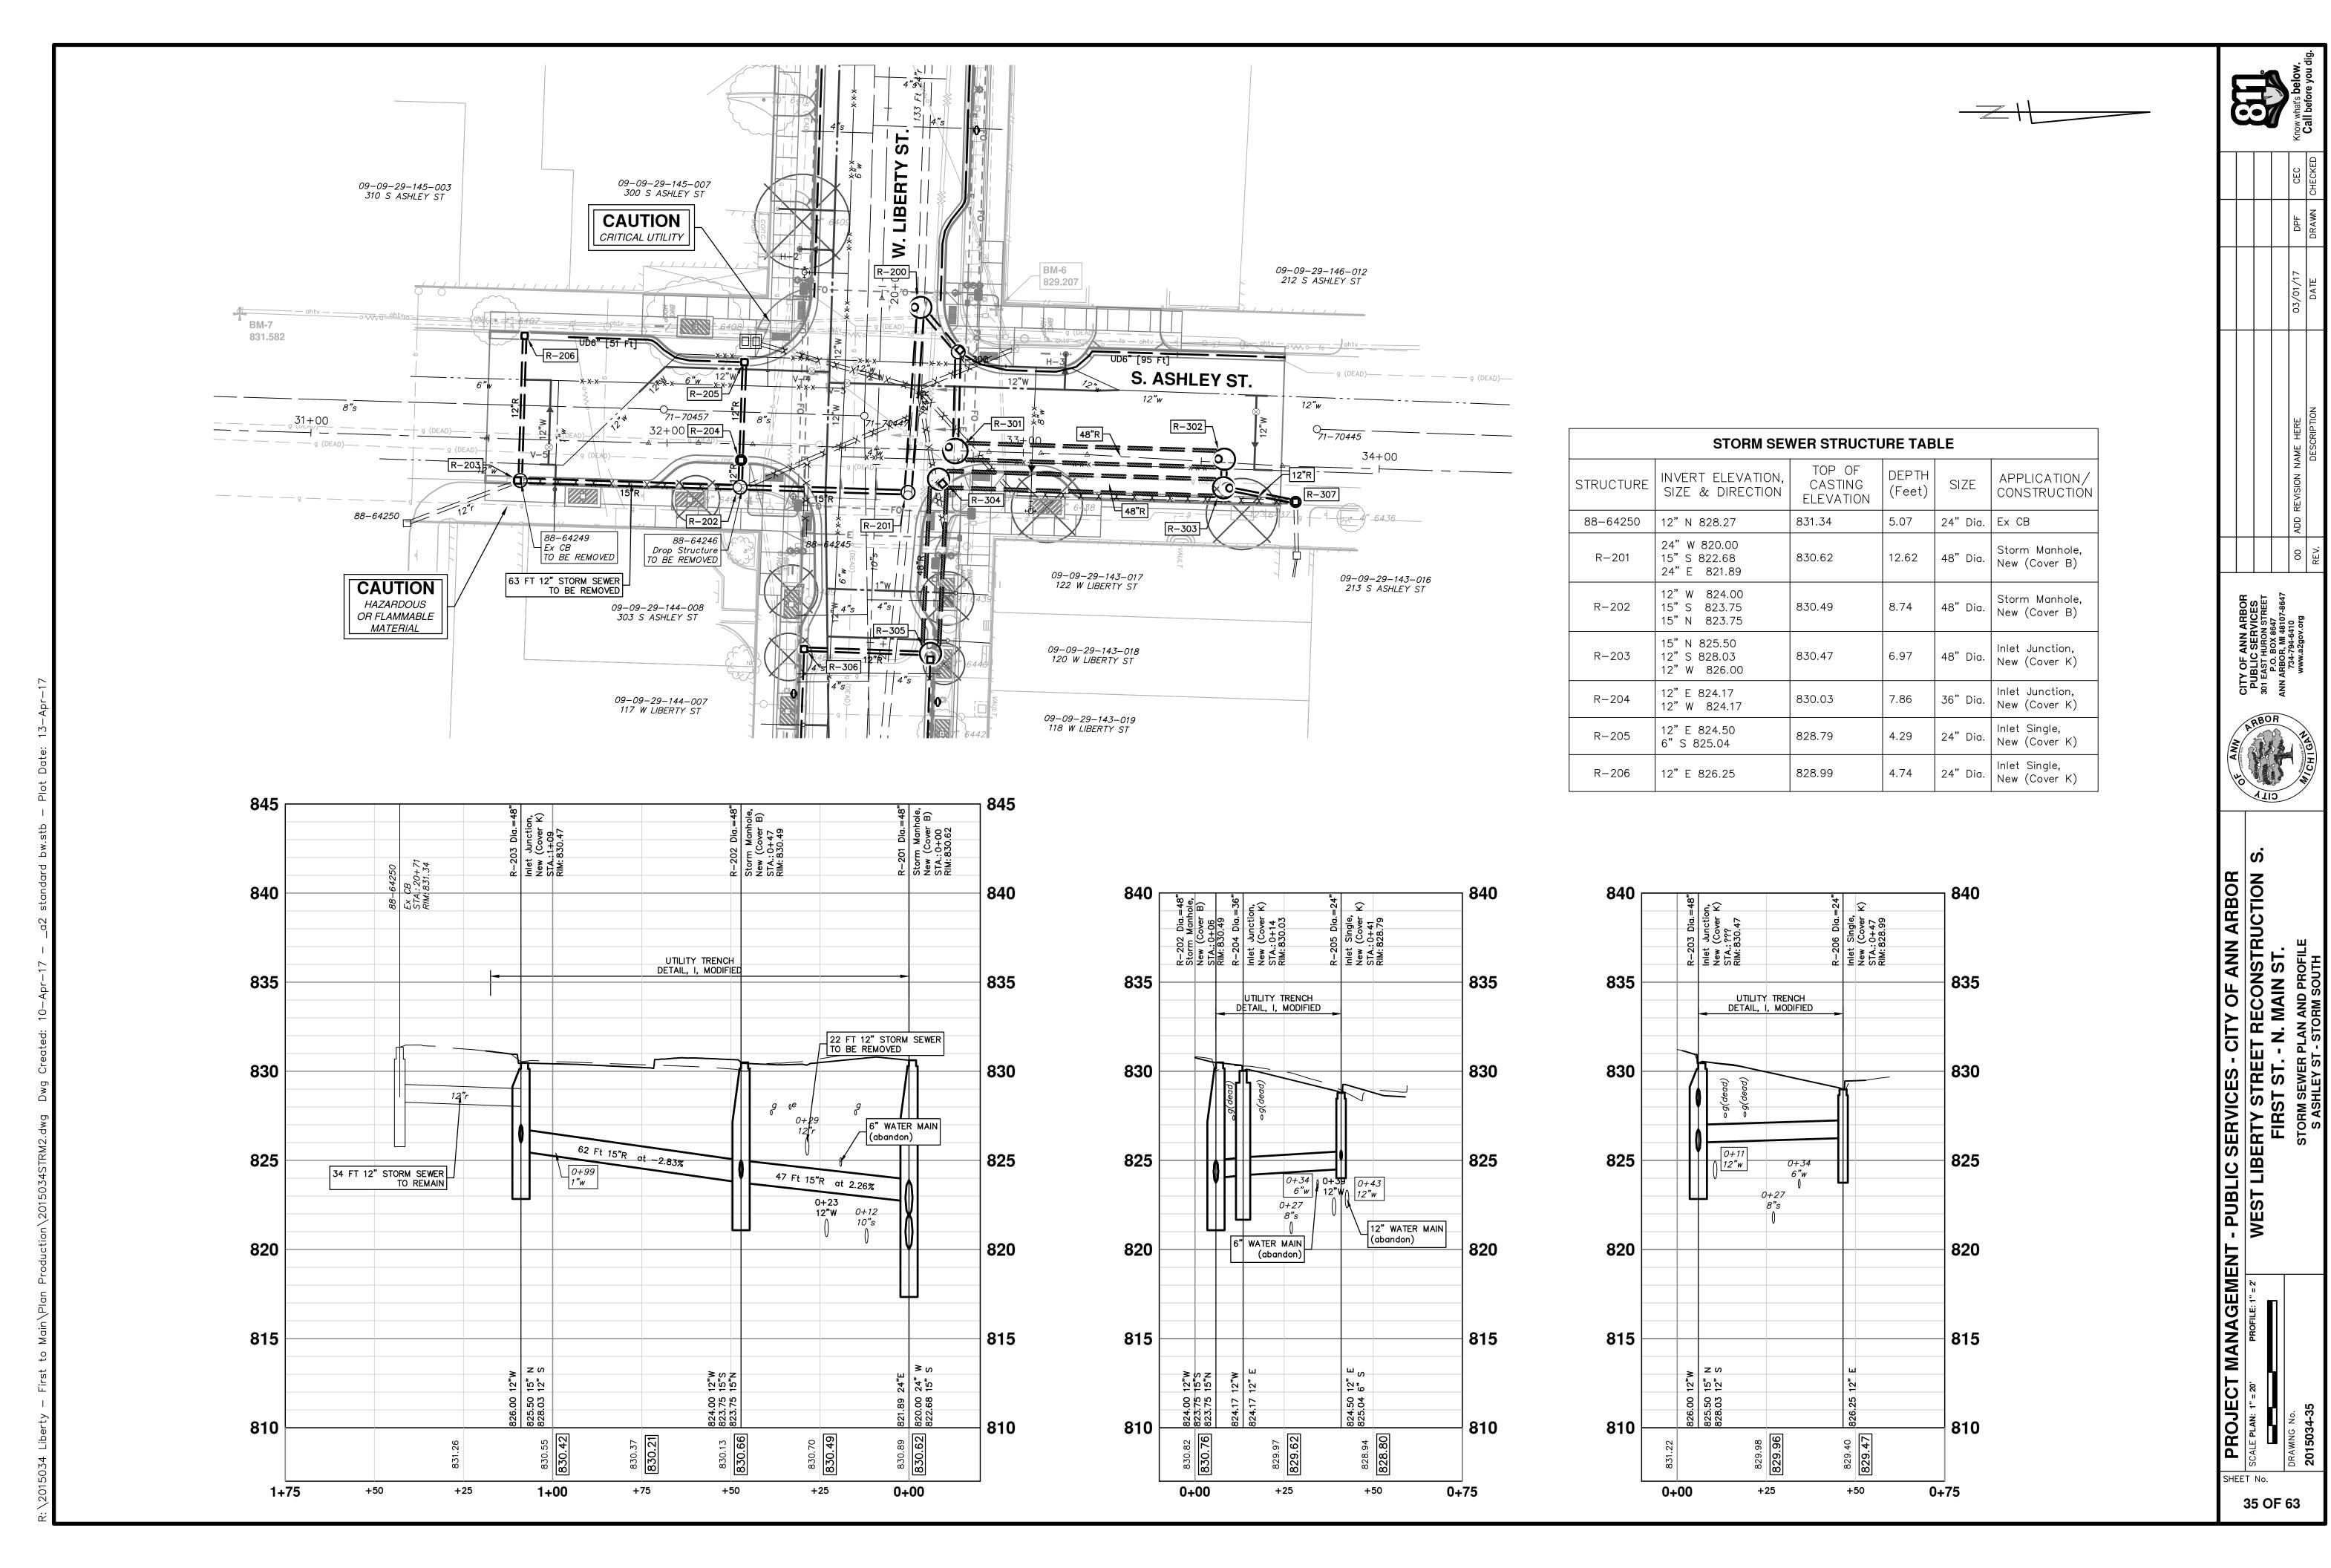


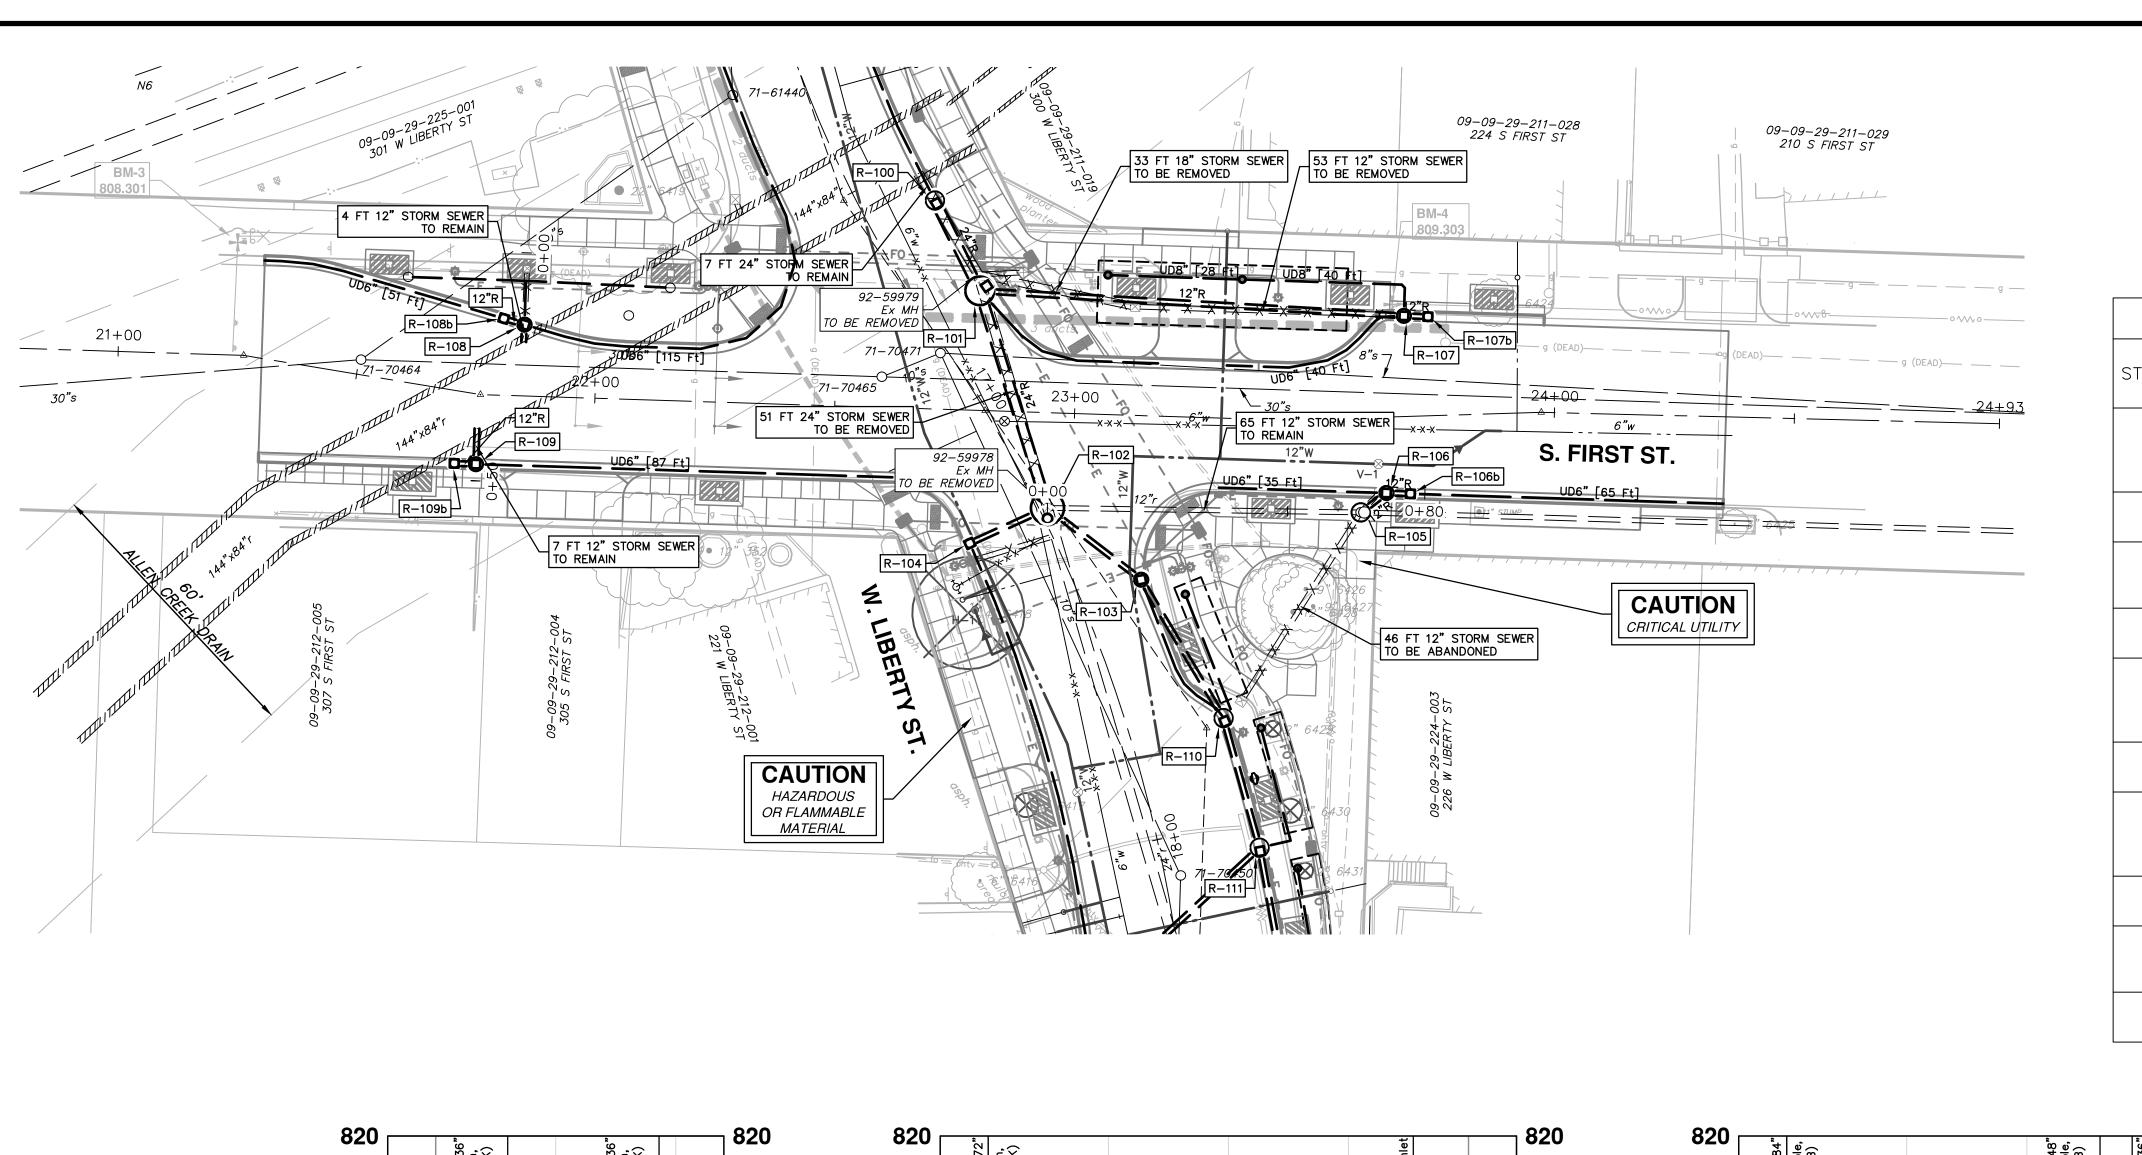

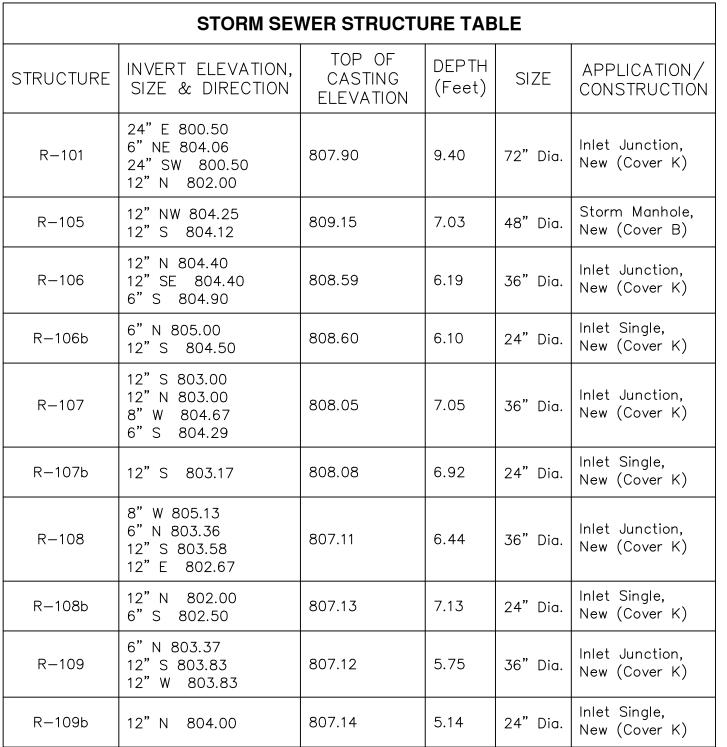

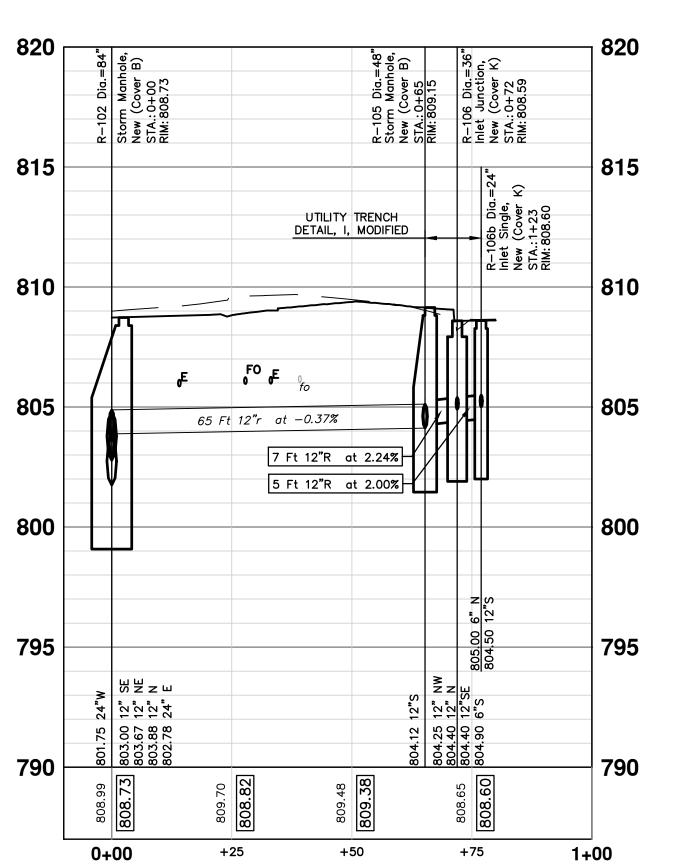



ECT MANAGEMENT - PUBLIC SERVICES - CITY OF ANN ARBOR	ANN ADDOD						
WEST LIBERTY STREET RECONSTRUCTION S	PUBLIC SERVICES 301 EAST HURON STREET PO BOX 8647						
STORM SEWER PLAN AND PROFILE	7-8647	OO ADD	ADD REVISION NAME HERE	03/01/17	DPF	CEC	Know what's below.
FIRST ST - STORM		REV.	DESCRIPTION	DATE	DRAWN	DRAWN CHECKED	Call before you dig.

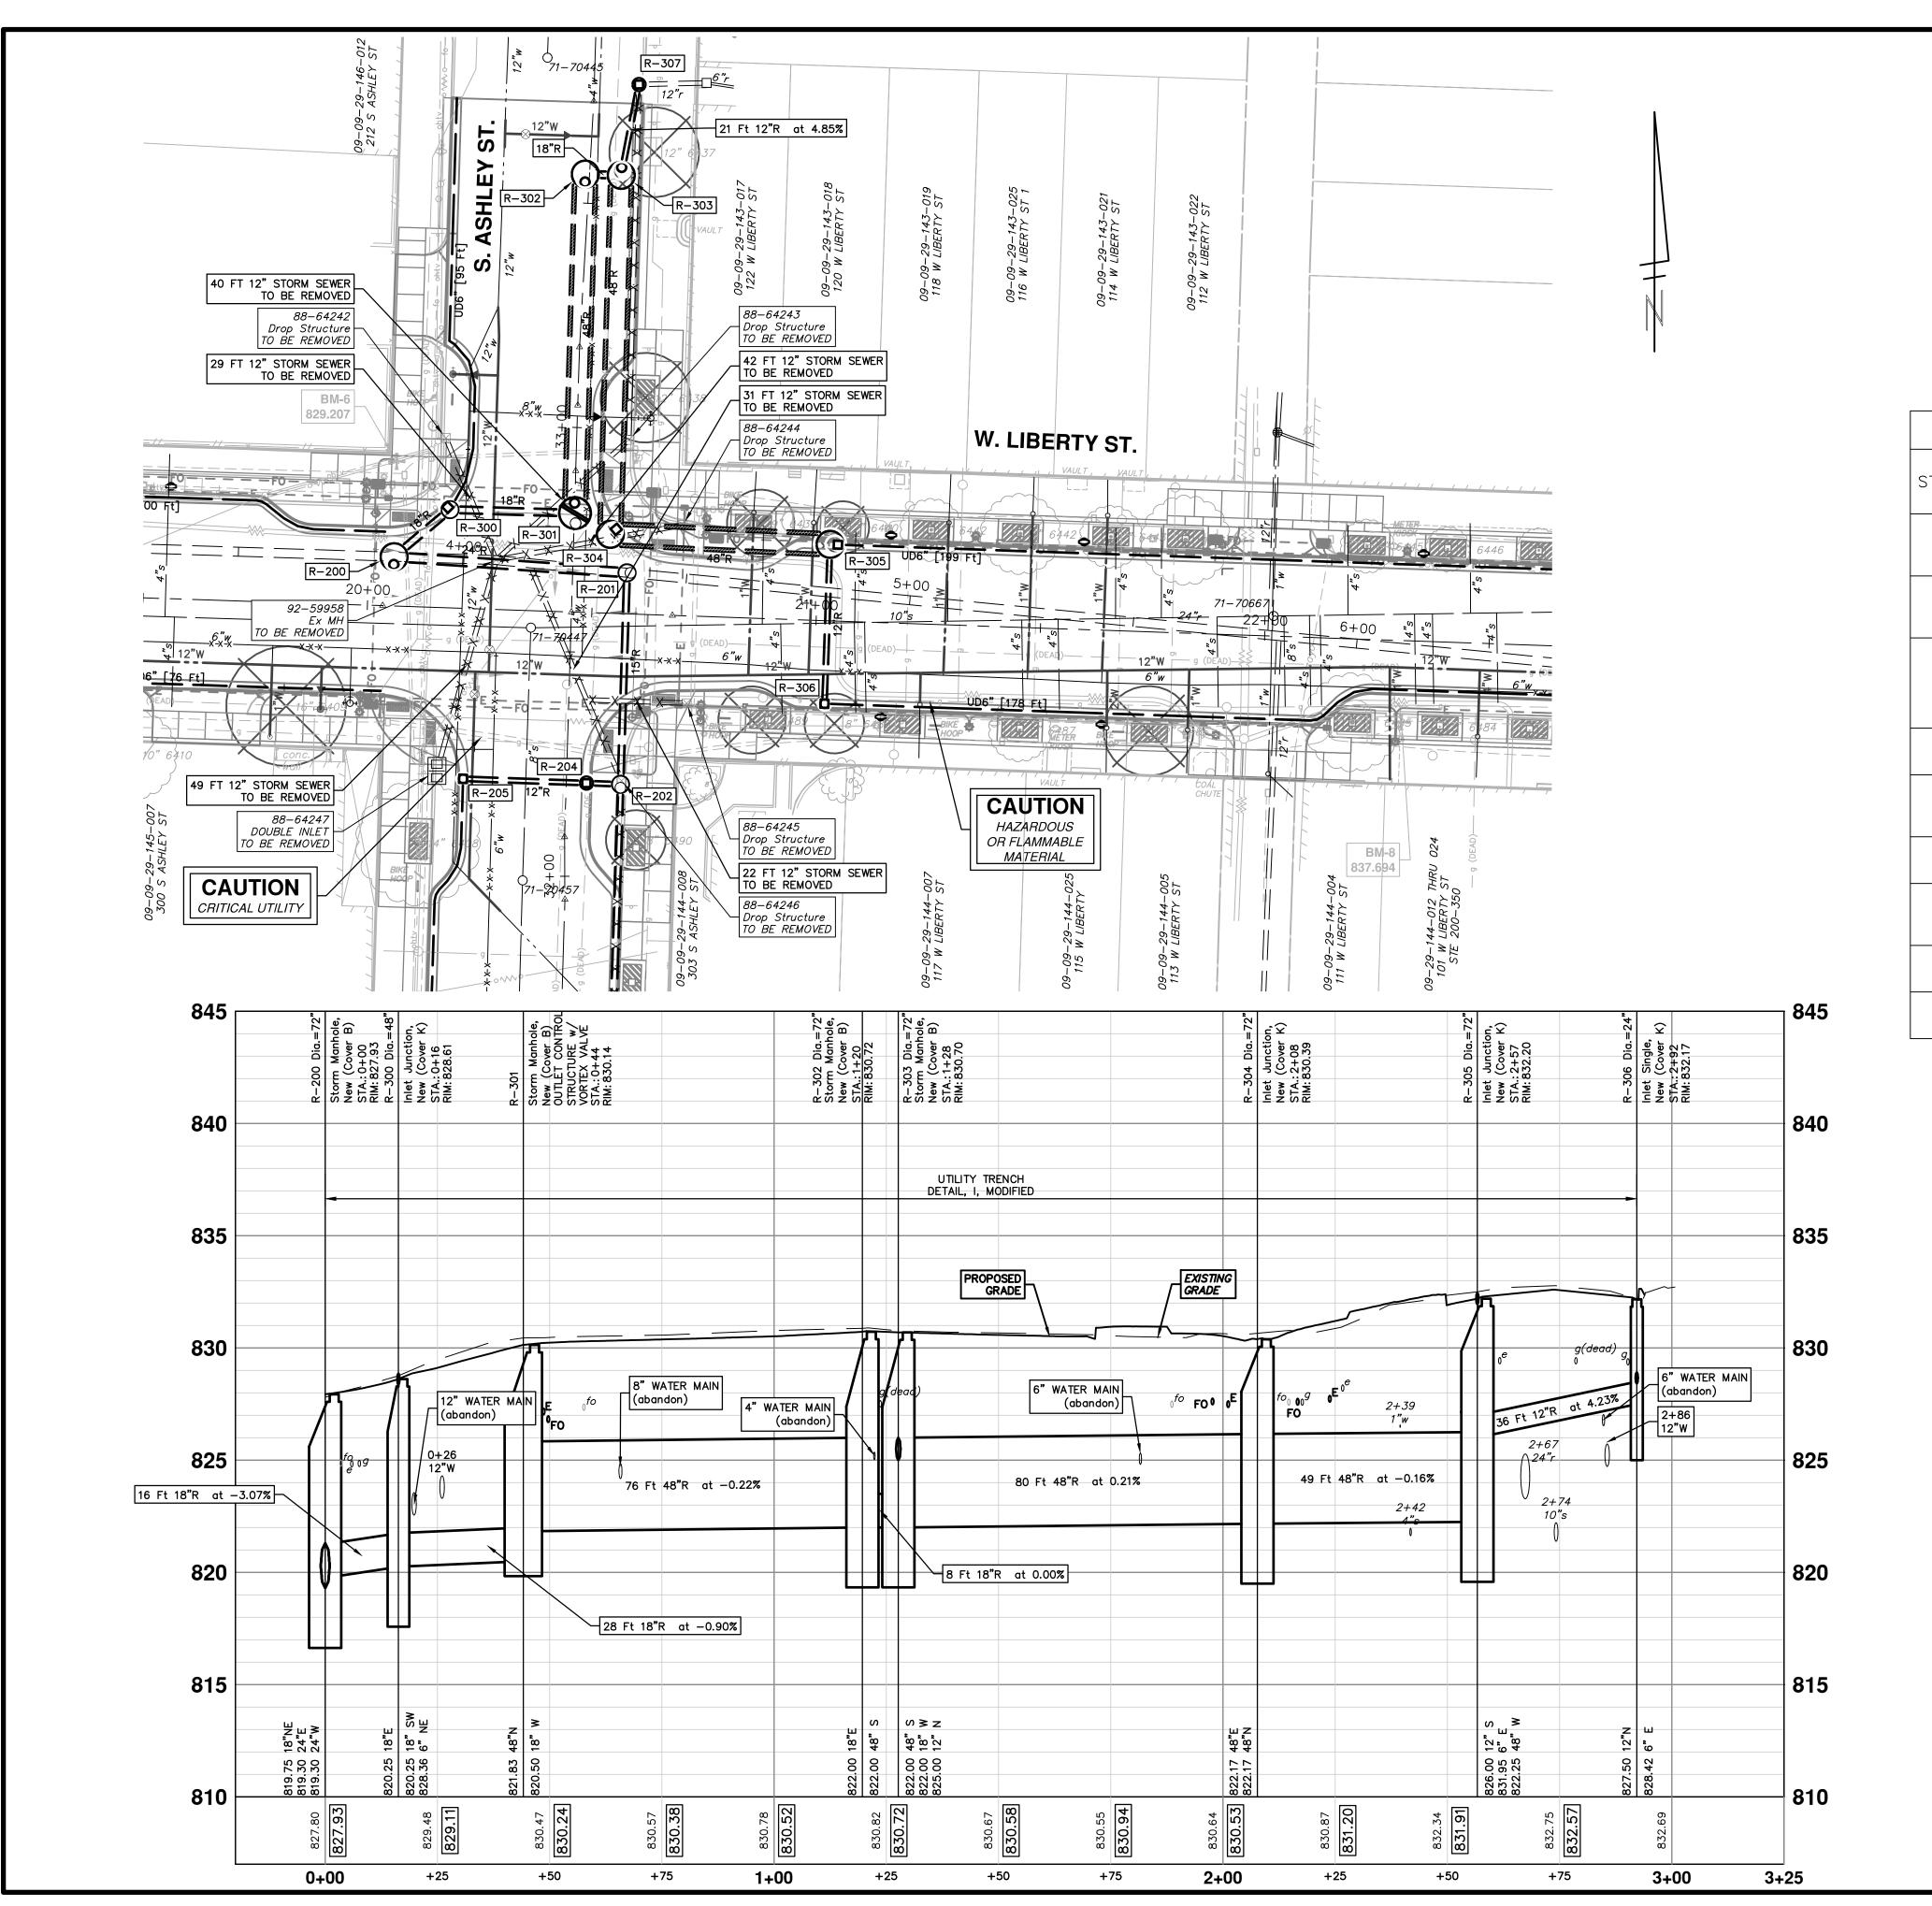

	STORM SEWER STRUCTURE TABLE				
STRUCTURE	INVERT ELEVATION, SIZE & DIRECTION	TOP OF CASTING ELEVATION	DEPTH (Feet)	SIZE	APPLICATION/ CONSTRUCTION
R-200	18" NE 819.75 24" E 819.30 24" W 819.30	827.93	10.63	72" Dia.	Storm Manhole, New (Cover B)
R-300	18" SW 820.25 6" NE 828.36 18" E 820.25	828.61	10.36	48" Dia.	Inlet Junction, New (Cover K)
R-301	18" W 820.50 48" N 821.83	830.14	9.64	84" Dia.	Storm Manhole, New (Cover B) OUTLET CONTROL STRUCTURE w/ VORTEX VALVE
R-302	48" S 822.00 18" E 822.00	830.72	10.72	72" Dia.	Storm Manhole, New (Cover B)
R-303	48" S 822.00 18" W 822.00 12" N 825.00	830.70	10.70	72" Dia.	Storm Manhole, New (Cover B)
R-304	48" E 822.17 48" N 822.17	830.39	10.22	72" Dia.	Inlet Junction, New (Cover K)
R-305	12" S 826.00 6" E 831.95 48" W 822.25	832.20	11.95	72" Dia.	Inlet Junction, New (Cover K)
R-306	6" E 828.42 12" N 827.50	832.17	6.67	24" Dia.	Inlet Single, New (Cover K)
R-307	12" E 827.45 12" S 826.00	830.75	6.75	36" Dia.	Inlet Junction, New (Cover K)

IT - PUBLIC SERVICES - CITY OF ANN ARBOR
WEST LIBERTY STREET RECONSTRUCTION
FIRST ST. - N. MAIN ST.
STORM SEWER PLAN AND PROFILE
S ASHLEY ST - STORM NORTH SHEET No. 37 OF 63

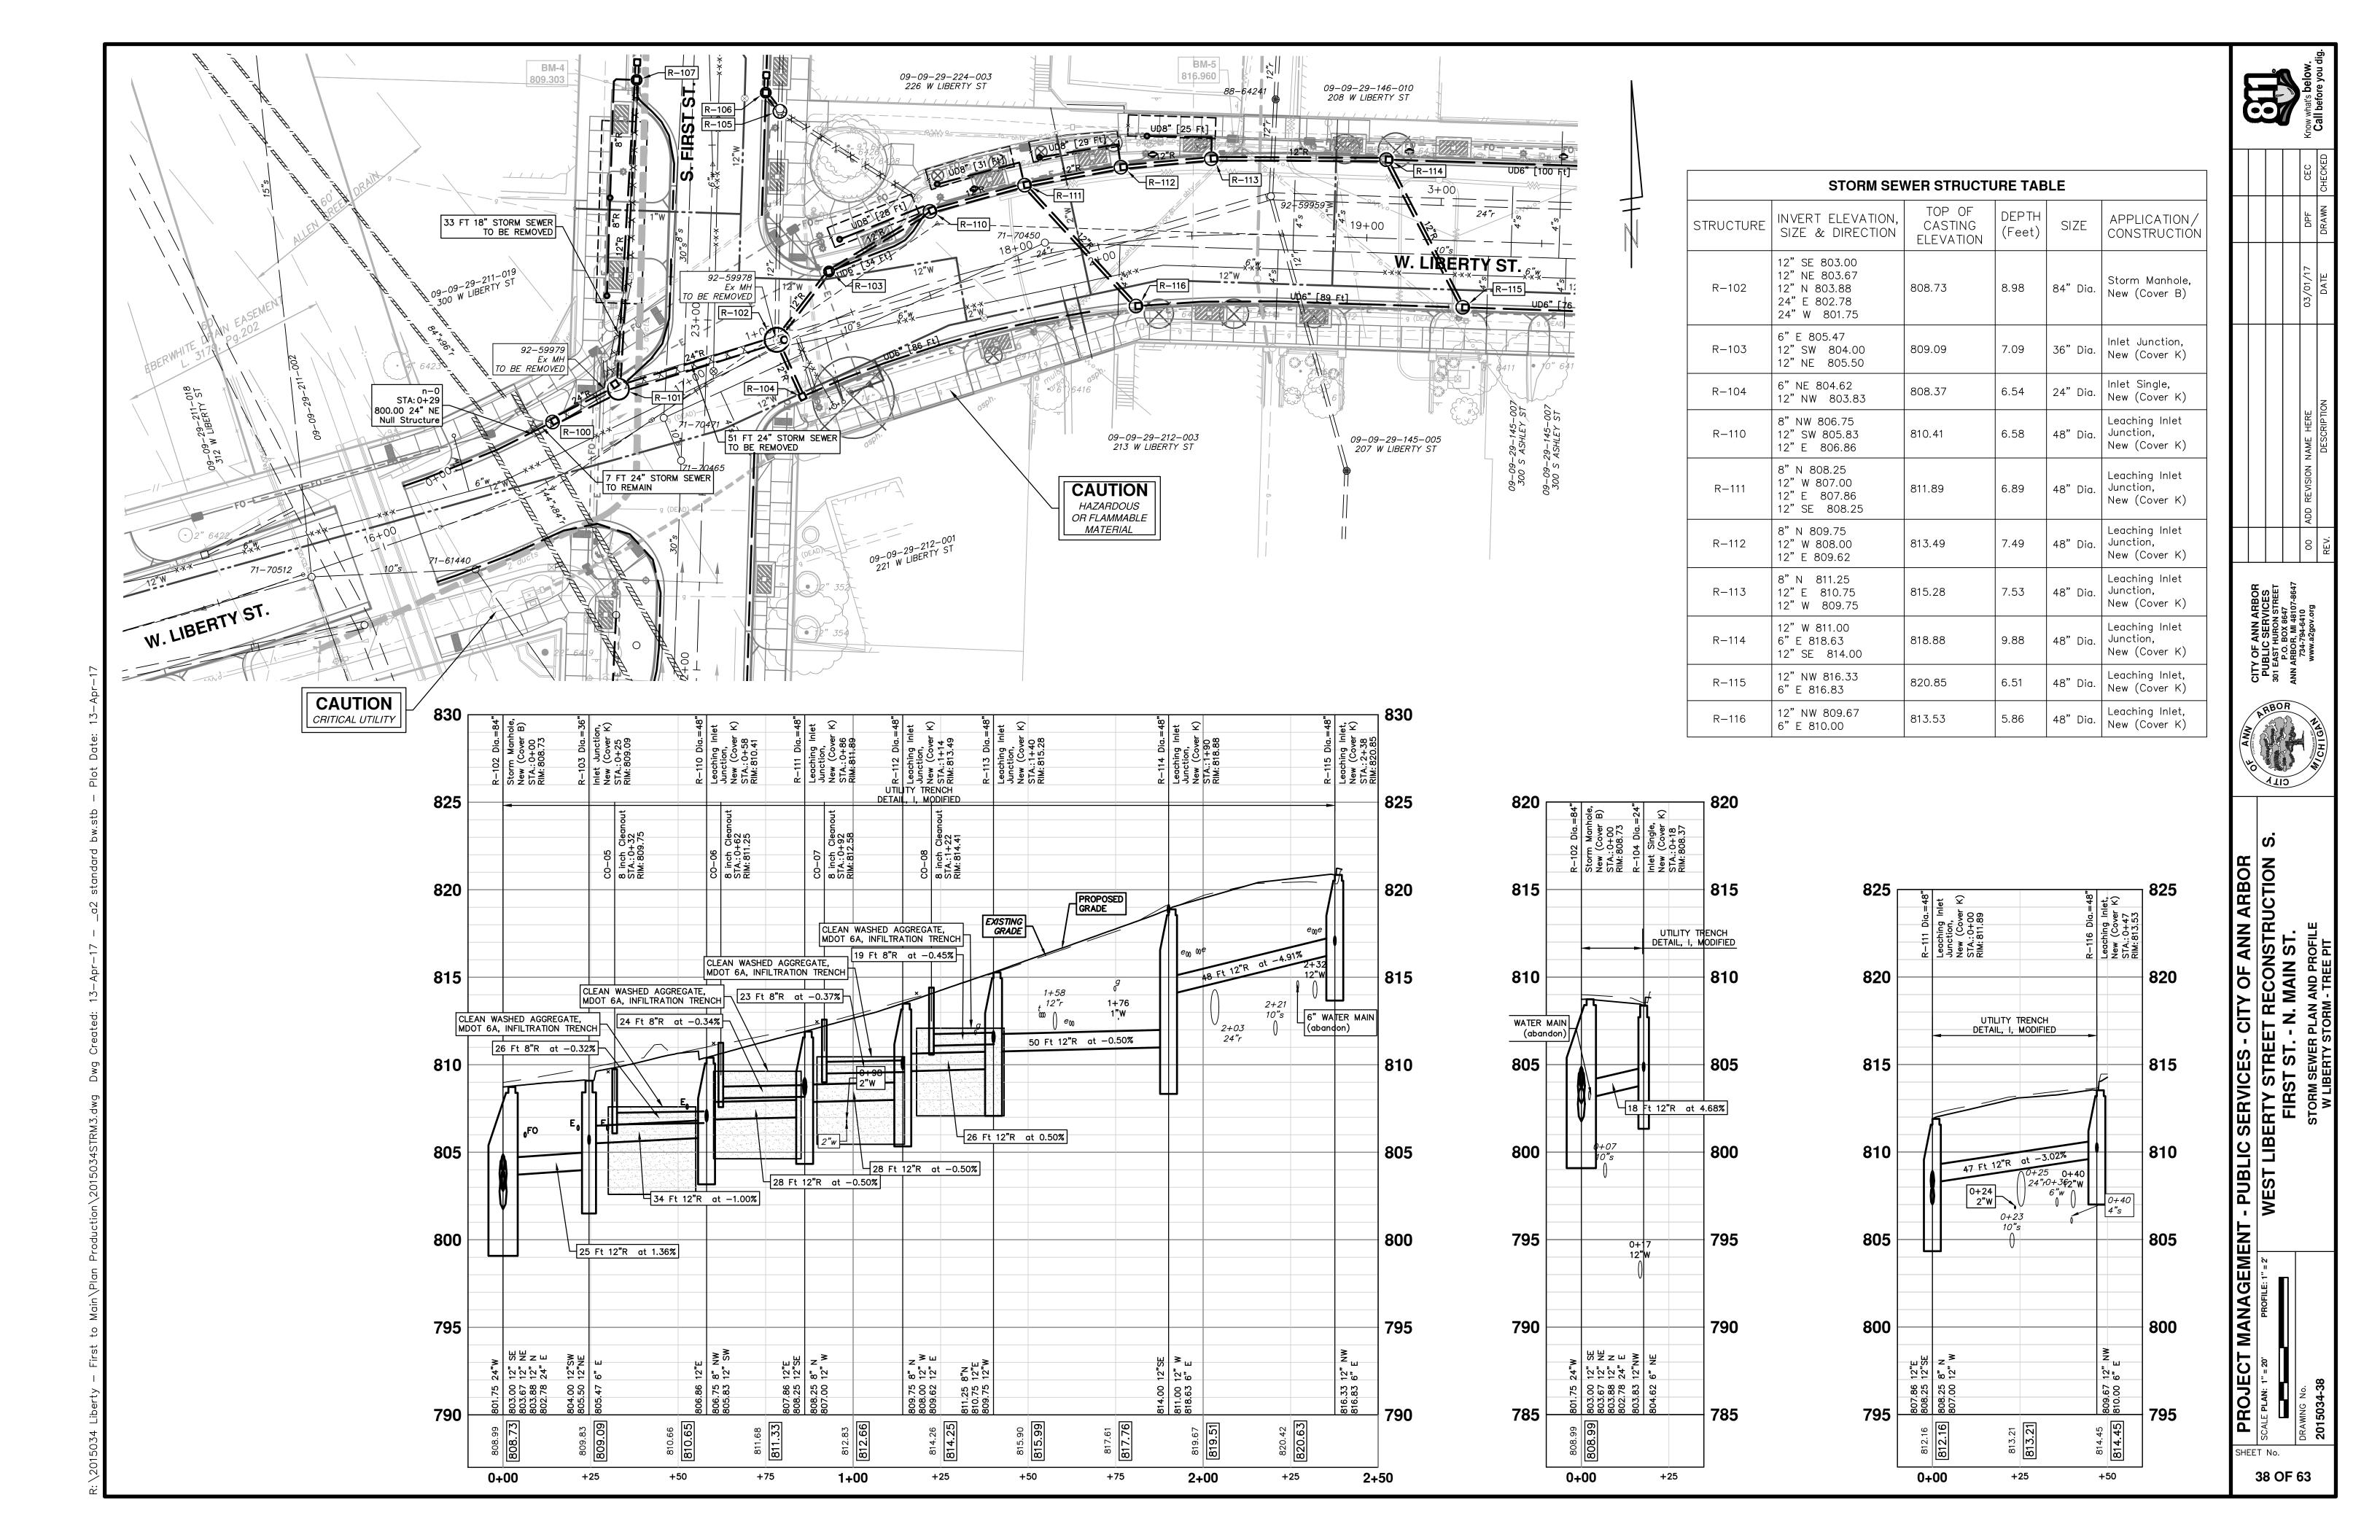

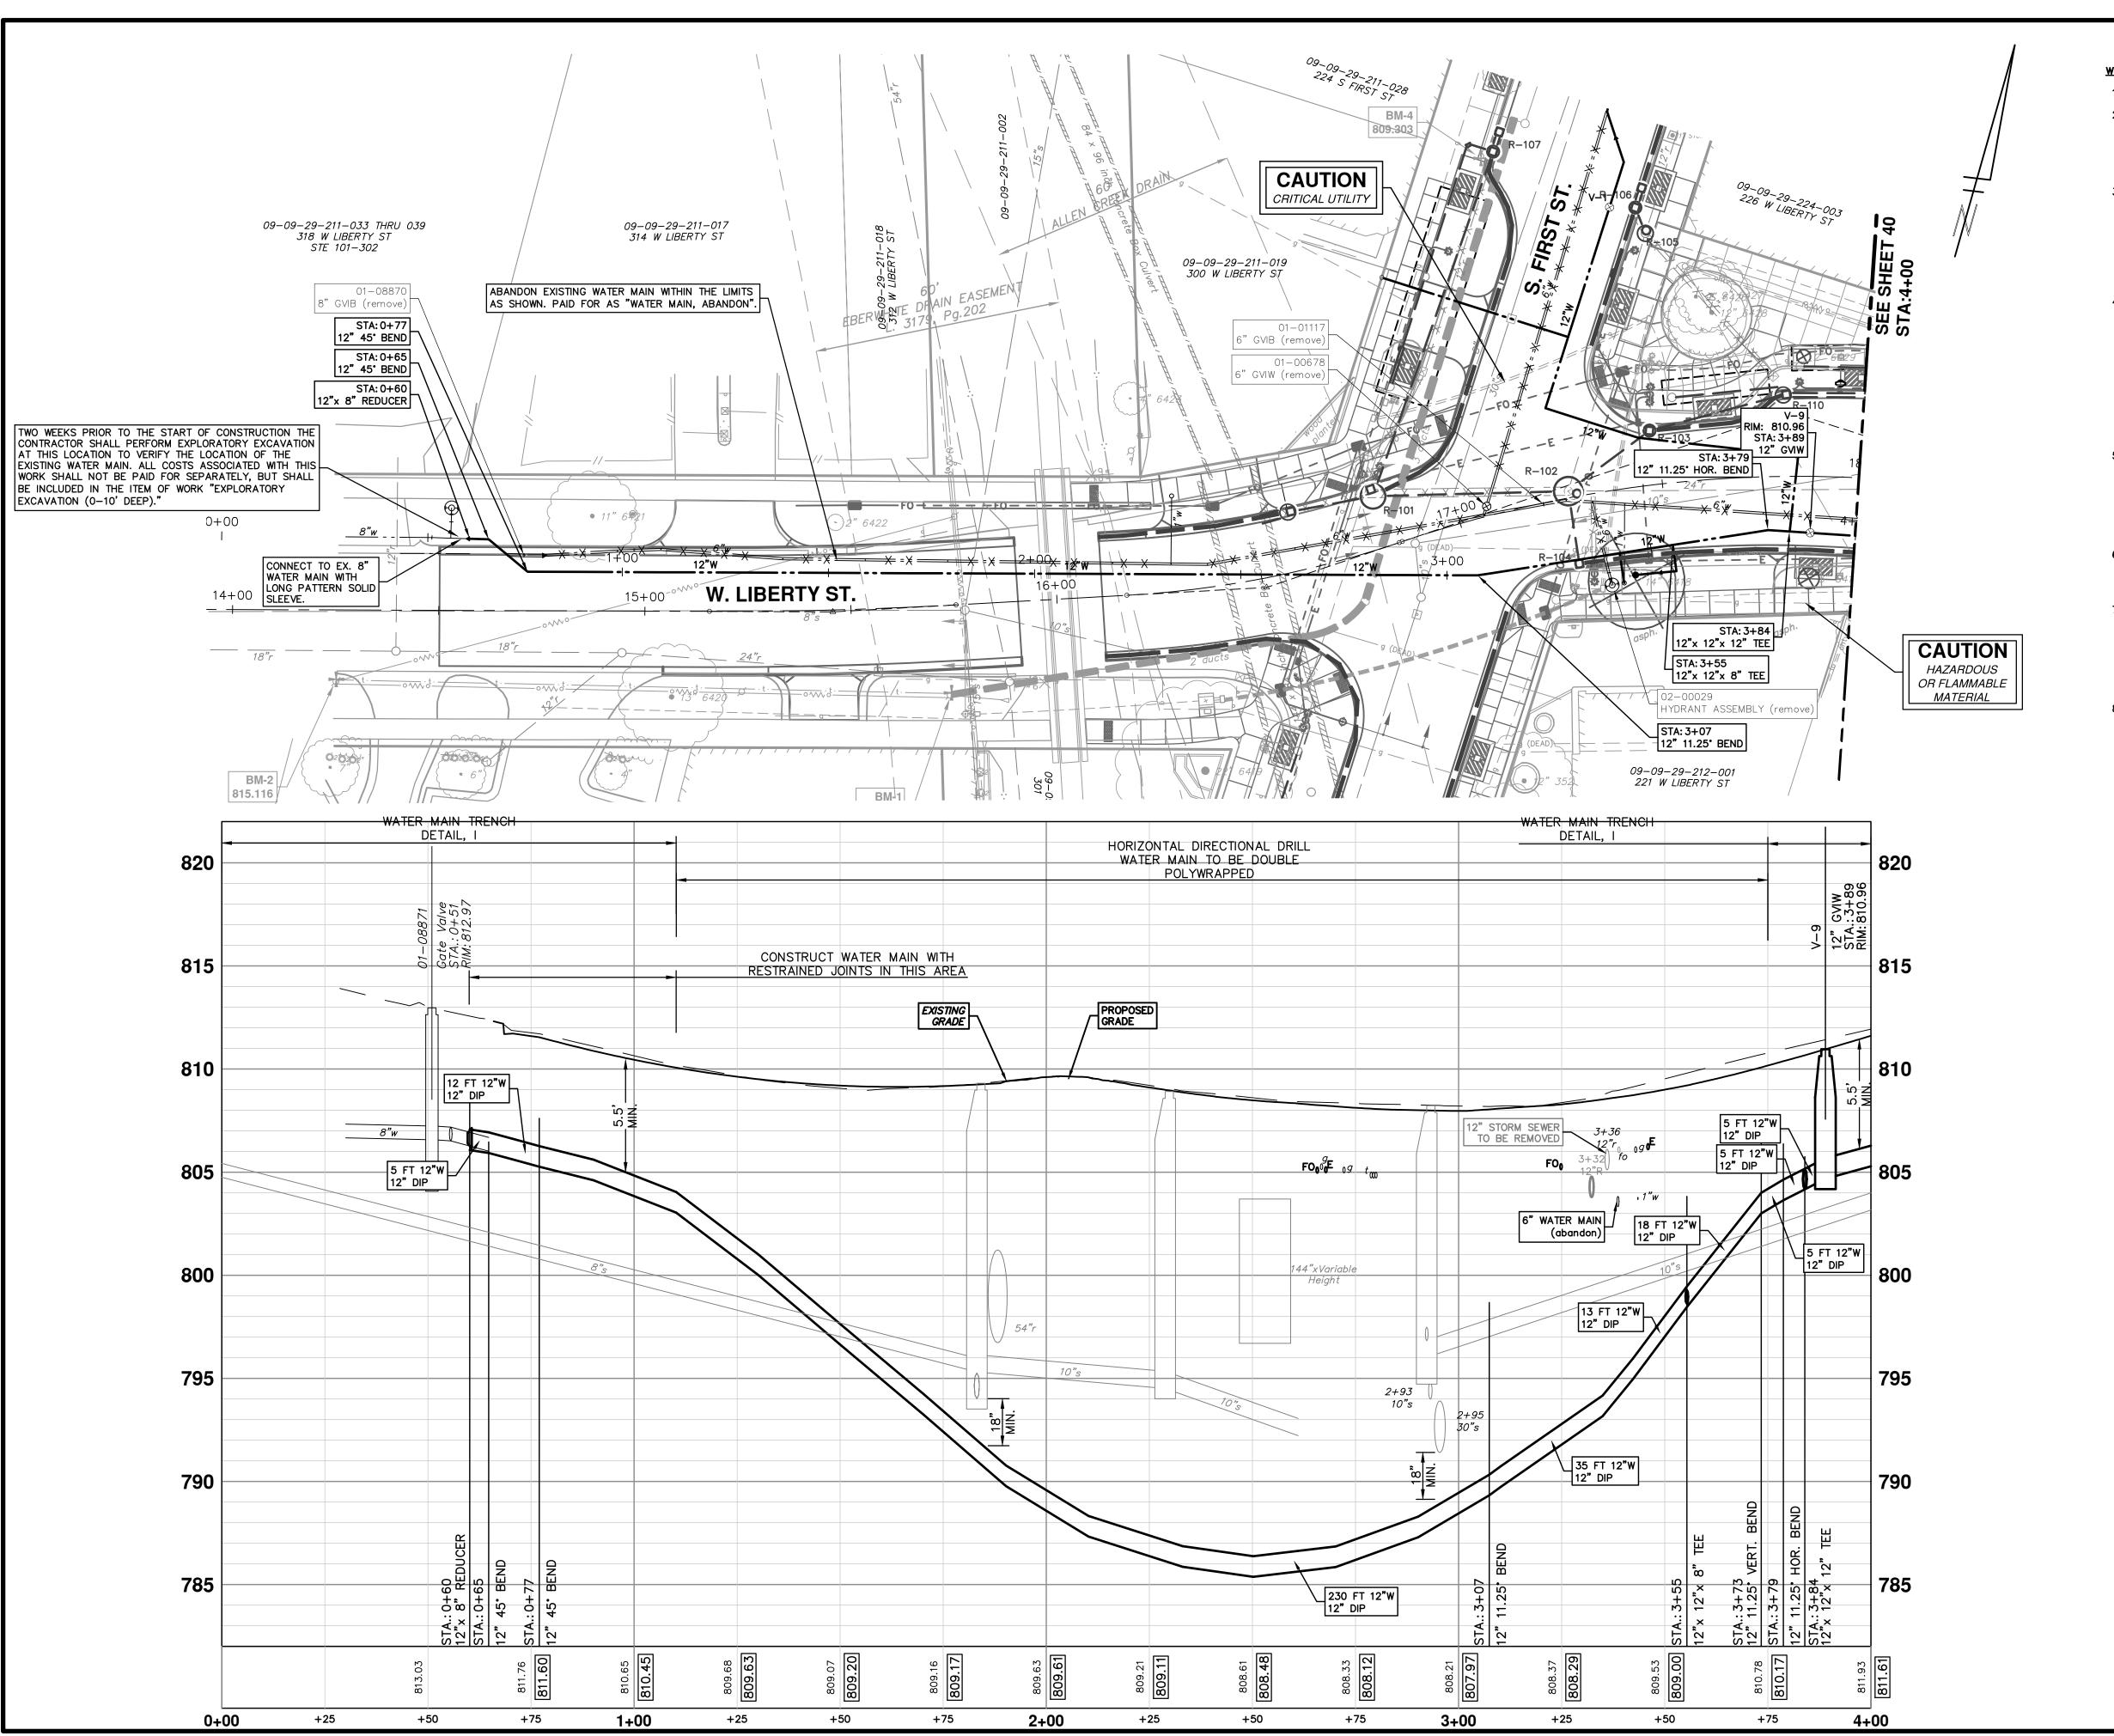


WATER MAIN CONSTRUCTION NOTES:


- 1: FOR EROSION CONTROL ITEMS SEE EROSION CONTROL SHEETS.
- 2: ALL WATER MAIN WORK SHALL BE STAGED IN ACCORDANCE WITH THE CONSTRUCTION STAGING SHEETS AND SPECIAL PROVISION AS DIRECTED BY THE ENGINEER. THE CONTRACTOR SHALL BE RESPONSIBLE FOR COORDINATING ALL WORK, CONSTRUCTION METHODS, AND EQUIPMENT TO COMPLY WITH THE CONTRACT REQUIREMENTS.
- 3: THE CONTRACTOR SHALL CAREFULLY PROTECT FROM DAMAGE OR INJURY DURING CONSTRUCTION OPERATIONS ALL UTILITIES NOT DESIGNATED FOR REMOVAL OR ABANDONMENT. PAYMENT FOR PROTECTION OF UTILITIES INCLUDED IN "MACHINE GRADING, MODIFIED, W LIBERTY STREET". EXISTING FACILITIES NOT DESIGNATED FOR REMOVAL OR ABANDONMENT BUT WHICH ARE DAMAGED BY THE CONTRACTOR'S OPERATION SHALL BE REPAIRED OR REPLACED BY THE CONTRACTOR AT HIS SOLE EXPENSE, IN A MANNER THAT IS APPROVED BY THE ENGINEER.
- 4: THE EXISTING UTILITIES SHOWN ON THESE PLANS REPRESENT THE BEST INFORMATION AVAILABLE AS OBTAINED THROUGH SURVEYS AND/OR EXISTING PLANS. THIS INFORMATION DOES NOT RELIEVE THE CONTRACTOR OF THE RESPONSIBILITY TO BE SATISFIED AS TO ITS ACCURACY AND/OR THE LOCATION OF EXISTING UTILITIES. IF STORM, SANITARY, OR WATER MAINS CROSS WITH LESS THAN 18" CLEARANCE. THEY SHALL BE SADDLED (SEE UTD DETAIL #3). IF STORM, SANITARY, OR WATER MAINS CROSS OTHER UTILITIES, CONTACT THEIR RESPECTIVE OWNERS FOR INFORMATION ON HOW TO PROCEED. PAYMENT FOR THE COORDINATION EFFORTS, CONCRETE SADDLES, AND ANY OTHER ASSOCIATED ITEMS SHALL BE INCLUDED IN THE RELATED STORM, SANITARY, OR WATER MAIN ITEMS AND SHALL NOT BE PAID FOR SEPARATELY.
- 5: THE CONTRACTOR WILL ONLY BE ALLOWED TO SHUT DOWN THE EXISTING WATER MAIN FOR A MAXIMUM DURATION OF 8 HOURS IN ANY ONE SHUTDOWN, IN ANY GIVEN 24 HOUR PERIOD. SHUTDOWN OF THE EXISTING WATERMAIN MUST BE SCHEDULED WITH THE ENGINEER A MINIMUM OF 3 WORKING DAYS IN ADVANCE OF THE INTENDED SHUTDOWN. THE SHUTDOWN OF THE WATER MAIN WILL NOT BE ALLOWED TO TAKE PLACE ON A SATURDAY OR A
- 6: PLEASE SEE THE SPECIAL PROVISION ENTITLED "WATER MAIN AND APPURTENANCES" FOR CONDITIONS AND ADDITIONAL REQUIREMENTS REGARDING THE DIP WATER MAIN, ITS INSTALLATION, AND TESTING.
- 7: THE CONTRACTOR SHALL PROPOSE A METHOD(S) AND EQUIPMENT FOR THE REVIEW AND APPROVAL OF THE ENGINEER TO BE USED FOR THE FLUSHING OF CHLORINATED WATER FROM PROPOSED WATER MAIN INTO EXISTING SANITARY SEWERS. CHLORINATED WATER SHALL NOT BE ALLOWED IN STORM SEWERS. ANY AND ALL MEASURES NECESSARY TO COMPLY WITH THIS REQUIREMENT SHALL BE INCLUDED IN THE COST OF THE WATER MAIN INSTALLATION AND WILL NOT BE PAID FOR SEPARATELY.
- 8: UPON COMPLETION OF THE 12" WATER MAIN CONSTRUCTION AND HYDROSTATIC AND BACTERIOLOGICAL TESTING, THE CONTRACTOR SHALL REMOVE THE TEMPORARY WATER MAIN TESTING AND CONNECTION ASSEMBLY AND CONSTRUCT THE PERMANENT WATER MAIN AS SHOWN ON THE PLAN SHEET. ALL WORK ASSOCIATED WITH REMOVING THE TEMPORARY TESTING CONNECTION AND CONSTRUCTING THE FINAL, PERMANENT, CONNECTION WILL NOT BE PAID FOR SEPARATELY, BUT SHALL BE INCLUDED IN THE RELATED



- PUBLIC SERVICES - CITY OF ANN ARBOR
WEST LIBERTY STREET RECONSTRUCTIO
S. FIRST ST. - N. MAIN ST.
LIBERTY ST. WATER MAIN PLAN AND PROFILE
STA. 0+60 TO STA. 4+00

SHEET No.

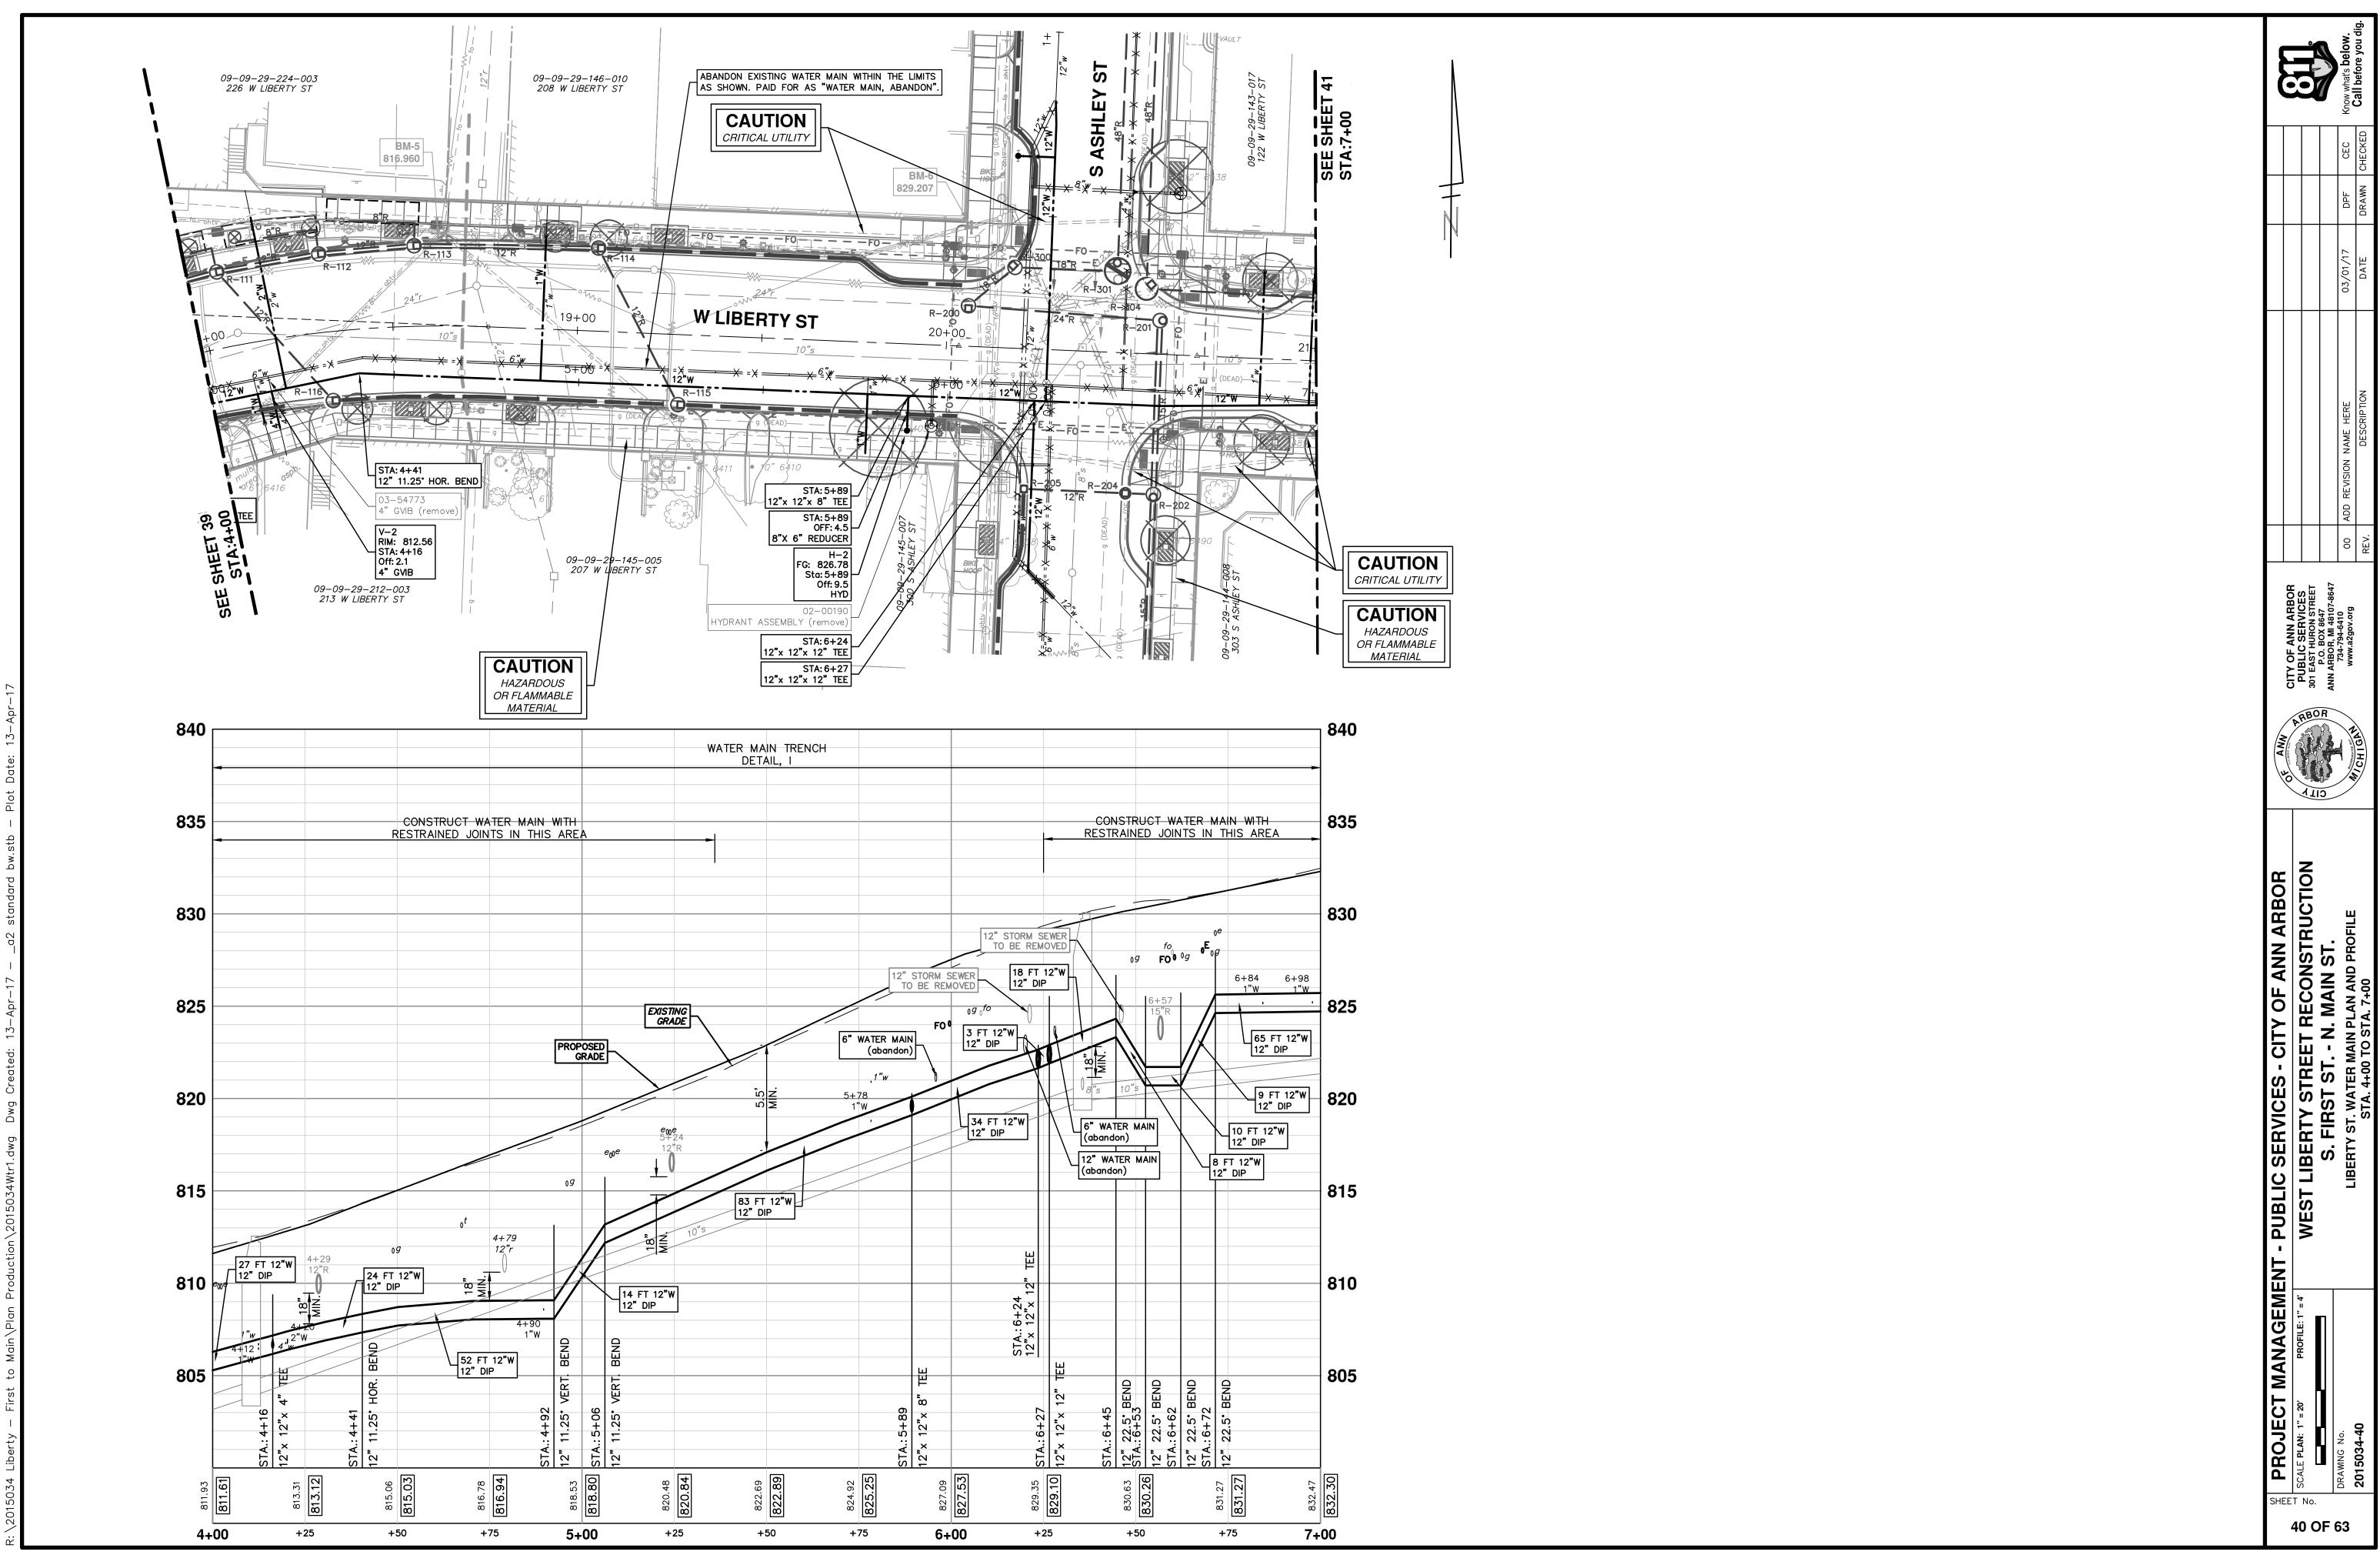

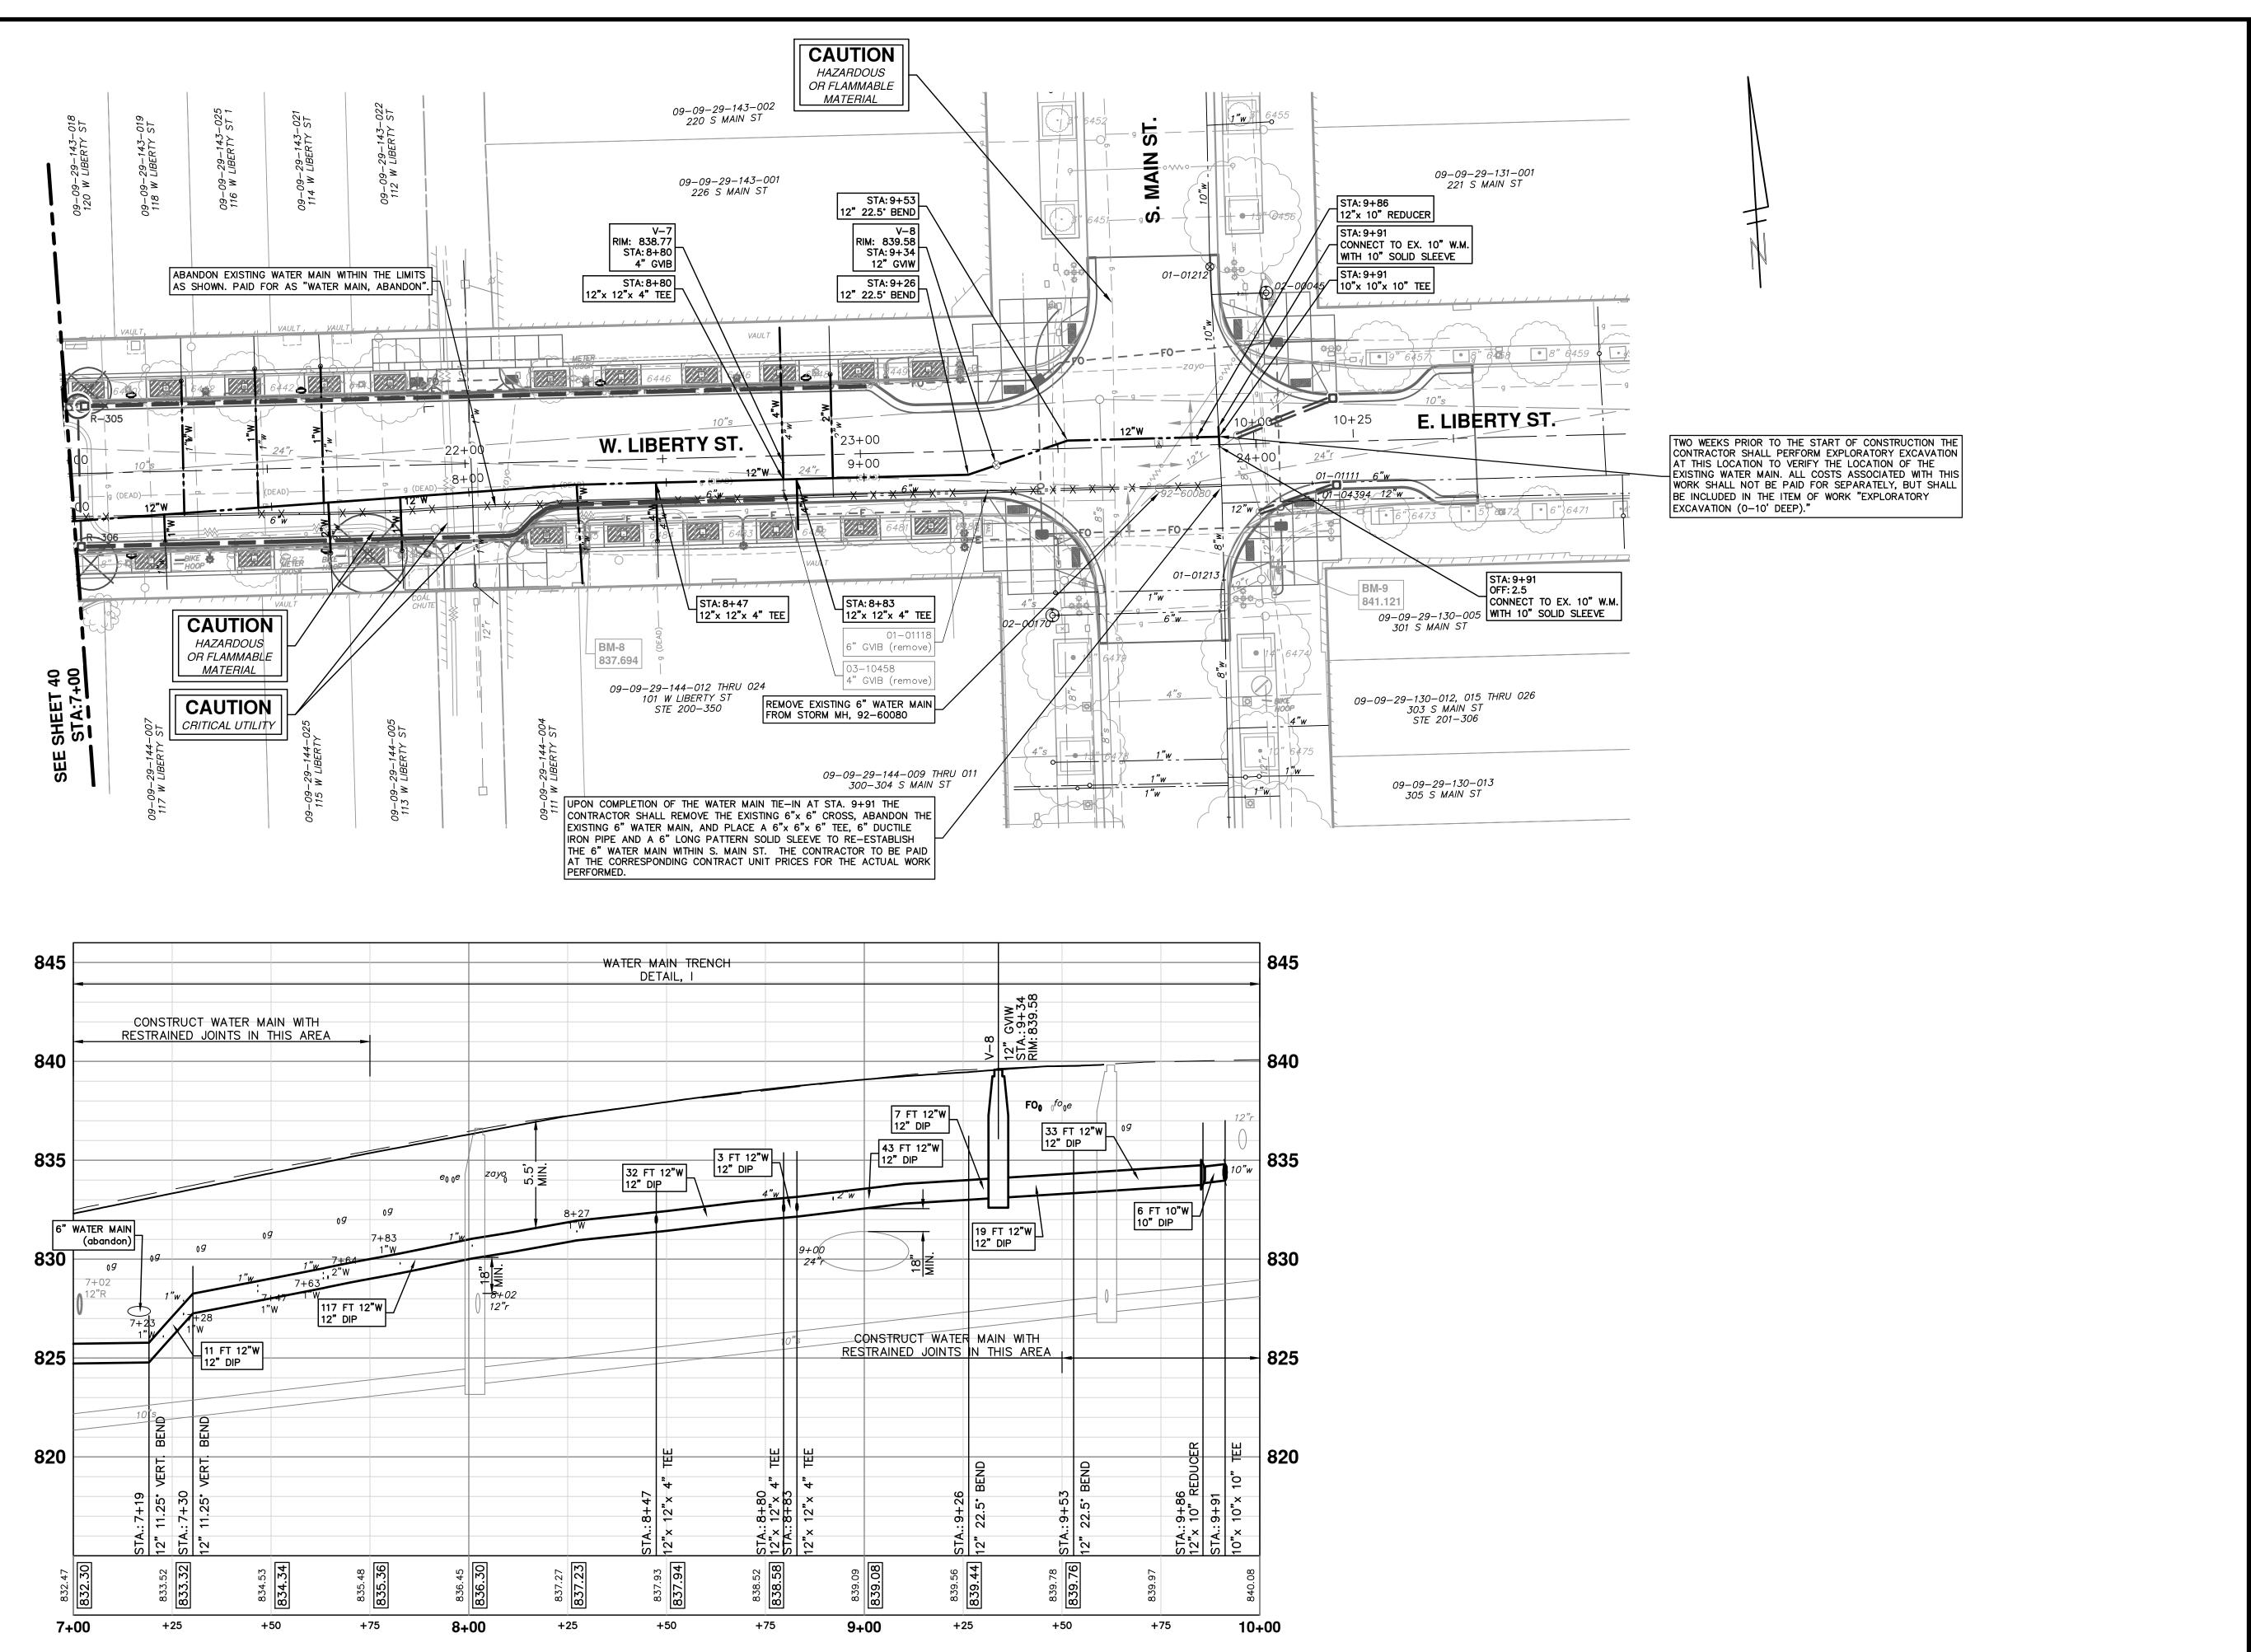






- PUBLIC SERVICES - CITY OF ANN ARBOR
WEST LIBERTY STREET RECONSTRUCTIO
S. FIRST ST. - N. MAIN ST.
LIBERTY ST. WATER MAIN PLAN AND PROFILE
STA. 7+00 TO STA. 9+90


PROJECT MANAGEMENT - SCALE PLAN: 1" = 20' PROFILE: 1" = 4'

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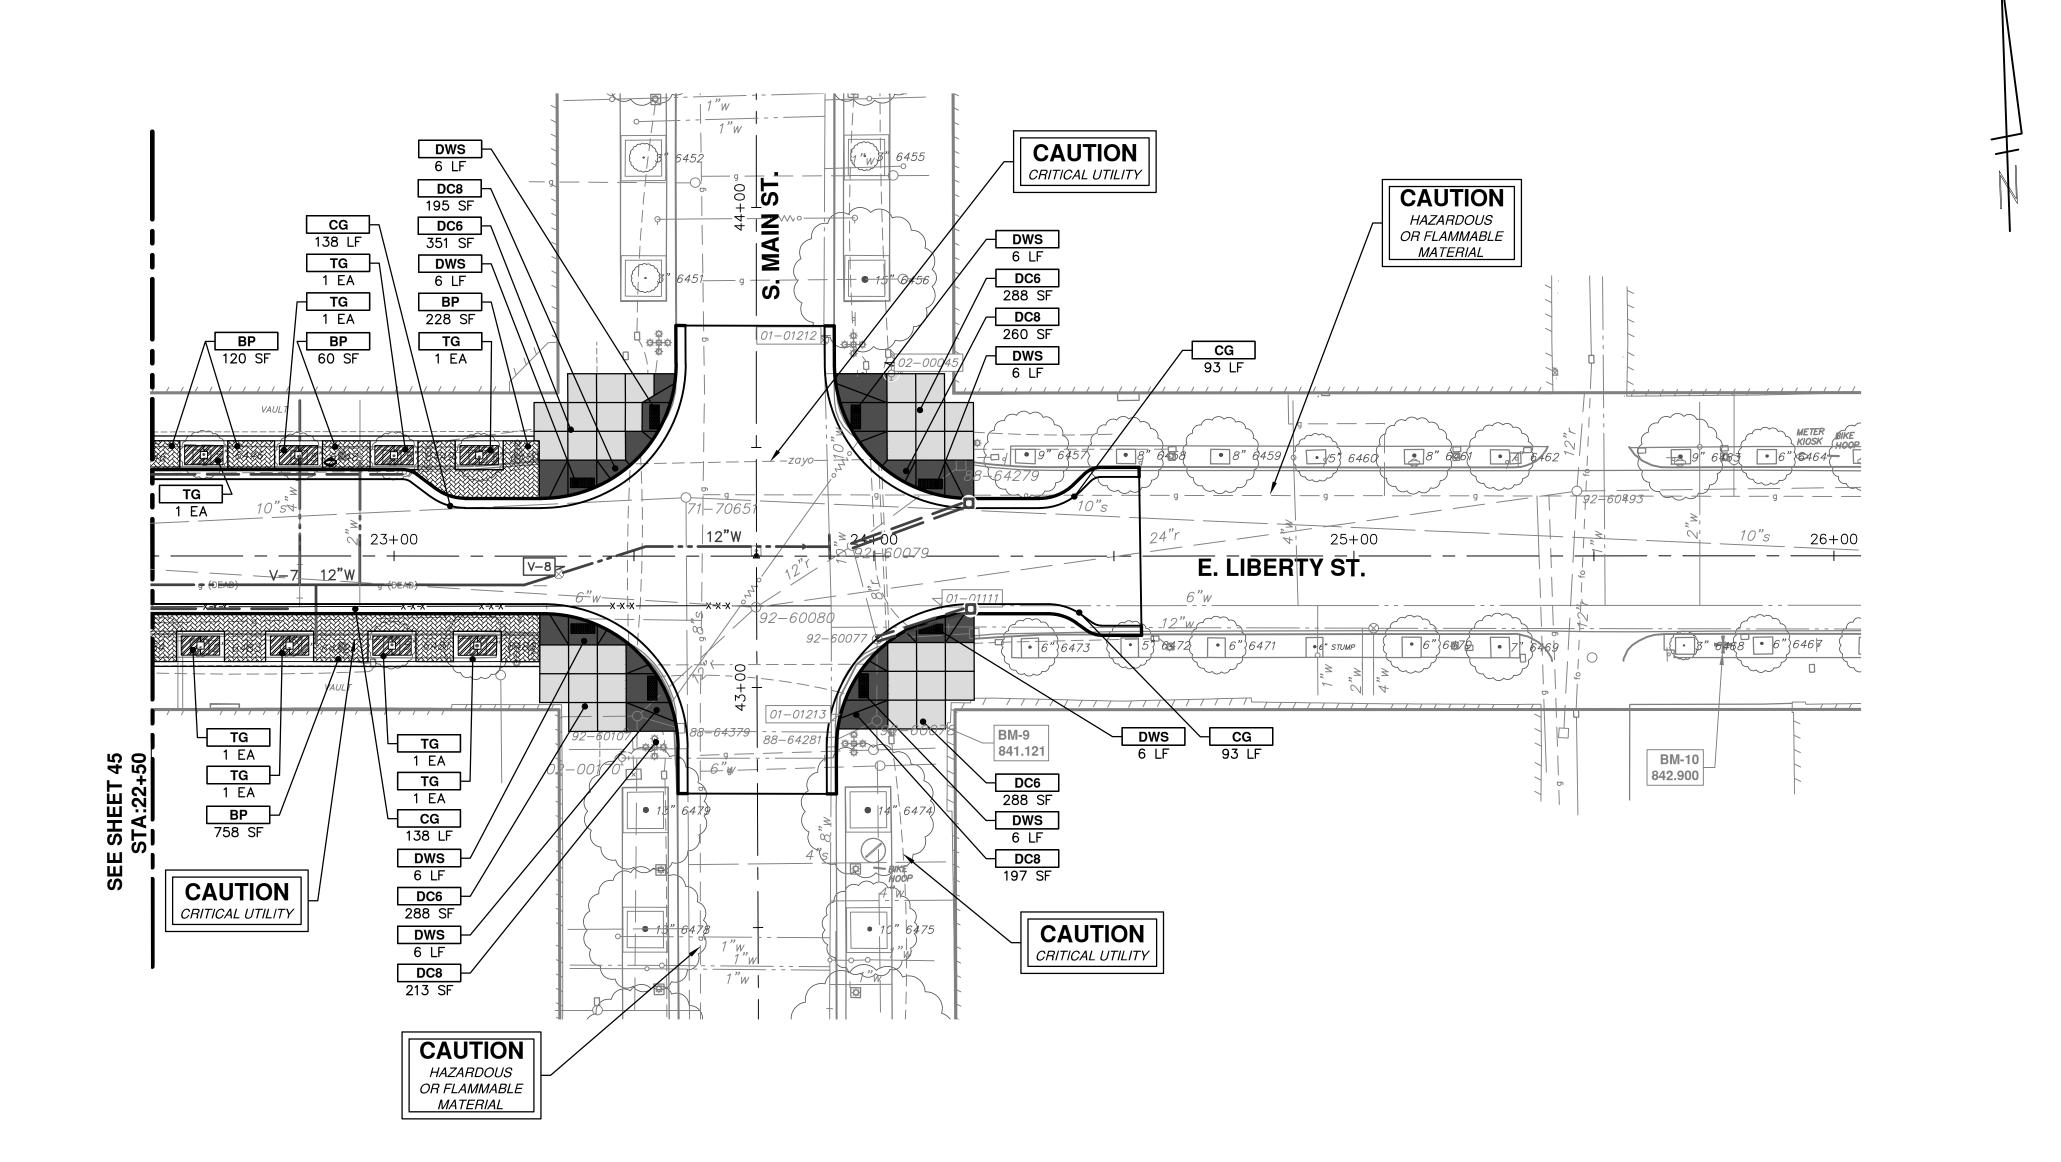


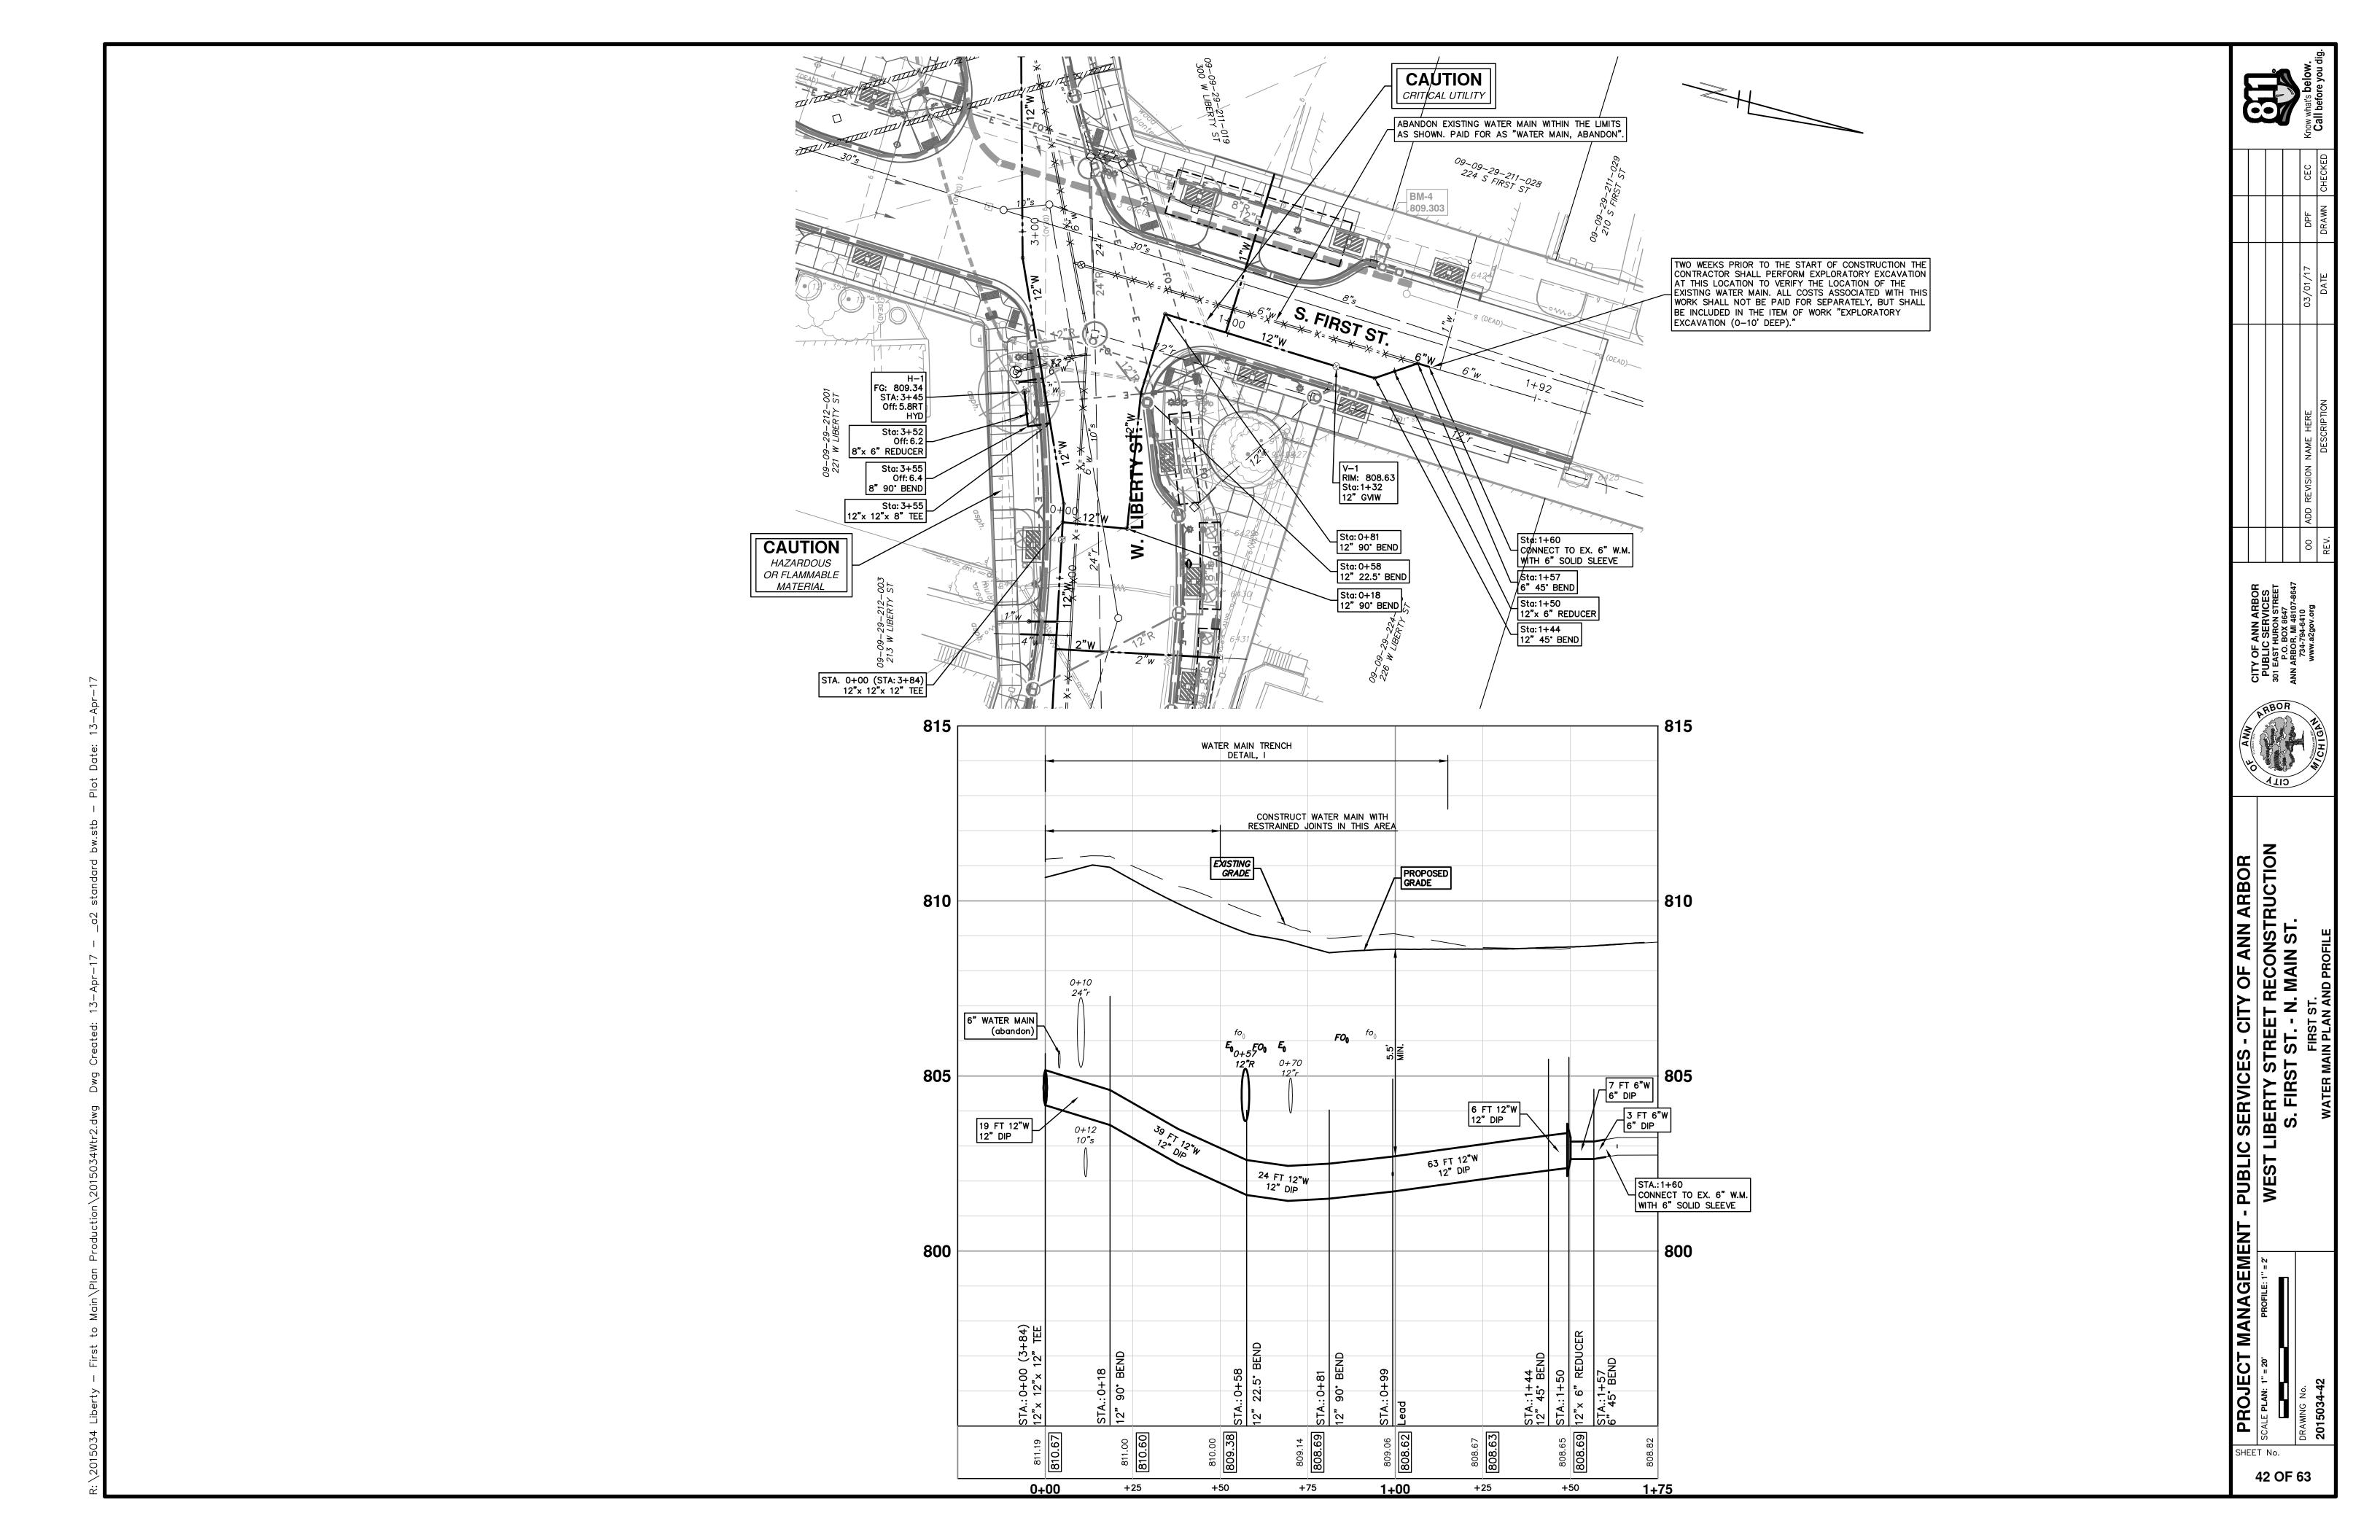	CONSTRUCTION KEY
KEY	DESCRIPTION
CG	PLACE CURB AND GUTTER, CONCRETE, MODIFIED
DO-M	DRIVE OPENING, CONCRETE, DET M, MODIFIED HIGH EARLY WITH FIBER MESH REINFORCE
DC6	PLACE SIDEWALK, CONCRETE, 6 INCH HIGH EARLY WITH FIBER MESH REINFORCE
DC8	PLACE SIDEWALK, RAMP, OR DRIVE, CONCRETE, 8 INCH HIGH EARLY WITH FIBER MESH REINFORCE
DWS	DETECTABLE WARNING SURFACE, MODIFIED, DIP
ВР	PLACE BRICK XXXXXXXX
TG	PLACE TREE GRATE
АВО	ADJUST BY OTHERS
1	ADJUST GATE VALVE BOX, MONUMENT BOX, OR GAS BOX.
2	REMOVE AND REPLACE MDOT TYPE B CASTING, MODIFIED
3	REMOVE AND REPLACE MDOT TYPE K CASTING, MODIFIED
4	POINT STRUCTURE.
5	ADJUST MDOT TYPE B CASTING TO FINISH GRADE
6	ADJUST MDOT TYPE K CASTING TO FINISH GRADE
7	ADDITIONAL DEPTH DRAINAGE STRUCTURE ADJUST/REPAIR. PERFORM DEPTH OF ADJUST/REPAIR AS SHOWN ON THE PLANS AND AS DIRECTED BY THE ENGINEER

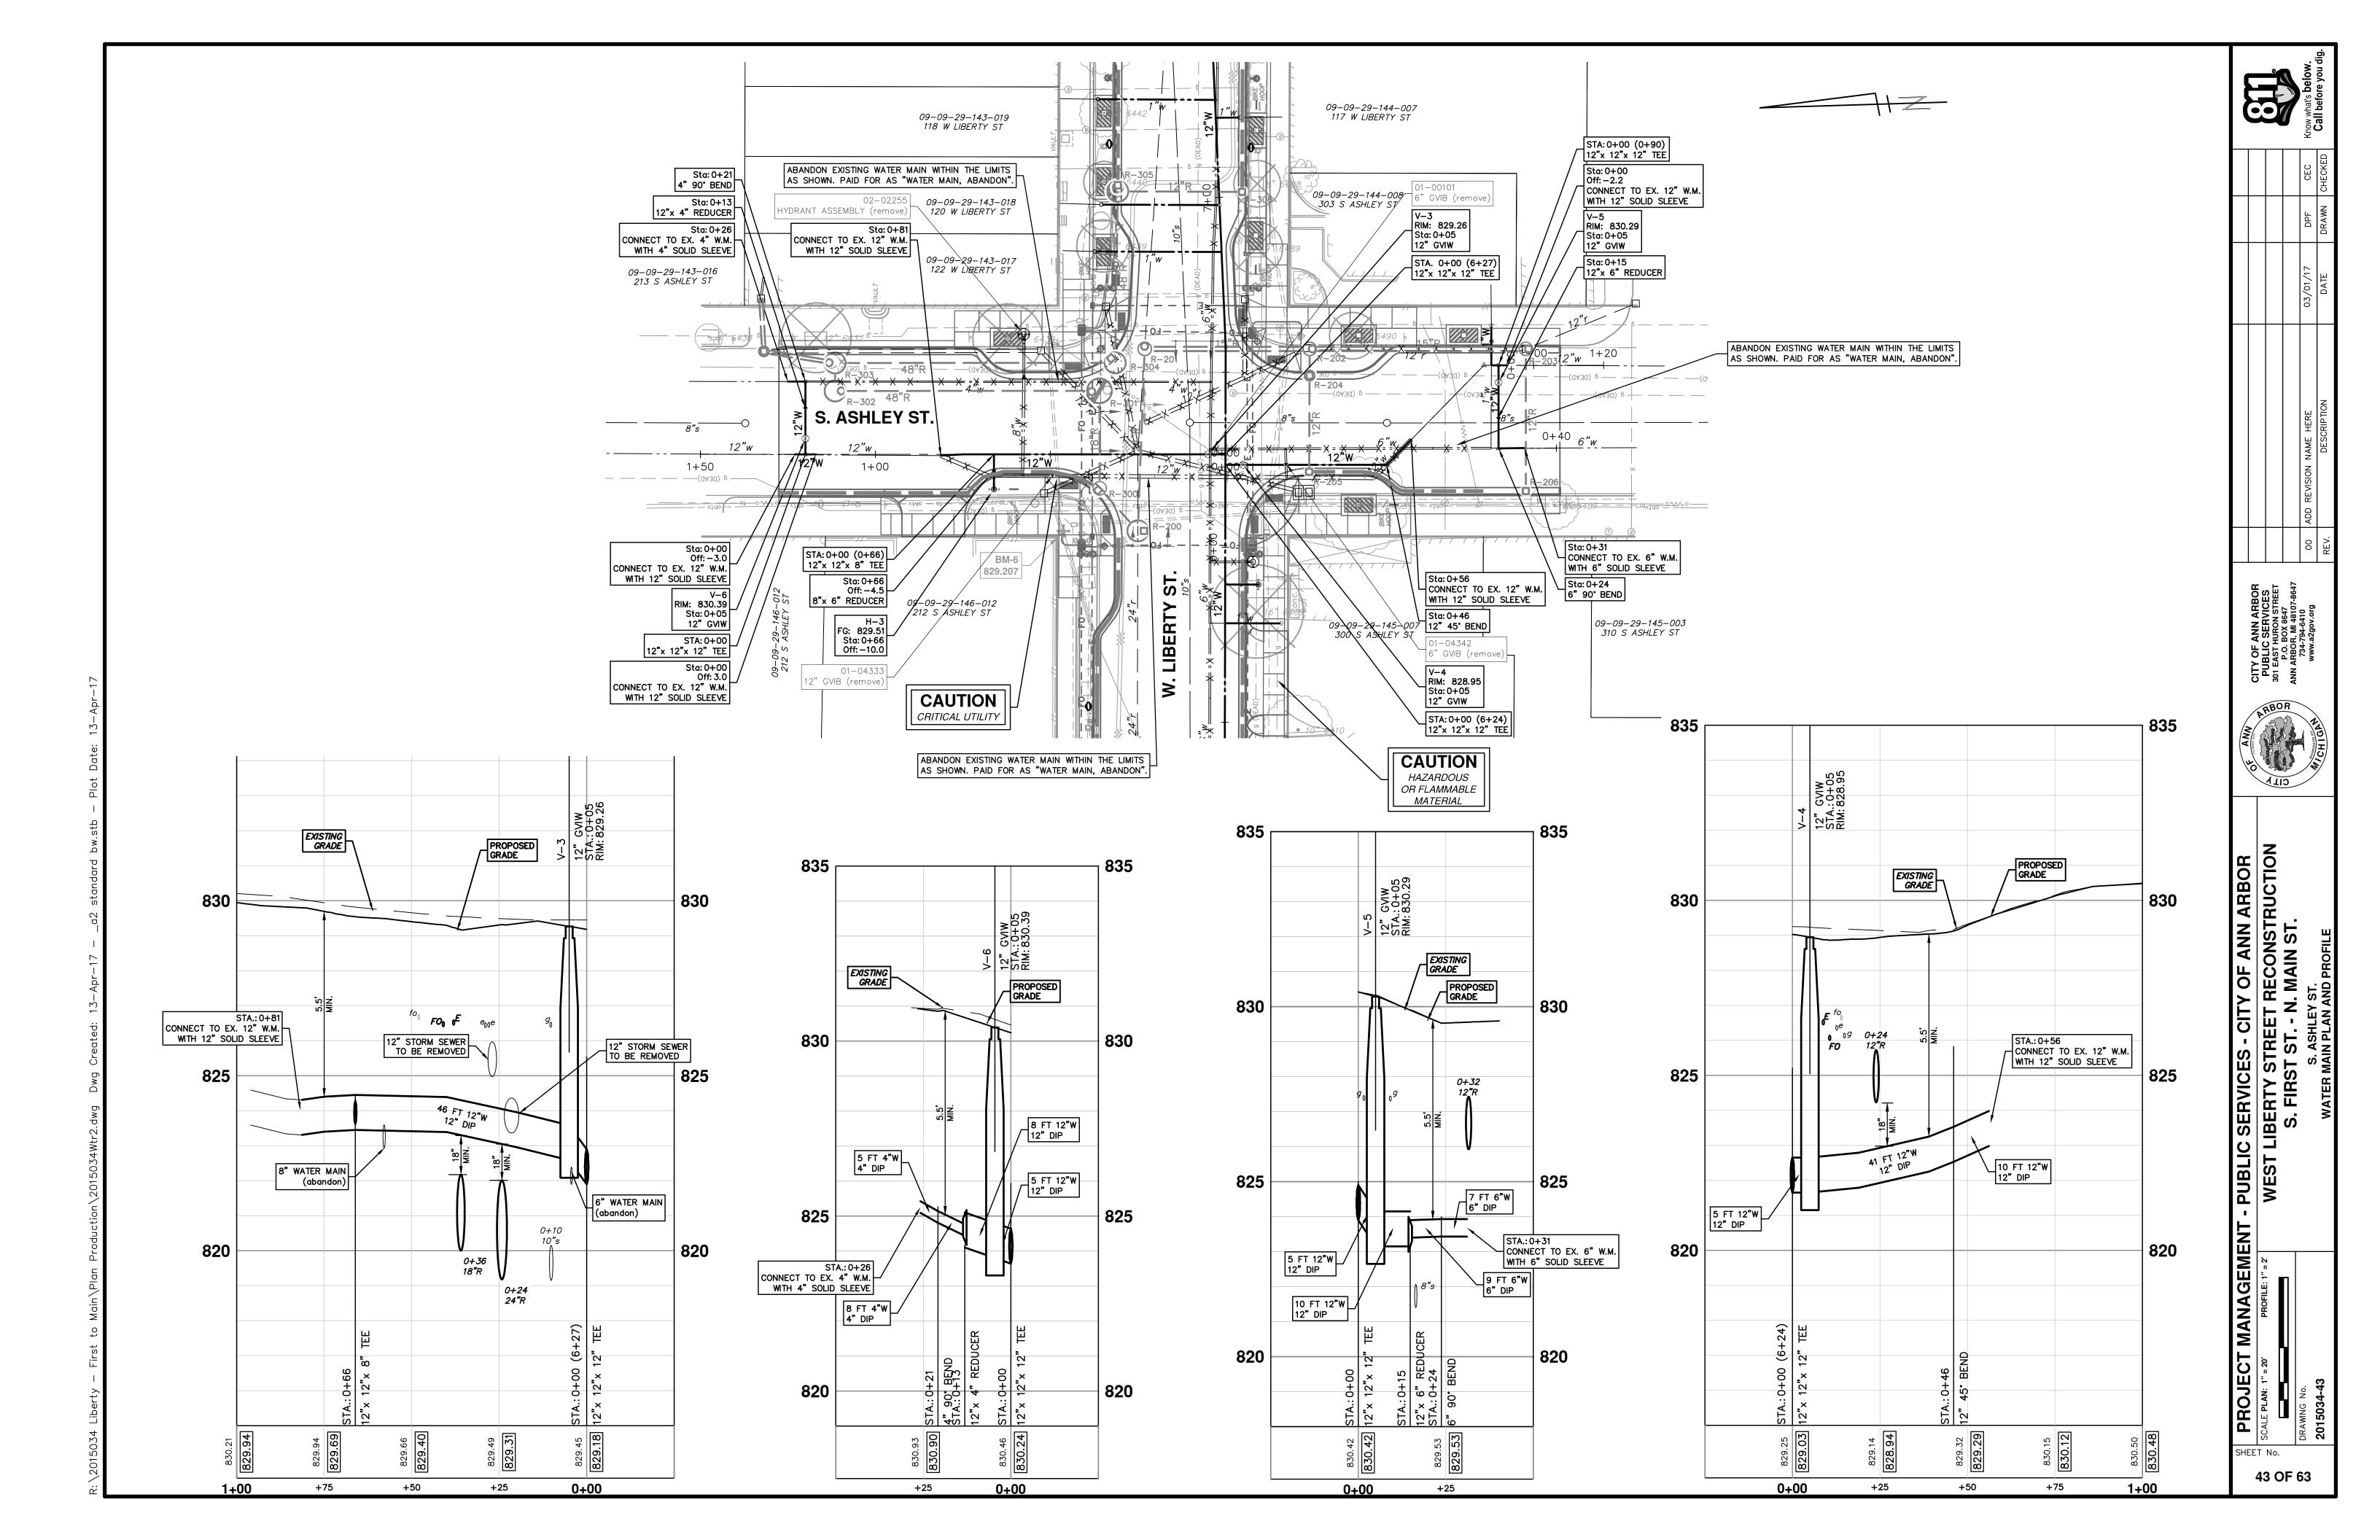-				
	00	00 ADD REVISION NAME HERE	03/01/17	DP
	REV.	DESCRIPTION	DATE	DRA

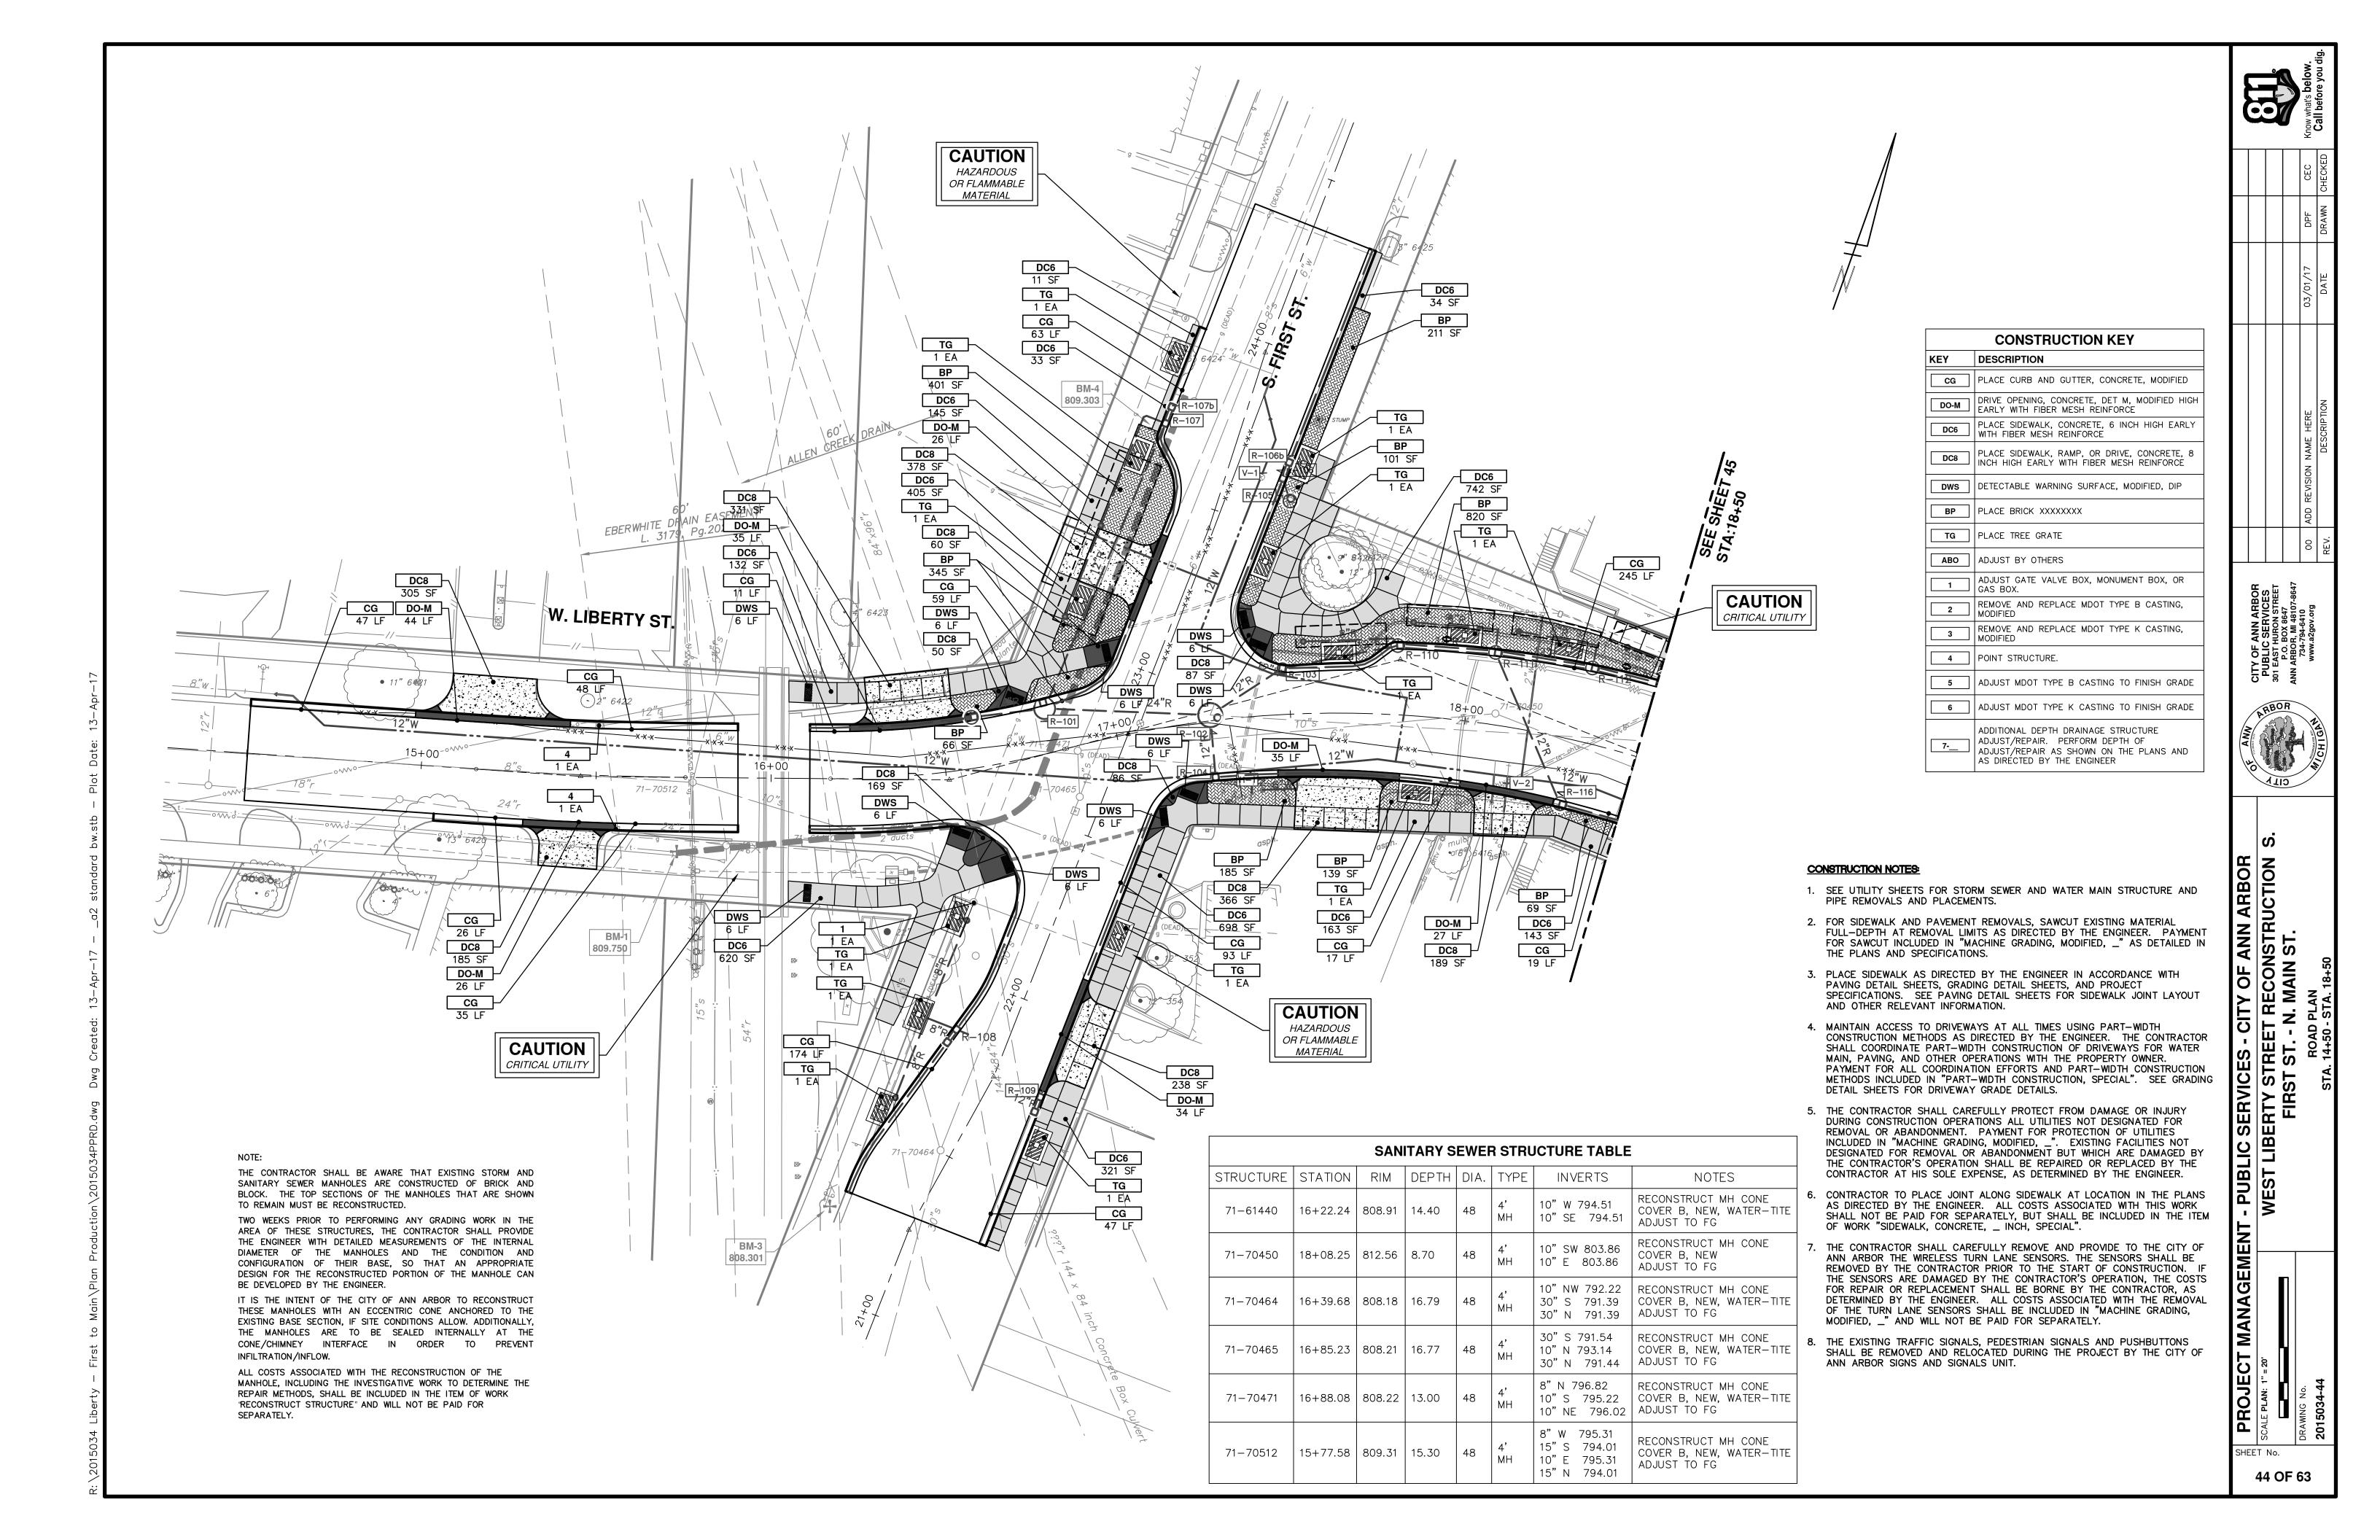F - PUBLIC SERVICES - CITY OF ANN ARBOR
WEST LIBERTY STREET RECONSTRUCTIO
S. FIRST ST. - N. MAIN ST.
ROAD PLAN
STA. 18+50 - STA. 22+50

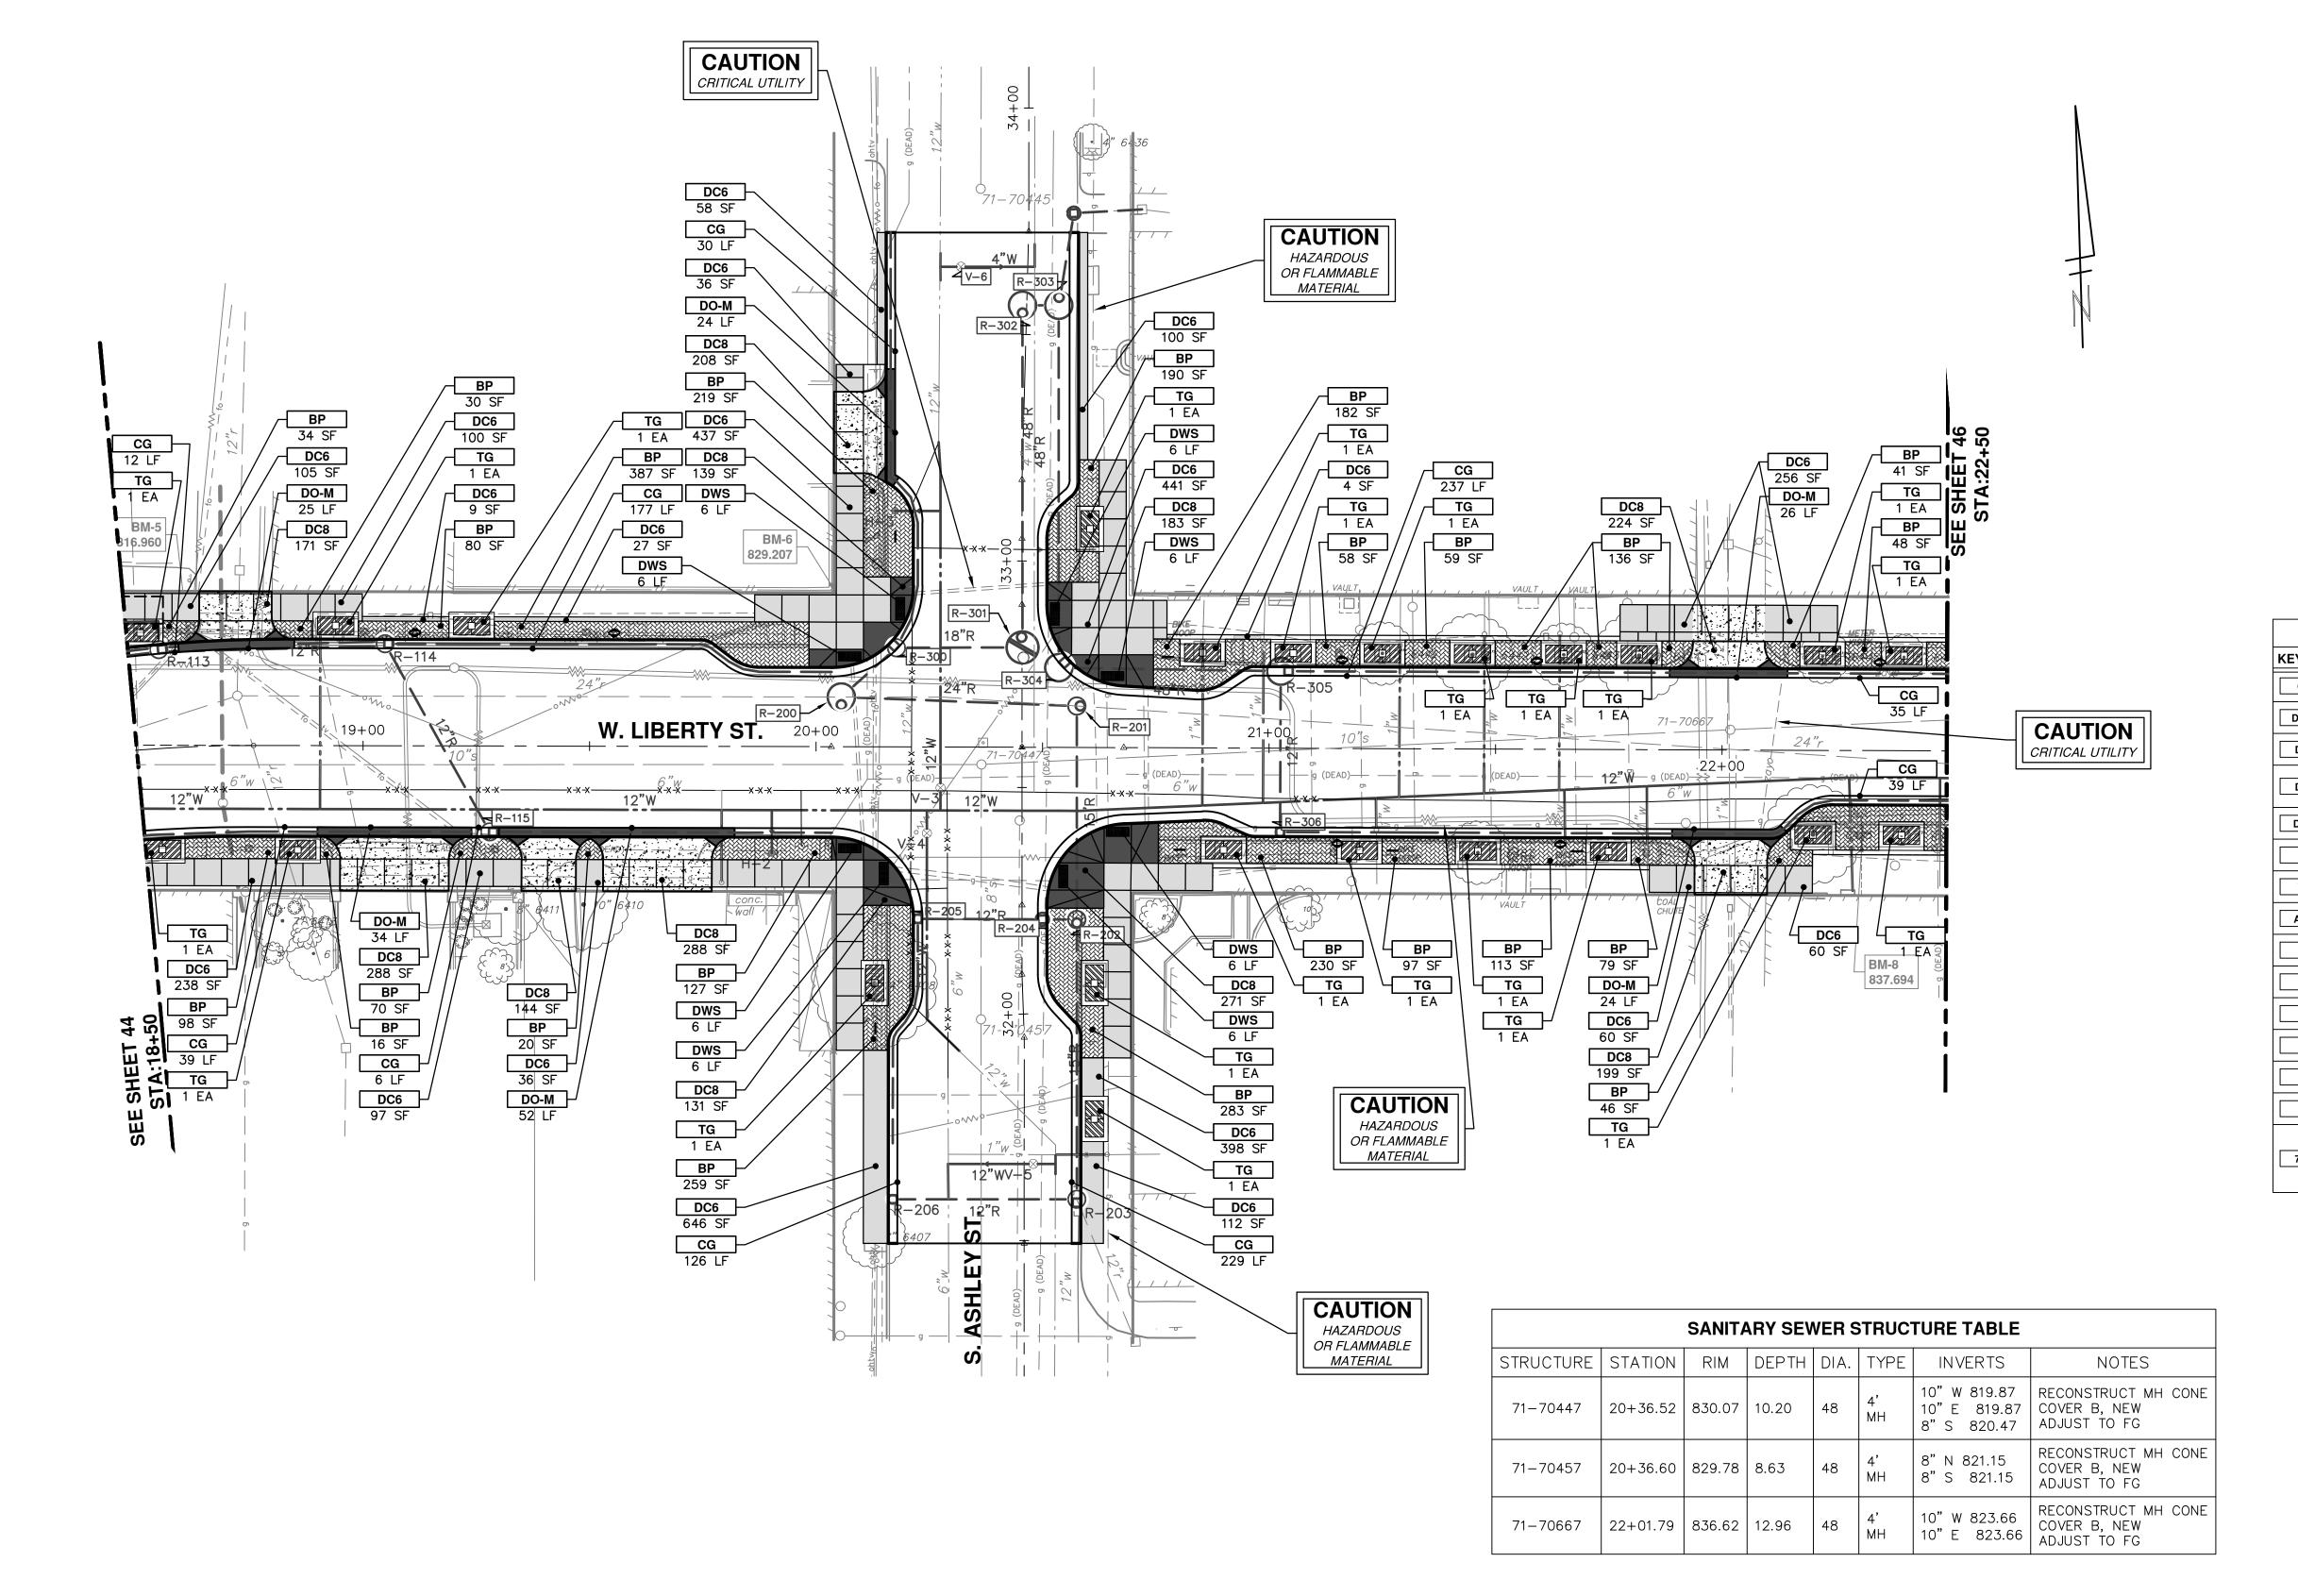
PROJECT MANAGEMENT -



	CONSTRUCTION KEY	
KEY	DESCRIPTION	
CG	PLACE CURB AND GUTTER, CONCRETE, MODIFIED	
DO-M	DRIVE OPENING, CONCRETE, DET M, MODIFIED HIGH EARLY WITH FIBER MESH REINFORCE	
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1	ADJUST GATE VALVE BOX, MONUMENT BOX, OR GAS BOX.	
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4	POINT STRUCTURE.	
5	ADJUST MDOT TYPE B CASTING TO FINISH GRADE	
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7	ADDITIONAL DEPTH DRAINAGE STRUCTURE ADJUST/REPAIR. PERFORM DEPTH OF ADJUST/REPAIR AS SHOWN ON THE PLANS AND AS DIRECTED BY THE ENGINEER	


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IT - PUBLIC SERVICES - CITY OF ANN ARBOR
WEST LIBERTY STREET RECONSTRUCTION
FIRST ST. - N. MAIN ST.
ROAD PROFILES
LIBERTY STREET & S. FIRST STREET PROJECT MANAGEMENT

SCALE: 1" = 20' PROFILE: 1" = 2'

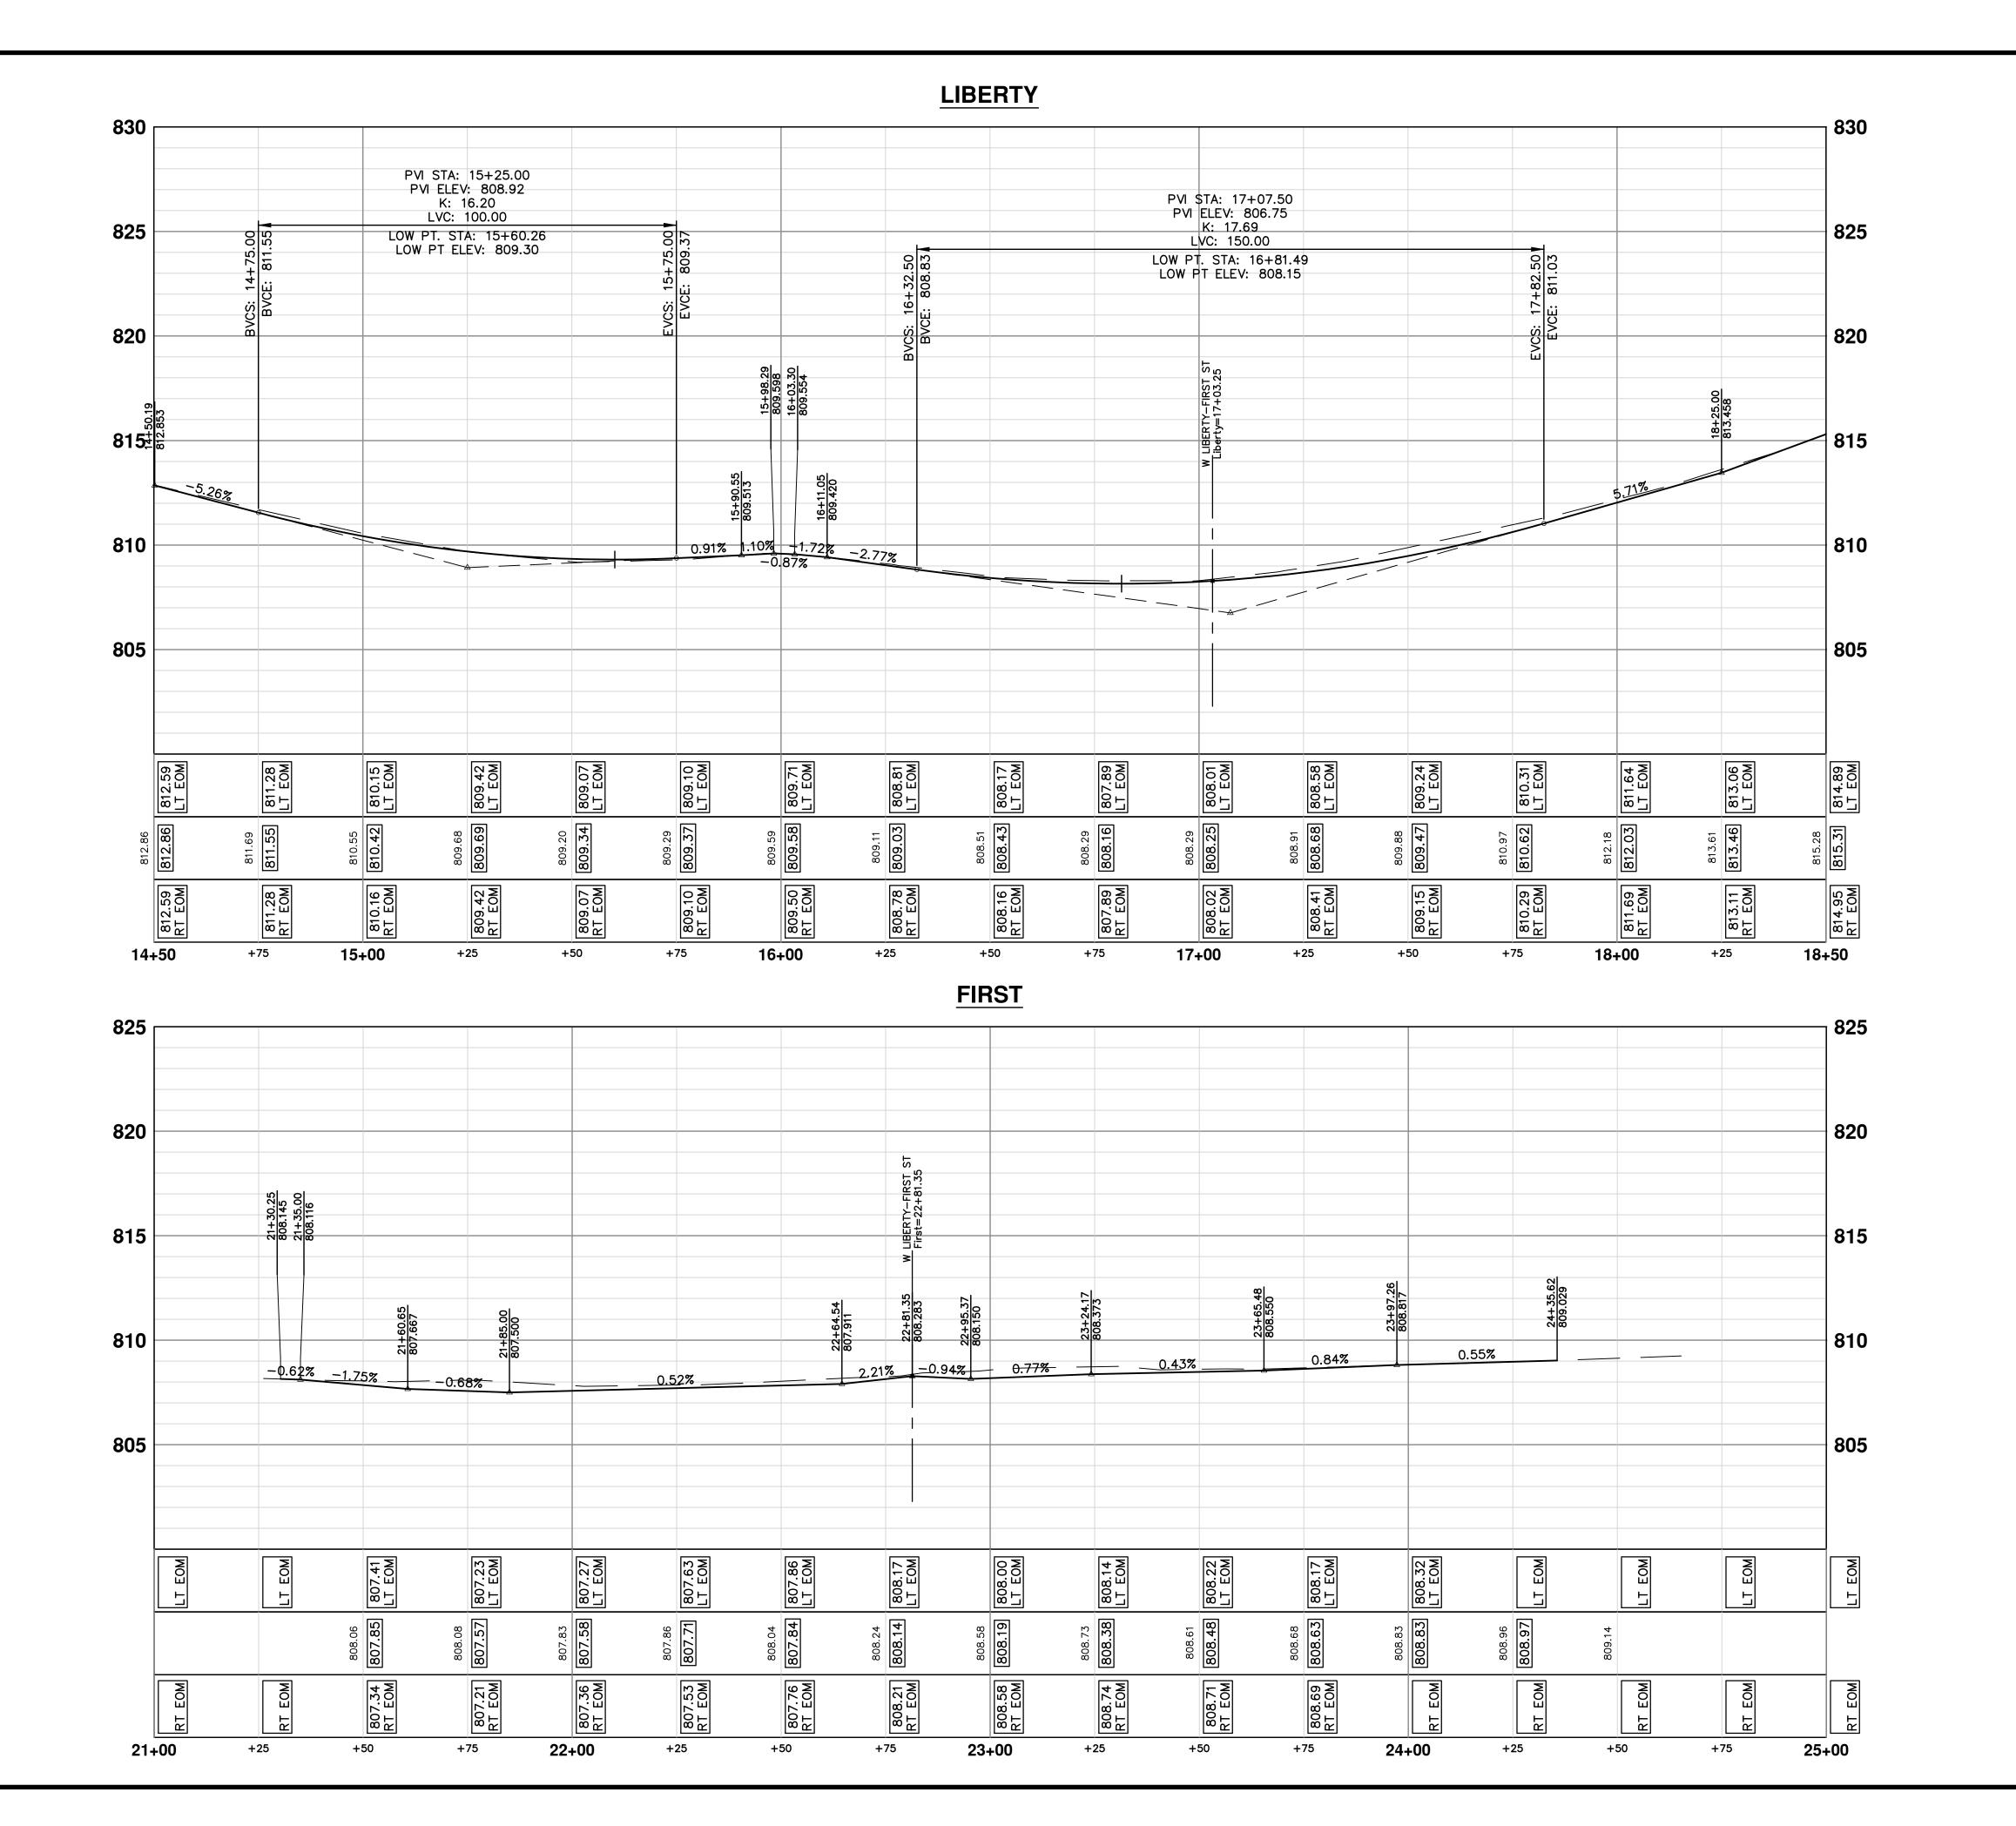

PROJECT MANAGEMENT - PUBLIC SERVICES - CITY OF ANN ARBC

SCALE: 1" = 20'

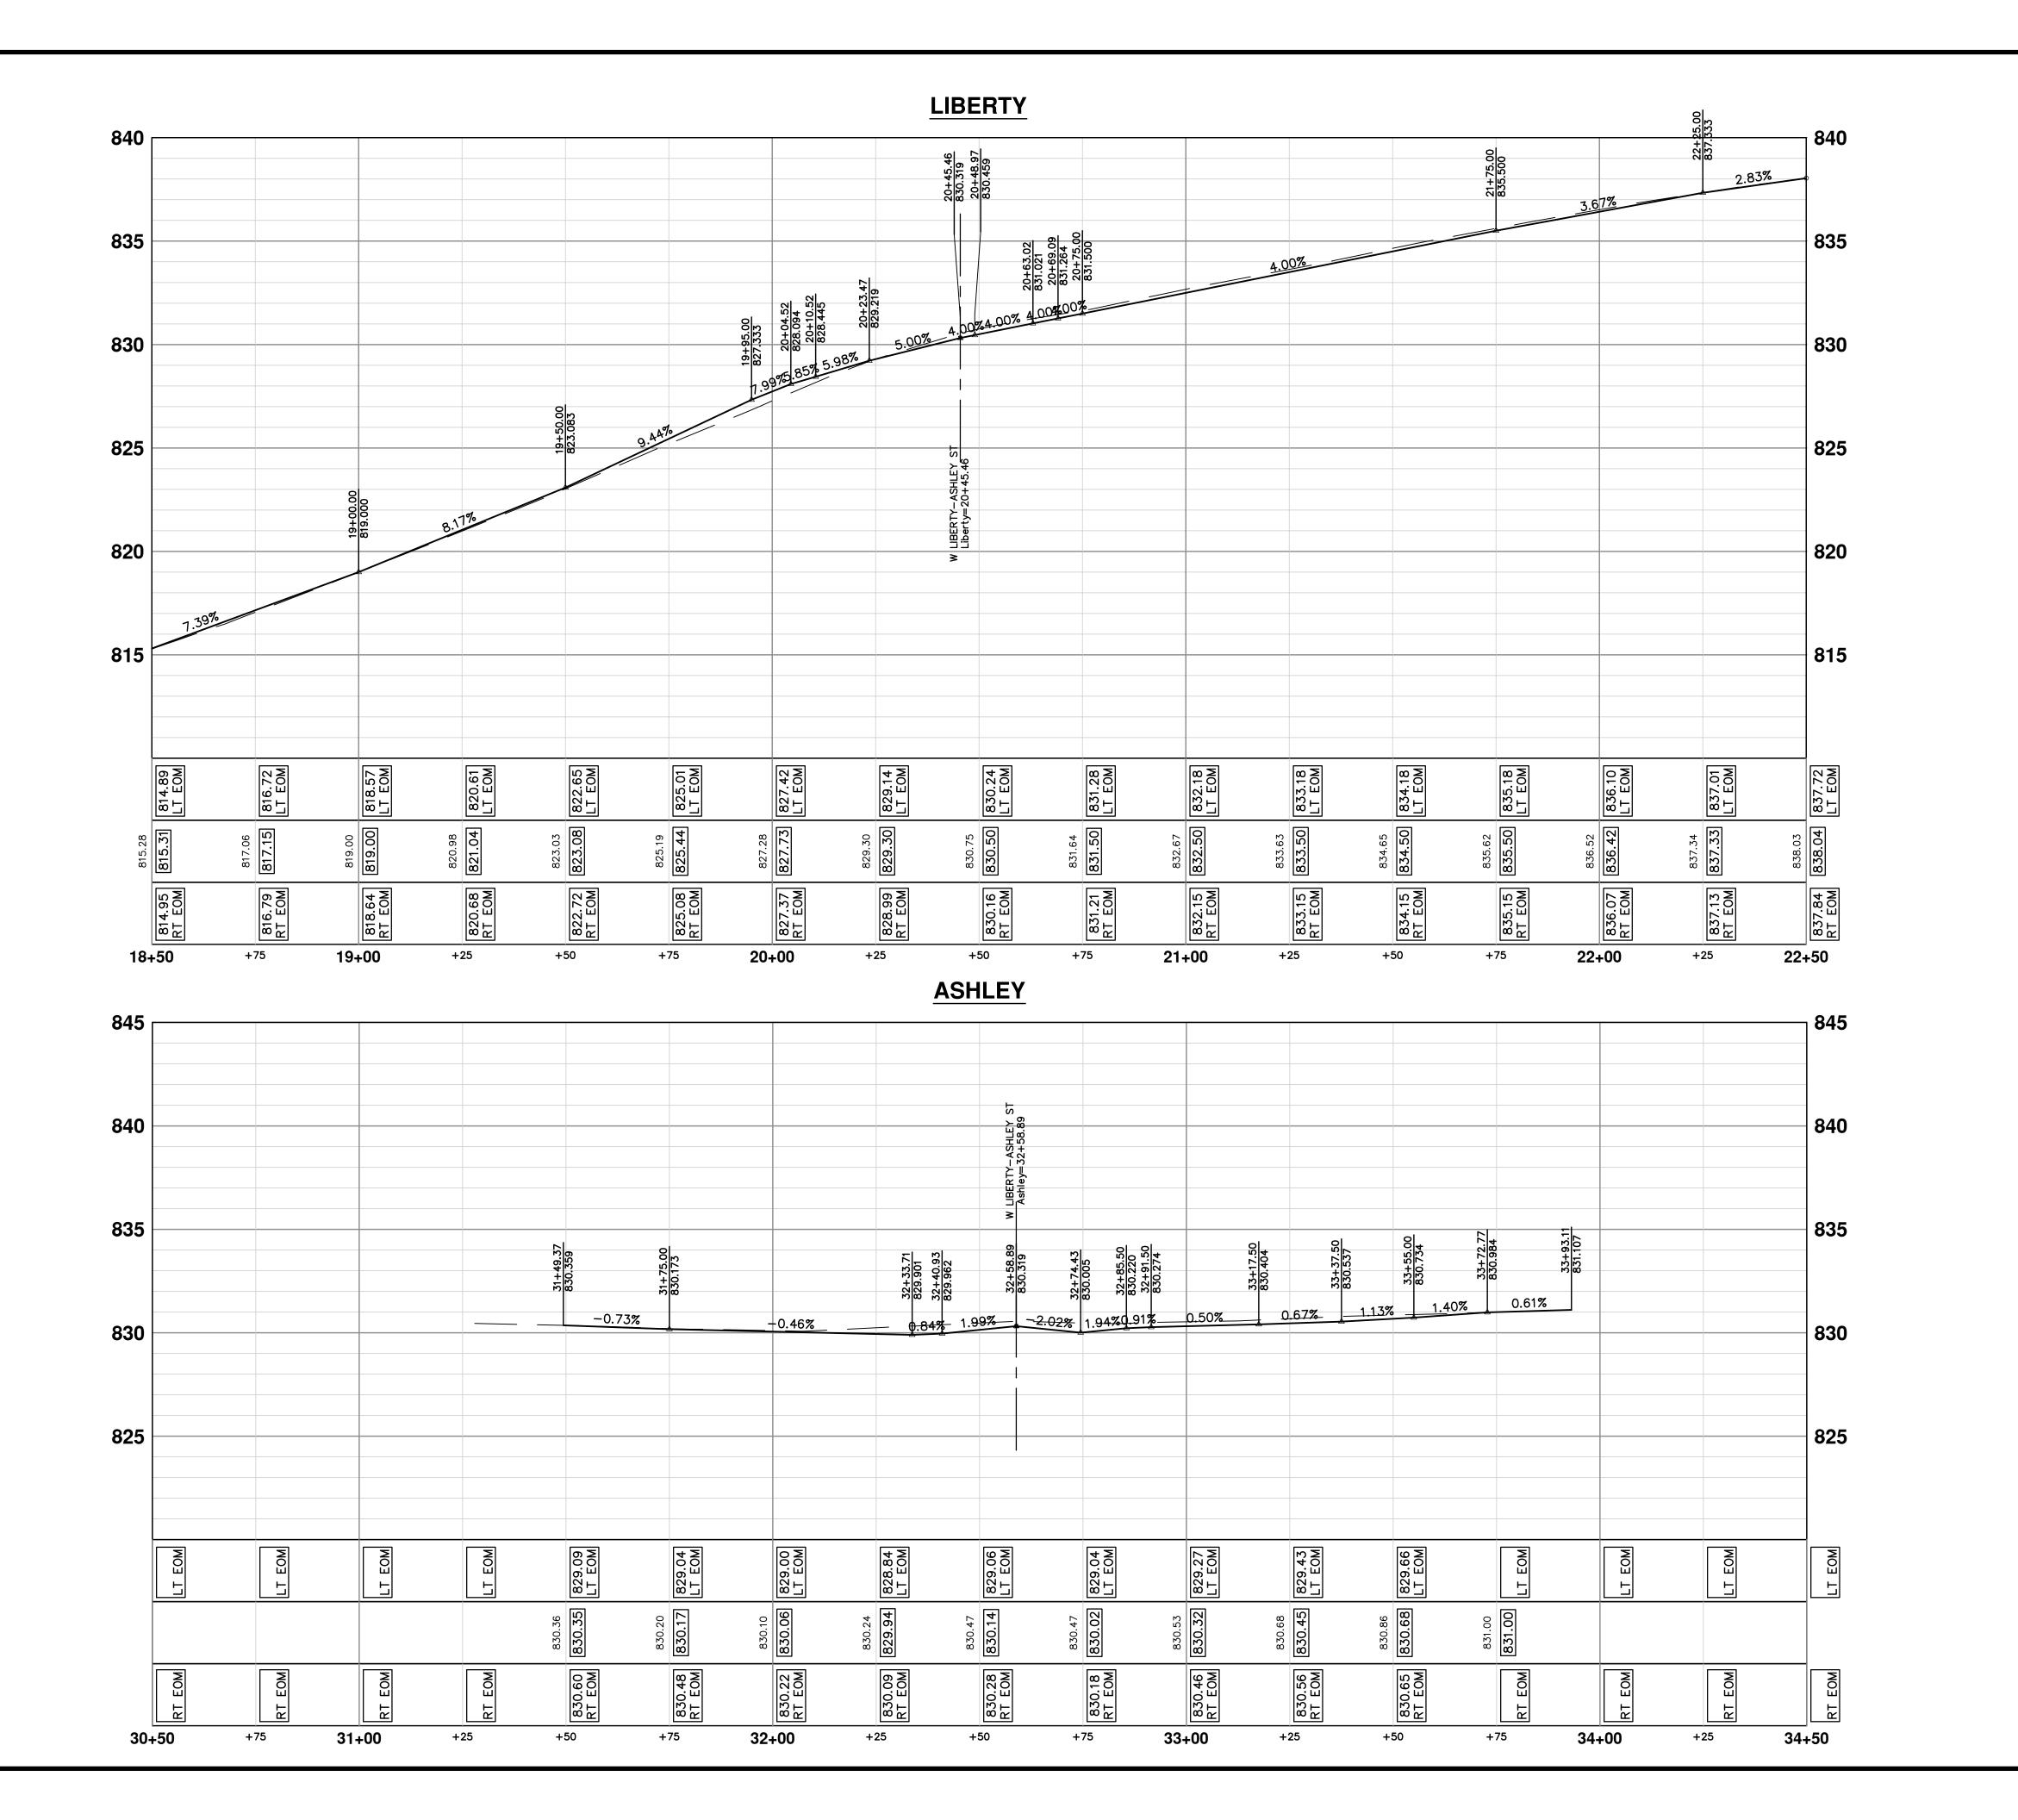SCALE: 1" = 20'


PROJECT MANAGEMENT - PUBLIC SERVICES - CITY OF ANN ARBC

WEST LIBERTY STREET RECONSTRUCT

S. FIRST ST. - N. MAIN ST.

ROAD PROFILES

LIBERTY STREET & S. ASHLEY STREET

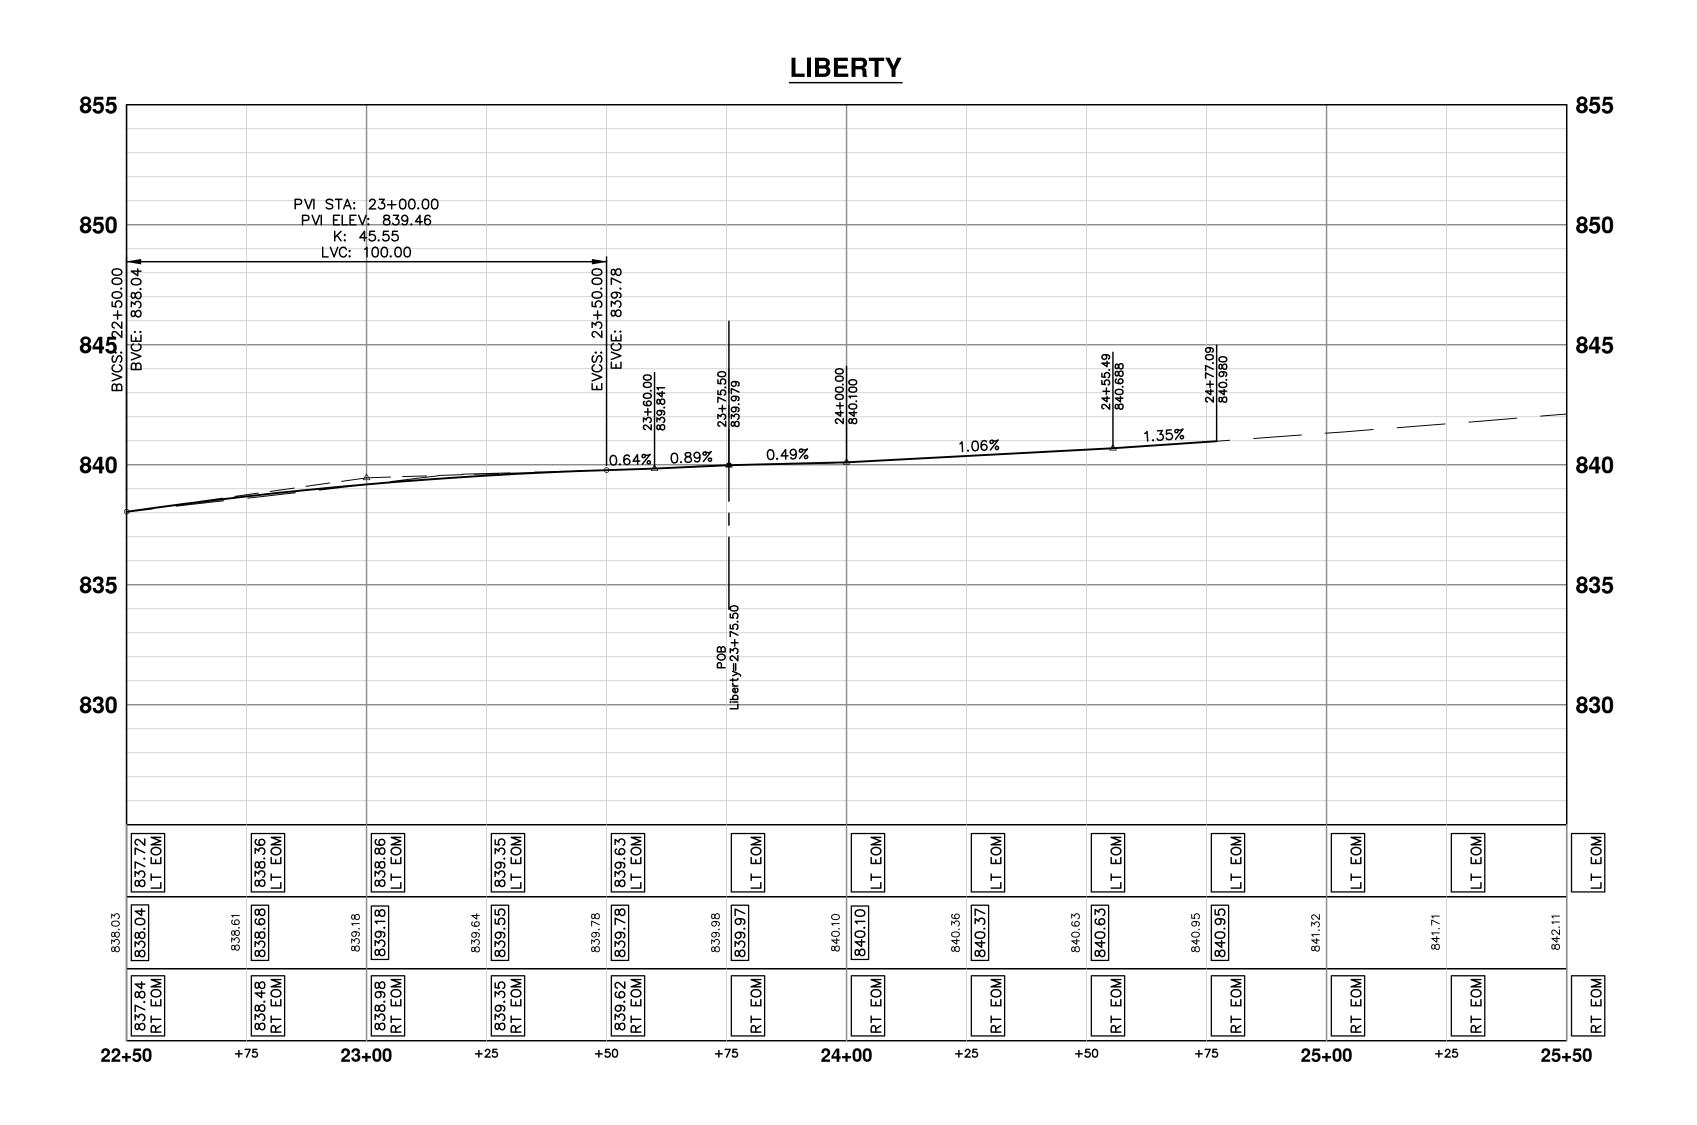

PROJECT MANAGEMENT - PUBLIC SERVICES - CITY OF ANN ARBOR

SCALE: 1" = 20'

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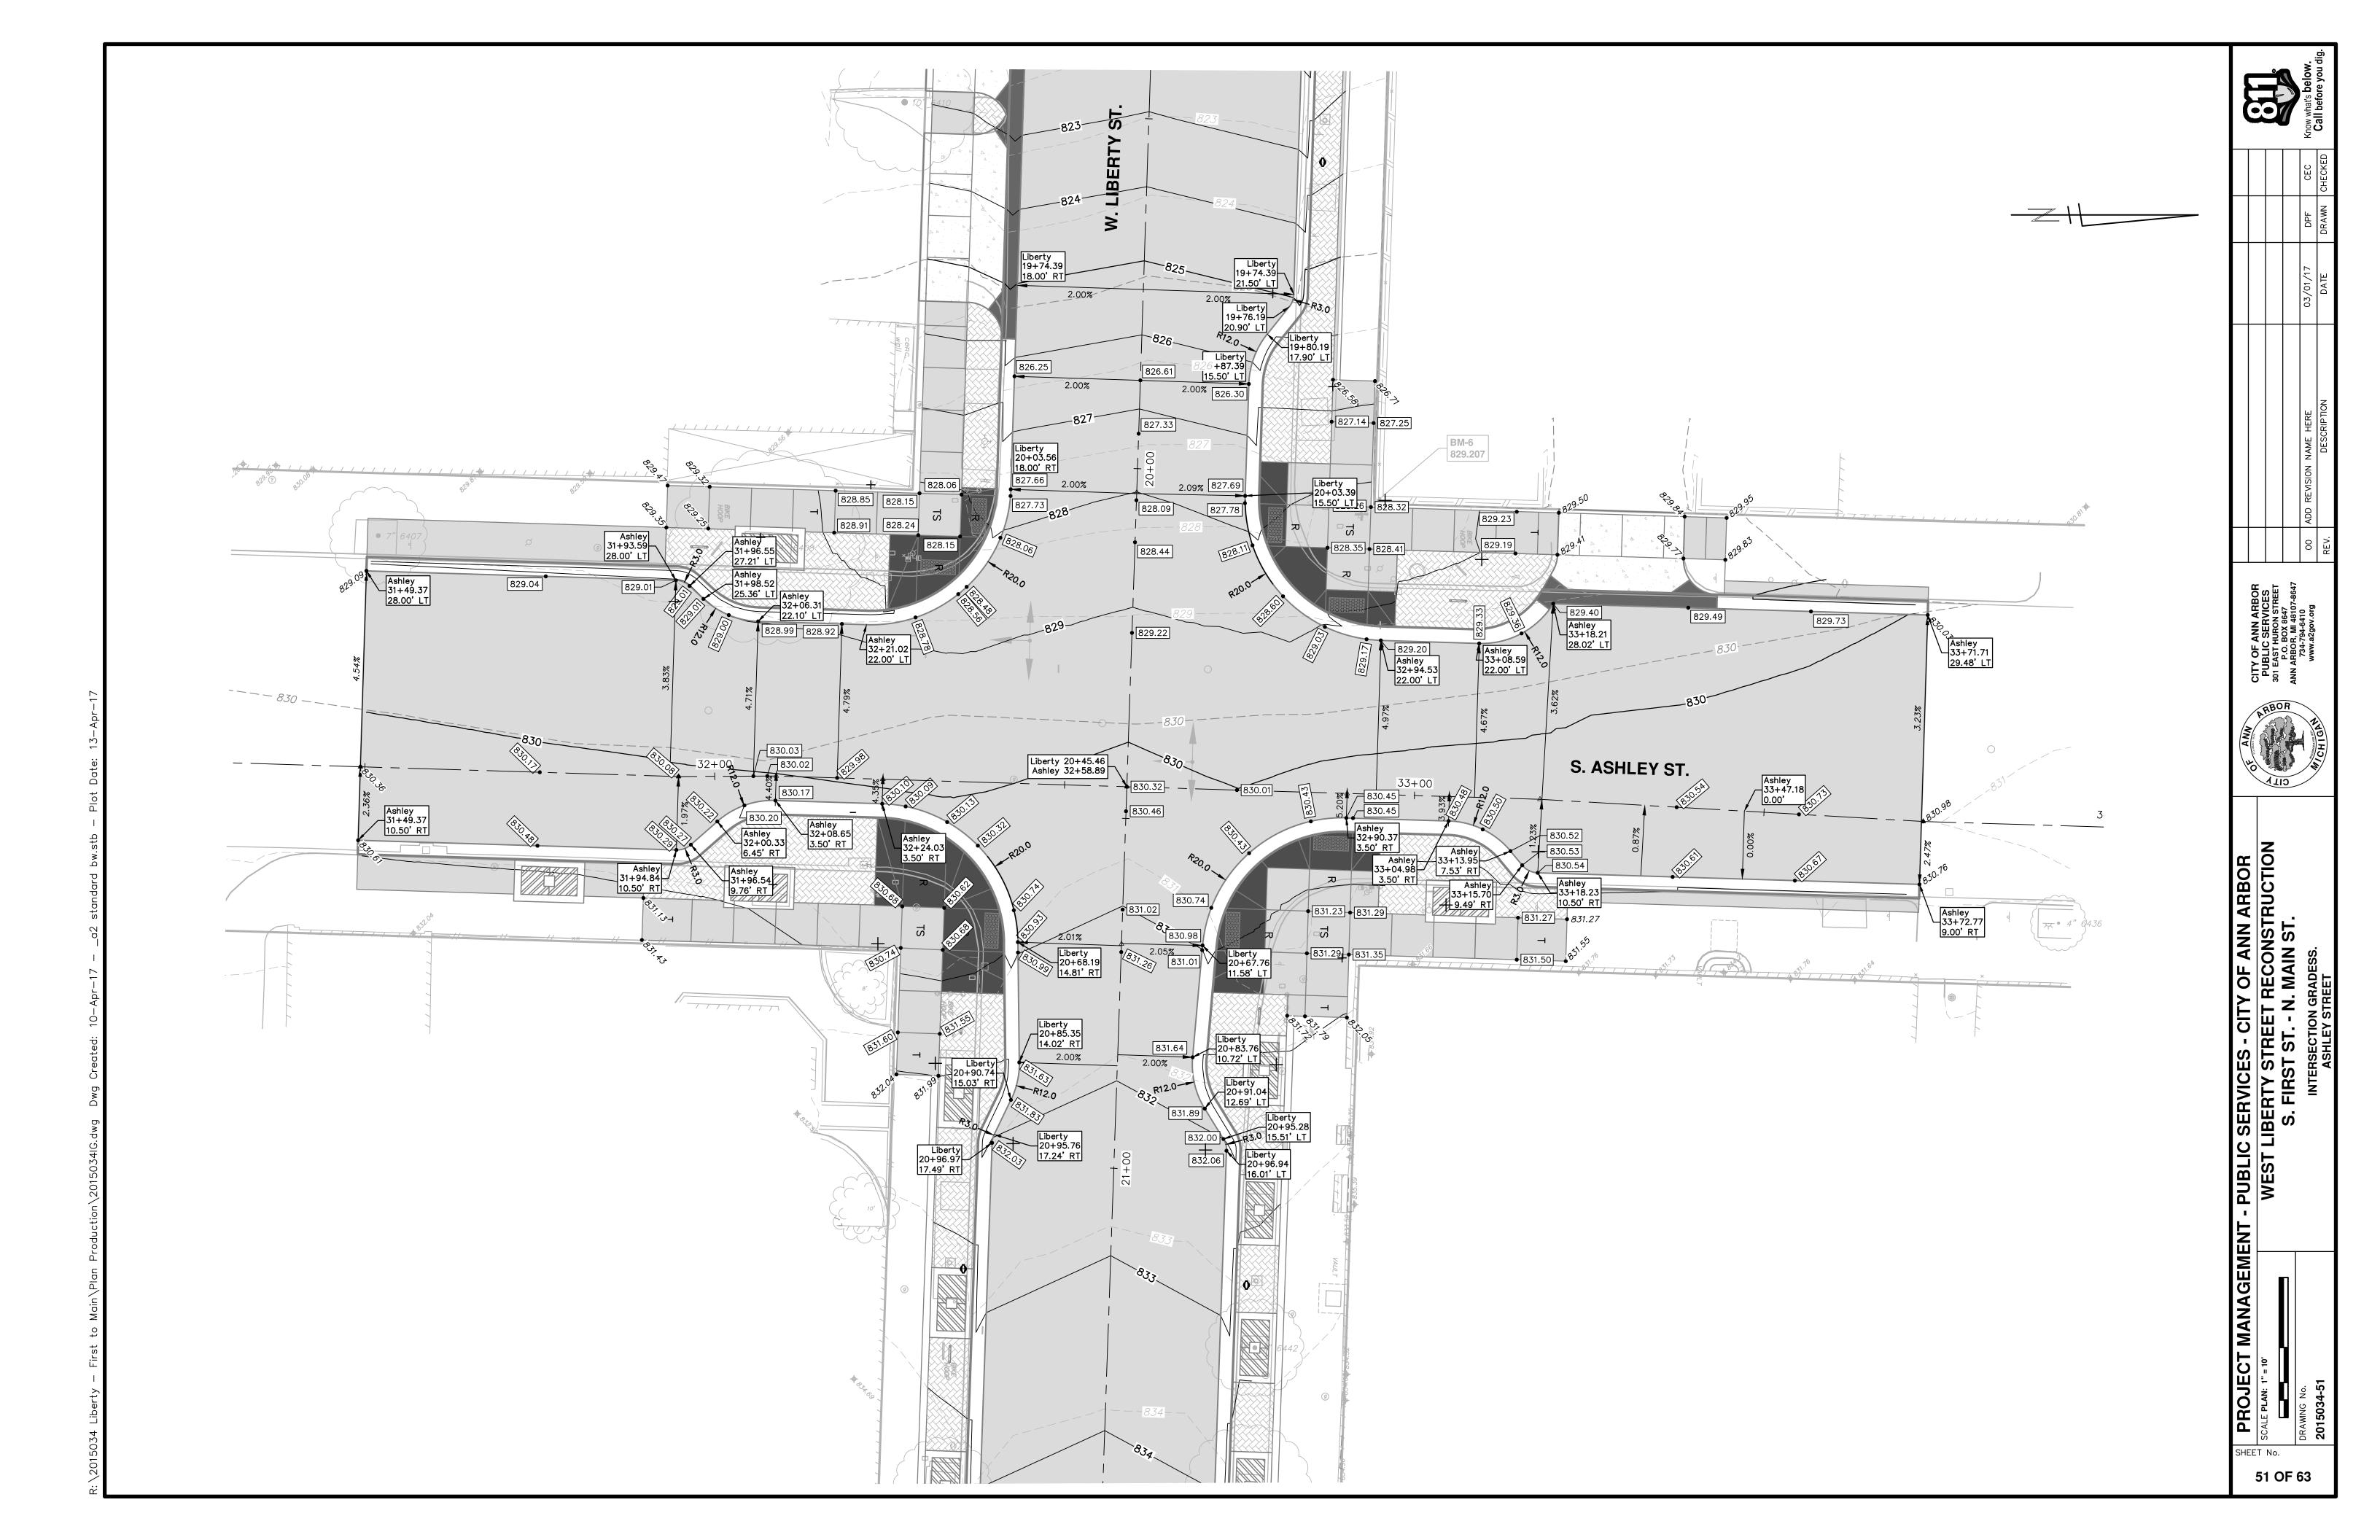
PROJECT MANAGEMENT - PUBLIC SERVICES - CITY OF ANN ARBOR


WEST LIBERTY STREET RECONSTRUCTION

S. FIRST ST. - N. MAIN ST.

ROAD PROFILES
LIBERTY STREET





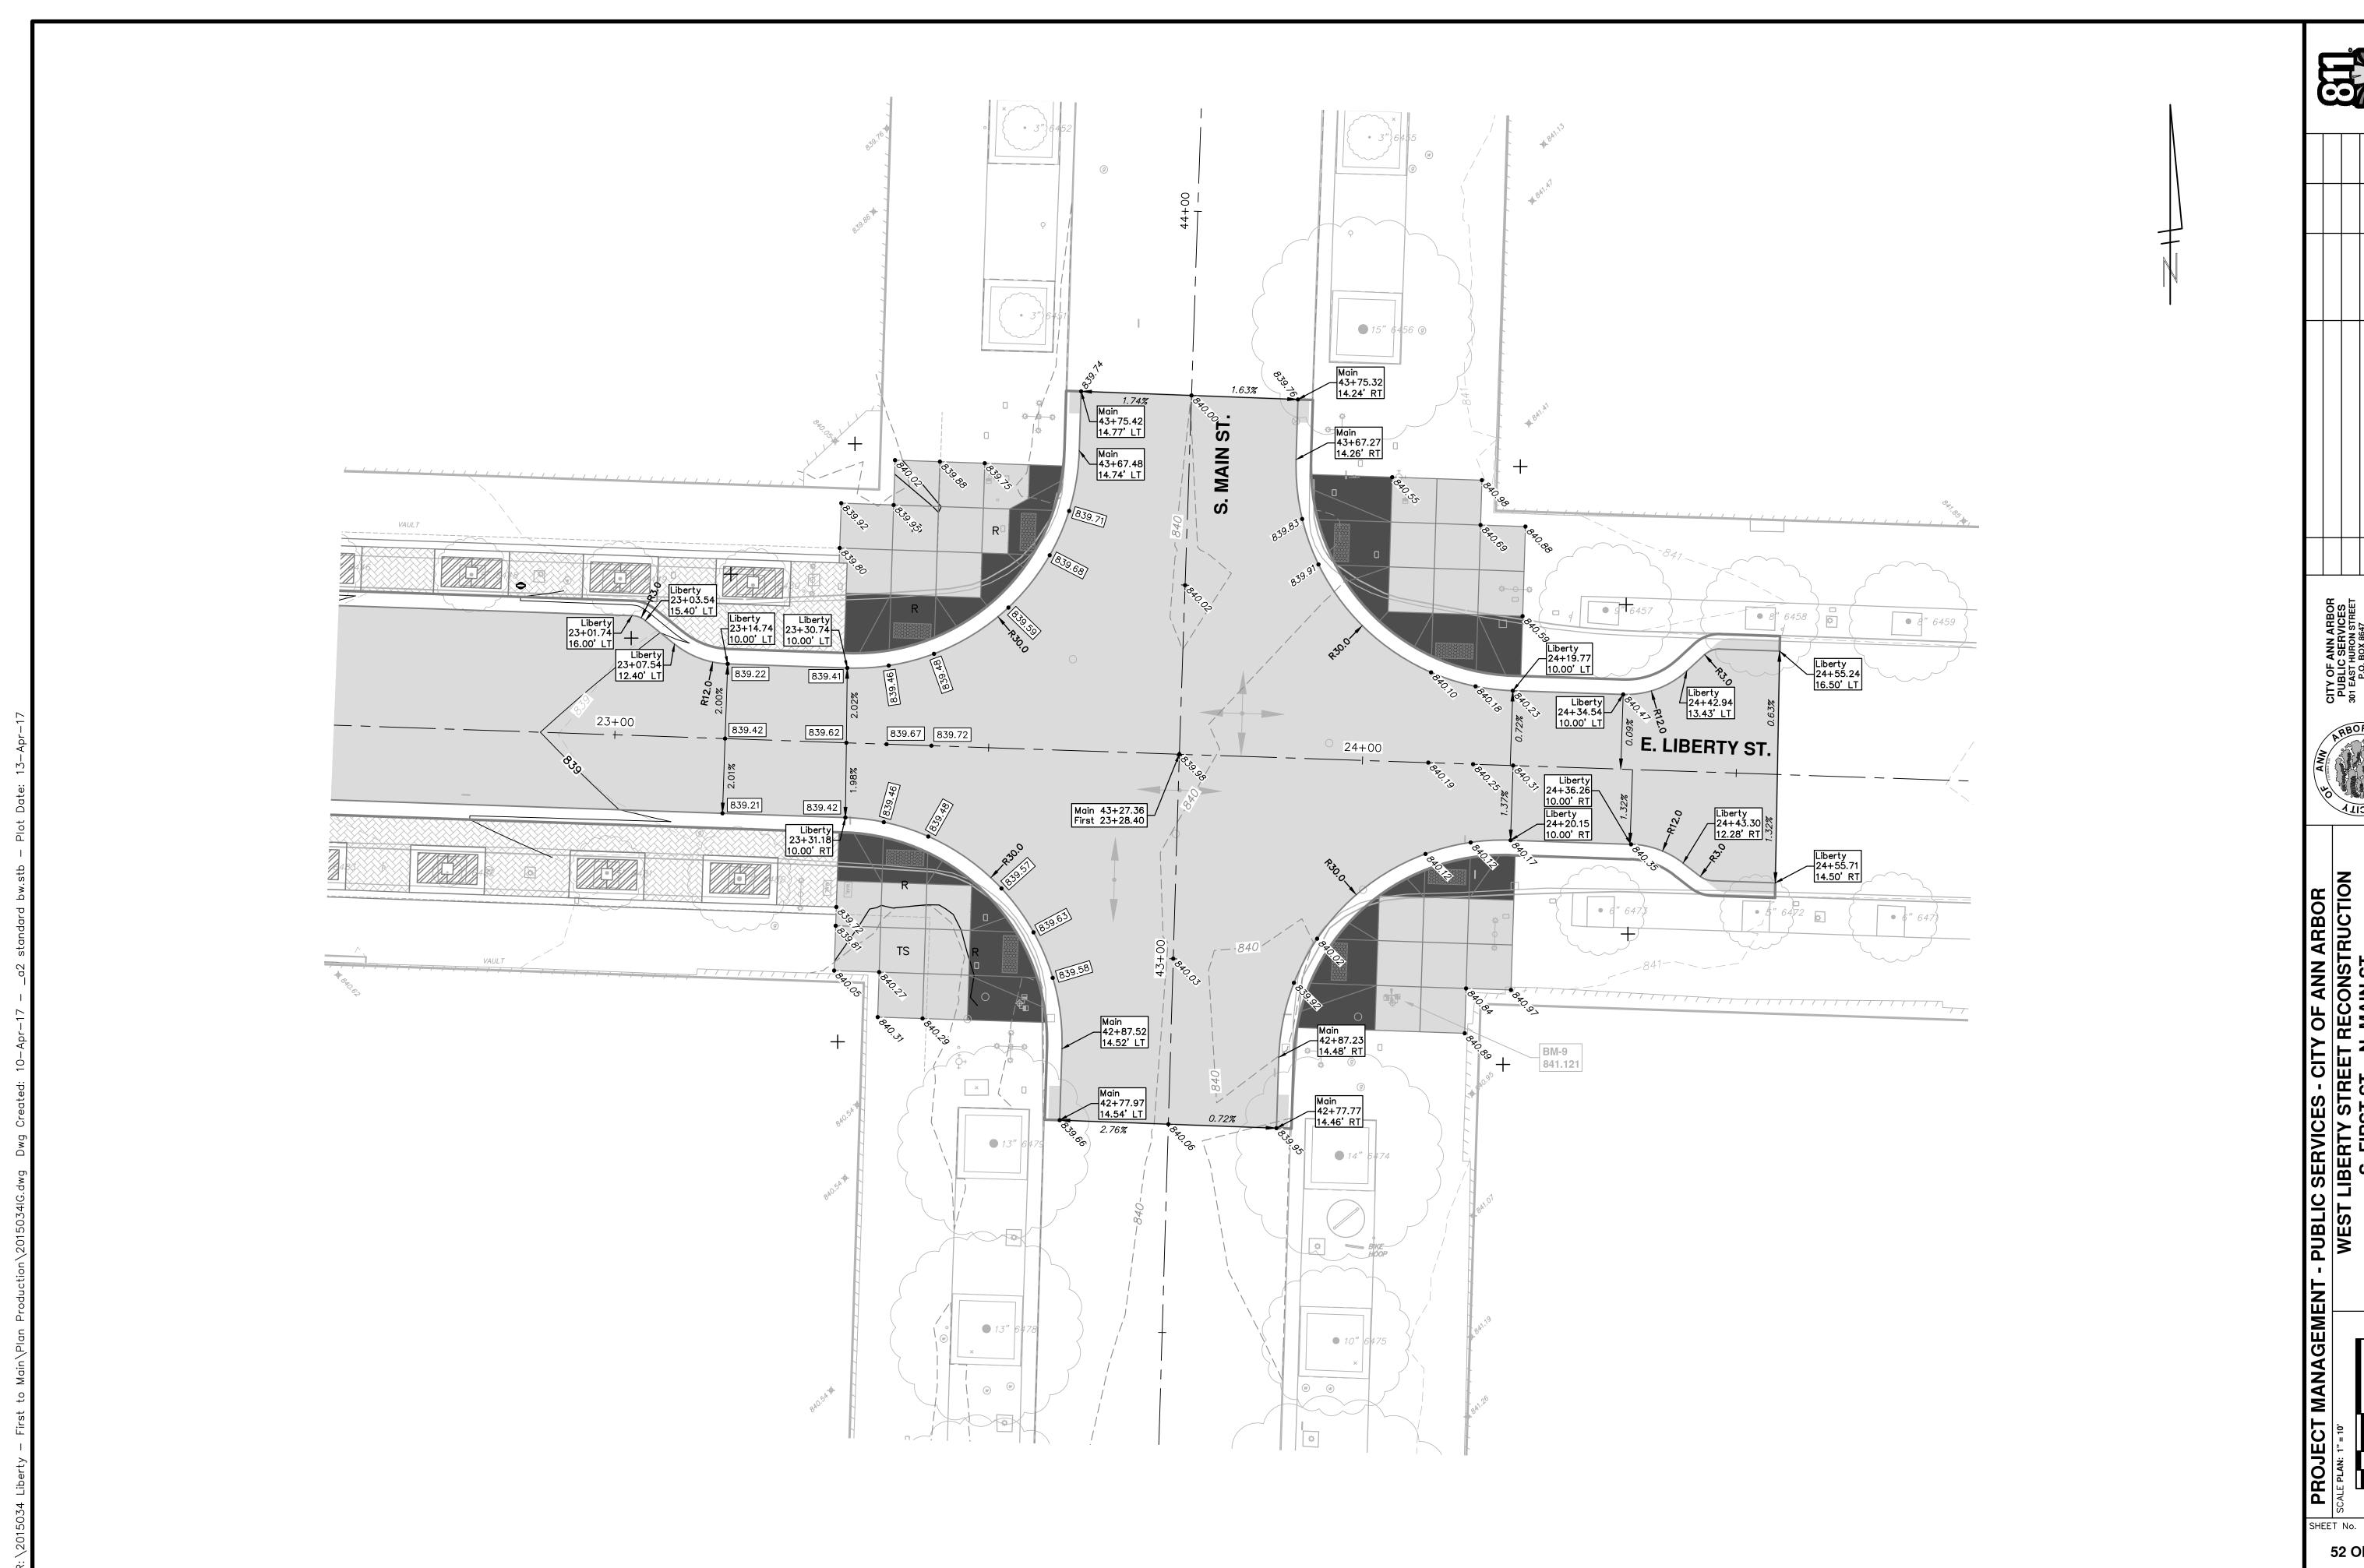

PROJECT MANAGEMENT - PUBLIC SERVICES - CITY OF ANN ARBOR

SCALE PLAN: 1" = 10*

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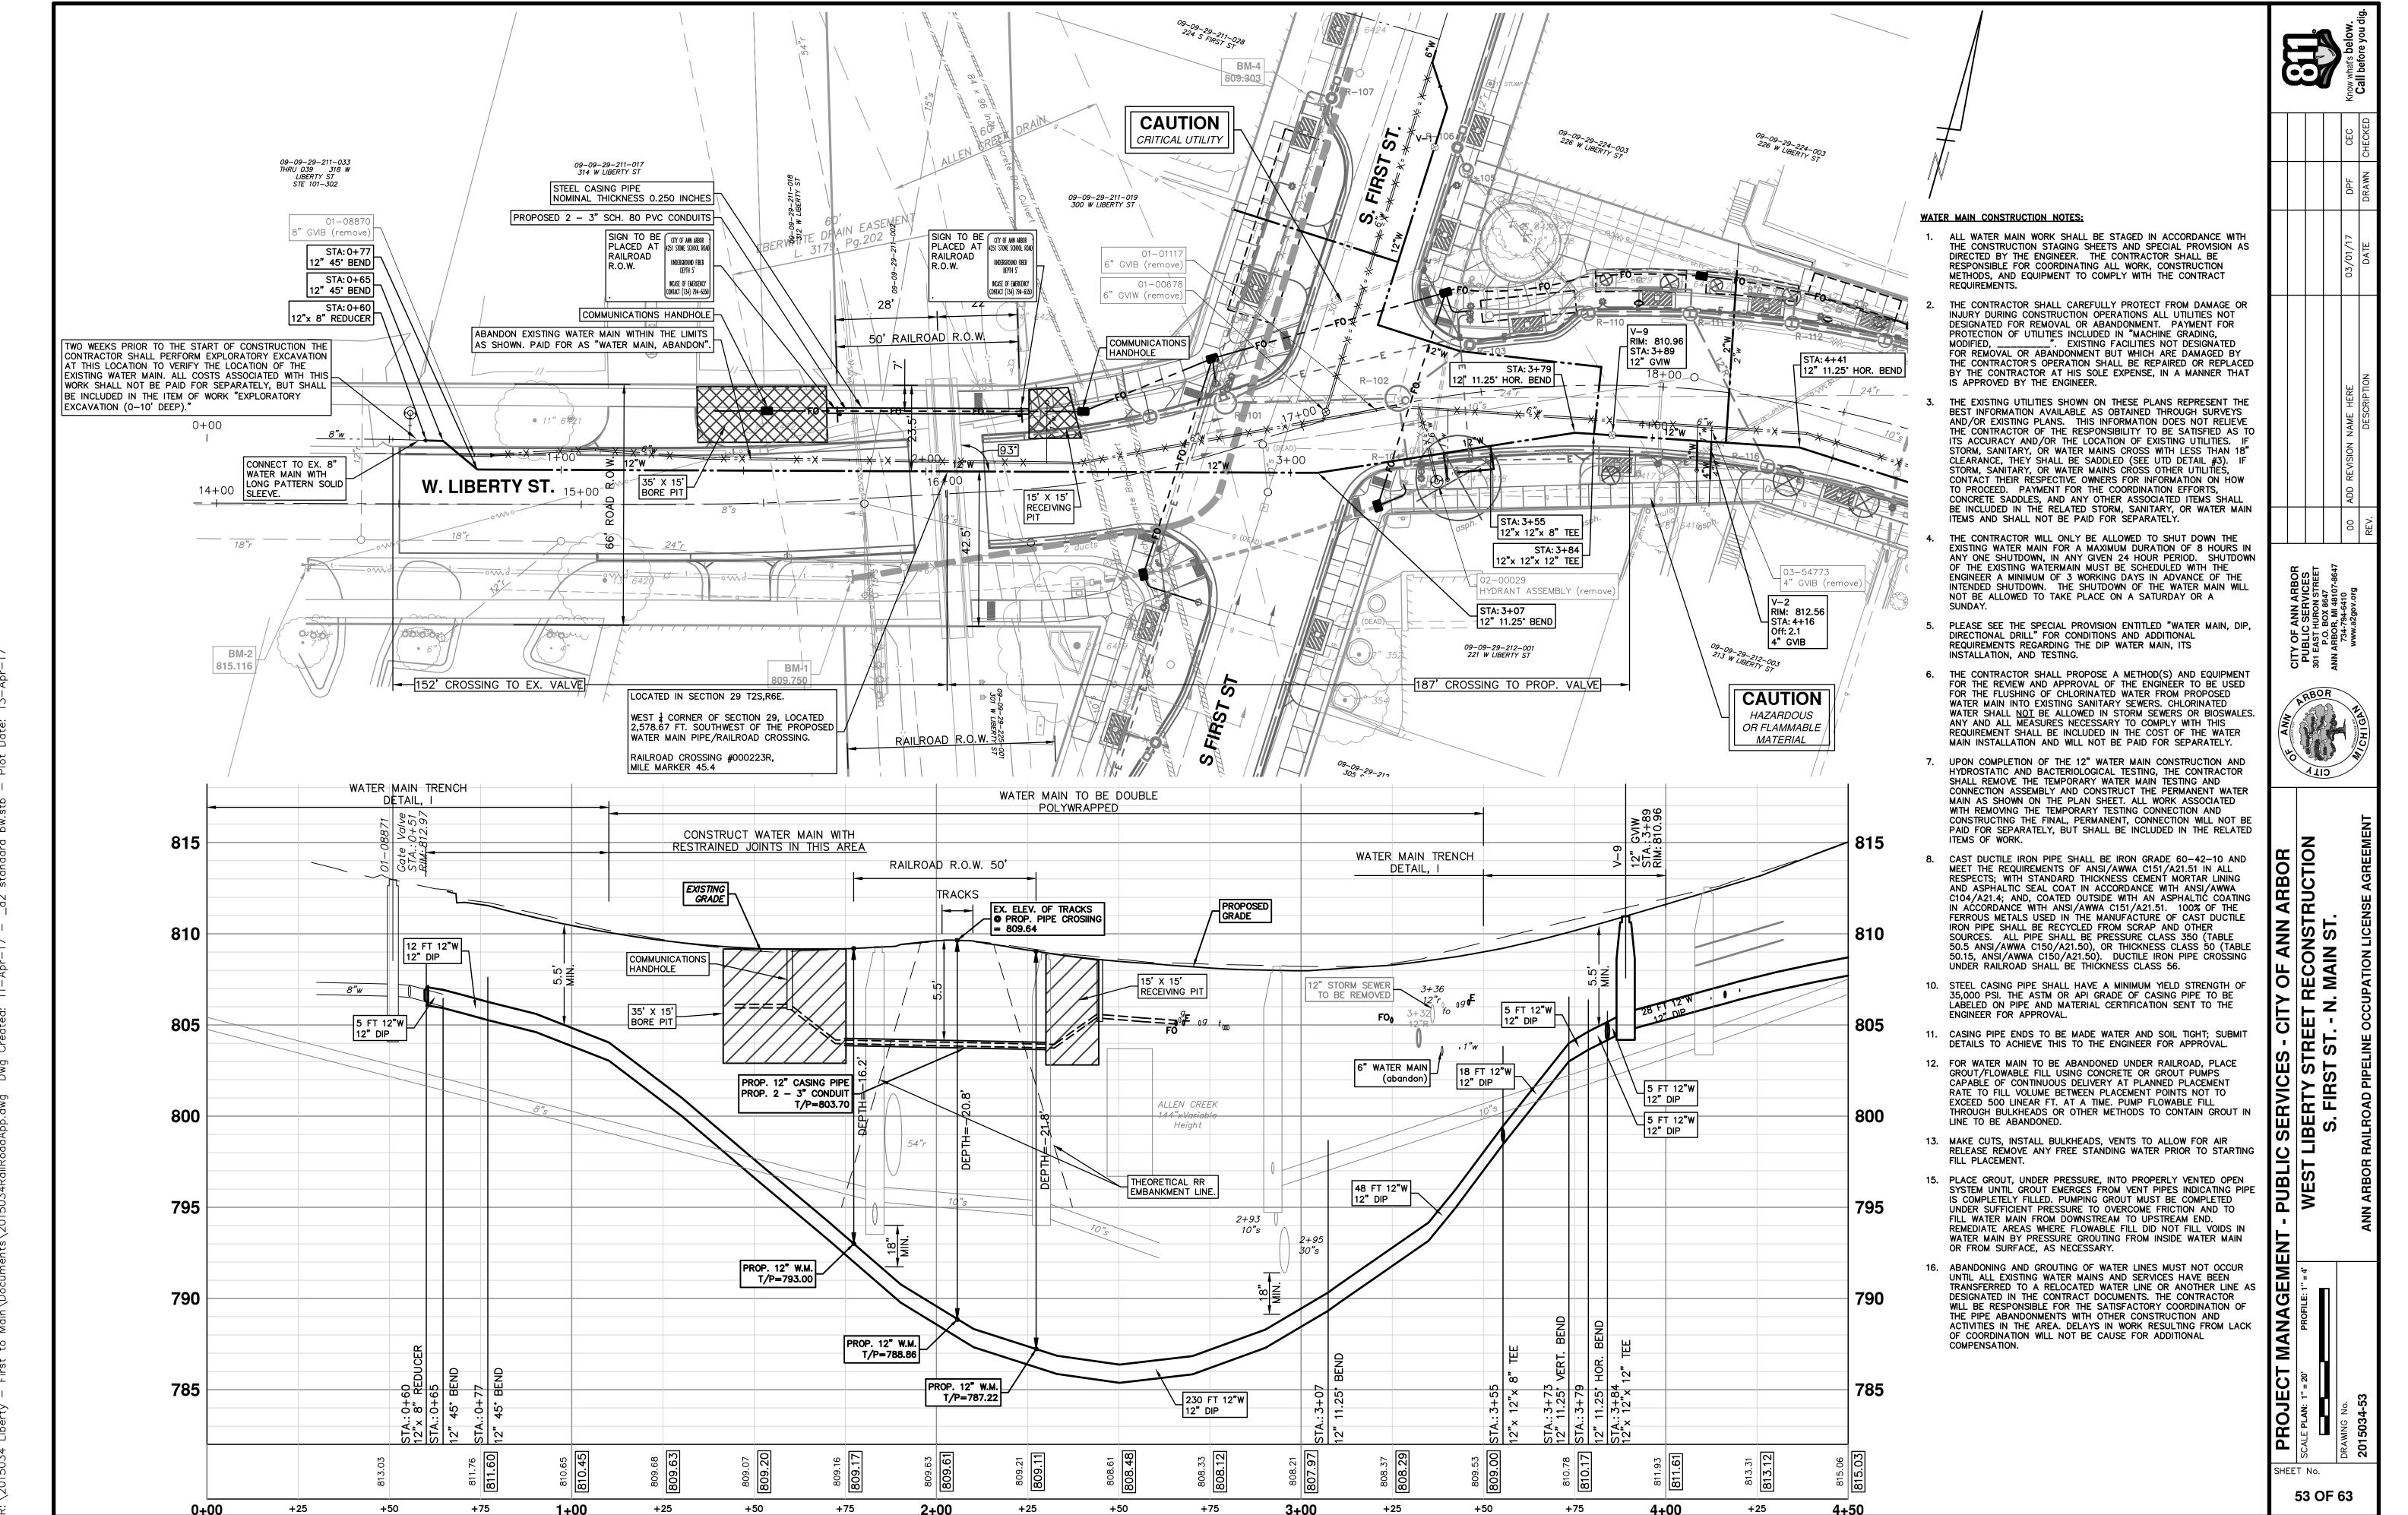
PROJECT MANAGEMENT - PUBLIC SERVICES - CITY OF ANN ARBOR

WEST LIBERTY STREET RECONSTRUCTION

S. FIRST ST. - N. MAIN ST.

INTERSECTION GRADESS.

MAIN STREET



MAST ARM FOUNDATIONS				
Point #	Northing	Easting	Description	
73	284632.3619	13289937.1244	Pr Trfc Fnd Mast Arm	
74	284691.3620	13289925.3356	Pr Trfc Fnd Mast Arm	

PR	PROPOSED COMMUNICATION HANDHOLES				
Point #	Northing	Easting	Description		
1	284650.5794	13289808.9693	Communications Handhole		
2	284674.0721	13289892.4629	Communications Handhole		
3	284697.7413	13289922.5406	Communications Handhole		
4	284732.5738	13289979.1461	Communications Handhole		
5	284756.0765	13290045.4606	Communications Handhole		
17	284671.1898	13289977.1881	Communications Handhole		
18	284635.5705	13289920.5272	Communications Handhole		

PROPOSED STREET LIGHTS				
Point #	Northing	Easting	Description	
33	284630.2541	13289928.3453	Light Pole Double	
34	284692.5441	13289928.8568	Light Pole Double	
35	284729.0408	13289987.2024	Light Pole Double	
36	284683.5069	13289986.1131	Light Pole Double	
43	284577.6308	13289925.2050	Light Pole Single	
44	284749.1395	13289930.6533	Light Pole Single	
45	284761.6777	13289974.0730	Light Pole Single	
46	284703.2822	13290047.9472	Light Pole Single	
47	284741.8534	13290021.2375	Light Pole Single	
49	284754.3170	13290079.9029	Light Pole Single	



<u>NOTES:</u>

- 1. CONTRACTOR SHALL FURNISH ALL MATERIALS, LABOR, AND EQUIPMENT AS INDICATED ON PLANS AND AS REQUIRED FOR A COMPLETE ELECTRICAL SYSTEM. REFER TO ROADWAY DRAWINGS FOR ADDITIONAL INFORMATION AND DETAILS. COORDINATE PROPOSED WORK WITH ALL CONTRACTORS.
- 2. PROVIDE A COMPLETE UNDERGROUND SYSTEM AS SHOWN ON PLANS INCLUDING ALL EXCAVATION AND BACKFILL.
- 3. ALL ELECTRICAL WORK SHALL BE PERFORMED BY A LICENCED ELECTRICIAN OR UNDER THE DIRECT SUPERVISION OF SUCH A PERSON AND IN ACCORDANCE WITH THE NATIONAL ELECTRICAL CODE.
- 4. CONTRACTOR SHALL CONTACT THE CITY OF ANN ARBOR REPRESENTATIVE PRIOR TO STARTING ELECTRICAL WORK, SIGNS AND SIGNALS. CONTACT: CHUCK FOJTIK 734-794-6361.
- 5. CONTRACTOR SHALL VISIT THE JOB SITE, THOROUGHLY CHECK THE EXISTING FIELD CONDITIONS AND EXISTING ELECTRICAL INSTALLATIONS, UTILITIES AND CLARIFY ALL DISCREPANCIES WITH THE ENGINEER BEFORE SUBMITTING A BID. NO EXTRAS WILL BE ALLOWED FOR OMITTED WORK DUE TO FAILURE TO
- 6. ALL ELECTRICAL WORK SHALL COMPLY WITH MDOT, NATIONAL ELECTRICAL CODE, LOCAL CODES, ORDINANCES AND REGULATIONS INCLUDING THE FEDERAL
- 7. THE WIRING METHODS USED SHALL BE SUITABLE FOR THE INSTALLATION AND USE IN CONFORMITY WITH THE PROVISIONS OF THE NEC. ALL MATERIAL SHALL BE NEW AND ONLY LISTED OR LABELED EQUIPMENT SHALL BE USED OR INSTALLED IN ACCORDANCE WITH ANY INSTRUCTIONS INCLUDED IN THE LISTING OR LABELING. (NEC, SECTION 110-3(A) AND 3(B))
- 8. ELECTRICAL ENCLOSURES, SUPPORT RACKS, CONDUIT SYSTEMS, ETC., SHALL BE THOROUGHLY GROUNDED IN ACCORDANCE WITH THE NATIONAL ELECTRICAL CODE. AND ALL LOCAL CODES.
- 9. ALL THREADED ELECTRICAL EQUIPMENT (CONDUIT, COUPLINGS, JUNCTION BOXES, ETC.) INSTALLED OUTDOORS SHALL BE COATED WITH ANTI-SEIZE COMPOUND PRIOR TO INSTALLATION.
- 10. ALL CONDUCTORS SHALL BE COPPER. NO CONDUCTOR SMALLER THAN #12 A.W.G. SHALL BE USED. CONDUCTORS #8 AND LARGER SHALL BE STRANDED COPPER
- 11. ALL CABLE SHALL BE INSTALLED IN CONTINUOUS UNCUT LENGTH BETWEEN HANDHOLES OR LIGHT STANDARDS. MINIMUM WIRE SIZE TO LIGHTING LOADS SHALL BE #10 AWG.

- 13. ALL FUSES SHALL BE UL LISTED AS MANUFACTURED BY BUSSMAN MANUFACTURING CO. OR APPROVED EQUAL.
- 14. DIRECT BURIAL LIGHTING CONDUITS SHALL BE INSTALLED 24" BELOW GRADE (MIN.). ALL CONDUIT JOINTS SHALL BE WATERTIGHT. MINIMUM BENDING RADIUS FOR ALL CONDUITS SHALL BE AS FOLLOWS: 4"C- 24 INCHES; 3"C 18 INCHES; 2"C 12 INCHES.
- 15. STREET LIGHTING CONDUIT SHALL BE SCHEDULE 80 PVC DIRECT BURIED UNLESS NOTED OTHERWISE. MINIMUM STREET LIGHTING CONDUIT SIZE SHALL BE
- 16. CONDUIT SHALL BE RUN IN A STRAIGHT LINE BETWEEN STRUCTURES I.E., HANDHOLE, LIGHT STANDARDS OR BUILDING. CONDUIT SHALL BE SLOPED TOWARD STRUCTURES AT ALL POINTS TO PREVENT WATER FROM ACCUMULATING IN THE CONDUIT. (NO "LOW POINTS").
- 17. COORDINATE ALL ELECTRICAL UNDERGROUND WORK WITH NEW AND EXISTING UNDERGROUND UTILITIES BEFORE INSTALLATION. LOCATION OF EXISTING UNDERGROUND AS SHOWN ON THE PLANS IS ONLY APPROXIMATE. CONTRACTOR TO VERIFY EXACT LOCATION OF EXISTING UNDERGROUND UTILITIES PRIOR TO INSTALLING PROPOSED WORK. ADJUST LOCATION OF DIRECT BURIAL CONDUITS IN THE FIELD TO AVOID CONFLICTS.
- 18. ALL DIRECT BURIAL CONDUITS INSTALLED BELOW ROADWAYS, SIDEWALKS, OR PARKING LOTS SHALL BE BACKFILLED WITH MDOT GRANULAR MATERIAL, CLASS II, AND COMPACTED TO 95% OF ITS MAXIMUM WEIGHT.
- 19. CONTRACTOR TO DISCONNECT AND REMOVE EXISTING STREET LIGHT POSTS. EXISTING CABLES/CONDUIT WILL BE ABANDONED IN PLACE. WHERE THE ABANDONED CABLE/CONDUITS CONFLICTS WITH PROPOSED WORK, THE CONTRACTOR SHALL CUT, CAP, REMOVE, AND ABANDON THE CABLE/CONDUIT AS DIRECTED BY THE ENGINEER
- 20. HAND DIG WHERE REQUIRED TO LOCATE EXISTING UTILITIES PRIOR TO INSTALLATION OF THE NEW DIRECT BURIAL ROADWAY LIGHTING CONDUITS.
- 21. IN AREAS WITH EXISTING TREES, CONTRACTOR SHALL CAREFULLY EXCAVATE THE CONDUIT RUNS SO AS NOT TO DAMAGE MAIN ROOTS OF TREES. DO NOT CUT OR REMOVE MAIN ROOTS OF TREES. ROUTE CONDUIT AROUND ROOTS AS MAY BE REQUIRED BY FIELD CONDITIONS.
- 22. ALL EMPTY CONDUITS AND/OR EMPTY DUCTS IN DUCT BANKS SHALL BE PROVIDED WITH A POLYPROPYLENE FISH LINE.
- 23. ALL LIGHTING POLES SHALL BE STORED WITH WOOD BLOCKING SEPARATION AND CARE SHALL BE TAKEN NOT TO DAMAGE FACTORY FINISH OF POLES AND LUMINAIRES. ALL DAMAGE SHALL BE TOUCHED UP WITH FACTORY APPROVED TOUCH—UP PAINT. ALL REPAIRS SHALL BE APPROVED BY THE

- 24. CARE SHALL BE EXERCISED DURING POLE BASE INSTALLATION AND POLE PLACEMENT SO THAT ANCHOR BOLTS ARE CORRECTLY ALIGNED, POLES ARE PLUMB, LUMINAIRES ARE HORIZONTAL AND ORIENTATED AS SHOWN ON THE PLANS. REFER TO POLE FOUNDATION DETAIL FOR INSTALLATIONS
- 25. FINAL LOCATIONS OF LIGHT STANDARDS, CONDUIT, HANDHOLES AND LIGHTING CONTROL ENCLOSURES SHALL BE FIELD ADJUSTED AS DIRECTED BY THE ENGINEER TO AVOID CONFLICTS THAT MAY BE ENCOUNTERED.
- 26. COMPLETE UNDERGROUND SYSTEM SHALL BE INSPECTED AND CERTIFIED PRIOR TO BACKFILLING BY THE LOCAL BUILDING DEPARTMENT ELECTRICAL INSPECTOR
- 27. PROVIDE LIGHTING SYSTEM GROUNDING MEETING THE REQUIREMENTS IN ARTICALE 250 OF THE NATIONAL ELECTRICAL CODE (NEC).
- 28. CONTRACTOR TO INSTALL A 120V, 20A GFCI RECEPTACLE WITH WATERPROOF COVER ON EACH LIGHT POLE. EACH RECEPTACLE SHALL BE CONNECTED TO A UNIQUE CIRCUIT LEG.

E HERE 03/01/17 DPF CEC

CITY OF ANN ARBOR PUBLIC SERVICES 301 EAST HURON STREET P.O. BOX 8647 ANN ARBOR, MI 48107-8647 734-794-6410 www.a2gov.org



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CES - CITY OF ANN ARBOR

/ STREET RECONSTRUCTIO

/ST ST. - N. MAIN ST.

/A. 14+50 TO STA. 18+50

- PUBLIC SERVICES - CITY
WEST LIBERTY STREET F
S. FIRST ST. - N.
TRAFFIC SIGNAL AND ST
STA. 14+50 TO ST.

ALE PLAN: 1" = 20"

AWING No.


EET No.

PRO	POSED ELE	CTRICAL HAN	DHOLE
Point #	Northing	Easting	Description
101	284738.0752	13290459.9327	Pr Elec HH
102	284739.1109	13290429.9505	Pr Elec HH
103	284748.6903	13290313.7014	Pr Elec HH
104	284704.6504	13290312.3562	Pr Elec HH
105	284706.4772	13290242.9759	Pr Elec HH
106	284754.6298	13290131.7480	Pr Elec HH
107	284754.5939	13290101.7482	Pr Elec HH
113	284699.6612	13290456.7786	Pr Elec HH
114	284700.6106	13290429.2950	Pr Elec HH
115	284750.8432	13290247.7155	Pr Elec HH


MAST ARM FOUNDATIONS				
Point #	Northing	Easting	Description	
70	284701.9922	13290302.0309	PR Trfc Fnd Mast Arr	
71	284746.7907	13290301.2566	Pr Trfc Fnd Mast Arn	
72	284747.4368	13290244.8825	Pr Trfc Fnd Mast Arn	

7 284757.7939 13290126.7678 Communications Handhole 9 284752.0334 13290306.8009 Communications Handhole 10 284741.5404 13290432.0357 Communications Handhole 11 284740.7118 13290456.0213 Communications Handhole 15 284703.3547 13290304.4786 Communications Handhole 16 284704.9540 13290243.8071 Communications Handhole					
6 284758.5113 13290104.7795 Communications Handhole 7 284757.7939 13290126.7678 Communications Handhole 9 284752.0334 13290306.8009 Communications Handhole 10 284741.5404 13290432.0357 Communications Handhole 11 284740.7118 13290456.0213 Communications Handhole 15 284703.3547 13290304.4786 Communications Handhole 16 284704.9540 13290243.8071 Communications Handhole	PROPOSED COMMUNICATION HANDHOLES				
7 284757.7939 13290126.7678 Communications Handhole 9 284752.0334 13290306.8009 Communications Handhole 10 284741.5404 13290432.0357 Communications Handhole 11 284740.7118 13290456.0213 Communications Handhole 15 284703.3547 13290304.4786 Communications Handhole 16 284704.9540 13290243.8071 Communications Handhole	Point #	Northing	Easting	Description	
9 284752.0334 13290306.8009 Communications Handhole 10 284741.5404 13290432.0357 Communications Handhole 11 284740.7118 13290456.0213 Communications Handhole 15 284703.3547 13290304.4786 Communications Handhole 16 284704.9540 13290243.8071 Communications Handhole	6	284758.5113	13290104.7795	Communications Handhole	
10 284741.5404 13290432.0357 Communications Handhole 11 284740.7118 13290456.0213 Communications Handhole 15 284703.3547 13290304.4786 Communications Handhole 16 284704.9540 13290243.8071 Communications Handhole	7	284757.7939	13290126.7678	Communications Handhole	
11 284740.7118 13290456.0213 Communications Handhole 15 284703.3547 13290304.4786 Communications Handhole 16 284704.9540 13290243.8071 Communications Handhole	9	284752.0334	13290306.8009	Communications Handhole	
15 284703.3547 13290304.4786 Communications Handhole 16 284704.9540 13290243.8071 Communications Handhole	10	284741.5404	13290432.0357	Communications Handhole	
16 284704.9540 13290243.8071 Communications Handhole	11	284740.7118	13290456.0213	Communications Handhole	
	15	284703.3547	13290304.4786	Communications Handhole	
21 284741.8813 13290320.7920 Communications Handhole	16	284704.9540	13290243.8071	Communications Handhole	
	21	284741.8813	13290320.7920	Communications Handhole	

PROPOSED STREET LIGHTS					
Point #	Northing	Easting	Description		
31	284705.0299	13290241.3347	Light Pole Double		
37	284744.4594	13290318.5745	Light Pole Double		
38	284752.5079	13290242.7849	Light Pole Double		
39	284702.9784	13290317.3075	Light Pole Double		
41	284696.6335	13290472.0109	Light Pole Single		
42	284698.0145	13290432.0347	Light Pole Single		
48	284709.1890	13290113.0740	Light Pole Single		
50	284707.3774	13290169.3859	Light Pole Single		
51	284756.2579	13290127.8458	Light Pole Single		
52	284754.3014	13290187.8140	Light Pole Single		
53	284699.9122	13290377.1009	Light Pole Single		
54	284742.3869	13290378.5682	Light Pole Single		
55	284740.4892	13290433.5020	Light Pole Single		
56	284739.0664	13290474.6864	Light Pole Single		

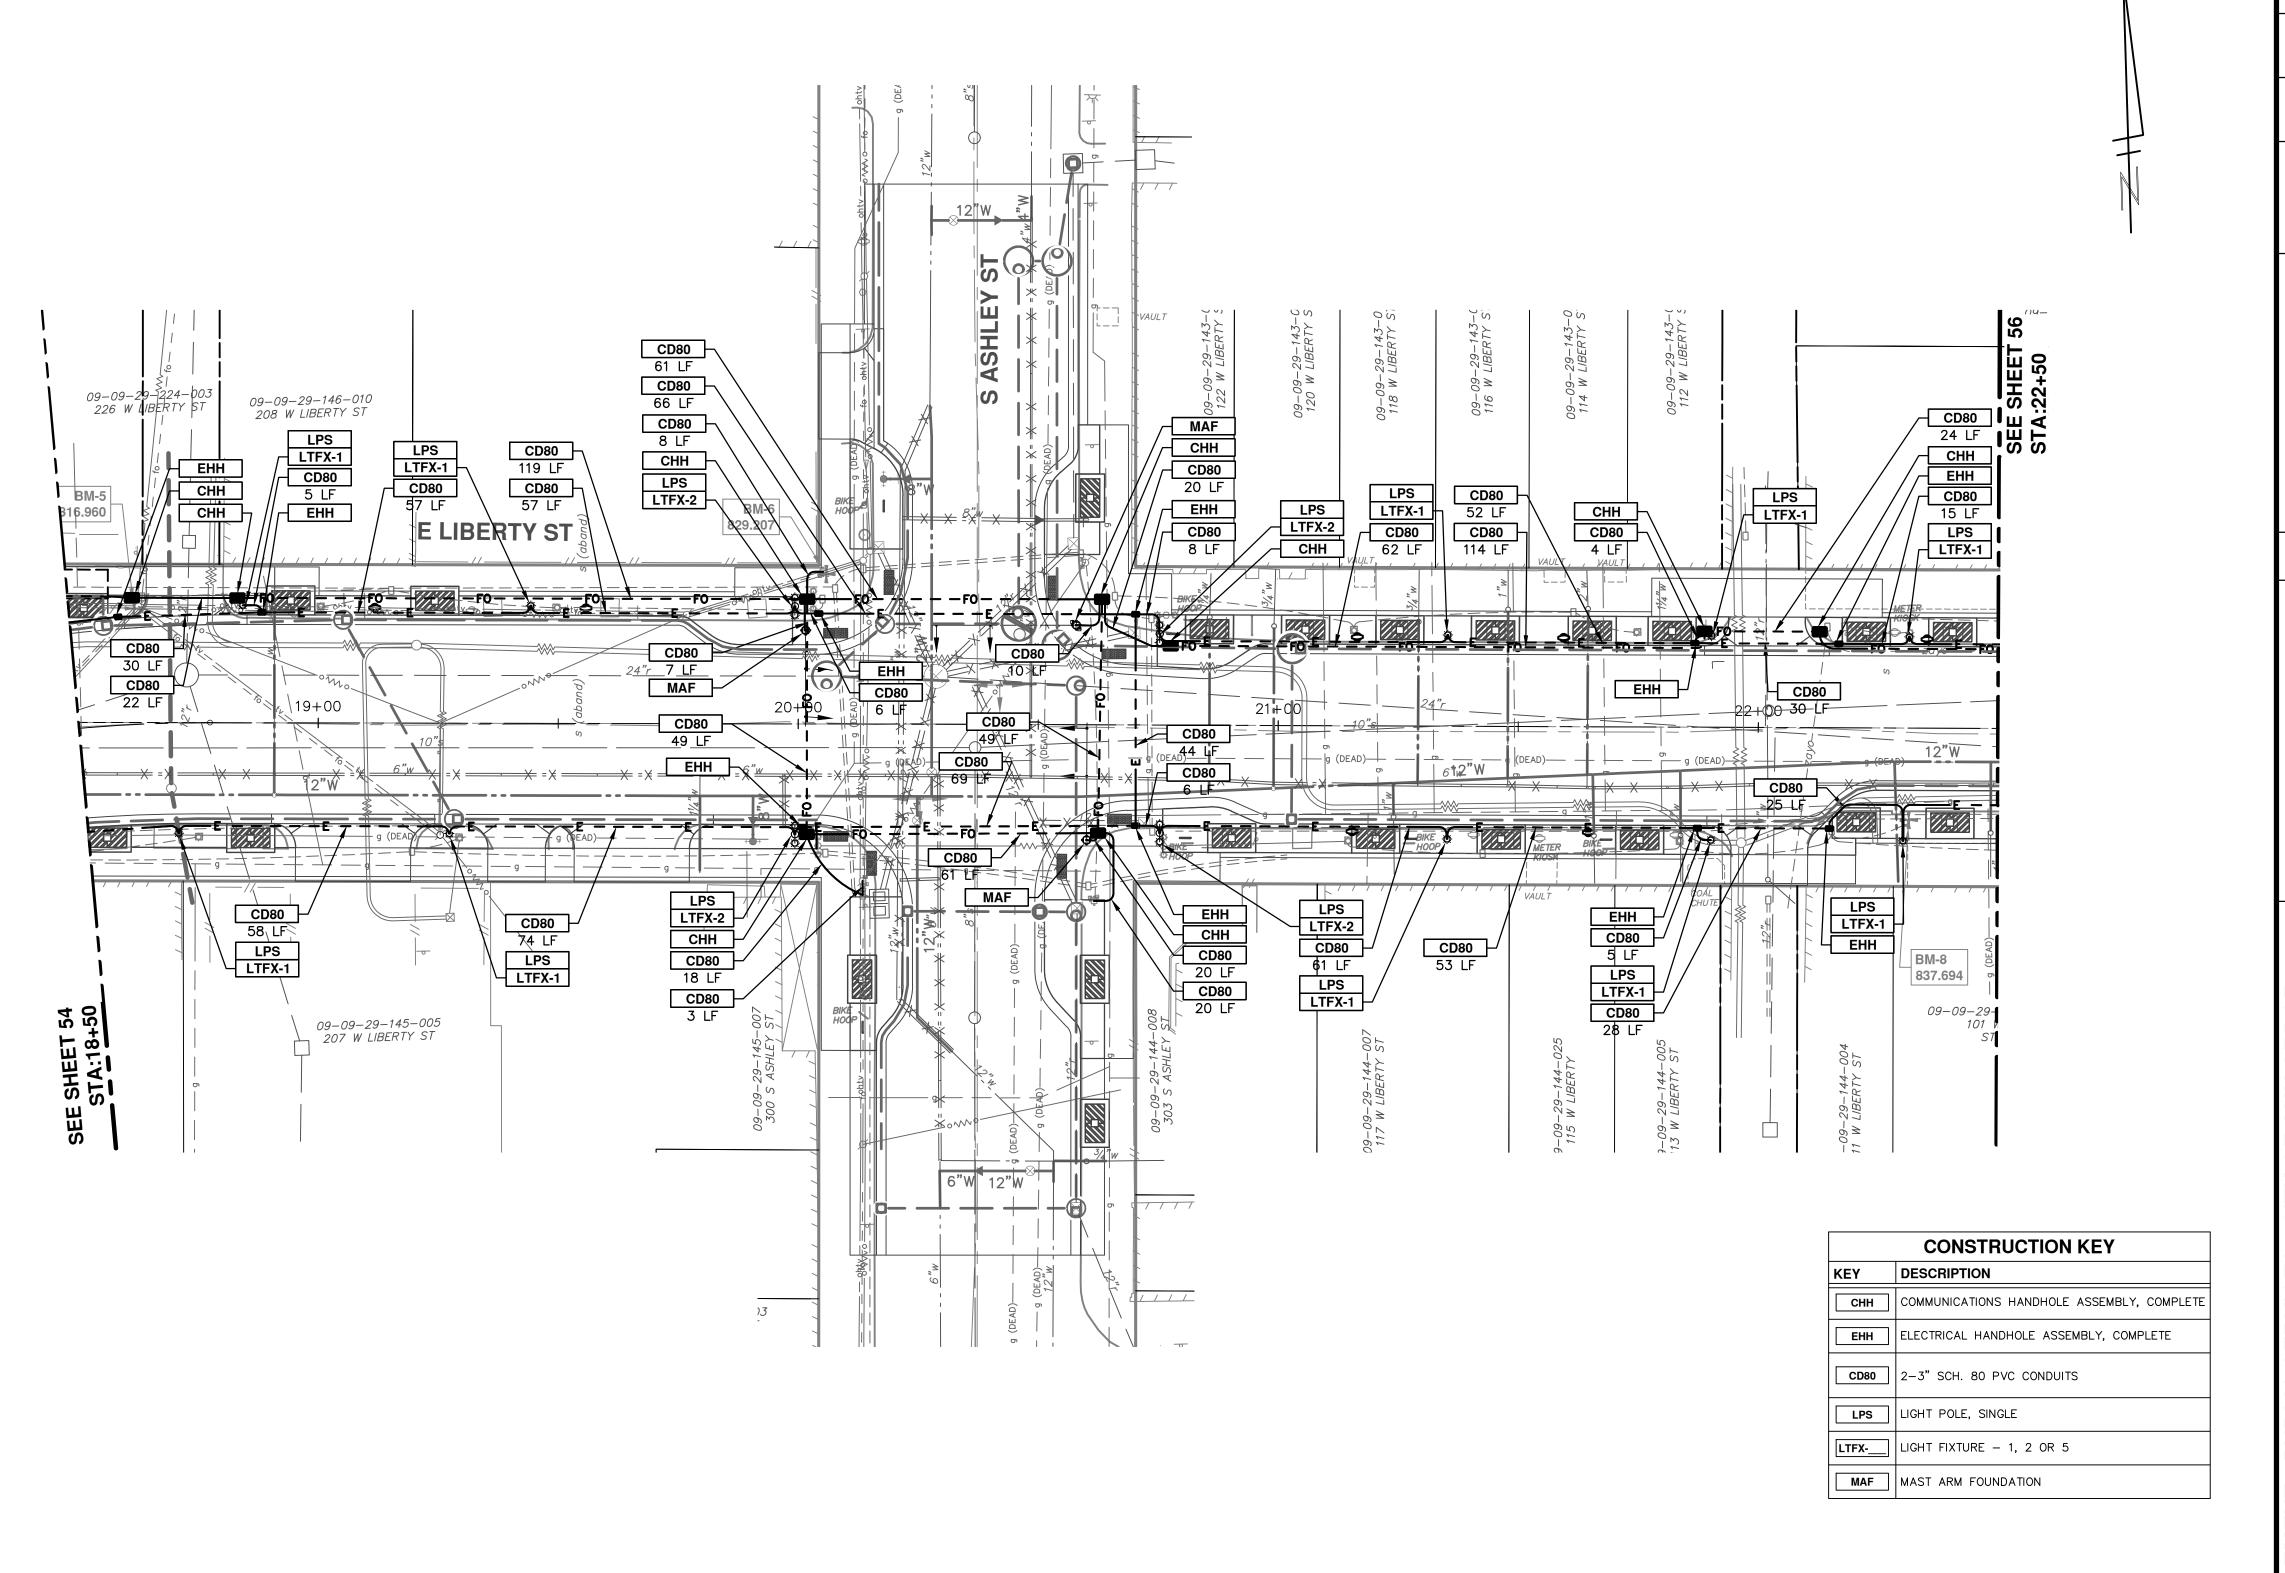



F - PUBLIC SERVICES - CITY OF ANN ARBOR
WEST LIBERTY STREET RECONSTRUCTIO
S. FIRST ST. - N. MAIN ST.
TRAFFIC SIGNAL AND STREET
LIGHTINGSTA. 18+50 TO STA. 22+50 PROJECT MANAGEMENT -

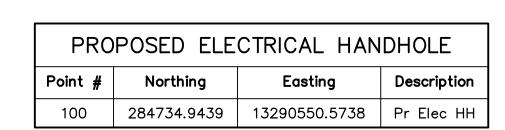



PROPOSED COMMUNICATION HANDHOLES					
Point #	Northing	Easting	Description		
12	284732.6210	13290588.8157	Communications Handhole		
13	284738.5542	13290649.5421	Communications Handhole		
19	284693.6455	13290587.4693	Communications Handhole		
20	284692.0731	13290647.9565	Communications Handhole		


PROPOSED STREET LIGHTS						
Point #	Northing	Easting	Description			
30	284693.3238	13290567.8151	Light Pole Double			
32	284735.7985	13290569.2824	Light Pole Double			
40	284695.2525	13290511.9870	Light Pole Single			
57	284737.7498	13290512.7993	Light Pole Single			

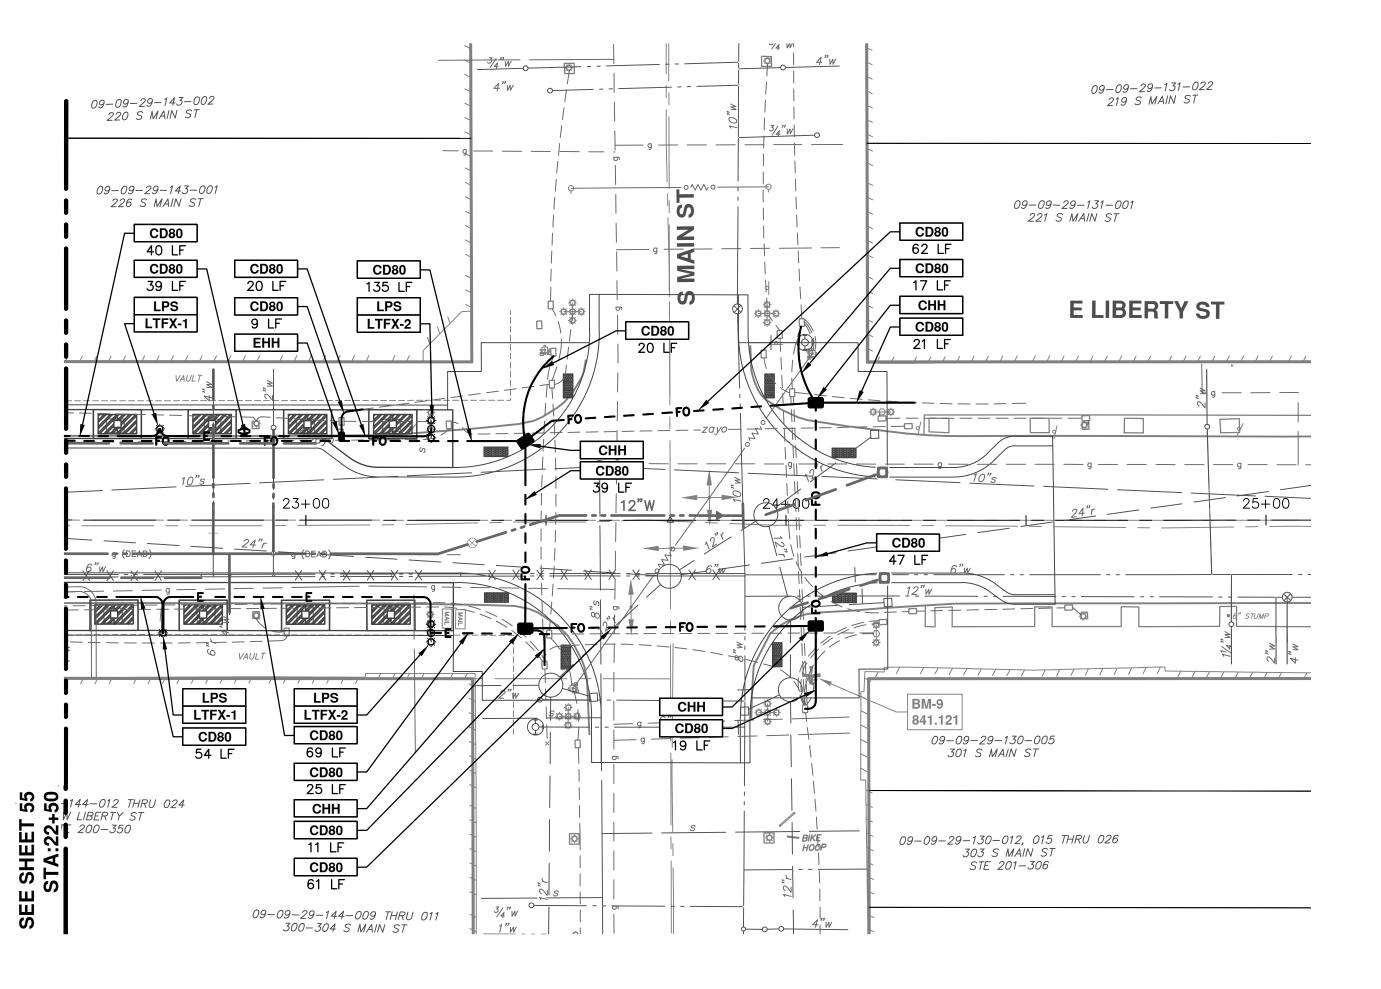


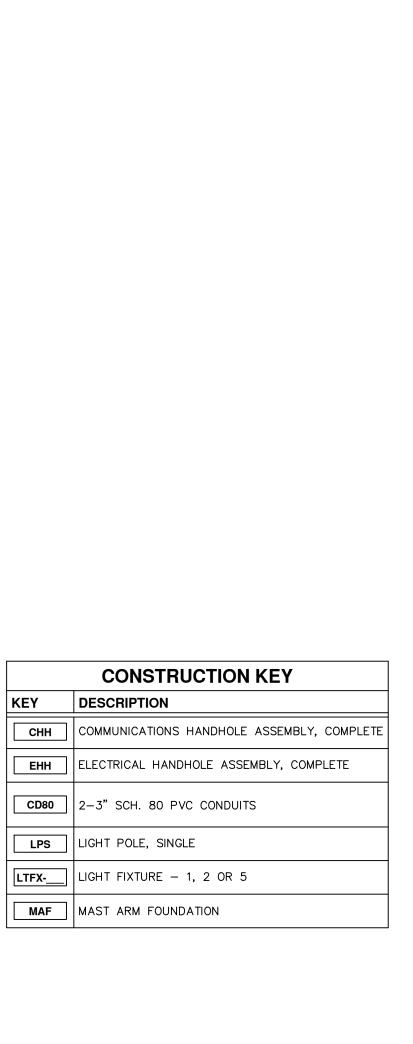


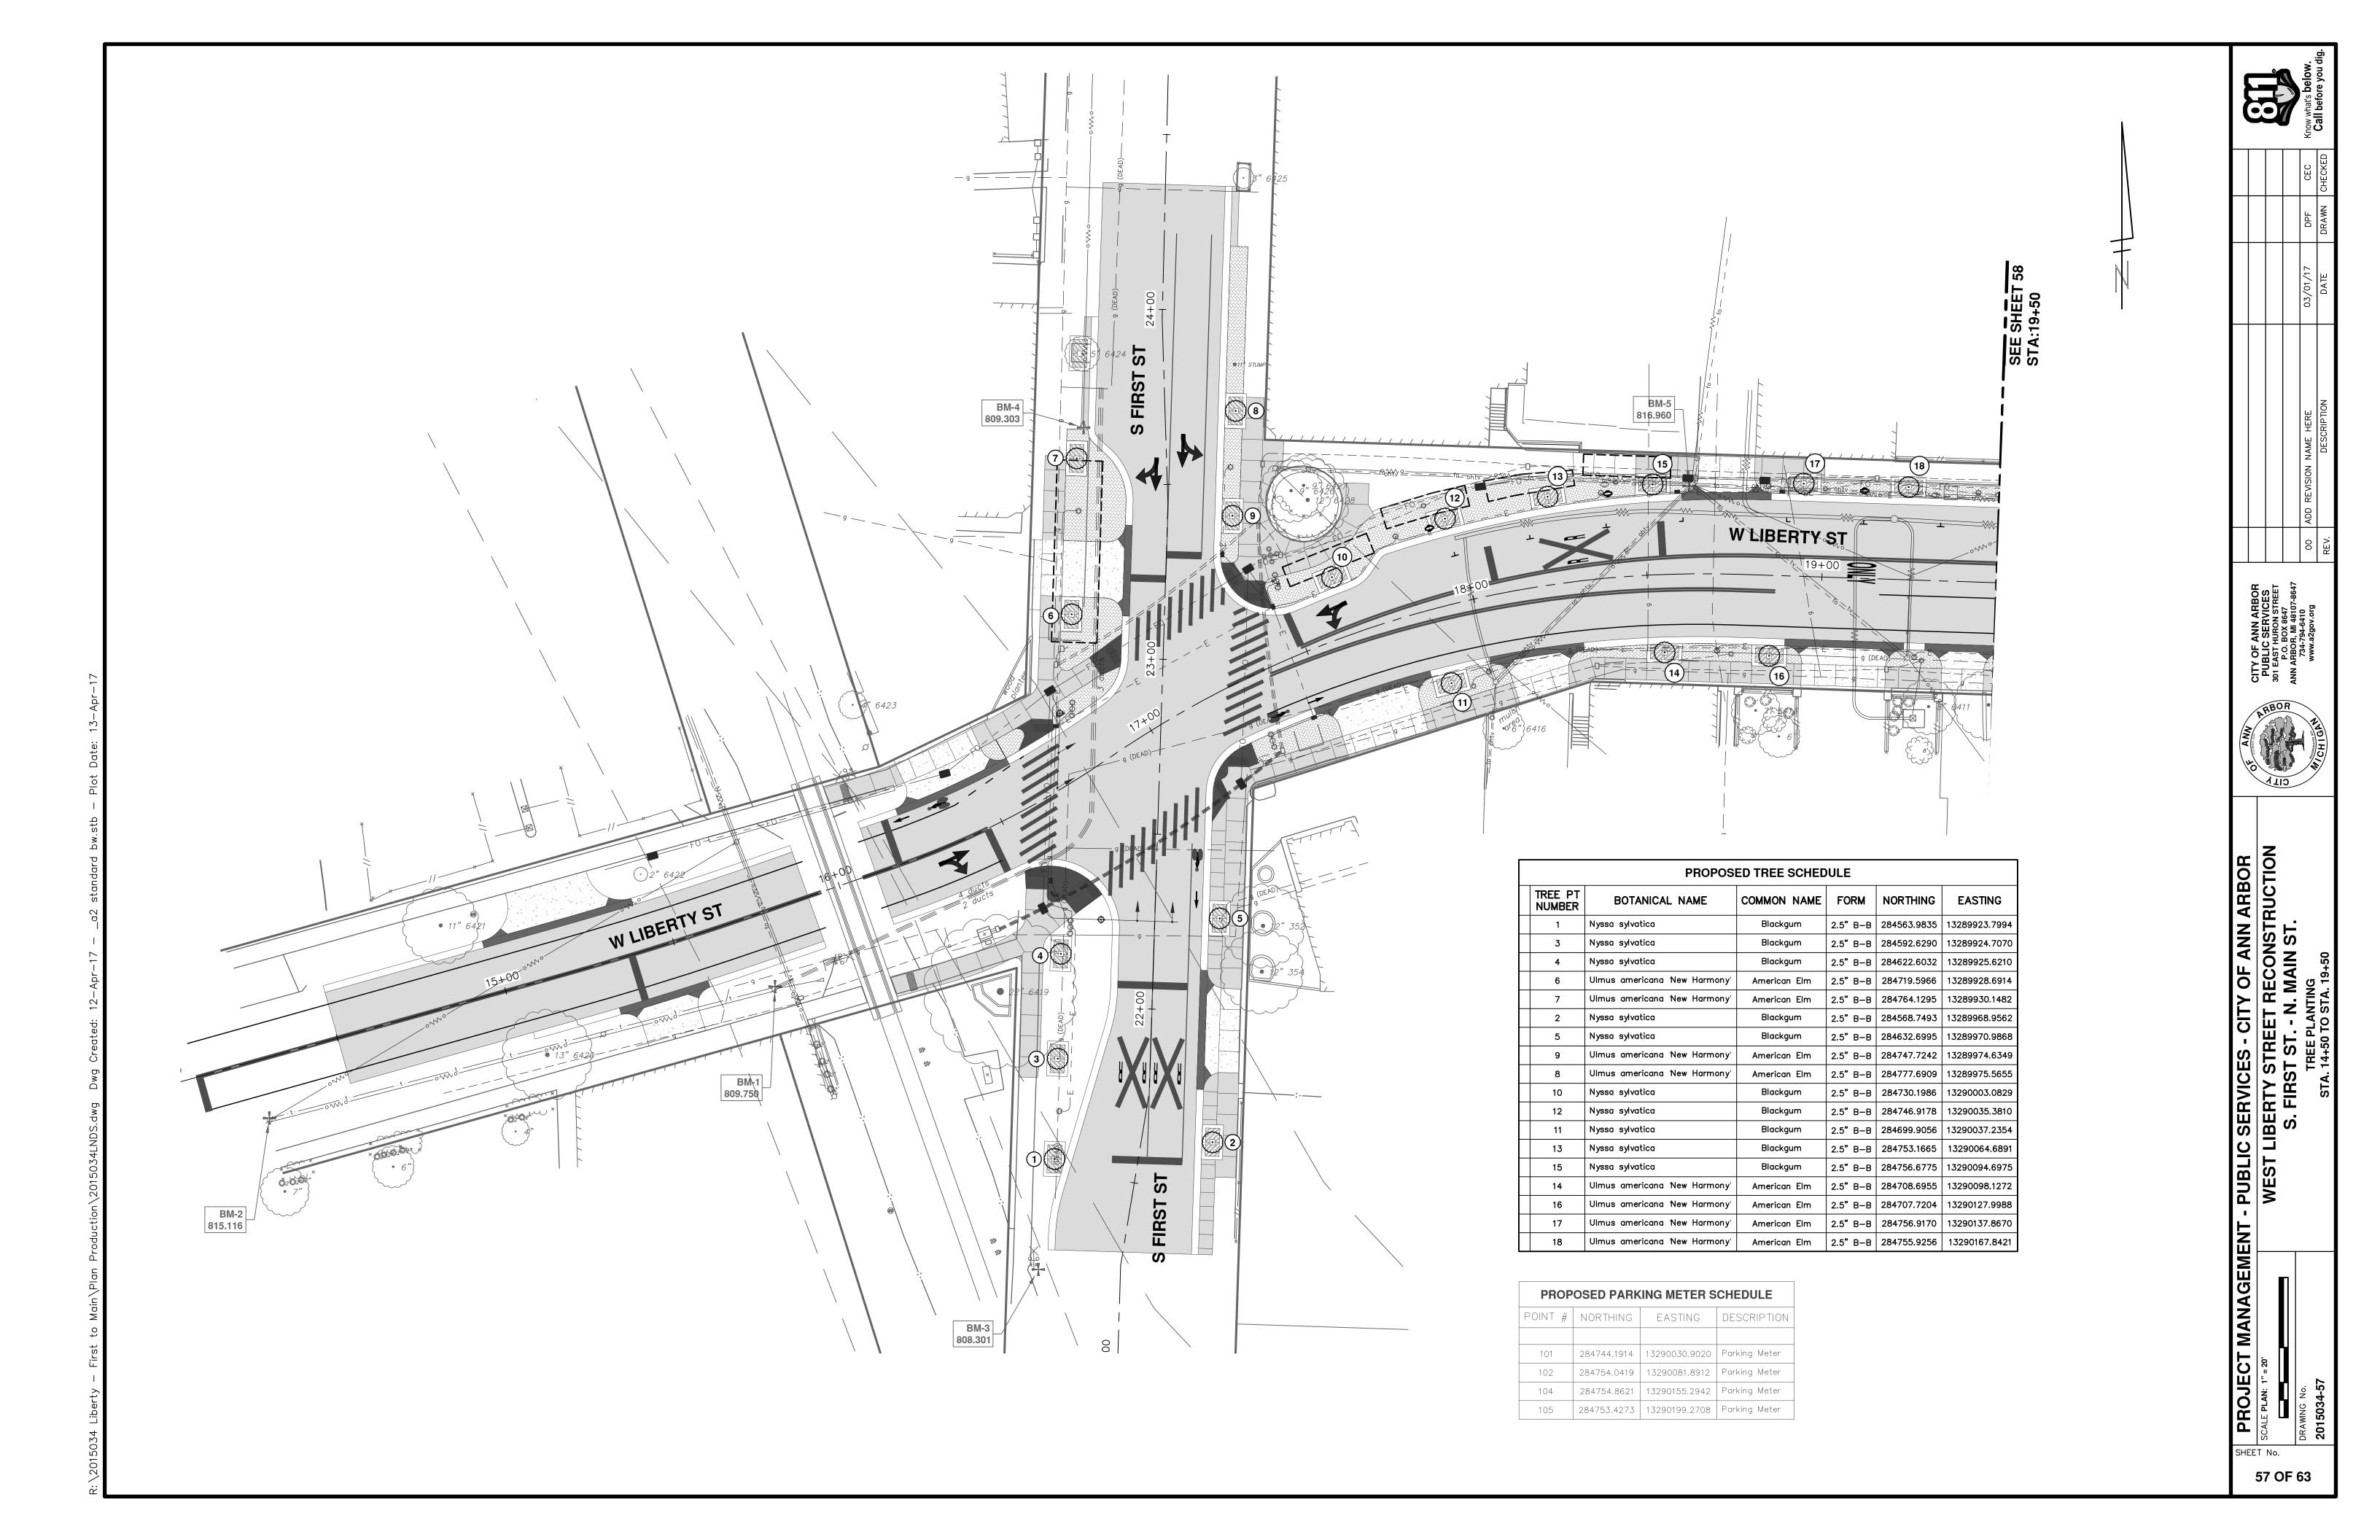


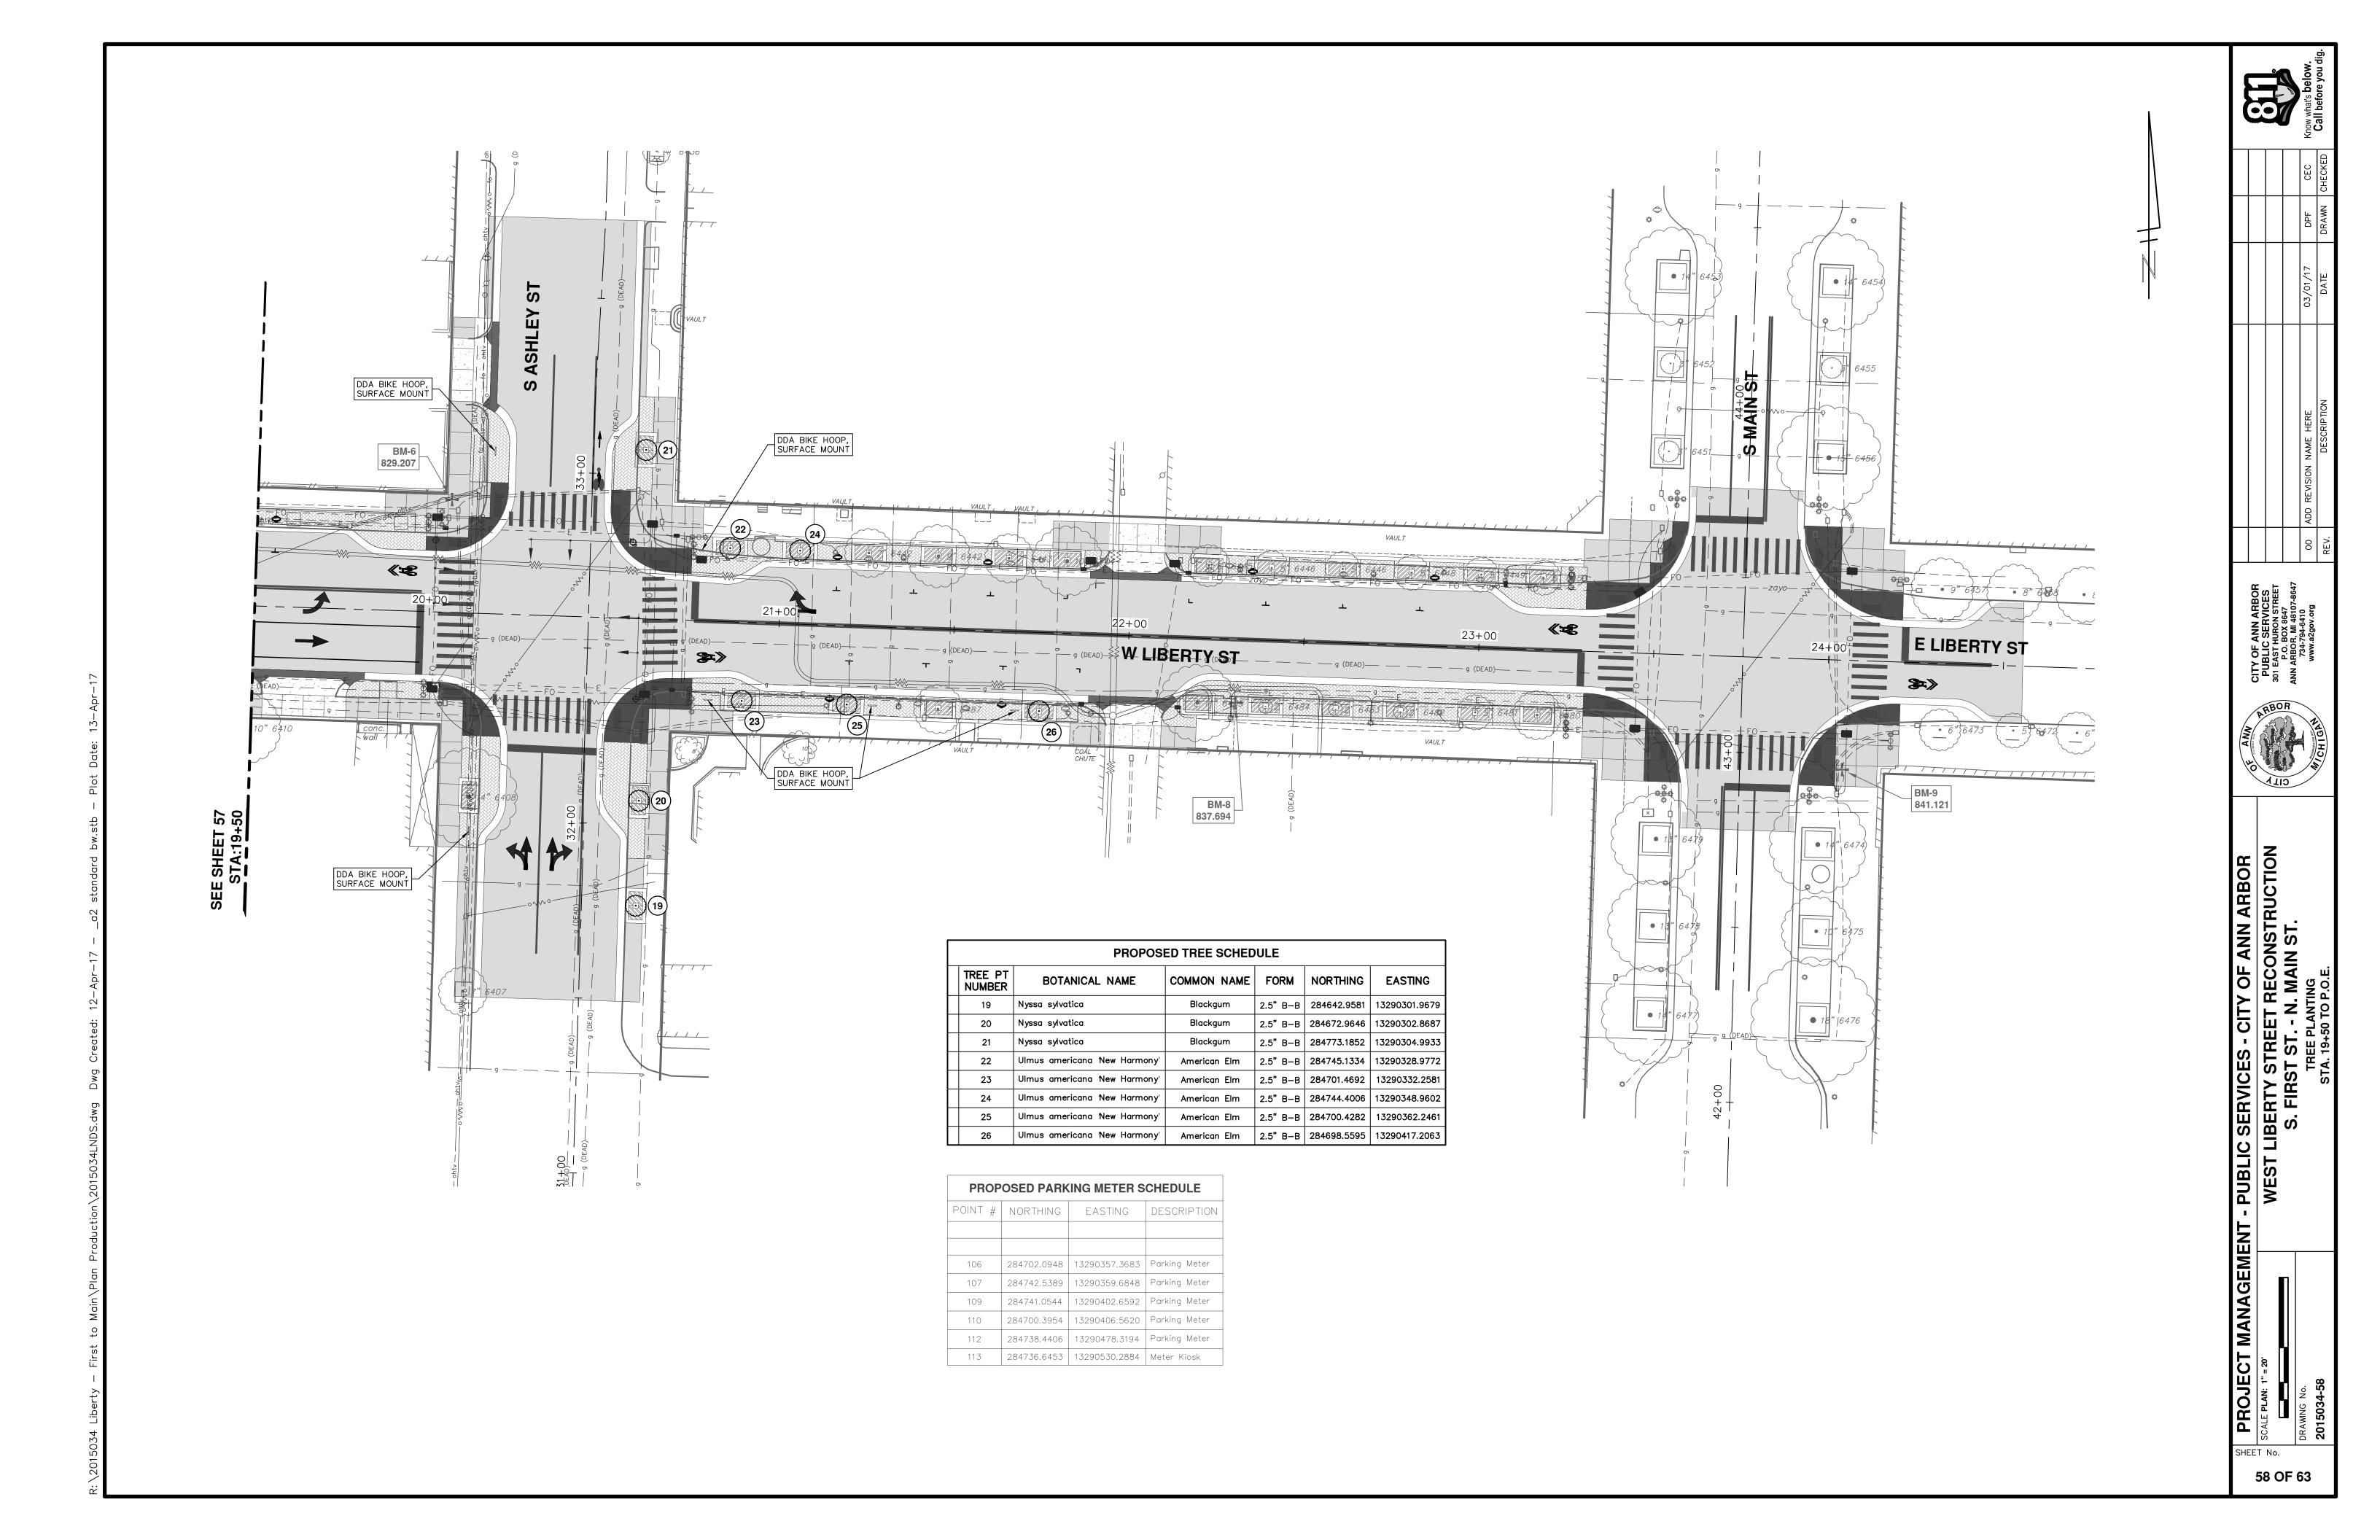

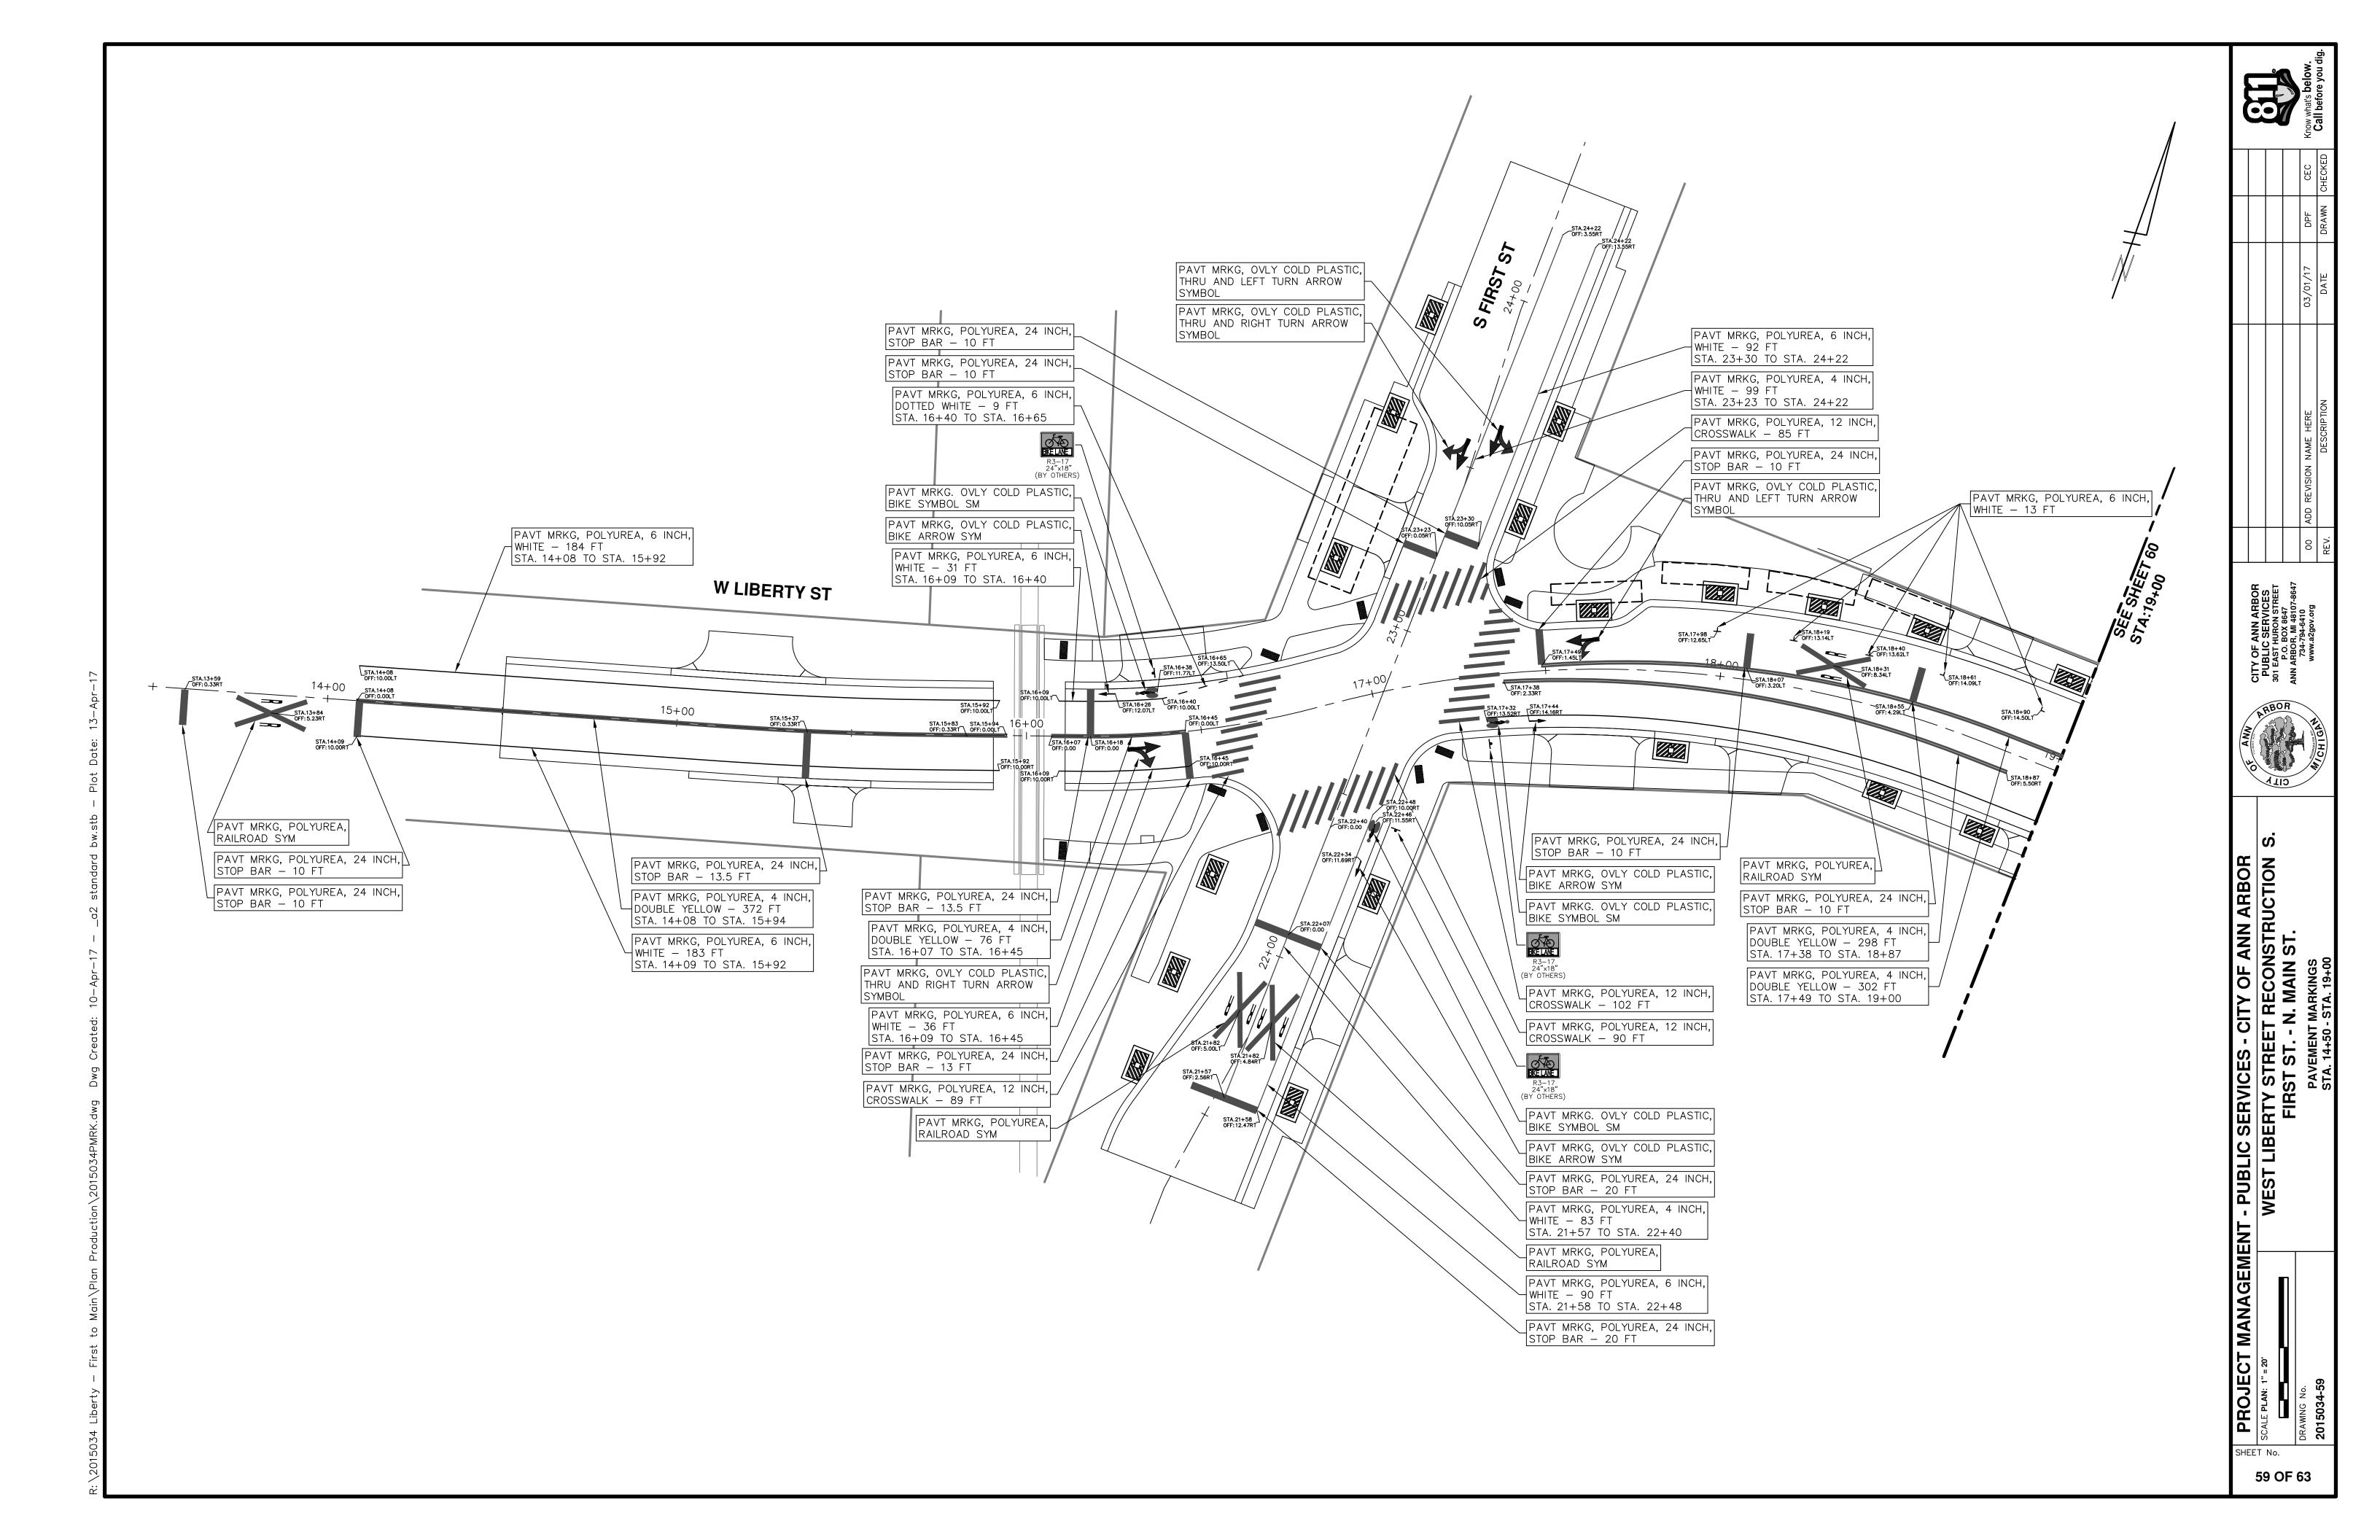

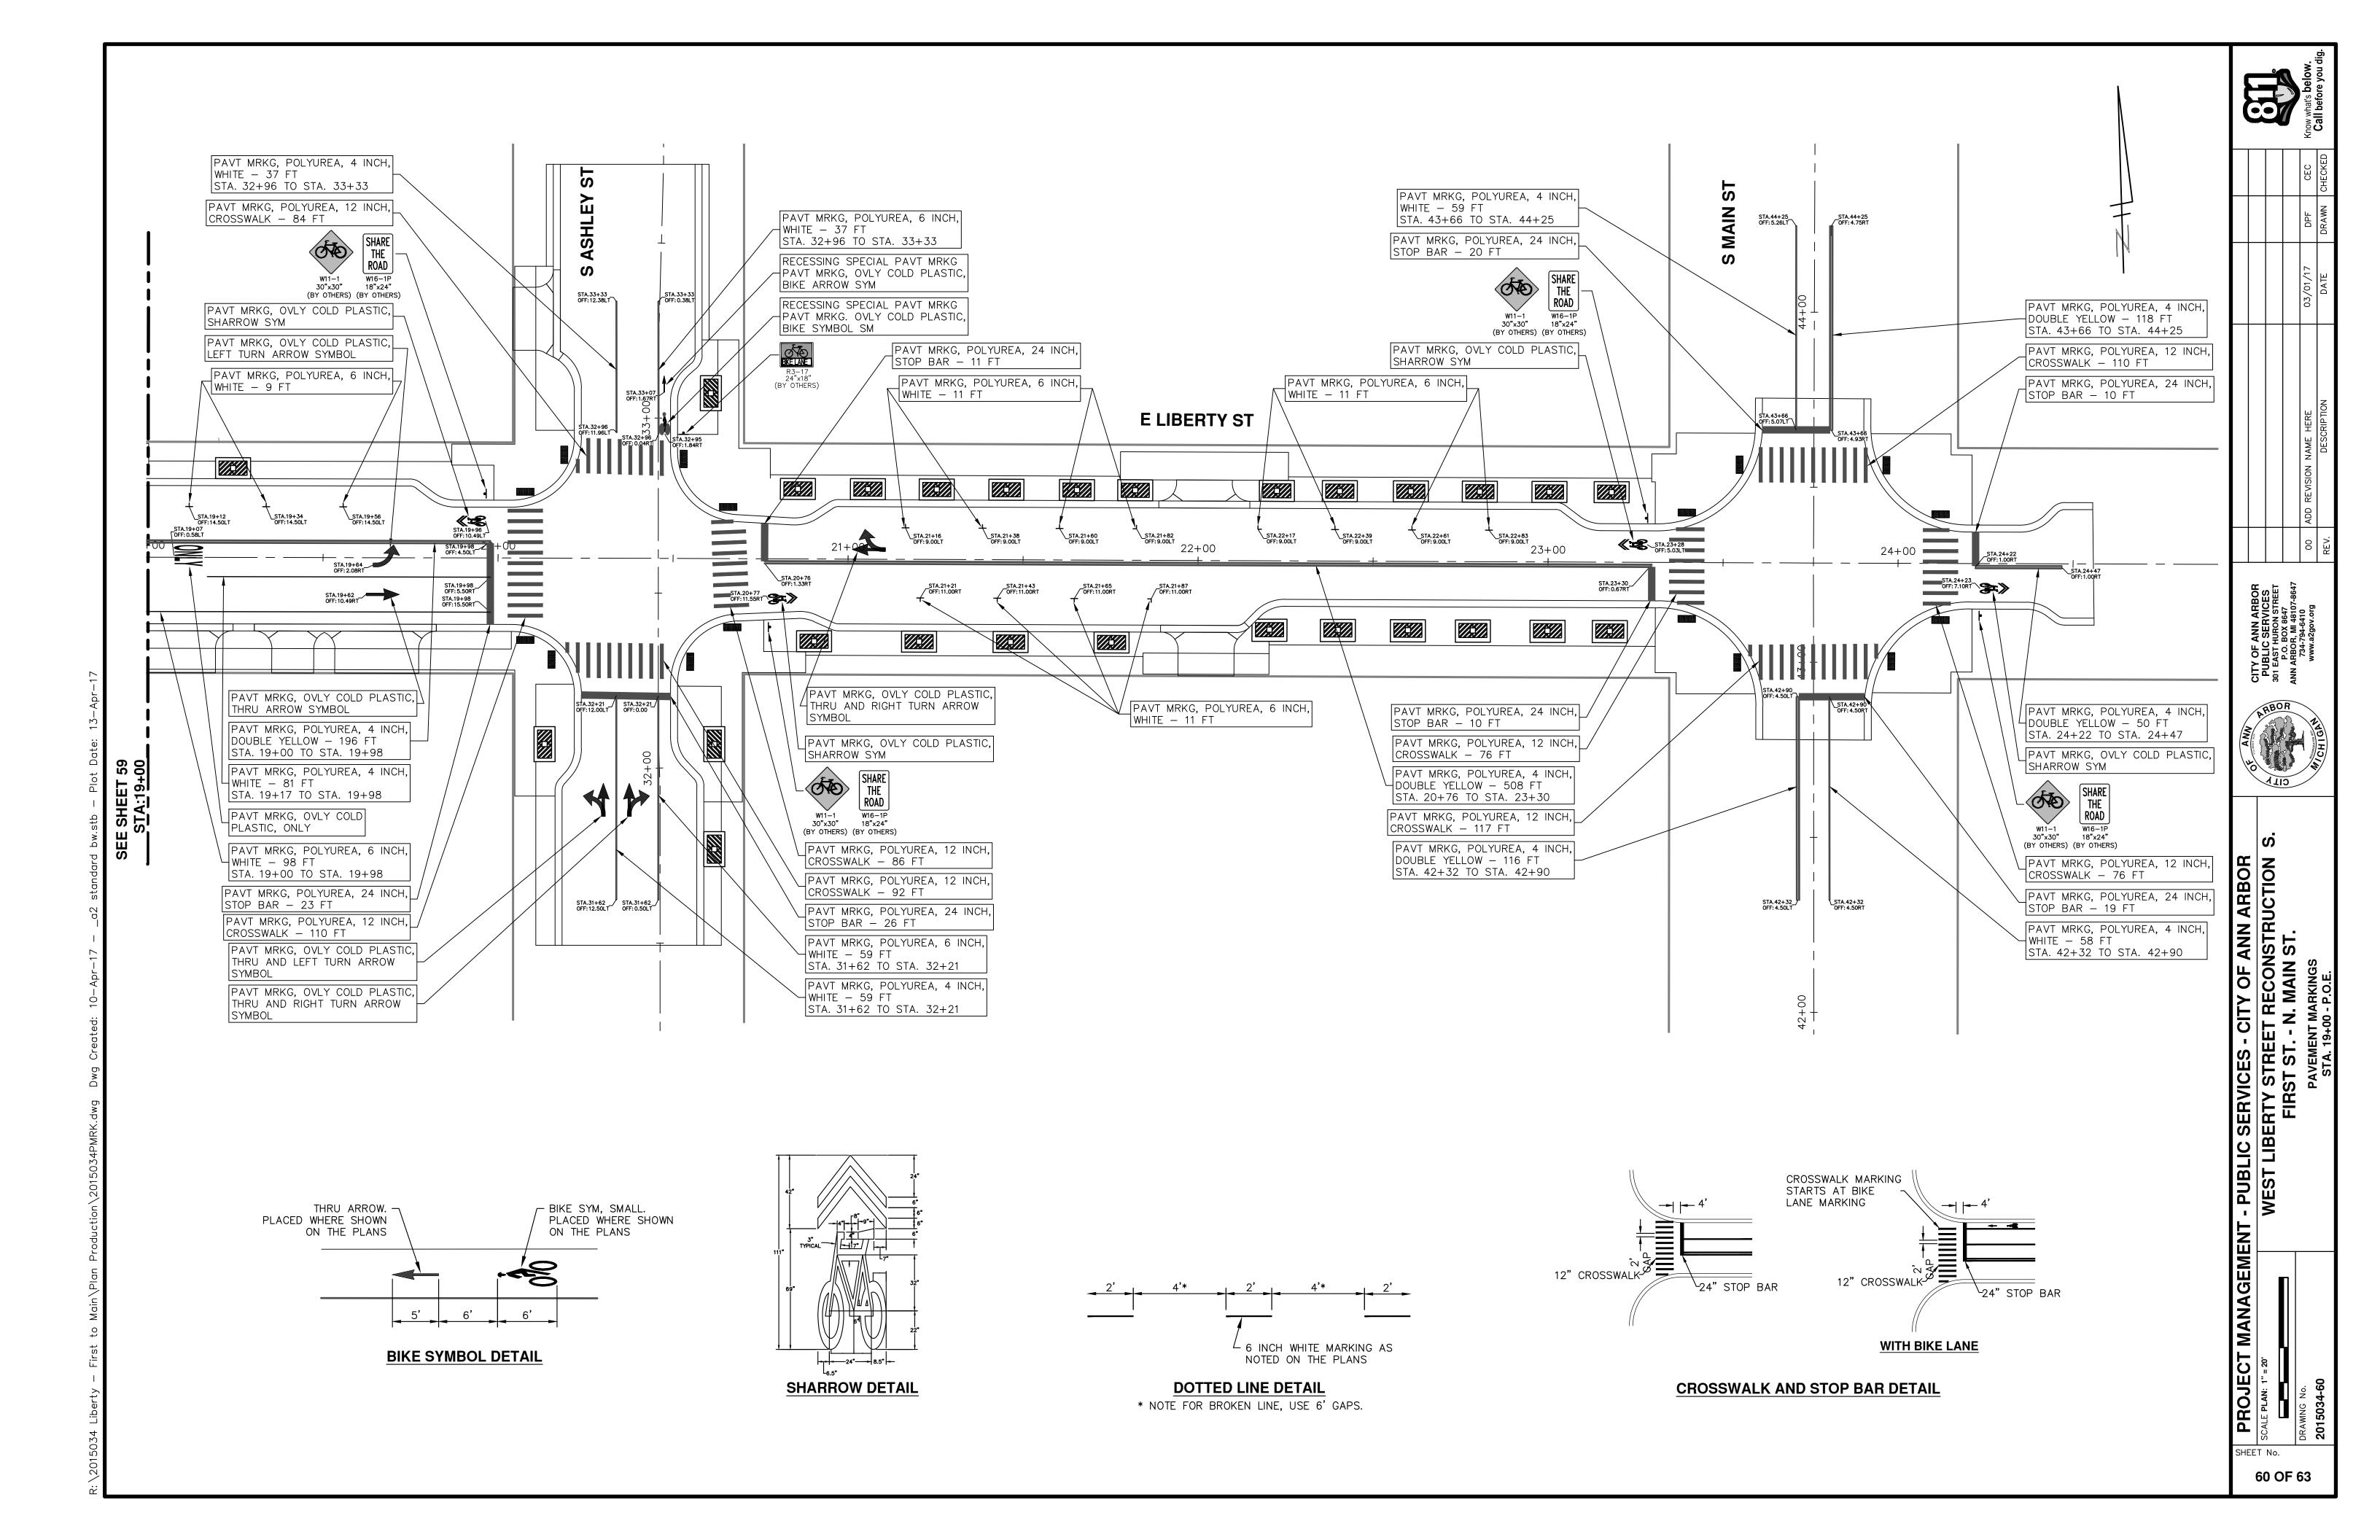


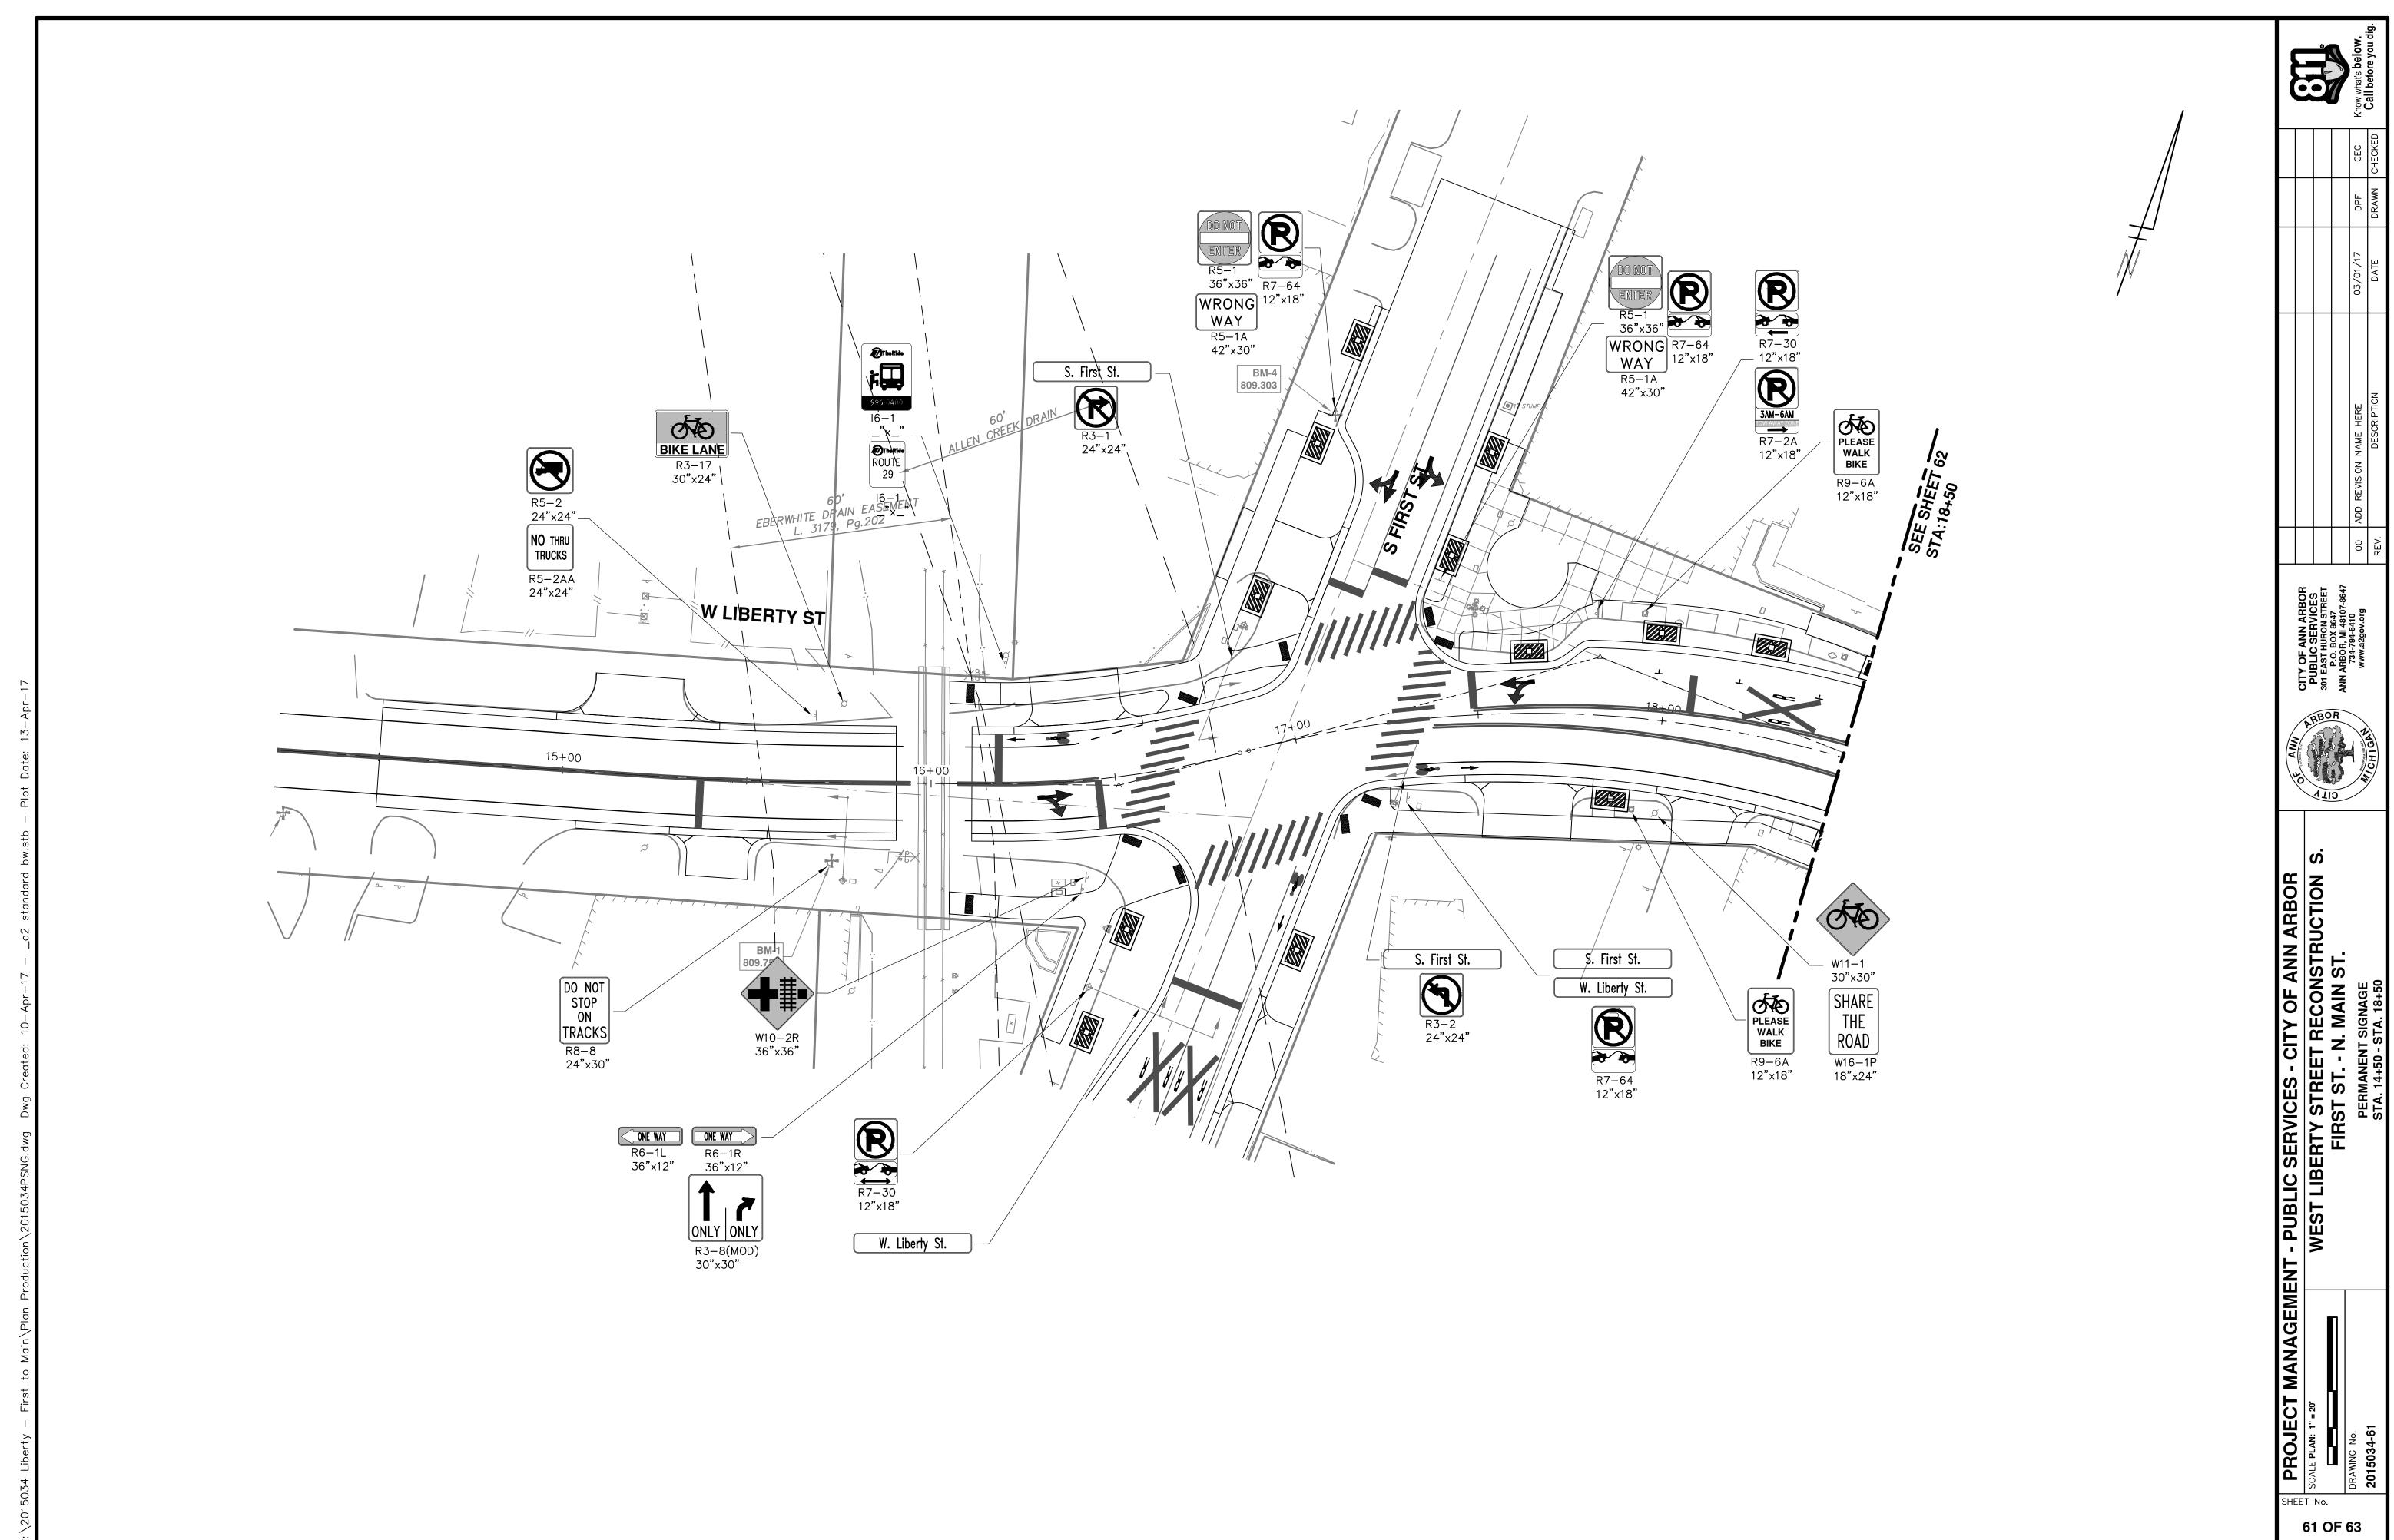

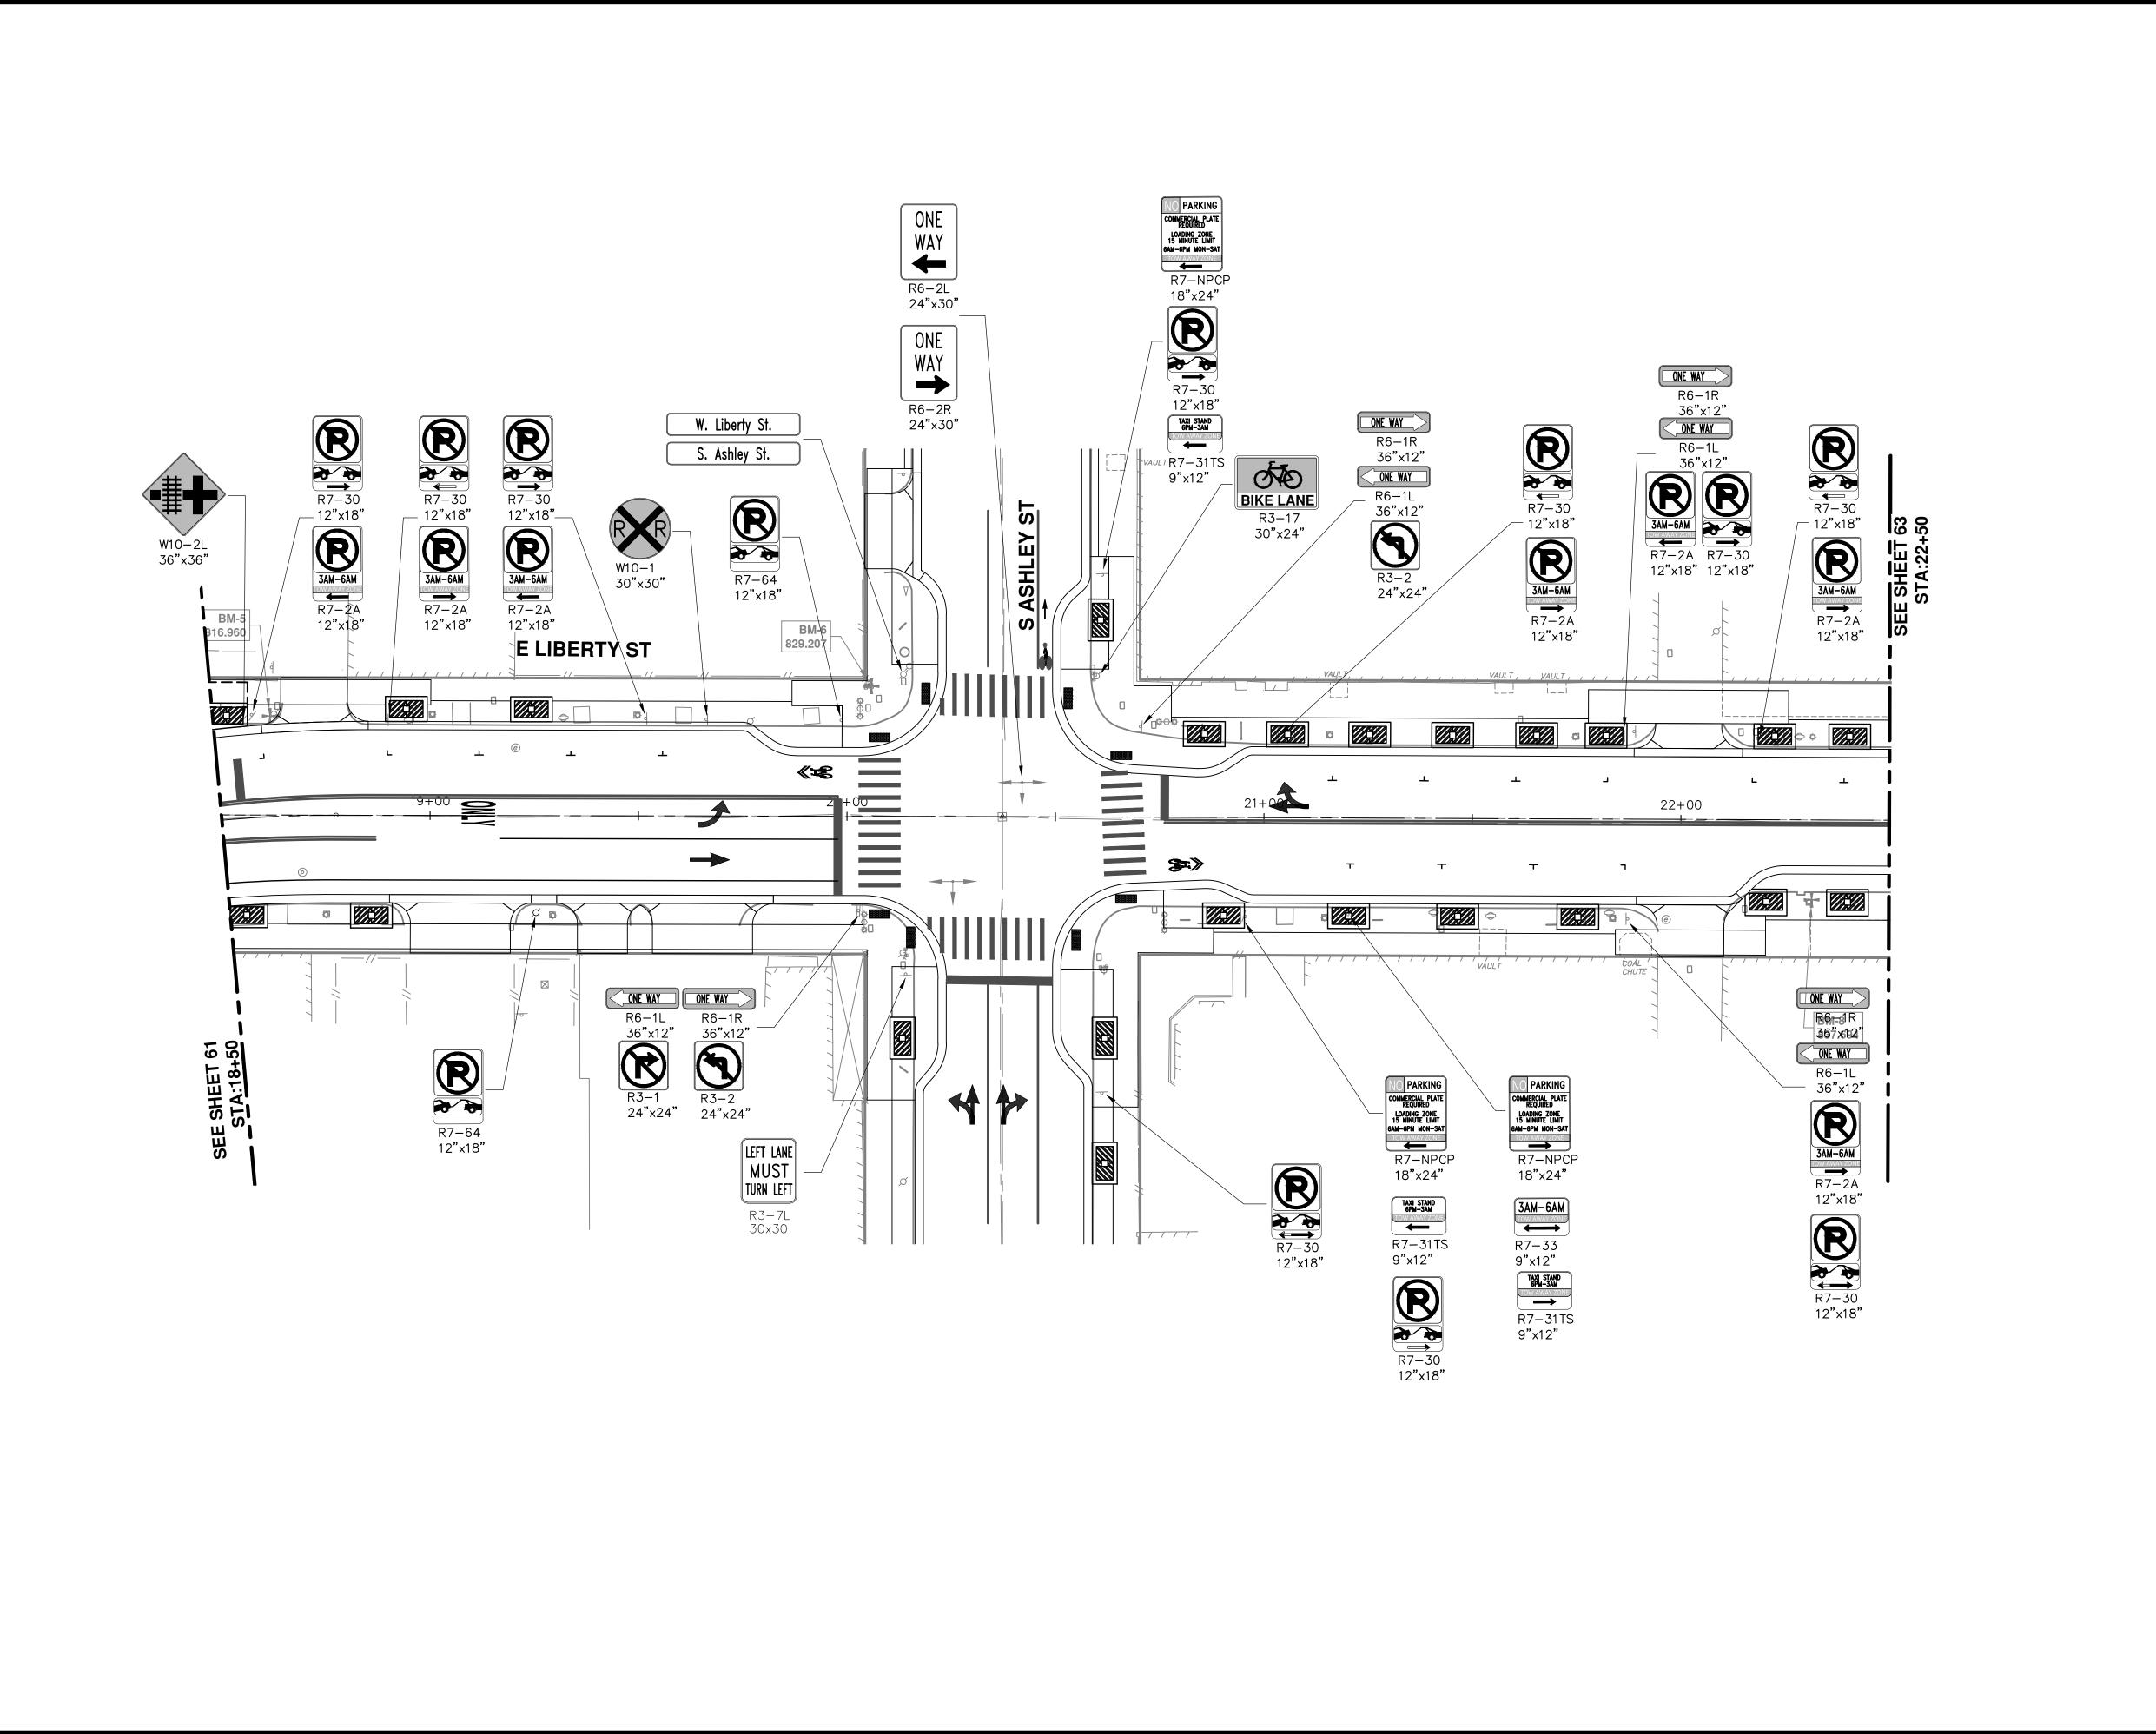

62 OF 63

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PROJECT MANAGEMENT - PUBLIC SERVICES - CITY OF ANN ARBC

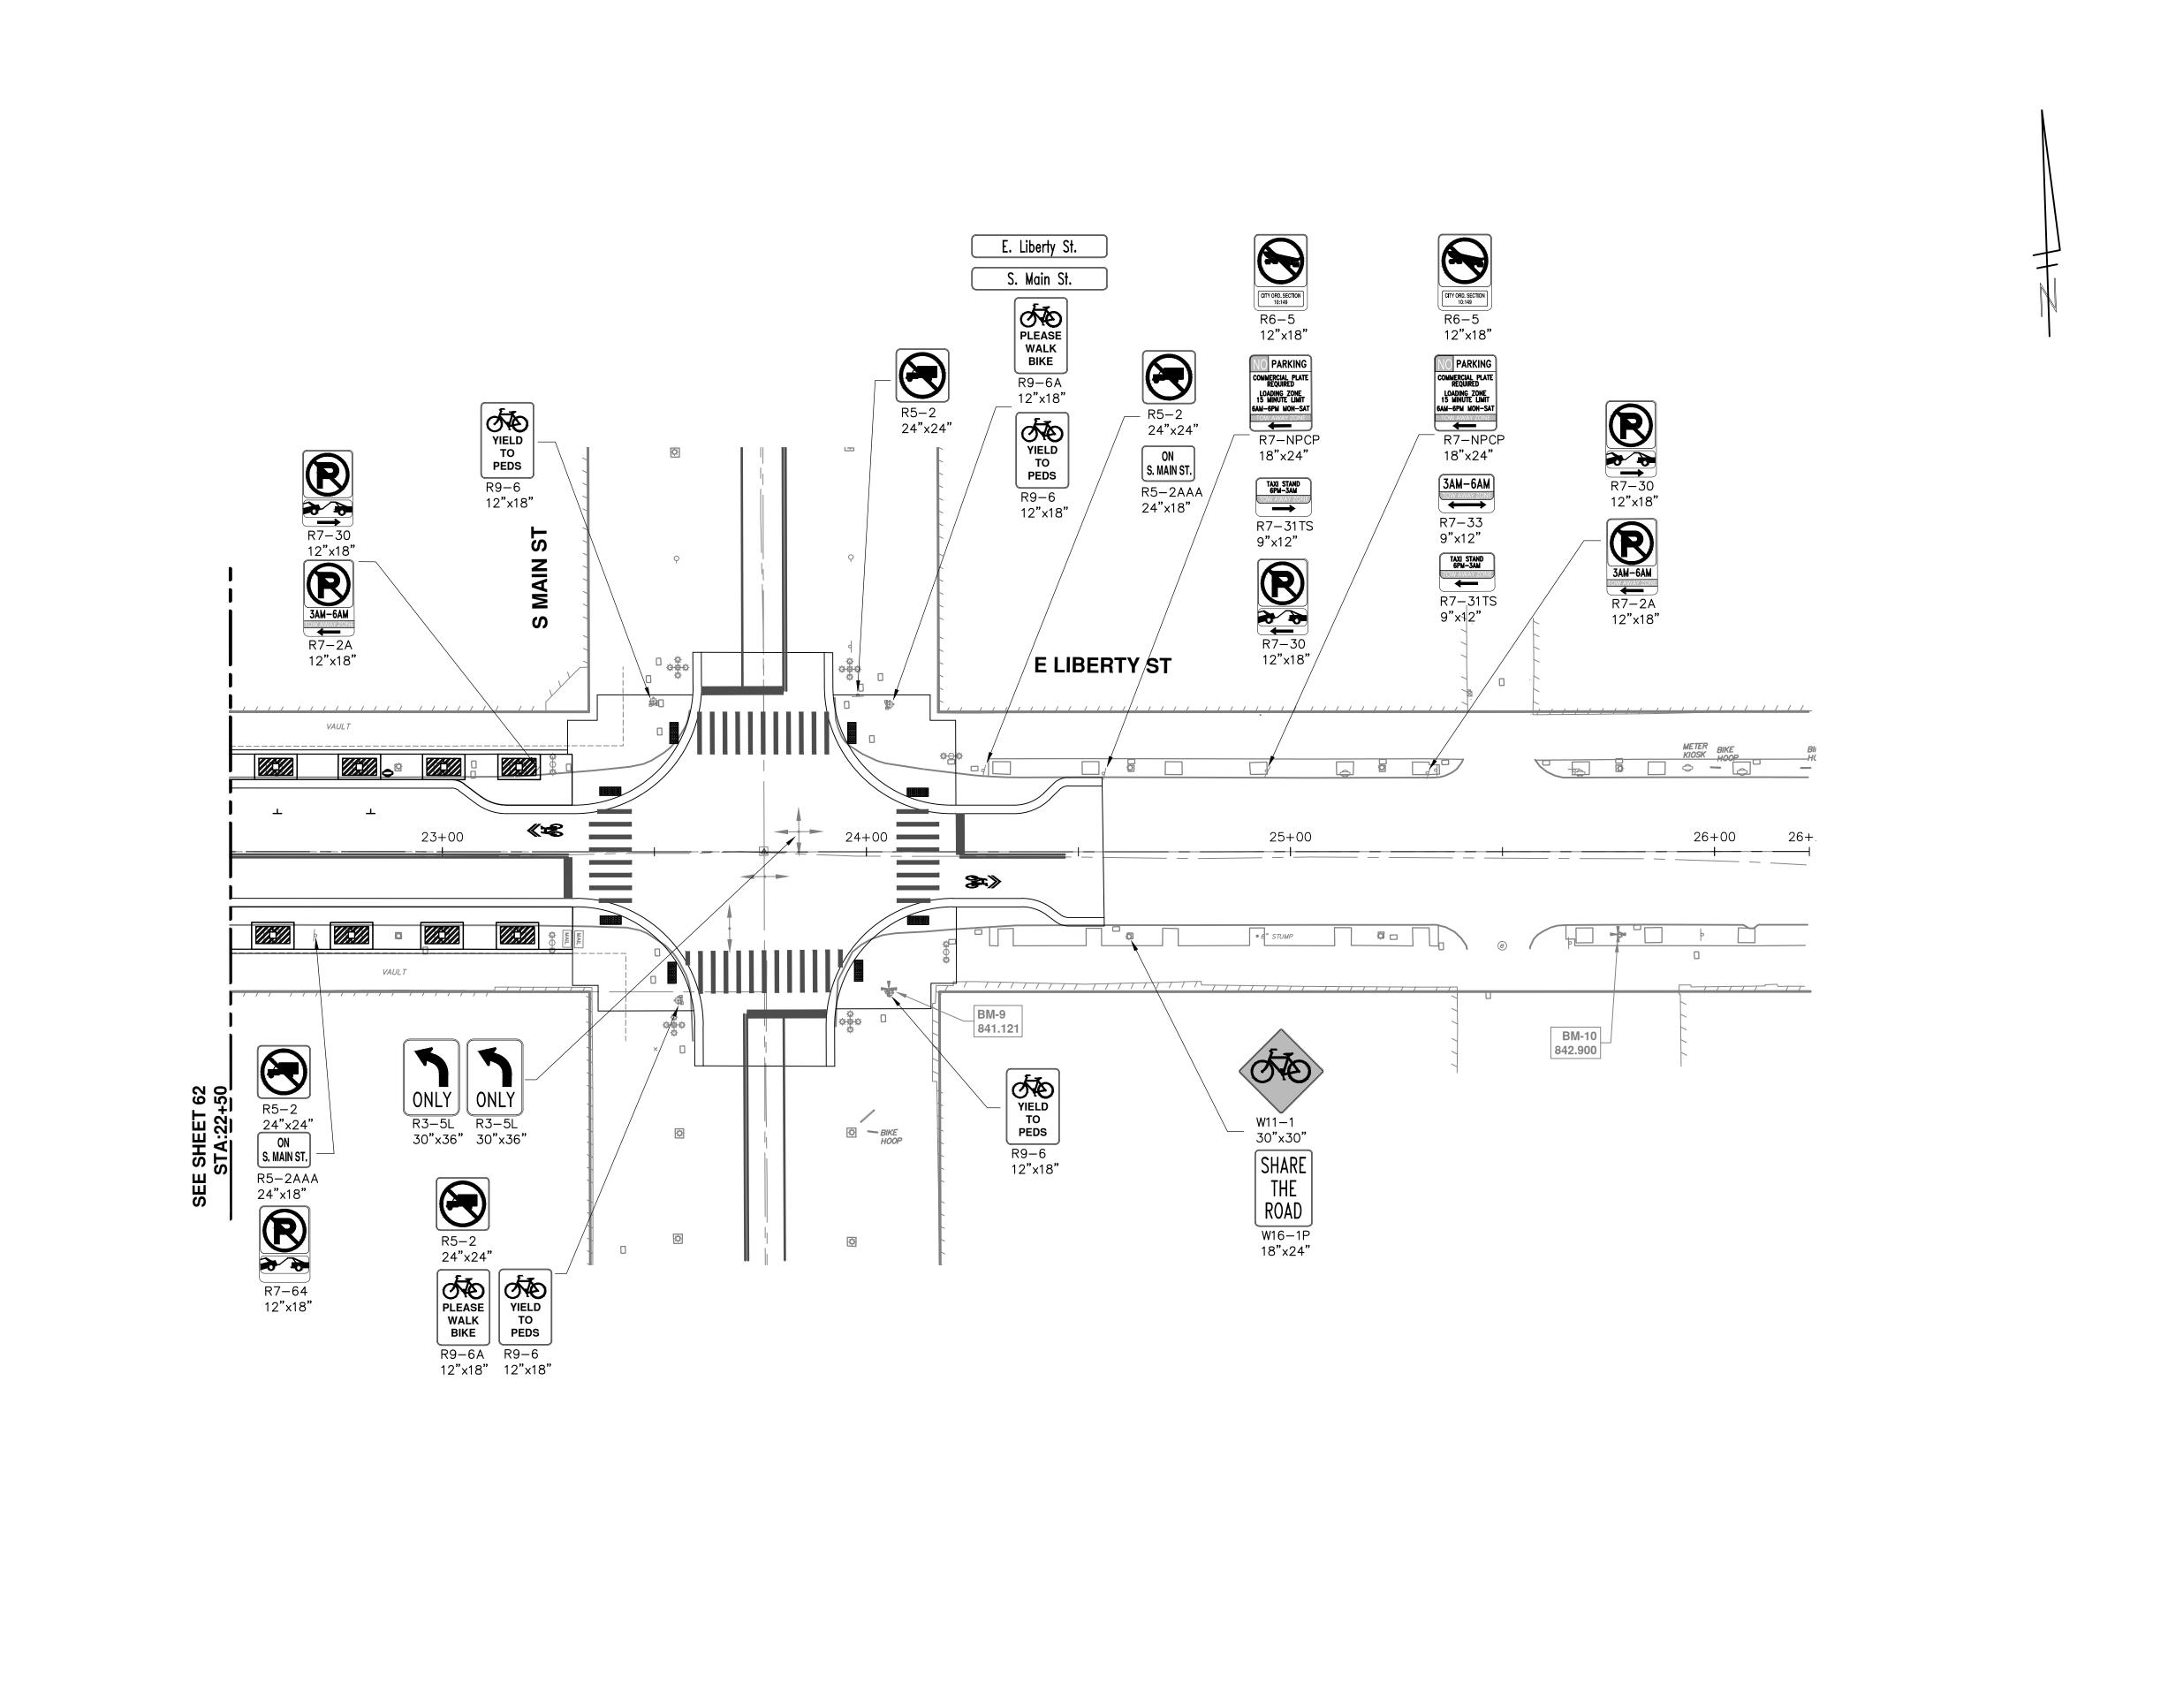SCALE PLAN: 1" = 20

SCALE PLAN: 1" = 20

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WEST LIBERTY STREET RECONSTRUCT

SCALE PLAN: 1" = 20

WEST LIBERTY STREET RECONSTRUCT

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