ADDENDUM No. 3

ITB No. 4477

Street Resurfacing - 2017

Bids Due: March 30, 2017 at 10:00 A.M. (local time)

The following changes, additions, and/or deletions shall be made to the Invitation to Bid for Street Resurfacing - 2017, ITB No. 4477, on which proposals will be received on/or before March 30, 2017, at 10:00 A.M. (local time).

The information contained herein shall take precedence over the original documents and all previous addenda (if any), and is appended thereto. **This Addendum includes 137 pages.**

Bidder is to acknowledge receipt of this Addendum No. 3, including all attachments (if any) in its Bid by so indicating on page ITB-1 of the Invitation to Bid Form. Bids submitted without acknowledgment of receipt of this addendum will be considered nonconforming.

The following forms provided within the ITB Document must be included in submitted bids at bid opening.

- City of Ann Arbor Prevailing Wage Declaration of Compliance
- City of Ann Arbor Living Wage Ordinance Declaration of Compliance
- Vendor Conflict of Interest Disclosure Form
- City of Ann Arbor Non-Discrimination Ordinance Declaration of Compliance

Bids that fail to provide these completed forms listed above upon bid opening will be rejected as non-responsive and will not be considered for award.

I. CORRECTIONS/ADDITIONS/DELETIONS/CLARIFICATIONS

Changes to the Bid documents outlined below are referenced to a page or Section in which they appear conspicuously. The Bidder is to take note in its review of the documents and include these changes as they may affect work or details in other areas not specifically referenced here.

Item #1: The revised Contract Plan Set mistakenly was not included with Addendum 2; replace the original issued Bid Set dated 03-08-17 (sheets 1 thru 136) with set issued as Addendum 1 dated 03-24-17 (sheets 1 thru 136) and included with this Addendum 3.

Changes include the following:

Plan Sheets 4, 6, 8, 10, 12, 14, 16, 18, 20, 22, 24, 26, 29, 31, 51, 59, 64, 68, 74, 82, 116, 122 and 133 of 136 (Location Cover Sheets) – Revised QUANTITY TABLE and QUANTITY TABLE for Sign, Type B, Temp, Prismatic to reflect correct pay items and quantities respective to each location, revised CONSTRUCTION METHOD AND SEQUENCING notes to reflect work required at each respective location.

Bidders are responsible for any conclusions that they may draw from the information contained in the Addendum.



CITY OF ANN ARBOR PROJECT MANAGEMENT ANNUAL STREET RESURFACING - 2017


SHEET NO.	TITLE	MAP INDEX NO. (THIS SHEET)
1	COVER SHEET	
2	LEGEND	
3	TRAFFIC CALMING DETAIL	
4-5	THIRD STREET	1
6-7	FOURTH STREET	2
8-9	FIFTH STREET - W HOOVER AVE TO W DAVIS AVE	3
10-11	FIFTH STREET - PRINCETON ST TO W LIBERTY ST	4
12-13	SIXTH STREET	5
14-15	ALLEY - S SEVENTH ST TO DEAD END	6
16-17	ARELLA BOULEVARD	7
18-19	HIGH ORCHARD DRIVE	8
20-21	HIGH ORCHARD COURT	9
22-23	ISLAND DRIVE - CANAL ST TO WALL ST	10
24-25	WEST DAVIS AVENUE	11
26-28	WEST JEFFERSON STREET	12
29-30	WILDER PLACE	13
31-50	ARLINGTON BOULEVARD	14
51-58	CATHERINE STREET	15
59-63	CHURCH STREET	16
64-67	GREEN ROAD NON-MOTORIZED PATH	17
68-73	HILL STREET	18
74-81	MILLER AVENUE	19
82-115	SOUTH DIVISION STREET	20
116-121	SOUTH UNIVERSITY AVENUE	21
122-132	WEST LIBERTY STREET	22
133-136	WEST STADIUM BOULEVARD	23


SHEET INDEX



NORTH

ITB No. 4477 FILE No. 2017004

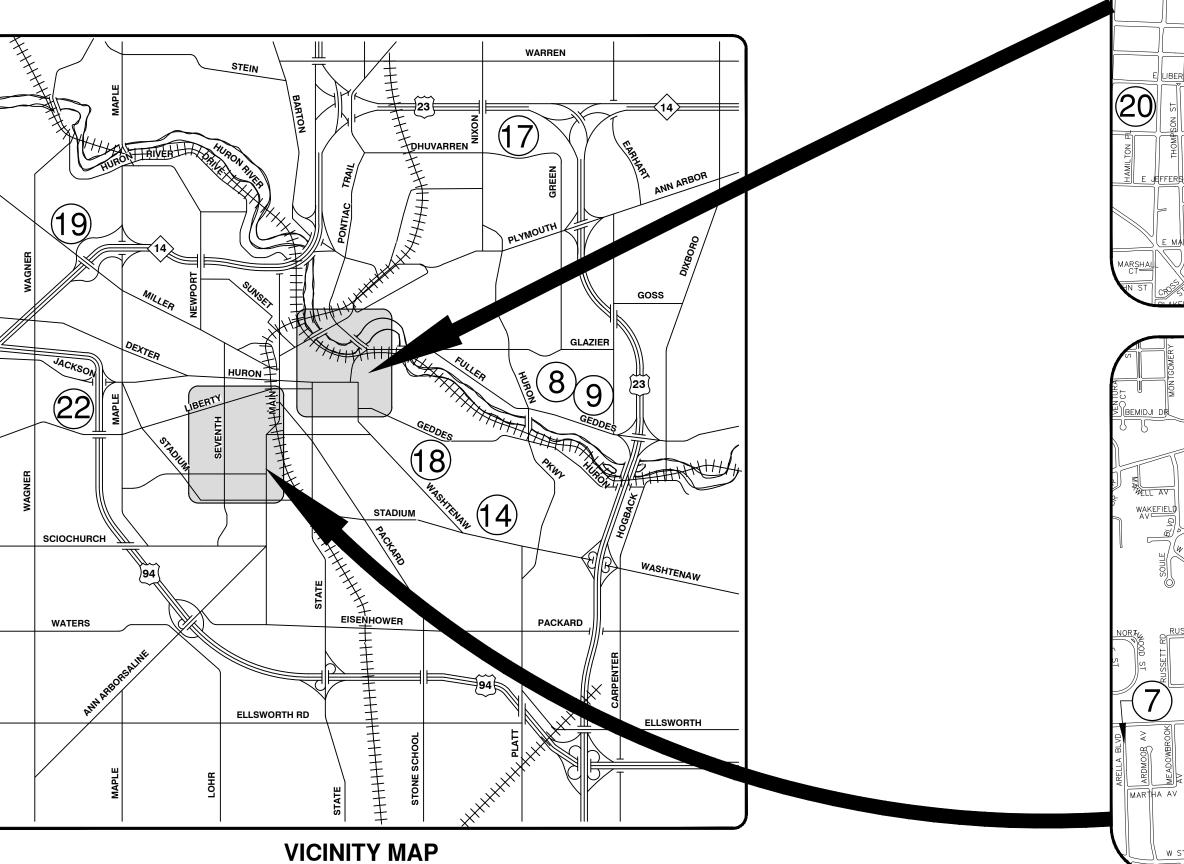

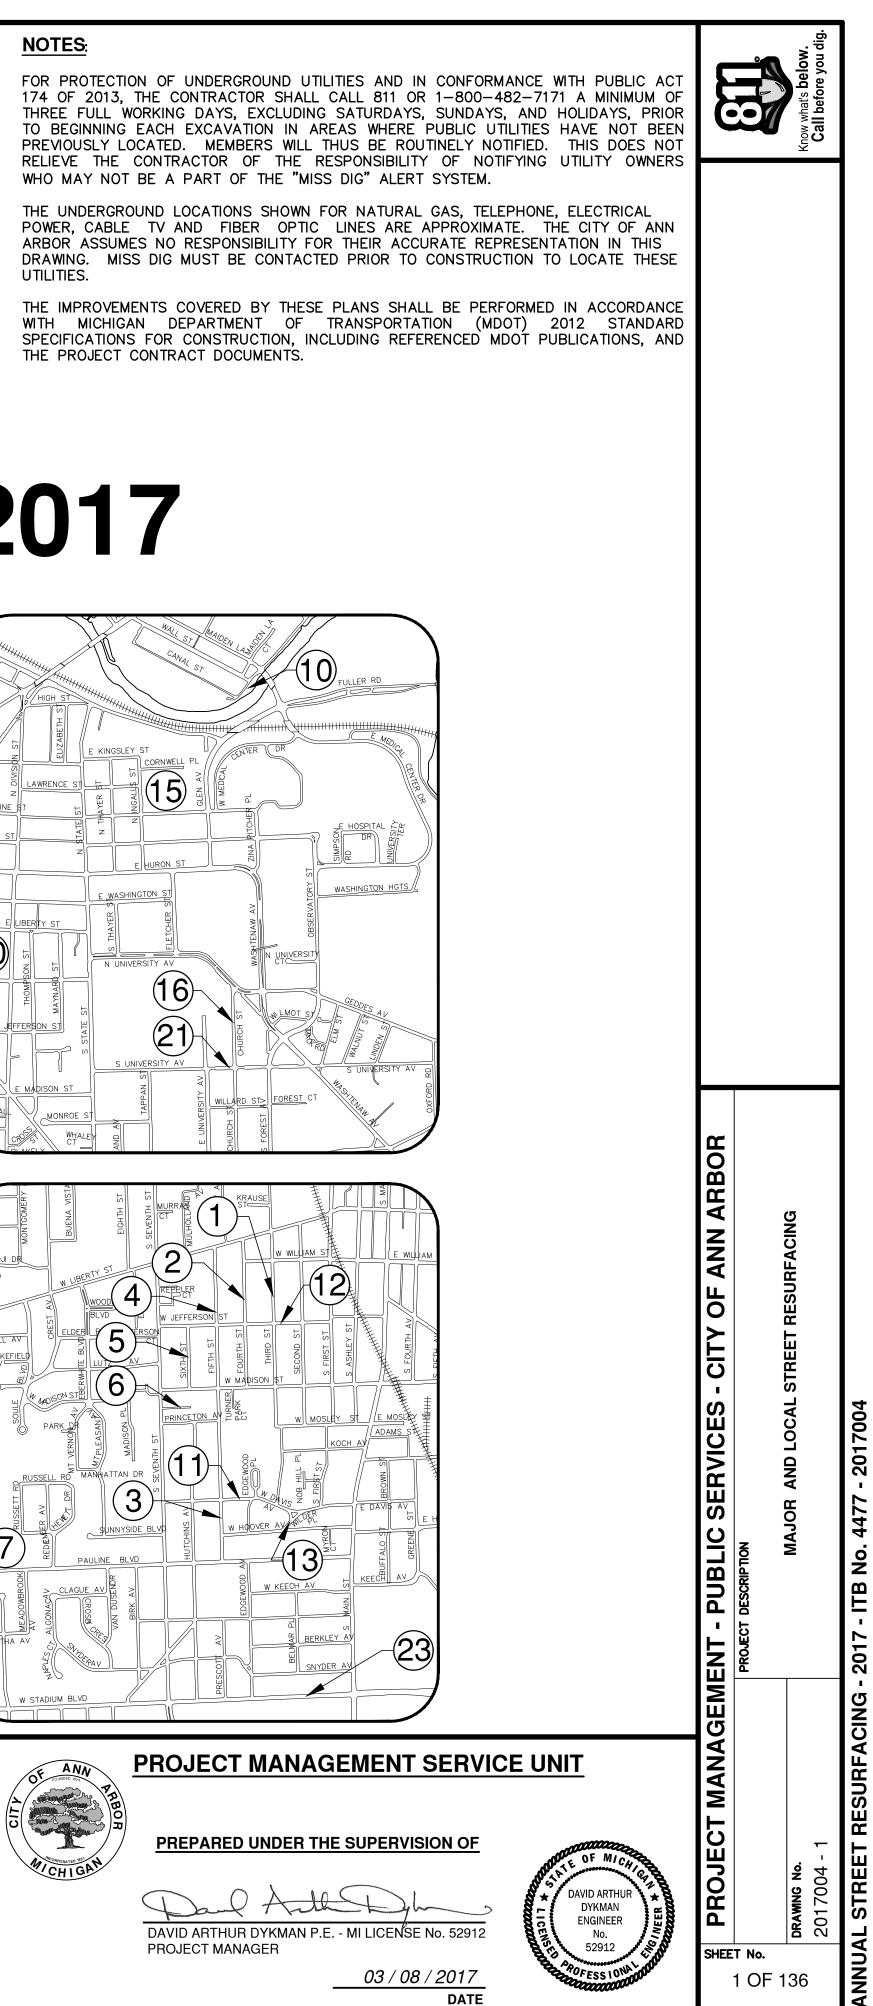

201 RESURFACING

EX	ISTING LEGEND			PROPOSED LEGEND
ţ +	FIRE HYDRANT	<i>w</i>	WATER MAIN	∳+ HYDRANT (PLAN)
I	GATE VALVE IN BOX	/-/-/-/-/-/-/-/-/-/-/-/-/-/-/-/-	WATER MAIN ABANDONED	↔ WATER GATE WELL
8	GATE VALVE IN WELL	<u> </u>	STORM SEWER	▼ REDUCER
W	STOP BOX	///	STORM SEWER ABANDONED	WATER GATE VALVE
w	WATER VAULT	<u> </u>	SANITARY SEWER	WATER STOP BOX
Ø	WELL	///	SANITARY SEWER ABANDONED	W WATER VAULT
	CATCH BASIN (SQ)	g	GAS MAIN	
€	CATCH BASIN (RD)	g (Dead)	GAS MAIN (DEAD)	DOUBLE INLET
С	STORM MANHOLE	o^vo	ELECTRICAL OVER HEAD	INLET JUNCTION CHAMBER
	NON-CURB CATCH BASIN (SQ)		ELECTRICAL UNDER GROUND	ROUND CATCH BASIN
)	END SECTION	e duct bank	ELECTRICAL DUCT BANK	STORM MANHOLE
С	SANITARY MANHOLE		TELEPHONE OVER HEAD	DRAIN ARROW
О	CLEAN-OUT		TELEPHONE UNDER GROUND	FLARED END SECTION
•	POST	t duct bank		SANITARY MANHOLE
ф	PEDESTRIAN SIGNAL		TELEPHONE DUCT BANK	© CLEAN-OUT
þ	SIGN	— ohtv —	CABLE TV OVER HEAD	BARREL
	HAND HOLE	— tv —	CABLE TV UNDER GROUND	- - - SIGN
¢	ORNAMENTAL LIGHT	fo fo	FIBER OPTIC	PUSH BUTTON
ጙ	FLOOD LIGHT		FIBER OPTIC DUCT BANK	HAND HOLE
୭	UNKNOWN MANHOLE		BOUNDARY	
Ð	TELEPHONE MANHOLE		BUILDING	
× X	TELEPHONE RISER		CENTERLINE OF DITCH	
9	GAS VALVE		CENTERLINE/CROWN OF ROAD	
0	GAS VENT	<i>800</i>	CONTOUR MAJOR	
Ħ	GAS BOX	— — — — 799 — — — —	CONTOUR MINOR	
Ĭ	ELECTRICAL RISER		EDGE OF WATER	
X	TRANSFORMER		FLOODPLAIN	
Ø	UTILITY POLE	////////////	FENCE	
0	LAMP POLE	:::	GRAVEL	
>	GUY ANCHOR		GUARDRAIL	
γ	GUY POLE	~~~~~~~~~~~~~~~~~~~~~~~~~~~~~~~~~~~~~~~	STONE WALL	
	MONITORING WELL		R.O.W.	
IN	MAILBOX		TREELINE	
•	SOIL BORING		WETLAND	
\wedge	TRAVERSE POINT	un u	EDGE OF BRUSH	
+	BENCH MARK			
0	IRON PIPE		HEDGE	
•	MON BOX		TREE (DECIDUOUS)	

My . AW

TREE (CONIFEROUS)

T.Y.

0

SHRUB (DECIDUOUS)

STUMP

R.Z. -


TREE TO REMAIN & PROTECT (DECIDUOUS) CRITICAL ROOT ZONE (C.R.Z.) = DIAMETER BREAST HEIGHT (INCHES) X 10

ML C.R.Z. 1 2 M

TREE TO REMAIN & PROTECT (CONIFEROUS) CRITICAL ROOT ZONE (C.R.Z.) = DIAMETER BREAST HEIGHT (INCHES) X 10

W 	WATER MAIN STORM SEWER	Ę			Know what's below	l before you dig.
<u> </u>	SANITARY SEWER FIBER OPTIC			٧	Know \	Cal
——E — — — — —	ELECTRICAL			DAD	DAD	CHECKED
	CENTERLINE OF DITCH CENTERLINE OF ROAD					CHE
////	FENCE			AG,GS,RG	AG,GS,RG	DRAWN
	GRAVEL			AG	AG	ā
• • • • • • • • •	SILT FENCE PROTECTIVE FENCE			-17	-17	Ш
	GUARDRAIL			03-24-17	03-08-17	DATE
	LOT/UNIT CURB					
	TEMPORARY GRADING PERMIT					
	CONTOUR MAJOR CONTOUR MINOR					
	WATER EASMENT					NOI
	STORM EASEMENT					DESCRIP TION
	SANITARY EASEMENT R.O.W.					DES
	LIMITS OF CONSTRUCTION			UM #1		
	LIMIT OF GRADING			ADDENDUM	D SET	
	STONE WALL				BID	
	DETECTABLE WARNING			0	00	REV.
4 <i>q</i> .	ASPHALT	ROB	ICES STREET	.7 07-8647	_ <u>5</u>	
	CONCRETE	OF ANN ARROR	C SERVICES HURON STREE	P.O. BOX 8647 RBOR, MI 4810	734-794-6410 www.a2gov.org	
	SIDEWALK			ANN A	734 WWV	
	TREE (DECIDUOUS)	ANN BINN	ARBC	R	PORATED WY	CHIGAN
S My	TREE (CONIFEROUS)	0E			Neone Alexandre	
	TREE TO BE REMOVED (DECIDUOUS)	N ARBOR	4G - 2017			
	TREE TO BE REMOVED (CONIFEROUS)	ITY OF AN	RESURFACING		1	-ND
	STUMP TO BE REMOVED	ICES - CI	FREET RE			LEGEND
		MANAGEMENT - PUBLIC SERVICES - CITY OF ANN	ANNUAL STREET			
		PROJECT	SCALE : N/A		DRAWING No.	2017004-2

2 OF 136

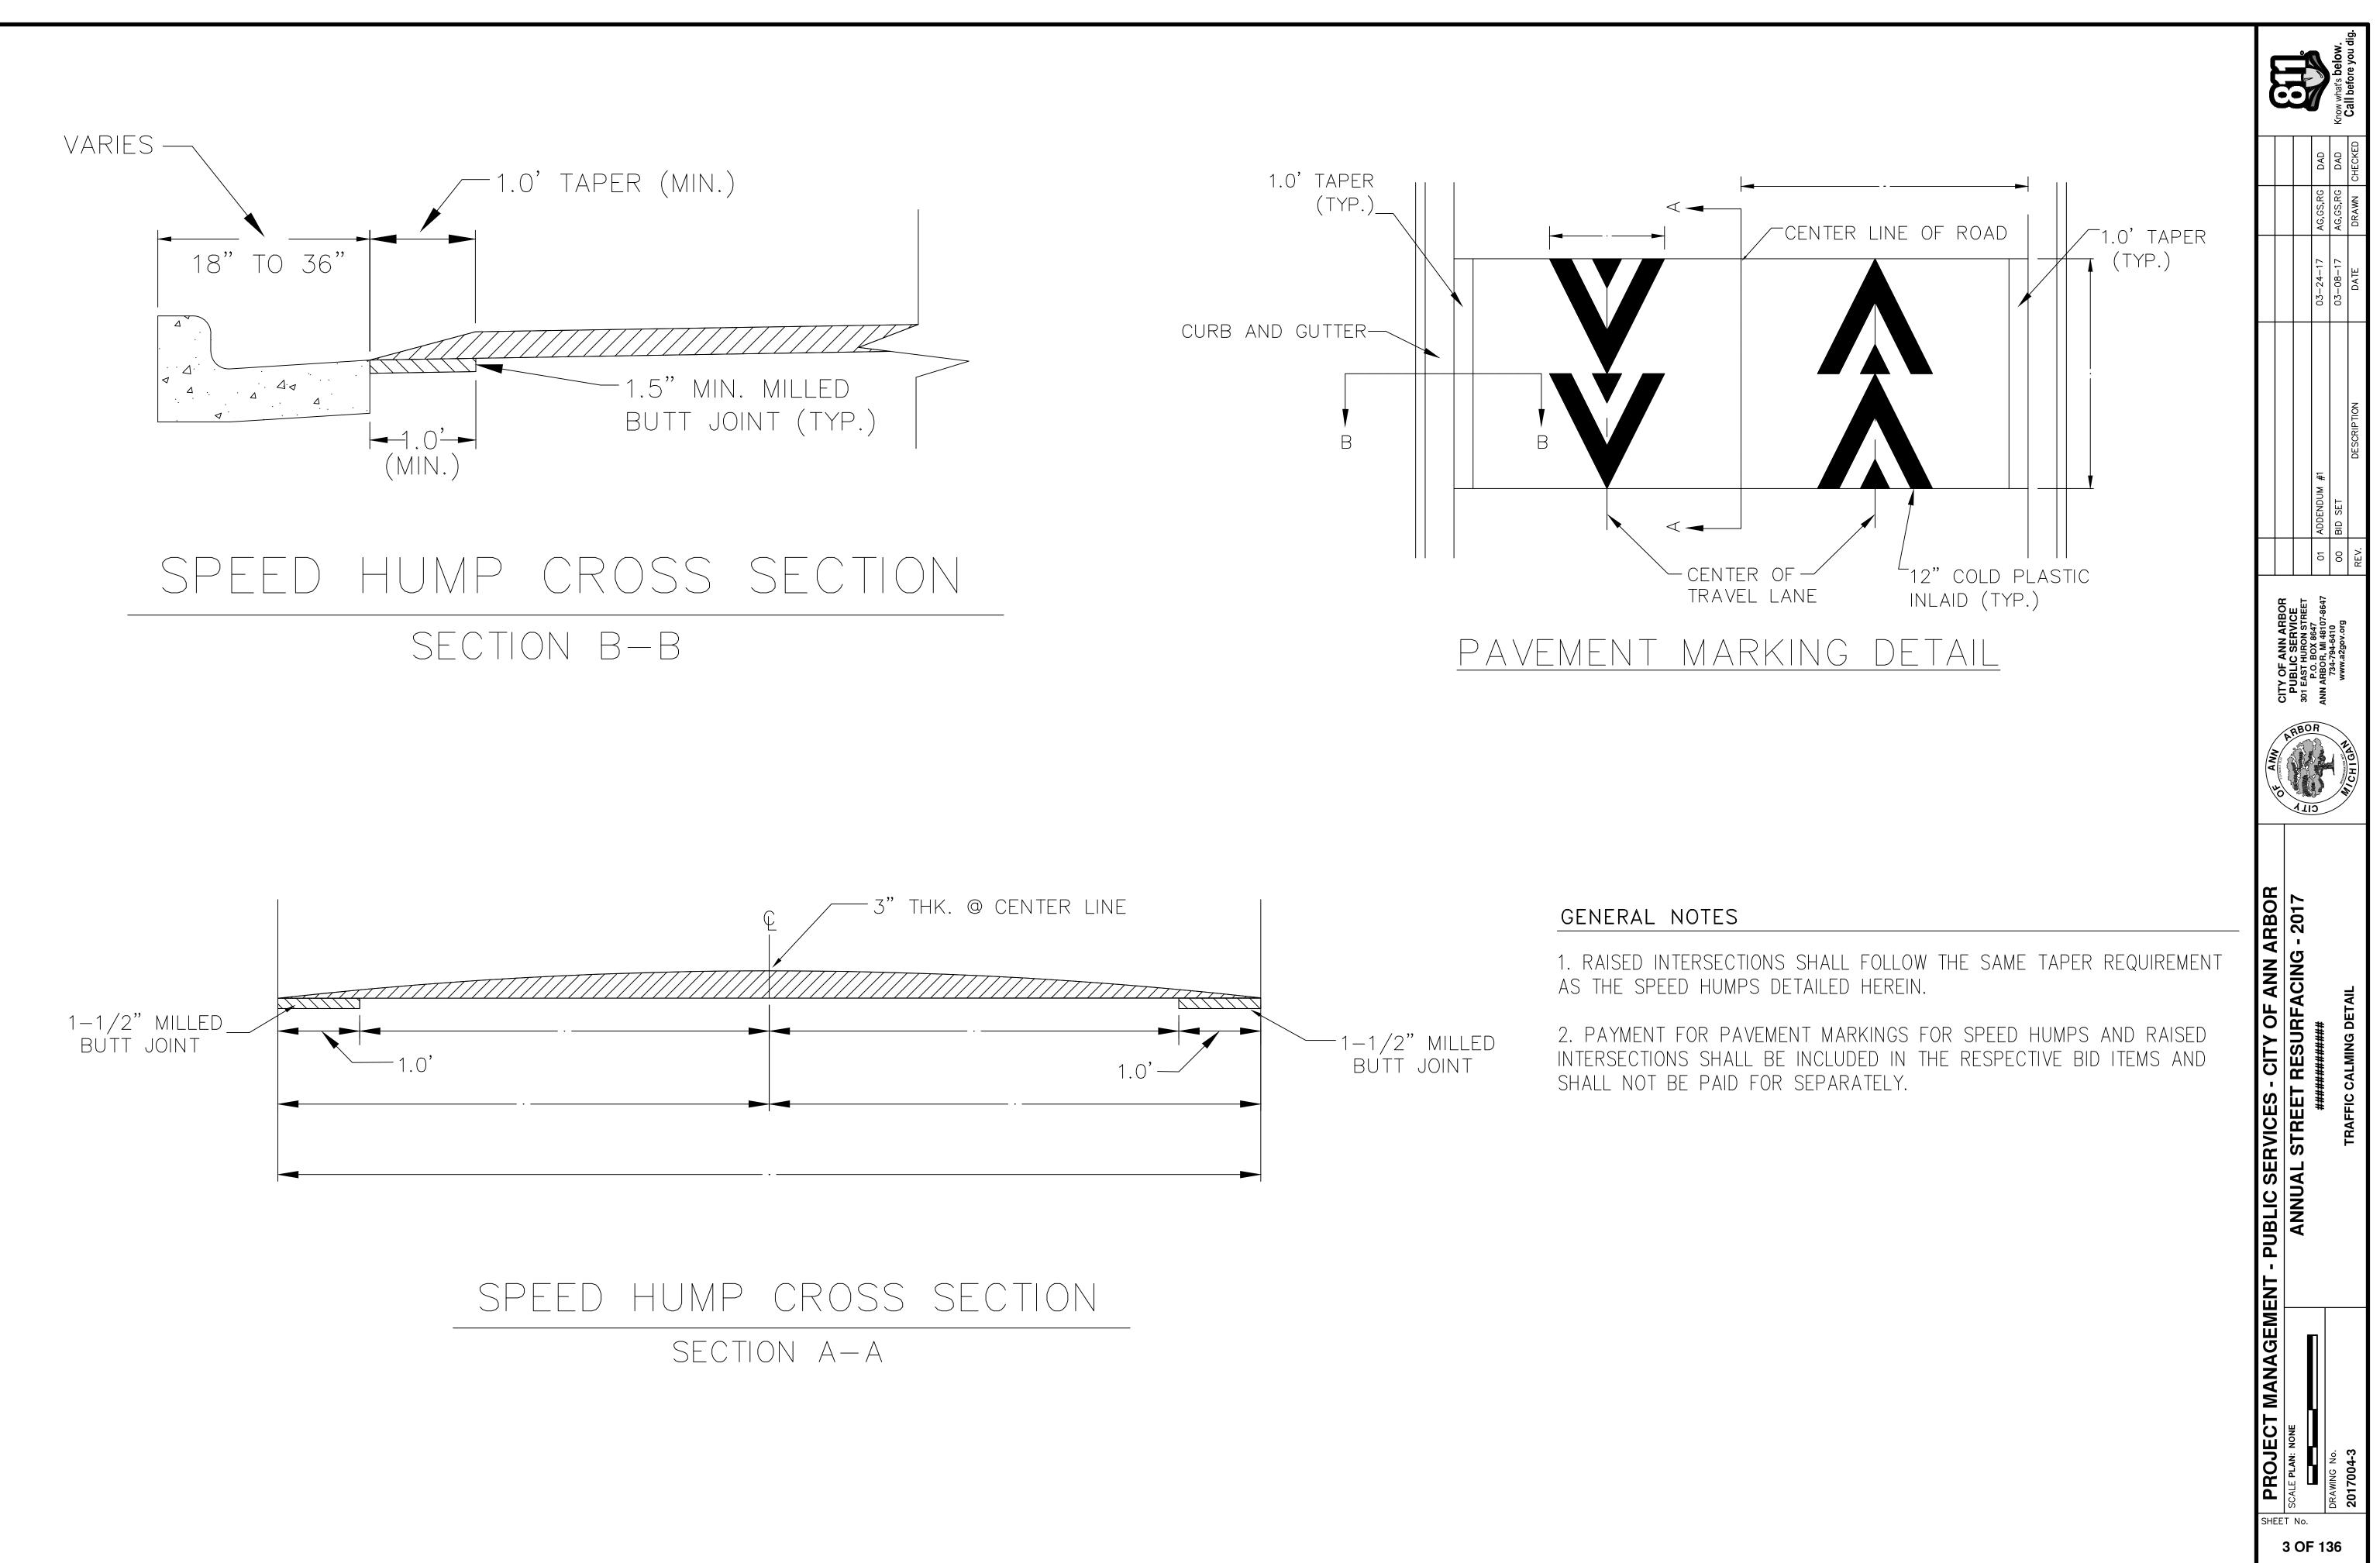



CITY OF ANN ARBOR PROJECT MANAGEMENT PROJECT LOCATION: 3RD STREET

QUANTITIES				
Item Code	Item Description	Units	Quantity	
2030011	Dr Structure, Rem	Ea	3.000	
2030015	Sewer, Rem, Less than 24 inch	Ft	30.000	
2047001	_Curb, Gutter, and Curb and Gutter, Any Type, Rem	Ft	106.000	
2057011	_Machine Grading, Special	Syd	4,571.000	
2057021	_Subgrade Undercutting, Type IIA	Cyd	458.000	
2080020	Erosion Control, Inlet Protection, Fabric Drop	Ea	7.000	
4020987	Sewer, CI IV, 12 inch, Tr Det B	Ft	30.000	
4030200	Dr Structure, 24 inch dia	Ea	3.000	
4037050	_Dr Structure Cover, Type B, Modified	Ea	8.000	
4037050	_Dr Structure Cover, Type K, Modified	Ea	3.000	
4037050	_Dr Structure, Adj, Case 1, Modified	Ea	11.000	
4037050	_Dr Structure, Temp Lowering, Modified	Ea	8.000	
5010003	Cold Milling HMA Surface	Ton	1,033.000	
5010005	HMA Surface, Rem	Syd	44.000	
5010703	HMA, LVSP	Ton	1,033.000	
5017031	_HMA, Wedging, 36A	Ton	8.000	
6027021	_Flowable Fill	Cyd	3.926	
8027001	_Curb and Gutter, Conc	Ft	118.000	
8117001	_Pavt Mrkg, Wet Retrflec, Thermopl, 6 inch, Crosswalk	Ft	140.000	
8117001	_Pavt Mrkg, Wet Retrflec, Thermopl, 24 inch, Stop Bar	Ft	32.000	
8120012	Barricade, Type III, High Intensity, Double Sided, Lighted, Furn	Ea	4.000	
8120013	Barricade, Type III, High Intensity, Double Sided, Lighted, Oper	Ea	4.000	
8120260	Plastic Drum, High Intensity, Lighted, Furn	Ea	53.000	
8120261	Plastic Drum, High Intensity, Lighted, Oper	Ea	53.000	
8120350	Sign, Type B, Temp, Prismatic, Furn	Sft	129.500	
8120351	Sign, Type B, Temp, Prismatic, Oper	Sft	129.500	
8127050	_No Parking Sign	Ea	35.000	
8167011	_Slope Restoration	Syd	120.000	
8230431	Gate Box, Adj, Case 1	Ea	1.000	

	CONSTRUCTION KEY
KEY	ASSOCIATED PAY ITEM(S)
	_Dr Structure, Adj, Case 1, Modified
AA	_Dr Structure, Adj, Case 2, Modified
	_Dr Structure, Temp Lowering, Modified _Dr Structure, Temp Lowering, Modified
	• _Gate Box, Adj, Case 1
AB	Gate Box, Adj, Case 2
	Monument Box Adjust
ADST	_Dr Structure, Adj, Add Depth, Modified
AK	_Dr Structure, Adj, Case 1, Modified
01	• _Sidewalk, Sidewalk Ramp, and Driveway Approach, Any Thickness, Rem
C4	 _Grading, Sidewalk _Sidewalk, Conc, 4 inch, Modified
	 _Sidewalk, Conc, 4 mcn, Modified _Sidewalk, Sidewalk Ramp, and Driveway Approach, Any Thickness, Rem
	Grading, Sidewalk
C4HE	• Cement
	 _Sidewalk, Conc, 4 inch, Modified
	• _Sidewalk, Sidewalk Ramp, and Driveway Approach, Any Thickness, Rem
	• _Grading, Sidewalk
C6	Grading, Sidewalk Ramp Detectable Warring Surface, Medified
	 _Detectable Warning Surface, Modified _Sidewalk Ramp, Conc, 6 inch, Modified
	 _Sidewalk, Conc, 6 inch, Modified
00	Grading, Driveway Approach
C8	_Driveway, Nonreinf Conc, 8 inch, Modified
	• _Sidewalk, Sidewalk Ramp, and Driveway Approach, Any Thickness, Rem
	_Grading, Driveway Approach
	• _Grading, Sidewalk
	 _Grading, Sidewalk Ramp Cement
C HE	_Driveway, Nonreinf Conc, 6 inch, Modified
	_Driveway, Nonreinf Conc, 8 inch, Modified
	Detectable Warning Surface, Modified
	 Sidewalk Ramp, Conc, 6 inch, Modified
	_Sidewalk, Conc, 6 inch, Modified
C/G	_Curb, Gutter, and Curb and Gutter, Any Type, Rem
	_Curb and Gutter, Conc
C/GHE	 _Curb, Gutter, and Curb and Gutter, Any Type, Rem Cement
CONL	_Driveway Opening, Conc, Det M, Modified
0.0	Grading, Sidewalk
CP	_Sidewalk, Conc, 4 inch, Modified
CR	• _Sidewalk, Sidewalk Ramp, and Driveway Approach, Any Thickness, Rem
5.0	• Dr Structure, Rem
DS	Sewer, Rem, Less than 24 inch
	Dr Structure, 24 inch dia Dr Structure, Rem
DSDI	Sewer, Rem, Less than 24 inch
DODI	• _Dr Structure, Double Inlet
PT	_Dr Structure, Point
RRA	Dr Structure Cover, Type B
	_Dr Structure Cover, Type B, Special
	• _Dr Structure, Adj, Case 1, Modified
	Dr Structure, Temp Lowering, Modified
RRK	 Dr Structure Cover, Type K _Dr Structure, Adj, Case 1, Modified
RS	_Dr Structure, Reconstruct
	Plastic Drum, High Intensity, Lighted, Furn
TYPE II	Plastic Drum, High Intensity, Lighted, Oper
TYPE III	Barricade, Type III, High Intensity, Double Sided, Lighted, Furn
	Barricade, Type III, High Intensity, Double Sided, Lighted, Oper

ITB No. 4477 FILE No. 2017-004

LEGEND				
SYMBOL	DESCRIPTION			
S	EXISTING SANITARY SEWER MANHOLE			
(\mathbf{r})	EXISTING STORM SEWER MANHOLE			
\otimes	EXISTING WATER MAIN VALVE IN WELL			
+	WATER MAIN GATE VALVE IN BOX			
+ Ç +	FIRE HYDRANT			
(g)	MICHCON GAS CO. VALVE BOX/WELL			
t	AMERITECH TELEPHONE VAULT			
e	ELECTRIC MANHOLE			
\bullet	SOIL BORING			
	EXISTING STORM SEWER INLET			
▣	MONUMENT BOX			
	REMOVE AND REPLACE CONC. SIDEWALK			
	PLACE CONCRETE SIDEWALK			
	REMOVE & REPLACE CONC. CURB & GUTTER			
	CONSTRUCTION LIMITS			
	6" WRAPPED UNDERDRAIN			
	REMOVE CONCRETE SIDEWALK			
	SUBGRADE UNDERCUT			

CONSTRUCTION METHOD AND SEQUENCING

IN ACCORDANCE WITH THE SCHEDULE OF STREETS WORK ON THIS STREET IS TO OCCUR CONCURRENTLY WITH THAT PROPOSED FOR 6TH STREET. WORK ON THIS STREET INCLUDES, BUT IS NOT LIMITED TO, THE FOLLOWING ITEMS. COMPLETE THE WORK IN ACCORDANCE WITH THE PLANS AND SPECIFICATIONS, AND AS DIRECTED BY THE ENGINEER. PERFORM THE WORK IN THE ORDER INDICATED BELOW UNLESS OTHERWIS BY THE ENGINEER.

- CONTROL MEASURES.
- COLDMILLING.
- AND MONUMENT BOXES AS REQUIRED.
- REQUIRED.

- AS REQUIRED.
- 12. CLEAN PAVEMENT AND COMPLETE ALL PAVEMENT MARKINGS.
- 14. REMOVE ALL TRAFFIC CONTROL DEVICES, AND MISS DIG FLAGS.

NOTES:

QUANTITIES Sign, Type B, Temp, Prismatic			FOR PRO 174 OF 1 THREE F TO BEGIN PREVIOUS RELIEVE WHO MA
	Area (sft)	Total Area	THE UND POWER,
	4.000	20.000	ARBOR A
("Road Closed To Thru Traffic")	12.500	37.500	DRAWING UTILITIES
Sign	9.000	54.000	0 HEIHES

THE IMPROVEMENTS COVERED BY THESE PLANS SHALL BE PERFORMED IN ACCORDANCE WITH MICHIGAN DEPARTMENT OF TRANSPORTATION (MDOT) 2012 STANDARD SPECIFICATIONS FOR CONSTRUCTION, INCLUDING REFERENCED MDOT PUBLICATIONS, AND THE PROJECT CONTRACT DOCUMENTS.

Quantity | Sign Code | Description 5.0 D3-1 Street Name Sign 3.0 R11-4 Road Closed Sign (W20-1 Road Work Ahead 6.0 2.0 W20-3 Road Closed Ahead Sign 9.000 18.000 TOTAL 129.500



1. IMPLEMENT MAINTENANCE OF TRAFFIC (M.O.T.) PLAN, AND INSTALL SOIL EROSION AND SEDIMENTATION

2. CONDUCT REMOVAL WORK RELATED TO PAVEMENT, DRAINAGE, AND CONCRETE ITEMS WITH EXCEPTION TO

3. INSTALL PROPOSED DRAINAGE STRUCTURES, STORM SEWER, AND UNDERDRAIN AS REQUIRED.

4. PERFORM ALL CONCRETE WORK, INCLUDING RESTORATION, AS REQUIRED.

5. TEMPORARY LOWER ALL STRUCTURE COVERS LOCATED WITHIN THE EXISTING PAVEMENT, INCLUDING GATE

6. REMOVE 4.0 INCHES OF EXISTING HMA SURFACE BY COLDMILLING. THIS MAY INCLUDE GRANULAR BASE MATERIAL, DEPTH TO BE DETERMINED BY THE ENGINEER. PROOF ROLL WITH FULLY LOADED TRUCK.

7. PERFORM ALL JOINT AND CRACK CLEANOUT, HMA/HAND PATCHING, UNDERCUTS AND/OR BASE REPAIRS AS

8. GRADE, SHAPE, AND COMPACT THE EXISTING BASE MATERIAL AS DIRECTED.

9. CLEAN PAVEMENT AS REQUIRED, AND PLACE 2.0 INCH LEVELING COURSE HMA MIX (LOCAL STREETS).

10. ADJUST ALL STRUCTURE COVERS, INCLUDING GATE AND MONUMENT BOXES, TO THEIR FINISHED ELEVATIONS

11. CLEAN PAVEMENT AND PLACE 2.0 INCH TOP COURSE HMA MIX (LOCAL STREETS).


13. COMPLETE ALL MISCELLANEOUS CONSTRUCTION INCLUDING ALL CLEAN UP AND FINAL RESTORATION.


FOR PROTECTION OF UNDERGROUND UTILITIES AND IN CONFORMANCE WITH PUBLIC ACT 2013, THE CONTRACTOR SHALL CALL 811 OR 1-800-482-7171 A MINIMUM OF FULL WORKING DAYS, EXCLUDING SATURDAYS, SUNDAYS, AND HOLIDAYS, PRIOR SINNING EACH EXCAVATION IN AREAS WHERE PUBLIC UTILITIES HAVE NOT BEEN JSLY LOCATED. MEMBERS WILL THUS BE ROUTINELY NOTIFIED. THIS DOES NOT THE CONTRACTOR OF THE RESPONSIBILITY OF NOTIFYING UTILITY OWNERS AY NOT BE A PART OF THE "MISS DIG" ALERT SYSTEM.

IDERGROUND LOCATIONS SHOWN FOR NATURAL GAS, TELEPHONE, ELECTRICAL CABLE TV AND FIBER OPTIC LINES ARE APPROXIMATE. THE CITY OF ANN ASSUMES NO RESPONSIBILITY FOR THEIR ACCURATE REPRESENTATION IN THIS G. MISS DIG MUST BE CONTACTED PRIOR TO CONSTRUCTION TO LOCATE THESE



IL PROJECT MANAGEMENT - PUBLIC SE	ENT - PUBLIC SERVICES - CITY OF ANN ARBOR
T No.	PROJECT DESCRIPTION ANNUAL STREET RESURFACING - 2017
DRAWING No. 2017004-4	3RD STREET

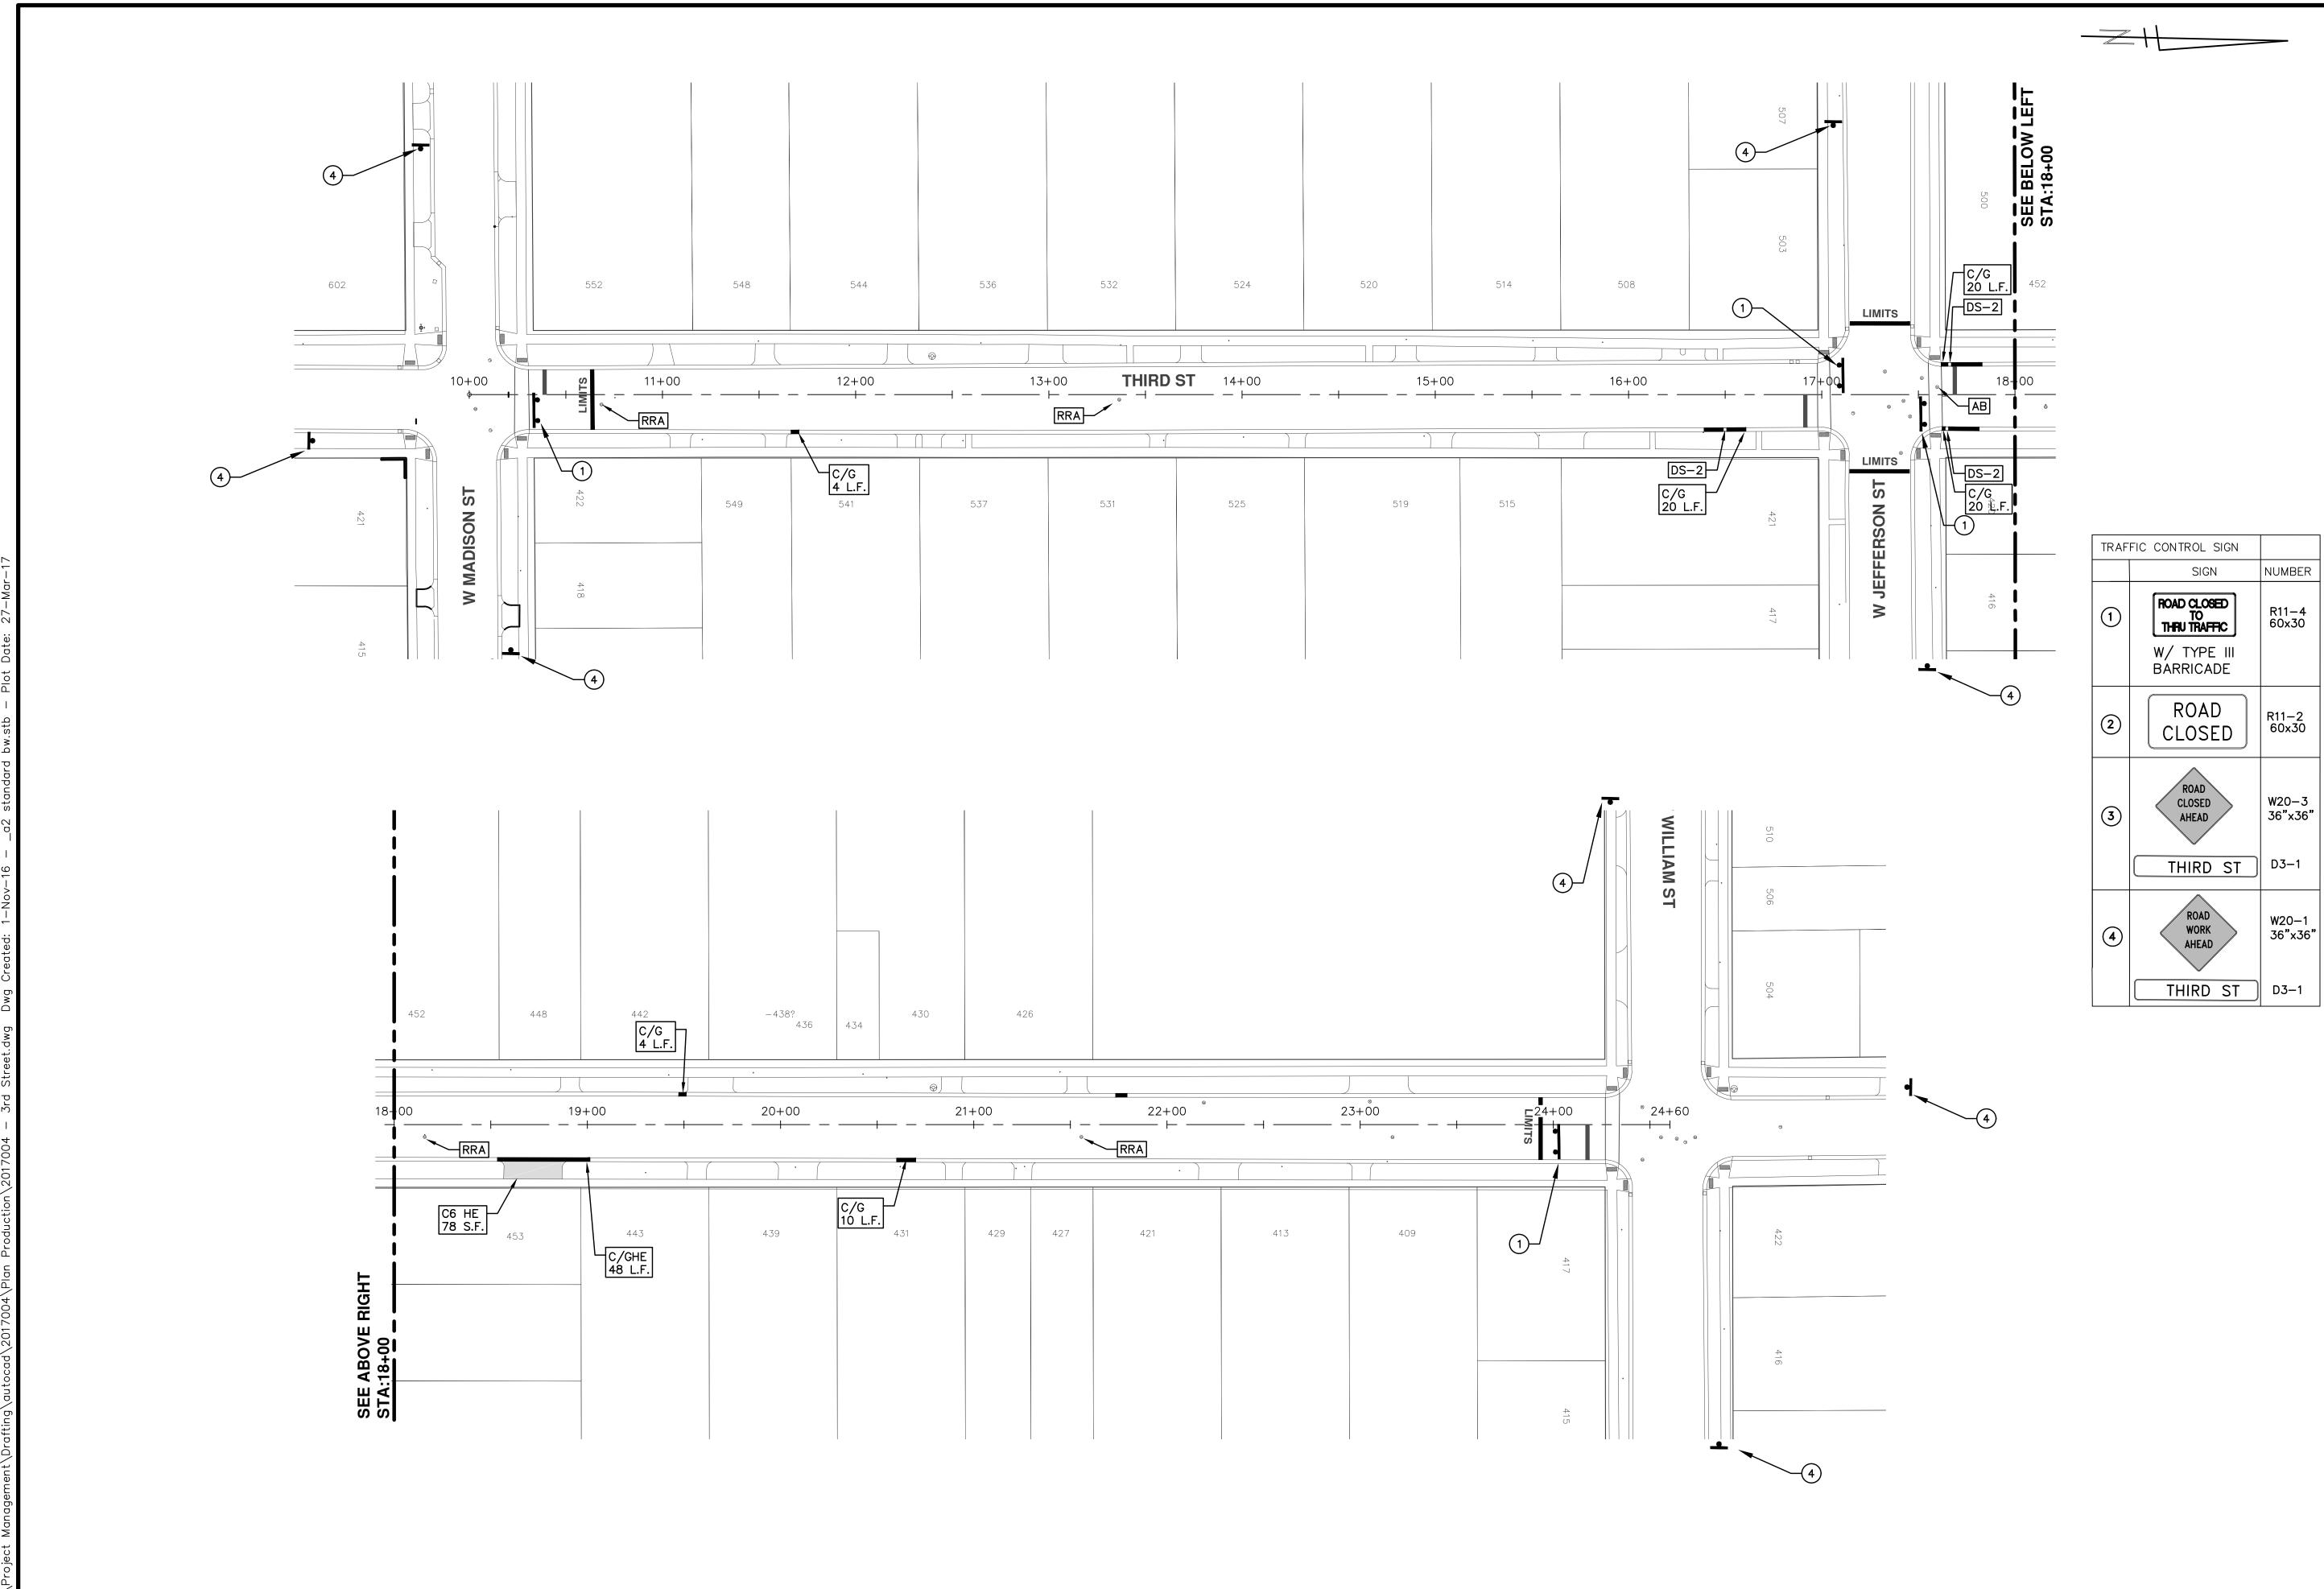

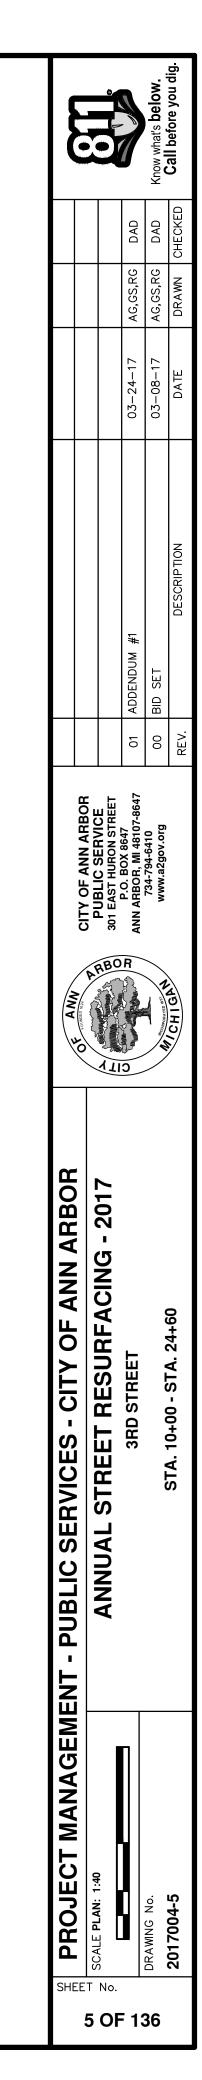



PROJECT LOCATION: 4TH STREET

QUANTITIES				
Item Code	Item Description	Units	Quantity	
2030011	Dr Structure, Rem	Ea	2.000	
2030015	Sewer, Rem, Less than 24 inch	Ft	20.000	
2047001	_Curb, Gutter, and Curb and Gutter, Any Type, Rem	Ft	170.000	
2047011	_Sidewalk, Sidewalk Ramp, and Driveway Approach, Any Thickness, Rem	Syd	13.000	
2057011	_Machine Grading, Special	Syd	4,575.000	
2057021	_Subgrade Undercutting, Type IIA	Cyd	458.000	
2080020	Erosion Control, Inlet Protection, Fabric Drop	Ea	7.000	
4020987	Sewer, CI IV, 12 inch, Tr Det B	Ft	20.000	
4030200	Dr Structure, 24 inch dia	Ea	2.000	
4037050	_Dr Structure Cover, Type B, Modified	Ea	8.000	
4037050	_Dr Structure Cover, Type K, Modified	Ea	2.000	
4037050	_Dr Structure, Adj, Case 1, Modified	Ea	11.000	
4037050	_Dr Structure, Temp Lowering, Modified	Ea	10.000	
5010003	Cold Milling HMA Surface	Ton	1,034.000	
5010005	HMA Surface, Rem	Syd	100.550	
5010703	HMA, LVSP	Ton	1,034.000	
5017031	_HMA, Wedging, 36A	Ton	8.000	
6027021	_Flowable Fill	Cyd	6.296	
6030005	Cement	Ton	1.000	
8017011	_Driveway, Nonreinf Conc, 8 inch, Modified	Syd	16.000	
8027001	_Curb and Gutter, Conc	Ft	145.000	
8027001	_Driveway Opening, Conc, Det M, Modified	Ft	33.000	
8117001	_Pavt Mrkg, Wet Retrflec, Thermopl, 6 inch, Crosswalk	Ft	140.000	
8117001	_Pavt Mrkg, Wet Retrflec, Thermopl, 12 inch, Crosswalk	Ft	192.000	
8117001	_Pavt Mrkg, Wet Retrflec, Thermopl, 24 inch, Stop Bar	Ft	32.000	
8117050	_Pavt Mrkg, Wet Retrflec, Thermopl, School	Ea	2.000	
8120012	Barricade, Type III, High Intensity, Double Sided, Lighted, Furn	Ea	4.000	
8120013	Barricade, Type III, High Intensity, Double Sided, Lighted, Oper	Ea	4.000	
8120260	Plastic Drum, High Intensity, Lighted, Furn	Ea	57.000	
8120261	Plastic Drum, High Intensity, Lighted, Oper	Ea	57.000	
8120350	Sign, Type B, Temp, Prismatic, Furn	Sft	129.500	
8120351	Sign, Type B, Temp, Prismatic, Oper	Sft	129.500	
8127050	_No Parking Sign	Ea	41.000	
8167011	_Slope Restoration	Syd	63.000	
8230431	Gate Box, Adj, Case 1	Ea	1.000	

	CONSTRUCTION KEY
KEY	ASSOCIATED PAY ITEM(S)
	_Dr Structure, Adj, Case 1, Modified
AA	• _Dr Structure, Adj, Case 2, Modified
	 _Dr Structure, Temp Lowering, Modified
	 _Dr Structure, Temp Lowering, Modified
AB	• _Gate Box, Adj, Case 1
110	• _Gate Box, Adj, Case 2
	Monument Box Adjust
ADST	_Dr Structure, Adj, Add Depth, Modified
AK	• _Dr Structure, Adj, Case 1, Modified
C1	 _Sidewalk, Sidewalk Ramp, and Driveway Approach, Any Thickness, Rem Crading, Sidewalk
C4	Grading, Sidewalk Sidewalk Cane 4 inch Medified
	 _Sidewalk, Conc, 4 inch, Modified _Sidewalk, Sidewalk Ramp, and Driveway Approach, Any Thickness, Rem
. =	 Grading, Sidewalk Grading, Sidewalk
C4HE	Cement
	_Sidewalk, Conc, 4 inch, Modified
	 Sidewalk, Sidewalk Ramp, and Driveway Approach, Any Thickness, Ren
	• _Grading, Sidewalk
C6	• _Grading, Sidewalk Ramp
00	Detectable Warning Surface, Modified
	 _Sidewalk Ramp, Conc, 6 inch, Modified
	 _Sidewalk, Conc, 6 inch, Modified
C8	 _Grading, Driveway Approach
	Driveway, Nonreinf Conc, 8 inch, Modified
	 _Sidewalk, Sidewalk Ramp, and Driveway Approach, Any Thickness, Ren Oradian, Driveway Approach, Any Thickness, Ren
	Grading, Driveway Approach Grading, Sidewalk
C HE	Grading, Sidewalk Grading, Sidewalk Pamp
	_Grading, Sidewalk Ramp Coment
	 Cement _Driveway, Nonreinf Conc, 6 inch, Modified
	 _Driveway, Nonreinf Conc, 8 inch, Modified _Driveway, Nonreinf Conc, 8 inch, Modified
	Detectable Warning Surface, Modified
	_Sidewalk, Conc, 6 inch, Modified
010	Curb, Gutter, and Curb and Gutter, Any Type, Rem
C/G	• _Curb and Gutter, Conc
	_Curb, Gutter, and Curb and Gutter, Any Type, Rem
/GHE	• Cement
	 _Driveway Opening, Conc, Det M, Modified
CP	_Grading, Sidewalk
	 _Sidewalk, Conc, 4 inch, Modified
CR	 _Sidewalk, Sidewalk Ramp, and Driveway Approach, Any Thickness, Ren
DC	Dr Structure, Rem
DS	Sewer, Rem, Less than 24 inch Dr Structure, 24 inch die
	Dr Structure, 24 inch dia
	 Dr Structure, Rem Sewer, Rem, Less than 24 inch
DSDI	Sewer, Rem, Less than 24 Inch _Dr Structure, Double Inlet
PT	_Dr Structure, Point
	Dr Structure, Point Dr Structure Cover, Type B
	_Dr Structure Cover, Type B, Special
RRA	_Dr Structure, Adj, Case 1, Modified
	_Dr Structure, Temp Lowering, Modified
	Dr Structure Cover, Type K
RRK	_Dr Structure, Adj, Case 1, Modified
RS	Dr Structure, Reconstruct
	Plastic Drum, High Intensity, Lighted, Furn
/PE II	 Plastic Drum, High Intensity, Lighted, Oper
PE II	Plastic Drum, High Intensity, Lighted, Oper Barricade, Type III, High Intensity, Double Sided, Lighted, Furn

ITB No. 4477 FILE No. 2017-004

LEGEND				
SYMBOL	DESCRIPTION			
\$	EXISTING SANITARY SEWER MANHOLE			
	EXISTING STORM SEWER MANHOLE			
\otimes	EXISTING WATER MAIN VALVE IN WELL			
+	WATER MAIN GATE VALVE IN BOX			
+ Q+	FIRE HYDRANT			
9	MICHCON GAS CO. VALVE BOX/WELL			
t	AMERITECH TELEPHONE VAULT			
e	ELECTRIC MANHOLE			
•	SOIL BORING			
	EXISTING STORM SEWER INLET			
٥	MONUMENT BOX			
	REMOVE AND REPLACE CONC. SIDEWALK			
	PLACE CONCRETE SIDEWALK			
	REMOVE & REPLACE CONC. CURB & GUTTER			
	CONSTRUCTION LIMITS			
	6" WRAPPED UNDERDRAIN			
	REMOVE CONCRETE SIDEWALK			
	SUBGRADE UNDERCUT			

CONSTRUCTION METHOD AND SEQUENCING

IN ACCORDANCE WITH THE SCHEDULE OF STREETS WORK ON THIS STREET IS TO OCCUR CONCURRENTLY WITH OSED FOR 5TH STREET AND WEST JEFFERSON STREET. WORK ON EACH LOCATION SIMULTANEOUSLY WITH EXCEPTION TO COLDMILLING AND LEVELING COURSE PAVING ACTIVITIES, WHICH TOGETHER COMPLETED SEQUENTIALLY STREET BY STREET. WORK ON THIS STREET INCLUDES. LIMITED TO, THE FOLLOWING ITEMS. COMPLETE THE WORK IN ACCORDANCE WITH THE PLANS AND SPECIFICATION: DIRECTED BY THE ENGINEER. PERFORM THE WORK IN THE ORDER INDICATED BELOW UNLESS OR DIRECTED BY THE ENGINEER

- CONTROL MEASURES.
- COLDMILLING.
- AND MONUMENT BOXES AS REQUIRED.
- REQUIRED.

- AS REQUIRED.

NOTES:

FOR	
174	
THR	E
ТО	E
PRE	V
RELI	E
WHO	

THE UNDERGROUND LOCATIONS SHOWN FOR NATURAL GAS, TELEPHONE, ELECTRICAL POWER, CABLE TV AND FIBER OPTIC LINES ARE APPROXIMATE. THE CITY OF ANN ARBOR ASSUMES NO RESPONSIBILITY FOR THEIR ACCURATE REPRESENTATION IN THIS DRAWING. MISS DIG MUST BE CONTACTED PRIOR TO CONSTRUCTION TO LOCATE THESE UTILITIES.

		QUANTITIES		
		Sign, Type B, Temp, Prismatic		
Quantity	Sign Code	Description	Area (sft)	Total Area
5.0	D3-1	Street Name Sign	4.000	20.000
3.0	R11-4	Road Closed Sign ("Road Closed To Thru Traffic")	12.500	37.500
6.0	W20-1	Road Work Ahead Sign	9.000	54.000
2.0	W20-3	Road Closed Ahead Sign	9.000	18.000
			TOTAL	129.500

<u>____</u>

IMPLEMENT MAINTENANCE OF TRAFFIC (M.O.T.) PLAN, AND INSTALL SOIL EROSION AND SEDIMENTATION

2. CONDUCT REMOVAL WORK RELATED TO PAVEMENT, DRAINAGE, AND CONCRETE ITEMS WITH EXCEPTION

INSTALL PROPOSED DRAINAGE STRUCTURES, STORM SEWER, AND UNDERDRAIN AS REQUIRED.

4. PERFORM ALL CONCRETE WORK, INCLUDING RESTORATION, AS REQUIRED.

5. TEMPORARY LOWER ALL STRUCTURE COVERS LOCATED WITHIN THE EXISTING PAVEMENT, INCLUDING GATE

6. REMOVE 4.0 INCHES OF EXISTING HMA SURFACE BY COLDMILLING. THIS MAY INCLUDE GRANULAR BASE MATERIAL, DEPTH TO BE DETERMINED BY THE ENGINEER. PROOF ROLL WITH FULLY LOADED TRUCK.

7. PERFORM ALL JOINT AND CRACK CLEANOUT, HMA/HAND PATCHING, UNDERCUTS AND/OR BASE REPAIRS AS

8. GRADE, SHAPE, AND COMPACT THE EXISTING BASE MATERIAL AS DIRECTED.

9. CLEAN PAVEMENT AS REQUIRED, AND PLACE 2.0 INCH LEVELING COURSE HMA MIX (LOCAL STREETS).

10. ADJUST ALL STRUCTURE COVERS, INCLUDING GATE AND MONUMENT BOXES, TO THEIR FINISHED ELEVATIONS

11. CLEAN PAVEMENT AND PLACE 2.0 INCH TOP COURSE HMA MIX (LOCAL STREETS).

12. CLEAN PAVEMENT AND COMPLETE ALL PAVEMENT MARKINGS.

13. COMPLETE ALL MISCELLANEOUS CONSTRUCTION INCLUDING ALL CLEAN UP AND FINAL RESTORATION.


14. REMOVE ALL TRAFFIC CONTROL DEVICES, AND MISS DIG FLAGS.

PROTECTION OF UNDERGROUND UTILITIES AND IN CONFORMANCE WITH PUBLIC ACT OF 2013, THE CONTRACTOR SHALL CALL 811 OR 1-800-482-7171 A MINIMUM OF EE FULL WORKING DAYS, EXCLUDING SATURDAYS, SUNDAYS, AND HOLIDAYS, PRIOR BEGINNING EACH EXCAVATION IN AREAS WHERE PUBLIC UTILITIES HAVE NOT BEEN VIOUSLY LOCATED. MEMBERS WILL THUS BE ROUTINELY NOTIFIED. THIS DOES NOT EVE THE CONTRACTOR OF THE RESPONSIBILITY OF NOTIFYING UTILITY OWNERS MAY NOT BE A PART OF THE "MISS DIG" ALERT SYSTEM.

THE IMPROVEMENTS COVERED BY THESE PLANS SHALL BE PERFORMED IN ACCORDANCE WITH MICHIGAN DEPARTMENT OF TRANSPORTATION (MDOT) 2012 STANDARD SPECIFICATIONS FOR CONSTRUCTION, INCLUDING REFERENCED MDOT PUBLICATIONS, AND THE PROJECT CONTRACT DOCUMENTS.



NT - PUBLIC SERVICES - CITY OF ANN ARBOR	PROJECT DESCRIPTION ANNUAL STREET RESURFACING - 2017	4TH STREET	
		DRAWING No.	2017004-6

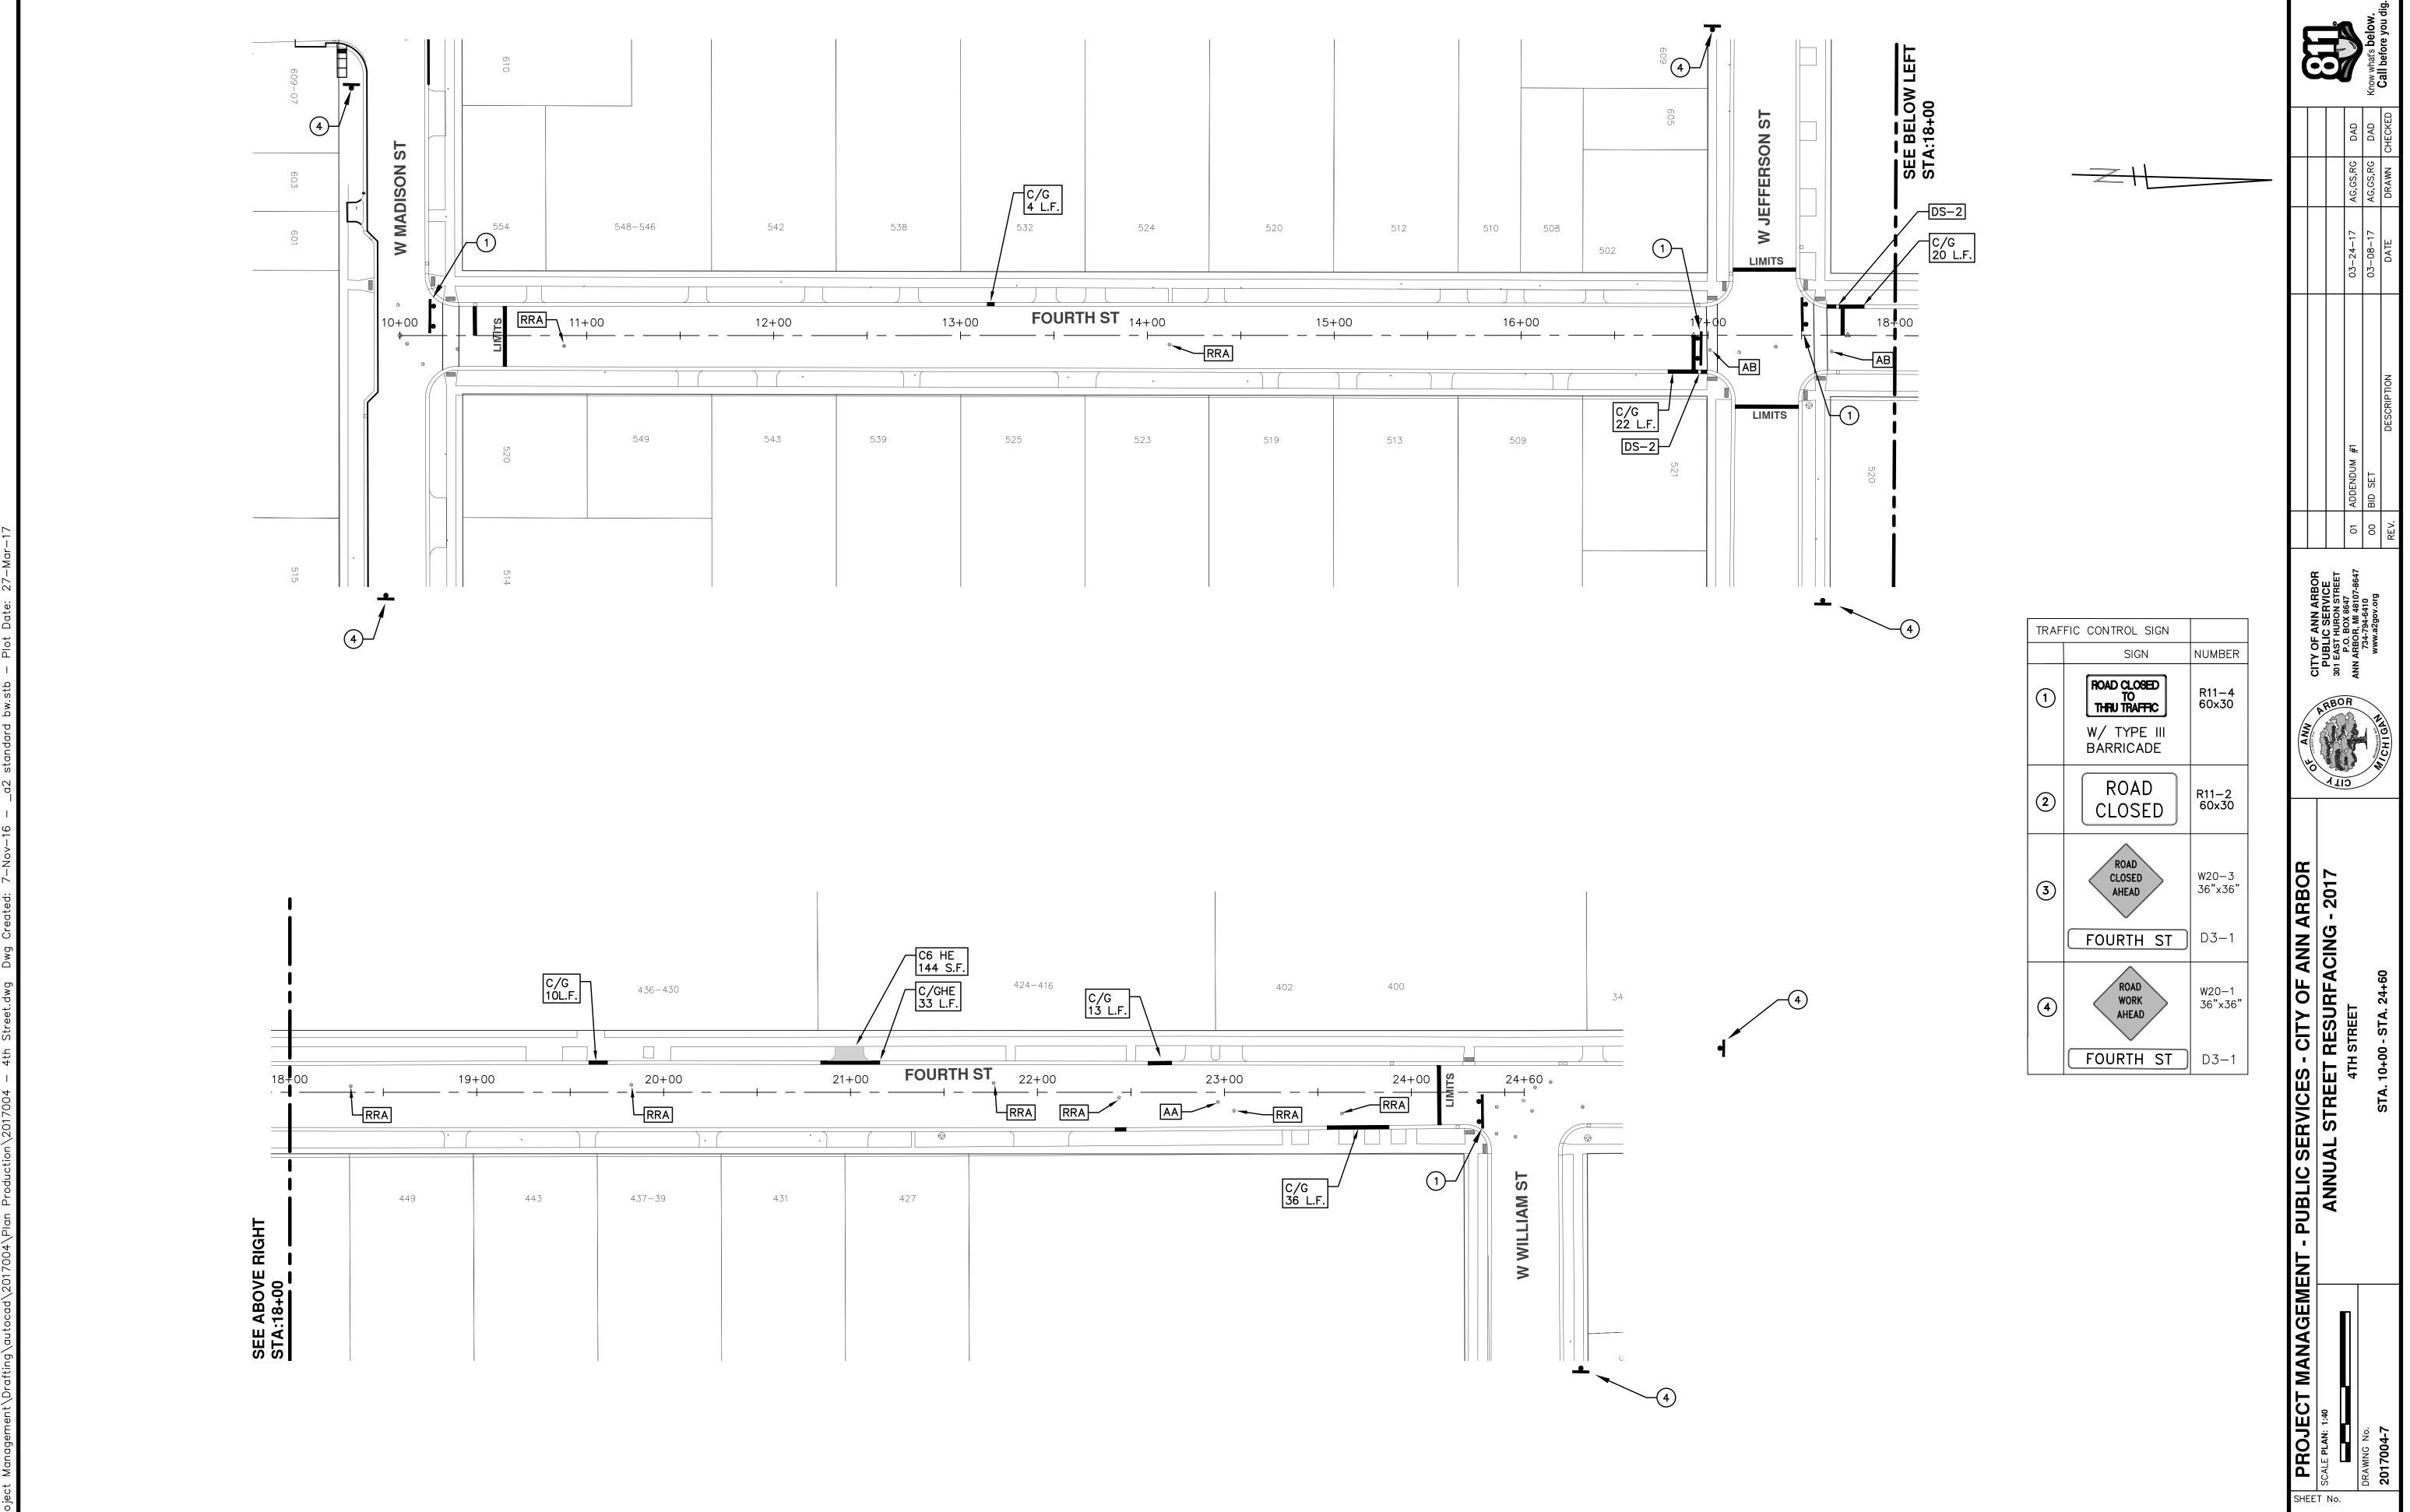

7 OF 136



CITY OF ANN ARBOR PROJECT MANAGEMENT PROJECT LOCATION: 5TH STREET - W HOOVER AVE TO W DAVIS AVE

QUANTITIES				
Item Code	Item Description	Units	Quantity	
2030011	Dr Structure, Rem	Ea	1.000	
2030015	Sewer, Rem, Less than 24 inch	Ft	10.000	
2047001	_Curb, Gutter, and Curb and Gutter, Any Type, Rem	Ft	79.500	
2047011	_Sidewalk, Sidewalk Ramp, and Driveway Approach, Any Thickness, Rem	Syd	29.000	
2057011	_Grading, Driveway Approach	Syd	28.000	
2057011	_Machine Grading, Special	Syd	1,311.000	
2057021	_Subgrade Undercutting, Type IIA	Cyd	121.000	
2080020	Erosion Control, Inlet Protection, Fabric Drop	Ea	3.000	
4020987	Sewer, CI IV, 12 inch, Tr Det B	Ft	10.000	
4030200	Dr Structure, 24 inch dia	Ea	1.000	
4037050	_Dr Structure Cover, Type K, Modified	Ea	1.000	
4037050	_Dr Structure, Adj, Case 1, Modified	Ea	3.000	
4037050	_Dr Structure, Temp Lowering, Modified	Ea	2.000	
5010003	Cold Milling HMA Surface	Ton	297.000	
5010005	HMA Surface, Rem	Syd	58.100	
5010703	HMA, LVSP	Ton	297.000	
5017031	_HMA, Wedging, 36A	Ton	8.000	
6027021	_Flowable Fill	Cyd	2.944	
6030005	Cement	Ton	2.000	
8017011	_Driveway, Nonreinf Conc, 6 inch, Modified	Syd	28.000	
8027001	_Curb and Gutter, Conc	Ft	31.000	
8027001	_Driveway Opening, Conc, Det M, Modified	Ft	48.500	
8117001	_Pavt Mrkg, Wet Retrflec, Thermopl, 6 inch, Crosswalk	Ft	70.000	
8117001	_Pavt Mrkg, Wet Retrflec, Thermopl, 24 inch, Stop Bar	Ft	16.000	
8120012	Barricade, Type III, High Intensity, Double Sided, Lighted, Furn	Ea	2.000	
8120013	Barricade, Type III, High Intensity, Double Sided, Lighted, Oper	Ea	2.000	
8120260	Plastic Drum, High Intensity, Lighted, Furn	Ea	14.000	
8120261	Plastic Drum, High Intensity, Lighted, Oper	Ea	14.000	
8120350	Sign, Type B, Temp, Prismatic, Fum	Sft	90.000	
8120351	Sign, Type B, Temp, Prismatic, Oper	Sft	90.000	
8127050	_No Parking Sign	Ea	13.000	
8167011	_Slope Restoration	Syd	30.000	
8230431	Gate Box, Adj, Case 1	Ea	1.000	

Y	CONSTRUCTION KEY ASSOCIATED PAY ITEM(S)			LEGEND	١.		IENT MAINTE OL MEASUR	
	_Dr Structure, Adj, Case 1, Modified	SYN	MBOL	DESCRIPTION				
	_Dr Structure, Adj, Case 2, Modified		S	EXISTING SANITARY SEWER MANHOLE	2.		CT REMOVA	L WORK
	_Dr Structure, Temp Lowering, Modified Dr Structure, Temp Lowering, Modified		-					
				EXISTING STORM SEWER MANHOLE	3.	INSTAL	L PROPOSE	D DRAINA
	• _Gate Box, Adj, Case 2		\otimes	EXISTING WATER MAIN VALVE IN WELL	4.	PERFO	RM ALL CON	NCRETE V
-	Monument Box Adjust		+	WATER MAIN GATE VALVE IN BOX				
	 _Dr Structure, Adj, Add Depth, Modified Dr Structure, Adj, Case 1, Modified 		+Q+	FIRE HYDRANT	5.		RARY LOWE ONUMENT B	
	• Sidewalk, Sidewalk Ramp, and Driveway Approach, Any Thickness, Rem		+				UNUMENT D	JUNES AS
	 _Grading, Sidewalk _Sidewalk, Conc, 4 inch, Modified 		<i>(g</i>)	MICHCON GAS CO. VALVE BOX/WELL	6.		E 4.0 INCH	
			(t)	AMERITECH TELEPHONE VAULT		MAIER	IAL. DEPTH	TO BE D
	Grading, Sidewalk		e	ELECTRIC MANHOLE	7.	PERFO	RM ALL JOII	NT AND
	Cement Sidowelk, Cape, 4 inch. Medified			SOIL BORING		REQUIR		
	 _Sidewalk, Conc, 4 inch, Modified _Sidewalk, Sidewalk Ramp, and Driveway Approach, Any Thickness, Rem 		-		8		, SHAPE, AI	
	• _Grading, Sidewalk			EXISTING STORM SEWER INLET	0.	GINADE,	, SHAFL, AI	IND COIVIE
	• _Grading, Sidewalk Ramp		•	MONUMENT BOX	9.	CLEAN	PAVEMENT	AS REQU
	 _Detectable Warning Surface, Modified _Sidewalk Ramp, Conc, 6 inch, Modified 			REMOVE AND REPLACE CONC. SIDEWALK	10			
	_Sidewalk, Conc, 6 inch, Modified			NEMOVE AND NEFEACE CONC. SIDEWALK	10.		T ALL STRU QUIRED.	CIURE C
	• _Grading, Driveway Approach			PLACE CONCRETE SIDEWALK				
	 _Driveway, Nonreinf Conc, 8 inch, Modified _Sidewalk, Sidewalk Ramp, and Driveway Approach, Any Thickness, Rem 				11.	CLEAN	PAVEMENT	AND PL
	_Grading, Driveway Approach	_		REMOVE & REPLACE CONC. CURB & GUTTER	12		PAVEMENT	AND CO
	• _Grading, Sidewalk			CONSTRUCTION LIMITS				
	 _Grading, Sidewalk Ramp Cement 		- •	6" WRAPPED UNDERDRAIN	13.	COMPL	ETE ALL MI	SCELLANE
	_Driveway, Nonreinf Conc, 6 inch, Modified			REMOVE CONCRETE SIDEWALK	14.	REMOV	E ALL TRAF	FIC CON
	 _Driveway, Nonreinf Conc, 8 inch, Modified 							
	 _Detectable Warning Surface, Modified _Sidewalk Ramp, Conc, 6 inch, Modified 			SUBGRADE UNDERCUT				
	_Sidewalk, Conc, 6 inch, Modified							
	• _Curb, Gutter, and Curb and Gutter, Any Type, Rem							
	 _Curb and Gutter, Conc Curb, Gutter, and Curb and Gutter, Any Type, Rem 							
Ξ	Cement							
	Driveway Opening, Conc, Det M, Modified							
	_Grading, Sidewalk Sidewalk Case 4 inch. Medified							
	 _Sidewalk, Conc, 4 inch, Modified Sidewalk, Sidewalk Ramp, and Driveway Approach, Any Thickness, Rem 			QUANTITIES				
	Dr Structure, Rem			Sign, Type B, Temp, Prismatic				
	• Sewer, Rem, Less than 24 inch						Total	
	Dr Structure, 24 inch dia Dr Structure, Rem	Quantity	Sign Cod	le Description	· · · · · · · · · · · · · · · · · · ·	Area (sft)	Area	
	Sewer, Rem, Less than 24 inch	5.0	D3-1	Street Name Sign		4.000	20.000	
	_Dr Structure, Double Inlet	2.0	R11-4	Road Closed Sign ("Road Closed To Thru Traffic")		12.500	25.000	
	_Dr Structure, Point	3.0	W20-1	Road Work Ahead Sign		9.000	27.000	
	Dr Structure Cover, Type B _Dr Structure Cover, Type B, Special	2.0	W20-3	Road Closed Ahead Sign		9.000	18.000	
	• _Dr Structure, Adj, Case 1, Modified					TOTAL	90.000	
_	_Dr Structure, Temp Lowering, Modified							
_	Dr Structure Cover, Type K							
	_Dr Structure, Adj, Case 1, Modified Dr Structure, Reconstruct							
	 Plastic Drum, High Intensity, Lighted, Furn Plastic Drum, High Intensity, Lighted, Oper 							

ITB No. 4477 FILE No. 2017-004

	LEGEND
SYMBOL	DESCRIPTION
S	EXISTING SANITARY SEWER MANHOLE
(r)	EXISTING STORM SEWER MANHOLE
\otimes	EXISTING WATER MAIN VALVE IN WELL
+	WATER MAIN GATE VALVE IN BOX
+Ŷ+	FIRE HYDRANT
(g)	MICHCON GAS CO. VALVE BOX/WELL
t	AMERITECH TELEPHONE VAULT
e	ELECTRIC MANHOLE
igodol	SOIL BORING
	EXISTING STORM SEWER INLET
٥	MONUMENT BOX
	REMOVE AND REPLACE CONC. SIDEWALK
	PLACE CONCRETE SIDEWALK
	REMOVE & REPLACE CONC. CURB & GUTTER
	CONSTRUCTION LIMITS
<u> </u>	6" WRAPPED UNDERDRAIN
	REMOVE CONCRETE SIDEWALK
	SUBGRADE UNDERCUT

CONSTRUCTION METHOD AND SEQUENCING

- AFFIC (M.O.T.) PLAN, AND INSTALL SOIL EROSION AND SEDIMENTATION

- JRE COVERS LOCATED WITHIN THE EXISTING PAVEMENT, INCLUDING GATE
- HMA SURFACE BY COLDMILLING. THIS MAY INCLUDE GRANULAR BASE INED BY THE ENGINEER. PROOF ROLL WITH FULLY LOADED TRUCK.
- THE EXISTING BASE MATERIAL AS DIRECTED.
- 2.0 INCH TOP COURSE HMA MIX (LOCAL STREETS).
- E ALL PAVEMENT MARKINGS.
- CONSTRUCTION INCLUDING ALL CLEAN UP AND FINAL RESTORATION.
- DEVICES, AND MISS DIG FLAGS.



- THE SCHEDULE OF STREETS WORK ON THIS STREET IS TO OCCUR CON THAT PROPOSED FOR WEST DAVIS AVENUE AND WILDER PLACE. WORK ON THIS STREE LIMITED TO, THE FOLLOWING ITEMS. COMPLETE THE WORK IN ACCORDANCE WITH AND AS DIRECTED BY THE ENGINEER. PERFORM THE WORK IN THE ORDER INDICA
 - TED TO PAVEMENT, DRAINAGE, AND CONCRETE ITEMS WITH EXCEPTION TO
 - TRUCTURES. STORM SEWER. AND UNDERDRAIN AS REQUIRED.
 - INCLUDING RESTORATION, AS REQUIRED.
 - CLEANOUT, HMA/HAND PATCHING, UNDERCUTS AND/OR BASE REPAIRS AS
 - AND PLACE 2.0 INCH LEVELING COURSE HMA MIX (LOCAL STREETS).
 - INCLUDING GATE AND MONUMENT BOXES, TO THEIR FINISHED ELEVATIONS

TES:


PROTECTION OF UNDERGROUND UTILITIES AND IN CONFORMANCE WITH PUBLIC ACT OF 2013, THE CONTRACTOR SHALL CALL 811 OR 1-800-482-7171 A MINIMUM OF EE FULL WORKING DAYS, EXCLUDING SATURDAYS, SUNDAYS, AND HOLIDAYS, PRIOR BEGINNING EACH EXCAVATION IN AREAS WHERE PUBLIC UTILITIES HAVE NOT BEEN VIOUSLY LOCATED. MEMBERS WILL THUS BE ROUTINELY NOTIFIED. THIS DOES NOT EVE THE CONTRACTOR OF THE RESPONSIBILITY OF NOTIFYING UTILITY OWNERS MAY NOT BE A PART OF THE "MISS DIG" ALERT SYSTEM.

UNDERGROUND LOCATIONS SHOWN FOR NATURAL GAS, TELEPHONE, ELECTRICAL ER, CABLE TV AND FIBER OPTIC LINES ARE APPROXIMATE. THE CITY OF ANN OR ASSUMES NO RESPONSIBILITY FOR THEIR ACCURATE REPRESENTATION IN THIS WING. MISS DIG MUST BE CONTACTED PRIOR TO CONSTRUCTION TO LOCATE THESE ITIES.


IMPROVEMENTS COVERED BY THESE PLANS SHALL BE PERFORMED IN ACCORDANCE MICHIGAN DEPARTMENT OF TRANSPORTATION (MDOT) 2012 STANDARD CIFICATIONS FOR CONSTRUCTION, INCLUDING REFERENCED MOOT PUBLICATIONS, AND PROJECT CONTRACT DOCUMENTS.



PROJECT MANAGEMENT - PUBLIC SERVICES - CITY OF ANN ARBOR	PROJECT DESCRIPTION ANNUAL STREET RESURFACING - 2017	5TH STREET - W HOOVER AVE TO W DAVIS AVE
HEE	T No. 3 OF 1	92 DRAWING No. 2017004-8

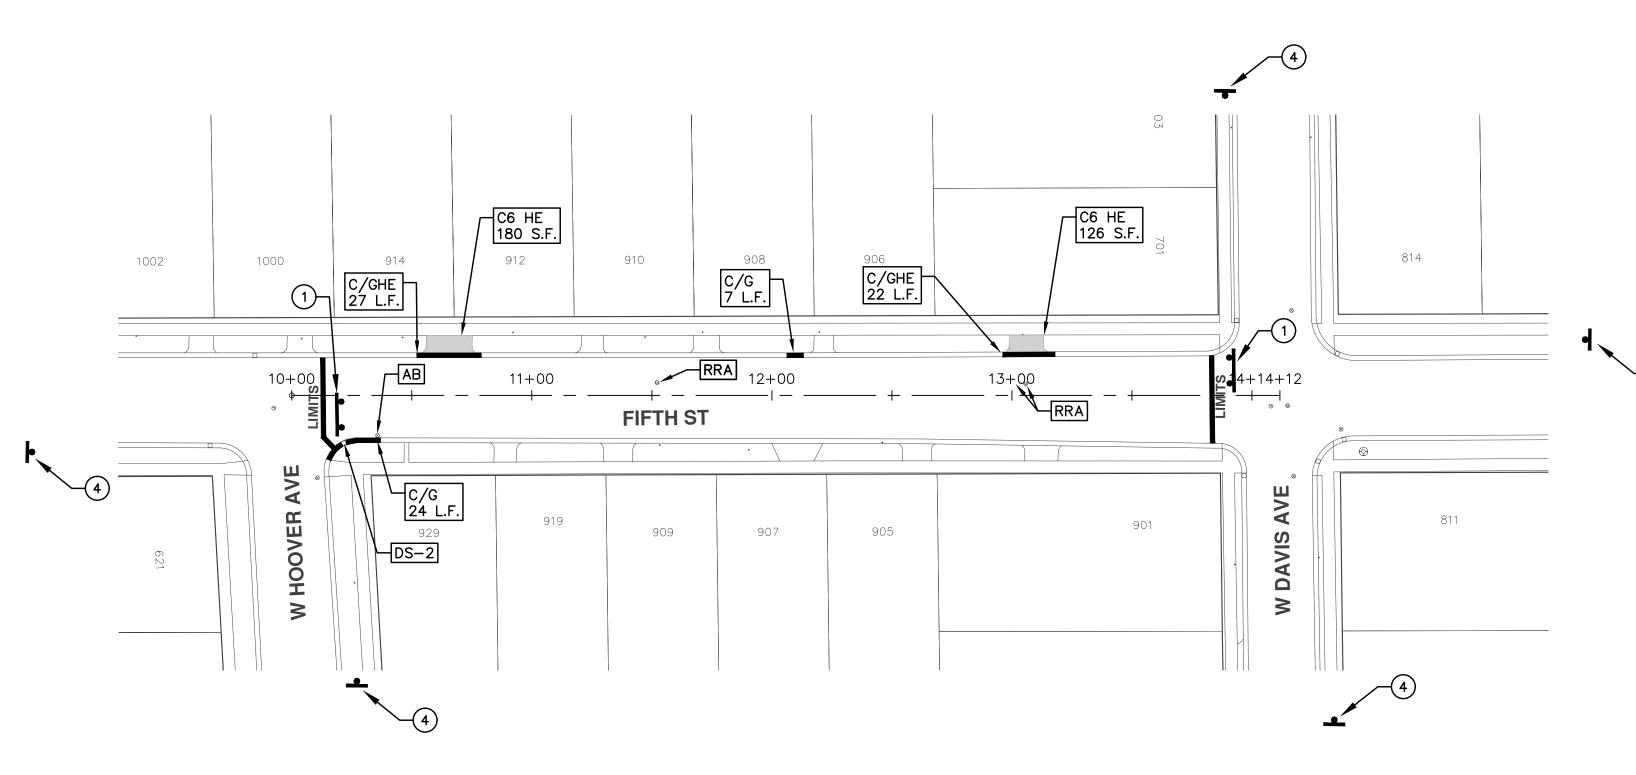

RBOR CE CE 7-8647			M #1 03-24-17 AG,GS,RG DAD	
RBOR OF AW AW 2017 OF AW BLIC SERVICE 2017 DIBLIC SERVICE 301 EAST HURON STREET VE 734-794-6410 734-794-6410				OO BID SET
VT - PUBLIC SERVICES - CITY OF ANN ARBOR ANNUAL STREET RESURFACING - 2017 5TH STREET - W HOOVER AVE TO W DAVIS AVE	OF ANN CITY OF ANN	PUBLIC SEI	D BOX 6 P.O. BOX 6 P.O	734-794-6410
	ERVICES - CITY OF ANN ARBOR			

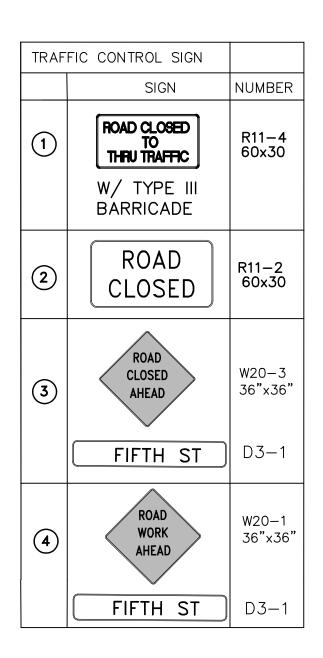



CONSTRU

ltem Code	Item Description	Units	Quantity
2030011	Dr Structure, Rem	Ea	3.00
2030015	Sewer, Rem, Less than 24 inch	Ft	30.0
2047001	_Curb, Gutter, and Curb and Gutter, Any Type, Rem	Ft	244.5
2047011	_Sidewalk, Sidewalk Ramp, and Driveway Approach, Any Thickness, Rem	Syd	139.0
2057011	_Grading, Driveway Approach	Syd	28.0
2057011	_Grading, Sidewalk	Syd	78.6
2057011	_Grading, Sidewalk Ramp	Syd	33.3
2057011	_Machine Grading, Special	Syd	7,895.0
2057021	_Subgrade Undercutting, Type IIA	Cyd	698.0
2080020	Erosion Control, Inlet Protection, Fabric Drop	Ea	5.0
4020987	Sewer, CI IV, 12 inch, Tr Det B	Ft	30.0
4030200	Dr Structure, 24 inch dia	Ea	3.0
4037050	_Dr Structure Cover, Type B, Modified	Ea	9.0
4037050	_Dr Structure Cover, Type K, Modified	Ea	3.0
4037050	_Dr Structure, Adj, Case 1, Modified	Ea	14.0
4037050	_Dr Structure, Temp Lowering, Modified	Ea	11.0
5010003	Cold Milling HMA Surface	Ton	1,785.0
5010005	HMA Surface, Rem	Syd	111.8
5010061	HMA, Approach	Ton	208.0
5010703	HMA, LVSP	Ton	1,577.0
5017031	_HMA, Wedging, 36A	Ton	8.0
6027021	_Flowable Fill	Cyd	9.0
6030005	Cement	Ton	2.0
8017011	_Driveway, Nonreinf Conc, 6 inch, Modified	Syd	28.0
8027001	_Curb and Gutter, Conc	Ft	145.0
8027001	 Driveway Opening, Conc, Det M, Modified	Ft	105.0
8037001	_Detectable Warning Surface, Modified	Ft	20.0
8037010	_Sidewalk Ramp, Conc, 6 inch, Modified	Sft	300.0
8037010		Sft	708.0
8117001	_Pavt Mrkg, Wet Retrflec, Thermopl, 6 inch, Crosswalk	Ft	210.0
8117001	_Pavt Mrkg, Wet Retrflec, Thermopl, 12 inch, Crosswalk	Ft	104.0
8117001	_Pavt Mrkg, Wet Retrflec, Thermopl, 24 inch, Stop Bar	Ft	45.0
8117050	_Pavt Mrkg, Wet Retrflec, Thermopl, School	Ea	2.0
8120012	Barricade, Type III, High Intensity, Double Sided, Lighted, Fum	Ea	7.0
8120013	Barricade, Type III, High Intensity, Double Sided, Lighted, Oper	Ea	7.0
8120260	Plastic Drum, High Intensity, Lighted, Furn	Ea	90.0
8120261	Plastic Drum, High Intensity, Lighted, Oper	Ea	90.0
8120350	Sign, Type B, Temp, Prismatic, Furn	Sft	191.5
8120351	Sign, Type B, Temp, Prismatic, Oper	Sft	191.5
8127050	_No Parking Sign	Ea	60.0
8167011	_Slope Restoration	Syd	90.0

	CONSTRUCTION KEY
KEY	ASSOCIATED PAY ITEM(S)
	_Dr Structure, Adj, Case 1, Modified
AA	 _Dr Structure, Adj, Case 2, Modified
	 _Dr Structure, Temp Lowering, Modified
	_Dr Structure, Temp Lowering, Modified
AB	• _Gate Box, Adj, Case 1
AD	• _Gate Box, Adj, Case 2
	_Monument Box Adjust
ADST	 _Dr Structure, Adj, Add Depth, Modified
AK	 _Dr Structure, Adj, Case 1, Modified
	 _Sidewalk, Sidewalk Ramp, and Driveway Approach, Any Thicking
C4	• _Grading, Sidewalk
	 _Sidewalk, Conc, 4 inch, Modified
	 _Sidewalk, Sidewalk Ramp, and Driveway Approach, Any Thicking
C4HE	_Grading, Sidewalk
OTTL	Cement
	 _Sidewalk, Conc, 4 inch, Modified
	 _Sidewalk, Sidewalk Ramp, and Driveway Approach, Any Thicki
	_Grading, Sidewalk
C6	 _Grading, Sidewalk Ramp
00	 _Detectable Warning Surface, Modified
	 _Sidewalk Ramp, Conc, 6 inch, Modified
	 _Sidewalk, Conc, 6 inch, Modified
C8	 _Grading, Driveway Approach
	Driveway, Nonreinf Conc, 8 inch, Modified
	 Sidewalk, Sidewalk Ramp, and Driveway Approach, Any Thicki
	 _Grading, Driveway Approach
	 _Grading, Sidewalk
	 _Grading, Sidewalk Ramp
C HE	Cement
	 _Driveway, Nonreinf Conc, 6 inch, Modified
	 _Driveway, Nonreinf Conc, 8 inch, Modified
	 _Detectable Warning Surface, Modified
	 _Sidewalk Ramp, Conc, 6 inch, Modified
	_Sidewalk, Conc, 6 inch, Modified
C/G	• _Curb, Gutter, and Curb and Gutter, Any Type, Rem
	_Curb and Gutter, Conc
	• _Curb, Gutter, and Curb and Gutter, Any Type, Rem
C/GHE	• Cement
	Driveway Opening, Conc, Det M, Modified
CP	• _Grading, Sidewalk
	Sidewalk, Conc, 4 inch, Modified
CR	 Sidewalk, Sidewalk Ramp, and Driveway Approach, Any Thicking Structure
D 2	• Dr Structure, Rem
DS	Sewer, Rem, Less than 24 inch
	Dr Structure, 24 inch dia
DOD	Dr Structure, Rem
DSDI	Sewer, Rem, Less than 24 inch
	Dr Structure, Double Inlet
PT	_Dr Structure, Point
	Dr Structure Cover, Type B
RRA	_Dr Structure Cover, Type B, Special
	_Dr Structure, Adj, Case 1, Modified
	_Dr Structure, Temp Lowering, Modified
RRK	Dr Structure Cover, Type K
	_Dr Structure, Adj, Case 1, Modified
RS	_Dr Structure, Reconstruct
TYPE II	Plastic Drum, High Intensity, Lighted, Furn
	Plastic Drum, High Intensity, Lighted, Oper
TYPE III	• Barricade, Type III, High Intensity, Double Sided, Lighted, Furn
	Barricade, Type III, High Intensity, Double Sided, Lighted, Oper

CITY OF ANN ARBOR PROJECT MANAGEMENT

PROJECT LOCATION: 5TH STREET -PRINCETON ST TO W LIBERTY ST

ITB No. 4477 FILE No. 2017-004

CTION KEY	
lified	
lified	
Modified	
Modified	
Modified	
lified	
Driveway Approach, Any Thickness, Rem	
ed	
Driveway Approach, Any Thickness, Rem	
ed	
d Driveway Approach, Any Thickness, Rem	
Nodified	
Modified	
ed	
h, Modified	
Driveway Approach, Any Thickness, Rem	
h, Modified	
h, Modified	
<i>l</i> odified Modified	
ed tter, Any Type, Rem	
tter, Any Type, Rem	
M, Modified	
ed	l r
Driveway Approach, Any Thickness, Rem	
becial	
dified	
Vodified	
lified	
anea	
ghted, Furn	
ghted, Oper	

	LEGEND
SYMBOL	DESCRIPTION
s	EXISTING SANITARY SEWER MANHOLE
()	EXISTING STORM SEWER MANHOLE
\otimes	EXISTING WATER MAIN VALVE IN WELL
+	WATER MAIN GATE VALVE IN BOX
+ Ç +	FIRE HYDRANT
(g)	MICHCON GAS CO. VALVE BOX/WELL
t	AMERITECH TELEPHONE VAULT
e	ELECTRIC MANHOLE
\bullet	SOIL BORING
	EXISTING STORM SEWER INLET
٥	MONUMENT BOX
	REMOVE AND REPLACE CONC. SIDEWALK
	PLACE CONCRETE SIDEWALK
	REMOVE & REPLACE CONC. CURB & GUTTER
	CONSTRUCTION LIMITS
<u> </u>	6" WRAPPED UNDERDRAIN
	REMOVE CONCRETE SIDEWALK
	SUBGRADE UNDERCUT

CONSTRUCTION METHOD AND SEQUENCING

IN ACCORDANCE WITH THE SCHEDULE OF STREETS WORK ON THIS STREET IS TO OCCUR CONCURRENTLY WITH THAT PROPOSED FOR 4TH STREET AND WEST JEFFERSON STREET. WORK ON EACH LOCATION MAY OCCUR SIMULTANEOUSLY WITH EXCEPTION TO COLDMILLING AND LEVELING COURSE PAVING ACTIVITIES. WHICH TOGETHE COMPLETED SEQUENTIALLY STREET BY STREET. WORK ON THIS STREET INCLUDES, BUT IS NOT LIMITED TO. THE FOLLOWING ITEMS. COMPLETE THE WORK IN ACCORDANCE WITH THE PLANS AND SPECIFICATION: AND AS DIRECTED BY THE ENGINEER. PERFORM AUTHORIZED OR DIRECTED BY THE ENGINEER

- CONTROL MEASURES.
- COLDMILLING.
- 4. PERFORM ALL CONCRETE WORK, INCLUDING RESTORATION, AS REQUIRED.
- AND MONUMENT BOXES AS REQUIRED.
- REQUIRED.

- AS REQUIRED.
- 12. CLEAN PAVEMENT AND COMPLETE ALL PAVEMENT MARKINGS.
- 14. REMOVE ALL TRAFFIC CONTROL DEVICES, AND MISS DIG FLAGS.

NOTES:

		QUANTITIES			
Sign, Type B, Temp, Prismatic					
Quantity	Sign Code	Description	Area (sft)	Total Area	
8.0	D3-1	Street Name Sign	4.000	32.000	
7.0	R11-4	Road Closed Sign ("Road Closed To Thru Traffic")	12.500	87.500	
7.0	W20-1	Road Work Ahead Sign	9.000	63.000	
1.0	W20-3	Road Closed Ahead Sign	9.000	9.000	
			TOTAL	191.500	

IMPROVEMENTS COVERED BY THESE PLANS SHALL BE PERFORMED IN ACCORDANCE MICHIGAN DEPARTMENT OF TRANSPORTATION (MDOT) 2012 STANDARD IFICATIONS FOR CONSTRUCTION, INCLUDING REFERENCED MOOT PUBLICATIONS, AND THE PROJECT CONTRACT DOCUMENTS.

1. IMPLEMENT MAINTENANCE OF TRAFFIC (M.O.T.) PLAN, AND INSTALL SOIL EROSION AND SEDIMENTATION

2. CONDUCT REMOVAL WORK RELATED TO PAVEMENT, DRAINAGE, AND CONCRETE ITEMS WITH EXCEPTION TO

3. INSTALL PROPOSED DRAINAGE STRUCTURES, STORM SEWER, AND UNDERDRAIN AS REQUIRED

5. TEMPORARY LOWER ALL STRUCTURE COVERS LOCATED WITHIN THE EXISTING PAVEMENT, INCLUDING GATE

6. REMOVE 4.0 INCHES OF EXISTING HMA SURFACE BY COLDMILLING. THIS MAY INCLUDE GRANULAR BASE MATERIAL. DEPTH TO BE DETERMINED BY THE ENGINEER. PROOF ROLL WITH FULLY LOADED TRUCK.

7. PERFORM ALL JOINT AND CRACK CLEANOUT, HMA/HAND PATCHING, UNDERCUTS AND/OR BASE REPAIRS AS

8. GRADE, SHAPE, AND COMPACT THE EXISTING BASE MATERIAL AS DIRECTED.

9. CLEAN PAVEMENT AS REQUIRED, AND PLACE 2.0 INCH LEVELING COURSE HMA MIX (LOCAL STREETS).

10. ADJUST ALL STRUCTURE COVERS. INCLUDING GATE AND MONUMENT BOXES. TO THEIR FINISHED ELEVATIONS

11. CLEAN PAVEMENT AND PLACE 2.0 INCH TOP COURSE HMA MIX (LOCAL STREETS).

13. COMPLETE ALL MISCELLANEOUS CONSTRUCTION INCLUDING ALL CLEAN UP AND FINAL RESTORATION.


FOR PROTECTION OF UNDERGROUND UTILITIES AND IN CONFORMANCE WITH PUBLIC ACT OF 2013, THE CONTRACTOR SHALL CALL 811 OR 1-800-482-7171 A MINIMUM OF E FULL WORKING DAYS, EXCLUDING SATURDAYS, SUNDAYS, AND HOLIDAYS, PRIOR BEGINNING EACH EXCAVATION IN AREAS WHERE PUBLIC UTILITIES HAVE NOT BEEN VIOUSLY LOCATED. MEMBERS WILL THUS BE ROUTINELY NOTIFIED. THIS DOES NOT EVE THE CONTRACTOR OF THE RESPONSIBILITY OF NOTIFYING UTILITY OWNERS MAY NOT BE A PART OF THE "MISS DIG" ALERT SYSTEM.

UNDERGROUND LOCATIONS SHOWN FOR NATURAL GAS, TELEPHONE, ELECTRICAL R. CABLE TV AND FIBER OPTIC LINES ARE APPROXIMATE. THE CITY OF ANN OR ASSUMES NO RESPONSIBILITY FOR THEIR ACCURATE REPRESENTATION IN THIS WING. MISS DIG MUST BE CONTACTED PRIOR TO CONSTRUCTION TO LOCATE THESE TIES.



	Know what's below	Call before you dig
--	--------------------------	---------------------

▲ 🖻 🎗 HEET NO. 10 OF 136

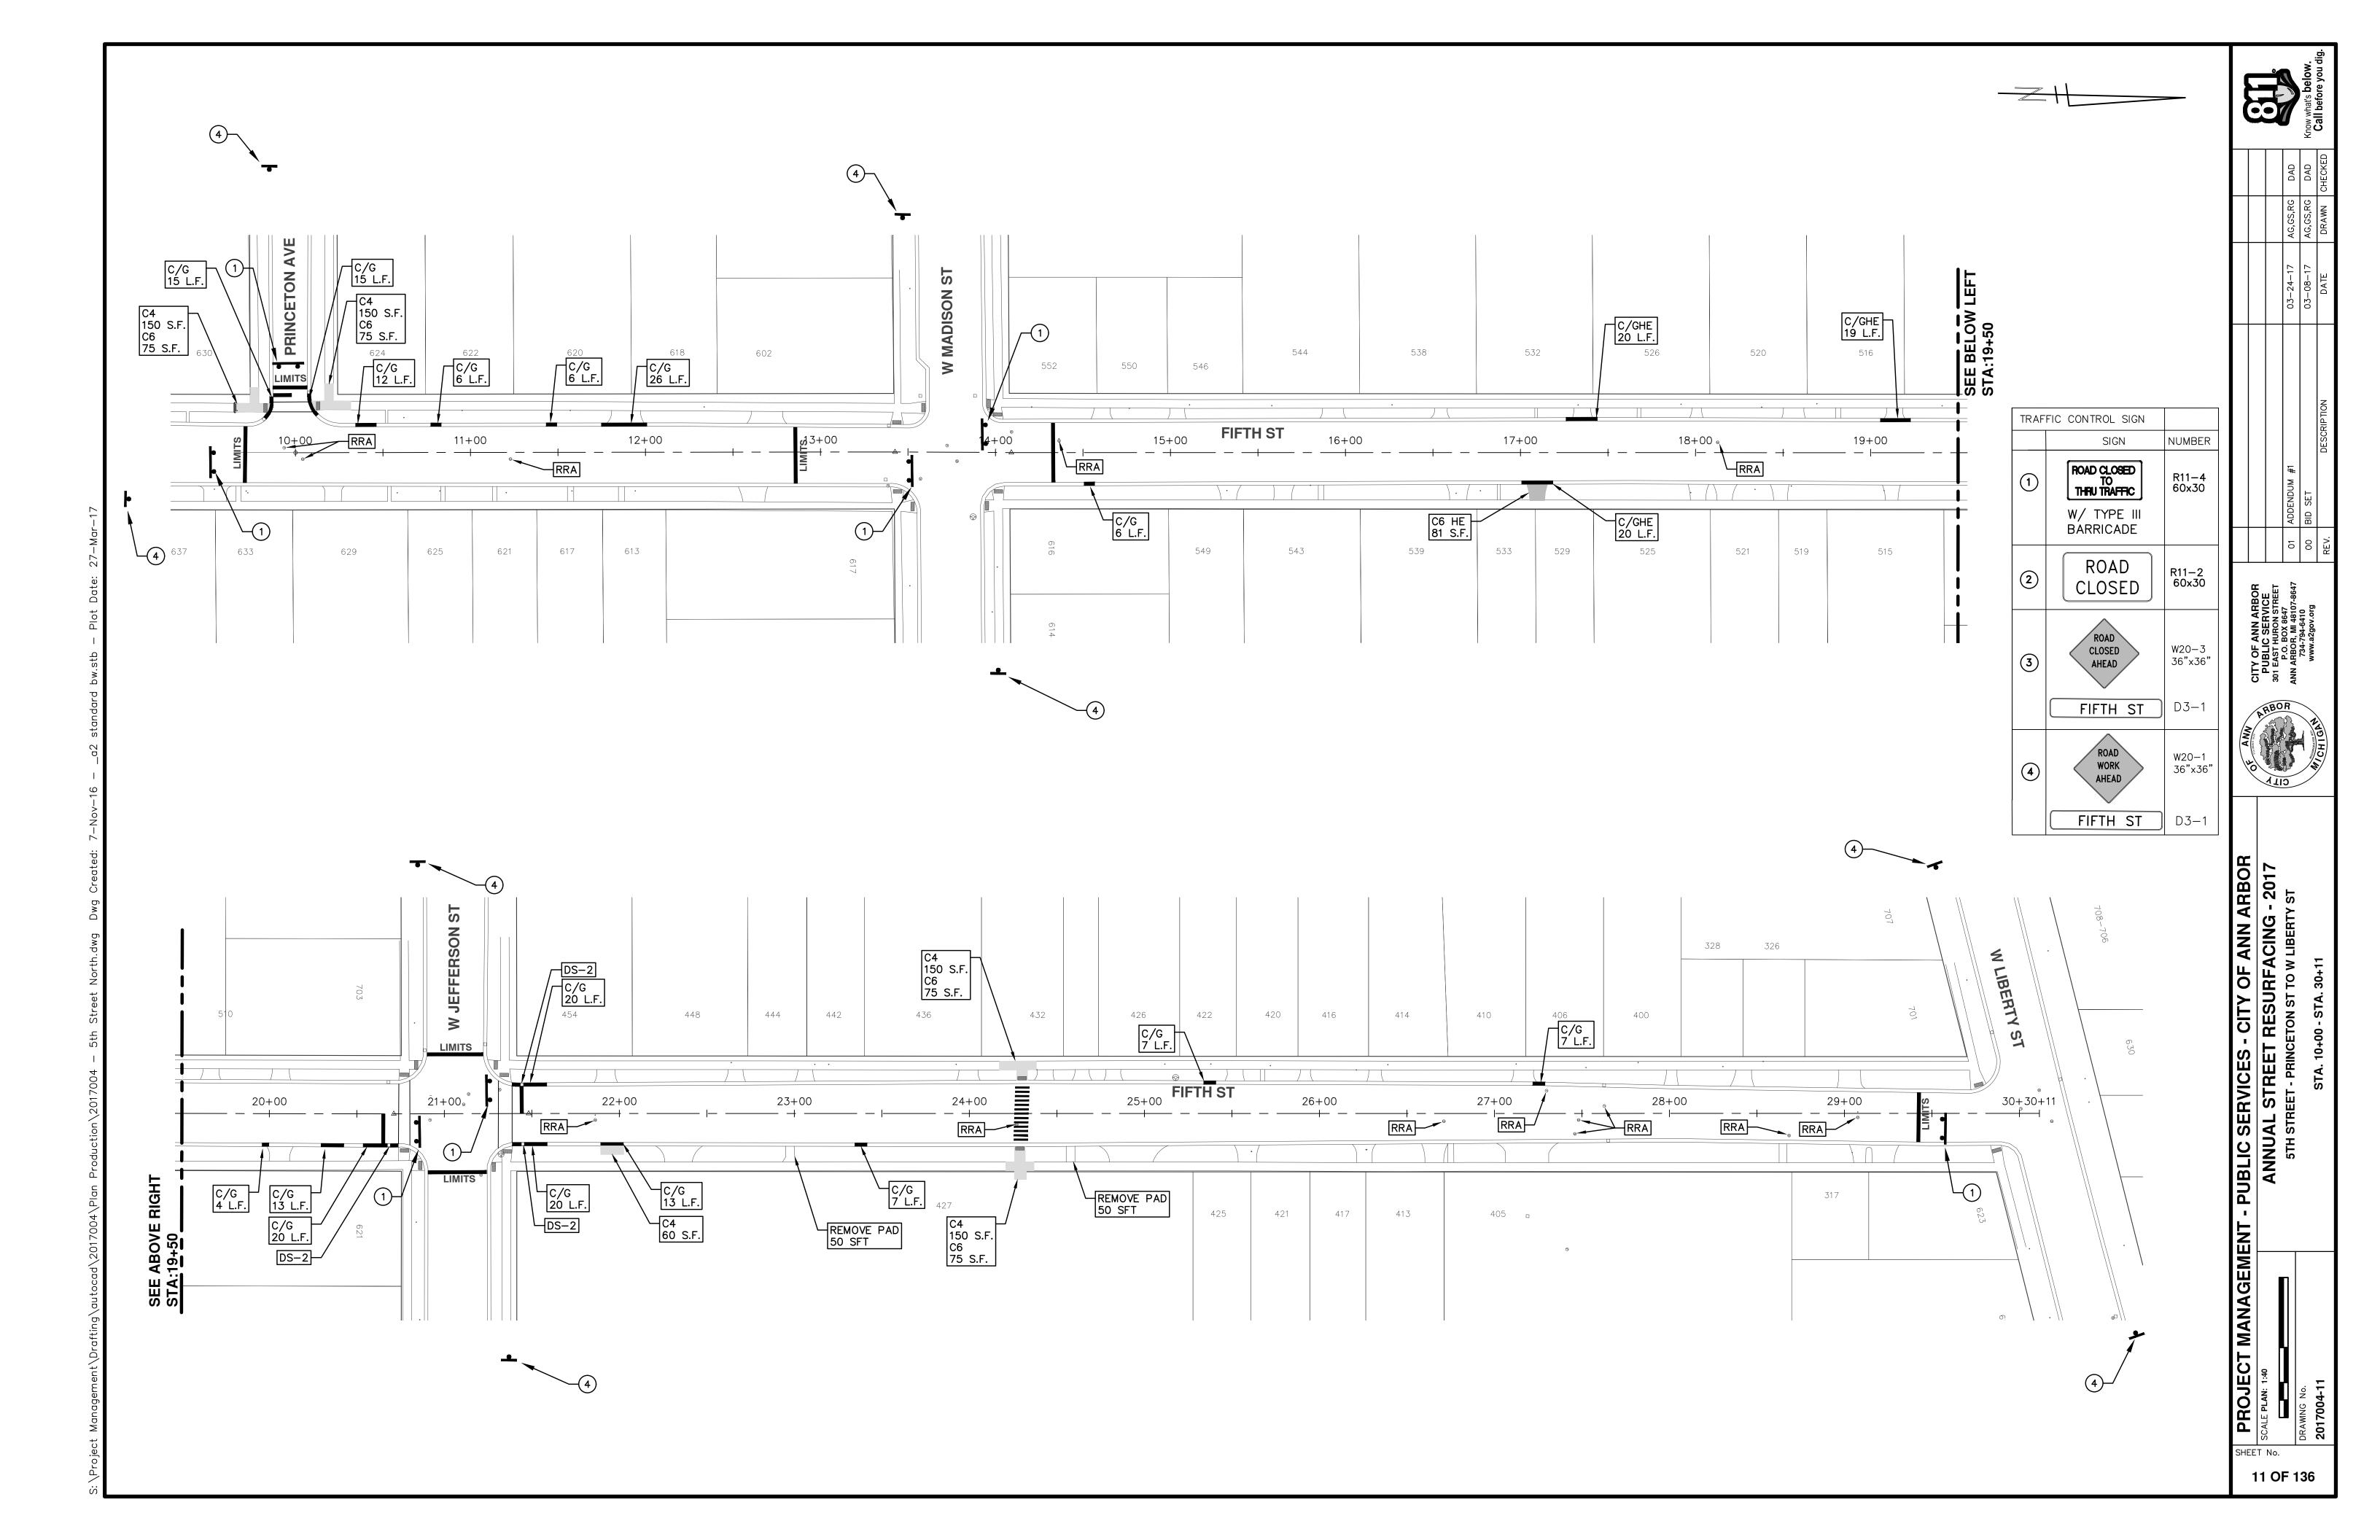



CITY OF ANN ARBOR PROJECT MANAGEMENT **PROJECT LOCATION: 6TH STREET** ITB No. 4477 FILE No. 2017-004

QUANTITIES			
Item Code	Item Description	Units	Quantity
2030011	Dr Structure, Rem	Ea	4.000
2030015	Sewer, Rem, Less than 24 inch	Ft	40.000
2047001	_Curb, Gutter, and Curb and Gutter, Any Type, Rem	Ft	46.000
2047011	_Sidewalk, Sidewalk Ramp, and Driveway Approach, Any Thickness, Rem	Syd	61.000
2057011	_Grading, Driveway Approach	Syd	-34.000
2057011	_Grading, Sidewalk	Syd	34.000
2057011	_Machine Grading, Special	Syd	2,232.000
2057021	_Subgrade Undercutting, Type IIA	Cyd	224.000
2080020	Erosion Control, Inlet Protection, Fabric Drop	Ea	4.000
4020987	Sewer, CI IV, 12 inch, Tr Det B	Ft	40.000
4037050	_Dr Structure Cover, Special	Ea	1.000
4037050	_Dr Structure Cover, Type B, Modified	Ea	1.000
4037050	_Dr Structure Cover, Type K, Modified	Ea	2.000
4037050	_Dr Structure, Adj, Case 1, Modified	Ea	3.000
4037050	_Dr Structure, Double Inlet	Ea	2.000
4037050	_Dr Structure, Temp Lowering, Modified	Ea	2.000
5010003	Cold Milling HMA Surface	Ton	505.000
5010703	HMA, LVSP	Ton	505.000
5017031	_HMA, Wedging, 36A	Ton	8.000
6027021	_Flowable Fill	Cyd	1.704
6030005	Cement	Ton	1.000
8017011	_Driveway, Nonreinf Conc, 6 inch, Modified	Syd	-34.000
8027001	_Curb and Gutter, Conc	Ft	46.000
8037010	_Sidewalk, Conc, 6 inch, Modified	Sft	300.000
8117001	_Pavt Mrkg, Wet Retrflec, Thermopl, 6 inch, Crosswalk	Ft	70.000
8117001	_Pavt Mrkg, Wet Retrflec, Thermopl, 24 inch, Stop Bar	Ft	15.000
8120012	Barricade, Type III, High Intensity, Double Sided, Lighted, Furn	Ea	2.000
8120013	Barricade, Type III, High Intensity, Double Sided, Lighted, Oper	Ea	2.000
8120260	Plastic Drum, High Intensity, Lighted, Fum	Ea	26.000
8120261	Plastic Drum, High Intensity, Lighted, Oper	Ea	26.000
8120350	Sign, Type B, Temp, Prismatic, Fum	Sft	129.000
8120351	Sign, Type B, Temp, Prismatic, Oper	Sft	129.000
8127050	_No Parking Sign	Ea	19.000
8167011	Slope Restoration	Syd	17.000
8230431	Gate Box, Adj, Case 1	Ea	1.000

	CONSTRUC
KEY	ASSOCIATED PAY ITEM(S)
	 _Dr Structure, Adj, Case 1, Modi
AA	 _Dr Structure, Adj, Case 2, Modi
	Dr Structure, Temp Lowering, M
	_Dr Structure, Temp Lowering, M
AB	• _Gate Box, Adj, Case 1
	 _Gate Box, Adj, Case 2 Monument Box Adjust
ADST	 _Monument Dox Adjust _Dr Structure, Adj, Add Depth, N
AK	 _Dr Structure, Adj, Add Depth, W _Dr Structure, Adj, Case 1, Modi
7413	 _Sidewalk, Sidewalk Ramp, and
C4	 Grading, Sidewalk
	 Sidewalk, Conc, 4 inch, Modifie
	• _Sidewalk, Sidewalk Ramp, and
C4HE	 Grading, Sidewalk
C4NE	Cement
	 _Sidewalk, Conc, 4 inch, Modifie
	• _Sidewalk, Sidewalk Ramp, and
	 _Grading, Sidewalk
C6	 Grading, Sidewalk Ramp
00	 _Detectable Warning Surface, Me
	 _Sidewalk Ramp, Conc, 6 inch, I
	 _Sidewalk, Conc, 6 inch, Modifie
C8	 _Grading, Driveway Approach
law or	Driveway, Nonreinf Conc, 8 inch
	• _Sidewalk, Sidewalk Ramp, and
	Grading, Driveway Approach
	Grading, Sidewalk
	• _Grading, Sidewalk Ramp
C HE	Cement Driveway, Nepreinf Cane, 6 inch
	 _Driveway, Nonreinf Conc, 6 inch _Driveway, Nonreinf Conc, 8 inch
	 _Driveway, Nonreini Conc, 8 inch _Detectable Warning Surface, Me
	 _Detectable Warning Sunace, Warni
	 _Sidewalk, Conc, 6 inch, Modifie
	 _Curb, Gutter, and Curb and Gut
C/G	_Curb and Gutter, Conc
	 _Curb, Gutter, and Curb and Gut
C/GHE	• Cement
	• _Driveway Opening, Conc, Det M
CD	Grading, Sidewalk
CP	 Sidewalk, Conc, 4 inch, Modifie
CR	 _Sidewalk, Sidewalk Ramp, and
	 Dr Structure, Rem
DS	Sewer, Rem, Less than 24 inch
	 Dr Structure, 24 inch dia
	 Dr Structure, Rem
DSDI	Sewer, Rem, Less than 24 inch
	Dr Structure, Double Inlet
PT	_Dr Structure, Point
	Dr Structure Cover, Type B
RRA	_Dr Structure Cover, Type B, Spe
	_Dr Structure, Adj, Case 1, Modi
	_Dr Structure, Temp Lowering, M
RRK	Dr Structure Cover, Type K
RS	 _Dr Structure, Adj, Case 1, Modi Dr Structure, Reconstruct
	 _Dr Structure, Reconstruct Plastic Drum, High Intensity, Light
TYPE II	 Plastic Drum, High Intensity, Light Plastic Drum, High Intensity, Light
	 Barricade, Type III, High Intensity
TYPE III	 Barricade, Type III, High Intensity Barricade, Type III, High Intensity
	Damoude, Type III, Flight Intel18ity

ICTION KEY
dified dified Modified
Modified
Modified
dified d Driveway Approach, Any Thickness, Rem
ied d Driveway Approach, Any Thickness, Rem
ied
d Driveway Approach, Any Thickness, Rem
Modified , Modified ied
sh, Modified
d Driveway Approach, Any Thickness, Rem
ch, Modified ch, Modified Modified , Modified ied
utter, Any Type, Rem
utter, Any Type, Rem
M, Modified
ied
d Driveway Approach, Any Thickness, Rem
1

pecial
dified
Modified
dified
ghted, Furn
ghted, Oper

0	, ,				
ty,	Double	Sided,	Lighted,	Furn	
ts /	Doublo	Cidod	Lightod	Onor	

r, Double Sided, Lighted, Oper

LEGEND			
SYMBOL	DESCRIPTION		
S	EXISTING SANITARY SEWER MANHOLE		
(r)	EXISTING STORM SEWER MANHOLE		
\otimes	EXISTING WATER MAIN VALVE IN WELL		
+	WATER MAIN GATE VALVE IN BOX		
+Q+	FIRE HYDRANT		
(g)	MICHCON GAS CO. VALVE BOX/WELL		
(t)	AMERITECH TELEPHONE VAULT		
e	ELECTRIC MANHOLE		
\bullet	SOIL BORING		
	EXISTING STORM SEWER INLET		
•	MONUMENT BOX		
	REMOVE AND REPLACE CONC. SIDEWALK		
Δ Δ . 	PLACE CONCRETE SIDEWALK		
	REMOVE & REPLACE CONC. CURB & GUTTER		
	CONSTRUCTION LIMITS		
	6" WRAPPED UNDERDRAIN		
	REMOVE CONCRETE SIDEWALK		
	SUBGRADE UNDERCUT		

CONSTRUCTION METHOD AND SEQUENCING

IN ACCORDANCE WITH THE SCHEDULE OF STREETS WORK ON THIS STREET IS TO OCCUR CONCURRENTLY WI THAT PROPOSED FOR 3RD STREET. WORK ON THIS STREET INCLUDES, BUT IS NOT LIMITED TO. ITEMS. COMPLETE THE WORK IN ACCORDANCE WITH THE PLANS AND SPECIFICATIONS. AND AS DIRECTED ENGINEER. PERFORM THE WORK IN THE ORDER INDICATED BELOW UNLESS OTHERWISE BY THE ENGINEER

- CONTROL MEASURES.
- COLDMILLING.

- AND MONUMENT BOXES AS REQUIRED.
- 7. REQUIRED.
- AS REQUIRED.
- 12. CLEAN PAVEMENT AND COMPLETE ALL PAVEMENT MARKINGS.
- 14. REMOVE ALL TRAFFIC CONTROL DEVICES, AND MISS DIG FLAGS.

NOTES:

		QUANTITIES		
		Sign, Type B, Temp, Prismatic		
Quantity	Sign Code	Description	Area (sft)	Total Area
8.0	D3-1	Street Name Sign	4.000	32.000
2.0	R11-4	Road Closed Sign ("Road Closed To Thru Traffic")	12.500	25.000
4.0	W20-1	Road Work Ahead Sign	9.000	36.000
4.0	W20-3	Road Closed Ahead Sign	9.000	36.000
			TOTAL	129.000

IMPLEMENT MAINTENANCE OF TRAFFIC (M.O.T.) PLAN, AND INSTALL SOIL EROSION AND SEDIMENTATION

2. CONDUCT REMOVAL WORK RELATED TO PAVEMENT, DRAINAGE, AND CONCRETE ITEMS WITH EXCEPTION TO

3. INSTALL PROPOSED DRAINAGE STRUCTURES, STORM SEWER, AND UNDERDRAIN AS REQUIRED.

PERFORM ALL CONCRETE WORK, INCLUDING RESTORATION, AS REQUIRED.

TEMPORARY LOWER ALL STRUCTURE COVERS LOCATED WITHIN THE EXISTING PAVEMENT, INCLUDING GATE

REMOVE 4.0 INCHES OF EXISTING HMA SURFACE BY COLDMILLING. THIS MAY INCLUDE GRANULAR BASE MATERIAL. DEPTH TO BE DETERMINED BY THE ENGINEER. PROOF ROLL WITH FULLY LOADED TRUCK.

PERFORM ALL JOINT AND CRACK CLEANOUT, HMA/HAND PATCHING, UNDERCUTS AND/OR BASE REPAIRS AS

8. GRADE, SHAPE, AND COMPACT THE EXISTING BASE MATERIAL AS DIRECTED

9. CLEAN PAVEMENT AS REQUIRED, AND PLACE 2.0 INCH LEVELING COURSE HMA MIX (LOCAL STREETS). 10. ADJUST ALL STRUCTURE COVERS. INCLUDING GATE AND MONUMENT BOXES. TO THEIR FINISHED ELEVATIONS

11. CLEAN PAVEMENT AND PLACE 2.0 INCH TOP COURSE HMA MIX (LOCAL STREETS).

13. COMPLETE ALL MISCELLANEOUS CONSTRUCTION INCLUDING ALL CLEAN UP AND FINAL RESTORATION.


FOR PROTECTION OF UNDERGROUND UTILITIES AND IN CONFORMANCE WITH PUBLIC ACT 174 OF 2013, THE CONTRACTOR SHALL CALL 811 OR 1-800-482-7171 A MINIMUM OF HREE FULL WORKING DAYS, EXCLUDING SATURDAYS, SUNDAYS, AND HOLIDAYS, PRIOR BEGINNING EACH EXCAVATION IN AREAS WHERE PUBLIC UTILITIES HAVE NOT BEEN REVIOUSLY LOCATED. MEMBERS WILL THUS BE ROUTINELY NOTIFIED. THIS DOES NOT ELIEVE THE CONTRACTOR OF THE RESPONSIBILITY OF NOTIFYING UTILITY OWNERS HO MAY NOT BE A PART OF THE "MISS DIG" ALERT SYSTEM.


HE UNDERGROUND LOCATIONS SHOWN FOR NATURAL GAS, TELEPHONE, ELECTRICAL WER, CABLE TV AND FIBER OPTIC LINES ARE APPROXIMATE. THE CITY OF ANN REOR ASSUMES NO RESPONSIBILITY FOR THEIR ACCURATE REPRESENTATION IN THIS RAWING. MISS DIG MUST BE CONTACTED PRIOR TO CONSTRUCTION TO LOCATE THESE TILITIES.

HE IMPROVEMENTS COVERED BY THESE PLANS SHALL BE PERFORMED IN ACCORDANCE ITH MICHIGAN DEPARTMENT OF TRANSPORTATION (MDOT) 2012 STANDARD PECIFICATIONS FOR CONSTRUCTION, INCLUDING REFERENCED MDOT PUBLICATIONS, AND HE PROJECT CONTRACT DOCUMENTS.



PROJECT MANAGEMENT - PUBLIC SERVICES - CITY OF ANN ARBOR	PROJECT DESCRIPTION ANNUAL STREET RESURFACING - 2017	6TH STREET
	T No.	DRAWING No. 2017004-12

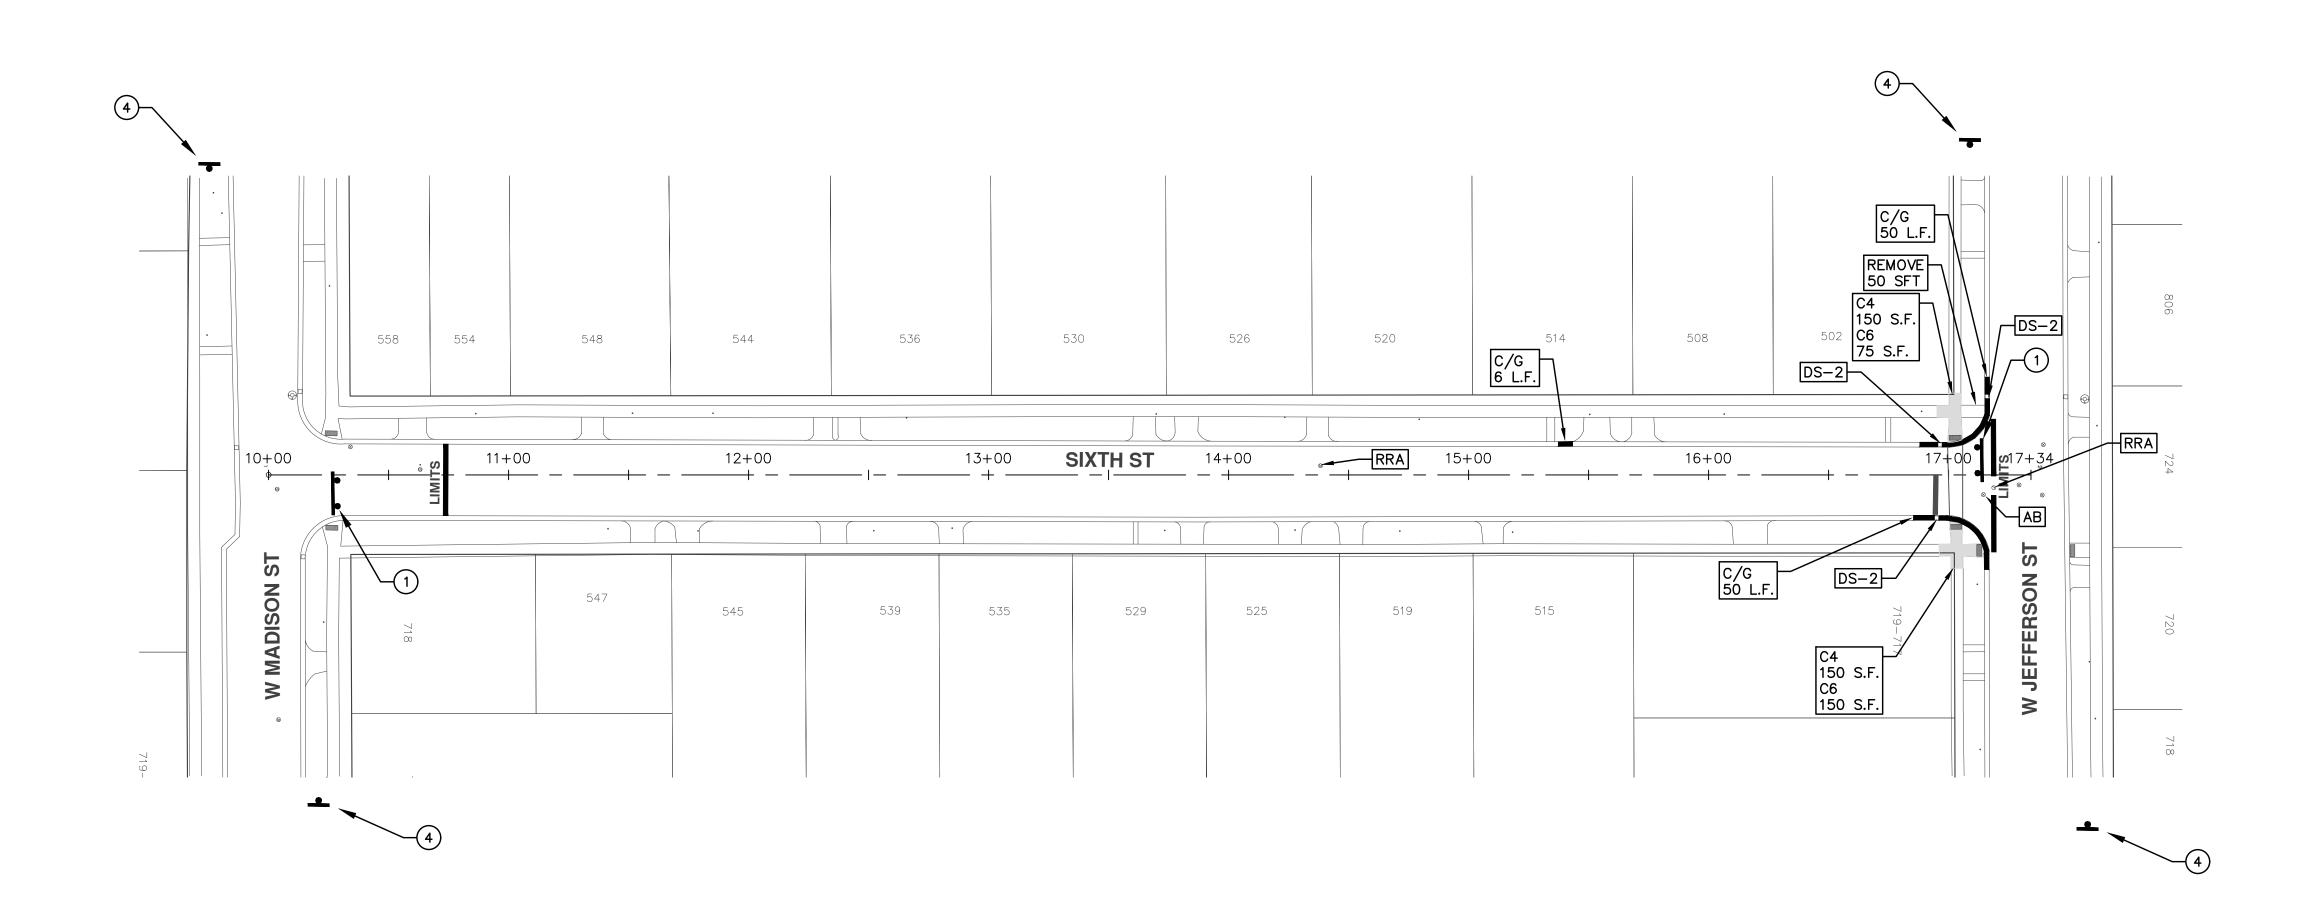

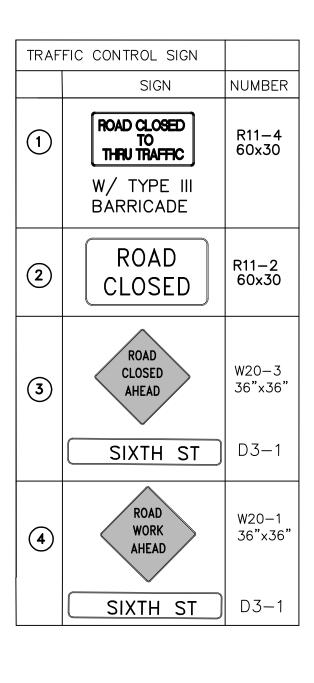

ξ	X X		Know what's below	Call before you dig.
		DAD	DAD	DRAWN CHECKED
		AG,GS,RG	AG,GS,RG	DRAWN
		03-24-17	03-08-17	DATE
		01 ADDENDUM #1	00 BID SET	REV. DESCRIPTION
ANN OF ANN	PUBLIC SERVICE 301 EAST HURON STREET	O O P.O. BOX 8647 ANN ARBOR, MI 48107-8647 ANN ARBOR, MI 48107-8647		WICHIGAN
MANAGEMENT - PUBLIC SERVICES - CITY OF ANN ARBOR	ANNUAL STREET RESURFACING - 2017	6TH STREET		SIA. 10+00 - SIA. 17+34
	SCALE PLAN: 1:40			2017004-13



QUANTITIES				
Item Code	Item Description	Units	Quantity	
2057011	_Machine Grading, Special	Syd	615.000	
2057021	_Subgrade Undercutting, Type IIA	Cyd	62.000	
2080020	Erosion Control, Inlet Protection, Fabric Drop	Ea	1.000	
5010003	Cold Milling HMA Surface	Ton	139.000	
5010703	HMA, LVSP	Ton	139.000	
8120012	Barricade, Type III, High Intensity, Double Sided, Lighted, Furn	Ea	1.000	
8120013	Barricade, Type III, High Intensity, Double Sided, Lighted, Oper	Ea	1.000	
8120260	Plastic Drum, High Intensity, Lighted, Furn	Ea	15.000	
8120261	Plastic Drum, High Intensity, Lighted, Oper	Ea	15.000	
8120350	Sign, Type B, Temp, Prismatic, Furn	Sft	38.500	
8120351	Sign, Type B, Temp, Prismatic, Oper	Sft	38.500	

	CONSTRUCT
KEY	ASSOCIATED PAY ITEM(S)
AA	 _Dr Structure, Adj, Case 1, Modified _Dr Structure, Adj, Case 2, Modified _Dr Structure, Temp Lowering, Modified
AB	 _Dr Structure, Temp Lowering, Modif _Gate Box, Adj, Case 1 _Gate Box, Adj, Case 2 Monument Box Adjust
ADST	 _Dr Structure, Adj, Add Depth, Modit
AK	
C4	 _Sidewalk, Sidewalk Ramp, and Driv _Grading, Sidewalk _Sidewalk, Conc, 4 inch, Modified
C4HE	 _Sidewalk, Sidewalk Ramp, and Driv _Grading, Sidewalk Cement _Sidewalk, Conc, 4 inch, Modified
C6	 Sidewalk, Sidewalk Ramp, and Driv Grading, Sidewalk Grading, Sidewalk Ramp Detectable Warning Surface, Modifi Sidewalk Ramp, Conc, 6 inch, Mod Sidewalk, Conc, 6 inch, Modified
C8	 _Grading, Driveway Approach _Driveway, Nonreinf Conc, 8 inch, Ma
C HE	 _Sidewalk, Sidewalk Ramp, and Driv _Grading, Driveway Approach _Grading, Sidewalk _Grading, Sidewalk Ramp Cement _Driveway, Nonreinf Conc, 6 inch, Me _Driveway, Nonreinf Conc, 8 inch, Me _Detectable Warning Surface, Modifiered _Sidewalk Ramp, Conc, 6 inch, Modifiered
C/G	 Curb, Gutter, and Curb and Gutter, Curb and Gutter, Conc
C/GHE	 _Curb, Gutter, and Curb and Gutter, Cement _Driveway Opening, Conc, Det M, M
CP	• _Grading, Sidewalk
00	• _Sidewalk, Conc, 4 inch, Modified
CR DS	 _Sidewalk, Sidewalk Ramp, and Driv Dr Structure, Rem Sewer, Rem, Less than 24 inch Dr Structure, 24 inch dia
DSDI	 Dr Structure, Rem Sewer, Rem, Less than 24 inch _Dr Structure, Double Inlet
PT	_Dr Structure, Point
RRA	 Dr Structure Cover, Type B _Dr Structure Cover, Type B, Specia _Dr Structure, Adj, Case 1, Modified _Dr Structure, Temp Lowering, Modified
RRK	 Dr Structure Cover, Type K _Dr Structure, Adj, Case 1, Modified
RS	_Dr Structure, Reconstruct
TYPE II	 Plastic Drum, High Intensity, Lighted Plastic Drum, High Intensity, Lighted
TYPE III	 Barricade, Type III, High Intensity, Do Barricade, Type III, High Intensity, Do

PROJECT LOCATION: ALLEY -SSEVENTH ST TO DEAD END

ITB No. 4477 FILE No. 2017-004

ION KEY
i ified
ified
lined
ified
1
veway Approach, Any Thickness, Rem
veway Approach, Any Thickness, Rem
www.ay Approach, Any Mickness, Kem
veway Approach, Any Thickness, Rem
fied
dified
lodified
veway Approach, Any Thickness, Rem
1odified
lodified fied
dified
unicu
Any Type, Rem
Any Type, Rem
Indified
lodified
veway Approach, Any Thickness, Rem
· · · · ·

al
d
lified
d
ed, Furn
ed, Oper
Double Sided, Lighted, Furn
Double Sided, Lighted, Oper

LEGEND				
SYMBOL	DESCRIPTION			
<u>s</u>	EXISTING SANITARY SEWER MANHOLE			
(7)	EXISTING STORM SEWER MANHOLE			
\otimes	EXISTING WATER MAIN VALVE IN WELL			
+	WATER MAIN GATE VALVE IN BOX			
+Ç+	FIRE HYDRANT			
(g)	MICHCON GAS CO. VALVE BOX/WELL			
t	AMERITECH TELEPHONE VAULT			
e	ELECTRIC MANHOLE			
\bullet	SOIL BORING			
	EXISTING STORM SEWER INLET			
٥	MONUMENT BOX			
	REMOVE AND REPLACE CONC. SIDEWALK			
	PLACE CONCRETE SIDEWALK			
	REMOVE & REPLACE CONC. CURB & GUTTER			
	CONSTRUCTION LIMITS			
	6" WRAPPED UNDERDRAIN			
	REMOVE CONCRETE SIDEWALK			
	SUBGRADE UNDERCUT			

CONSTRUCTION METHOD AND SEQUENCING

WORK ON THIS STREET INCLUDES, BUT IS NOT LIMITED TO, THE FOLLOWING ITEMS. COMPLETE THE WORK IN ACCORDANCE WITH THE PLANS AND SPECIFICATIONS. AND AS DIRECTED BY THE ENGINEER. PERFORM THE WORK E ORDER INDICATED BELOW UNLESS OTHERWISE AUTHORIZED OR DIRECTED BY THE ENGINEER

- CONTROL MEASURES.
- COLDMILLING.
- AND MONUMENT BOXES AS REQUIRED.
- 7. PERFORM ALL JOINT AND CRACK CLEANOUT, HMA/HAND PATCHING, UNDERCUTS AND/OR BASE REPAIRS AS REQUIRED
- 8. GRADE, SHAPE, AND COMPACT THE EXISTING BASE MATERIAL AS DIRECTED.
- AS REQUIRED.
- 12. CLEAN PAVEMENT AND COMPLETE ALL PAVEMENT MARKINGS.
- 14. REMOVE ALL TRAFFIC CONTROL DEVICES, AND MISS DIG FLAGS.

NOTES:

FOR 174 THRE TO E PREV RELIE WHO	
WHO	

THE UNDERGROUND LOCATIONS SHOWN FOR NATURAL GAS, TELEPHONE, ELECTRICAL POWER, CABLE TV AND FIBER OPTIC LINES ARE APPROXIMATE. THE CITY OF ANN ARBOR ASSUMES NO RESPONSIBILITY FOR THEIR ACCURATE REPRESENTATION IN THIS DRAWING. MISS DIG MUST BE CONTACTED PRIOR TO CONSTRUCTION TO LOCATE THESE UTILITIES. THE IMPROVEMENTS COVERED BY THESE PLANS SHALL BE PERFORMED IN ACCORDANCE



	QUANTITIES				
Sign, Type B, Temp, Prismatic					
Quantity	Sign Code	Description	Area (sft)	Total Area	
2.0	D3-1	Street Name Sign	4.000	8.000	
1.0	R11-4	Road Closed Sign ("Road Closed To Thru Traffic")	12.500	12.500	
2.0	W20-1	Road Work Ahead Sign	9.000	18.000	
0.0	W20-3	Road Closed Ahead Sign	9.000	0.000	
			TOTAL	38.500	

IMPLEMENT MAINTENANCE OF TRAFFIC (M.O.T.) PLAN, AND INSTALL SOIL EROSION AND SEDIMENTATION

CONDUCT REMOVAL WORK RELATED TO PAVEMENT, DRAINAGE, AND CONCRETE ITEMS WITH EXCEPTION TO

3. INSTALL PROPOSED DRAINAGE STRUCTURES, STORM SEWER, AND UNDERDRAIN AS REQUIRED.

4. PERFORM ALL CONCRETE WORK, INCLUDING RESTORATION, AS REQUIRED.

5. TEMPORARY LOWER ALL STRUCTURE COVERS LOCATED WITHIN THE EXISTING PAVEMENT, INCLUDING GATE

REMOVE 4.0 INCHES OF EXISTING HMA SURFACE BY COLDMILLING. THIS MAY INCLUDE GRANULAR BASE DEPTH TO BE DETERMINED BY THE ENGINEER. PROOF ROLL WITH FULLY LOADED TRUCK.

9. CLEAN PAVEMENT AS REQUIRED, AND PLACE 2.0 INCH LEVELING COURSE HMA MIX (LOCAL STREETS). 10. ADJUST ALL STRUCTURE COVERS, INCLUDING GATE AND MONUMENT BOXES, TO THEIR FINISHED ELEVATIONS


11. CLEAN PAVEMENT AND PLACE 2.0 INCH TOP COURSE HMA MIX (LOCAL STREETS).

13. COMPLETE ALL MISCELLANEOUS CONSTRUCTION INCLUDING ALL CLEAN UP AND FINAL RESTORATION.

PROTECTION OF UNDERGROUND UTILITIES AND IN CONFORMANCE WITH PUBLIC ACT OF 2013, THE CONTRACTOR SHALL CALL 811 OR 1-800-482-7171 A MINIMUM OF EE FULL WORKING DAYS, EXCLUDING SATURDAYS, SUNDAYS, AND HOLIDAYS, PRIOR BEGINNING EACH EXCAVATION IN AREAS WHERE PUBLIC UTILITIES HAVE NOT BEEN VIOUSLY LOCATED. MEMBERS WILL THUS BE ROUTINELY NOTIFIED. THIS DOES NOT EVE THE CONTRACTOR OF THE RESPONSIBILITY OF NOTIFYING UTILITY OWNERS MAY NOT BE A PART OF THE "MISS DIG" ALERT SYSTEM.

WITH MICHIGAN DEPARTMENT OF TRANSPORTATION (MDOT) 2012 STANDARD SPECIFICATIONS FOR CONSTRUCTION, INCLUDING REFERENCED MDOT PUBLICATIONS, AND THE PROJECT CONTRACT DOCUMENTS.

	ENT - PUBLIC SERVICES - CITY OF ANN ARBOR
T No.	PROJECT DESCRIPTION ANNUAL STREET RESURFACING - 2017
DRAWING No. 2017004-14	ALLEY - S SEVENTH ST TO DEAD END

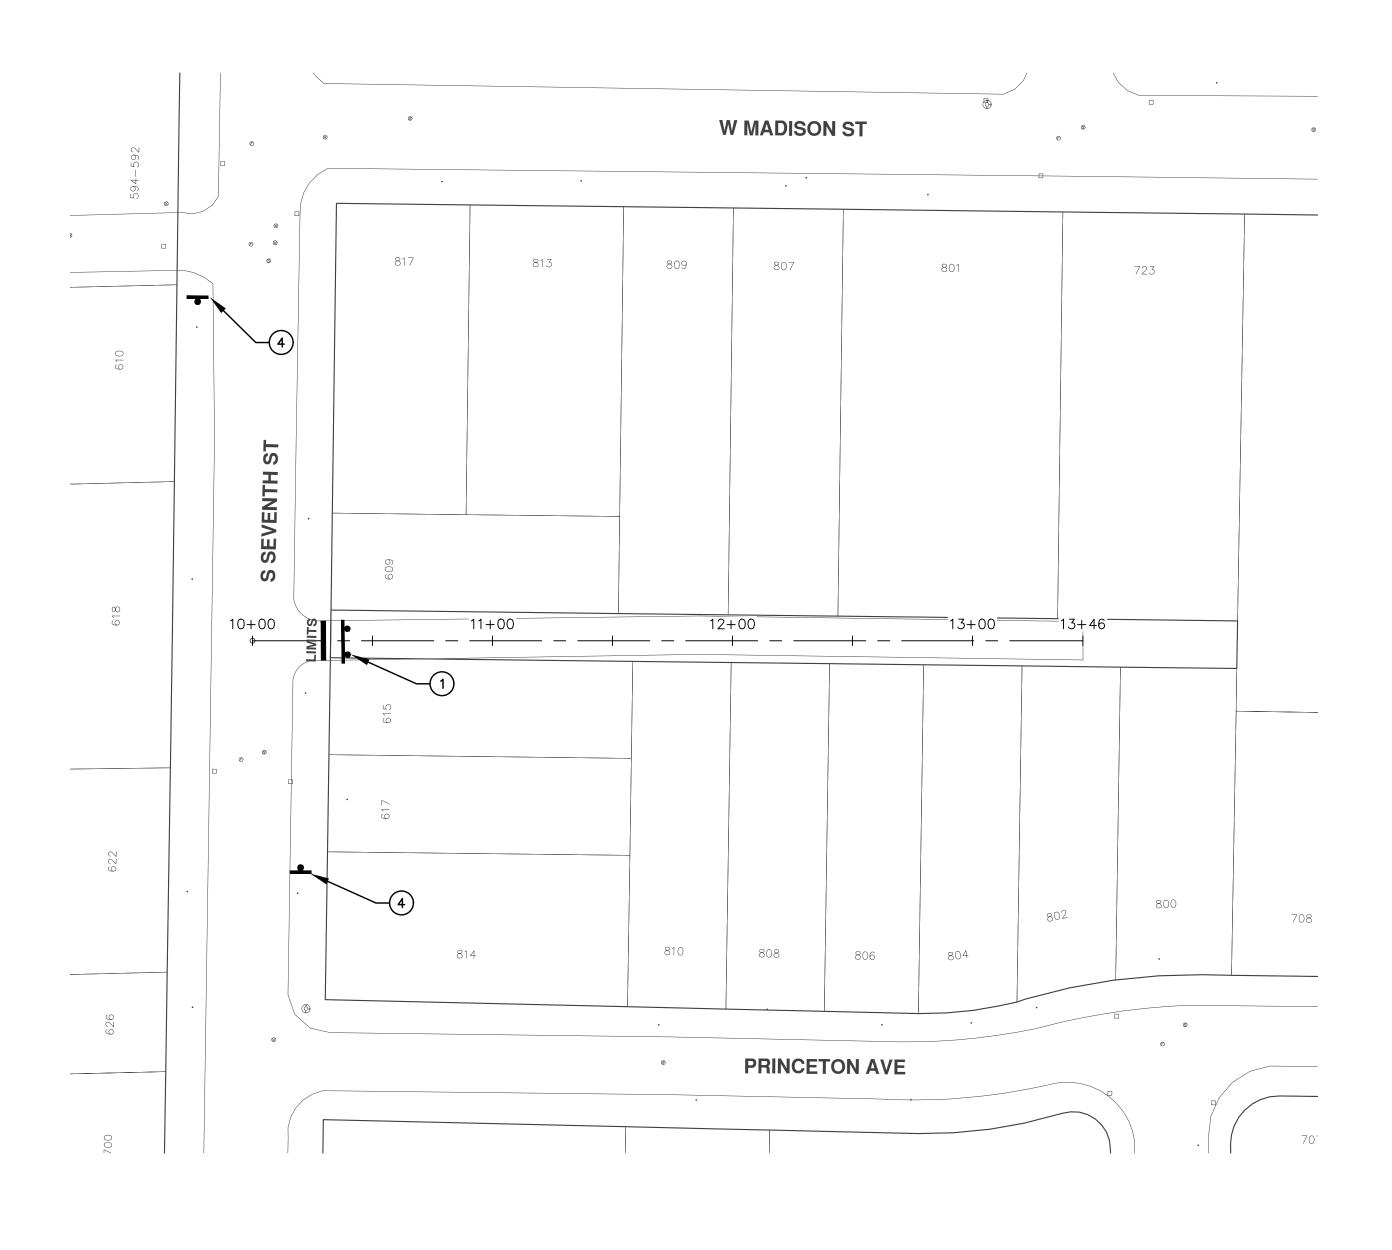

				Know what's below.	 Call before you dig.
F			AG.GS.RG DAD		DRAWN CHECKED
			03-24-17 AG.(03-08-17 AG,0	DATE DR
			ADDENDUM #1	BID SET	DESCRIPTION
L			6	8	REV.
(:	OF ANN CITY OF ANN ABROD	A CONTRACT OF A	D 301 EASI HURON SI KEEI D B D P.O. BOX 8647 ANN APPOR MI 48107-8647	734-794-6410 WWW.a2gov.org	CHIGN
		ANNUAL STRFFT RESURFACING - 2017	ALLEY - S SEVENTH ST TO DEAD END		SIA. 10+00 - SIA. 13+46
BBO IECT MANA CEMEI		SCALE PLAN: 1:40		DRAWING No.	2017004-15

TRAF	FIC CONTROL SIGN	
	SIGN	NUMBER
1	ROAD CLOSED TO THRU TRAFFIC W/ TYPE III BARRICADE	R11-4 60x30
2	ROAD CLOSED	R11-2 60x30
3	ROAD CLOSED AHEAD	W20-3 36"x36"
	ALLEY	D3-1
4	ROAD WORK AHEAD	W20-1 36"x36"
	ALLEY	D3-1



QUANTITIES				
Item Code	Item Description	Units	Quantity	
2030011	Dr Structure, Rem	Ea	4.000	
2030015	Sewer, Rem, Less than 24 inch	Ft	40.000	
2047001	_Curb, Gutter, and Curb and Gutter, Any Type, Rem	Ft	460.000	
2047011	_Sidewalk, Sidewalk Ramp, and Driveway Approach, Any Thickness, Rem	Syd	110.000	
2057011	_Grading, Driveway Approach	Syd	110.000	
2057011	_Machine Grading, Special	Syd	2,201.000	
2057021	_Subgrade Undercutting, Type IIA	Cyd	221.000	
2080020	Erosion Control, Inlet Protection, Fabric Drop	Ea	6.000	
4020987	Sewer, CI IV, 12 inch, Tr Det B	Ft	40.000	
4030200	Dr Structure, 24 inch dia	Ea	4.000	
4037050	_Dr Structure Cover, Type B, Modified	Ea	3.000	
4037050	_Dr Structure Cover, Type K, Modified	Ea	4.000	
4037050	_Dr Structure, Adj, Case 1, Modified	Ea	7.000	
4037050	_Dr Structure, Temp Lowering, Modified	Ea	3.000	
5010003	Cold Milling HMA Surface	Ton	498.000	
5010005	HMA Surface, Rem	Syd	144.660	
5010703	HMA, LVSP	Ton	498.000	
6027021	_Flowable Fill	Cyd	17.037	
6030005	Cement	Ton	6.000	
8017011	_Driveway, Nonreinf Conc, 6 inch, Modified	Syd	110.000	
8027001	_Curb and Gutter, Conc	Ft	200.000	
8027001	_Driveway Opening, Conc, Det M, Modified	Ft	316.000	
8117001	_Pavt Mrkg, Wet Retrflec, Thermopl, 6 inch, Crosswalk	Ft	60.000	
8117001	_Pavt Mrkg, Wet Retrflec, Thermopl, 24 inch, Stop Bar	Ft	30.000	
8120012	Barricade, Type III, High Intensity, Double Sided, Lighted, Furn	Ea	2.000	
8120013	Barricade, Type III, High Intensity, Double Sided, Lighted, Oper	Ea	2.000	
8120260	Plastic Drum, High Intensity, Lighted, Furn	Ea	40.000	
8120261	Plastic Drum, High Intensity, Lighted, Oper	Ea	40.000	
8120350	Sign, Type B, Temp, Prismatic, Furn	Sft	77.000	
8120351	Sign, Type B, Temp, Prismatic, Oper	Sft	77.000	
8127050	_No Parking Sign	Ea	22.000	
8167011	_Slope Restoration	Syd	169.000	
8230431	Gate Box, Adj, Case 1	Ea	1.000	

	CONSTRUCTION KEY
KEY	ASSOCIATED PAY ITEM(S)
	_Dr Structure, Adj, Case 1, Modified
AA	 _Dr Structure, Adj, Case 2, Modified
	_Dr Structure, Temp Lowering, Modified
	 _Dr Structure, Temp Lowering, Modified
AB	• _Gate Box, Adj, Case 1
	• _Gate Box, Adj, Case 2
ADOT	Monument Box Adjust
ADST AK	 _Dr Structure, Adj, Add Depth, Modified _Dr Structure, Adj, Case 1, Modified
AN	 _Di Structure, Auj, Case 1, Modified _Sidewalk, Sidewalk Ramp, and Driveway Approach, Any Thickr
C4	 Grading, Sidewalk Grading, Sidewalk
01	 _Sidewalk, Conc, 4 inch, Modified
	 Sidewalk, Sidewalk Ramp, and Driveway Approach, Any Thickr
CALLE	Grading, Sidewalk
C4HE	• Cement
	 _Sidewalk, Conc, 4 inch, Modified
	 _Sidewalk, Sidewalk Ramp, and Driveway Approach, Any Thickr
	 _Grading, Sidewalk
C6	 _Grading, Sidewalk Ramp
	Detectable Warning Surface, Modified
	_Sidewalk Ramp, Conc, 6 inch, Modified
	Sidewalk, Conc, 6 inch, Modified
C8	Grading, Driveway Approach Driveway, Naproinf Cana, 8 inch, Madified
	 _Driveway, Nonreinf Conc, 8 inch, Modified _Sidewalk, Sidewalk Ramp, and Driveway Approach, Any Thickr
	 _Grading, Driveway Approach
	Grading, Sidewalk
	Grading, Sidewalk Ramp
0.115	• Cement
C HE	 _Driveway, Nonreinf Conc, 6 inch, Modified
	 Driveway, Nonreinf Conc, 8 inch, Modified
	 _Detectable Warning Surface, Modified
	 _Sidewalk Ramp, Conc, 6 inch, Modified
	_Sidewalk, Conc, 6 inch, Modified
C/G	• _Curb, Gutter, and Curb and Gutter, Any Type, Rem
	_Curb and Gutter, Conc
C/GHE	 _Curb, Gutter, and Curb and Gutter, Any Type, Rem Cement
CIGHE	_Driveway Opening, Conc, Det M, Modified
	Grading, Sidewalk
CP	 _Sidewalk, Conc, 4 inch, Modified
CR	 Sidewalk, Sidewalk Ramp, and Driveway Approach, Any Thickr
0.000 pm	Dr Structure, Rem
DS	 Sewer, Rem, Less than 24 inch
	Dr Structure, 24 inch dia
	Dr Structure, Rem
DSDI	Sewer, Rem, Less than 24 inch
	_Dr Structure, Double Inlet
PT	_Dr Structure, Point
	Dr Structure Cover, Type B
RRA	_Dr Structure Cover, Type B, Special
	 _Dr Structure, Adj, Case 1, Modified _Dr Structure, Temp Lowering, Modified
	Dr Structure, Temp Lowening, Mounied Dr Structure Cover, Type K
RRK	_Dr Structure, Adj, Case 1, Modified
RS	_Dr Structure, Reconstruct
	Plastic Drum, High Intensity, Lighted, Furn
TYPE II	Plastic Drum, High Intensity, Lighted, Oper
	• Barricade, Type III, High Intensity, Double Sided, Lighted, Furn
TYPE III	• Barricade, Type III, High Intensity, Double Sided, Lighted, Oper

PROJECT LOCATION: ARELLA BOULEVARD

ITB No. 4477 FILE No. 2017-004

CTION KEY	
fied	
fied	
lodified	
lodified	

Driveway Approach, Any Thickness, Rem

Driveway Approach, Any Thickness, Rem

Driveway Approach, Any Thickness, Rem

Modified Driveway Approach, Any Thickness, Rem

Driveway Approach, Any Thickness, Rem

SYMBOL	DESCRIPTION
<u>s</u>	EXISTING SANITARY SEWER MANHOLE
	EXISTING STORM SEWER MANHOLE
\otimes	EXISTING WATER MAIN VALVE IN WELL
+	WATER MAIN GATE VALVE IN BOX
+Q+	FIRE HYDRANT
(g)	MICHCON GAS CO. VALVE BOX/WELL
t	AMERITECH TELEPHONE VAULT
e	ELECTRIC MANHOLE
Ð	SOIL BORING
	EXISTING STORM SEWER INLET
⊡	MONUMENT BOX
	REMOVE AND REPLACE CONC. SIDEWALK
A A	PLACE CONCRETE SIDEWALK
	REMOVE & REPLACE CONC. CURB & GUTTER
	CONSTRUCTION LIMITS
·	6" WRAPPED UNDERDRAIN
	REMOVE CONCRETE SIDEWALK
	SUBGRADE UNDERCUT

LEGEND

CONSTRUCTION METHOD AND SEQUENCING

WORK ON THIS STREET INCLUDES, BUT IS NOT LIMITED TO, THE FOLLOWING ITEMS. COMPLETE THE WORK IN ACCORDANCE WITH THE PLANS AND SPECIFICATIONS. AND AS DIRECTED BY THE ENGINEER. PERFORM THE WORK IN THE ORDER INDICATED BELOW UNLESS OTHERWISE AUTHORIZED OR DIRECTED BY THE ENGINEER.

- CONTROL MEASURES.
- COLDMILLING.
- 4. PERFORM ALL CONCRETE WORK, INCLUDING RESTORATION, AS REQUIRED.
- AND MONUMENT BOXES AS REQUIRED.
- **REQUIRED.**
- 10. ADJUST ALL STRUCTURE COVERS, INCLUDING GATE AND MONUMENT BOXES, TO THEIR FINISHED ELEVATIONS AS REQUIRED.
- 12. CLEAN PAVEMENT AND COMPLETE ALL PAVEMENT MARKINGS.
- 14. REMOVE ALL TRAFFIC CONTROL DEVICES, AND MISS DIG FLAGS.

NOTES:

FOR	
174	(
THR	_
TO	
PRE	-
RELI	
WHO	

THE UNDERGROUND LOCATIONS SHOWN FOR NATURAL GAS, TELEPHONE, ELECTRICAL POWER, CABLE TV AND FIBER OPTIC LINES ARE APPROXIMATE. THE CITY OF ANN ARBOR ASSUMES NO RESPONSIBILITY FOR THEIR ACCURATE REPRESENTATION IN THIS DRAWING. MISS DIG MUST BE CONTACTED PRIOR TO CONSTRUCTION TO LOCATE THESE UTILITIES.

		QUANTITIES		
		Sign, Type B, Temp, Prismatic		
Quantity	Sign Code	Description	Area (sft)	Total Area
4.0	D3-1	Street Name Sign	4.000	16.000
2.0	R11-4	Road Closed Sign ("Road Closed To Thru Traffic")	12.500	25.000
4.0	W20-1	Road Work Ahead Sign	9.000	36.000
0.0	W20-3	Road Closed Ahead Sign	9.000	0.000
			TOTAL	77.000

IMPLEMENT MAINTENANCE OF TRAFFIC (M.O.T.) PLAN, AND INSTALL SOIL EROSION AND SEDIMENTATION

2. CONDUCT REMOVAL WORK RELATED TO PAVEMENT, DRAINAGE, AND CONCRETE ITEMS WITH EXCEPTION TO

INSTALL PROPOSED DRAINAGE STRUCTURES, STORM SEWER, AND UNDERDRAIN AS REQUIRED.

TEMPORARY LOWER ALL STRUCTURE COVERS LOCATED WITHIN THE EXISTING PAVEMENT, INCLUDING GATE

REMOVE 4.0 INCHES OF EXISTING HMA SURFACE BY COLDMILLING. THIS MAY INCLUDE GRANULAR BASE MATERIAL. DEPTH TO BE DETERMINED BY THE ENGINEER. PROOF ROLL WITH FULLY LOADED TRUCK.

PERFORM ALL JOINT AND CRACK CLEANOUT. HMA/HAND PATCHING, UNDERCUTS AND/OR BASE REPAIRS AS

8. GRADE, SHAPE, AND COMPACT THE EXISTING BASE MATERIAL AS DIRECTED.

9. CLEAN PAVEMENT AS REQUIRED, AND PLACE 2.0 INCH LEVELING COURSE HMA MIX (LOCAL STREETS).

11. CLEAN PAVEMENT AND PLACE 2.0 INCH TOP COURSE HMA MIX (LOCAL STREETS).

13. COMPLETE ALL MISCELLANEOUS CONSTRUCTION INCLUDING ALL CLEAN UP AND FINAL RESTORATION.


PROTECTION OF UNDERGROUND UTILITIES AND IN CONFORMANCE WITH PUBLIC ACT OF 2013, THE CONTRACTOR SHALL CALL 811 OR 1-800-482-7171 A MINIMUM OF EE FULL WORKING DAYS, EXCLUDING SATURDAYS, SUNDAYS, AND HOLIDAYS, PRIOR BEGINNING EACH EXCAVATION IN AREAS WHERE PUBLIC UTILITIES HAVE NOT BEEN VIOUSLY LOCATED. MEMBERS WILL THUS BE ROUTINELY NOTIFIED. THIS DOES NOT EVE THE CONTRACTOR OF THE RESPONSIBILITY OF NOTIFYING UTILITY OWNERS MAY NOT BE A PART OF THE "MISS DIG" ALERT SYSTEM.

THE IMPROVEMENTS COVERED BY THESE PLANS SHALL BE PERFORMED IN ACCORDANCE WITH MICHIGAN DEPARTMENT OF TRANSPORTATION (MDOT) 2012 STANDARD SPECIFICATIONS FOR CONSTRUCTION, INCLUDING REFERENCED MDOT PUBLICATIONS, AND THE PROJECT CONTRACT DOCUMENTS.



Know what's below. Call before you dig.

нее 1	PROJECT MANAGEMI	ENT - PUBLIC SERVICES - CITY OF ANN ARBOR
τ Νο. 6 ΟΙ		PROJECT DESCRIPTION ANNUAL STREET RESURFACING - 2017
= 1		
36	DRAWING No.	
6	2017004-16	

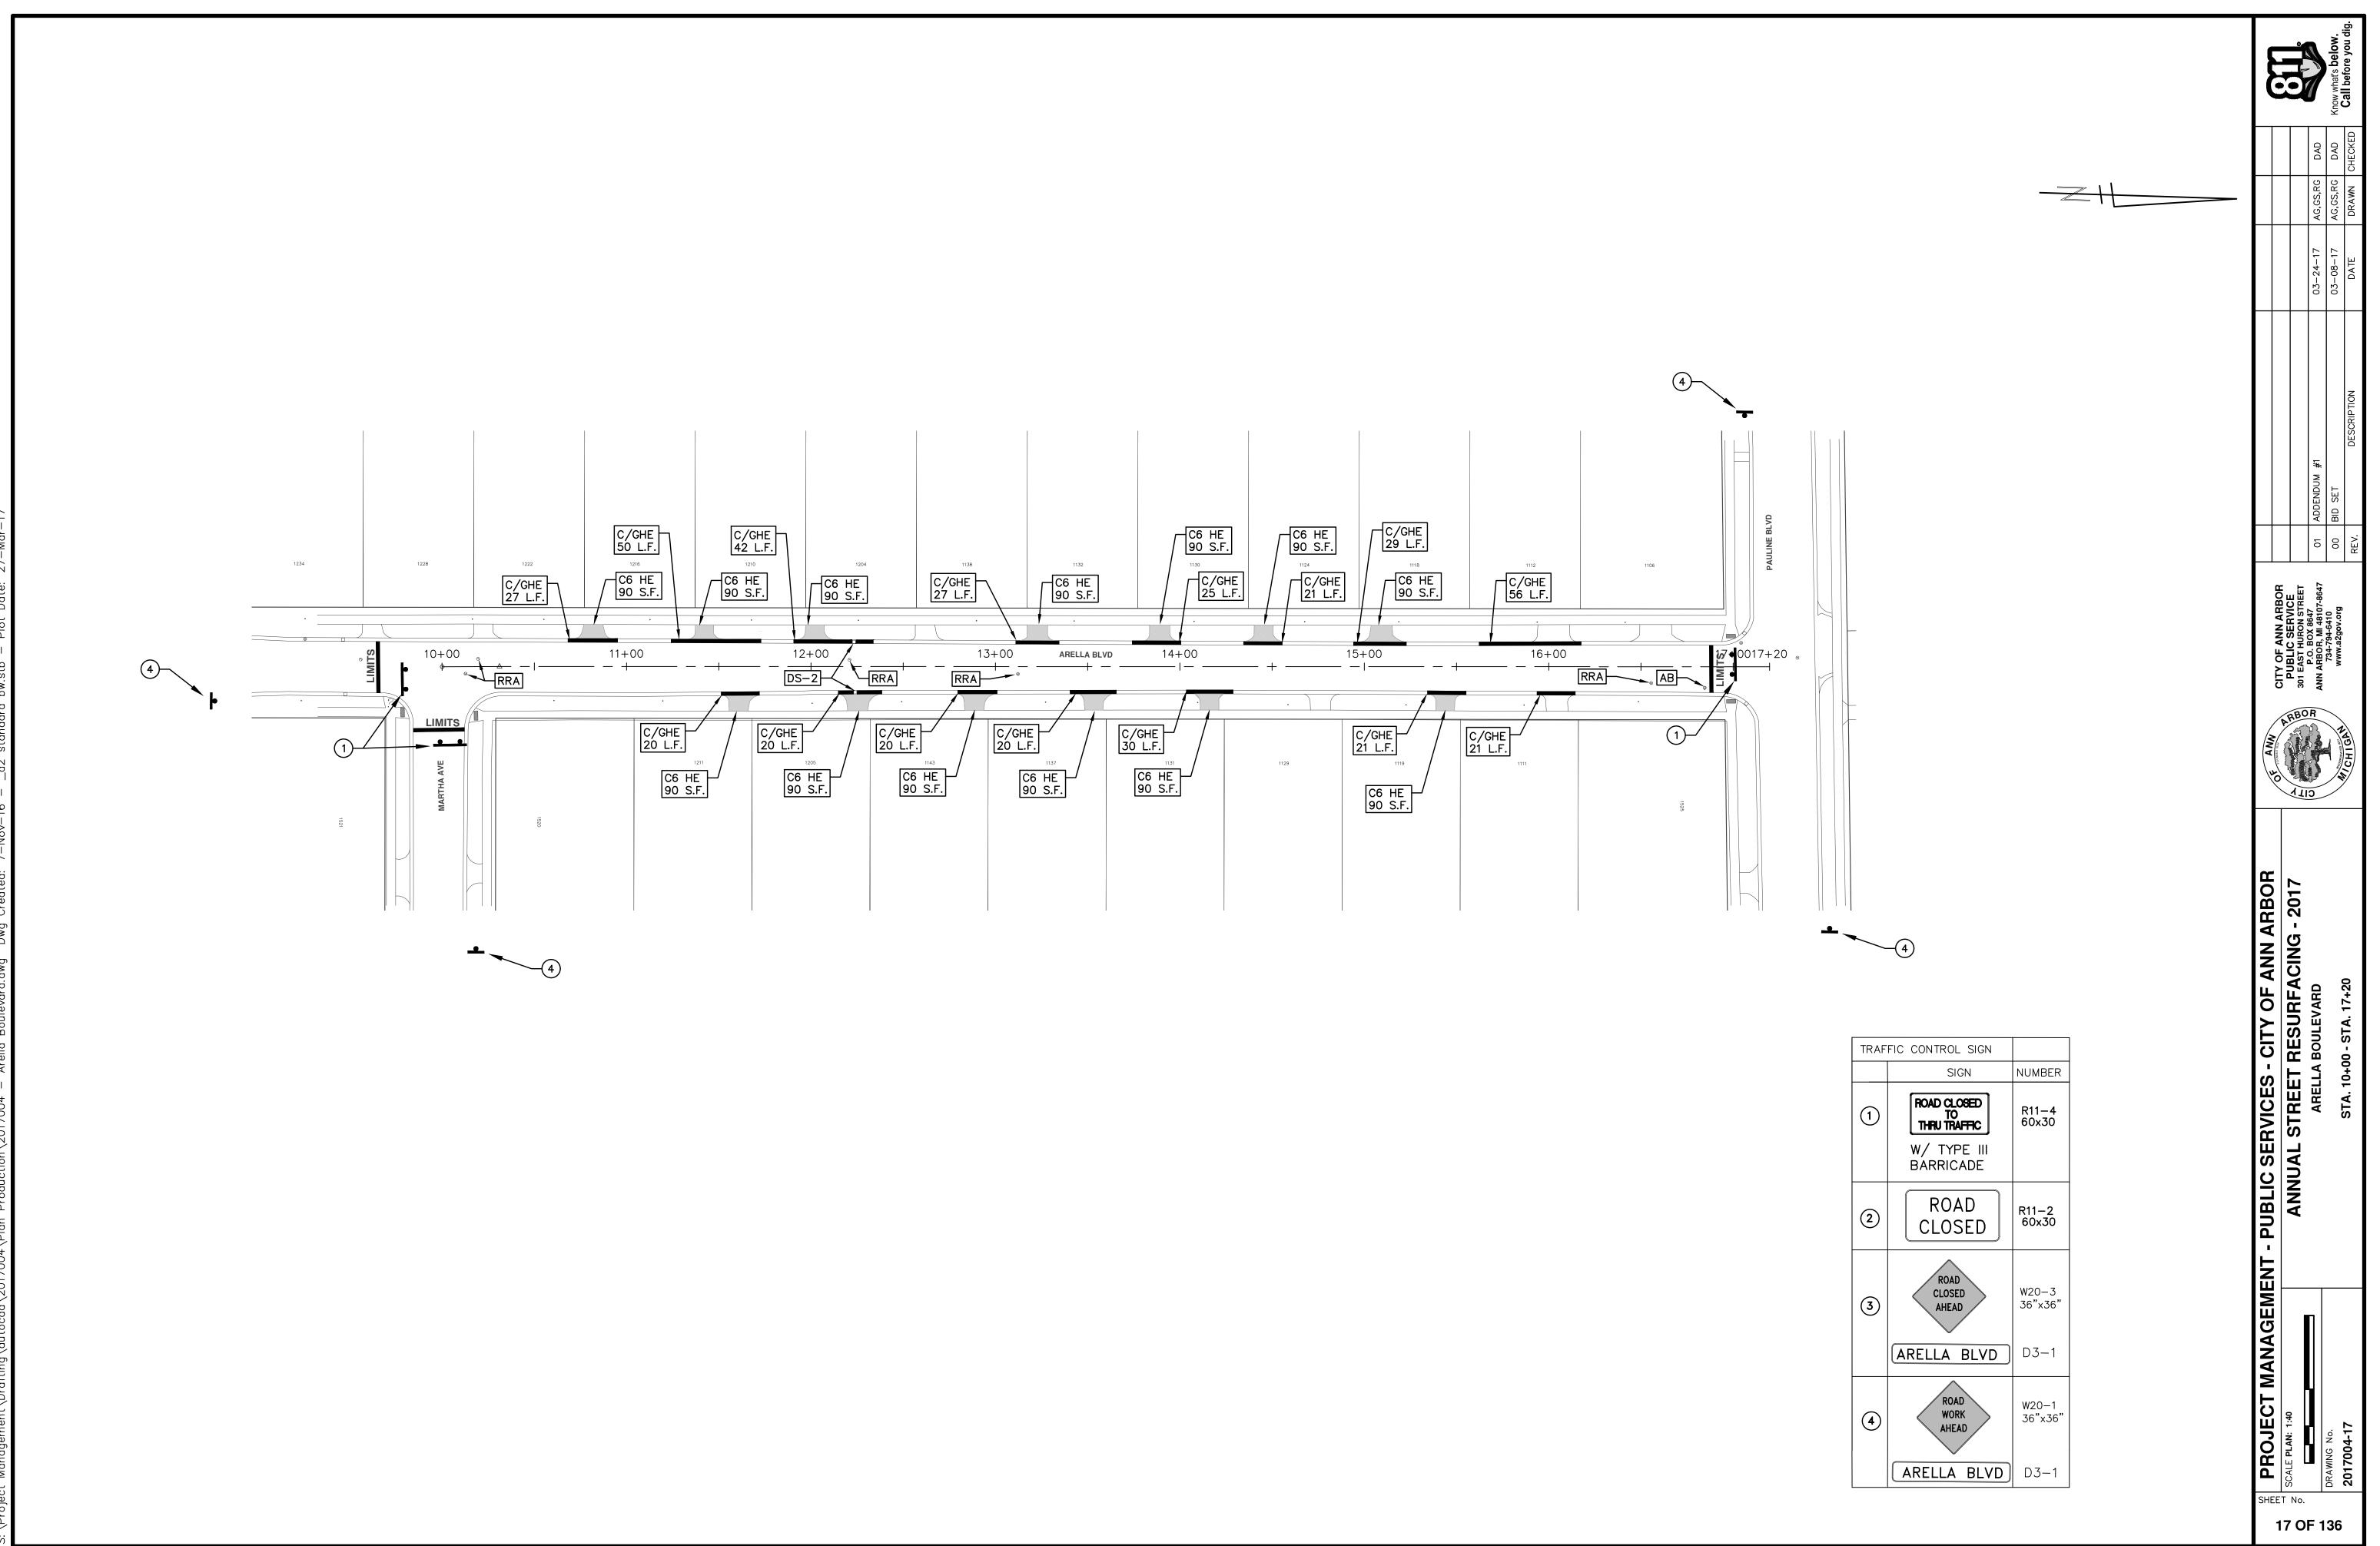



Item Code	Item Description	Units	Quantity
2057011	_Machine Grading, Special	Syd	1,075.000
2057021	_Subgrade Undercutting, Type IIA	Cyd	108.000
5010003	Cold Milling HMA Surface	Ton	243.000
5010703	HMA, LVSP	Ton	243.000
8120012	Barricade, Type III, High Intensity, Double Sided, Lighted, Furn	Ea	2.000
8120013	Barricade, Type III, High Intensity, Double Sided, Lighted, Oper	Ea	2.000
8120260	Plastic Drum, High Intensity, Lighted, Furn	Ea	15.000
8120261	Plastic Drum, High Intensity, Lighted, Oper	Ea	15.000
8120350	Sign, Type B, Temp, Prismatic, Furn	Sft	59.000
8120351	Sign, Type B, Temp, Prismatic, Oper	Sft	59.00
8127050	_No Parking Sign	Ea	11.00

	CONSTRUCTION KEY
KEY	ASSOCIATED PAY ITEM(S)
	Dr Structure, Adj, Case 1, Modified
AA	Dr Structure, Adj, Case 2, Modified
	_Dr Structure, Temp Lowering, Modified
	Dr Structure, Temp Lowering, Modified
	Gate Box, Adj, Case 1
AB	Gate Box, Adj, Case 2
	Monument Box Adjust
ADST	
AK	Dr Structure, Adj, Case 1, Modified
	
C4	Grading, Sidewalk
	 _Sidewalk, Conc, 4 inch, Modified
	 Sidewalk, Sidewalk Ramp, and Driveway Approach, Any Thicknes
	Grading, Sidewalk
C4HE	• Cement
	 _Sidewalk, Conc, 4 inch, Modified
	
	Grading, Sidewalk
00	Grading, Sidewalk Ramp
C6	Detectable Warning Surface, Modified
	 Sidewalk Ramp, Conc, 6 inch, Modified
	 _Sidewalk, Conc, 6 inch, Modified
00	Grading, Driveway Approach
C8	 Driveway, Nonreinf Conc, 8 inch, Modified
	 Sidewalk, Sidewalk Ramp, and Driveway Approach, Any Thicknes
	 Grading, Driveway Approach
	 Grading, Sidewalk
	 _Grading, Sidewalk Ramp
CHE	Cement
U HE	 _Driveway, Nonreinf Conc, 6 inch, Modified
	 Driveway, Nonreinf Conc, 8 inch, Modified
	 Detectable Warning Surface, Modified
	 _Sidewalk Ramp, Conc, 6 inch, Modified
	 _Sidewalk, Conc, 6 inch, Modified
C/G	 _Curb, Gutter, and Curb and Gutter, Any Type, Rem
0/6	_Curb and Gutter, Conc
	 _Curb, Gutter, and Curb and Gutter, Any Type, Rem
C/GHE	Cement
	 _Driveway Opening, Conc, Det M, Modified
CP	_Grading, Sidewalk
UF	 _Sidewalk, Conc, 4 inch, Modified
CR	·_Sidewalk, Sidewalk Ramp, and Driveway Approach, Any Thicknes
	Dr Structure, Rem
DS	 Sewer, Rem, Less than 24 inch
	Dr Structure, 24 inch dia
	Dr Structure, Rem
DSDI	Sewer, Rem, Less than 24 inch
	_Dr Structure, Double Inlet
PT	_Dr Structure, Point
	Dr Structure Cover, Type B
RRA	 _Dr Structure Cover, Type B, Special
RRA	 _Dr Structure, Adj, Case 1, Modified
	Dr Structure, Temp Lowering, Modified
DDK	Dr Structure Cover, Type K
RRK	 _Dr Structure, Adj, Case 1, Modified
RS	_Dr Structure, Reconstruct
TYPE II	Plastic Drum, High Intensity, Lighted, Furn
	Plastic Drum, High Intensity, Lighted, Oper
	· Flastic Dium, riigh intensity, Lighted, Oper
	Barricade, Type III, High Intensity, Double Sided, Lighted, Furn

PROJECT LOCATION: HIGH ORCHARD DRIVE

ITB No. 4477 FILE No. 2017-004

CONSTRUCTION KEY

ess, Rem

ess, Rem

ess, Rem

ess, Rem

ess, Rem

	LEGEND
SYMBOL	DESCRIPTION
S	EXISTING SANITARY SEWER MANHOLE
Ø	EXISTING STORM SEWER MANHOLE
8	EXISTING WATER MAIN VALVE IN WELL
+	WATER MAIN GATE VALVE IN BOX
Ø	FIRE HYDRANT
Ø	MICHCON GAS CO. VALVE BOX/WELL
C	AMERITECH TELEPHONE VAULT
۲	ELECTRIC MANHOLE
•	SOIL BORING
0	EXISTING STORM SEWER INLET
Ð	MONUMENT BOX
	REMOVE AND REPLACE CONC. SIDEWALK
	PLACE CONCRETE SIDEWALK
	REMOVE & REPLACE CONC. CURB & GUTTER
	CONSTRUCTION LIMITS
	6" WRAPPED UNDERDRAIN
	REMOVE CONCRETE SIDEWALK
	SUBGRADE UNDERCUT

CONSTRUCTION METHOD AND SEQUENCING

DIRECTED BY THE ENGINEER. AUTHORIZED OR DIRECTED BY THE ENGINEER.

- 1. IMPLEMENT MAINTENANCE OF TRAFFIC (M.O.T.) PLAN, AND INSTALL SOIL EROSION AND SEDIMENTATION CONTROL MEASURES.
- 2. CONDUCT REMOVAL WORK RELATED TO PAVEMENT, DRAINAGE, AND CONCRETE ITEMS WITH EXCEPTION TO COLDMILLING.
- INSTALL PROPOSED DRAINAGE STRUCTURES, STORM SEWER, AND UNDERDRAIN AS REQUIRED.
- 4. PERFORM ALL CONCRETE WORK, INCLUDING RESTORATION, AS REQUIRED
- TEMPORARY LOWER ALL STRUCTURE COVERS LOCATED WITHIN THE EXISTING PAVEMENT, INCLUDING GATE AND MONUMENT BOXES AS REQUIRED.
- REMOVE 4.0 INCHES OF EXISTING HMA SURFACE BY COLDMILLING. THIS MAY INCLUDE GRANULAR BASE MATERIAL. DEPTH TO BE DETERMINED BY THE ENGINEER. PROOF ROLL WITH FULLY LOADED TRUCK.
- 7. PERFORM ALL JOINT AND CRACK CLEANOUT, HMA/HAND PATCHING, UNDERCUTS AND/OR BASE REPAIRS AS REQUIRED.
- 8. GRADE, SHAPE, AND COMPACT THE EXISTING BASE MATERIAL AS DIRECTED.
- 9. CLEAN PAVEMENT AS REQUIRED, AND PLACE 2.0 INCH LEVELING COURSE HMA MIX (LOCAL STREETS).
- 10. ADJUST ALL STRUCTURE COVERS, INCLUDING GATE AND MONUMENT BOXES, TO THEIR FINISHED ELEVATIONS AS REQUIRED.
- 11. CLEAN PAVEMENT AND PLACE 2.0 INCH TOP COURSE HMA MIX (LOCAL STREETS).
- 12. CLEAN PAVEMENT AND COMPLETE ALL PAVEMENT MARKINGS.
- 13. COMPLETE ALL MISCELLANEOUS CONSTRUCTION INCLUDING ALL CLEAN UP AND FINAL RESTORATION.
- 14. REMOVE ALL TRAFFIC CONTROL DEVICES, AND MISS DIG FLAGS.

NOTES:

		QUANTITIES		
		Sign, Type B, Temp, Prismatic		
Quantity	Sign Code	Description	Area (sft)	Total Area
4.0	D3-1	Street Name Sign	4.000	16.000
2.0	R11-4	Road Closed Sign ("Road Closed To Thru Traffic")	12.500	25.000
2.0	W20-1	Road Work Ahead Sign	9.000	18.000
			TOTAL	59.000

IN ACCORDANCE WITH THE SCHEDULE OF STREETS WORK ON THIS STREET IS TO OCCUR CONCURRENTLY WI THAT PROPOSED FOR HIGH ORCHARD COURT. WORK ON THIS STREET INCLUDES, BUT IS NOT FOLLOWING ITEMS. COMPLETE THE WORK IN ACCORDANCE WITH THE PLANS AND SPECIFICATIONS, AND AS PERFORM THE WORK IN THE ORDER INDICATED BELOW

> FOR PROTECTION OF UNDERGROUND UTILITIES AND IN CONFORMANCE WITH PUBLIC ACT 174 OF 2013, THE CONTRACTOR SHALL CALL 811 OR 1-800-482-7171 A MINIMUM OF THREE FULL WORKING DAYS, EXCLUDING SATURDAYS, SUNDAYS, AND HOLIDAYS, PRIOR TO BEGINNING EACH EXCAVATION IN AREAS WHERE PUBLIC UTILITIES HAVE NOT BEEN PREVIOUSLY LOCATED. MEMBERS WILL THUS BE ROUTINELY NOTIFIED. THIS DOES NOT RELIEVE THE CONTRACTOR OF THE RESPONSIBILITY OF NOTIFYING UTILITY OWNERS WHO MAY NOT BE A PART OF THE "MISS DIG" ALERT SYSTEM.


THE UNDERGROUND LOCATIONS SHOWN FOR NATURAL GAS, TELEPHONE, ELECTRICAL POWER, CABLE TV AND FIBER OPTIC LINES ARE APPROXIMATE. THE CITY OF ANN ARBOR ASSUMES NO RESPONSIBILITY FOR THEIR ACCURATE REPRESENTATION IN THIS DRAWING. MISS DIG MUST BE CONTACTED PRIOR TO CONSTRUCTION TO LOCATE THESE UTILITIES.

THE IMPROVEMENTS COVERED BY THESE PLANS SHALL BE PERFORMED IN ACCORDANCE WITH MICHIGAN DEPARTMENT OF TRANSPORTATION (MDOT) 2012 STANDARD SPECIFICATIONS FOR CONSTRUCTION, INCLUDING REFERENCED MDOT PUBLICATIONS, AND THE PROJECT CONTRACT DOCUMENTS.



Know what's below. Call before you dig.

MENT - PUBLIC SERVICES - CITY OF ANN ARBOR	PROJECT DESCRIPTION ANNUAL STREET RESURFACING - 2017	HIGH ORCHARD DRIVE
	T No.	DRAWING No. 2017004-18

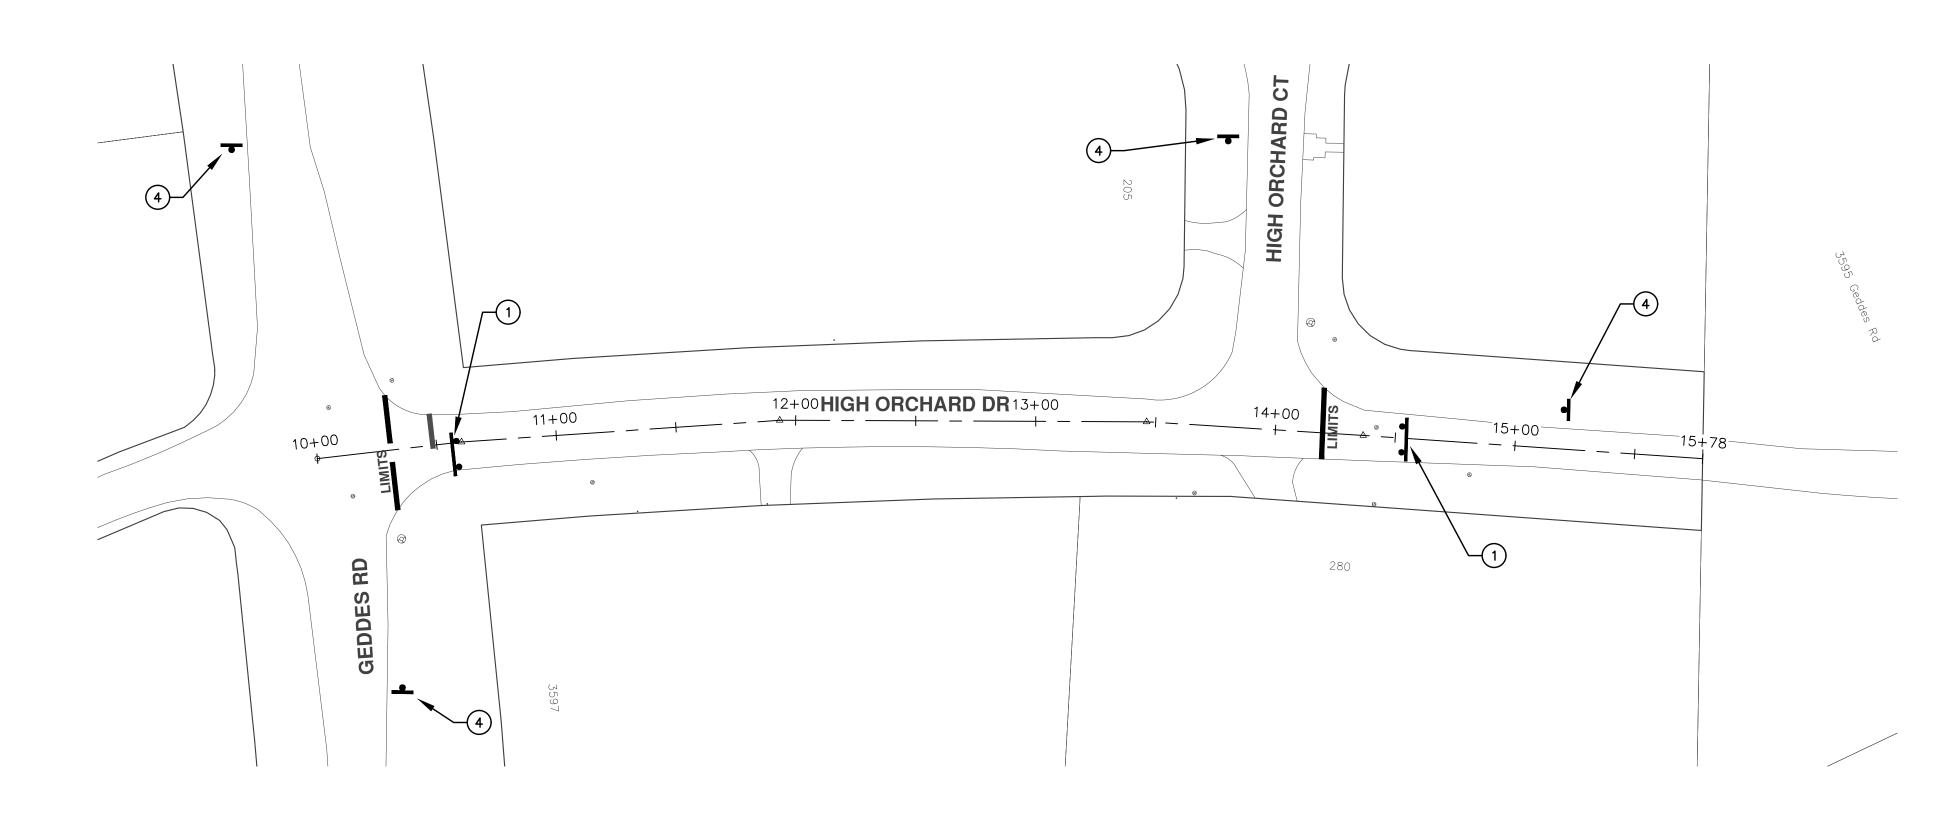

				ŀ					
	PROJECT MANAGEME	ANAGEMENT - PUBLIC SERVICES - CITY OF ANN ARBOR	AMA						
1									
9	H SCALE PLAN: 1.40								
C	N O	ANNUAL STREET RESURFACING - 2017	L/ 2016 SCH VICE 301 EAST HURON STREET						e D
)F			C BOX 8647 BOX 8647 BOX 8647	5					
1			ANN ARBOR, MI 48107-8647	-0	01 AUDENDUM #1	00-24-17	92,62,RG	DAD	
36	DRAWING No.		734-794-6410 With a 24-04 ord	8	00 BID SET	03-08-17	AG,GS,RG	DAD	Know what's below.
5		CT \$ 10,00 CT \$ 15,70							
	201/004-19	SIA. 10+00 - SIA. 13+78	VCH1GM	REV.	DESCRIPTION	DATE	DRAWN	DRAWN CHECKED	

	FIC CONTROL SIGN	NUMBER
	51611	NUMBER
1	ROAD CLOSED TO THRU TRAFFIC W/ TYPE III BARRICADE	R11-4 60×30
2	ROAD CLOSED	R11-2 60x30
3	ROAD CLOSED AHEAD	W20-3 36"x36"
	HIGH ORCHARD DR.	D3-1
4	ROAD WORK AHEAD	W20-1 36"x36"
	HIGH ORCHARD DR.	D3-1

H



PROJECT LOCATION: HIGH ORCHARD COURT

	QUANTITIES			
Item Code	Item Description	Units	Quantity	
2057011	_Machine Grading, Special	Syd	1,315.000	
2057021	_Subgrade Undercutting, Type IIA	Cyd	45.000	
4037050	_Dr Structure, Adj, Case 1, Modified	Ea	1.000	
4037050	_Dr Structure, Temp Lowering, Modified	Ea	1.000	
5010003	Cold Milling HMA Surface	Ton	298.000	
5010703	HMA, LVSP	Ton	298.000	
8120012	Barricade, Type III, High Intensity, Double Sided, Lighted, Furn	Ea	1.000	
8120013	Barricade, Type III, High Intensity, Double Sided, Lighted, Oper	Ea	1.000	
8120260	Plastic Drum, High Intensity, Lighted, Furn	Ea	11.000	
8120261	Plastic Drum, High Intensity, Lighted, Oper	Ea	11.000	
8120350	Sign, Type B, Temp, Prismatic, Furn	Sft	38.500	
8120351	Sign, Type B, Temp, Prismatic, Oper	Sft	38.500	
8127050	_No Parking Sign	Ea	7.000	

T
Mar
⊿- ∠
N.
ate:
\Box
lot
<u>م</u>
.stb
≥ A
ק
ppu
stai
2
٦
Ι
-16
->0
ž I
Ļ
ted:
eat
Š
٨g
Ó
б×
ð.
ourt
Ŭ —
are
rchard
n Orchard
High Orchard
High (
H – High (
H – High (
017004 – High (
17004 – High (
017004 – High (
017004 – High (
017004 – High (
017004 – High (
an Production\2017004 - High (
an Production\2017004 - High (
an Production\2017004 - High (
roduction\2017004 - High (
an Production\2017004 - High (
.017004\Plan Production\2017004 - High (
.017004\Plan Production\2017004 - High (
.017004\Plan Production\2017004 - High (
.017004\Plan Production\2017004 - High (
\autocad\2017004\Plan Production\2017004 - High (
\autocad\2017004\Plan Production\2017004 - High (
\autocad\2017004\Plan Production\2017004 - High (
ment\Drafting\autocad\2017004\PIan Production\2017004 - High (
\autocad\2017004\Plan Production\2017004 - High (
ement\Drafting\autocad\2017004\PIan Production\2017004 - High (
t Management\Drafting\autocad\2017004\Plan Production\2017004 - High (
.ject Management\Drafting\autocad\2017004\Plan Production\2017004 - High (
ct Management\Drafting\autocad\2017004\Plan Production\2017004 - High (

	CONSTRUCTION KEY
KEY	ASSOCIATED PAY ITEM(S)
	_Dr Structure, Adj, Case 1, Modified
AA	_Dr Structure, Adj, Case 2, Modified
	Dr Structure, Temp Lowering, Modified
	 _Dr Structure, Temp Lowering, Modified Gate Box, Adj, Case 1
AB	
	Gate Box, Adj, Case 2 Monument Box, Adjust
ADST	Monument Box Adjust
AK	 _Dr Structure, Adj, Add Depth, Modified Dr Structure, Adj, Case 1, Modified
	 Sidewalk, Sidewalk Ramp, and Driveway Approach, Any Thickness, Rem
C4	 Grading, Sidewalk
01	_Sidewalk, Conc, 4 inch, Modified
	 _Sidewalk, Sidewalk Ramp, and Driveway Approach, Any Thickness, Rem
	Grading, Sidewalk
C4HE	Cement
	 _Sidewalk, Conc, 4 inch, Modified
	 Sidewalk, Sidewalk Ramp, and Driveway Approach, Any Thickness, Rem
	 Grading, Sidewalk
	Grading, Sidewalk Ramp
C6	Detectable Warning Surface, Modified
	Sidewalk Ramp, Conc, 6 inch, Modified
	• _Sidewalk, Conc, 6 inch, Modified
	Grading, Driveway Approach
C8	
	 Sidewalk, Sidewalk Ramp, and Driveway Approach, Any Thickness, Ren
	Grading, Driveway Approach
	• _Grading, Sidewalk
	Grading, Sidewalk Ramp
	• Cement
C HE	
	Detectable Warning Surface, Modified
	 Sidewalk Ramp, Conc, 6 inch, Modified
	 _Sidewalk, Conc, 6 inch, Modified
	Curb, Gutter, and Curb and Gutter, Any Type, Rem
C/G	• _Curb and Gutter, Conc
	Curb, Gutter, and Curb and Gutter, Any Type, Rem
C/GHE	Cement
	Driveway Opening, Conc, Det M, Modified
	Grading, Sidewalk
CP	 _Sidewalk, Conc, 4 inch, Modified
CR	 _Sidewalk, Sidewalk Ramp, and Driveway Approach, Any Thickness, Ren
~ ,	Dr Structure, Rem
DS	Sewer, Rem, Less than 24 inch
	• Dr Structure, 24 inch dia
	• Dr Structure, Rem
DSDI	Sewer, Rem, Less than 24 inch
2001	• _Dr Structure, Double Inlet
PT	Dr Structure, Point
	Dr Structure Cover, Type B
	_Dr Structure Cover, Type B, Special
RRA	 Dr Structure, Adj, Case 1, Modified
	• _Dr Structure, Temp Lowering, Modified
	Dr Structure Cover, Type K
RRK	• _Dr Structure, Adj, Case 1, Modified
RS	_Dr Structure, Reconstruct
	Plastic Drum, High Intensity, Lighted, Furn
YPE II	 Plastic Drum, High Intensity, Lighted, Purn Plastic Drum, High Intensity, Lighted, Oper
	Plastic Drum, High Intensity, Lighted, Oper Barricade, Type III, High Intensity, Double Sided, Lighted, Fum

CITY OF ANN ARBOR PROJECT MANAGEMENT

ITB No. 4477 FILE No. 2017-004

LEGEND		
SYMBOL	DESCRIPTION	
S	EXISTING SANITARY SEWER MANHOLE	
(r)	EXISTING STORM SEWER MANHOLE	
\otimes	EXISTING WATER MAIN VALVE IN WELL	
+	WATER MAIN GATE VALVE IN BOX	
+Ç+	FIRE HYDRANT	
(g)	MICHCON GAS CO. VALVE BOX/WELL	
t	AMERITECH TELEPHONE VAULT	
e	ELECTRIC MANHOLE	
\bullet	SOIL BORING	
	EXISTING STORM SEWER INLET	
•	MONUMENT BOX	
	REMOVE AND REPLACE CONC. SIDEWALK	
	PLACE CONCRETE SIDEWALK	
	REMOVE & REPLACE CONC. CURB & GUTTER	
	CONSTRUCTION LIMITS	
<u> </u>	6" WRAPPED UNDERDRAIN	
	REMOVE CONCRETE SIDEWALK	
	SUBGRADE UNDERCUT	

CONSTRUCTION METHOD AND SEQUENCING

IN ACCORDANCE WITH THE SCHEDULE OF STREETS WORK ON THIS STREET IS TO OCCUR CONCURRENTLY WITH THAT PROPOSED FOR HIGH ORCHARD DRIVE. WORK ON THIS STREET INCLUDES, BUT IS NOT LIMITED FOLLOWING ITEMS. COMPLETE THE WORK IN ACCORDANCE WITH THE PLANS AND SPECIFICATIONS, AND AS DIRECTED BY THE ENGINEER. PERFORM THE WORK IN THE ORDER INDICATED BELOW UNLESS OTHERWISE AUTHORIZED OR DIRECTED BY THE ENGINEER.

- CONTROL MEASURES.
- COLDMILLING.

- AND MONUMENT BOXES AS REQUIRED.
- REQUIRED.

- AS REQUIRED.
- 12. CLEAN PAVEMENT AND COMPLETE ALL PAVEMENT MARKINGS.
- 14. REMOVE ALL TRAFFIC CONTROL DEVICES, AND MISS DIG FLAGS.

		QUANTITIES			
		Sign, Type B, Temp, Prismatic			
Quantity	Sign Code	Description	Area (sft)	Total Area	FOR F 174 C
2.0	D3-1	Street Name Sign	4.000	8.000	THREE
1.0	R11-4	Road Closed Sign ("Road Closed To Thru Traffic")	12.500	12.500	
2.0	W20-1	Road Work Ahead Sign	9.000	18.000	PREVI RELIE
			τοται	38,500	

THE UNDERGROUND LOCATIONS SHOWN FOR NATURAL GAS, TELEPHONE, ELECTRICAL POWER, CABLE TV AND FIBER OPTIC LINES ARE APPROXIMATE. THE CITY OF ANN ARBOR ASSUMES NO RESPONSIBILITY FOR THEIR ACCURATE REPRESENTATION IN THIS DRAWING. MISS DIG MUST BE CONTACTED PRIOR TO CONSTRUCTION TO LOCATE THESE UTILITIES.



IMPLEMENT MAINTENANCE OF TRAFFIC (M.O.T.) PLAN, AND INSTALL SOIL EROSION AND SEDIMENTATION

2. CONDUCT REMOVAL WORK RELATED TO PAVEMENT, DRAINAGE, AND CONCRETE ITEMS WITH EXCEPTION TO

3. INSTALL PROPOSED DRAINAGE STRUCTURES, STORM SEWER, AND UNDERDRAIN AS REQUIRED.

4. PERFORM ALL CONCRETE WORK, INCLUDING RESTORATION, AS REQUIRED.

5. TEMPORARY LOWER ALL STRUCTURE COVERS LOCATED WITHIN THE EXISTING PAVEMENT, INCLUDING GATE

6. REMOVE 4.0 INCHES OF EXISTING HMA SURFACE BY COLDMILLING. THIS MAY INCLUDE GRANULAR BASE MATERIAL. DEPTH TO BE DETERMINED BY THE ENGINEER. PROOF ROLL WITH FULLY LOADED TRUCK.

PERFORM ALL JOINT AND CRACK CLEANOUT, HMA/HAND PATCHING, UNDERCUTS AND/OR BASE REPAIRS AS

8. GRADE, SHAPE, AND COMPACT THE EXISTING BASE MATERIAL AS DIRECTED.

9. CLEAN PAVEMENT AS REQUIRED, AND PLACE 2.0 INCH LEVELING COURSE HMA MIX (LOCAL STREETS).

10. ADJUST ALL STRUCTURE COVERS, INCLUDING GATE AND MONUMENT BOXES, TO THEIR FINISHED ELEVATIONS

11. CLEAN PAVEMENT AND PLACE 2.0 INCH TOP COURSE HMA MIX (LOCAL STREETS).

13. COMPLETE ALL MISCELLANEOUS CONSTRUCTION INCLUDING ALL CLEAN UP AND FINAL RESTORATION.


<u>'ES</u>:

PROTECTION OF UNDERGROUND UTILITIES AND IN CONFORMANCE WITH PUBLIC ACT OF 2013, THE CONTRACTOR SHALL CALL 811 OR 1-800-482-7171 A MINIMUM OF E FULL WORKING DAYS, EXCLUDING SATURDAYS, SUNDAYS, AND HOLIDAYS, PRIOR BEGINNING EACH EXCAVATION IN AREAS WHERE PUBLIC UTILITIES HAVE NOT BEEN VIOUSLY LOCATED. MEMBERS WILL THUS BE ROUTINELY NOTIFIED. THIS DOES NOT EVE THE CONTRACTOR OF THE RESPONSIBILITY OF NOTIFYING UTILITY OWNERS ________WHO MAY NOT BE A PART OF THE "MISS DIG" ALERT SYSTEM.


THE IMPROVEMENTS COVERED BY THESE PLANS SHALL BE PERFORMED IN ACCORDANCE WITH MICHIGAN DEPARTMENT OF TRANSPORTATION (MDOT) 2012 STANDARD SPECIFICATIONS FOR CONSTRUCTION, INCLUDING REFERENCED MDOT PUBLICATIONS, AND THE PROJECT CONTRACT DOCUMENTS.

PROJECT DESCRIPTION ANNUAL STREET RESURFACING - 2017	HIGH ORCHARD COURT
т No. 0 ОF	DRAWNG No. 2017004-20
	PROJECT DESCRIPTION



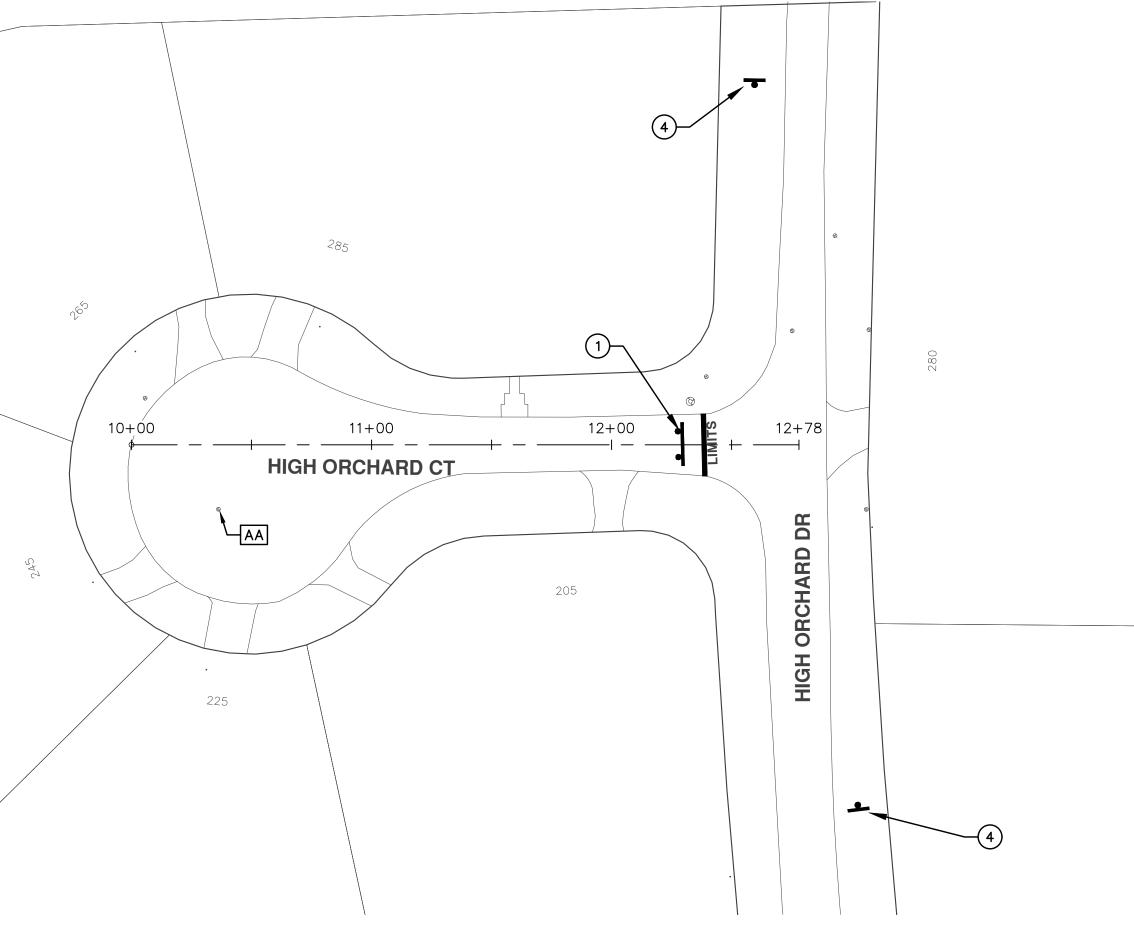

	E PRO.IFCT MANAGEME	NAGEMENT - PURLIC SERVICES - CITY OF ANN ARROR	ANA						
	SCALE PLAN: 1:40	ANNUAL STREET RESURFACING - 2017	LA BUBLIC BUBLIC BUBLIC BUBLIC	PUBLIC SERVICE					
F 1		HIGH ORCHARD COURT	CI P.O. B. ANN ARBOR,		01 ADDENDUM #1	03-24-17	AG,GS,RG) DAD	
36	DRAWING No.		734-7'	734-794-6410 www.a2gov.org	00 BID SET	03-08-17	AG,GS,RG	DAD 2	Know what's below
	2017004-21	SIA. 10+00 - SIA. 12+78	CHIGN	REV	V. DESCRIPTION	DATE	DRAWN	DRAWN CHECKED	Call before you dig.

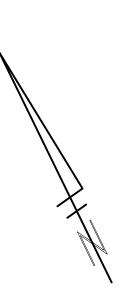

TRAF	FIC CONTROL SIGN	
	SIGN	NUMBER
1	HOAD CLOSED TO THRU TRAFFIC W/ TYPE III BARRICADE	R11-4 60x30
2	ROAD CLOSED	R11-2 60x30
3	ROAD CLOSED AHEAD HIGH ORCHARD CT.	₩20-3 36"x36" D3-1
	HIGH ORCHARD CI.	
4	ROAD WORK AHEAD	W20-1 36"x36"
	HIGH ORCHARD CT.	D3-1



PROJECT MANAGEMENT **PROJECT LOCATION: ISLAND DRIVE -**CANAL ST TO WALL ST

QUANTITIES			
ltem Code	Item Description	Units	Quantity
2047001	_Curb, Gutter, and Curb and Gutter, Any Type, Rem	Ft	25.000
2047011	_Sidewalk, Sidewalk Ramp, and Driveway Approach, Any Thickness, Rem	Syd	125.000
2047050	_Parking Blocks, Rem	Ea	20.000
2047050	_Landscape Boulder, Rem and Salvage	Ea	60.000
2057011	_Grading, Sidewalk	Syd	23.000
2057011	_Grading, Sidewalk Ramp	Syd	20.000
2057011	_Machine Grading, Special	Syd	578.000
2057011	_Machine Grading, Parking Area & Driveway Entrance	Syd	500.000
2057021	_Subgrade Undercutting, Type IIA	Cyd	58.000
5010003	Cold Milling HMA Surface	Ton	131.000
5010005	HMA Surface, Rem	Syd	44.440
5010703	HMA, LVSP	Ton	131.000
8060040	Shared use Path, HMA	Ton	42.000
6027021	_Flowable Fill	Cyd	0.926
8027001	_Curb and Gutter, Conc	Ft	225.000
8037001	_Detectable Warning Surface, Modified	Ft	10.000
8037010	_Sidewalk Ramp, Conc, 6 inch, Modified	Sft	175.000
8037010	_Sidewalk, Conc, 4 inch, Modified	Sft	200.000
8117001	_Pavt Mrkg, Wet Retrflec, Thermopl, 6 inch, Crosswalk	Ft	45.000
8120012	Barricade, Type III, High Intensity, Double Sided, Lighted, Furn	Ea	2.000
8120013	Barricade, Type III, High Intensity, Double Sided, Lighted, Oper	Ea	2.000
8120260	Plastic Drum, High Intensity, Lighted, Fum	Ea	25.000
8120261	Plastic Drum, High Intensity, Lighted, Oper	Ea	25.000
8120350	Sign, Type B, Temp, Prismatic, Furn	Sft	59.000
8120351	Sign, Type B, Temp, Prismatic, Oper	Sft	59.000
8127050	_No Parking Sign	Ea	7.000
8167011	_Slope Restoration	Syd	424.000

	CONSTRUCTION KEY
KEY	ASSOCIATED PAY ITEM(S)
	_Dr Structure, Adj, Case 1, Modified
AA	 Dr Structure, Adj, Case 1, Modified Dr Structure, Adj, Case 2, Modified
	_Dr Structure, Temp Lowering, Modified
	_Dr Structure, Temp Lowering, Modified
	• _Gate Box, Adj, Case 1
AB	Gate Box, Adj, Case 2
	Monument Box Adjust
ADST	_Dr Structure, Adj, Add Depth, Modified
AK	 _Dr Structure, Adj, Case 1, Modified
	• _Sidewalk, Sidewalk Ramp, and Driveway Approach, Any Thickness, Rem
C4	 _Grading, Sidewalk
	_Sidewalk, Conc, 4 inch, Modified
	• _Sidewalk, Sidewalk Ramp, and Driveway Approach, Any Thickness, Rem
C4HE	• _Grading, Sidewalk
	Cement Sidewalk Cone 4 inch Madified
	 _Sidewalk, Conc, 4 inch, Modified Sidewalk, Sidewalk Ramp, and Driveway Approach, Any Thickness, Rem
	• _Grading, Sidewalk
No. 3	Grading, Sidewalk Ramp
C6	Detectable Warning Surface, Modified
	 Sidewalk Ramp, Conc, 6 inch, Modified
	 Sidewalk, Conc, 6 inch, Modified
C8	Grading, Driveway Approach
0	 _Driveway, Nonreinf Conc, 8 inch, Modified
	• _Sidewalk, Sidewalk Ramp, and Driveway Approach, Any Thickness, Rem
	 _Grading, Driveway Approach
	• _Grading, Sidewalk
	• _Grading, Sidewalk Ramp
C HE	Cement Drivery Neuroinf Cane, Clinck, Madified
	 _Driveway, Nonreinf Conc, 8 inch, Modified _Detectable Warning Surface, Modified
	_Sidewalk, Conc, 6 inch, Modified
0/0	_Curb, Gutter, and Curb and Gutter, Any Type, Rem
C/G	Curb and Gutter, Conc
	 _Curb, Gutter, and Curb and Gutter, Any Type, Rem
C/GHE	Cement
	 _Driveway Opening, Conc, Det M, Modified
CP	 _Grading, Sidewalk
	_Sidewalk, Conc, 4 inch, Modified
CR	• _Sidewalk, Sidewalk Ramp, and Driveway Approach, Any Thickness, Rem
DC	Dr Structure, Rem Source Demotions then 24 inch
DS	 Sewer, Rem, Less than 24 inch Dr Structure, 24 inch dia
	• Dr Structure, Rem
DSDI	Sewer, Rem, Less than 24 inch
DODI	_Dr Structure, Double Inlet
PT	Dr Structure, Point
	Dr Structure Cover, Type B
RRA	• _Dr Structure Cover, Type B, Special
RRA	 _Dr Structure, Adj, Case 1, Modified
	_Dr Structure, Temp Lowering, Modified
RRK	Dr Structure Cover, Type K
The second cases for	_Dr Structure, Adj, Case 1, Modified
RS	_Dr Structure, Reconstruct
TYPE II	Plastic Drum, High Intensity, Lighted, Furn
	Plastic Drum, High Intensity, Lighted, Oper Sided Lighted Furp
TYPE III	 Barricade, Type III, High Intensity, Double Sided, Lighted, Furn Barricade, Type III, High Intensity, Double Sided, Lighted, Oper
	- Damoade, Type III, Fligh Intensity, Double Slued, Lighted, Oper

CITY OF ANN ARBOR

ITB No. 4477 FILE No. 2017-004

LEGEND		
SYMBOL	DESCRIPTION	
S	EXISTING SANITARY SEWER MANHOLE	
(r)	EXISTING STORM SEWER MANHOLE	
\otimes	EXISTING WATER MAIN VALVE IN WELL	
+	WATER MAIN GATE VALVE IN BOX	
+Ç+	FIRE HYDRANT	
(g)	MICHCON GAS CO. VALVE BOX/WELL	
t	AMERITECH TELEPHONE VAULT	
e	ELECTRIC MANHOLE	
Ð	SOIL BORING	
	EXISTING STORM SEWER INLET	
٥	MONUMENT BOX	
	REMOVE AND REPLACE CONC. SIDEWALK	
	PLACE CONCRETE SIDEWALK	
	REMOVE & REPLACE CONC. CURB & GUTTER	
	CONSTRUCTION LIMITS	
— · —	6" WRAPPED UNDERDRAIN	
	REMOVE CONCRETE SIDEWALK	
	SUBGRADE UNDERCUT	

CONSTRUCTION METHOD AND SEQUENCING

WORK ON THIS STREET INCLUDES, BUT IS NOT LIMITED TO, THE FOLLOWING ITEMS. COMPLETE THE WORK IN ACCORDANCE WITH THE PLANS AND SPECIFICATIONS, AND AS DIRECTED BY THE IN THE ORDER INDICATED BELOW UNLESS OTHERWISE AUTHORIZED OR DIRECTED BY THE ENGINEER

- CONTROL MEASURES.
- COLDMILLING.

- AND MONUMENT BOXES AS REQUIRED.
- **REQUIRED.**

- AS REQUIRED.
- 12. CLEAN PAVEMENT AND COMPLETE ALL PAVEMENT MARKINGS.
- 14. REMOVE ALL TRAFFIC CONTROL DEVICES, AND MISS DIG FLAGS.

FOR	
174	
THR	c
	_
TO	E
DDE	١

QUANTITIES				
		Sign, Type B, Temp, Prismatic		
Quantity	Sign Code	Description	Area (sft)	Total Area
4.0	D3-1	Street Name Sign	4.000	16.000
2.0	R11-4	Road Closed Sign ("Road Closed To Thru Traffic")	12.500	25.000
1.0	W20-1	Road Work Ahead Sign	9.000	9.000
1.0	W20-3	Road Closed Ahead Sign	9.000	9.000
			TOTAL	59.000

IMPLEMENT MAINTENANCE OF TRAFFIC (M.O.T.) PLAN, AND INSTALL SOIL EROSION AND SEDIMENTATION

CONDUCT REMOVAL WORK RELATED TO PAVEMENT, DRAINAGE, AND CONCRETE ITEMS WITH EXCEPTION TO

INSTALL PROPOSED DRAINAGE STRUCTURES, STORM SEWER, AND UNDERDRAIN AS REQUIRED.

4. PERFORM ALL CONCRETE WORK, INCLUDING RESTORATION, AS REQUIRED.

TEMPORARY LOWER ALL STRUCTURE COVERS LOCATED WITHIN THE EXISTING PAVEMENT, INCLUDING GATE

REMOVE 4.0 INCHES OF EXISTING HMA SURFACE BY COLDMILLING. THIS MAY INCLUDE GRANULAR BASE MATERIAL. DEPTH TO BE DETERMINED BY THE ENGINEER. PROOF ROLL WITH FULLY LOADED TRUCK.

7. PERFORM ALL JOINT AND CRACK CLEANOUT. HMA/HAND PATCHING, UNDERCUTS AND/OR BASE REPAIRS AS

8. GRADE, SHAPE, AND COMPACT THE EXISTING BASE MATERIAL AS DIRECTED.

9. CLEAN PAVEMENT AS REQUIRED, AND PLACE 2.0 INCH LEVELING COURSE HMA MIX (LOCAL STREETS).

10. ADJUST ALL STRUCTURE COVERS, INCLUDING GATE AND MONUMENT BOXES, TO THEIR FINISHED ELEVATIONS

11. CLEAN PAVEMENT AND PLACE 2.0 INCH TOP COURSE HMA MIX (LOCAL STREETS).

13. COMPLETE ALL MISCELLANEOUS CONSTRUCTION INCLUDING ALL CLEAN UP AND FINAL RESTORATION.

NOTES:

PROTECTION OF UNDERGROUND UTILITIES AND IN CONFORMANCE WITH PUBLIC ACT OF 2013, THE CONTRACTOR SHALL CALL 811 OR 1-800-482-7171 A MINIMUM OF REE FULL WORKING DAYS, EXCLUDING SATURDAYS, SUNDAYS, AND HOLIDAYS, PRIOR BEGINNING EACH EXCAVATION IN AREAS WHERE PUBLIC UTILITIES HAVE NOT BEEN PREVIOUSLY LOCATED. MEMBERS WILL THUS BE ROUTINELY NOTIFIED. THIS DOES NOT RELIEVE THE CONTRACTOR OF THE RESPONSIBILITY OF NOTIFYING UTILITY OWNERS WHO MAY NOT BE A PART OF THE "MISS DIG" ALERT SYSTEM.

THE UNDERGROUND LOCATIONS SHOWN FOR NATURAL GAS. TELEPHONE, ELECTRICAL POWER. CABLE TV AND FIBER OPTIC LINES ARE APPROXIMATE. THE CITY OF ANN ARBOR ASSUMES NO RESPONSIBILITY FOR THEIR ACCURATE REPRESENTATION IN THIS DRAWING. MISS DIG MUST BE CONTACTED PRIOR TO CONSTRUCTION TO LOCATE THESE UTILITIES.

THE IMPROVEMENTS COVERED BY THESE PLANS SHALL BE PERFORMED IN ACCORDANCE WITH MICHIGAN DEPARTMENT OF TRANSPORTATION (MDOT) 2012 STANDARD SPECIFICATIONS FOR CONSTRUCTION, INCLUDING REFERENCED MDOT PUBLICATIONS, AND THE PROJECT CONTRACT DOCUMENTS.





PROJECT MANAGEMENT SERVICES UNIT CITY OF ANN ARBOR PUBLIC SERVICES 301 EAST HURON STREET, P.O. BOX 8647 ANN ARBOR, MICHIGAN 48107-8647 734-794-6410 www.a2gov.org

C		Know wh Call t
OR		
ROJECT MANAGEMENT - PUBLIC SERVICES - CITY OF ANN ARBOR	ACING - 2017	TO WALL ST
ITY OF /		
ICES - C	ANNUAL STREET RESURF.	ISLAND DRIVE - CANAL ST
IC SERV		ISLAND DI
L- PUBL	PROJECT DESCRIPTION	
GEMEN	PROJI	
T MANA		
PROJEC		AWING No. 017004-22
HEE	Г No.	K K

22 OF 136

at's belo

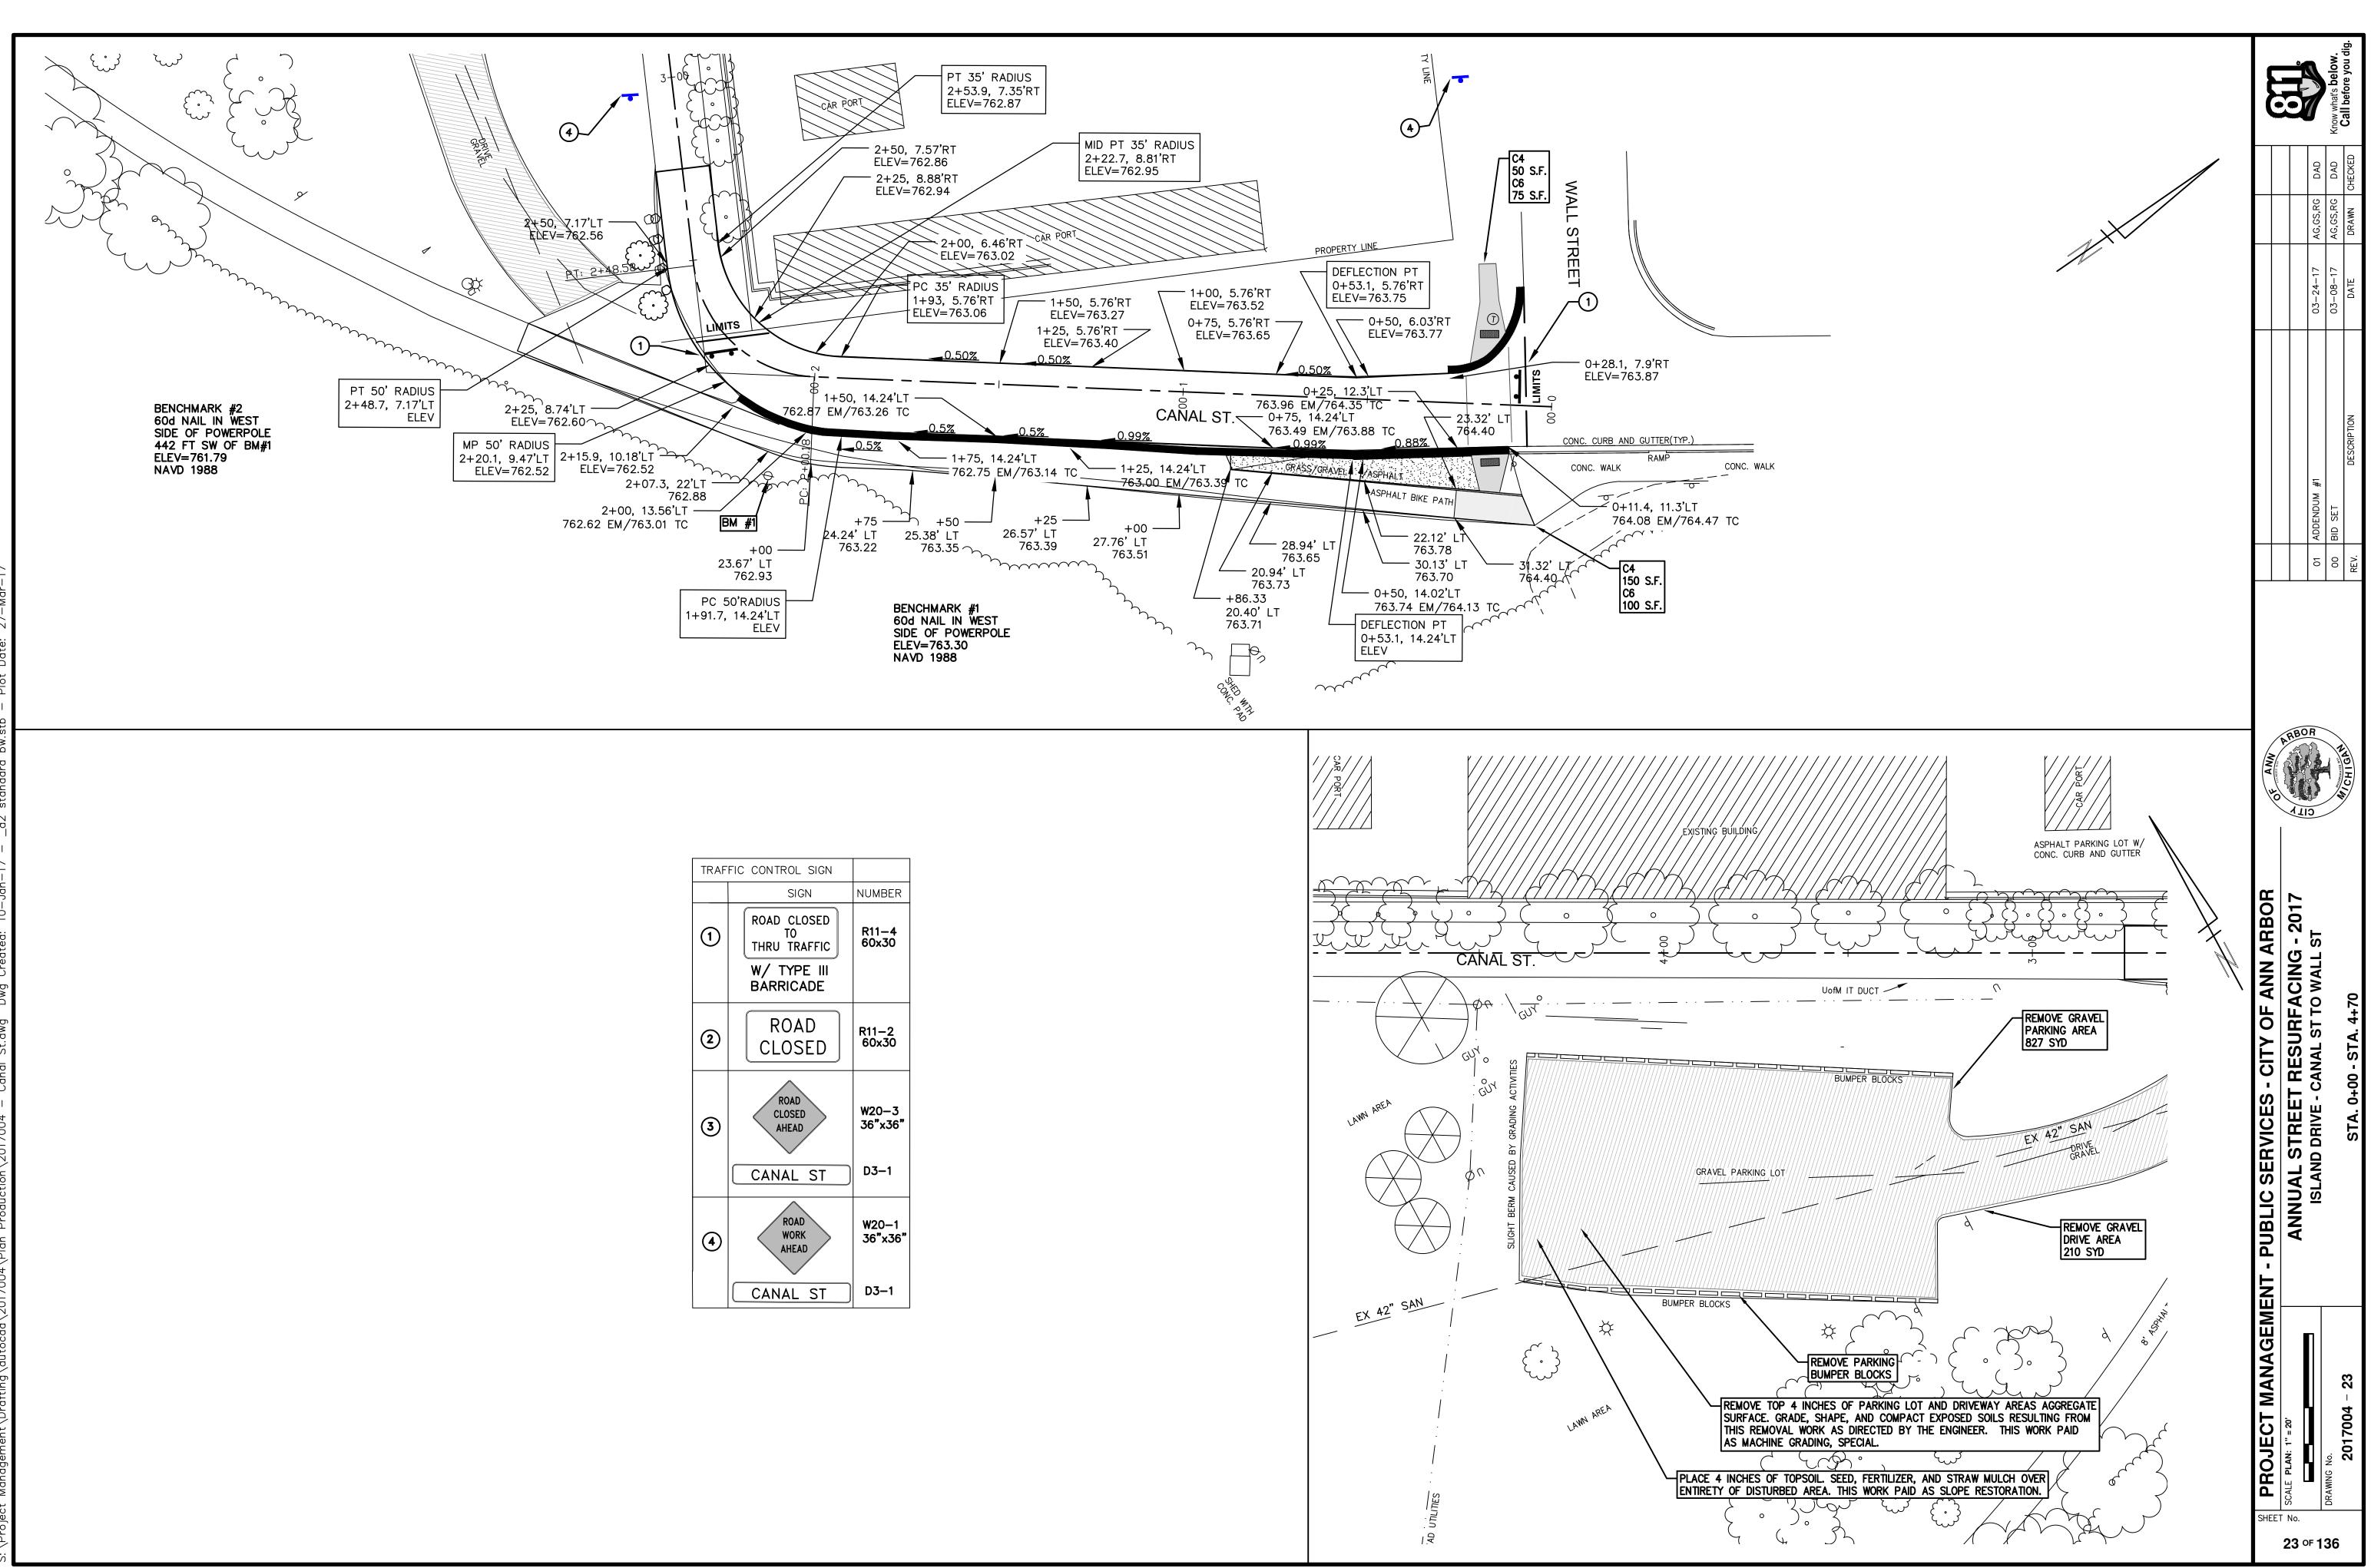

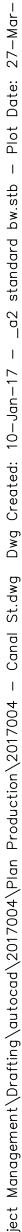



tem Code	QUANTITIES Item Description	Units	Quantity
2030011	Dr Structure, Rem	Ea	6.000
2030015	Sewer, Rem, Less than 24 inch	Ft	60.000
2047001	Curb, Gutter, and Curb and Gutter, Any Type, Rem	Ft	435.000
2047011	Sidewalk, Sidewalk Ramp, and Driveway Approach, Any Thickness, Rem	Syd	417.000
2057011	Grading, Driveway Approach	Syd	7.000
2057011	Grading, Sidewalk	Syd	207.000
2057011	 Grading, Sidewalk Ramp	Syd	148.000
2057011	Machine Grading, Special	Syd	4,321.000
2057021	_Subgrade Undercutting, Type IIA	Cyd	372.000
2080020	Erosion Control, Inlet Protection, Fabric Drop	Ea	13.000
4020987	Sewer, CI IV, 12 inch, Tr Det B	Ft	60.000
4030200	Dr Structure, 24 inch dia	Ea	6.000
4037050	_Dr Structure Cover, Type B, Modified	Ea	9.000
4037050	Dr Structure Cover, Type D, Modified	Ea	1.000
4030050	Dr Structure Cover, Type K, Modified	Ea	5.000
4037050	Dr Structure, Adj, Case 1, Modified	Ea	16.000
4037050	Dr Structure, Temp Lowering, Modified	Ea	13.000
5010003	Cold Milling HMA Surface	Ton	977.000
5010005	HMA Surface, Rem	Syd	153.550
5010061	HMA, Approach	Ton	68.000
5010703	HMA, LVSP	Ton	977.000
6027021	_Flowable Fill	Cyd	16.111
6030005	Cement	Ton	1.000
8017011	_Driveway, Nonreinf Conc, 6 inch, Modified	Syd	7.000
8027001	_Curb and Gutter, Conc	Ft	447.000
8027001	 Driveway Opening, Conc, Det M, Modified	Ft	40.000
8037001	_Detectable Warning Surface, Modified	Ft	110.000
8037010	Sidewalk Ramp, Conc, 6 inch, Modified	Sft	1,325.000
8037010	_Sidewalk, Conc, 4 inch, Modified	Sft	1,850.000
8037010	_Sidewalk, Conc, 6 inch, Modified	Sft	7.000
8117001	_Pavt Mrkg, Wet Retrflec, Thermopl, 6 inch, Crosswalk	Ft	660.000
8117001	_Pavt Mrkg, Wet Retrflec, Thermopl, 24 inch, Stop Bar	Ft	135.000
8120012	Barricade, Type III, High Intensity, Double Sided, Lighted, Furn	Ea	8.000
8120013	Barricade, Type III, High Intensity, Double Sided, Lighted, Oper	Ea	8.000
8120260	Plastic Drum, High Intensity, Lighted, Furn	Ea	60.000
8120261	Plastic Drum, High Intensity, Lighted, Oper	Ea	60.000
8120350	Sign, Type B, Temp, Prismatic, Furn	Sft	230.000
8120351	Sign, Type B, Temp, Prismatic, Oper	Sft	230.000
8127050	_No Parking Sign	Ea	52.000
8167011	_Slope Restoration	Syd	160.000
8230431	Gate Box, Adj, Case 1	Ea	3.000

KEY	ASSOCIATED PAY ITEM(S)
	 _Dr Structure, Adj, Case 1, Modified
AA	 Dr Structure, Adj, Case 2, Modified
	Dr Structure, Temp Lowering, Modified
	Dr Structure, Temp Lowering, Modified
4.0	• _Gate Box, Adj, Case 1
AB	• _Gate Box, Adj, Case 2
	Monument Box Adjust
ADST	Dr Structure, Adj, Add Depth, Modified
AK	Dr Structure, Adj, Case 1, Modified
-	• Sidewalk, Sidewalk Ramp, and Driveway Approach, Any Thickness, Rem
C4	Grading, Sidewalk
	 _Sidewalk, Conc, 4 inch, Modified
	• Sidewalk, Sidewalk Ramp, and Driveway Approach, Any Thickness, Rem
C4HE	 Grading, Sidewalk
C4HE	Cement
	 _Sidewalk, Conc, 4 inch, Modified
	• _Sidewalk, Sidewalk Ramp, and Driveway Approach, Any Thickness, Rem
	 _Grading, Sidewalk
<u> </u>	 _Grading, Sidewalk Ramp
C6	 _Detectable Warning Surface, Modified
	 _Sidewalk Ramp, Conc, 6 inch, Modified
	 _Sidewalk, Conc, 6 inch, Modified
C8	 _Grading, Driveway Approach
Co	 _Driveway, Nonreinf Conc, 8 inch, Modified
	 _Sidewalk, Sidewalk Ramp, and Driveway Approach, Any Thickness, Rem
	 _Grading, Driveway Approach
	• _Grading, Sidewalk
	 _Grading, Sidewalk Ramp
	Cement
CHE	 _Driveway, Nonreinf Conc, 6 inch, Modified
	 _Driveway, Nonreinf Conc, 8 inch, Modified
	 _Detectable Warning Surface, Modified
	 _Sidewalk Ramp, Conc, 6 inch, Modified
	 _Sidewalk, Conc, 6 inch, Modified
C/G	 _Curb, Gutter, and Curb and Gutter, Any Type, Rem
0/0	_Curb and Gutter, Conc
	 _Curb, Gutter, and Curb and Gutter, Any Type, Rem
C/GHE	Cement
	 _Driveway Opening, Conc, Det M, Modified
CP	 _Grading, Sidewalk
	 _Sidewalk, Conc, 4 inch, Modified
CR	 _Sidewalk, Sidewalk Ramp, and Driveway Approach, Any Thickness, Rem
	Dr Structure, Rem
DS	 Sewer, Rem, Less than 24 inch
	Dr Structure, 24 inch dia
	Dr Structure, Rem
DSDI	 Sewer, Rem, Less than 24 inch
	_Dr Structure, Double Inlet
PT	_Dr Structure, Point
	Dr Structure Cover, Type B
RRA	 _Dr Structure Cover, Type B, Special
	 _Dr Structure, Adj, Case 1, Modified
	_Dr Structure, Temp Lowering, Modified
RRK	Dr Structure Cover, Type K
	_Dr Structure, Adj, Case 1, Modified
RS	_Dr Structure, Reconstruct
TYPE II	Plastic Drum, High Intensity, Lighted, Furn
	Plastic Drum, High Intensity, Lighted, Oper
TYPE III	Barricade, Type III, High Intensity, Double Sided, Lighted, Furn
	 Barricade, Type III, High Intensity, Double Sided, Lighted, Oper

PROJECT LOCATION: WEST DAVIS AVENUE

ITB No. 4477 FILE No. 2017-004

CONSTRUCTION KEY

	LEGEND
SYMBOL	DESCRIPTION
্ঞ	EXISTING SANITARY SEWER MANHOLE
	EXISTING STORM SEWER MANHOLE
\otimes	EXISTING WATER MAIN VALVE IN WELL
+	WATER MAIN GATE VALVE IN BOX
+Q+	FIRE HYDRANT
(g)	MICHCON GAS CO. VALVE BOX/WELL
t	AMERITECH TELEPHONE VAULT
e	ELECTRIC MANHOLE
\bullet	SOIL BORING
	EXISTING STORM SEWER INLET
•	MONUMENT BOX
	REMOVE AND REPLACE CONC. SIDEWALK
<u>4</u> <u>4</u> <u>4</u>	PLACE CONCRETE SIDEWALK
	REMOVE & REPLACE CONC. CURB & GUTTER
	CONSTRUCTION LIMITS
	6" WRAPPED UNDERDRAIN
	REMOVE CONCRETE SIDEWALK
	SUBGRADE UNDERCUT

CONSTRUCTION METHOD AND SEQUENCING

IN ACCORDANCE WITH THE SCHEDULE OF STREETS WORK ON THIS STREET IS TO OCCUR CONCURRENTLY WITI THAT PROPOSED FOR 5TH STREET AND WILDER PLACE. WORK ON THIS STREET INCLUDES, BUT IS NOT LIMITED TO, THE FOLLOWING ITEMS. COMPLETE THE WORK IN ACCORDANCE WITH THE PLANS AND SPECIFICATIONS, AND AS DIRECTED BY THE ENGINEER. PERFORM THE WORK IN THE ORDER INDICATED ED OR DIRECTED BY THE ENGINEER

- CONTROL MEASURES.
- COLDMILLING.
- AND MONUMENT BOXES AS REQUIRED.
- REQUIRED.
- AS REQUIRED.
- 12. CLEAN PAVEMENT AND COMPLETE ALL PAVEMENT MARKINGS.
- 14. REMOVE ALL TRAFFIC CONTROL DEVICES, AND MISS DIG FLAGS.

NOTES:

		QUANTITIES		
		Sign, Type B, Temp, Prismatic		
Quantity	Sign Code	Description	Area (sft)	Total Area
10.0	D3-1	Street Name Sign	4.000	40.000
8.0	R11-4	Road Closed Sign ("Road Closed To Thru Traffic")	12.500	100.000
9.0	W20-1	Road Work Ahead Sign	9.000	81.000
1.0	W20-3	Road Closed Ahead Sign	9.000	9.000
			TOTAL	230.000

THE IMPROVEMENTS COVERED BY THESE PLANS SHALL BE PERFORMED IN ACCORDANCE WITH MICHIGAN DEPARTMENT OF TRANSPORTATION (MDOT) 2012 STANDARD SPECIFICATIONS FOR CONSTRUCTION, INCLUDING REFERENCED MDOT PUBLICATIONS, AND THE PROJECT CONTRACT DOCUMENTS.

1. IMPLEMENT MAINTENANCE OF TRAFFIC (M.O.T.) PLAN, AND INSTALL SOIL EROSION AND SEDIMENTATION

2. CONDUCT REMOVAL WORK RELATED TO PAVEMENT, DRAINAGE, AND CONCRETE ITEMS WITH EXCEPTION TO

3. INSTALL PROPOSED DRAINAGE STRUCTURES, STORM SEWER, AND UNDERDRAIN AS REQUIRED.

4. PERFORM ALL CONCRETE WORK, INCLUDING RESTORATION, AS REQUIRED.

5. TEMPORARY LOWER ALL STRUCTURE COVERS LOCATED WITHIN THE EXISTING PAVEMENT, INCLUDING GATE

6. REMOVE 4.0 INCHES OF EXISTING HMA SURFACE BY COLDMILLING. THIS MAY INCLUDE GRANULAR BASE TO BE DETERMINED BY THE ENGINEER. PROOF ROLL WITH FULLY LOADED TRUCK.

7. PERFORM ALL JOINT AND CRACK CLEANOUT, HMA/HAND PATCHING, UNDERCUTS AND/OR BASE REPAIRS AS

8. GRADE, SHAPE, AND COMPACT THE EXISTING BASE MATERIAL AS DIRECTED.

9. CLEAN PAVEMENT AS REQUIRED, AND PLACE 2.0 INCH LEVELING COURSE HMA MIX (LOCAL STREETS). 10. ADJUST ALL STRUCTURE COVERS, INCLUDING GATE AND MONUMENT BOXES, TO THEIR FINISHED ELEVATIONS

11. CLEAN PAVEMENT AND PLACE 2.0 INCH TOP COURSE HMA MIX (LOCAL STREETS).

13. COMPLETE ALL MISCELLANEOUS CONSTRUCTION INCLUDING ALL CLEAN UP AND FINAL RESTORATION.


FOR PROTECTION OF UNDERGROUND UTILITIES AND IN CONFORMANCE WITH PUBLIC ACT 174 OF 2013, THE CONTRACTOR SHALL CALL 811 OR 1-800-482-7171 A MINIMUM OF THREE FULL WORKING DAYS, EXCLUDING SATURDAYS, SUNDAYS, AND HOLIDAYS, PRIOR TO BEGINNING EACH EXCAVATION IN AREAS WHERE PUBLIC UTILITIES HAVE NOT BEEN PREVIOUSLY LOCATED. MEMBERS WILL THUS BE ROUTINELY NOTIFIED. THIS DOES NOT RELIEVE THE CONTRACTOR OF THE RESPONSIBILITY OF NOTIFYING UTILITY OWNERS WHO MAY NOT BE A PART OF THE "MISS DIG" ALERT SYSTEM.


THE UNDERGROUND LOCATIONS SHOWN FOR NATURAL GAS, TELEPHONE, ELECTRICAL POWER, CABLE TV AND FIBER OPTIC LINES ARE APPROXIMATE. THE CITY OF ANN ARBOR ASSUMES NO RESPONSIBILITY FOR THEIR ACCURATE REPRESENTATION IN THIS DRAWING. MISS DIG MUST BE CONTACTED PRIOR TO CONSTRUCTION TO LOCATE THESE UTILITIES.



Know what's below. Call before you dig.

ынее 2	PROJECT MANAGEME	ENT - PUBLIC SERVICES - CITY OF ANN ARBOR
τ _{Νο.} 4 ΟΓ		PROJECT DESCRIPTION ANNUAL STREET RESURFACING - 2017
13	DRAWING NO	
6	2017004-24	WEST DAVIS AVENUE

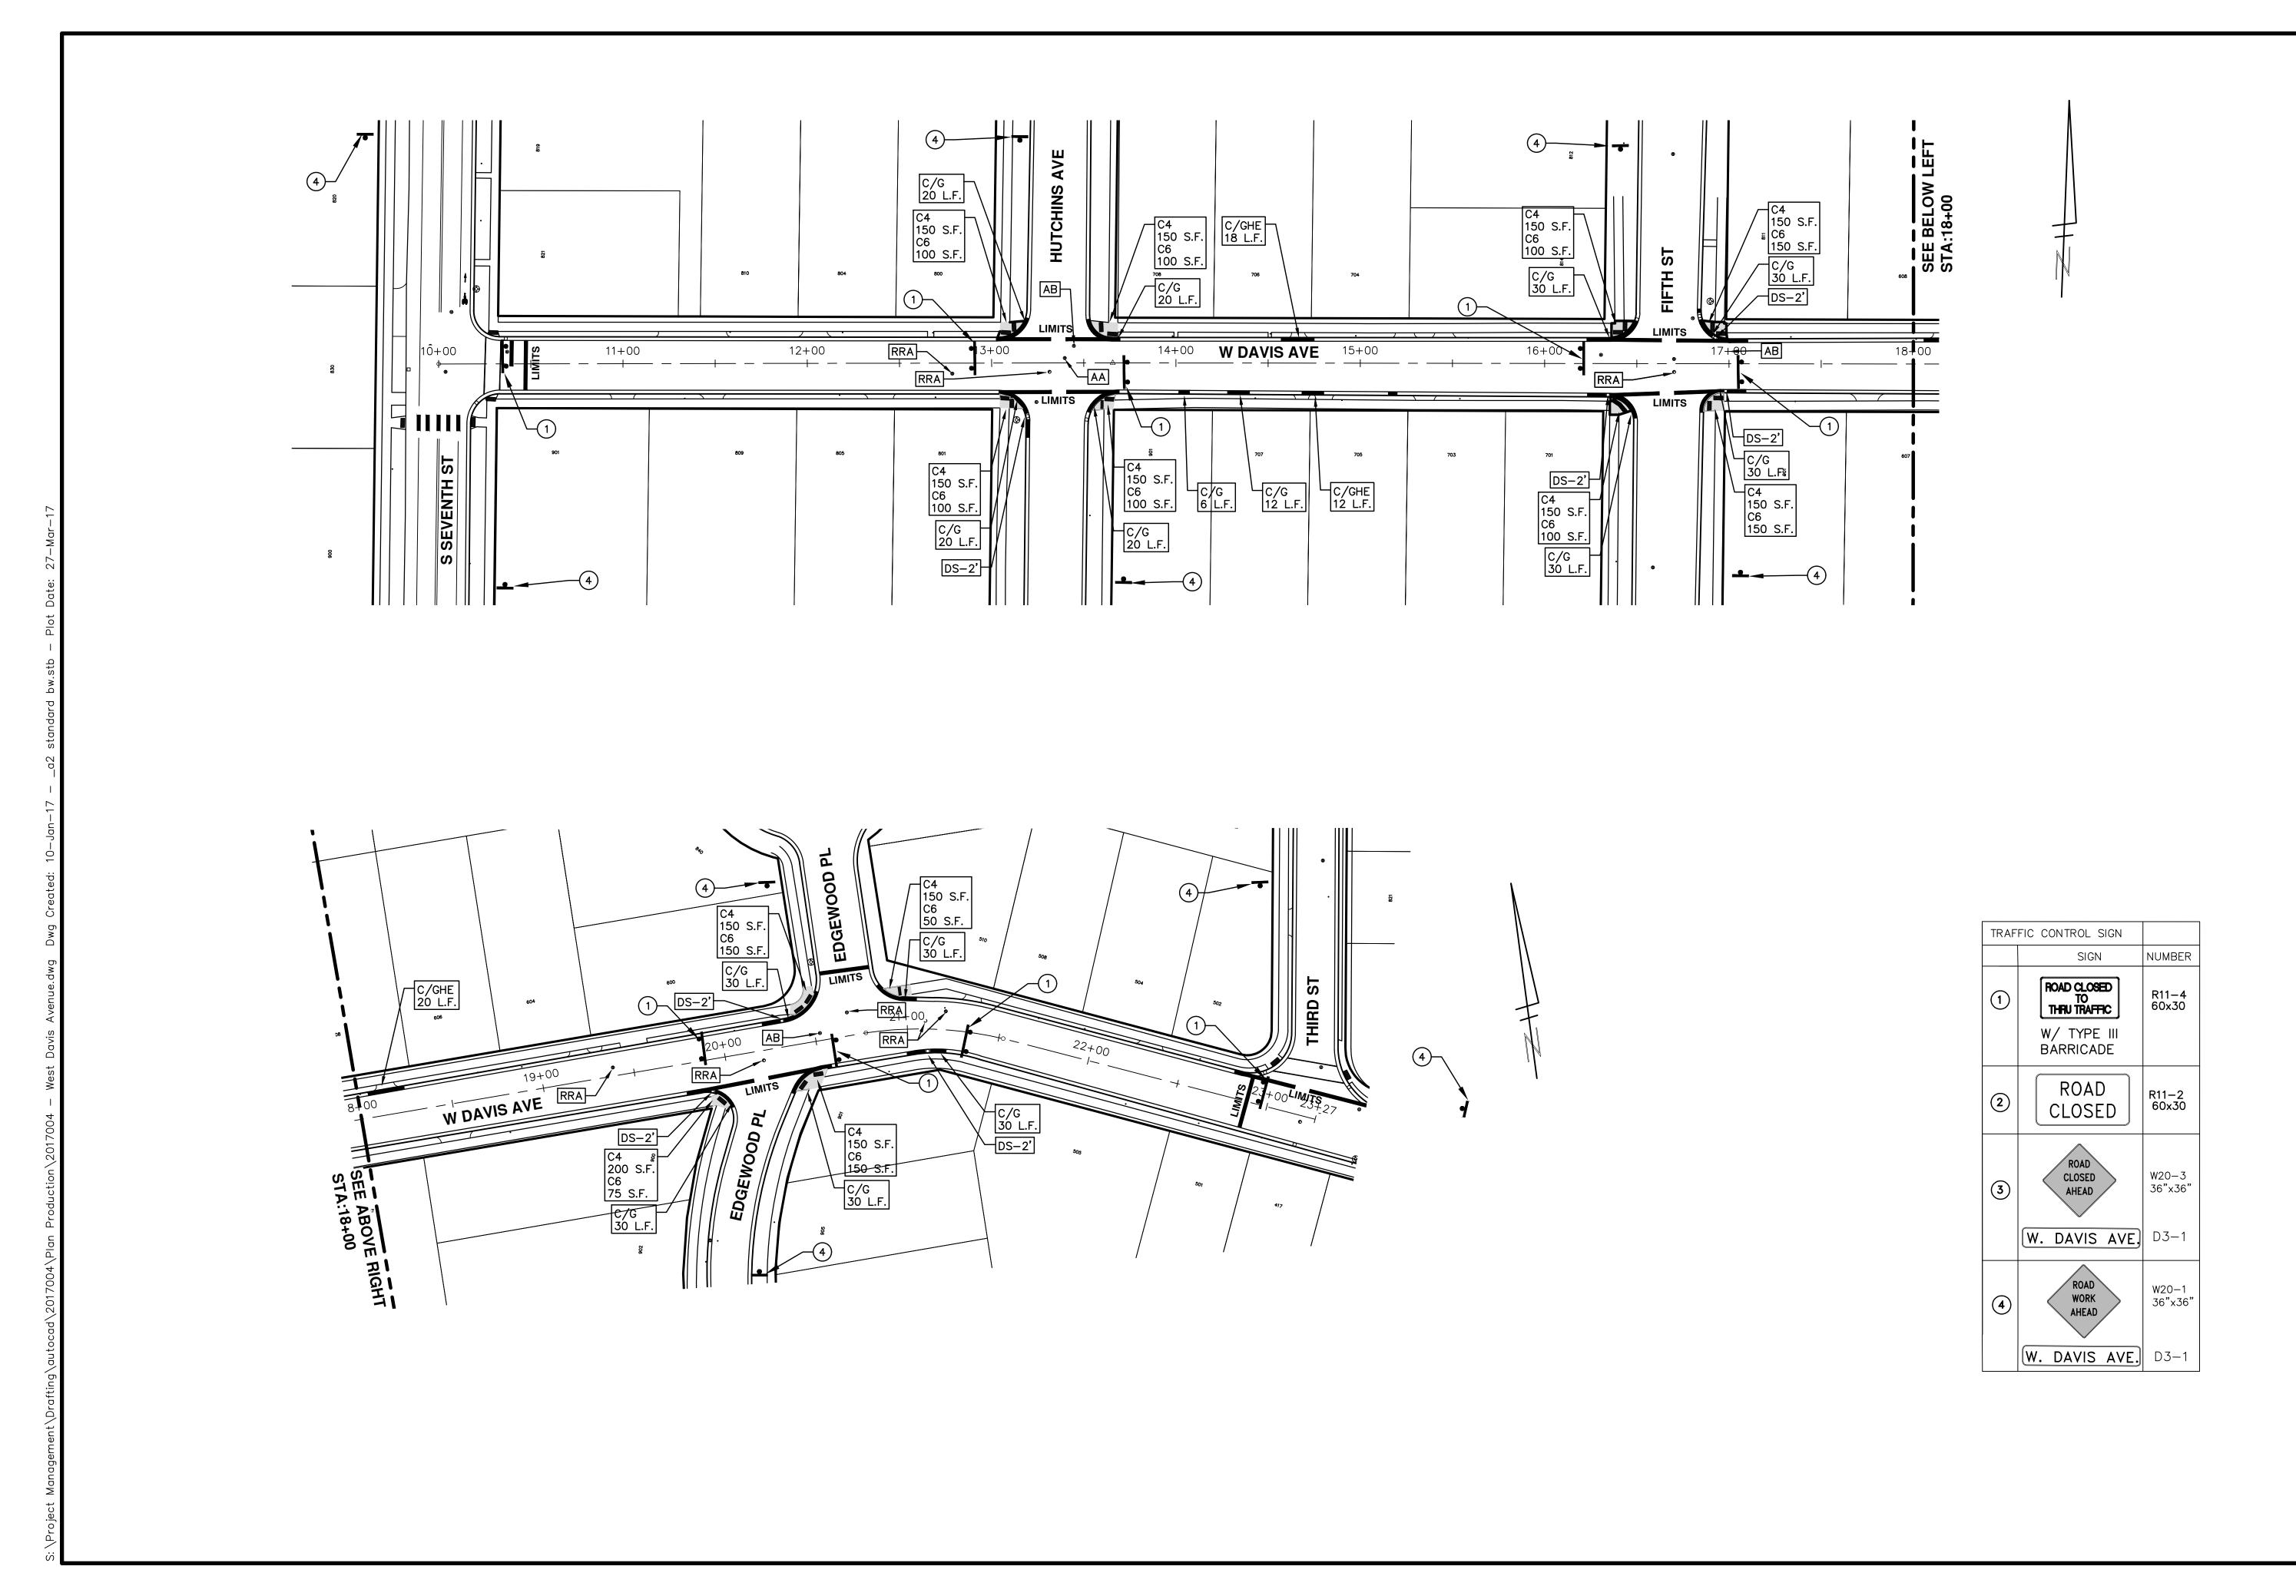

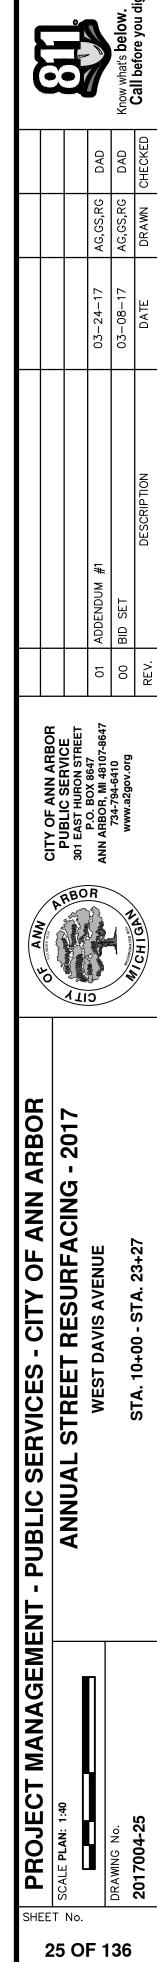



PROJECT LOCATION: WEST JEFFERSON STREET

QUANTITIES			
Item Code	Item Description	Units	Quantity
2030011	Dr Structure, Rem	Ea	21.000
2030015	Sewer, Rem, Less than 24 inch	Ft	210.000
2047001	_Curb, Gutter, and Curb and Gutter, Any Type, Rem	Ft	1,338.000
2047011	_Sidewalk, Sidewalk Ramp, and Driveway Approach, Any Thickness, Rem	Syd	126.000
2057011	_Grading, Driveway Approach	Syd	51.000
2057011	_Grading, Sidewalk	Syd	203.000
2057011	_Grading, Sidewalk Ramp	Syd	201.000
2057011	_Machine Grading, Special	Syd	9,611.000
2057021	_Subgrade Undercutting, Type IIA	Cyd	962.000
2080020	Erosion Control, Inlet Protection, Fabric Drop	Ea	37.000
4020987	Sewer, CI IV, 12 inch, Tr Det B	Ft	210.000
4030200	Dr Structure, 24 inch dia	Ea	21.000
4030210	Dr Structure, 48 inch dia	Ea	12.000
4037050	_Dr Structure Cover, Type B, Modified	Ea	37.000
4030050	_Dr Structure Cover, Type K, Modified	Ea	21.000
4037050	_Dr Structure, Adj, Case 1, Modified	Ea	54.000
4037050	_Dr Structure, Adj, Case 2, Modified	Ea	12.000
4037050	_Dr Structure, Temp Lowering, Modified	Ea	38.000
5010003	Cold Milling HMA Surface	Ton	2,173.000
5010005	HMA Surface, Rem	Syd	374.660
5010703	HMA, LVSP	Ton	2,173.000
6027021	_Flowable Fill	Cyd	49.556
6030005	Cement	Ton	3.000
8017011	_Driveway, Nonreinf Conc, 6 inch, Modified	Syd	51.000
8027001	_Curb and Gutter, Conc	Ft	1,269.000
8027001	 Driveway Opening, Conc, Det M, Modified	Ft	119.000
8037001	_Detectable Warning Surface, Modified	Ft	140.000
8037010	_Sidewalk Ramp, Conc, 6 inch, Modified	Sft	1,805.000
8037010		Sft	1,825.000
8117001		Ft	935.000
8117001	_Pavt Mrkg, Wet Retrflec, Thermopl, 12 inch, Crosswalk	Ft	320.000
8117001	_Pavt Mrkg, Wet Retrflec, Thermopl, 24 inch, Stop Bar	Ft	160.000
8117050	_Pavt Mrkg, Wet Retrflec, Thermopl, School	Ea	2.000
8117050	_Pavt Mrkg, Wet Retrflec, Thermopl, Railroad Sym	Ea	2.000
8120012	Barricade, Type III, High Intensity, Double Sided, Lighted, Furn	Ea	14.000
8120013	Barricade, Type III, High Intensity, Double Sided, Lighted, Oper	Ea	14.000
8120260	Plastic Drum, High Intensity, Lighted, Furn	Ea	105.000
8120261	Plastic Drum, High Intensity, Lighted, Oper	Ea	105.000
8120350	Sign, Type B, Temp, Prismatic, Furn	Sft	383.000
8120351	Sign, Type B, Temp, Prismatic, Oper	Sft	383.000
8127050	No Parking Sign	Ea	84.000
8167011	Slope Restoration	Syd	824.280
8217050	Monument Box Adjust	Ea	5.000
8230431	Gate Box, Adj, Case 1	Ea	9.000
		<u> </u>	0.000

	CONSTRUCTION KEY
KEY	ASSOCIATED PAY ITEM(S)
	 _Dr Structure, Adj, Case 1, Modified
AA	 _Dr Structure, Adj, Case 2, Modified
	 _Dr Structure, Temp Lowering, Modified
	 _Dr Structure, Temp Lowering, Modified
AB	• _Gate Box, Adj, Case 1
ΛD	• _Gate Box, Adj, Case 2
	Monument Box Adjust
ADST	 _Dr Structure, Adj, Add Depth, Modified
AK	_Dr Structure, Adj, Case 1, Modified
	 _Sidewalk, Sidewalk Ramp, and Driveway Approach, Any
C4	• _Grading, Sidewalk
	_Sidewalk, Conc, 4 inch, Modified
	 _Sidewalk, Sidewalk Ramp, and Driveway Approach, Any Optimized States
C4HE	• _Grading, Sidewalk
	Cement Didewalls Open A inch Madified
	_Sidewalk, Conc, 4 inch, Modified
	 _Sidewalk, Sidewalk Ramp, and Driveway Approach, Any Crading, Sidewalk
	• _Grading, Sidewalk
C6	_Grading, Sidewalk Ramp _Detectable Warring Surface, Medified
	Detectable Warning Surface, Modified Sidewalk Ramp, Capa, 6 inch, Modified
	 _Sidewalk Ramp, Conc, 6 inch, Modified _Sidewalk, Conc, 6 inch, Modified
	Sidewark, Conc, 6 Inch, Modified Grading, Driveway Approach
C8	Grading, Driveway Approach Driveway, Nonreinf Conc, 8 inch, Modified
	 Sidewalk, Sidewalk Ramp, and Driveway Approach, Any
	 _Grading, Driveway Approach
	Grading, Sidewalk
	Grading, Sidewalk Ramp
	Cement
C HE	Driveway, Nonreinf Conc, 6 inch, Modified
	_Driveway, Nonreinf Conc, 8 inch, Modified
	Detectable Warning Surface, Modified
	Sidewalk Ramp, Conc, 6 inch, Modified
	 Sidewalk, Conc, 6 inch, Modified
0/0	_Curb, Gutter, and Curb and Gutter, Any Type, Rem
C/G	Curb and Gutter, Conc
	Curb, Gutter, and Curb and Gutter, Any Type, Rem
C/GHE	• Cement
	 Driveway Opening, Conc, Det M, Modified
CP	 _Grading, Sidewalk
OF	 _Sidewalk, Conc, 4 inch, Modified
CR	 _Sidewalk, Sidewalk Ramp, and Driveway Approach, Any
	Dr Structure, Rem
DS	 Sewer, Rem, Less than 24 inch
	Dr Structure, 24 inch dia
	Dr Structure, Rem
DSDI	Sewer, Rem, Less than 24 inch
	Dr Structure, Double Inlet
PT	_Dr Structure, Point
RRA	Dr Structure Cover, Type B
	_Dr Structure Cover, Type B, Special
	_Dr Structure, Adj, Case 1, Modified
	_Dr Structure, Temp Lowering, Modified
RRK	Dr Structure Cover, Type K
DO	_Dr Structure, Adj, Case 1, Modified
RS	_Dr Structure, Reconstruct
TYPE II	Plastic Drum, High Intensity, Lighted, Furn Plastic Drum, High Intensity, Lighted, Oper
	Plastic Drum, High Intensity, Lighted, Oper Barricade, Type III, High Intensity, Double Sided, Lighted
TYPE III	Barricade, Type III, High Intensity, Double Sided, Lighted Barricade, Type III, High Intensity, Double Sided, Lighted
	 Barricade, Type III, High Intensity, Double Sided, Lighted

CITY OF ANN ARBOR PROJECT MANAGEMENT

ITB No. 4477 FILE No. 2017-004

ny Thickness, Rem

ny Thickness, Rem

ny Thickness, Rem

ny Thickness, Rem

y Thickness, Rem

ed, Furn Barricade, Type III, High Intensity, Double Sided, Lighted, Oper

LEGEND		
SYMBOL	DESCRIPTION	
S	EXISTING SANITARY SEWER MANHOLE	
$\langle r \rangle$	EXISTING STORM SEWER MANHOLE	
\otimes	EXISTING WATER MAIN VALVE IN WELL	
+	WATER MAIN GATE VALVE IN BOX	
+ Q+	FIRE HYDRANT	
(G)	MICHCON GAS CO. VALVE BOX/WELL	
t	AMERITECH TELEPHONE VAULT	
e	ELECTRIC MANHOLE	
Ð	SOIL BORING	
	EXISTING STORM SEWER INLET	
٥	MONUMENT BOX	
	REMOVE AND REPLACE CONC. SIDEWALK	
	PLACE CONCRETE SIDEWALK	
	REMOVE & REPLACE CONC. CURB & GUTTER	
	CONSTRUCTION LIMITS	
	6" WRAPPED UNDERDRAIN	
	REMOVE CONCRETE SIDEWALK	
	SUBGRADE UNDERCUT	

CONSTRUCTION METHOD AND SEQUENCING

IN ACCORDANCE WITH THE SCHEDULE OF STREETS WORK ON THIS STREET IS TO OCCUR CONCURRENTLY WITH THAT PROPOSED FOR 4TH STREET AND 5TH STREET. WORK ON EACH LOCATION MAY OCCUR SIMULTANEOUSLY WITH EXCEPTION TO COLDMILLING AND LEVELING COURSE PAVING ACTIVITIES. WHICH TOGETHER SHALL BE SEQUENTIALLY STREET BY STREET. WORK ON THIS STREET INCLUDES, BUT IS NOT LIMITED TO, FOLLOWING ITEMS. COMPLETE THE WORK IN ACCORDANCE WITH THE PLANS AND SPECIFICATIONS, AND AS DIRECTED BY THE ENGINEER. PERFORM THE WORK IN THE ORDER INDICATED BELOW UNLESS OTHERWISE AUTHORIZED OR DIRECTED BY THE ENGINEER

- CONTROL MEASURES.
- COLDMILLING.

- AND MONUMENT BOXES AS REQUIRED.
- REQUIRED
- AS REQUIRED.
- 12. CLEAN PAVEMENT AND COMPLETE ALL PAVEMENT MARKINGS.
- 14. REMOVE ALL TRAFFIC CONTROL DEVICES, AND MISS DIG FLAGS.

NOTES:

FOR PROTECTION OF UNDERGROUND UTILITIES AND IN CONFORMANCE WITH PUBLIC ACT 174 OF 2013, THE CONTRACTOR SHALL CALL 811 OR 1-800-482-7171 A MINIMUM OF THREE FULL WORKING DAYS, EXCLUDING SATURDAYS, SUNDAYS, AND HOLIDAYS, PRIOR TO BEGINNING EACH EXCAVATION IN AREAS WHERE PUBLIC UTILITIES HAVE NOT BEEN PREVIOUSLY LOCATED. MEMBERS WILL THUS BE ROUTINELY NOTIFIED. THIS DOES NOT RELIEVE THE CONTRACTOR OF THE RESPONSIBILITY OF NOTIFYING UTILITY OWNERS WHO MAY NOT BE A PART OF THE "MISS DIG" ALERT SYSTEM.

THE UNDERGROUND LOCATIONS SHOWN FOR NATURAL GAS, TELEPHONE, ELECTRICAL POWER, CABLE TV AND FIBER OPTIC LINES ARE APPROXIMATE. THE CITY OF ANN ARBOR ASSUMES NO RESPONSIBILITY FOR THEIR ACCURATE REPRESENTATION IN THIS DRAWING. MISS DIG MUST BE CONTACTED PRIOR TO CONSTRUCTION TO LOCATE THESE UTILITIES.

THE IMPROVEMENTS COVERED BY THESE PLANS SHALL BE PERFORMED IN ACCORDANCE WITH MICHIGAN DEPARTMENT OF TRANSPORTATION (MDOT) 2012 STANDARD SPECIFICATIONS FOR CONSTRUCTION, INCLUDING REFERENCED MDOT PUBLICATIONS, AND THE PROJECT CONTRACT DOCUMENTS.

QUANTITIES Sign, Type B, Temp, Prismatic Total Quantity | Sign Code | Description Area (sft) Area 64.000 16.0 D3-1 Street Name Sign 4.000 R11-4 Road Closed Sign ("Road Closed To Thru Traffic") 12.500 175.000 14.0 16.0 W20-1 Road Work Ahead Sign 9.000 144.000

TOTAL 383.000



1. IMPLEMENT MAINTENANCE OF TRAFFIC (M.O.T.) PLAN, AND INSTALL SOIL EROSION AND SEDIMENTATION

2. CONDUCT REMOVAL WORK RELATED TO PAVEMENT, DRAINAGE, AND CONCRETE ITEMS WITH EXCEPTION TO

3. INSTALL PROPOSED DRAINAGE STRUCTURES, STORM SEWER, AND UNDERDRAIN AS REQUIRED

4. PERFORM ALL CONCRETE WORK, INCLUDING RESTORATION, AS REQUIRED.

5. TEMPORARY LOWER ALL STRUCTURE COVERS LOCATED WITHIN THE EXISTING PAVEMENT, INCLUDING GATE

6. REMOVE 4.0 INCHES OF EXISTING HMA SURFACE BY COLDMILLING. THIS MAY INCLUDE GRANULAR BASE DEPTH TO BE DETERMINED BY THE ENGINEER. PROOF ROLL WITH FULLY LOADED TRUCK.

7. PERFORM ALL JOINT AND CRACK CLEANOUT, HMA/HAND PATCHING, UNDERCUTS AND/OR BASE REPAIRS AS

8. GRADE, SHAPE, AND COMPACT THE EXISTING BASE MATERIAL AS DIRECTED.

9. CLEAN PAVEMENT AS REQUIRED, AND PLACE 2.0 INCH LEVELING COURSE HMA MIX (LOCAL STREETS).


10. ADJUST ALL STRUCTURE COVERS, INCLUDING GATE AND MONUMENT BOXES, TO THEIR FINISHED ELEVATIONS


11. CLEAN PAVEMENT AND PLACE 2.0 INCH TOP COURSE HMA MIX (LOCAL STREETS).


13. COMPLETE ALL MISCELLANEOUS CONSTRUCTION INCLUDING ALL CLEAN UP AND FINAL RESTORATION.



ENI - PUBLIC SERVICES - CITY OF ANN ARBOR	PROJECT DESCRIPTION ANNUAL STREET RESURFACING - 2017	WEST JEFFERSON STREET
		95 DRAWING No. 2017004-26

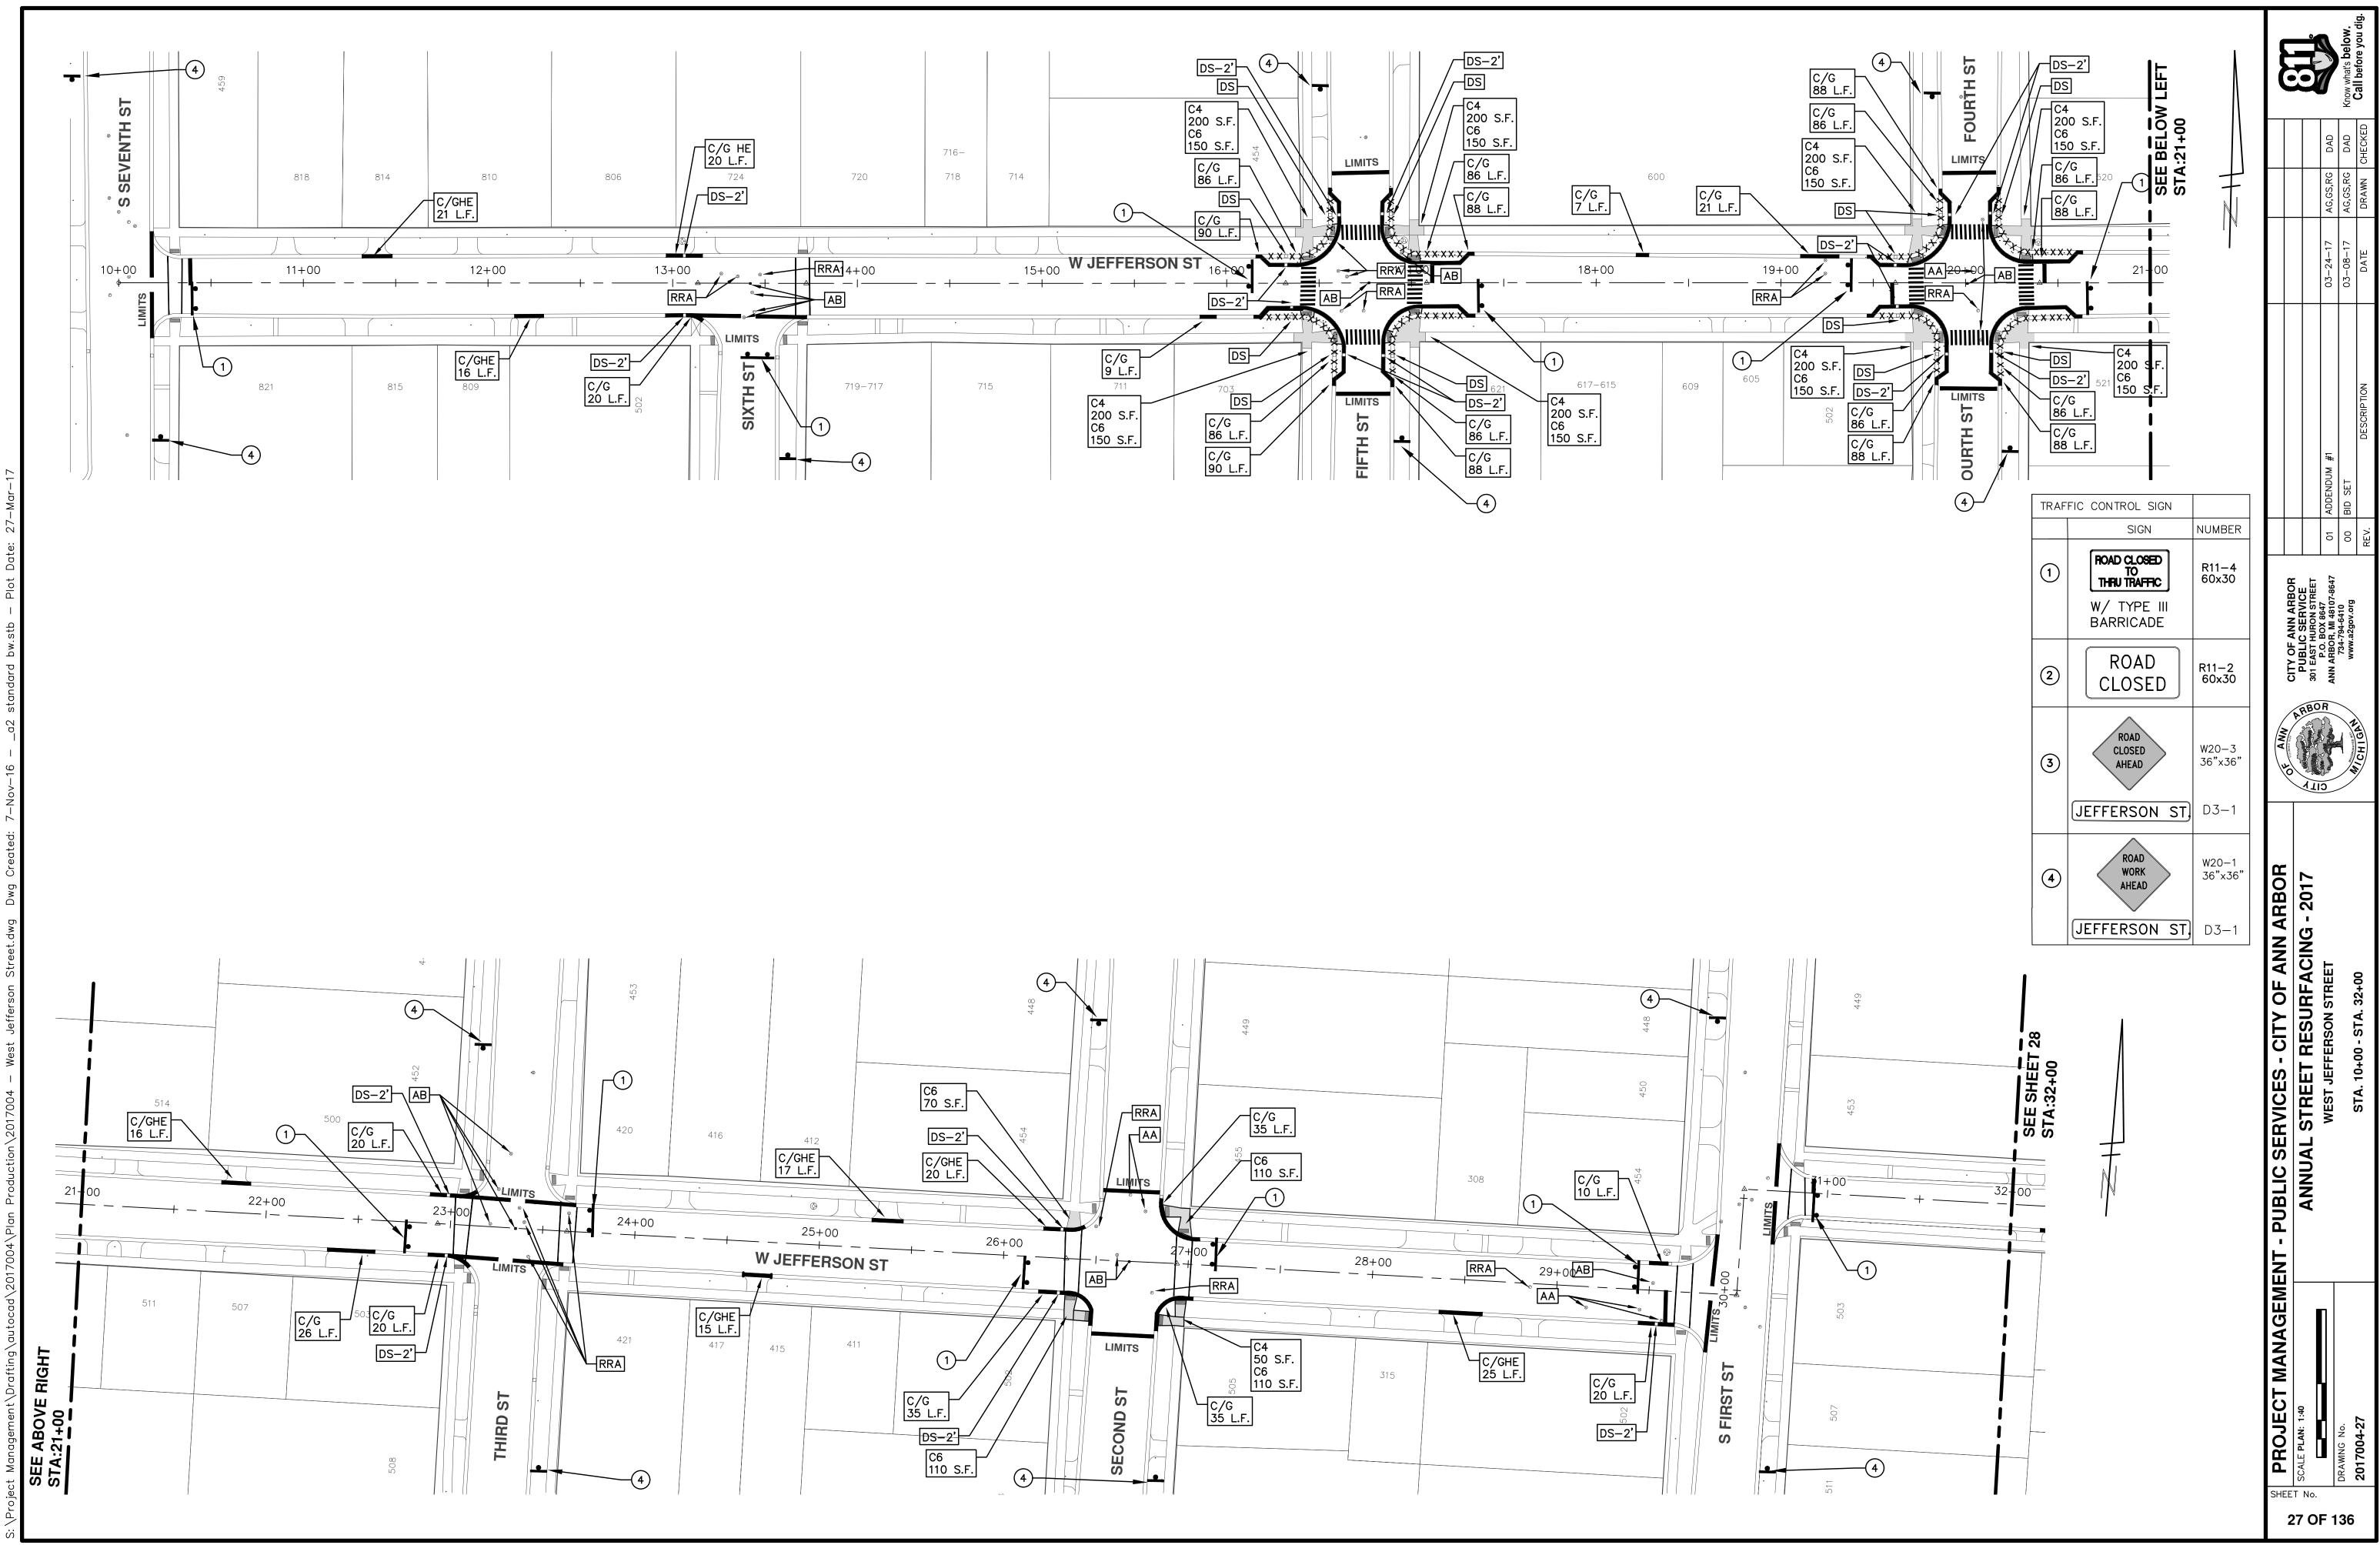

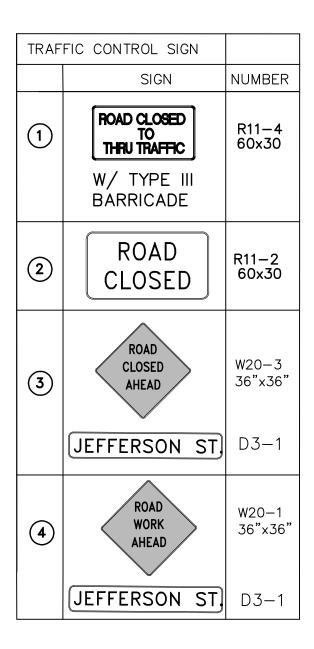

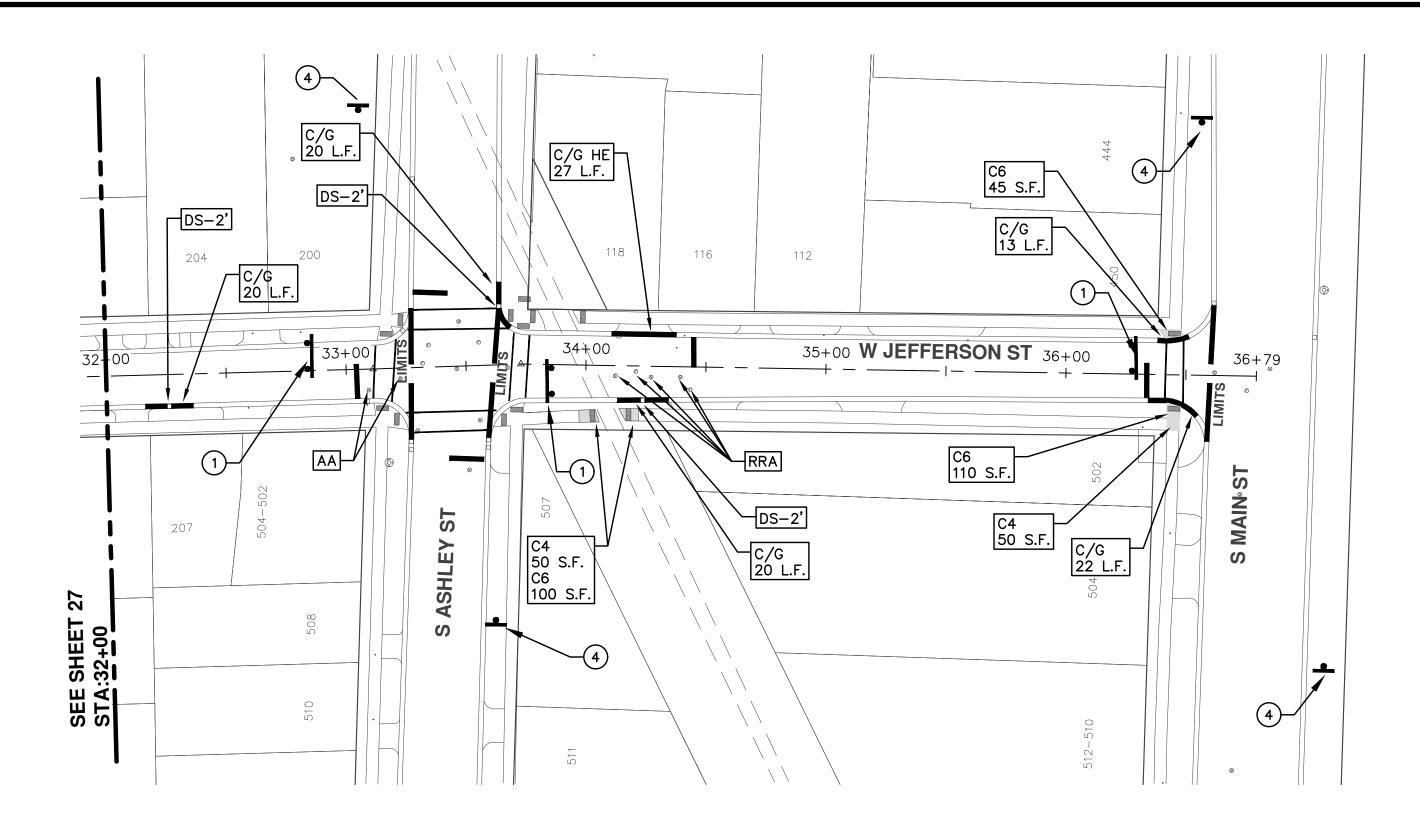

	Know what's below.
	RG DAD CHECKED
	AG,GS,RG AG,GS,RG DRAWN
	03-24-17 03-08-17 DATE
	ADDENDUM #1 BID SET DESCRIPTION
	864 864 864 864 864 864 864 864 864 864
	CITY OF ANN ARBOR PUBLIC SERVICE 301 EAST HURON STREET P.O. BOX 8647 ANN ARBOR, MI 48107-8647 734-794-6410 www.a2gov.org
	ARBOR IN HOLID
	PROJECT MANAGEMENT - PUBLIC SERVICES - CITY OF ANN ARBOR CALE PLAN: 1:40 CALE PLAN: 1:40 ANNUAL STREET RESURFACING - 2017 VANNG NG. ANNUAL STREET RESURFACING - 2017
	PROJECT MANAGEME SCALE PLAN: 1:40 DRAWING No. 2017004-28 2017004-28



CITY OF ANN ARBOR PROJECT MANAGEMENT PROJECT LOCATION: WILDER PLACE ITB No. 4477 FILE No. 2017-004

	QUANTITIES		
Item Code	Item Description	Units	Quantity
2030011	Dr Structure, Rem	Ea	3.000
2030015	Sewer, Rem, Less than 24 inch	Ft	30.000
2047001	_Curb, Gutter, and Curb and Gutter, Any Type, Rem	Ft	152.000
2047011	_Sidewalk, Sidewalk Ramp, and Driveway Approach, Any Thickness, Rem	Syd	13.000
2047050	_Exploratory Excavation (0-10' Deep) Tr Det I	Ea	1.000
2057011	_Grading, Driveway Approach	Syd	14.000
2057011	_Machine Grading, Special	Syd	1,077.000
2057021	_Subgrade Undercutting, Type IIA	Cyd	108.000
2080020	Erosion Control, Inlet Protection, Fabric Drop	Ea	5.000
4020987	Sewer, CI IV, 12 inch, Tr Det B	Ft	30.000
4030200	Dr Structure, 24 inch dia	Ea	3.000
4030050	_Dr Structure Cover, Type K, Modified	Ea	3.000
4037050	_Dr Structure, Adj, Case 1, Modified	Ea	6.000
4037050	_Dr Structure, Temp Lowering, Modified	Ea	3.000
5010003	Cold Milling HMA Surface	Ton	244.000
5010005	HMA Surface, Rem	Syd	34.770
5010703	HMA, LVSP	Ton	244.000
5017031	_HMA, Wedging, 36A	Ton	8.000
6027021	_Flowable Fill	Cyd	5.630
6030005	Cement	Ton	1.000
8017011	_Driveway, Nonreinf Conc, 6 inch, Modified	Syd	14.000
8027001	_Curb and Gutter, Conc	Ft	96.000
8027001	_Driveway Opening, Conc, Det M, Modified	Ft	62.000
8117001	_Pavt Mrkg, Wet Retrflec, Thermopl, 6 inch, Crosswalk	Ft	122.000
8120012	Barricade, Type III, High Intensity, Double Sided, Lighted, Furn	Ea	3.000
8120013	Barricade, Type III, High Intensity, Double Sided, Lighted, Oper	Ea	3.000
8120260	Plastic Drum, High Intensity, Lighted, Furn	Ea	20.000
8120261	Plastic Drum, High Intensity, Lighted, Oper	Ea	20.000
8120350	Sign, Type B, Temp, Prismatic, Fum	Sft	89.500
8120351	Sign, Type B, Temp, Prismatic, Oper	Sft	89.500
8127050	_No Parking Sign	Ea	10.000

KEY	CONSTRUCTION KEY ASSOCIATED PAY ITEM(S)
	_Dr Structure, Adj, Case 1, Modified
AA	 Dr Structure, Adj, Case 2, Modified
	Dr Structure, Temp Lowering, Modified
	_Dr Structure, Temp Lowering, Modified
	• _Gate Box, Adj, Case 1
AB	• _Gate Box, Adj, Case 2
	 _Monument Box Adjust
ADST	 _Dr Structure, Adj, Add Depth, Modified
AK	 _Dr Structure, Adj, Case 1, Modified
	 _Sidewalk, Sidewalk Ramp, and Driveway Approach, Any T
C4	 _Grading, Sidewalk
	 _Sidewalk, Conc, 4 inch, Modified
	 _Sidewalk, Sidewalk Ramp, and Driveway Approach, Any T
C4HE	• _Grading, Sidewalk
	• Cement
	_Sidewalk, Conc, 4 inch, Modified
	 _Sidewalk, Sidewalk Ramp, and Driveway Approach, Any The Crading Cidewalk
	• _Grading, Sidewalk
C6	Grading, Sidewalk Ramp Detectorial Marine Surface Medified
	Detectable Warning Surface, Modified
	_Sidewalk Ramp, Conc, 6 inch, Modified
	Sidewalk, Conc, 6 inch, Modified
C8	 _Grading, Driveway Approach _Driveway, Nonreinf Conc, 8 inch, Modified
	 Driveway, Nomenn Conc, 8 mcn, Modified _Sidewalk, Sidewalk Ramp, and Driveway Approach, Any T
	 Grading, Driveway Approach
	Grading, Sidewalk
	• _Grading, Sidewalk Ramp
	Cement
C HE	_Driveway, Nonreinf Conc, 6 inch, Modified
	_Driveway, Nonreinf Conc, 8 inch, Modified
	Detectable Warning Surface, Modified
	
	 Sidewalk, Conc, 6 inch, Modified
0/0	_Curb, Gutter, and Curb and Gutter, Any Type, Rem
C/G	Curb and Gutter, Conc
	 Curb, Gutter, and Curb and Gutter, Any Type, Rem
C/GHE	• Cement
	 _Driveway Opening, Conc, Det M, Modified
CP	Grading, Sidewalk
UF	 _Sidewalk, Conc, 4 inch, Modified
CR	 Sidewalk, Sidewalk Ramp, and Driveway Approach, Any T
	Dr Structure, Rem
DS	 Sewer, Rem, Less than 24 inch
	Dr Structure, 24 inch dia
	Dr Structure, Rem
DSDI	 Sewer, Rem, Less than 24 inch
	_Dr Structure, Double Inlet
PT	_Dr Structure, Point
	Dr Structure Cover, Type B
RRA	 _Dr Structure Cover, Type B, Special
	 _Dr Structure, Adj, Case 1, Modified
	_Dr Structure, Temp Lowering, Modified
RRK	Dr Structure Cover, Type K
	_Dr Structure, Adj, Case 1, Modified
RS	• _Dr Structure, Reconstruct
TYPE II	Plastic Drum, High Intensity, Lighted, Furn
	Plastic Drum, High Intensity, Lighted, Oper
	In Karricada, Lyna III, High Intensity, Double Sided, Lighted, F
TYPE III	 Barricade, Type III, High Intensity, Double Sided, Lighted, F Barricade, Type III, High Intensity, Double Sided, Lighted, O

Thickness, Rem

Thickness, Rem

Thickness, Rem

Thickness, Rem

Thickness, Rem

	LEGEND
SYMBOL	DESCRIPTION
\$	EXISTING SANITARY SEWER MANHOLE
	EXISTING STORM SEWER MANHOLE
\otimes	EXISTING WATER MAIN VALVE IN WELL
+	WATER MAIN GATE VALVE IN BOX
+Q+	FIRE HYDRANT
(g)	MICHCON GAS CO. VALVE BOX/WELL
t	AMERITECH TELEPHONE VAULT
e	ELECTRIC MANHOLE
•	SOIL BORING
	EXISTING STORM SEWER INLET
•	MONUMENT BOX
	REMOVE AND REPLACE CONC. SIDEWALK
	PLACE CONCRETE SIDEWALK
	REMOVE & REPLACE CONC. CURB & GUTTER
	CONSTRUCTION LIMITS
	6" WRAPPED UNDERDRAIN
	REMOVE CONCRETE SIDEWALK
	SUBGRADE UNDERCUT

CONSTRUCTION METHOD AND SEQUENCING

IN ACCORDANCE WITH THE SCHEDULE OF STREETS WORK ON THIS STREET IS TO OCCUR CONCURRENTLY THAT PROPOSED FOR 5TH STREET AND WEST DAVIS AVENUE. WORK ON THIS STREET INCLUDES. THE FOLLOWING ITEMS. COMPLETE THE WORK IN ACCORDANCE WITH THE PLANS AND SPECIFICATIONS AND AS DIRECTED BY THE ENGINEER. PERFORM THE WORK IN THE ORDER INDICATED AUTHORIZED OR DIRECTED BY THE ENGINEER.

- CONTROL MEASURES.
- COLDMILLING.

- AND MONUMENT BOXES AS REQUIRED.
- REQUIRED.
- AS REQUIRED.
- 12. CLEAN PAVEMENT AND COMPLETE ALL PAVEMENT MARKINGS.
- 14. REMOVE ALL TRAFFIC CONTROL DEVICES, AND MISS DIG FLAGS.

NOTES:

FOR PROTECTION OF UNDERGROUND UTILITIES AND IN CONFORMANCE WITH PUBLIC ACT 174 OF 2013, THE CONTRACTOR SHALL CALL 811 OR 1-800-482-7171 A MINIMUM OF THREE FULL WORKING DAYS, EXCLUDING SATURDAYS, SUNDAYS, AND HOLIDAYS, PRIOR TO BEGINNING EACH EXCAVATION IN AREAS WHERE PUBLIC UTILITIES HAVE NOT BEEN PREVIOUSLY LOCATED. MEMBERS WILL THUS BE ROUTINELY NOTIFIED. THIS DOES NOT RELIEVE THE CONTRACTOR OF THE RESPONSIBILITY OF NOTIFYING UTILITY OWNERS WHO MAY NOT BE A PART OF THE "MISS DIG" ALERT SYSTEM.

THE UNDERGROUND LOCATIONS SHOWN FOR NATURAL GAS, TELEPHONE, ELECTRICAL POWER, CABLE TV AND FIBER OPTIC LINES ARE APPROXIMATE. THE CITY OF ANN ARBOR ASSUMES NO RESPONSIBILITY FOR THEIR ACCURATE REPRESENTATION IN THIS DRAWING. MISS DIG MUST BE CONTACTED PRIOR TO CONSTRUCTION TO LOCATE THESE UTILITIES.

THE IMPROVEMENTS COVERED BY THESE PLANS SHALL BE PERFORMED IN ACCORDANCE WITH MICHIGAN DEPARTMENT OF TRANSPORTATION (MDOT) 2012 STANDARD SPECIFICATIONS FOR CONSTRUCTION, INCLUDING REFERENCED MDOT PUBLICATIONS, AND THE PROJECT CONTRACT DOCUMENTS.

	QUANTITIES						
	Sign, Type B, Temp, Prismatic						
Quantity	Quantity Sign Code Description Area (sft)						
4.0	D3-1	Street Name Sign	4.000	16.000			
3.0	R11-4	Road Closed Sign ("Road Closed To Thru Traffic")	12.500	37.500			
4.0	W20-1	Road Work Ahead Sign	9.000	36.000			
			TOTAL	89.500			

1. IMPLEMENT MAINTENANCE OF TRAFFIC (M.O.T.) PLAN, AND INSTALL SOIL EROSION AND SEDIMENTATION

2. CONDUCT REMOVAL WORK RELATED TO PAVEMENT, DRAINAGE, AND CONCRETE ITEMS WITH EXCEPTION TO

3. INSTALL PROPOSED DRAINAGE STRUCTURES, STORM SEWER, AND UNDERDRAIN AS REQUIRED.

4. PERFORM ALL CONCRETE WORK, INCLUDING RESTORATION, AS REQUIRED.

5. TEMPORARY LOWER ALL STRUCTURE COVERS LOCATED WITHIN THE EXISTING PAVEMENT, INCLUDING GATE

6. REMOVE 4.0 INCHES OF EXISTING HMA SURFACE BY COLDMILLING. THIS MAY INCLUDE GRANULAR BASE MATERIAL. DEPTH TO BE DETERMINED BY THE ENGINEER. PROOF ROLL WITH FULLY LOADED TRUCK.

7. PERFORM ALL JOINT AND CRACK CLEANOUT, HMA/HAND PATCHING, UNDERCUTS AND/OR BASE REPAIRS AS

8. GRADE, SHAPE, AND COMPACT THE EXISTING BASE MATERIAL AS DIRECTED.

9. CLEAN PAVEMENT AS REQUIRED, AND PLACE 2.0 INCH LEVELING COURSE HMA MIX (LOCAL STREETS). 10. ADJUST ALL STRUCTURE COVERS, INCLUDING GATE AND MONUMENT BOXES, TO THEIR FINISHED ELEVATIONS


11. CLEAN PAVEMENT AND PLACE 2.0 INCH TOP COURSE HMA MIX (LOCAL STREETS).


13. COMPLETE ALL MISCELLANEOUS CONSTRUCTION INCLUDING ALL CLEAN UP AND FINAL RESTORATION.



JECT MANAGEMENT - PUBLIC SERVICES - CITY OF ANN ARBOR	PROJECT DESCRIPTION ANNUAL STREET RESURFACING - 2017	WILDER PLACE
FROJECT MANAGEM	T No.	DRAWING No. 2017004-29



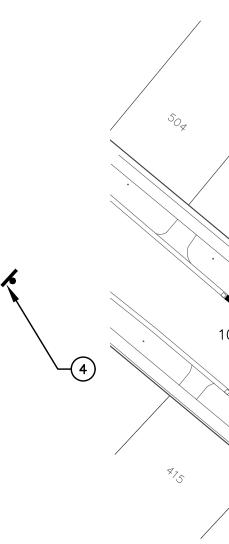

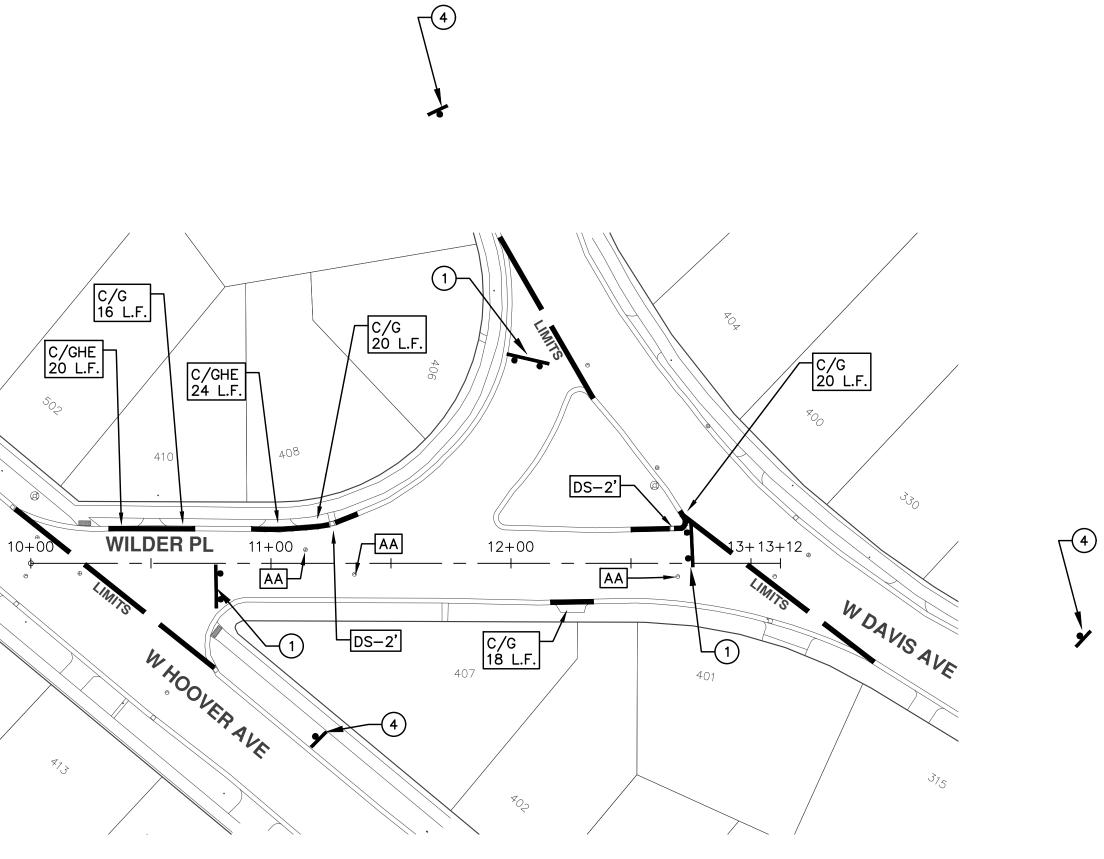

	PROJECT MANAGEME	ANAGEMENT - PUBLIC SERVICES - CITY OF ANN ARBOR	ANN							
3			CITY OF	CITY OF ANN ARBOR						
0	H SCALF PLAN. 1.40									
0	No.	ANNUAL STREET RESURFACING - 2017		301 EAST HURON STREET						
F		WILDER PLACE	O(1) $O(1)$	P.O. BOX 8647 ANN ARBOR. MI 48107-8647	01 ADI	01 ADDENDUM #1	03-24-17	AG,GS,RG	DAD	
136	DRAWING No.		734-		00 BID	BID SET	03-08-17	AG,GS,RG	DAD	Know what's below.
6	2017004-30	STA. 10+00 - STA. 13+12	MICHIGAN WITH		REV.	DESCRIPTION	DATE	DRAWN	DRAWN CHECKED	- Call before you dig.

TRAF	FIC CONTROL SIGN	
	SIGN	NUMBER
1	ROAD CLOSED TO THRU TRAFFIC W/ TYPE III BARRICADE	R11-4 60x30
2	ROAD CLOSED	R11-2 60x30
3	ROAD CLOSED AHEAD	W20-3 36"x36"
	WILDER PL.	D3-1
4	ROAD WORK AHEAD	W20-1 36"x36"
	WILDER PL.	D3-1





Item Code	QUANTITIES Item Description	Units	Quantity
2030011	Dr Structure, Rem	Ea	23.000
2030015	Sewer, Rem, Less than 24 inch	Ft	230.000
2047001	_Curb, Gutter, and Curb and Gutter, Any Type, Rem	Ft	1,433.000
2047001	Sidewalk, Sidewalk Ramp, and Driveway Approach, Any Thickness, Rem	Syd	105.000
2057011	Grading, Driveway Approach	Syd	21.000
2057011	Grading, Sidewalk Ramp	Syd	106.000
2057011	Machine Grading, Special	Syd	420.000
2057011	Subgrade Undercutting, Type IIA	Cyd	1,077.000
2080020	Erosion Control, Inlet Protection, Fabric Drop	Ea	43.000
3020001	Aggregate Base	Ton	115.000
4020987	Sewer, CI IV, 12 inch, Tr Det B	Ft	230.000
4030200	Dr Structure, 24 inch dia	Ea	23.000
4037050	_Dr Structure Cover, Type B, Modified	Ea	20.000
4037050	Dr Structure Cover, Type D, Modified	Ea	1.000
4037050	Dr Structure Cover, Type E, Modified	Ea	2.000
4037050	Dr Structure Cover, Type K, Modified	Ea	22.000
4037050	Dr Structure, Adj, Case 1, Modified	Ea	59.000
4037050	Dr Structure, Temp Lowering, Modified	Ea	34.000
5010003		Ton	2,786.000
5010003	Cold Milling HMA Surface		
5010003	HMA Surface, Rem HMA, LVSP	Syd Top	159.000
5010703	HMA, LVSP HMA, Approach	Ton Ton	3,598.000
5010081	HMA, Wedging, 36A	Ton	292.000
5017050 6027021	_HMA Surface, Around Structure Cover, Rem Flowable Fill	Ea	44.000
6027021	Cement	Cyd Ton	53.074 3.000
8017011			21.000
	_Driveway, Nonreinf Conc, 8 inch, Modified	Syd	
8027001	_Curb and Gutter, Conc	Ft Et	720.000
8027001	_Driveway Opening, Conc, Det M, Modified	Ft	544.000
8037010 8050020	_Sidewalk Ramp, Conc, 6 inch, Modified Curb Vertical, HMA	Sft Ft	948.000
	Rem Raised Pavt Marker		169.000
8110332	Pavt Mrkg, Wet Retrflec, Thermopl, 4 inch, White	Ea	80.000
8110520	Pavt Mrkg, Wet Retriec, Thermopi, 4 inch, White	Ft	5,908.000
8110521		Ft	6,151.00
8110524	Pavt Mrkg, Wet Retrflec, Thermopl, 4 inch, Yellow Pavt Mrkg, Wet Retrflec, Thermopl, 24 inch, Stop Bar	Ft Ft	12,059.000
8117001		Ft	224.000
8117001	_Pavt Mrkg, Wet Retrflec, Thermopl, 12 inch, Crosswalk	Ft	160.000
8117050	Pavt Mrkg, Wet Retrflec, Thermopl, Only	Ea	2.000
8117050	Pavt Mrkg, Wet Retrflec, Thermopl, Lt Turn Arrow Sym	Ea	2.000
8117050	Pavt Mrkg, Wet Retrflec, Thermopl, Rt Turn Arrow Sym	Ea	2.000
8120012	Barricade, Type III, High Intensity, Double Sided, Lighted, Furn	Ea	15.000
8120013	Barricade, Type III, High Intensity, Double Sided, Lighted, Oper	Ea	15.000
8120140	Lighted Arrow, Type C, Furn	Ea	2.00
8120141	Lighted Arrow, Type C, Oper	Ea	2.000
8120260	Plastic Drum, High Intensity, Lighted, Furn	Ea	240.000
8120261	Plastic Drum, High Intensity, Lighted, Oper	Ea	240.000
8120330	Sign, Portable, Changeable Message, Furn	Ea	2.000
8120331	Sign, Portable, Changeable Message, Oper	Ea	2.00
8120350	Sign, Type B, Temp, Prismatic, Fum	Sft	845.00
8120351	Sign, Type B, Temp, Prismatic, Oper	Sft	845.000
8167011	_Slope Restoration	Syd	526.00
8217050	_Monument Box Adjust	Ea	1.000
8230431	Gate Box, Adj, Case 1	Ea	10.00

ANA

	CONSTRUCTIO
KEY	ASSOCIATED PAY ITEM(S)
	• _Dr Structure, Adj, Case 1, Modified
AA	• _Dr Structure, Adj, Case 2, Modified
925 <u>535</u> 999	• _Dr Structure, Temp Lowering, Modifie
	Dr Structure, Temp Lowering, Modifie
	 Gate Box, Adj, Case 1
AB	• _Gate Box, Adj, Case 2
	Monument Box Adjust
ADST	
AK	 _Dr Structure, Adj, Case 1, Modified
741	 _Sidewalk, Sidewalk Ramp, and Drive
C4	 Grading, Sidewalk
04	• _Sidewalk, Conc, 4 inch, Modified
	 _Sidewalk, Sidewalk Ramp, and Drive
C4HE	 _Grading, Sidewalk Cement
	• _Sidewalk, Conc, 4 inch, Modified
	_Sidewalk, Sidewalk Ramp, and Drive
	• _Grading, Sidewalk
C6	 _Grading, Sidewalk Ramp
	 _Detectable Warning Surface, Modifie
	 _Sidewalk Ramp, Conc, 6 inch, Modif
	 _Sidewalk, Conc, 6 inch, Modified
C8	 Grading, Driveway Approach
0	 _Driveway, Nonreinf Conc, 8 inch, Mod
	 _Sidewalk, Sidewalk Ramp, and Drive
	 Grading, Driveway Approach
	 _Grading, Sidewalk
	 Grading, Sidewalk Ramp
	• Cement
C HE	• _Driveway, Nonreinf Conc, 6 inch, Mo
	 Driveway, Nonreinf Conc, 8 inch, Mod
	 Detectable Warning Surface, Modifie
	 _Sidewalk Ramp, Conc, 6 inch, Modifi
	 _Sidewalk, Conc, 6 inch, Modified
	_Curb, Gutter, and Curb and Gutter, A
C/G	 Curb and Gutter, Conc
	_Curb, Gutter, and Curb and Gutter, A
C/GHE	Cement
0/ONL	_Driveway Opening, Conc, Det M, Mo
	 Grading, Sidewalk
CP	_
CR	Sidewalk, Conc, 4 inch, Modified
UK	 Sidewalk, Sidewalk Ramp, and Drive
DO	Dr Structure, Rem
DS	• Sewer, Rem, Less than 24 inch
	Dr Structure, 24 inch dia
DOD	• Dr Structure, Rem
DSDI	Sewer, Rem, Less than 24 inch
	Dr Structure, Double Inlet
PT	_Dr Structure, Point
	 Dr Structure Cover, Type B
RRA	• _Dr Structure Cover, Type B, Special
	 _Dr Structure, Adj, Case 1, Modified
	 _Dr Structure, Temp Lowering, Modifie
RRK	 Dr Structure Cover, Type K
ININIX	 _Dr Structure, Adj, Case 1, Modified
RS	_Dr Structure, Reconstruct
	• Plastic Drum, High Intensity, Lighted,
TYPE II	• Plastic Drum, High Intensity, Lighted,
	• Barricade, Type III, High Intensity, Dou
TYPE III	• Barricade, Type III, High Intensity, Dou
	, , , , , , , , , , , , , , , , , , , ,

CITY OF ANN ARBOR PROJECT MANAGEMENT PROJECT LOCATION: ARLINGTON BOULEVARD

ITB No. 4477 FILE No. 2017-004

CONSTRUCTION KEY		NSTF	RUCTIO	N METHOD AND SEQUENCING		
/ ITEM(S)						
i, Case 1, Modified	WOR	K ON THI	S STREET II	NCLUDES, BUT IS NOT LIMITED TO, THE FOLLOWING ITEMS.	COMPLET	E THE
i, Case 2, Modified				TH THE PLANS AND SPECIFICATIONS, AS DIRECTED BY THE		
mp Lowering, Modified	UTILI	ZING PAR	RT WIDTH 1	TWO (2) PHASE CONSTRUCTION. PERFORM THE WORK	IN THE	ORDER
np Lowering, Modified	INDIC	CATED BE	LOW UNLES	S OTHÉRWISE AUTHORIZED OR DIRECTED BY THE ENGINEE	ER. COM	IPLETE
Case 1 Case 2				ZING THE M.O.T. PLAN CURRENTLY IN PLACE, LANE CLOSUI	RES, AND	FLAG
Adjust	CON	TROL OPER	RATIONS AS	DIRECTED BY THE ENGINEER.		
i, Add Depth, Modified						
i, Case 1, Modified	PHAS	<u>SE 1A</u> – V	WASHTENAW	AVEUNE TO HEATHER WAY (SOUTH)		
alk Ramp, and Driveway Approach, Any Thickness, Rem						
lk				NCE OF TRAFFIC (M.O.T.) PLAN, AND INSTALL SOIL EROSION ROL MEASURES.	AND	
4 inch, Modified	4			NOE MEASURES.		
alk Ramp, and Driveway Approach, Any Thickness, Rem Ik			REMOVAL W N TO COLDM	VORK RELATED TO PAVEMENT, DRAINAGE, AND CONCRETE ITE	MS WITH	
4 inch, Modified	3.			RAINAGE STRUCTURES, STORM SEWER, AND UNDERDRAIN AS	REOURE	١
alk Ramp, and Driveway Approach, Any Thickness, Rem	J.	INSTALL F		KAINAGE STRUCTURES, STORM SEWER, AND UNDERDRAIN AS		·•
lk Ik Ramp	4.	PERFORM	ALL CONCR	ETE WORK, INCLUDING RESTORATION.		
ing Surface, Modified				LI STRUCTURE COVERS LOCATER WITHIN THE EVICTING RAVE		- •
Conc, 6 inch, Modified				LL STRUCTURE COVERS LOCATED WITHIN THE EXISTING PAVE MONUMENT BOXES.	MENT ARE	_A,
6 inch, Modified		INCLUDING	GATE AND	MONOMENT BOXES.		
y Approach	6.	REMOVE 4	INCHES OF	F EXISTING HMA SURFACE BY COLDMILLING. THIS MAY INCLU	DE GRANI	JLAR
nf Conc, 8 inch, Modified				TH TO BE DETERMINED BY THE ENGINEER. PROOF ROLL WITH		
alk Ramp, and Driveway Approach, Any Thickness, Rem		TRUCK.				
y Approach						
	7.	PERFORM	ALL JOINT	AND CRACK CLEANOUT. HMA/HAND PATCHING, UNDERCUTS A	AND/OR B	ASE
lk Ramp		REPAIRS	AS REQUIRE	D.		
nf Conc, 6 inch, Modified				CONDACT THE EVICTING DASE MATERIAL AS DECLIDED		
nf Conc, 8 inch, Modified	8.	GRADE, S	HAPE, AND	COMPACT THE EXISTING BASE MATERIAL AS REQUIRED.		
ing Surface, Modified	9.					
Conc, 6 inch, Modified	9.	CLEAN FA	VENIENT AN	D PLACE 2 INCH LEVELING COURSE HMA MIX (LVSP).		
6 inch, Modified	рна,	SF 1R _ \	NACHTENAW	AVEUNE TO HEATHER WAY (SOUTH)		
d Curb and Gutter, Any Type, Rem				Aveone to heather wat (Sooth)		
Conc	10.	REPEAT I	TEMS 1 THRU	U 9 IN THE ORDER SHOWN SHOWN ABOVE.		
d Curb and Gutter, Any Type, Rem						
a Cone Det M Medified	ļ			QUANTITIES		
g, Conc, Det M, Modified	- I		-	Sign, Type B, Temp, Prismatic		
4 inch, Modified		Quantity	Sign Code	Description	Area (sft)	Total
alk Ramp, and Driveway Approach, Any Thickness, Rem	1	Quantity	Sign Code		Alea (Sit)	Area
)]	1	15.0	D3-1	Street Name Sign	4.000	60.000
s than 24 inch		1.0	M4-10L	Detour Arrow (Right) Sign	6.000	6.000
nch dia	ļ	1.0	M4-8a	End Detour Sign	3.000	3.000
1		3.0	M4-9L	Detour Sign (w/Left Arrow)	5.000	15.000
s than 24 inch		2.0	M4-9R	Detour Sign (w/Right Arrow)	5.000	10.000
uble Inlet]	5.0	M4-9S	Detour Sign (w/Thru Arrow)	5.000	25.000
int	Į	2.0	R5-1	Do Not Enter Sign	6.250	12.500
r, Type B					_	
er, Type B, Special i, Case 1, Modified		2.0	R5-1A	Wrong Way Sign	6.000	12.000
np Lowering, Modified		15.0	R11-2	Road Closed Sign ("Road Closed")	8.000	120.000
r, Type K	1 I	15.0	R11-3a	Road Closed Sign ("Road Closed Local Traffic Only")	12.500	187.500
i, Case 1, Modified		7.0	R3-1	Movement Prohibition Sign ("No Right Turn")	4.000	28.000
construct	1	8.0	R3-2	Movement Prohibition Sign ("No Left Turn")	5.000	40.000
h Intensity, Lighted, Furn		6.0	R6-1R	One Way (Left) Sign	3.000	18.000
h Intensity, Lighted, Oper]	7.0	R6-1L	One Way (Right) Sign	3.000	21.000
l, High Intensity, Double Sided, Lighted, Furn		0.0	R6-2R	One Way	3.000	0.000
l, High Intensity, Double Sided, Lighted, Oper	J ł	4.0	SP-1	Special Sign	20.000	80.000
		19.0	W20-1	Road Work Ahead Sign	9.000	171.000
		2.0	W20-3	Road Closed Ahead	9.000	18.000
		2.0	W20-2	Detour Ahead	9.000	18.000
		I	· ····		1 I	

ELEVATION. ELEVATION.

NOTES:

FOR PROTECTION OF UNDERGROUND UTILITIES AND IN CONFORMANCE WITH PUBLIC ACT 174 OF 2013, THE CONTRACTOR SHALL CALL 811 OR 1-800-482-7171 A MINIMUM OF THREE FULL WORKING DAYS, EXCLUDING SATURDAYS, SUNDAYS, AND HOLIDAYS, PRIOR TO BEGINNING EACH EXCAVATION IN AREAS WHERE PUBLIC UTILITIES HAVE NOT BEEN PREVIOUSLY LOCATED. MEMBERS WILL THUS BE ROUTINELY NOTIFIED. THIS DOES NOT RELIEVE THE CONTRACTOR OF THE RESPONSIBILITY OF NOTIFYING UTILITY OWNERS WHO MAY NOT BE A PART OF THE "MISS DIG" ALERT SYSTEM.

UTILITIES.

TOTAL

845.000

LEGEND		
SYMBOL	DESCRIPTION	
\$	EXISTING SANITARY SEWER MANHOLE	
	EXISTING STORM SEWER MANHOLE	
\otimes	EXISTING WATER MAIN VALVE IN WELL	
+	WATER MAIN GATE VALVE IN BOX	
+Q+	FIRE HYDRANT	
(g)	MICHCON GAS CO. VALVE BOX/WELL	
t	AMERITECH TELEPHONE VAULT	
e	ELECTRIC MANHOLE	
•	SOIL BORING	
	EXISTING STORM SEWER INLET	
•	MONUMENT BOX	
	REMOVE AND REPLACE CONC. SIDEWALK	
	PLACE CONCRETE SIDEWALK	
	REMOVE & REPLACE CONC. CURB & GUTTER	
	CONSTRUCTION LIMITS	
	6" WRAPPED UNDERDRAIN	
	REMOVE CONCRETE SIDEWALK	
	SUBGRADE UNDERCUT	



11. ADJUST ALL STRUCTURE COVERS, INCLUDING GATE AND MONUMENT BOXES, TO THEIR FINISH

PHASE 2A - HEATHER WAY (SOUTH) TO GEDDES AVENUE

12. REPEAT ITEMS 1 THRU 3 IN THE ORDER SHOWN SHOWN ABOVE

13. REMOVE 2 INCHES OF EXISTING HMA SURFACE BY COLDMILLING.

14. PERFORM ALL JOINT AND CRACK CLEANOUT. HMA/HAND PATCHING, UNDERCUTS AND/OR BASE REPAIRS AS REQUIRED.

15. ADJUST ALL STRUCTURE COVERS. INCLUDING GATE AND MONUMENT BOXES. TO THEIR FINISH

16. CLEAN PAVEMENT AND PLACE 2 INCH TOP COURSE HMA MIX (LVSP)

PHASE 2B - HEATHER WAY (SOUTH) TO GEDDES AVENUE

17. REPEAT ITEMS 12 THRU 16 IN THE ORDER SHOWN SHOWN ABOVE.

18. CLEAN PAVEMENT AND PLACE ALL HMA APPROACHES AS REQUIRED.

19. CLEAN PAVEMENT AND COMPLETE ALL PERMANENT PAVEMENT MARKINGS.

20. COMPLETE ALL MISCELLANEOUS CONSTRUCTION INCLUDING ALL CLEANUP AND FINAL RESTORATION.

21. REMOVE ALL TRAFFIC CONTROL DEVICES AND MISS DIG FLAGS.

NOTE: PLACEMENT OF THE HMA TOP COURSE SHOWN TO BE COMPLETED IN PHASES 2A AND 2B SHALL EXTEND FROM WASHTENAW AVENUE AND GEDDES AVENUE.


THE UNDERGROUND LOCATIONS SHOWN FOR NATURAL GAS, TELEPHONE, ELECTRICAL POWER, CABLE TV AND FIBER OPTIC LINES ARE APPROXIMATE. THE CITY OF ANN ARBOR ASSUMES NO RESPONSIBILITY FOR THEIR ACCURATE REPRESENTATION IN THIS DRAWING. MISS DIG MUST BE CONTACTED PRIOR TO CONSTRUCTION TO LOCATE THESE


THE IMPROVEMENTS COVERED BY THESE PLANS SHALL BE PERFORMED IN ACCORDANCE WITH MICHIGAN DEPARTMENT OF TRANSPORTATION (MDOT) 2012 STANDARD SPECIFICATIONS FOR CONSTRUCTION, INCLUDING REFERENCED MDOT PUBLICATIONS, AND THE PROJECT CONTRACT DOCUMENTS.








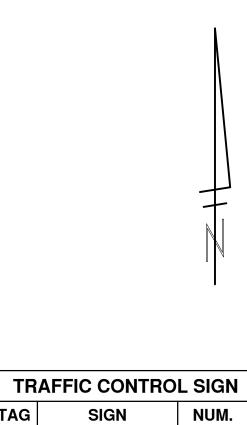


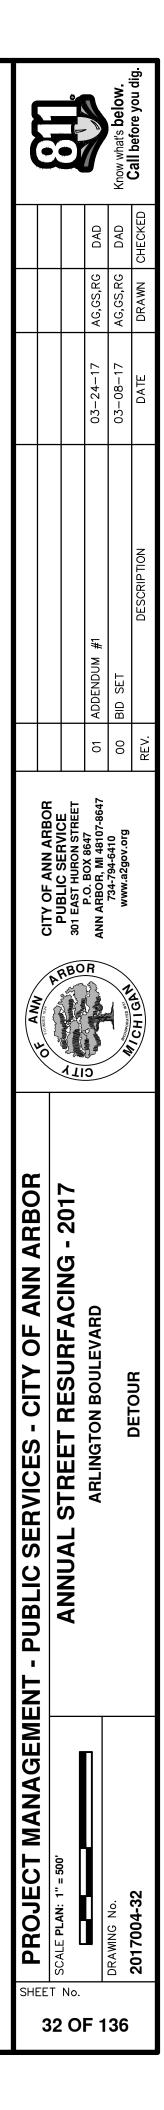


TAG	SIGN	NUM.
	ARLINGTON BLVD	D3-1
10	DETOUR	M4-9S 30x24
(11)	ARLINGTON BLVD	D3-1 M4-9R
<u> </u>		30x24
(12)	ARLINGTON BLVD	D3-1 M4-9L
		30x24
		D3-1
(13)	DETOUR ENDS	M4—8a 24X18
14	SOUTH BOUND AFLINGTON BLVD CLOBED AT WASHTENAW AVE	SPECIAL 48x60
(15)	SOUTH BOUND AFLINGTON BLVD CLOSED	SPECIAL 48x60
16	DETOUR AHEAD W20-2 36"x36" ARLINGTON BLVD D3-1	W20-2 36"X36"
(17)	DO NOT ENTER R5-1 30x30	R5–1 30"X30'
18	WRONG WAY	R5–1A 42"x30"
(19)	ROAD CLOSED AHEAD W20-3 36"×36" APLINGTON BLVD D3-1	W20-3 36"X36"

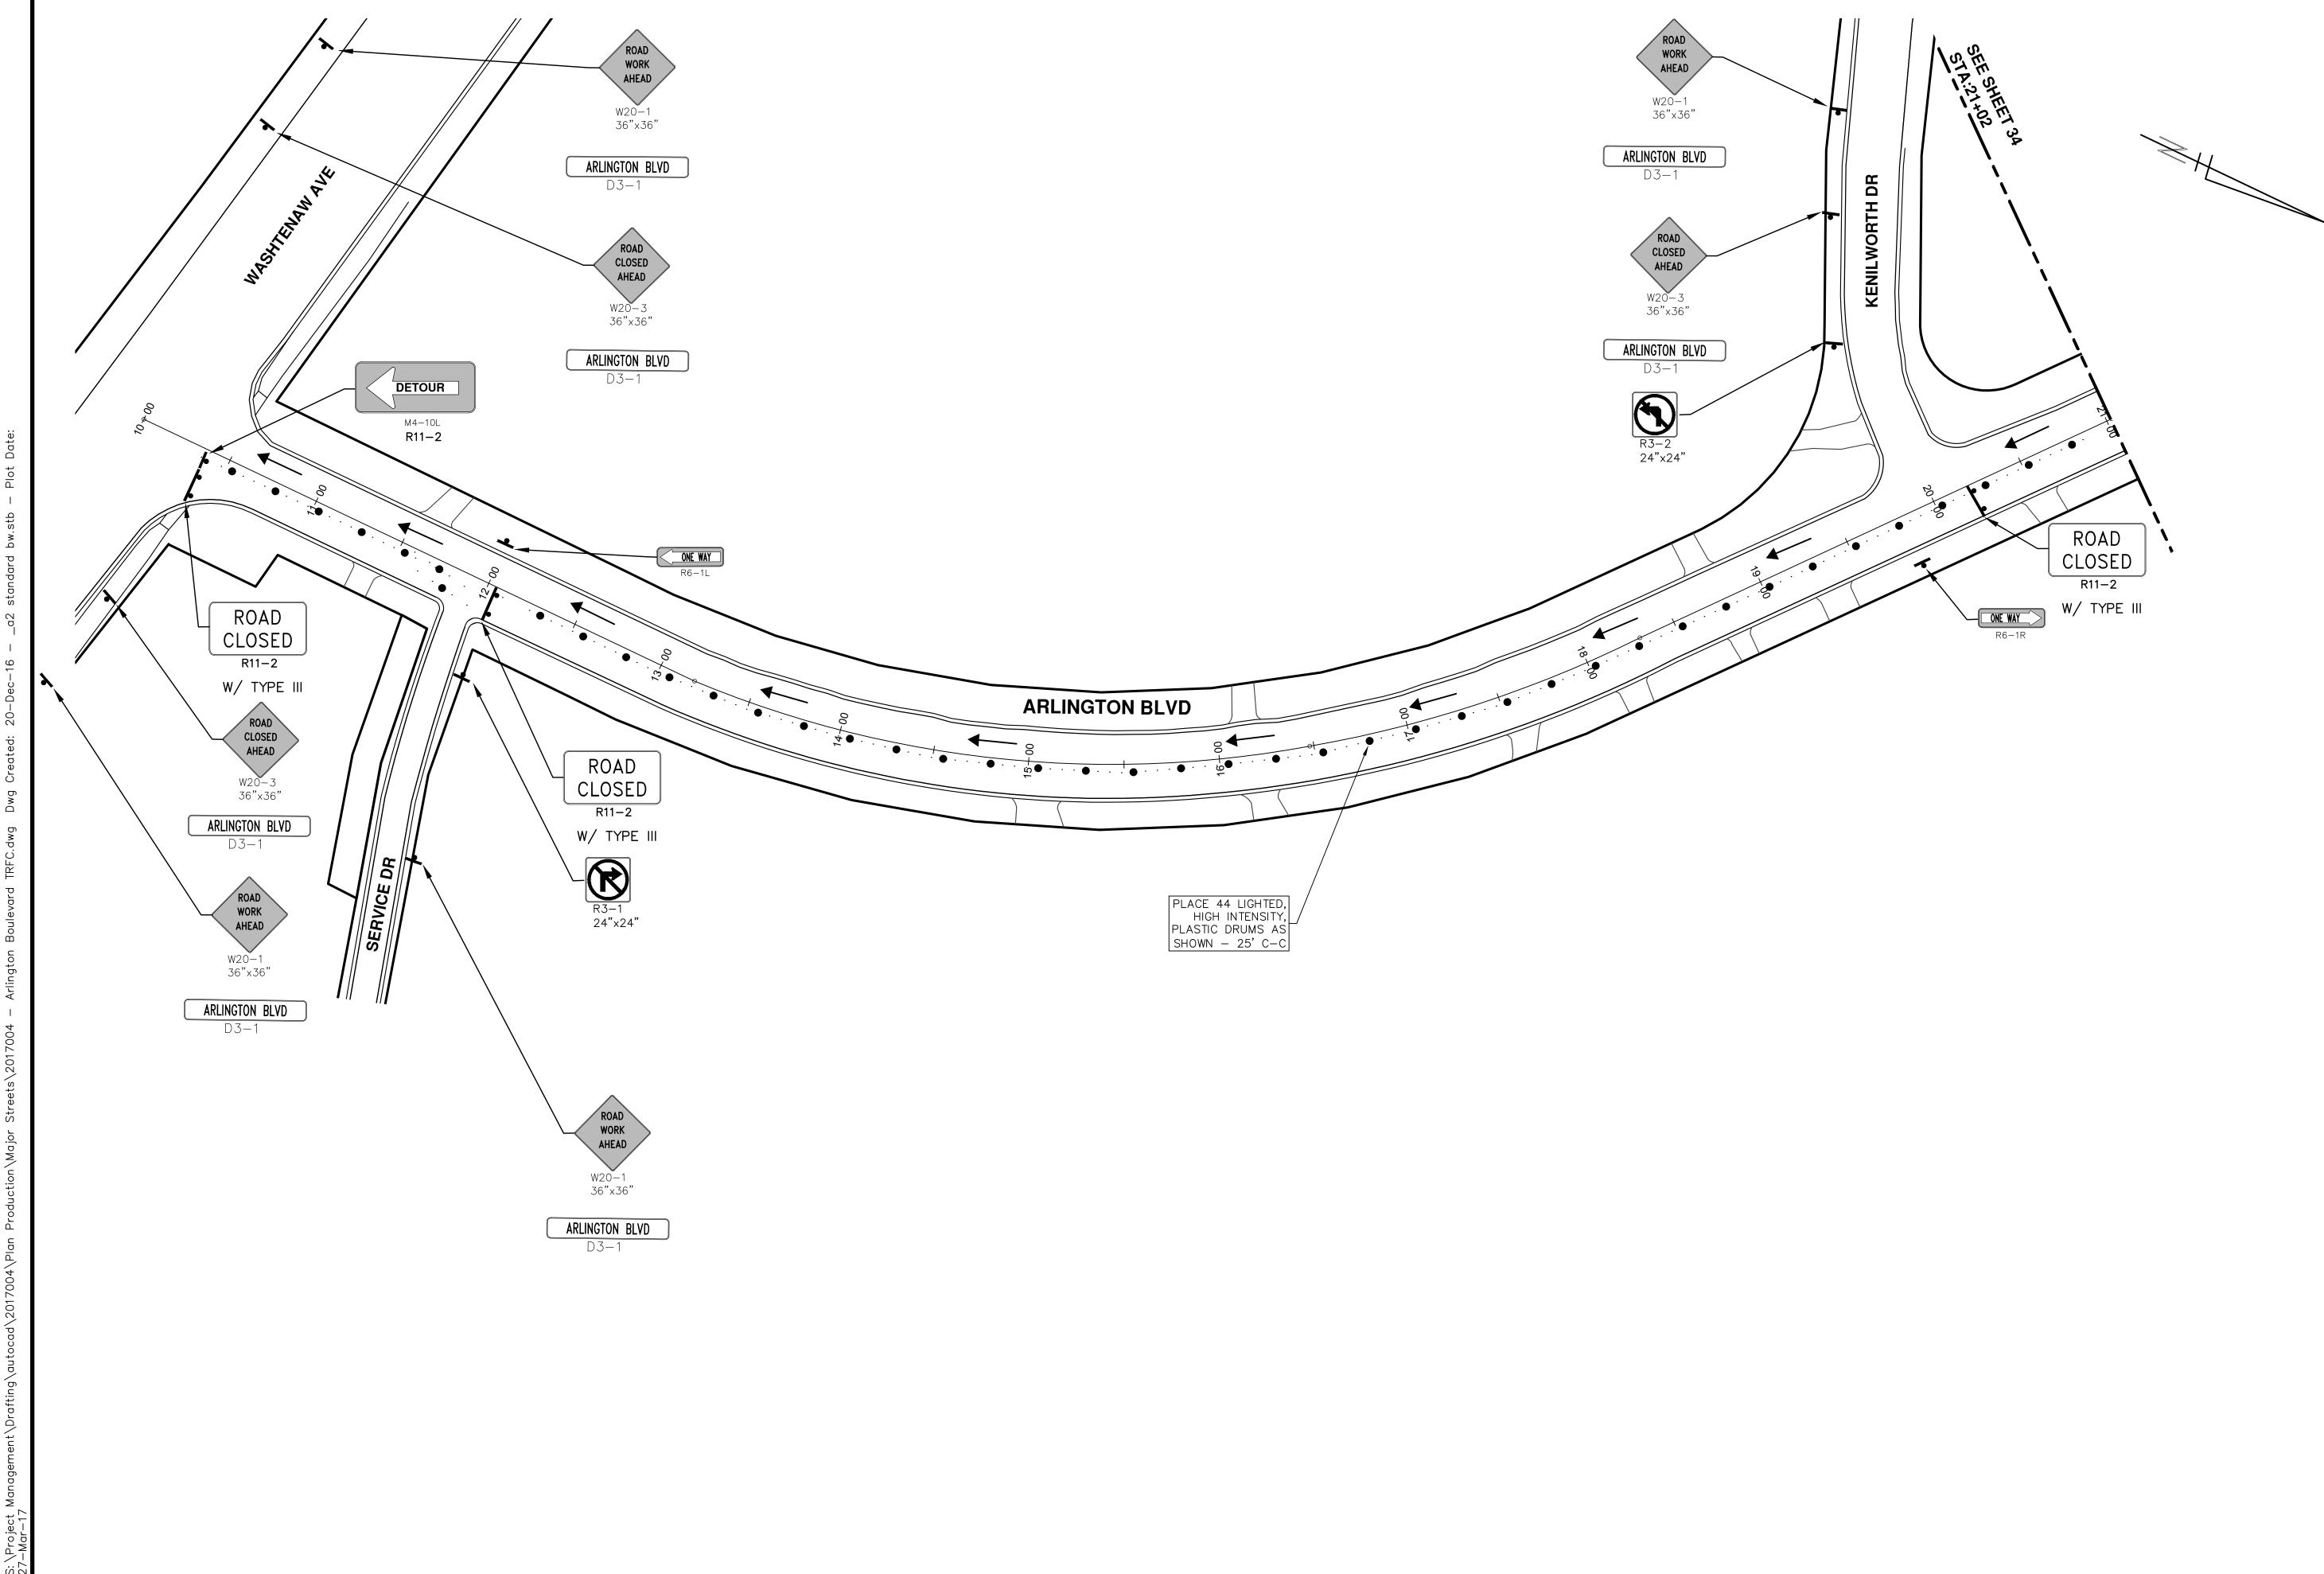


 α Si si

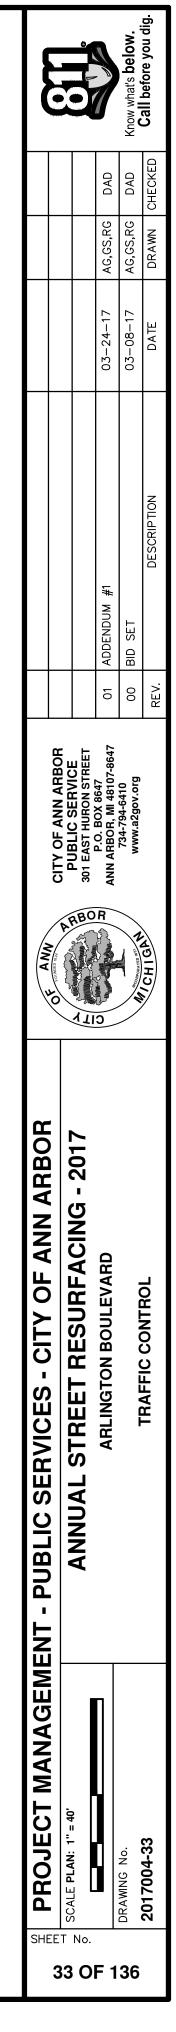


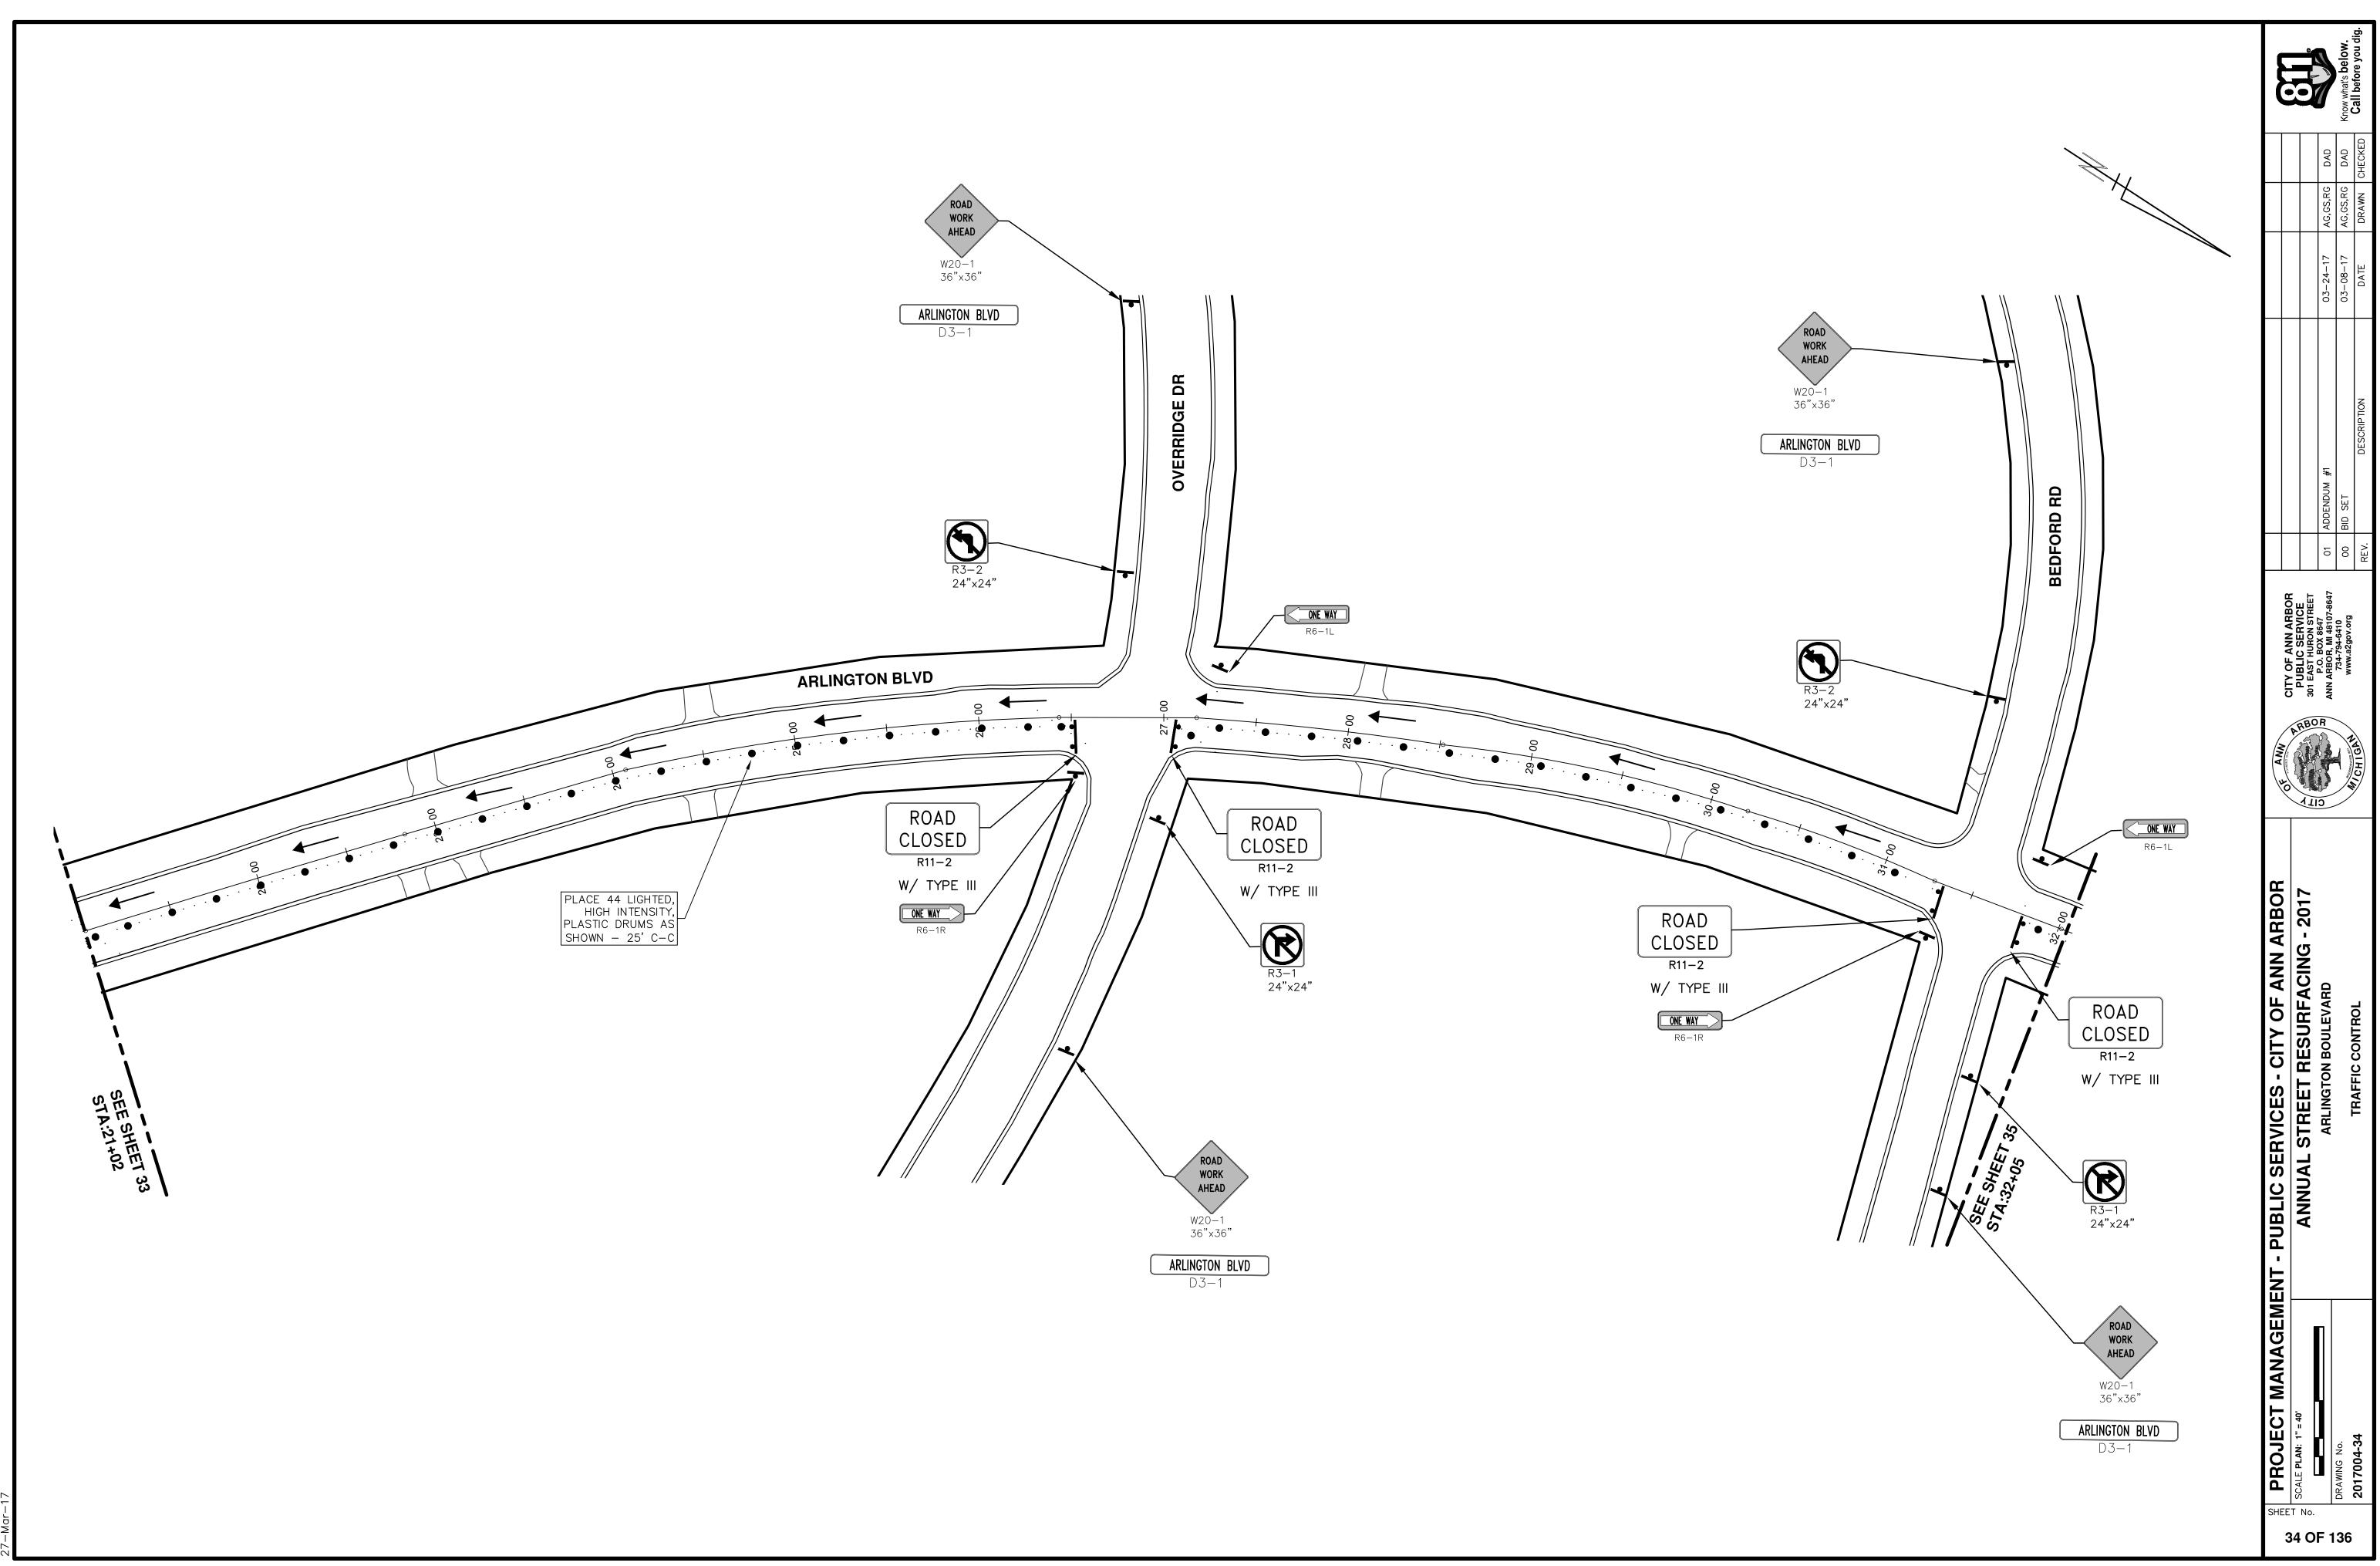


4 ∖Proje('-Marς, Υ

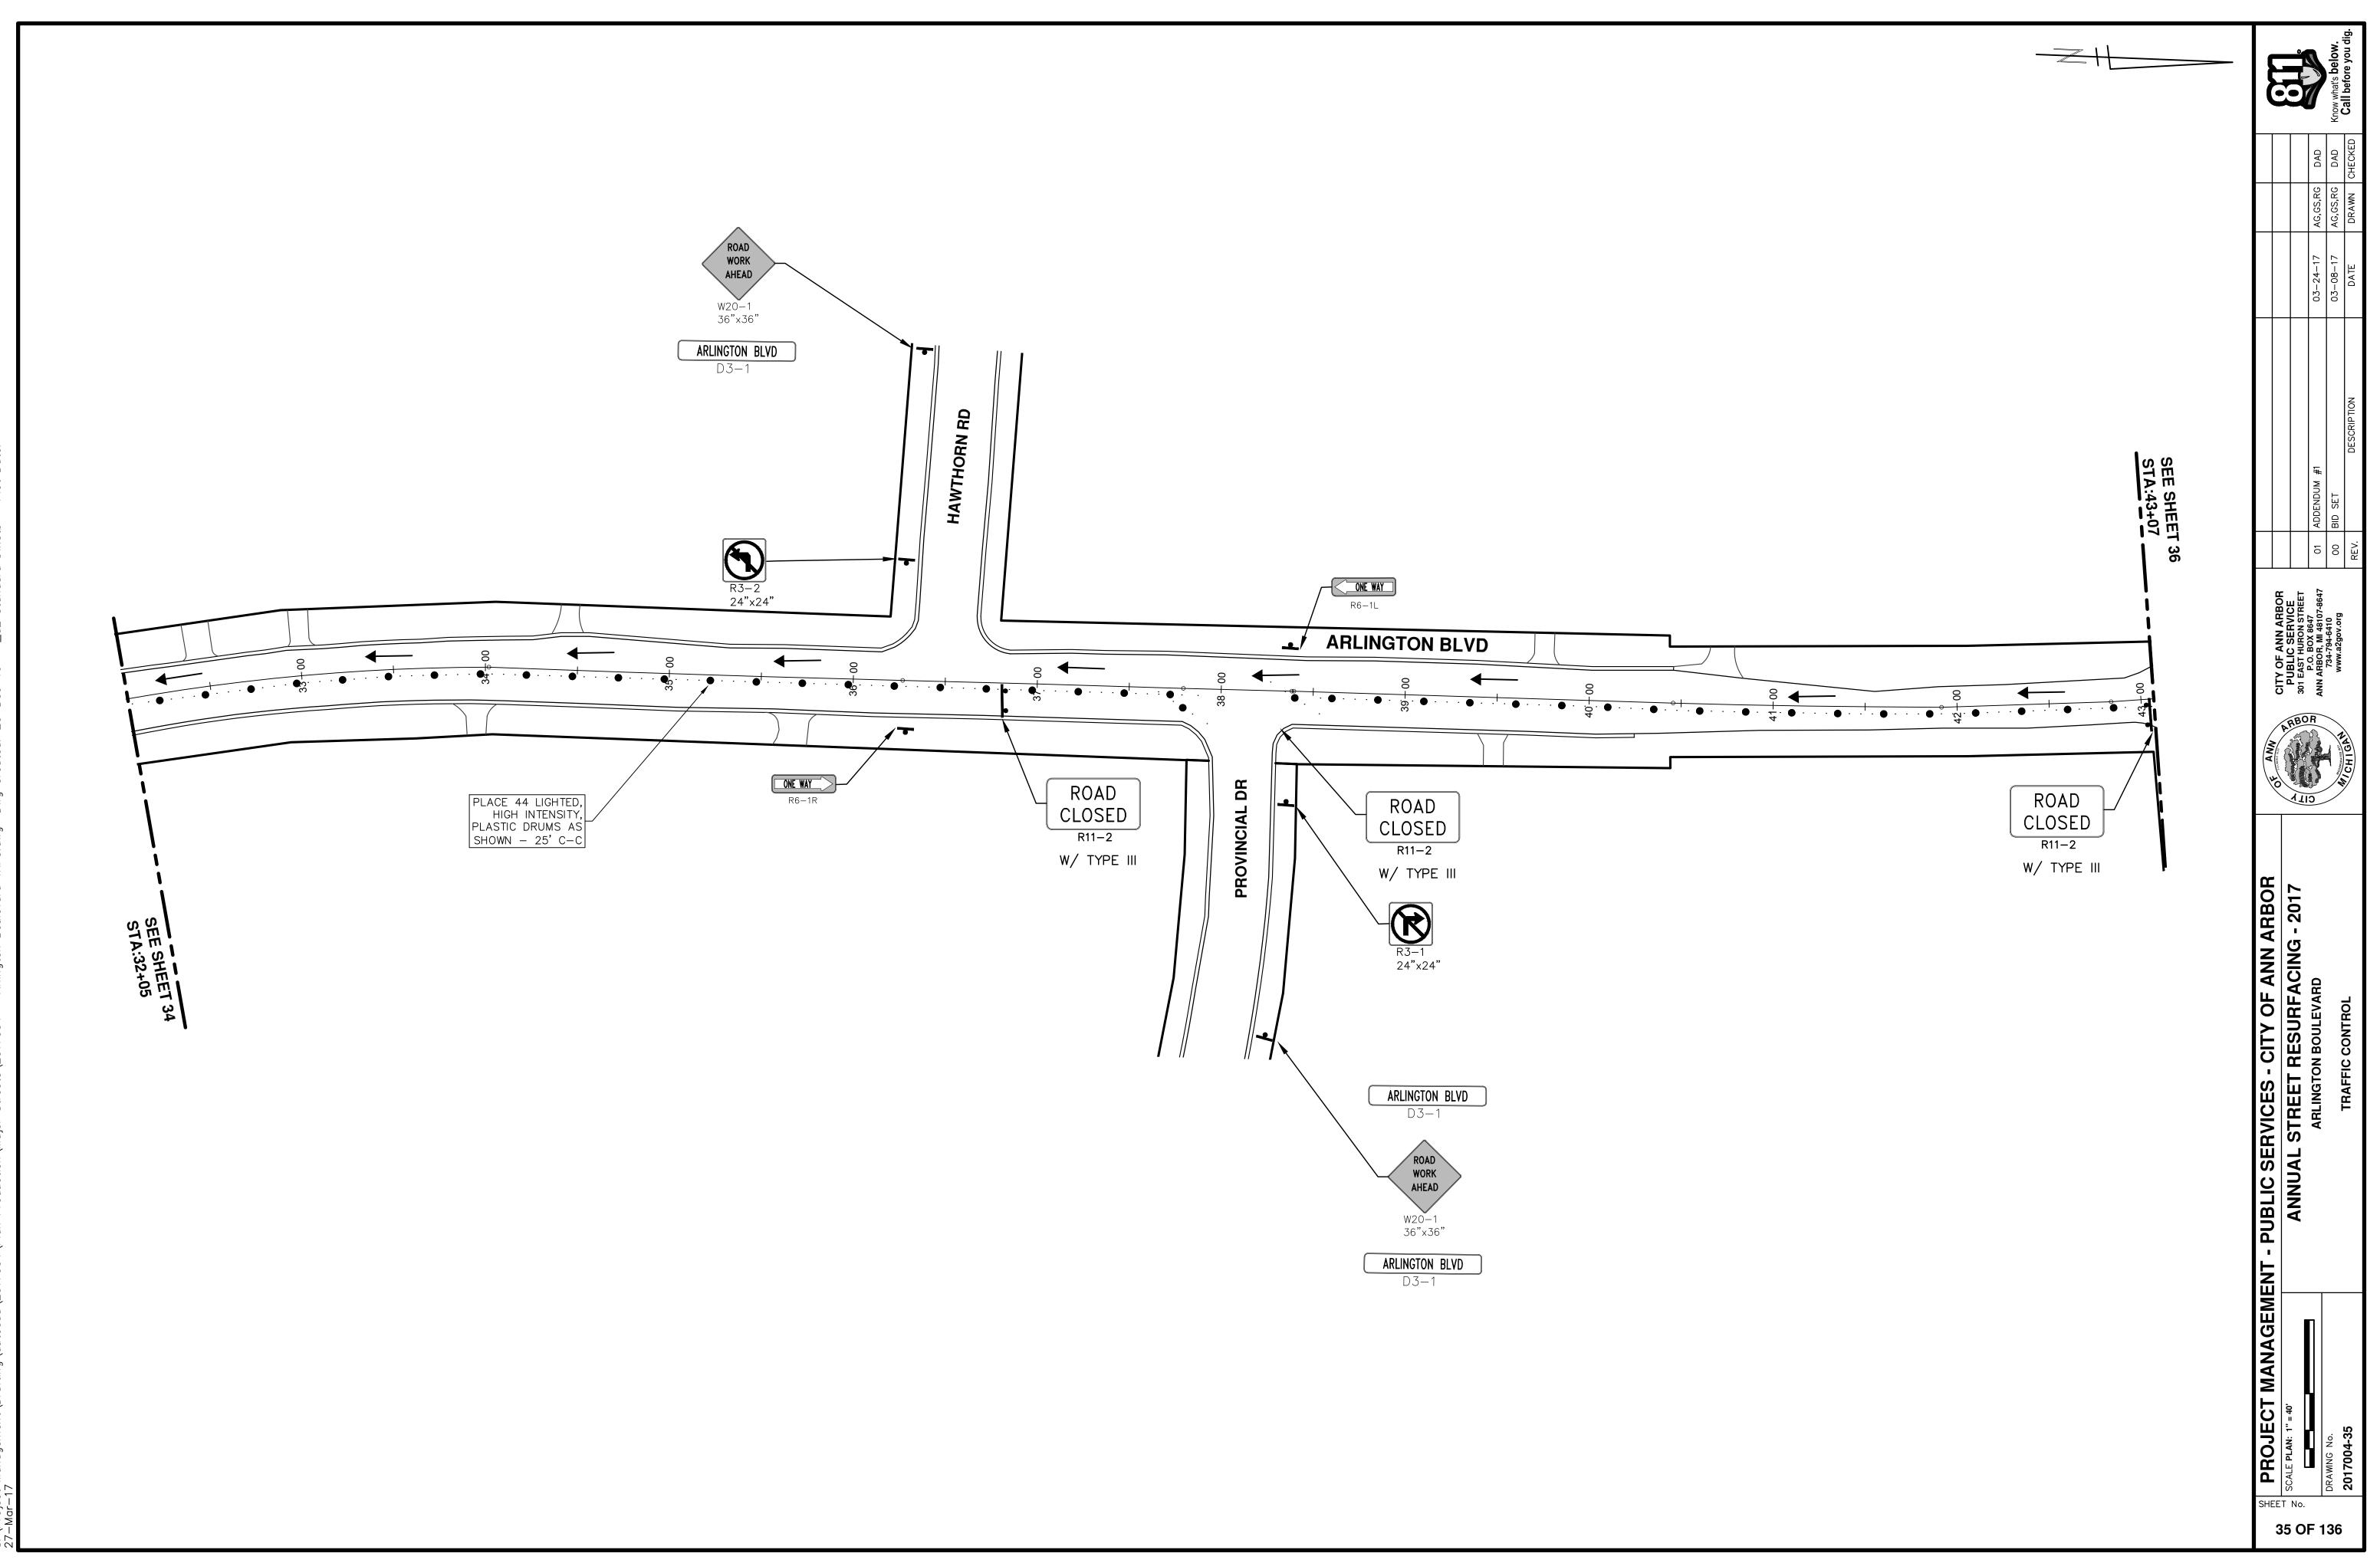


4 \Project 7-Mar-17 S'N

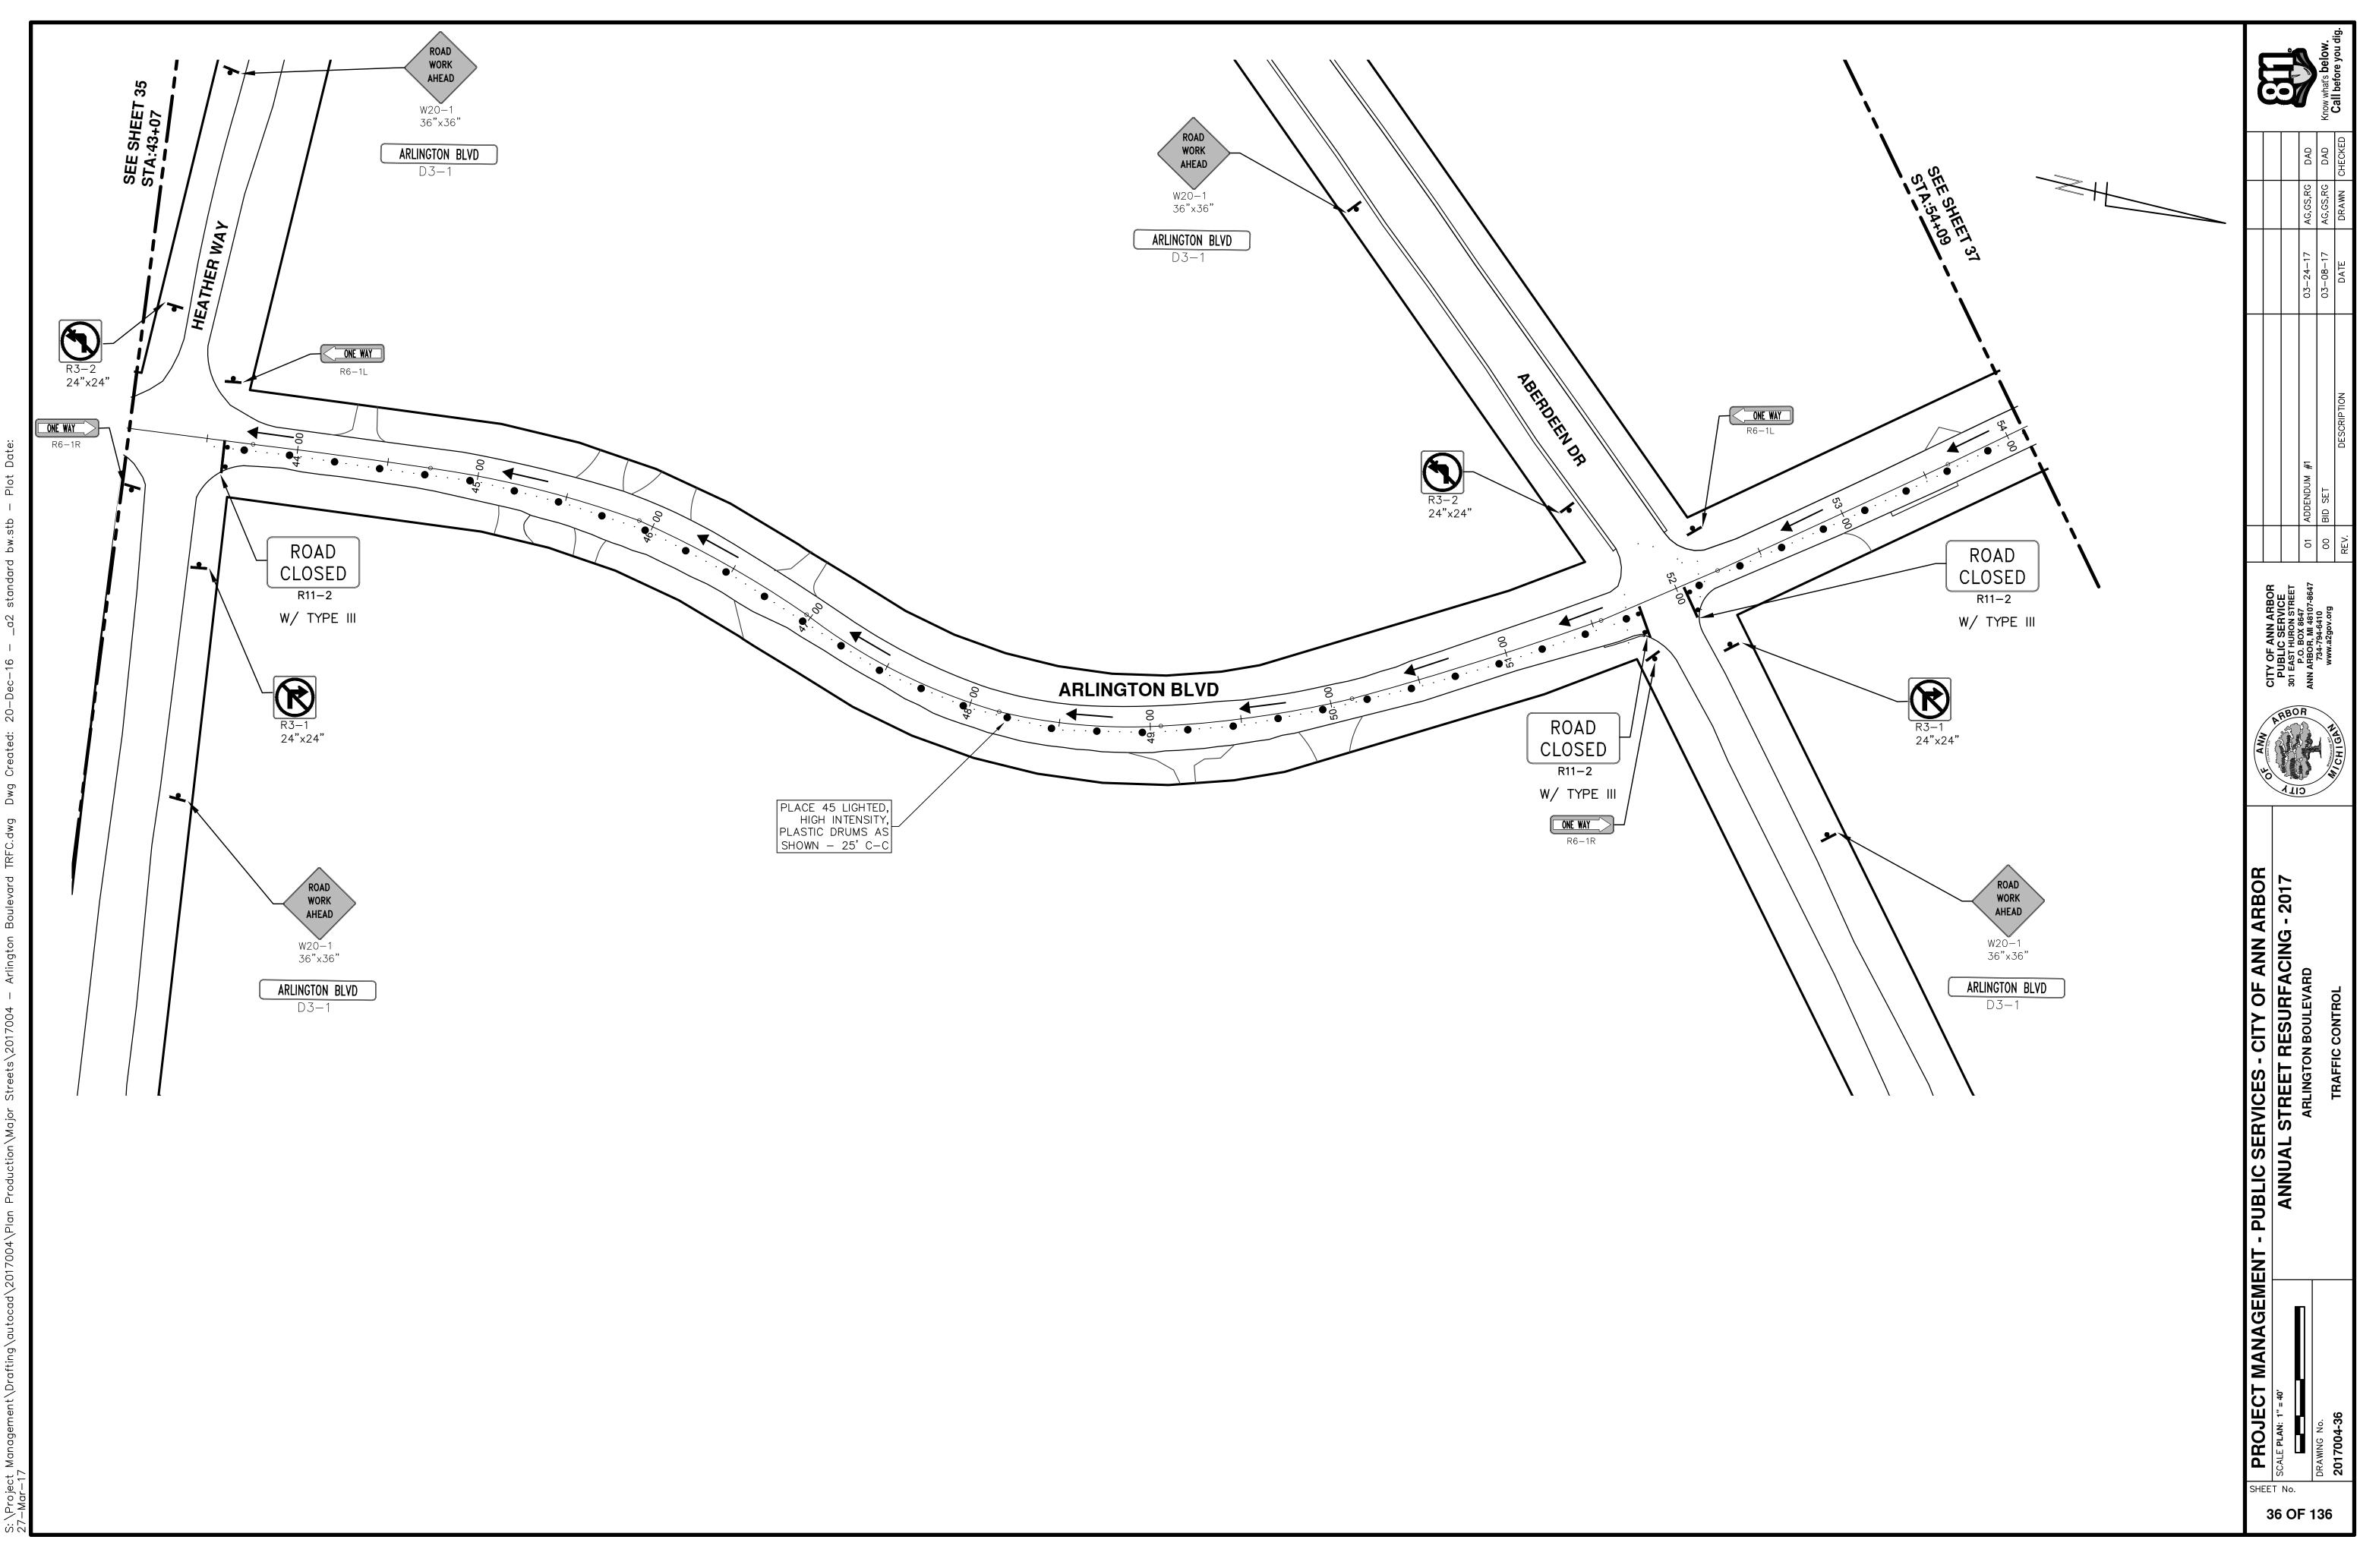


 α 4 Ū \Project 7-Mar-17

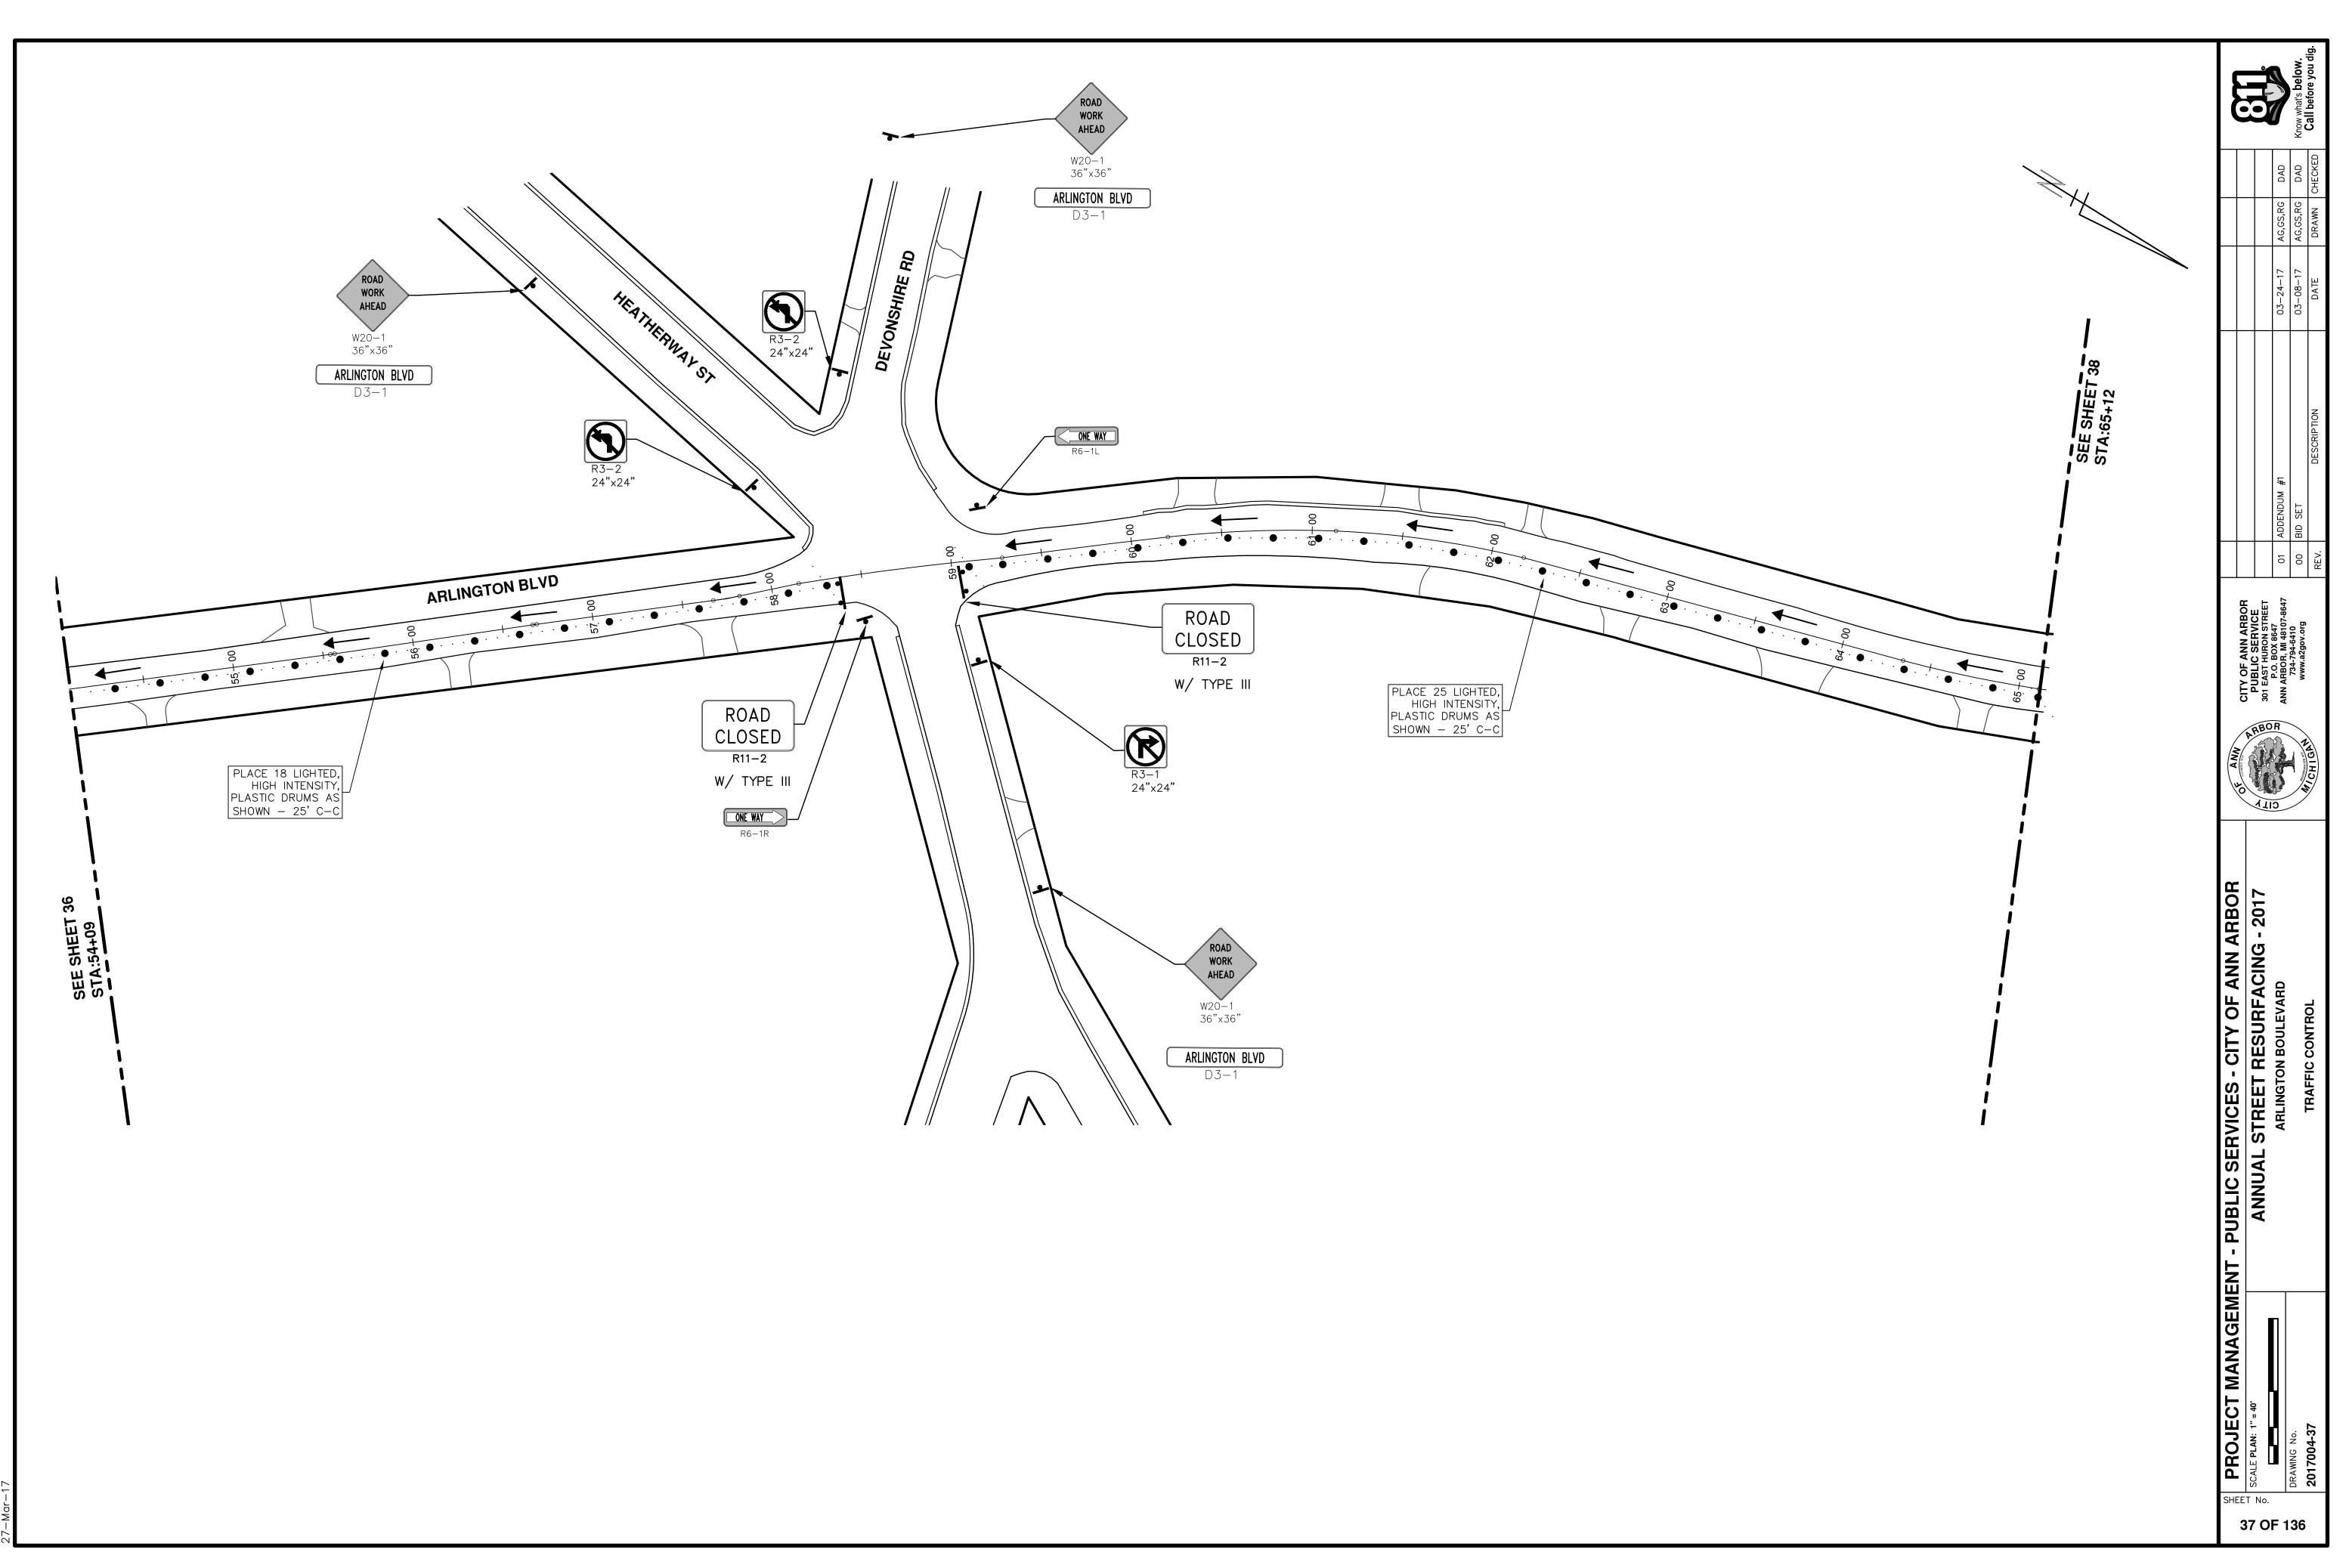


004 \Project 7-Mar-17 S'N *i*

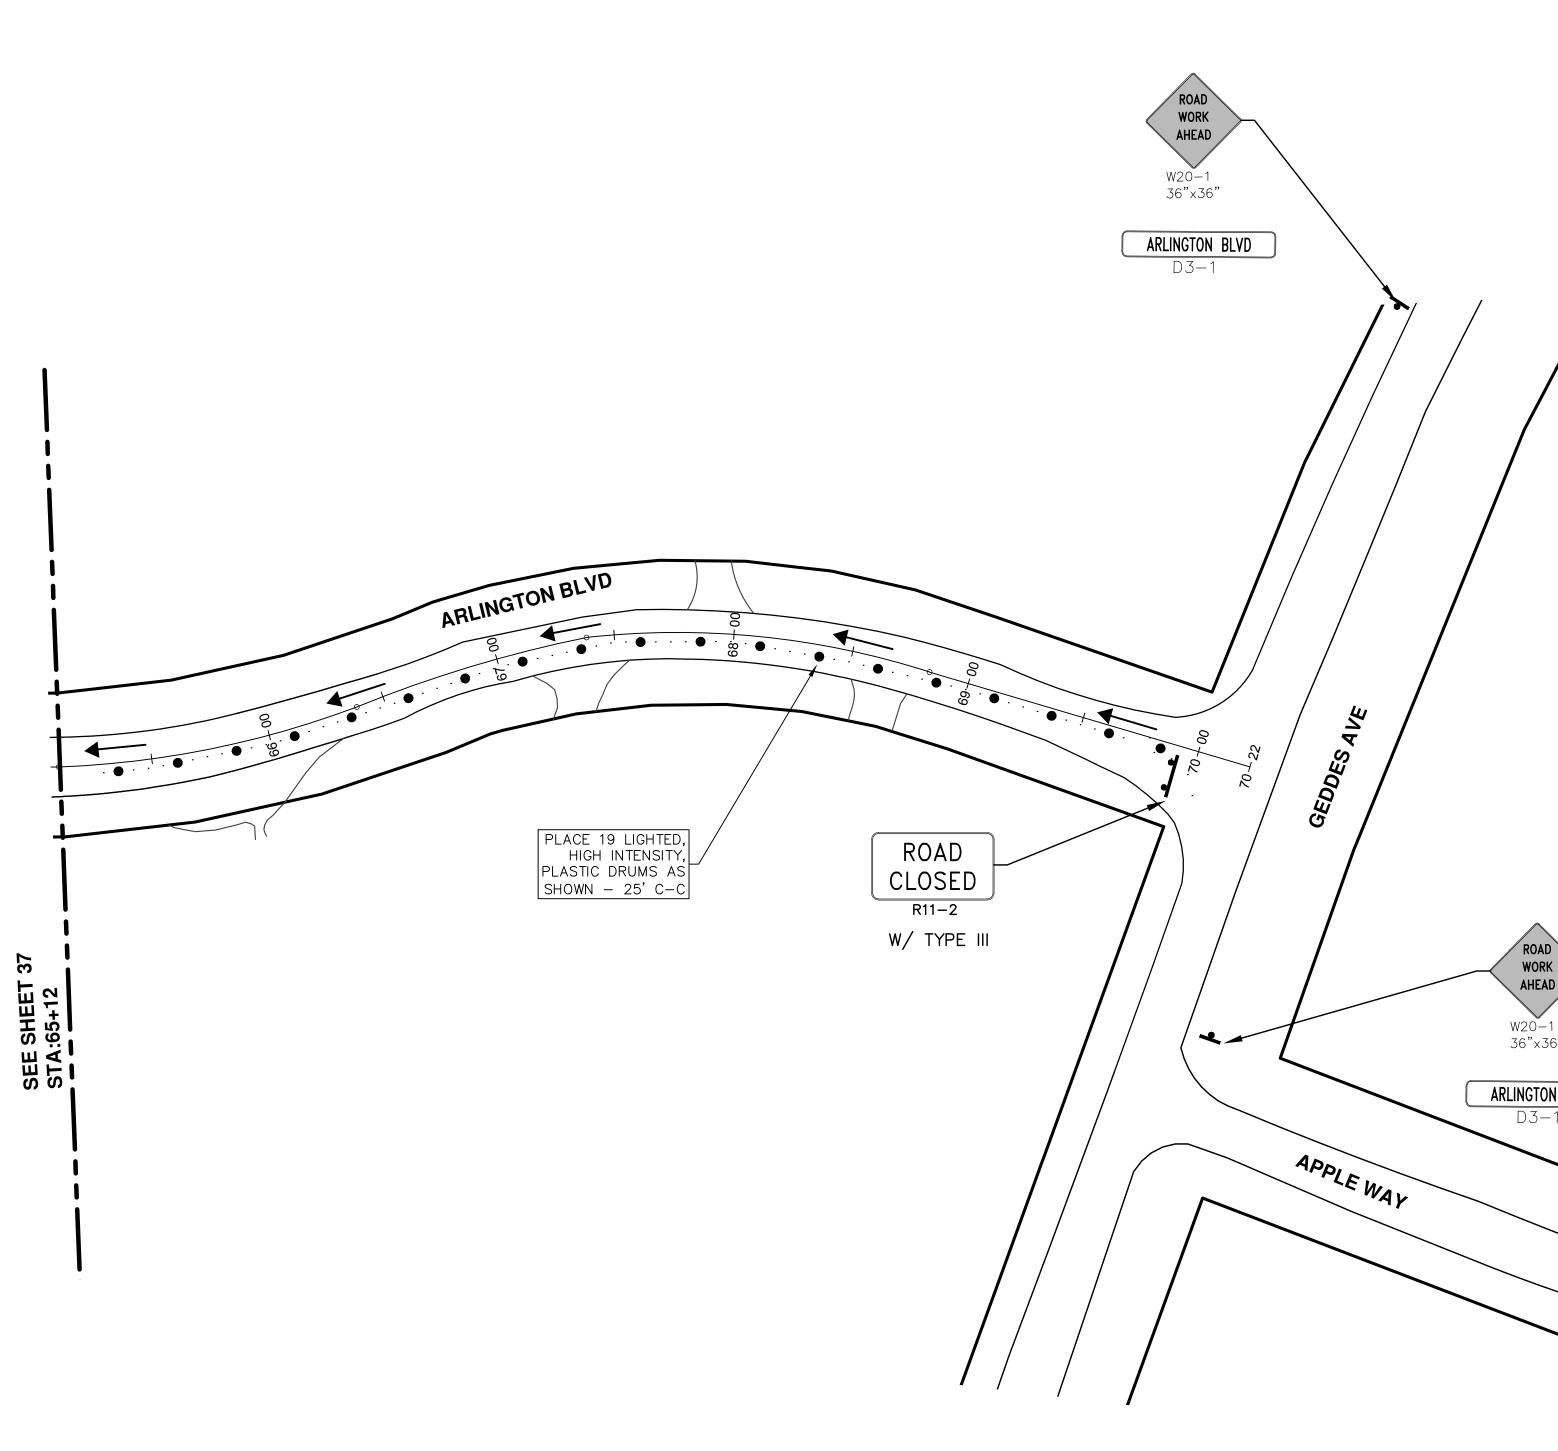


		Know what's below.
		A DAD K CHECKED
	×++	AG,GS,RG AG,GS,RG DRAWN CI
		O3-24-17 / 03-08-17 / DATE
		03
		ADDENDUM #1 BID SET DESCRIPTION
		00 01 P
		CITY OF ANN ARBOR PUBLIC SERVICE 301 EAST HURON STREET P.O. BOX 8647 ANN ARBOR, MI 48107-8647 734-794-6410 www.a2gov.org
D K D		ARBOR NUCHICINA LIID
1 N BLVD -1 -1 -1 -1 -1 -1 -1 -1 -1 -1		PROJECT MANAGEMENT - PUBLIC SERVICES - CITY OF ANN ARBOR Cale Plan: 1" = 40 Cale Plan: 1" =
		PROJECT MANAGEME SCALE PLAN: 1" = 40' DRAWING NO. 2017004-38 2017004-38

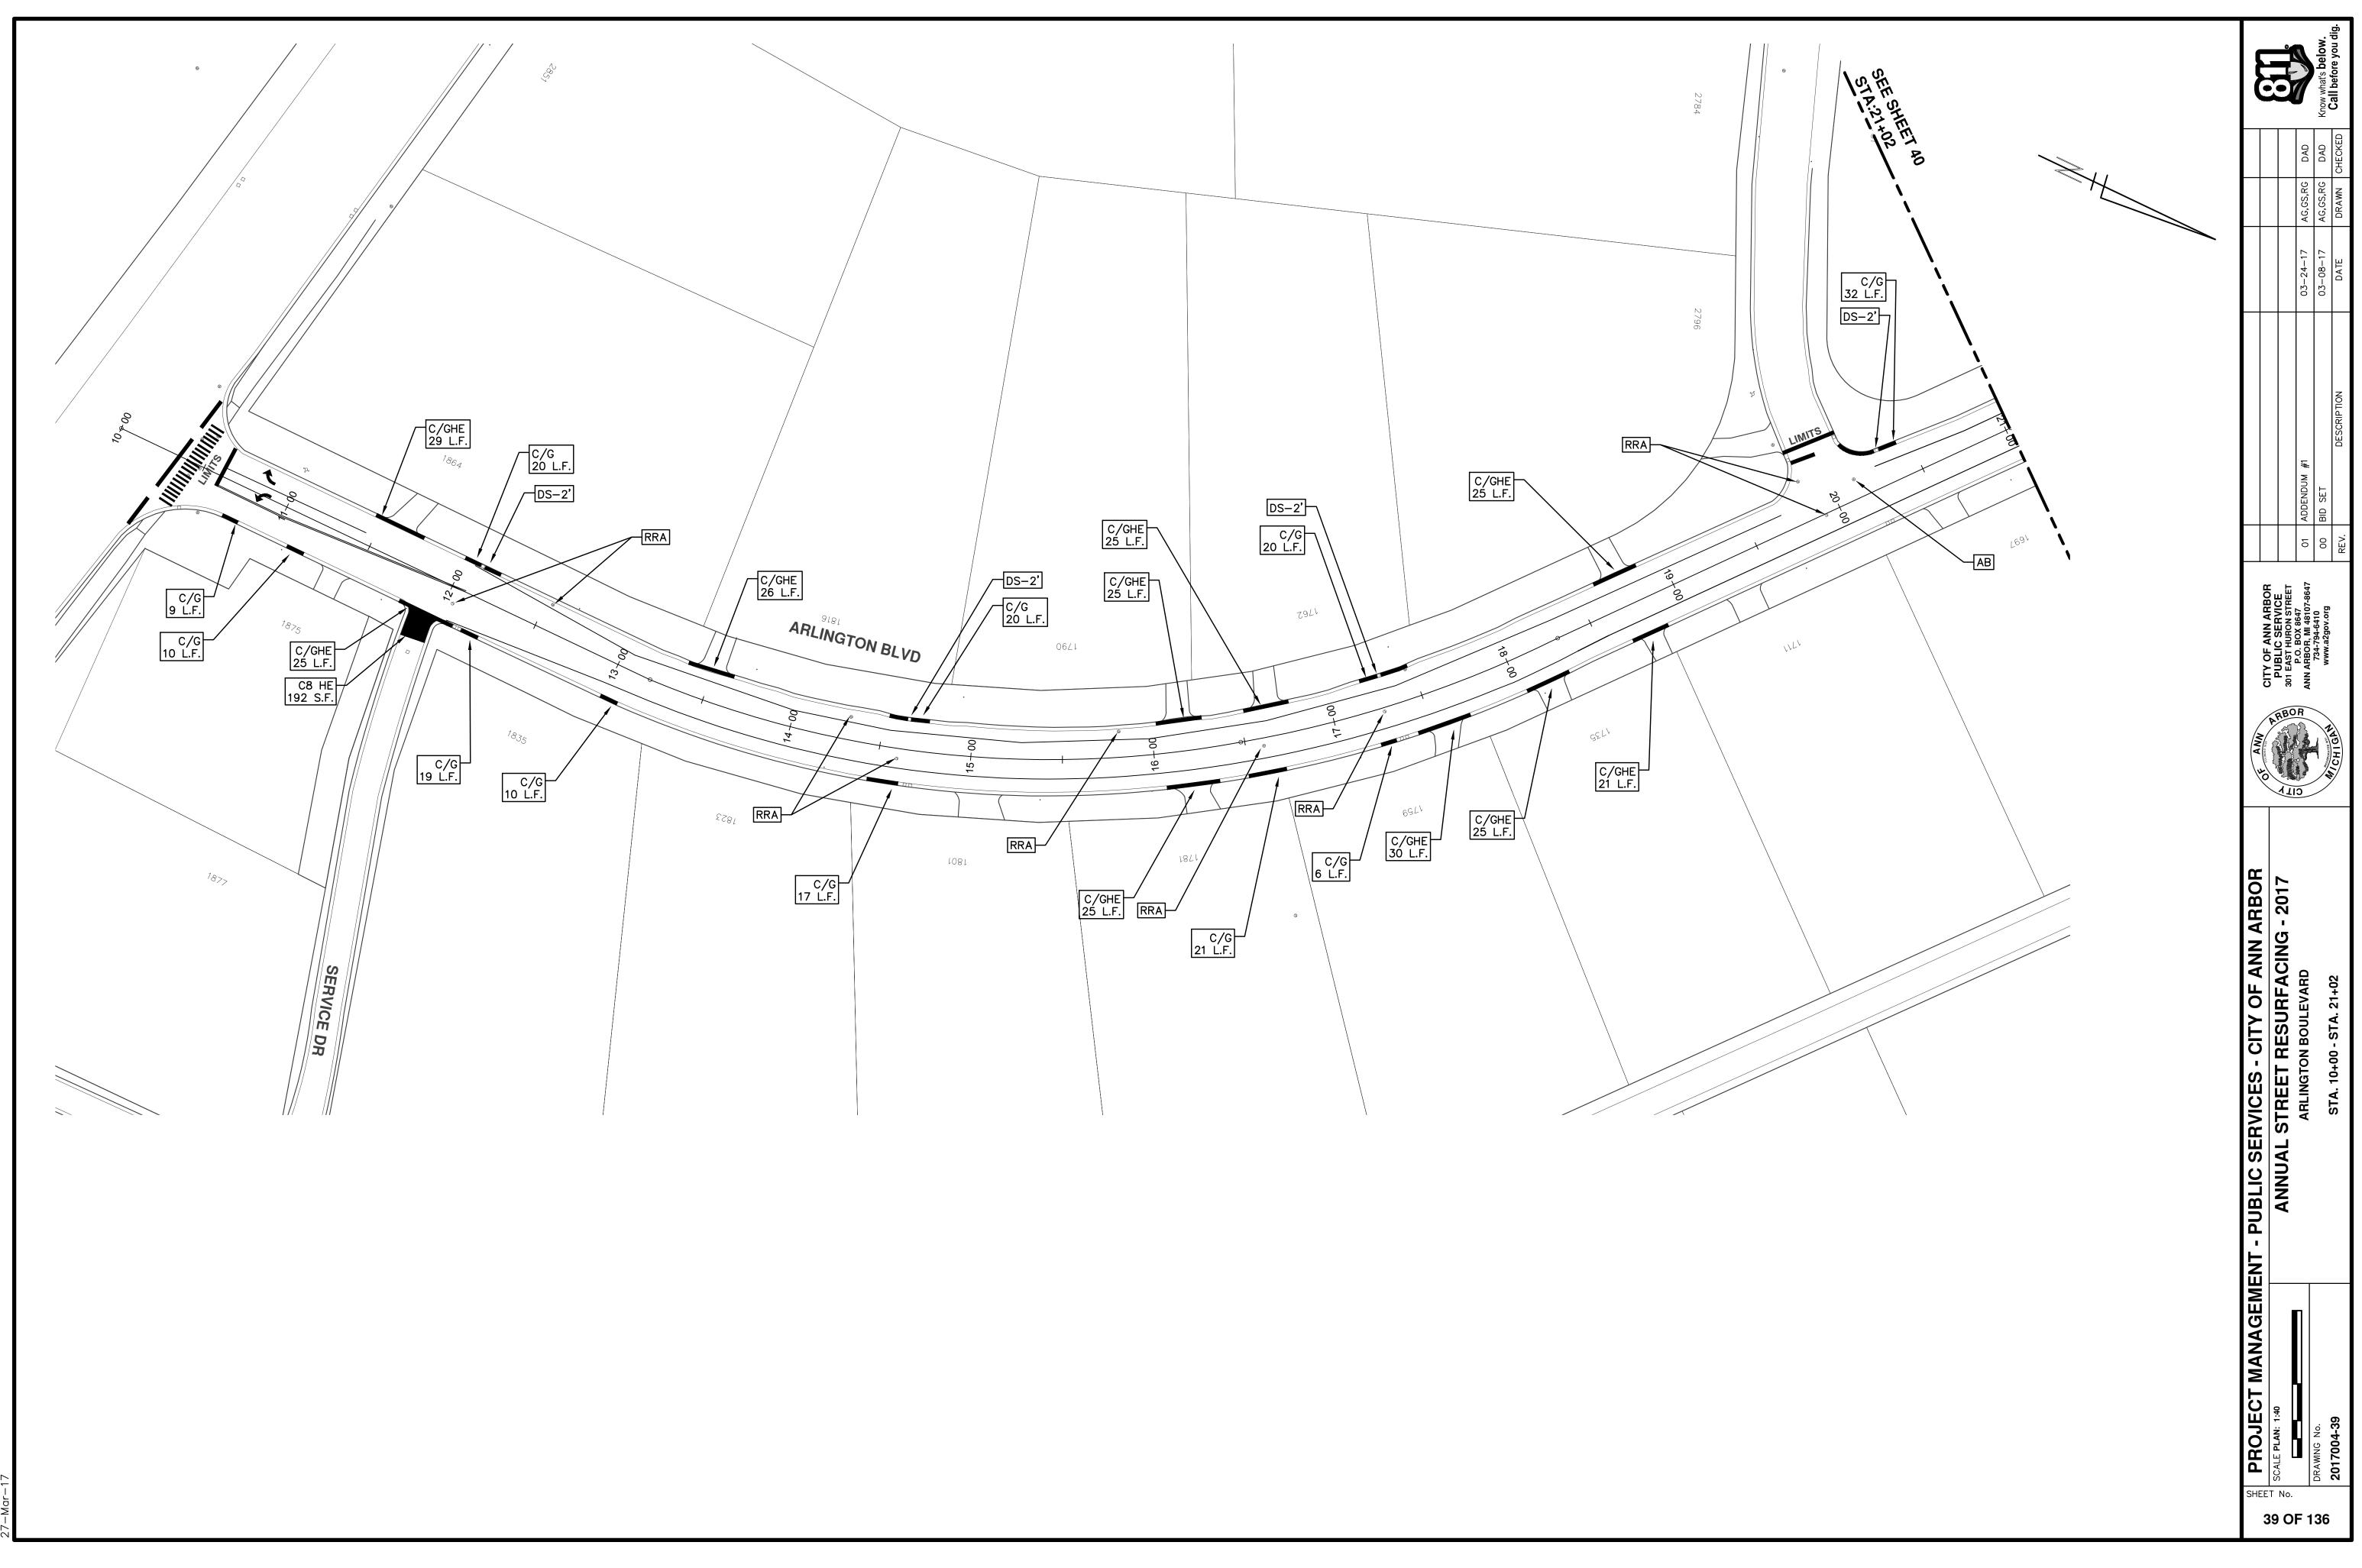


S S: \Project 27-Mar-17

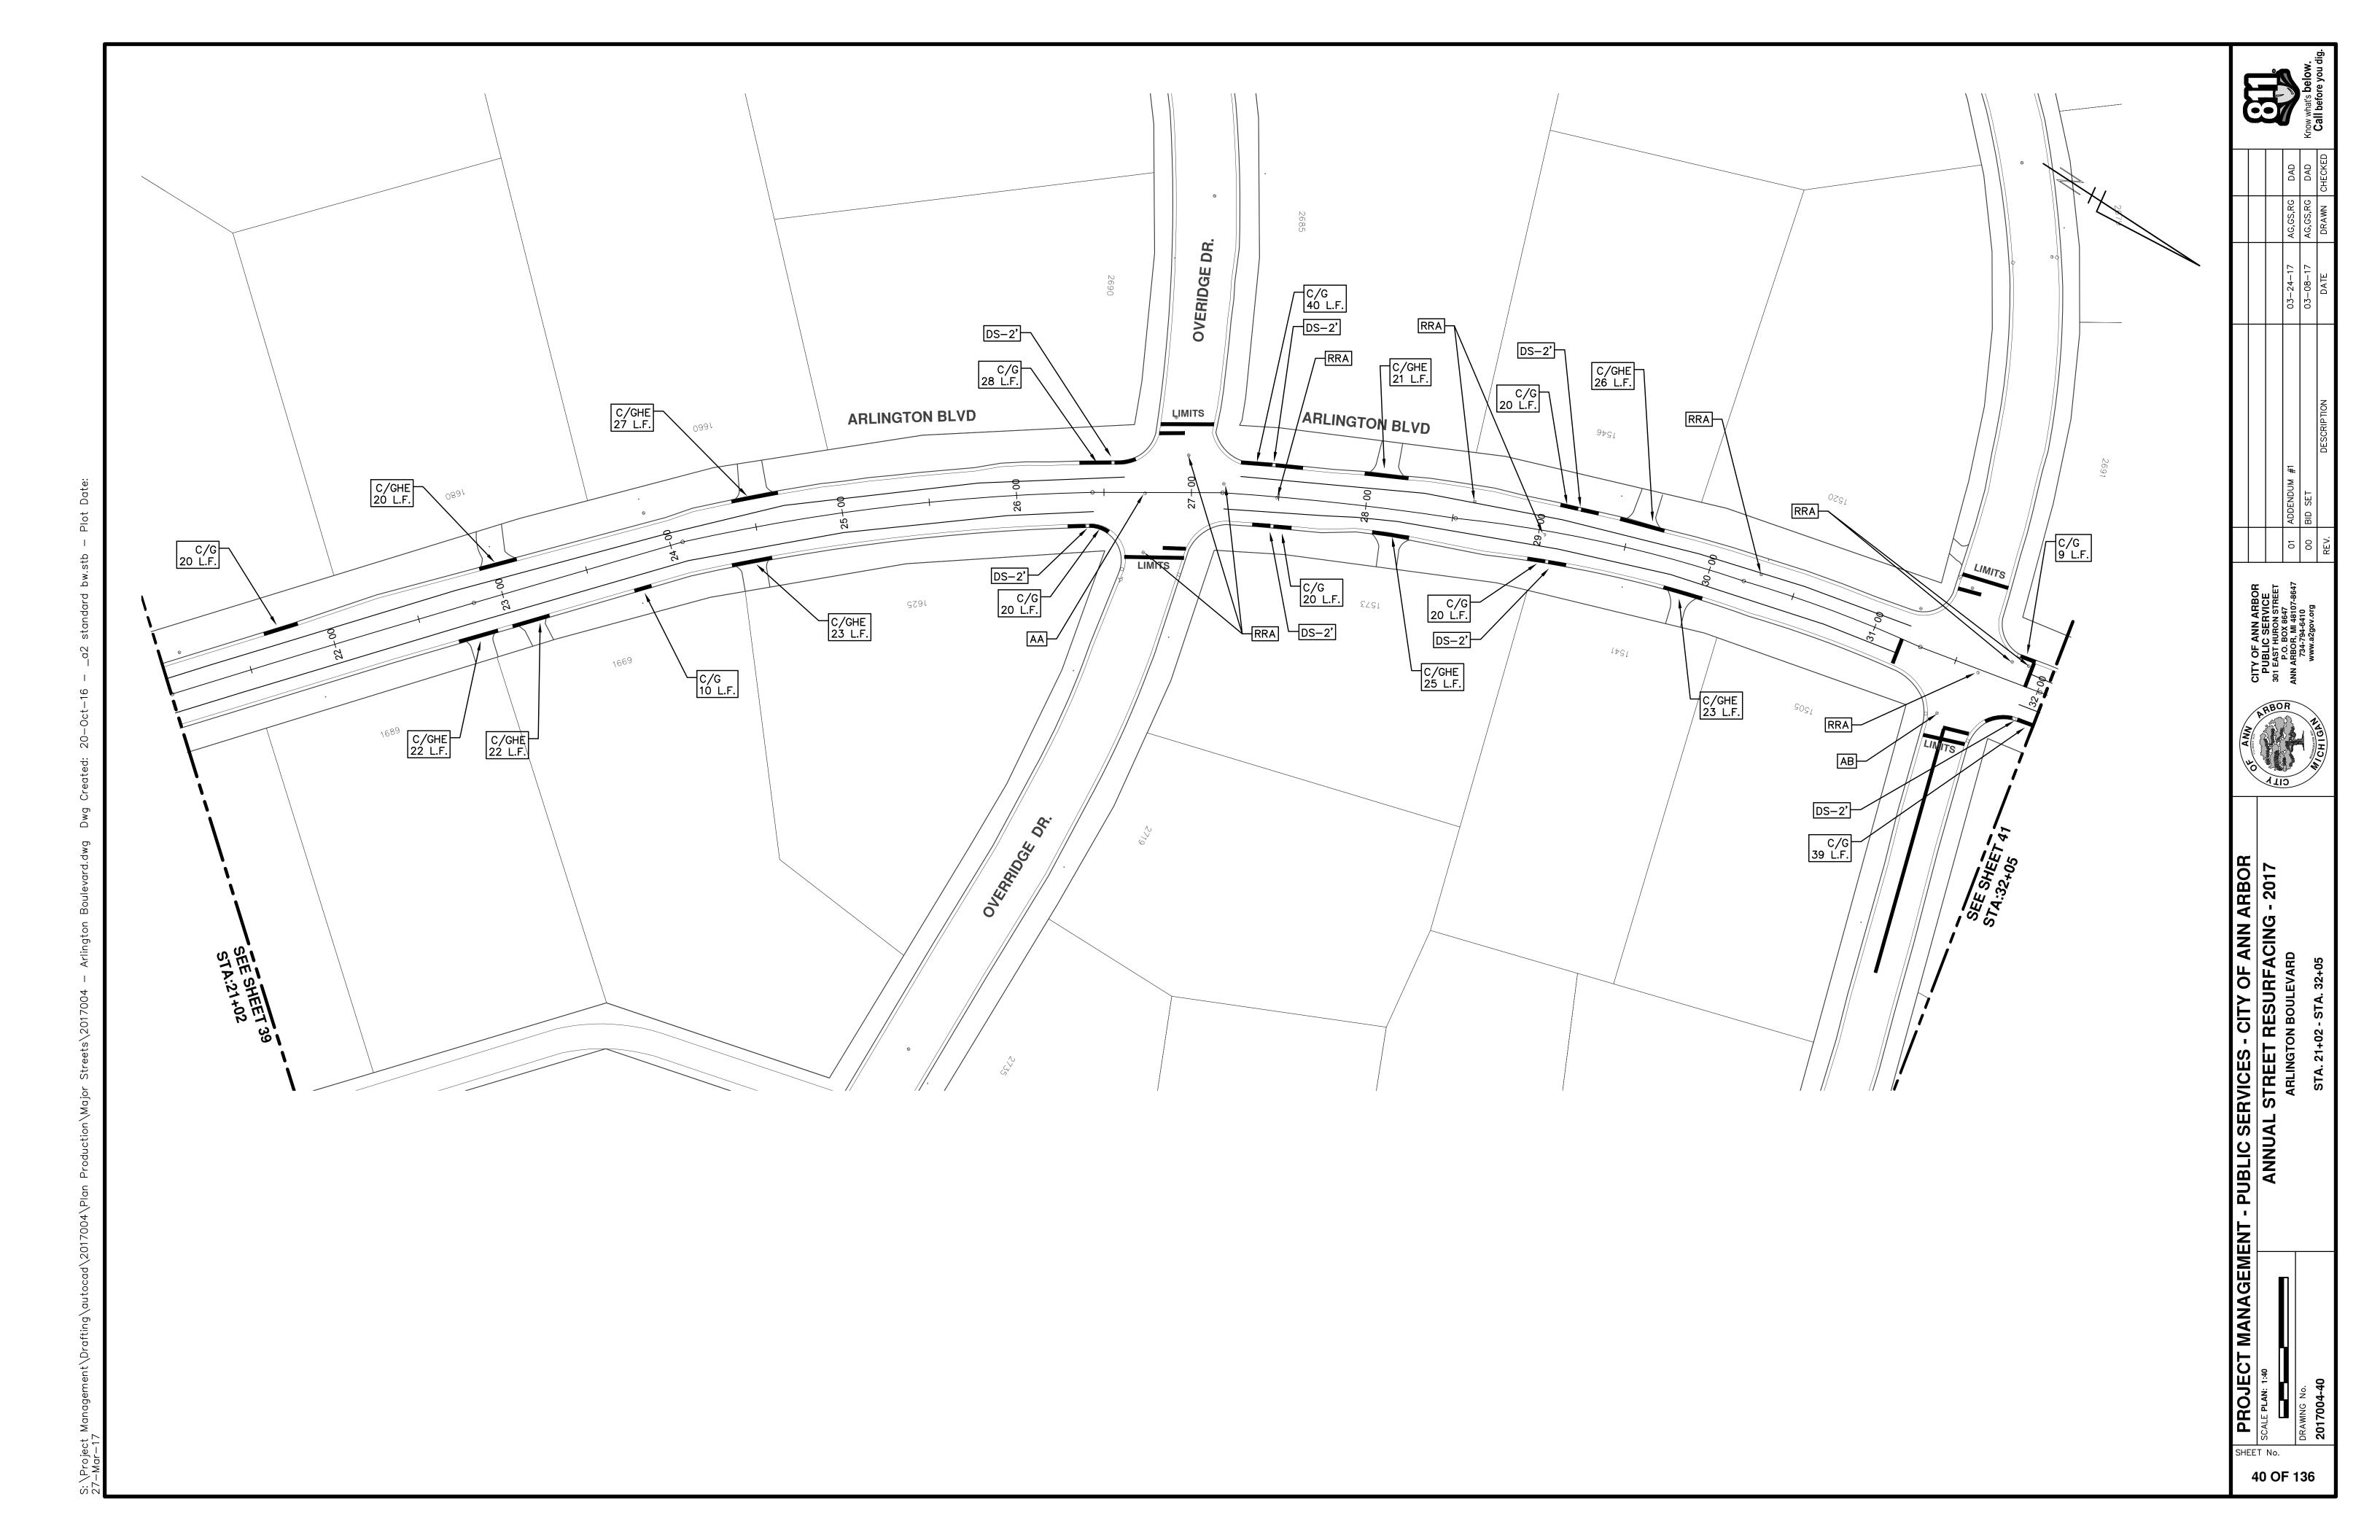


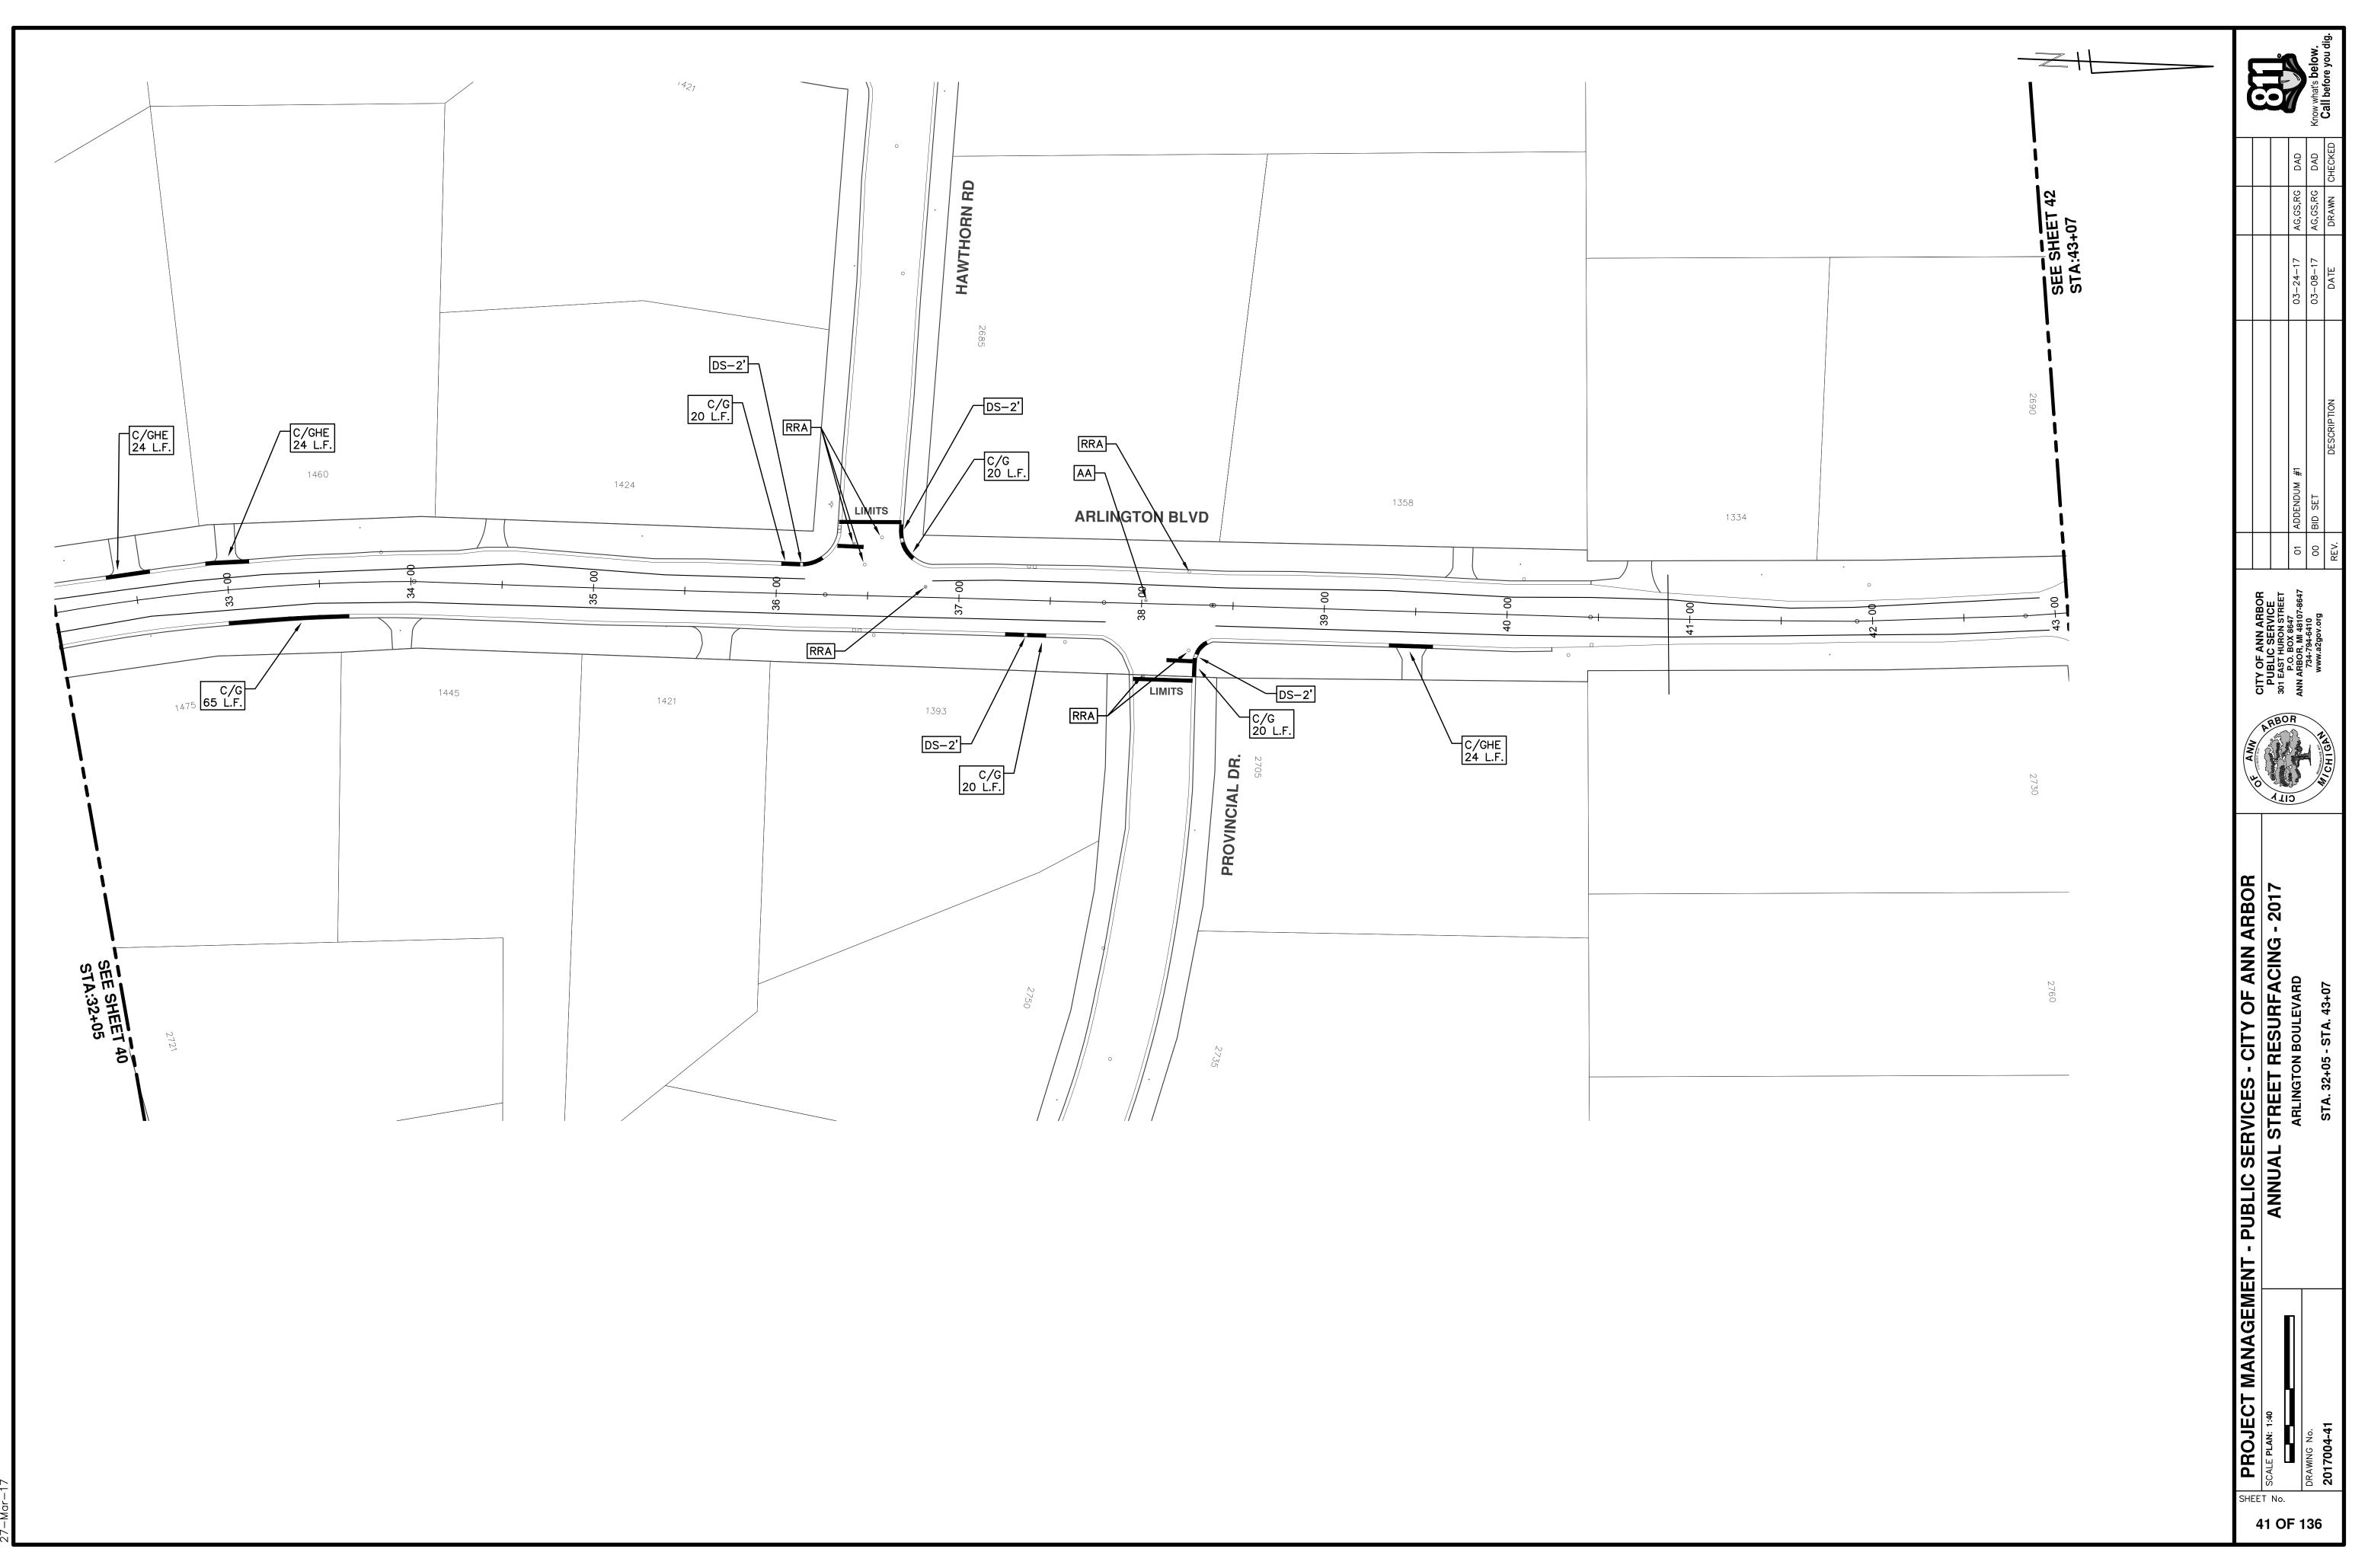

4 Ū. S: \Project 27-Mar-17

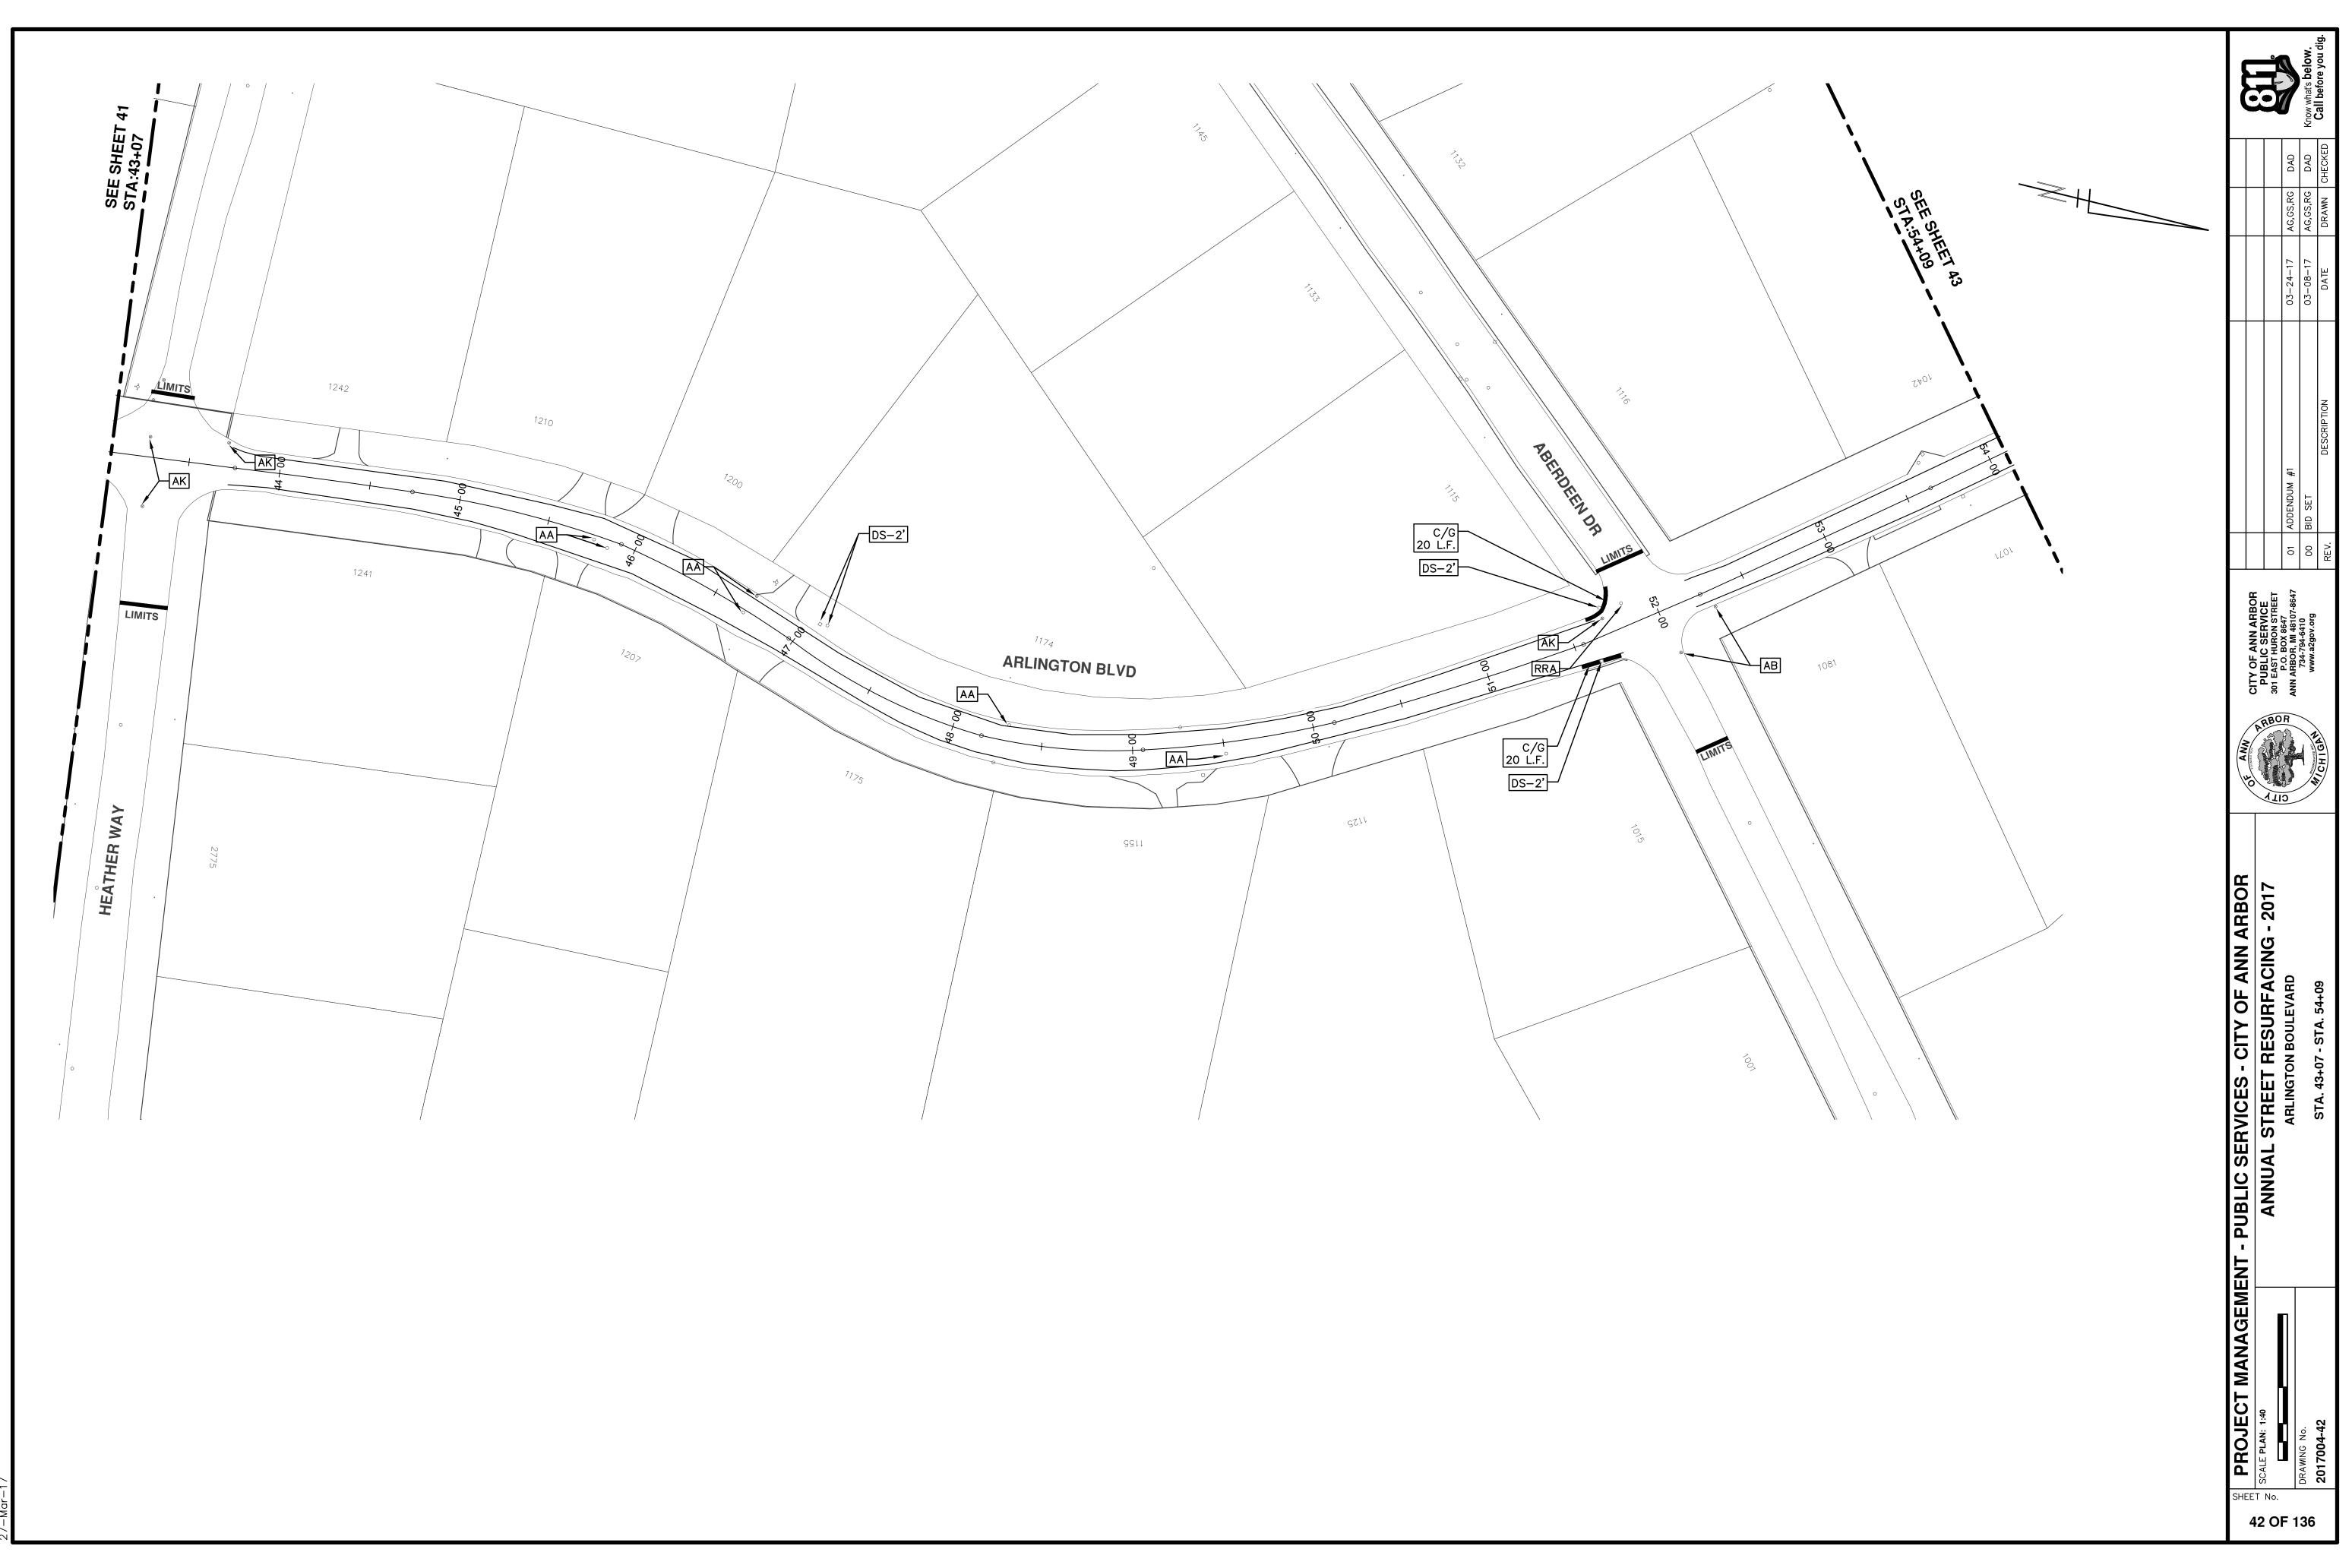



2017004 S: \Project 27-Mar-17

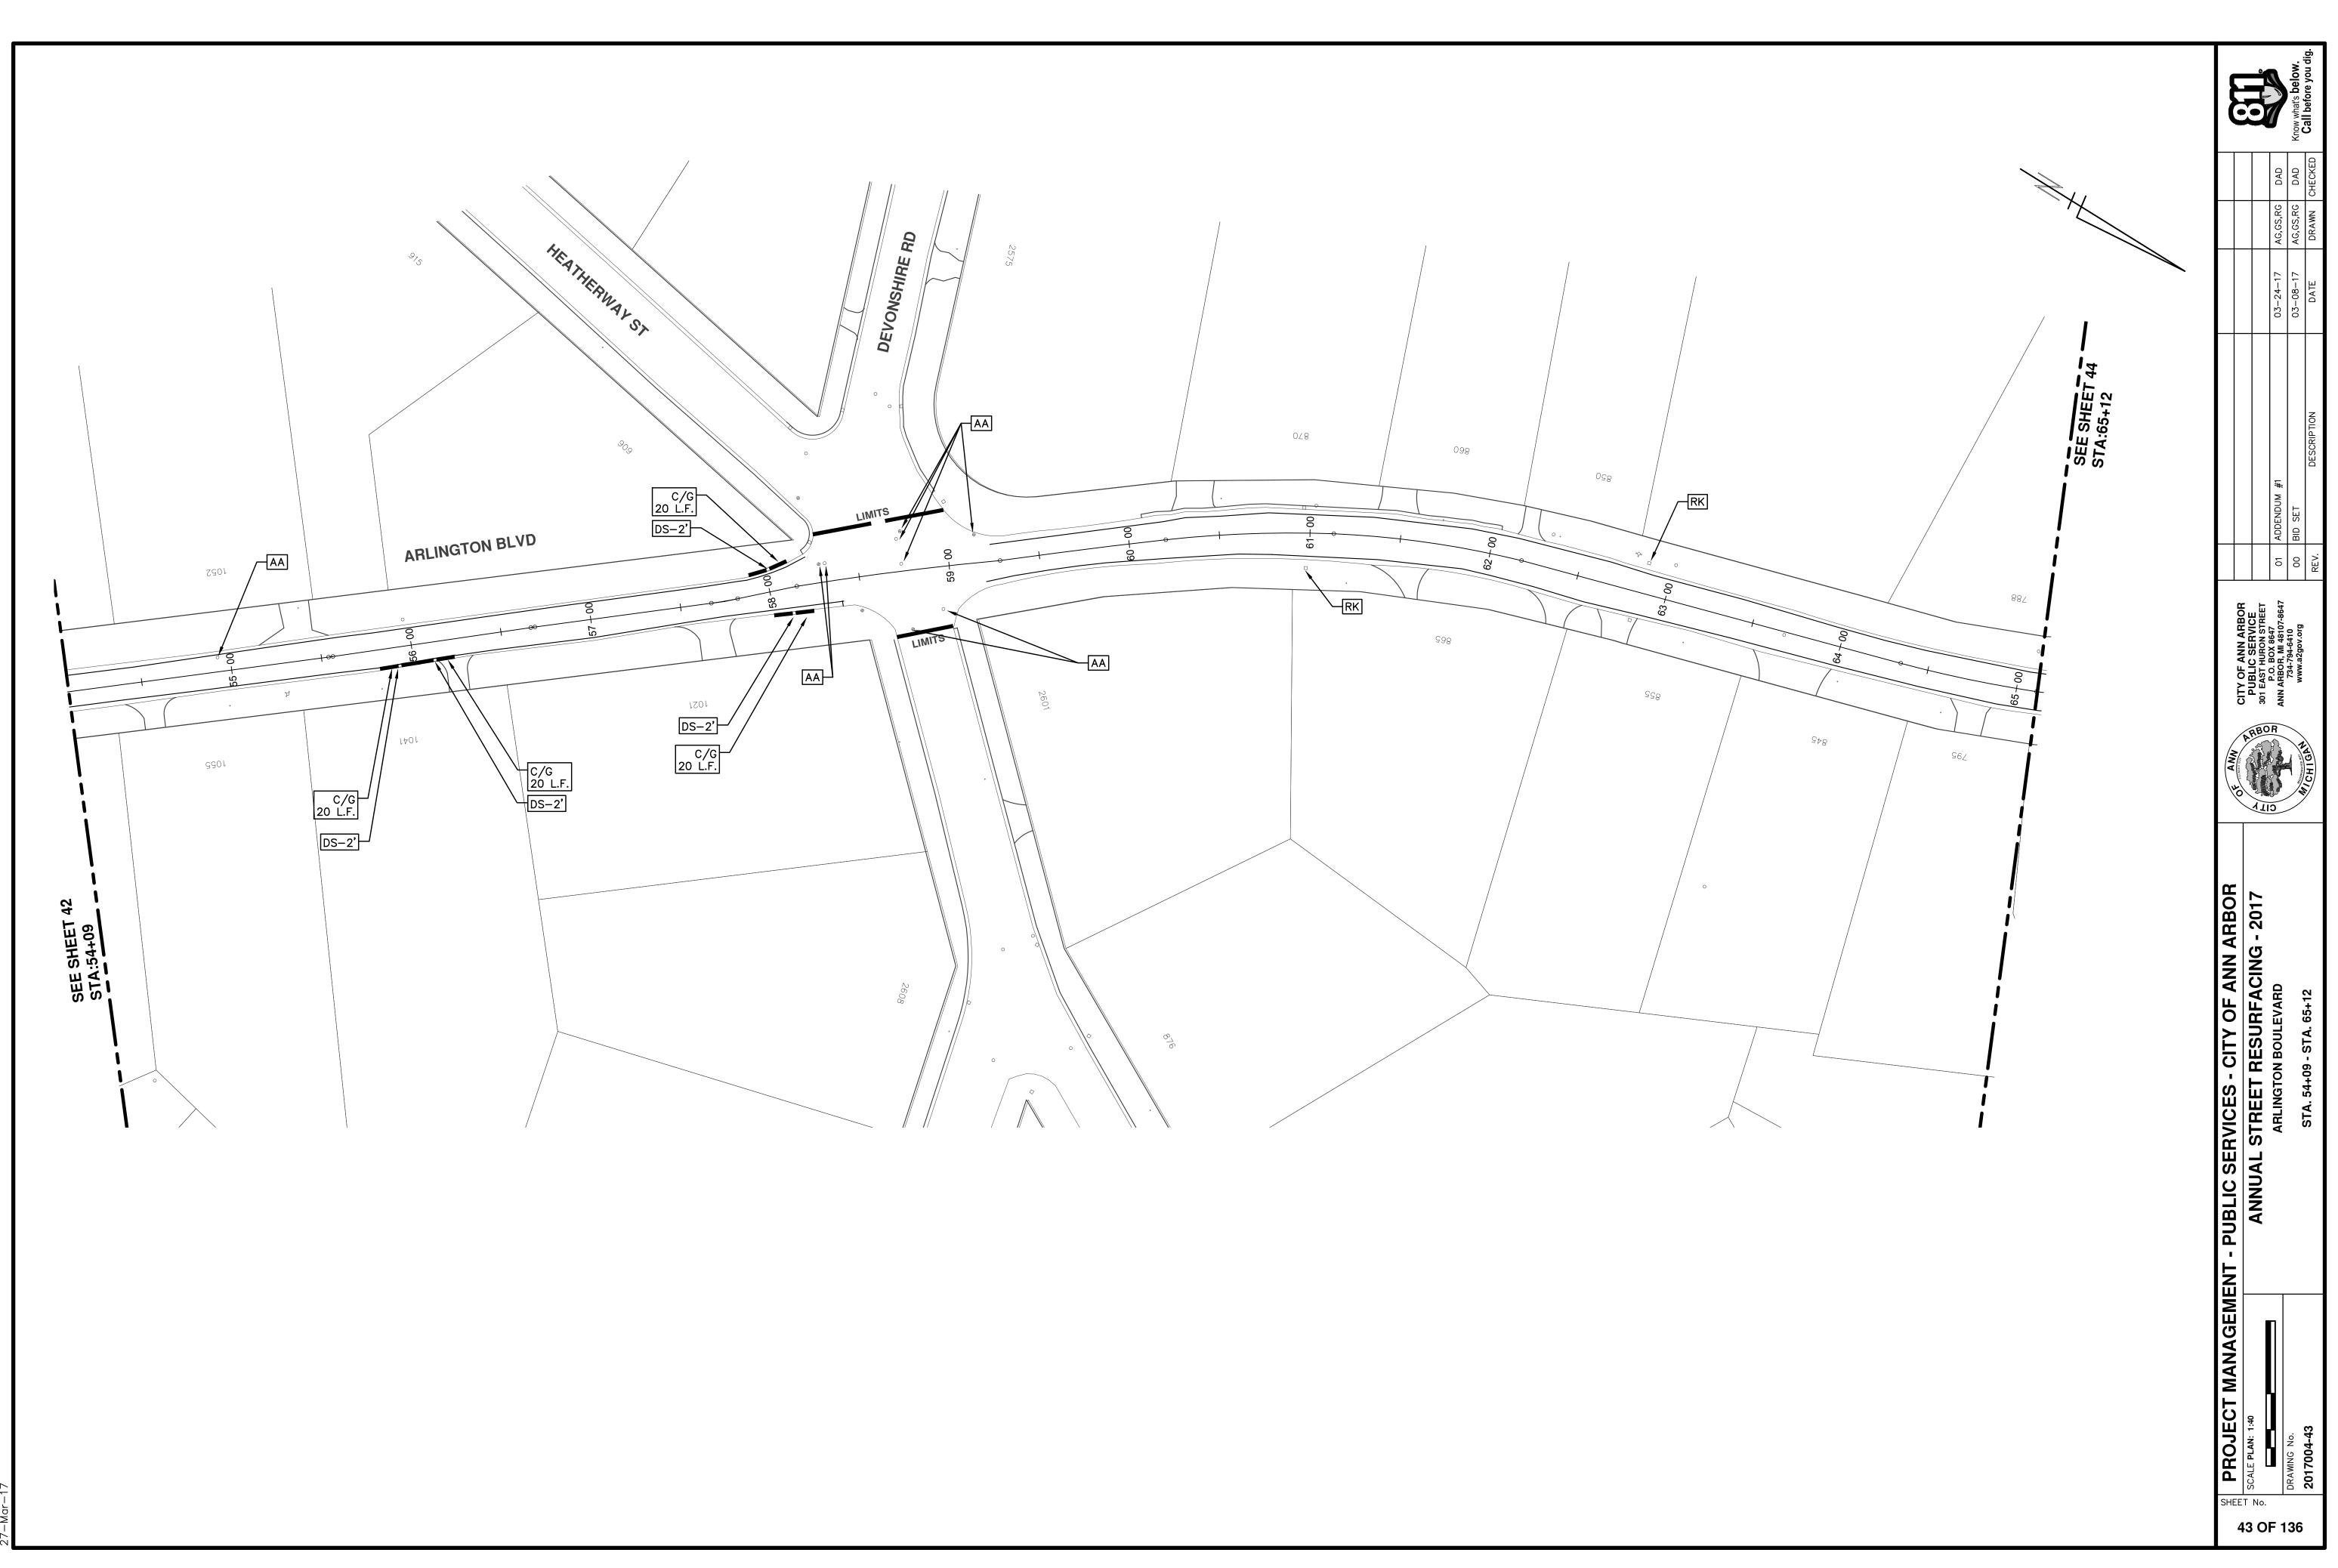


a2 16 004 Ū S: \Project 27-Mar-17

4 S: \Project 27-Mar-17

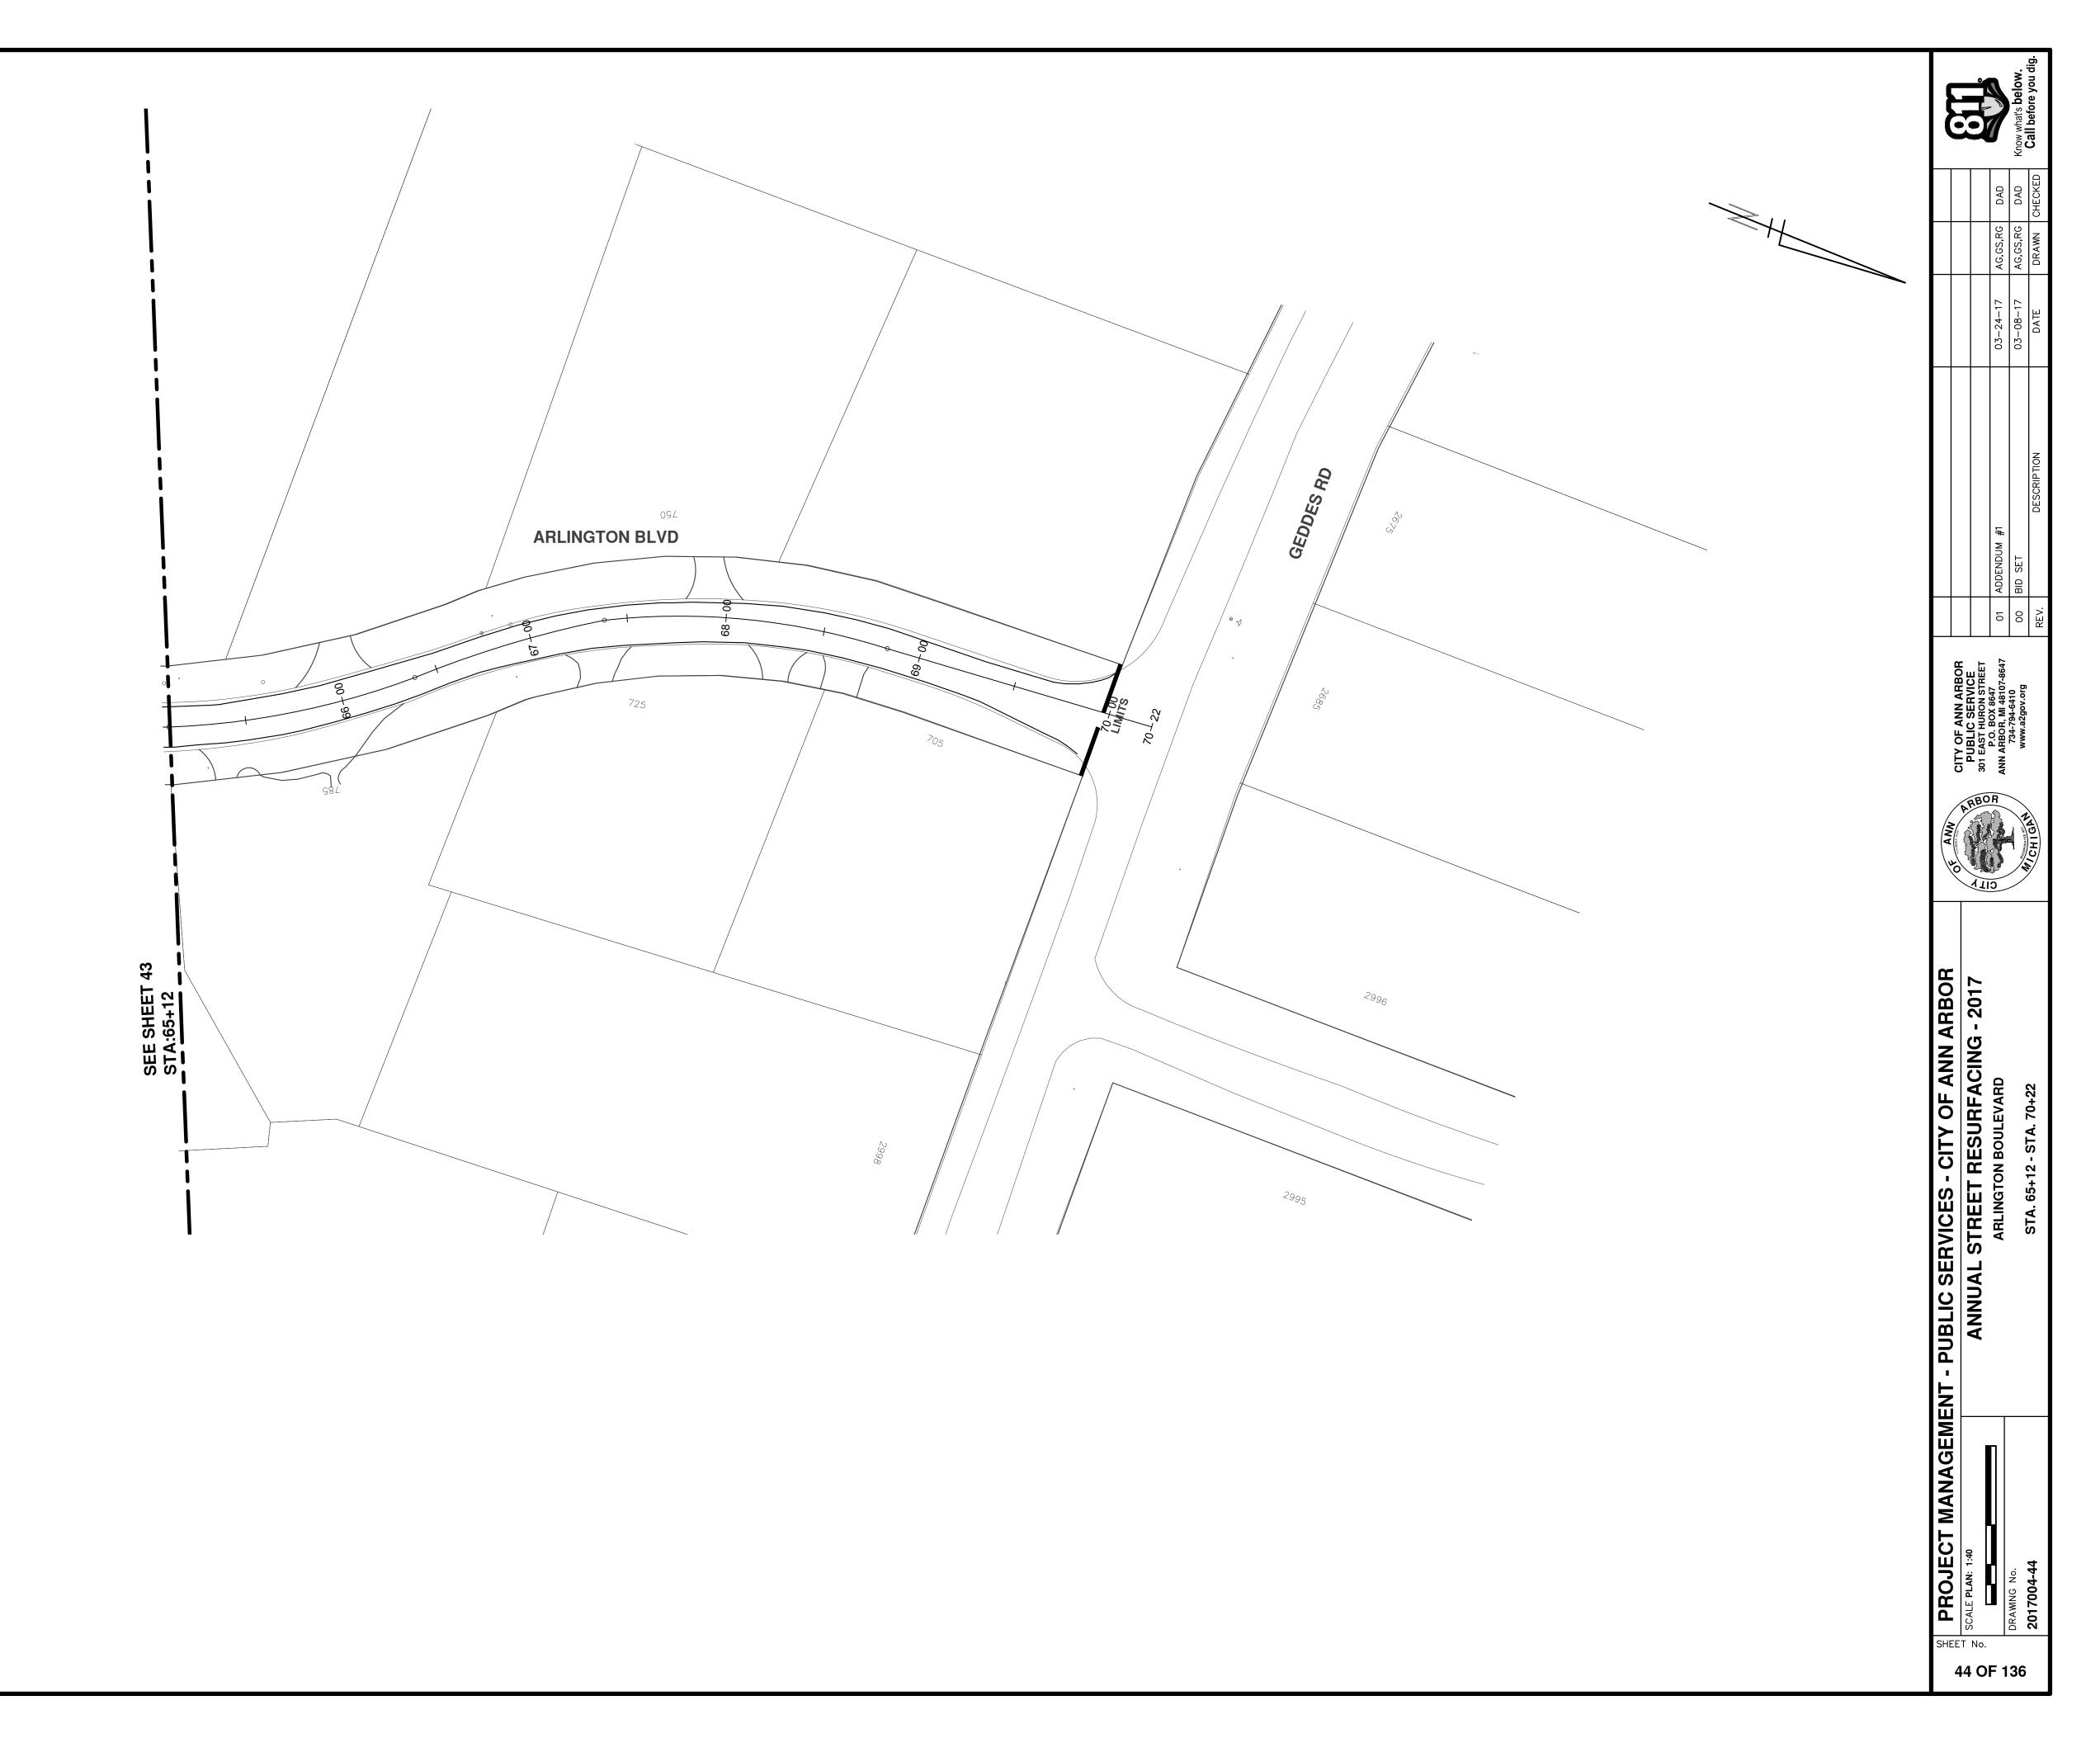


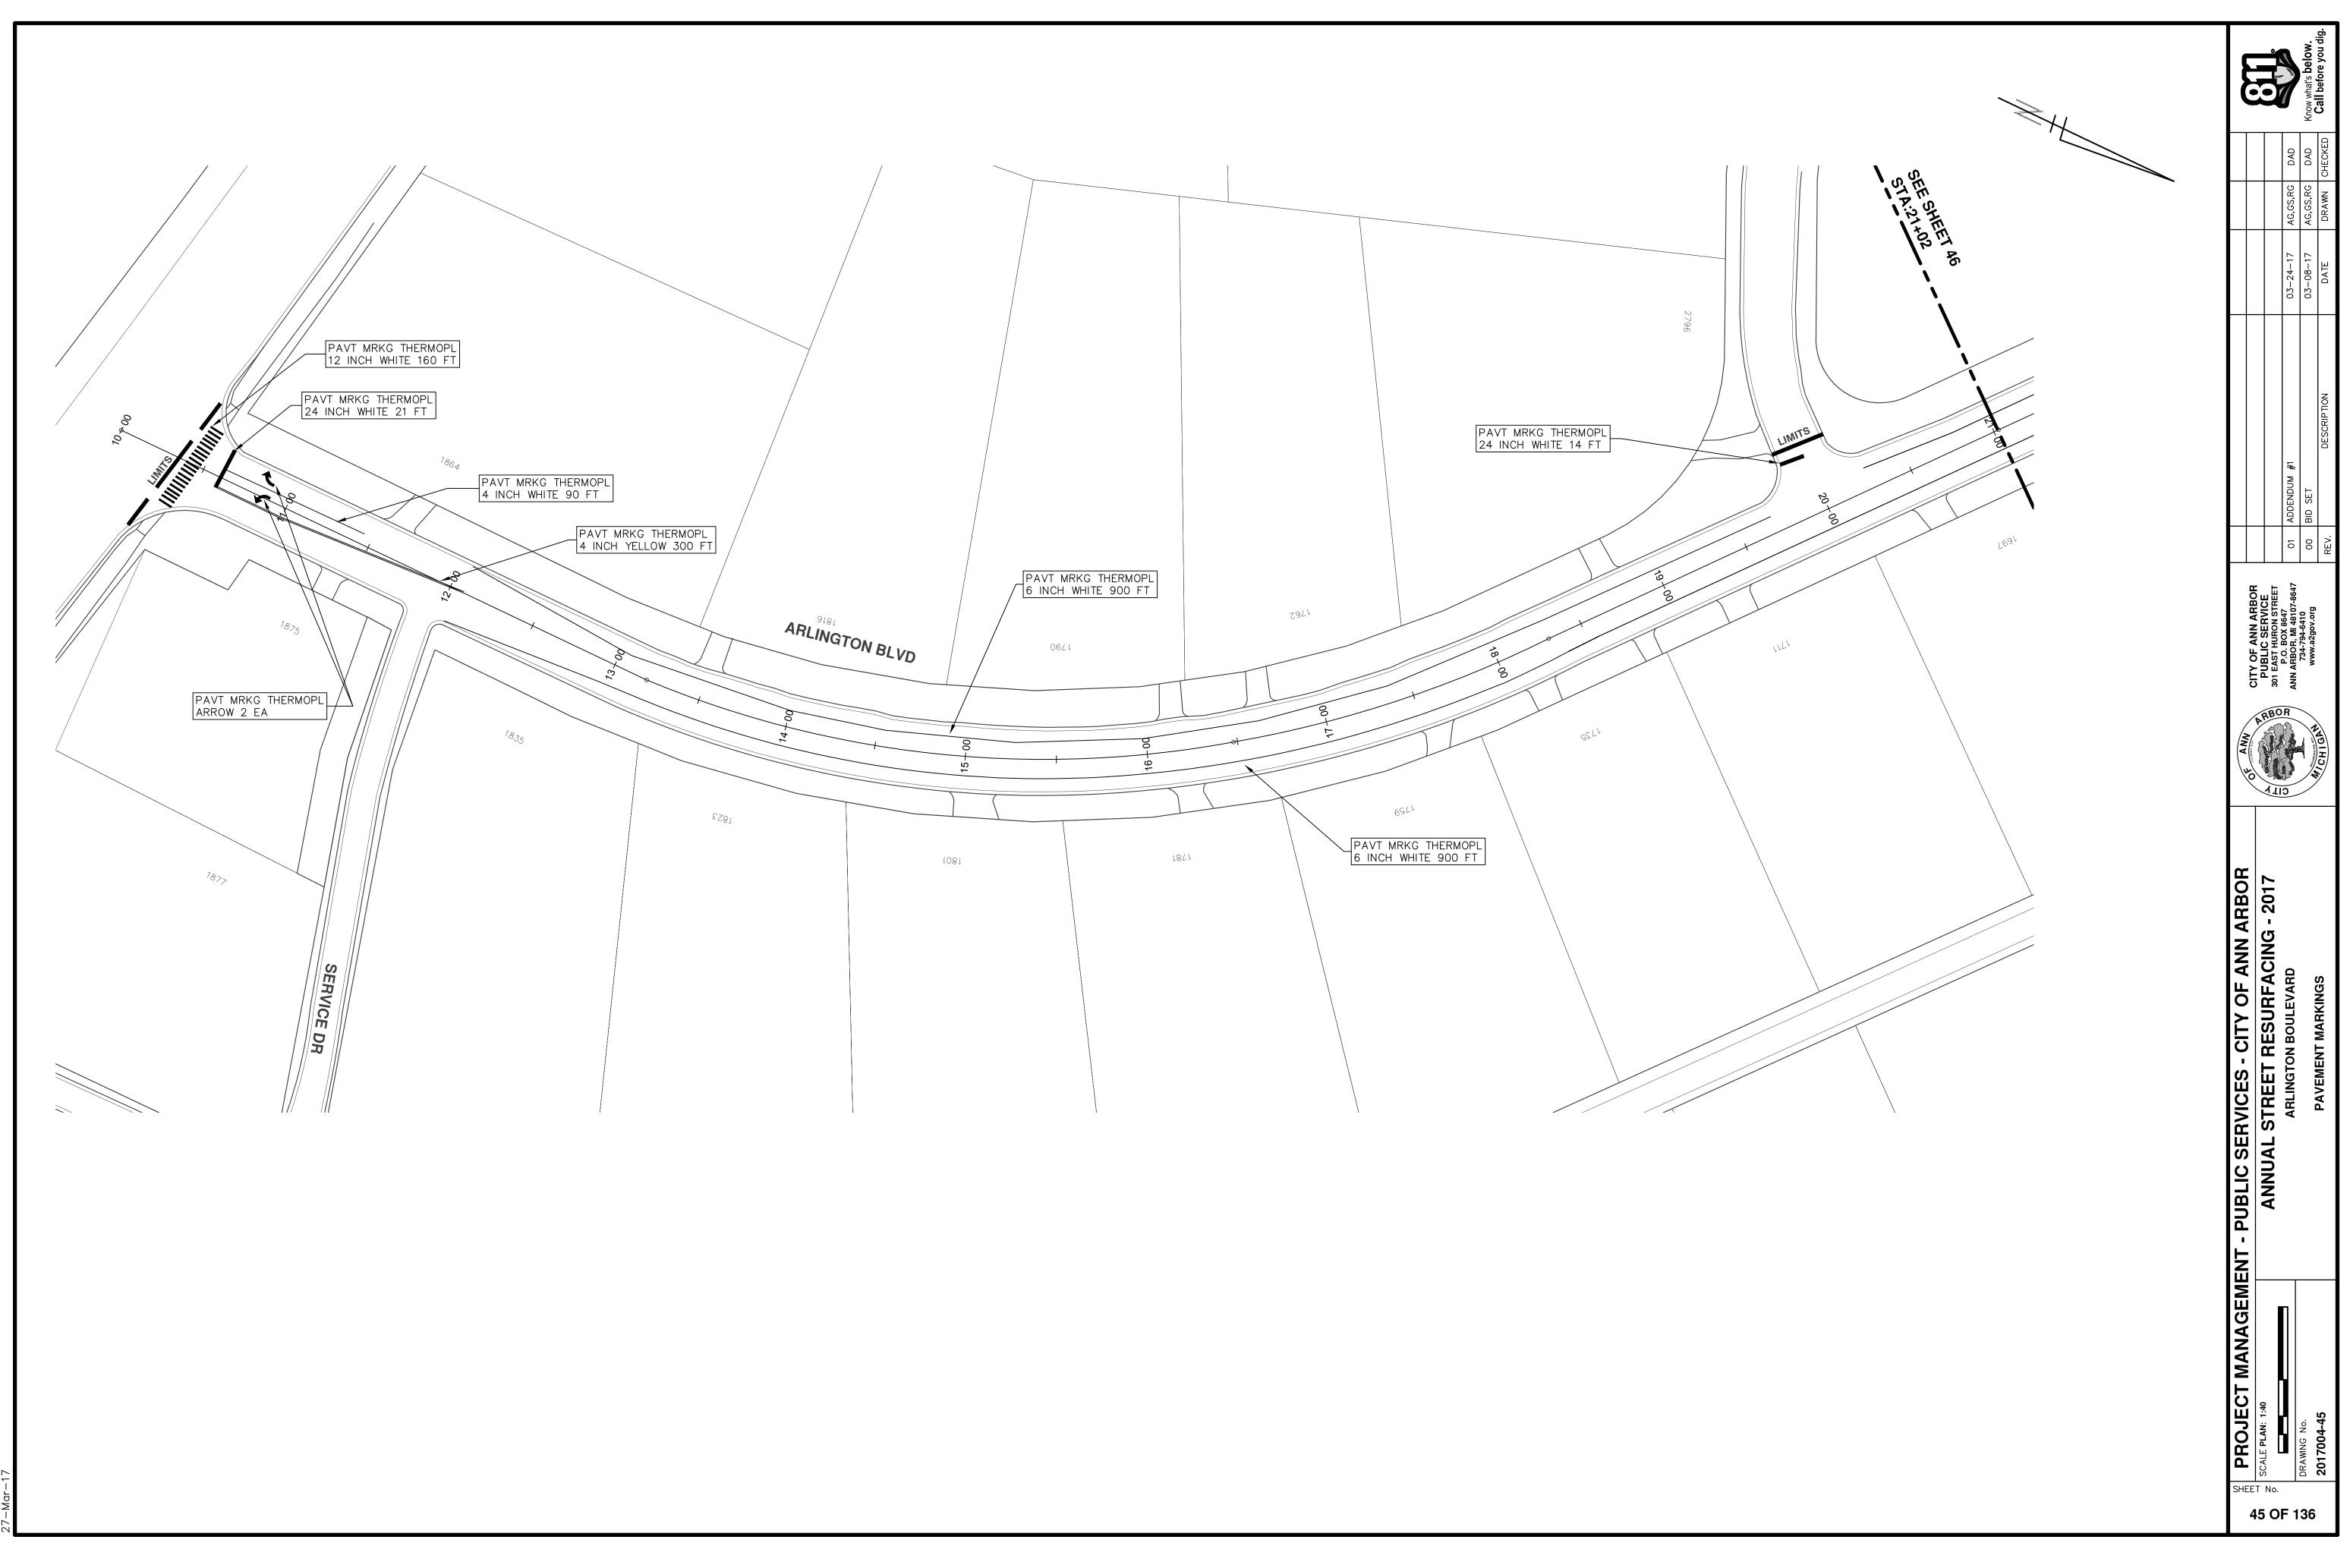


9 St S: \Project 27-Mar-17

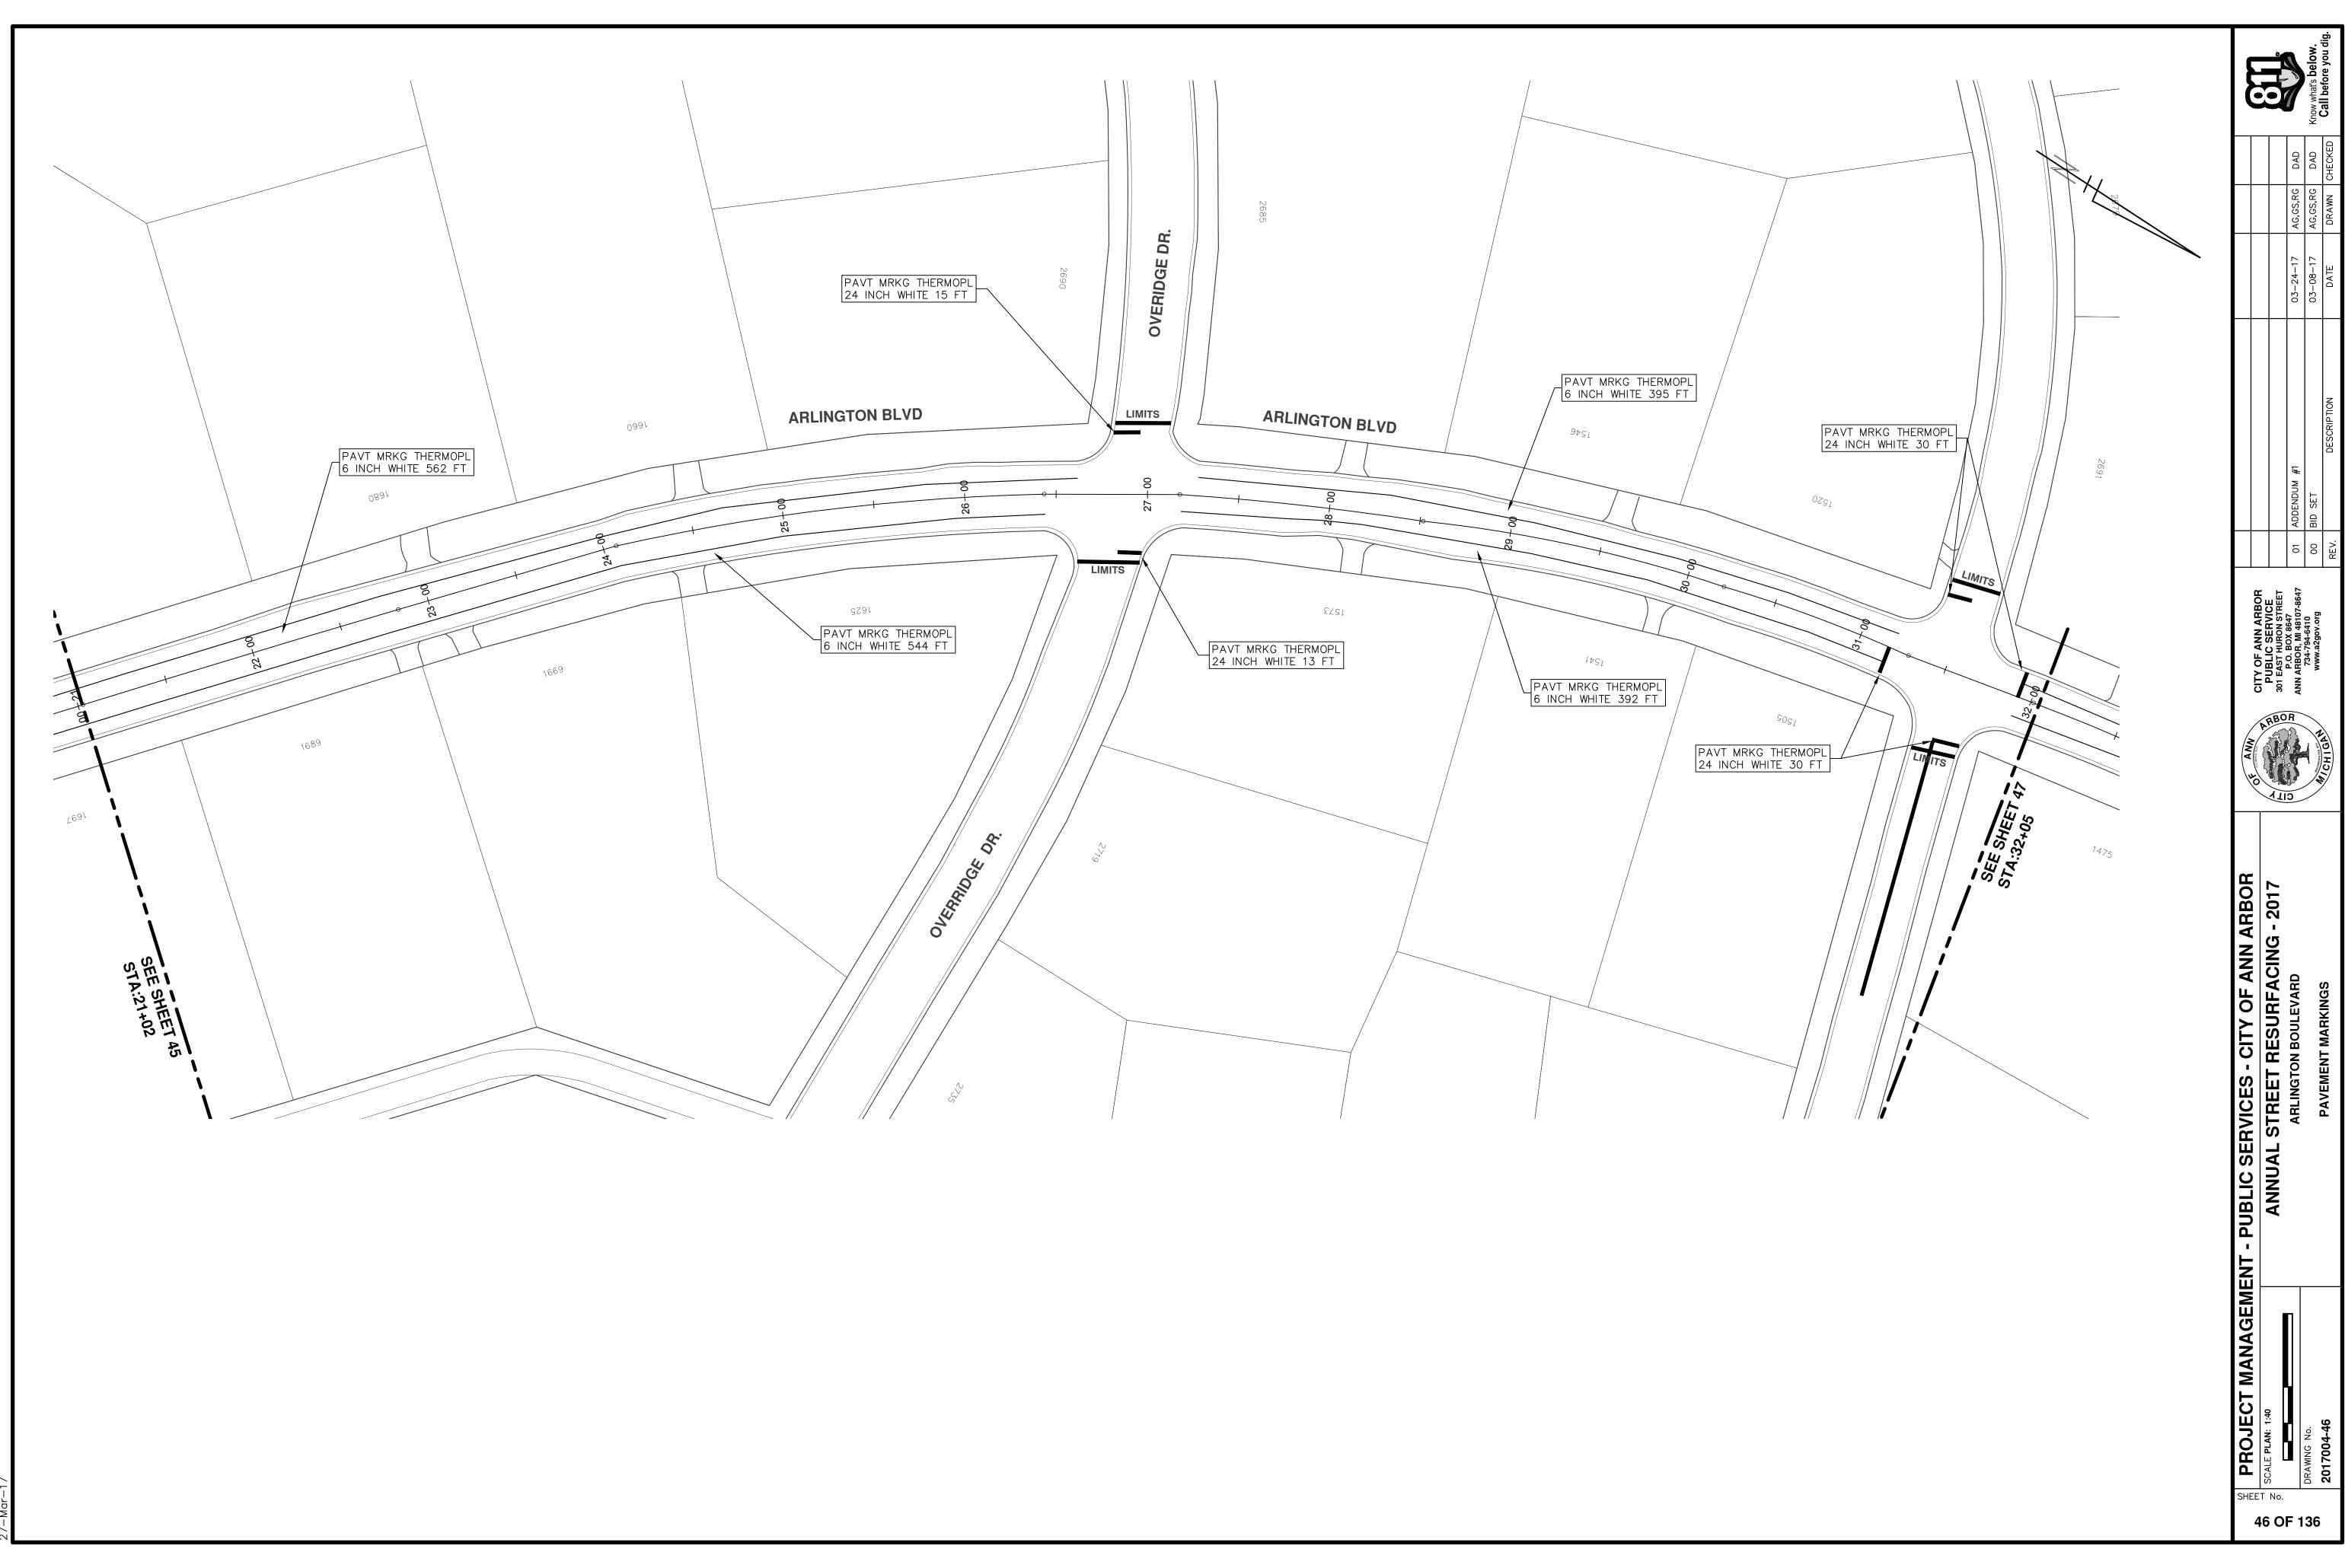


 \sim : \Project 7-Mar-17 S'N

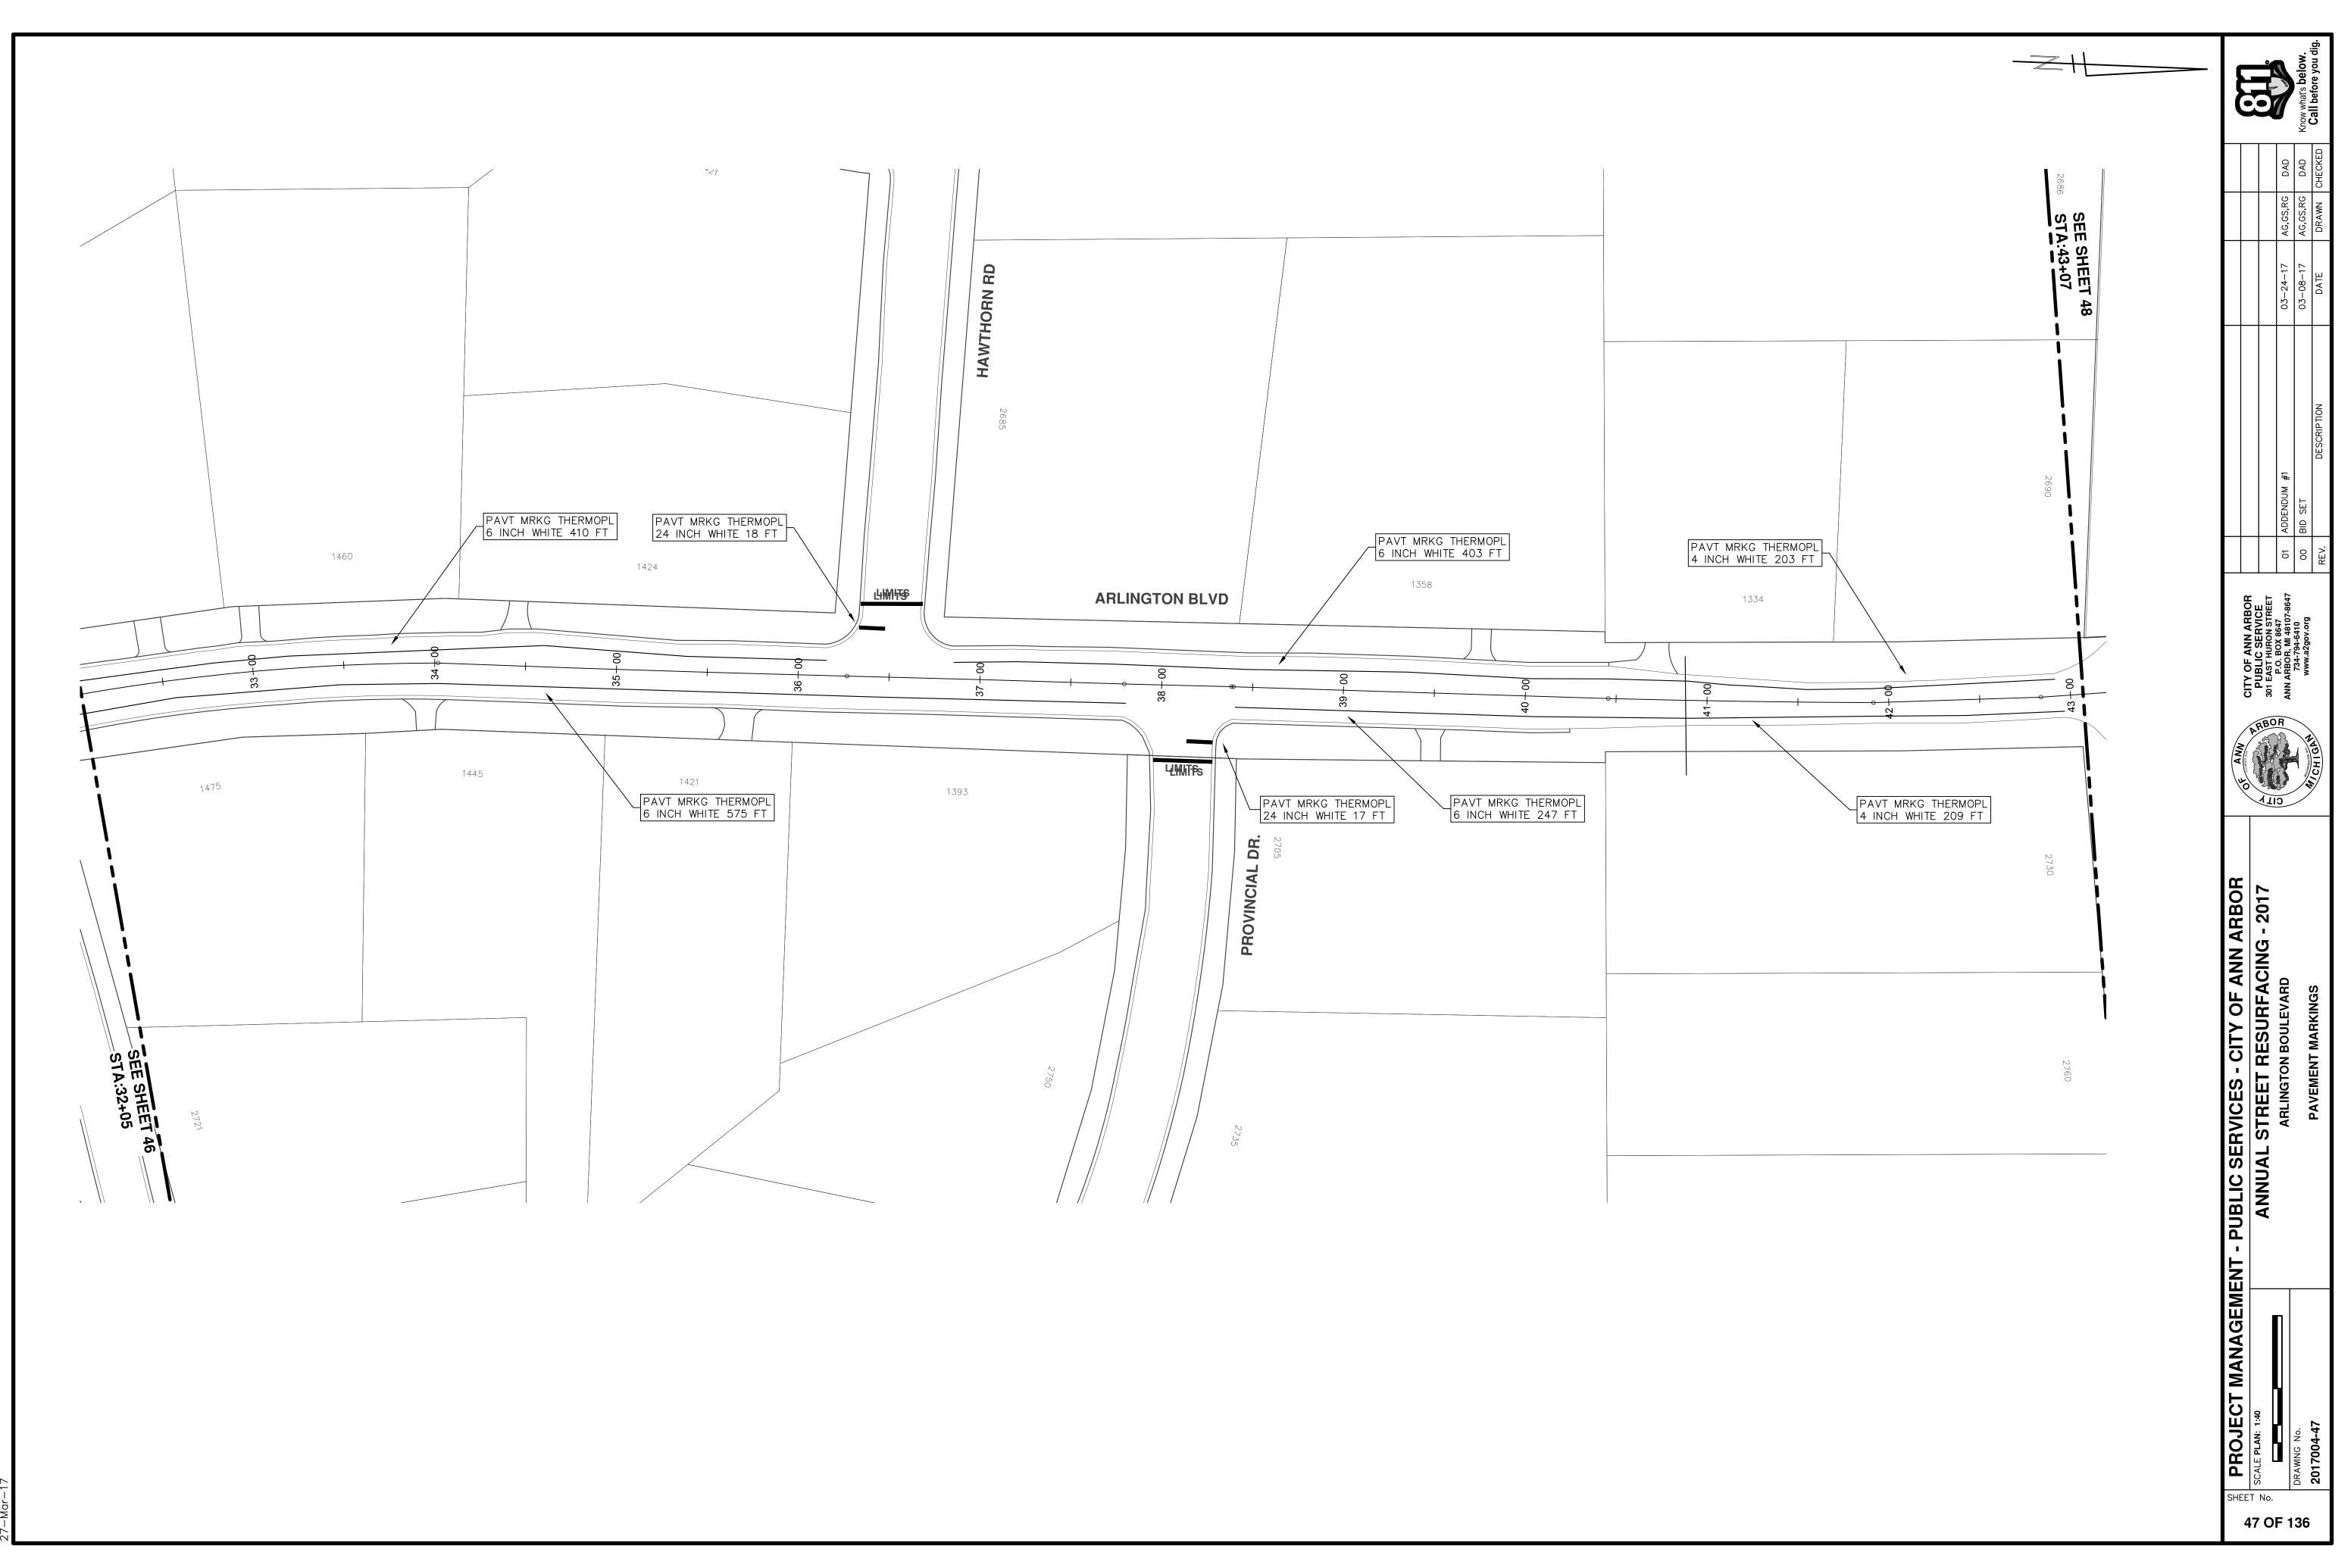


4 S: \Project 27-Mar-17

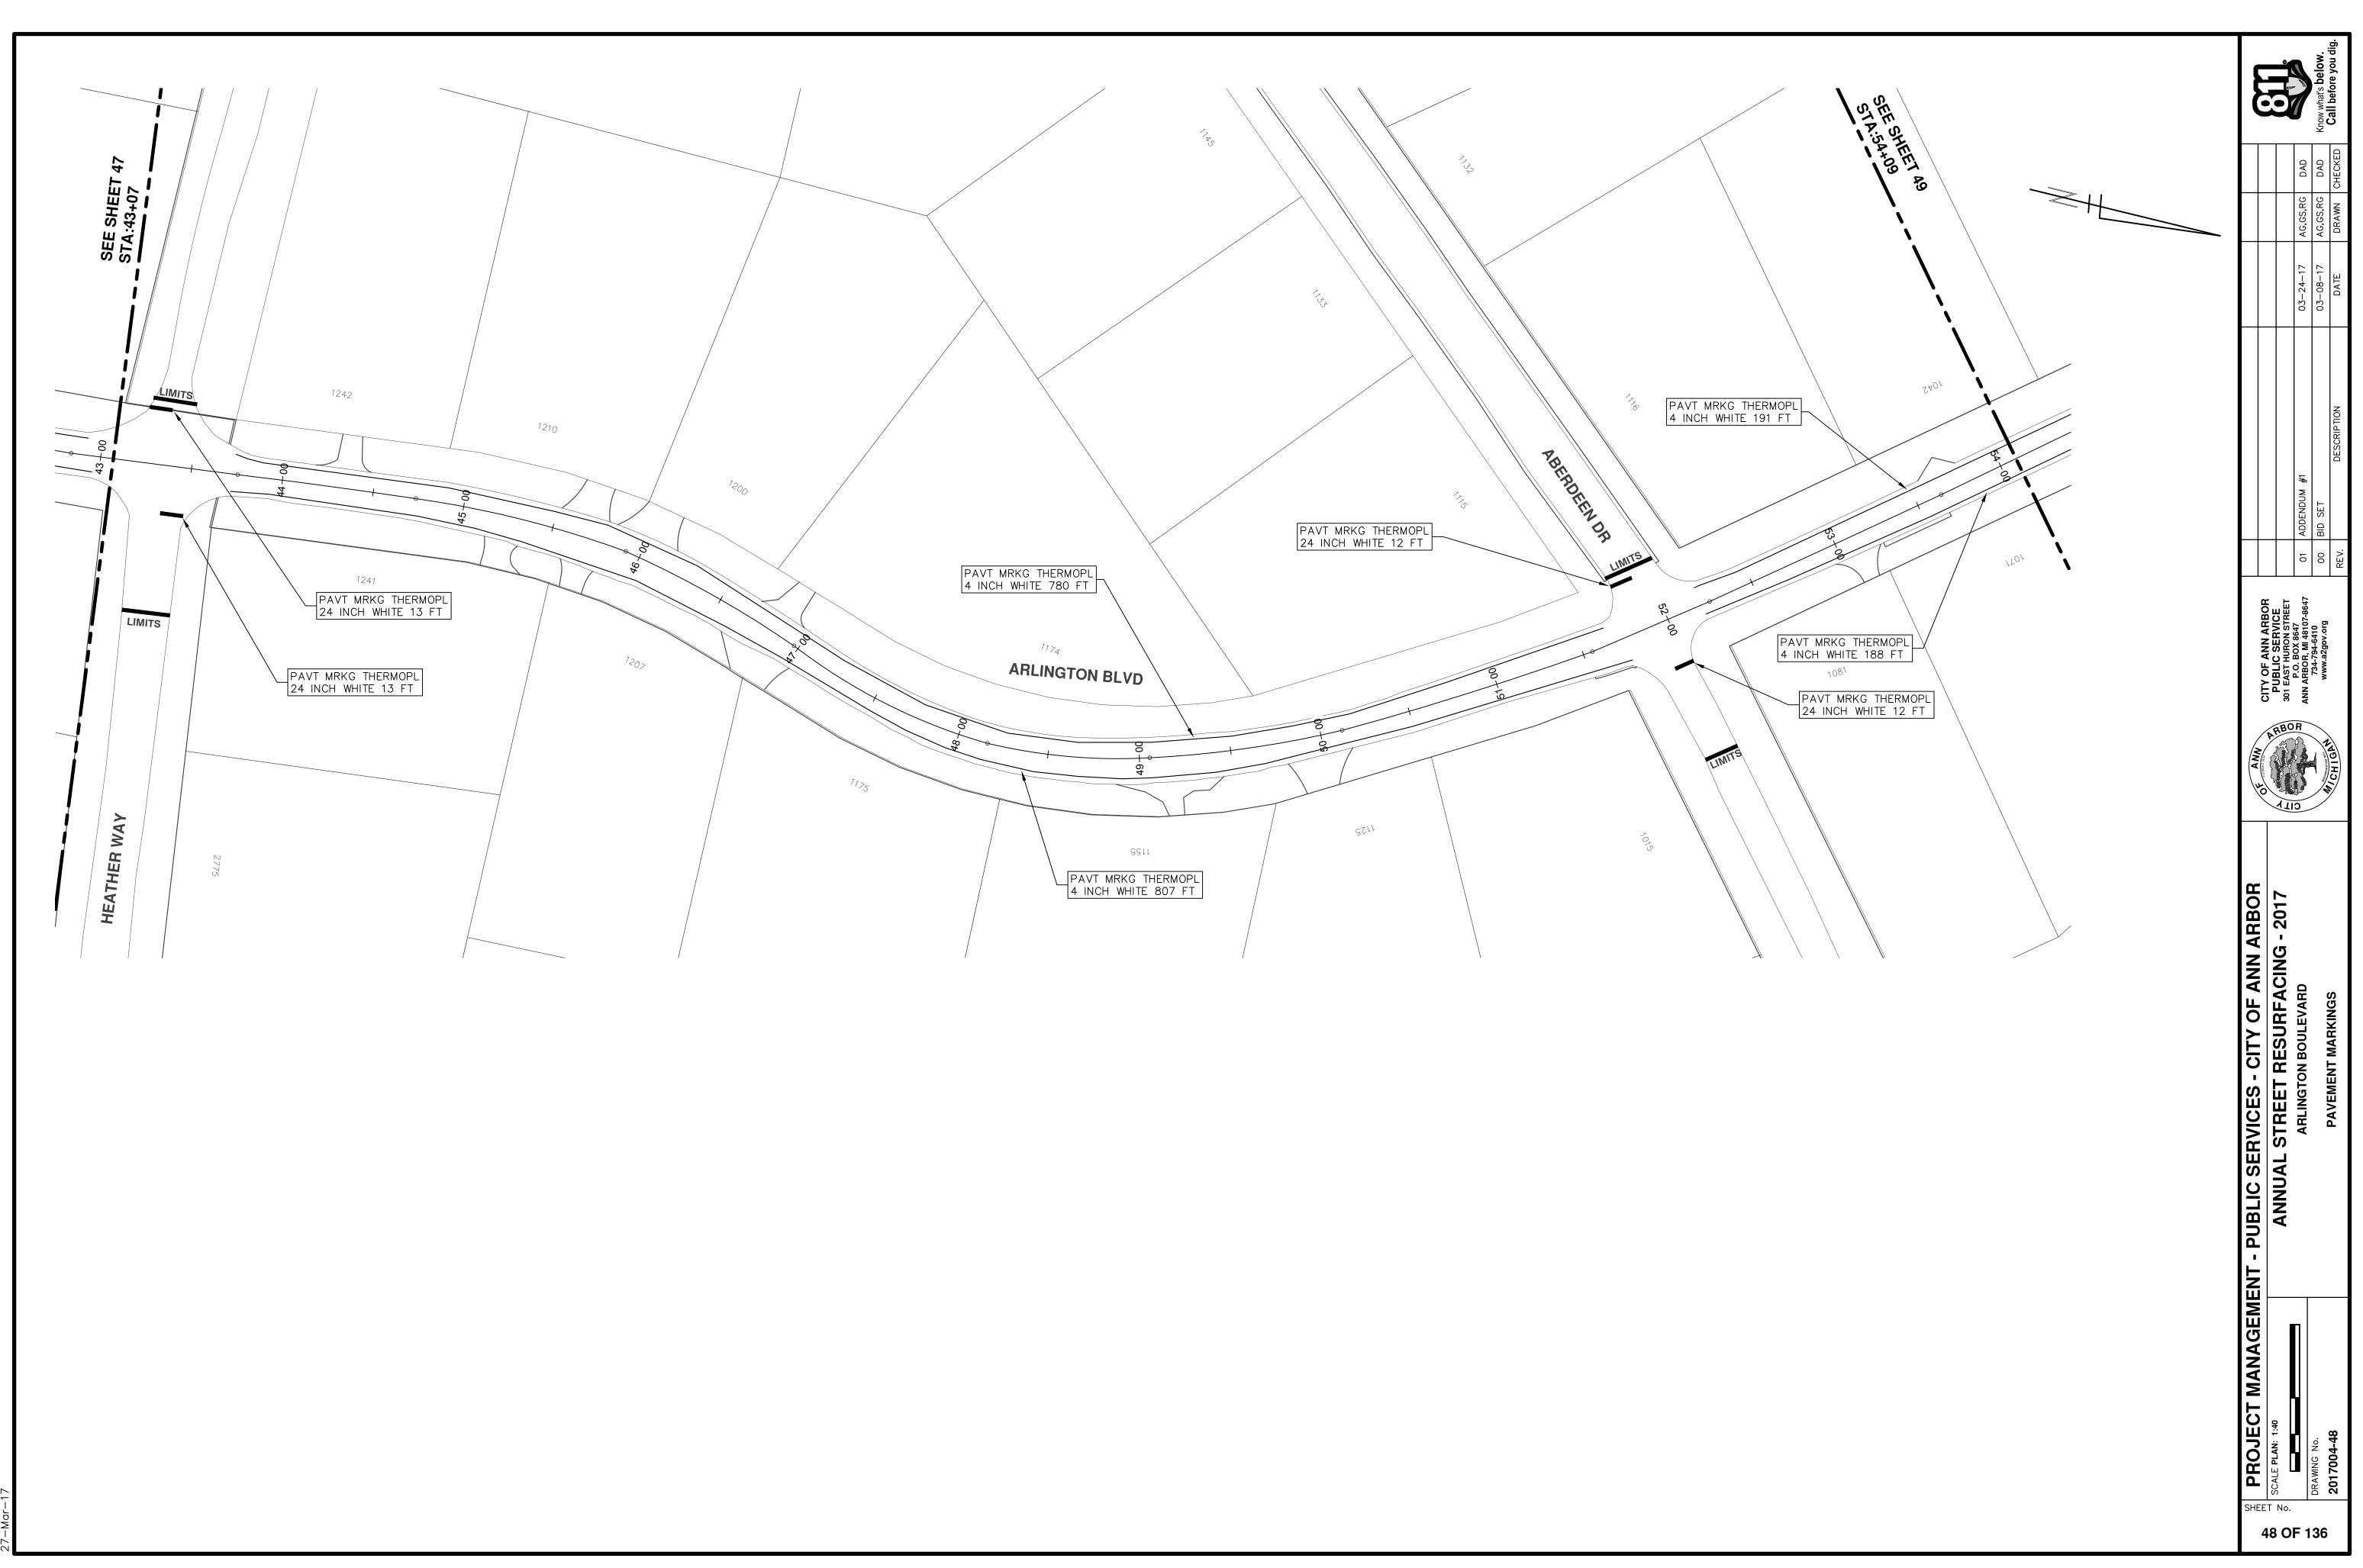

4 S: \Project 27-Mar-17

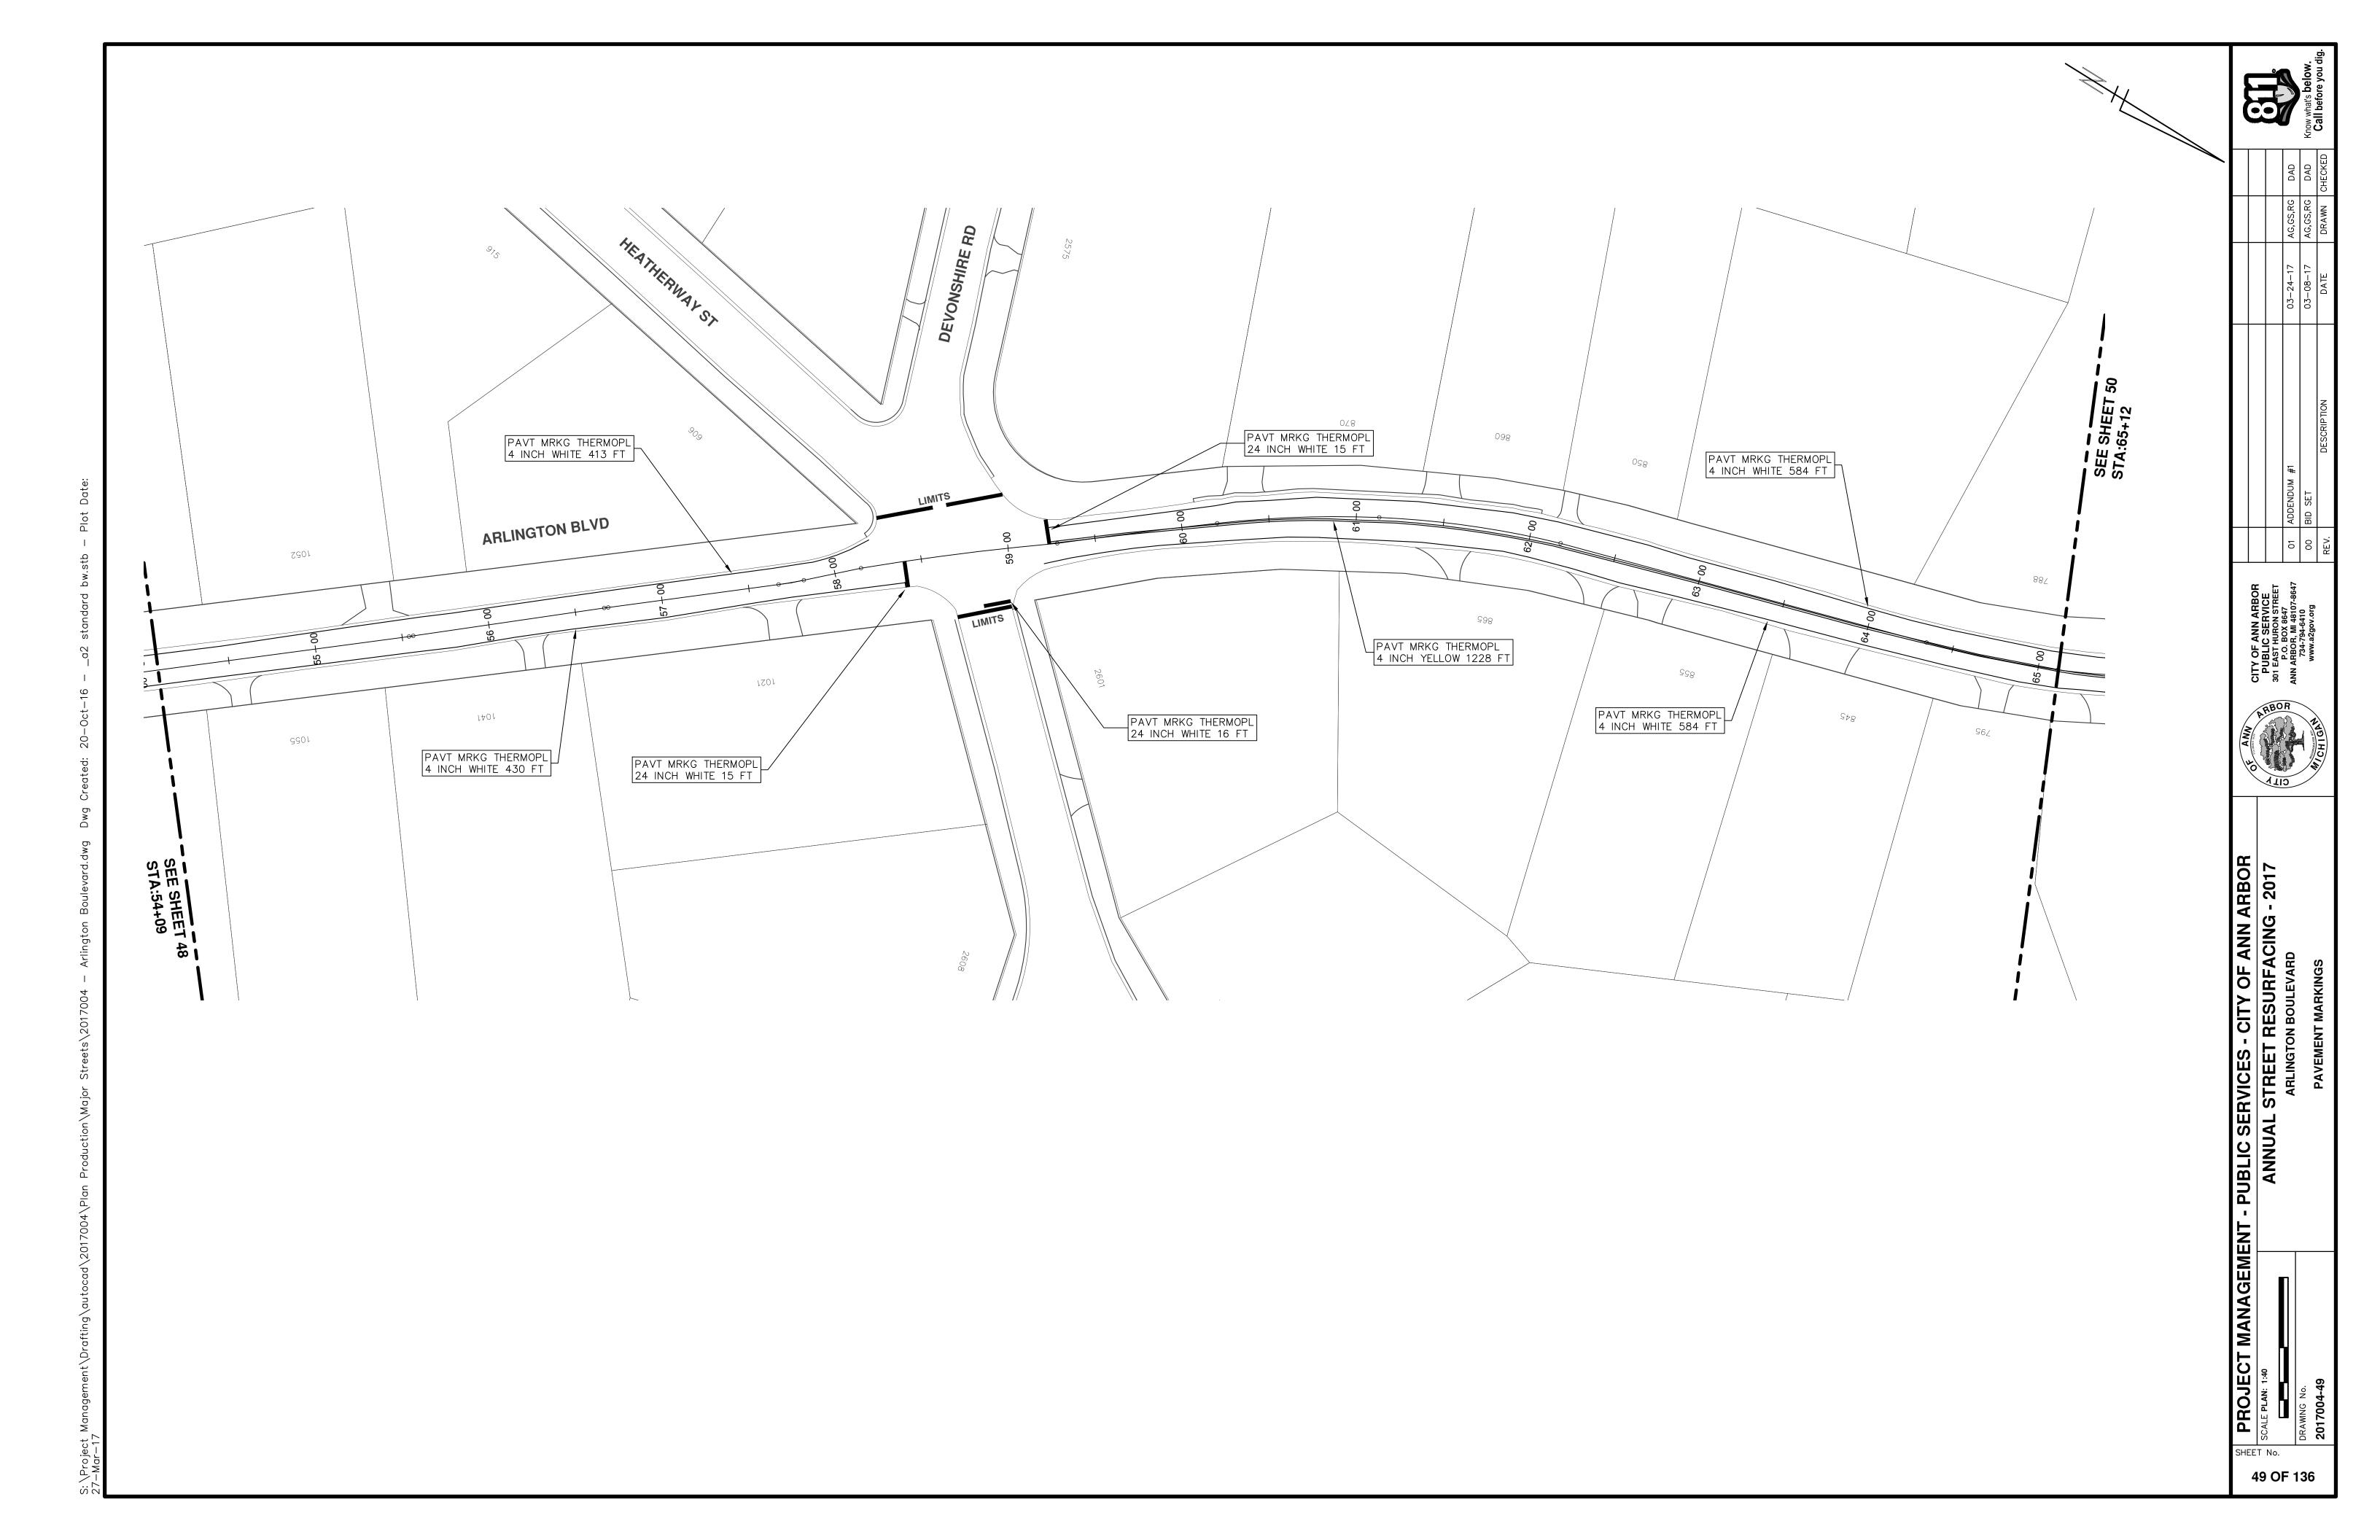



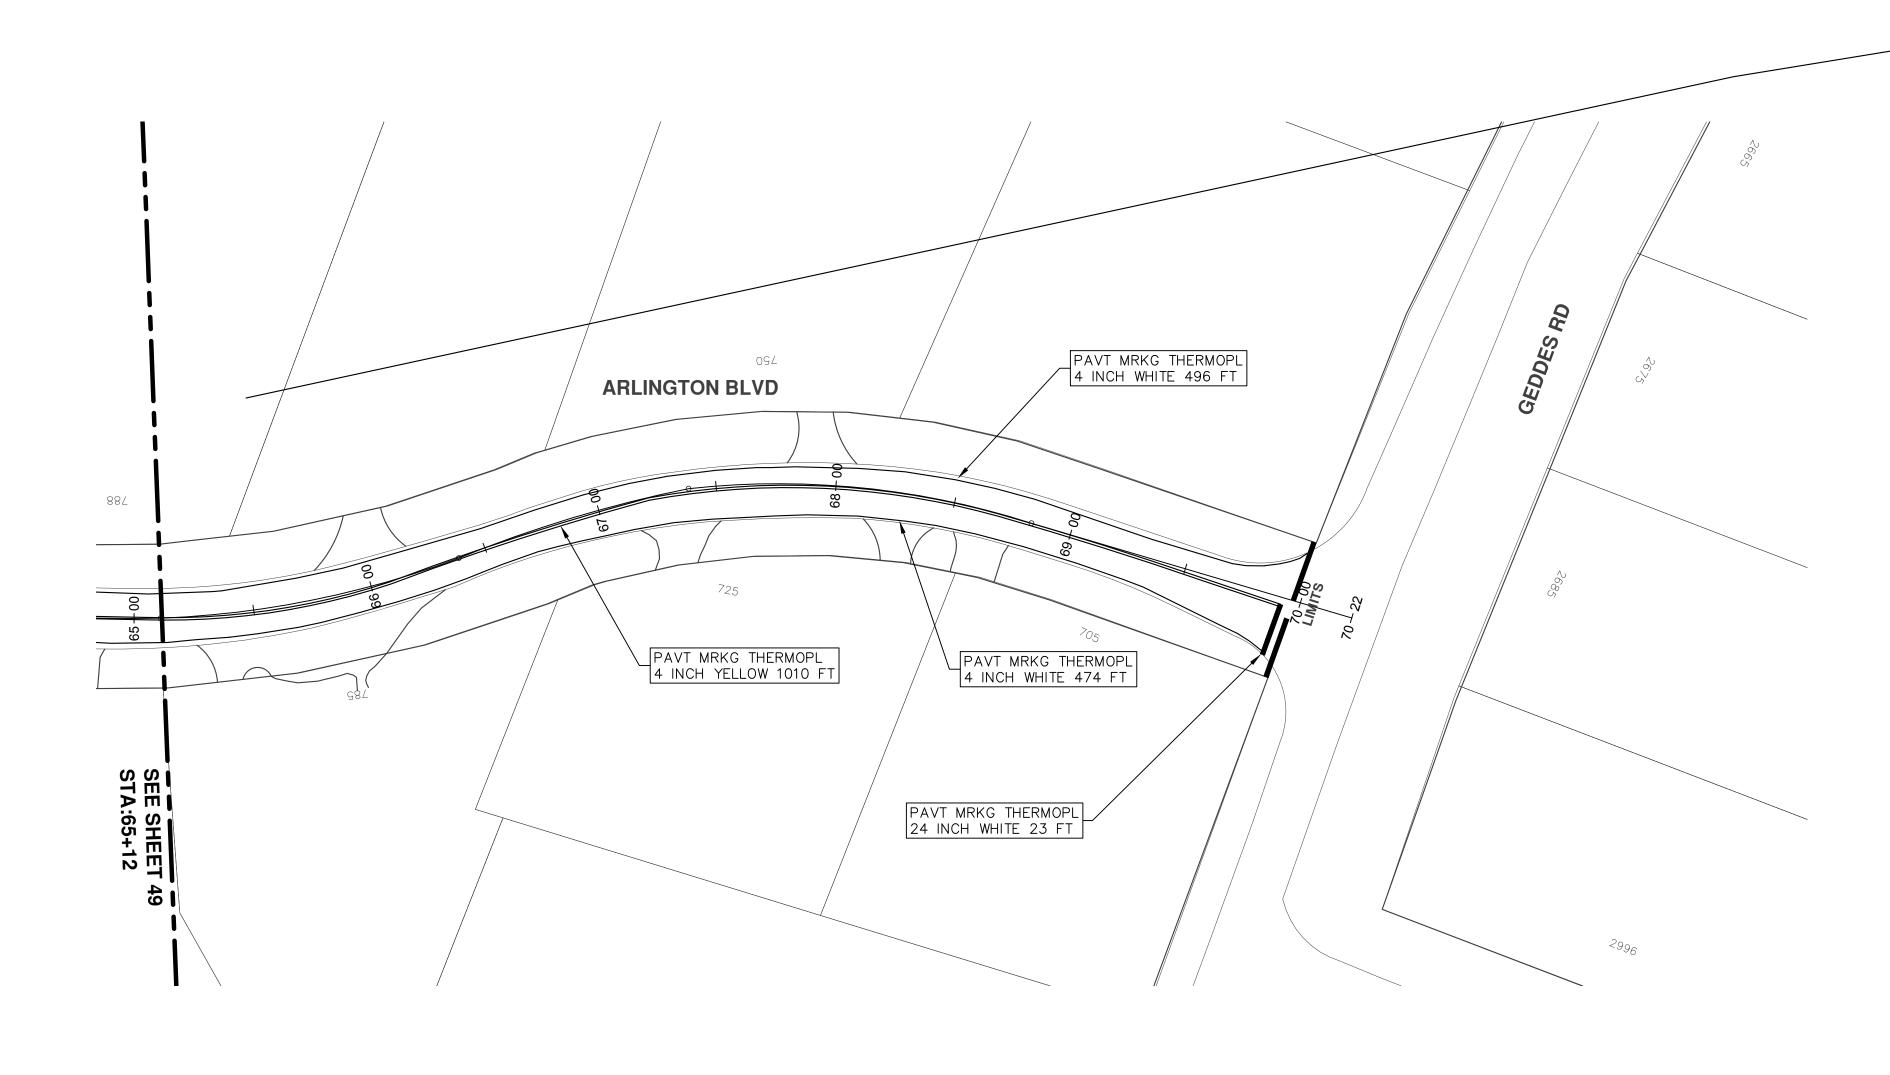

SH	E PROJECT MANAGEME	ANAGEMENT - PUBLIC SERVICES - CITY OF ANN ARBOR	AMA							
				CITY OF ANN ARROR						
50	H SCALE DI AN. 1.40									
		ANNUAL STREET RESURFACING - 2017		301 EAST HURON STREET						
F 1		ARLINGTON BOULEVARD		P.O. BOX 8647 ANN ARBOR. MI 48107-8647	01 ADDENDUM #1	03	03-24-17	AG,GS,RG	DAD	
136	DRAWING No.			734-794-6410 www.a2gov.org	00 BID SET	03	03-08-17	AG,GS,RG	DAD	Know what's below.
	2017004-50	PAVEMENT MARKINGS	MICHIGAT		REV. DESCRIPTION		DATE	DRAWN CHECKED	CHECKED	Call before you dig.



CITY OF ANN ARBOR PROJECT MANAGEMENT

tem Code	QUANTITIES Item Description	Units	Quantity
2047001		Ft	50.0
2047011		Syd	39.0
2057011	Grading, Sidewalk Ramp	Syd	39.0
2057021		Cyd	183.0
2080020	Erosion Control, Inlet Protection, Fabric Drop	Ea	14.(
4037050	Dr Structure, Adj, Case 1, Modified	Ea	27.0
4037050	Dr Structure, Temp Lowering, Modified	Ea	27.0
5010003	Cold Milling HMA Surface	Ton	2,471.
5010005	HMA Surface, Rem	Syd	11.
5010703	HMA, LVSP	Ton	2,411.
5017031	_HMA, Wedging, 36A	Ton	8.
5017050	HMA Surface, Around Structure Cover, Rem	Ea	7.
6027021	Flowable Fill	Cyd	1.5
8027001	 Curb and Gutter, Conc	Ft	50.
8037001		Ft	30.
8037010	Sidewalk Ramp, Conc, 6 inch, Modified	Sft	350.
8037010		Sft	70.
8110049	Pavt Mrkg, Ovly Cold Plastic, Direction Arrow Sym, Bike	Ea	8.
8110058	Pavt Mrkg, Ovly Cold Plastic, Bike, Small Sym	Ea	3.
8110520	Pavt Mrkg, Wet Retrflec, Thermopl, 4 inch, White	Ft	696.
8110521	Pavt Mrkg, Wet Retrflec, Thermopl, 6 inch, White	Ft	5,311.
8110524	Pavt Mrkg, Wet Retrflec, Thermopl, 4 inch, Yellow	Ft	1,975.
8117001	_Pavt Mrkg, Wet Retrflec, Thermopl, 24 inch, Stop Bar	Ft	374.
8117001		Ft	584.
8117001	Pavt Mrkg, Wet Retrflec, Thermopl, 4 inch, Parking Sym, White	Ft	832.
8117050	Pavt Mrkg, Wet Retrflec, Thermopl, Only	Ea	8.
8117050	_Pavt Mrkg, Wet Retrflec, Thermopl, Stop	Ea	2.
8117050	Pavt Mrkg, Wet Retrflec, Thermopl, Lt Turn Arrow Sym	Ea	5.
8117050	Pavt Mrkg, Wet Retrflec, Thermopl, Rt Turn Arrow Sym	Ea	4.
8117050	Pavt Mrkg, Wet Retrflec, Thermopl, Thru Arrow Sym	Ea	2.
8117050		Ea	1.
8117050		Ea	1.
8120012	Barricade, Type III, High Intensity, Double Sided, Lighted, Furn	Ea	10.
8120013	Barricade, Type III, High Intensity, Double Sided, Lighted, Oper	Ea	10.
8120140	Lighted Arrow, Type C, Furn	Ea	2.
8120141	Lighted Arrow, Type C, Oper	Ea	2.
8120210	Pavt Mrkg, Longit, 6 inch or Less Width, Rem	Ft	40.
8120260	Plastic Drum, High Intensity, Lighted, Fum	Ea	125.
8120261	Plastic Drum, High Intensity, Lighted, Oper	Ea	125.
8120330	Sign, Portable, Changeable Message, Furn	Ea	2.
8120331	Sign, Portable, Changeable Message, Oper	Ea	2.
8120350	Sign, Type B, Temp, Prismatic, Furn	Sft	 542.
8120351	Sign, Type B, Temp, Prismatic, Oper	Sft	542.
8127050	_No Parking Sign	Ea	38.
8167011	Slope Restoration	Syd	
8217050	Monument Box Adjust	Ea	1.

KEY	ASSOCIATED PAY ITEM(S)
	 _Dr Structure, Adj, Case 1, Modified
AA	 _Dr Structure, Adj, Case 2, Modified
	_Dr Structure, Temp Lowering, Modified
	 _Dr Structure, Temp Lowering, Modified
AB	• _Gate Box, Adj, Case 1
AD	 _Gate Box, Adj, Case 2
	_Monument Box Adjust
ADST	_Dr Structure, Adj, Add Depth, Modified
AK	Dr Structure, Adj, Case 1, Modified
	• _Sidewalk, Sidewalk Ramp, and Driveway Approach, Any Thickness, Re
C4	Grading, Sidewalk
	• _Sidewalk, Conc, 4 inch, Modified
	 _sidewalk, Sidewalk Ramp, and Driveway Approach, Any Thickness, Re
	 Grading, Sidewalk
C4HE	Cement
	_Sidewalk, Conc, 4 inch, Modified
	•_Sidewalk, Sidewalk Ramp, and Driveway Approach, Any Thickness, Re
	• _Grading, Sidewalk
C6	• _Grading, Sidewalk Ramp
	 _Detectable Warning Surface, Modified
	 _Sidewalk Ramp, Conc, 6 inch, Modified
	 _Sidewalk, Conc, 6 inch, Modified
C8	 _Grading, Driveway Approach
00	 _Driveway, Nonreinf Conc, 8 inch, Modified
	•_Sidewalk, Sidewalk Ramp, and Driveway Approach, Any Thickness, Re
	 Grading, Driveway Approach
	Grading, Sidewalk
	• _Grading, Sidewalk Ramp
	• Cement
CHE	Driveway, Nonreinf Conc, 6 inch, Modified
	 Driveway, Nonreinf Conc, 8 inch, Modified
	Detectable Warning Surface, Modified
	_
	_Sidewalk Ramp, Conc, 6 inch, Modified
	_Sidewalk, Conc, 6 inch, Modified
C/G	• _Curb, Gutter, and Curb and Gutter, Any Type, Rem
	_Curb and Gutter, Conc
	 _Curb, Gutter, and Curb and Gutter, Any Type, Rem
C/GHE	Cement
	 _Driveway Opening, Conc, Det M, Modified
CP	_Grading, Sidewalk
CP	 _Sidewalk, Conc, 4 inch, Modified
CR	•_Sidewalk, Sidewalk Ramp, and Driveway Approach, Any Thickness, Re
	Dr Structure, Rem
DS	Sewer, Rem, Less than 24 inch
_	• Dr Structure, 24 inch dia
	Dr Structure, Rem
DSDI	Sewer, Rem, Less than 24 inch
0301	Contractions (20) in a provide the state of
DT	Dr Structure, Double Inlet
PT	_Dr Structure, Point
	Dr Structure Cover, Type B
RRA	_Dr Structure Cover, Type B, Special
	 _Dr Structure, Adj, Case 1, Modified
	_Dr Structure, Temp Lowering, Modified
DDK	Dr Structure Cover, Type K
RRK	• _Dr Structure, Adj, Case 1, Modified
RS	
	Plastic Drum, High Intensity, Lighted, Furn
TYPE II	Plastic Drum, High Intensity, Lighted, Oper
	Barricade, Type III, High Intensity, Double Sided, Lighted, Furn
TYPE III	
	 Barricade, Type III, High Intensity, Double Sided, Lighted, Oper

PROJECT LOCATION: CATHERINE STRE

ITB No. 4477 FILE No. 2017-004

CONCEPTION VE

	LEGEND		
SYMBOL	DESCRIPTION		
S	EXISTING SANITARY SEWER MANHOLE		
(\mathbf{r})	EXISTING STORM SEWER MANHOLE		
\otimes	EXISTING WATER MAIN VALVE IN WELL		
+	WATER MAIN GATE VALVE IN BOX		
+ Ç +	FIRE HYDRANT		
(g)	MICHCON GAS CO. VALVE BOX/WELL		
t	AMERITECH TELEPHONE VAULT		
e	ELECTRIC MANHOLE		
\bullet	SOIL BORING		
	EXISTING STORM SEWER INLET		
•	MONUMENT BOX		
	REMOVE AND REPLACE CONC. SIDEWALK		
	PLACE CONCRETE SIDEWALK		
	REMOVE & REPLACE CONC. CURB & GUTTER		
	CONSTRUCTION LIMITS		
	6" WRAPPED UNDERDRAIN		
	REMOVE CONCRETE SIDEWALK		
	SUBGRADE UNDERCUT		

	CONSTRUCTION	N METHO
-		

WORK ON THIS STREET INCLUDES, BUT WITH THE PLANS AND SPECIFICATIONS CONSTRUCTION. PERFORM THE WORK THE ENGINEER. COMPLETE ITEMS 11 TH CONTROL OPERATIONS AS DIRECTED BY

PHASE I

- 1. IMPLEMENT MAINTENANCE OF TRAFF MEASURES.
- 2. CONDUCT REMOVAL WORK RELATED
- 3. INSTALL PROPOSED DRAINAGE STRU
- 4. PERFORM ALL CONCRETE WORK, INC
- 5. TEMPORARY LOWER ALL STRUCTURE MONUMENT BOXES WITH EXCEPTION STRUCTURES SHALL COLDMILLED AF
- 6. REMOVE 4 INCHES OF EXISTING HM STREET AND GLEN AVENUE, WHICH INCLUDE GRANULAR BASE MATERIAL TRUCK.
- 7. PERFORM ALL JOINT AND CRACK CI
- 8. GRADE, SHAPE, AND COMPACT THE
- 9. CLEAN PAVEMENT AND PLACE 2 INC N INGALLS STREET AND GLEN AVEN

<u>PHASE II</u>


- 10. REPEAT ITEMS 1 THRU 9 IN THE OR
- 11. ADJUST ALL STRUCTURE COVERS, IN
- 12. CLEAN PAVEMENT AND PLACE 2 INC INGALLS STREET AND GLEN AVENUE
- 13. CLEAN PAVEMENT AND PLACE HMA
- 14. CLEAN PAVEMENT AND COMPLETE A
- 15. COMPLETE ALL MISCELLANEOUS CON
- 16. REMOVE ALL TRAFFIC CONTROL DEV


NO	T


		QUANTITIES Sign, Type B, Temp, Prismatic		
Quantity	Sign Code	Description	Area (sft)	Total Area
32.0	D3-1	Street Name Sign	4.000	128.000
1.0	M4-10R	Detour Arrow (Right) Sign	6.000	6.000
1.0	M4-8a	End Detour Sign	3.000	3.000
5.0	M4-9L	Detour Sign (w/Left Arrow)	5.000	25.000
1.0	M4-9R	Detour Sign (w/Right Arrow)	5.000	5.000
2.0	M4-9S	Detour Sign (w/Thru Arrow)	5.000	10.000
2.0	R5-1	Do Not Enter Sign	6.250	12.500
2.0	R5-1A	Wrong Way Sign	6.000	12.000
8.0	R11-2	Road Closed Sign ("Road Closed")	8.000	64.000
1.0	R11-4	Road Closed Sign ("Road Closed To Thru Traffic")	12.500	12.500
1.0	R3-1	Movement Prohibition Sign ("No Right Turn")	4.000	4.000
1.0	R3-2	Movement Prohibition Sign ("No Left Turn")	5.000	5.000
1.0	R6-1L	One Way (Left) Sign	3.000	3.000
1.0	R6-1R	One Way (Right) Sign	3.000	3.000
3.0	SP-1	Special Sign	20.000	60.000
15.0	W20-1	Road Work Ahead Sign	9.000	135.000
3.0	W20-2	Detour Ahead	9.000	27.000
3.0	W20-3	Road Closed Ahead	9.000	27.000
			TOTAL	542.000


		Know what's below Call before you
EET		
THOD AND SEQUENCING		
, BUT IS NOT LIMITED TO, THE FOLLOWING ITEMS. COMPLETE THE WORK IN ACCORDANCE ATIONS, AS DIRECTED BY THE ENGINEER, AND UTILIZING PART WIDTH TWO (2) PHASE ORK IN THE ORDER INDICATED BELOW UNLESS OTHERWISE AUTHORIZED OR DIRECTED BY 11 THRU 16 UTILIZING THE M.O.T. PLAN CURRENTLY IN PLACE, LANE CLOSURES, AND FLAG D BY THE ENGINEER.		
TRAFFIC (M.O.T.) PLAN, AND INSTALL SOIL EROSION AND SEDIMENTATION CONTROL		
ATED TO PAVEMENT, DRAINAGE, AND CONCRETE ITEMS WITH EXCEPTION TO COLDMILLING. STRUCTURES, STORM SEWER, AND UNDERDRAIN AS REQUIRED. K, INCLUDING RESTORATION.		
CTURE COVERS LOCATED WITHIN THE EXISTING PAVEMENT AREA, INCLUDING GATE AND PTION TO THE SEGMENT BETWEEN N INGALLS STREET AND GLEN AVENUE, WHICH ED AROUND.		
G HMA SURFACE BY COLDMILLING WITH EXCEPTION TO THE SEGMENT BETWEEN N INGALLS /HICH PAVEMENT SHALL BE REMOVED TO A DEPTH OF ONLY 2 INCHES. THIS MAY TERIAL. DEPTH TO BE DETERMINED BY THE ENGINEER. PROOF ROLL WITH FULLY LOADED		
CK CLEANOUT. HMA/HAND PATCHING, UNDERCUTS AND/OR BASE REPAIRS AS REQUIRED. T THE EXISTING BASE MATERIAL AS REQUIRED. 2 INCH LEVELING COURSE HMA MIX (LVSP) WITH EXCEPTION TO THE SEGMENT BETWEEN AVENUE, WHICH PLACEMENT SHALL BE 2 INCH TOP COURSE HMA MIX (LVSP).	ARBOR 017	
HE ORDER SHOWN SHOWN ABOVE.		
ERS, INCLUDING GATE AND MONUMENT BOXES, TO THEIR FINISH ELEVATION.	OF /	STREET
2 INCH TOP COURSE HMA MIX (LVSP) WITH EXCEPTION TO THE SEGMENT BETWEEN N VENUE, WHICH TOP COURSE PLACEMENT SHALL BE COMPLETED UNDER ITEM 10 ABOVE.	CITY OF AN RESURFACING	
HMA APPROACHES AS REQUIRED.	╹ │ ⊢	CATHERINE
ETE ALL PAVEMENT MARKINGS. S CONSTRUCTION INCLUDING ALL CLEAN UP AND FINAL RESTORATION.	/ICES - STREET	CATI
L DEVICES, AND MISS DIG FLAGS. NOTES:	SERV	
FOR PROTECTION OF UNDERGROUND UTILITIES AND IN CONFORMANCE WITH PUBLIC ACT 174 OF 2013, THE CONTRACTOR SHALL CALL 811 OR 1-800-482-7171 A MINIMUM OF THREE FULL WORKING DAYS, EXCLUDING SATURDAYS, SUNDAYS, AND HOLIDAYS, PRIOR TO BEGINNING EACH EXCAVATION IN AREAS WHERE PUBLIC UTILITIES HAVE NOT BEEN PREVIOUSLY LOCATED. MEMBERS WILL THUS BE ROUTINELY NOTIFIED. THIS DOES NOT RELIEVE THE CONTRACTOR OF THE RESPONSIBILITY OF NOTIFYING UTILITY OWNERS WHO MAY NOT BE A PART OF THE "MISS DIG" ALERT SYSTEM.	- PUBLI	
THE UNDERGROUND LOCATIONS SHOWN FOR NATURAL GAS, TELEPHONE, ELECTRICAL POWER, CABLE TV AND FIBER OPTIC LINES ARE APPROXIMATE. THE CITY OF ANN ARBOR ASSUMES NO RESPONSIBILITY FOR THEIR ACCURATE REPRESENTATION IN THIS DRAWING. MISS DIG MUST BE CONTACTED PRIOR TO CONSTRUCTION TO LOCATE THESE UTILITIES.	GEME	
THE IMPROVEMENTS COVERED BY THESE PLANS SHALL BE PERFORMED IN ACCORDANCE WITH MICHIGAN DEPARTMENT OF TRANSPORTATION (MDOT) 2012 STANDARD SPECIFICATIONS FOR CONSTRUCTION, INCLUDING REFERENCED MDOT PUBLICATIONS, AND THE PROJECT CONTRACT DOCUMENTS.	ECT MANA	51
PROJECT MANAGEMENT SERVICES UNIT CITY OF ANN ARBOR PUBLIC SERVICES 301 EAST HURON STREET, P.O. BOX 8647 ANN ARBOR, MICHIGAN 48107-8647 734-794-6410 www.a2gov.org	SHEET No.	DRAWING No. 2017004-5
CHIGAN 134-134-0410 www.azgov.org	51 OF ⁻	136

dig

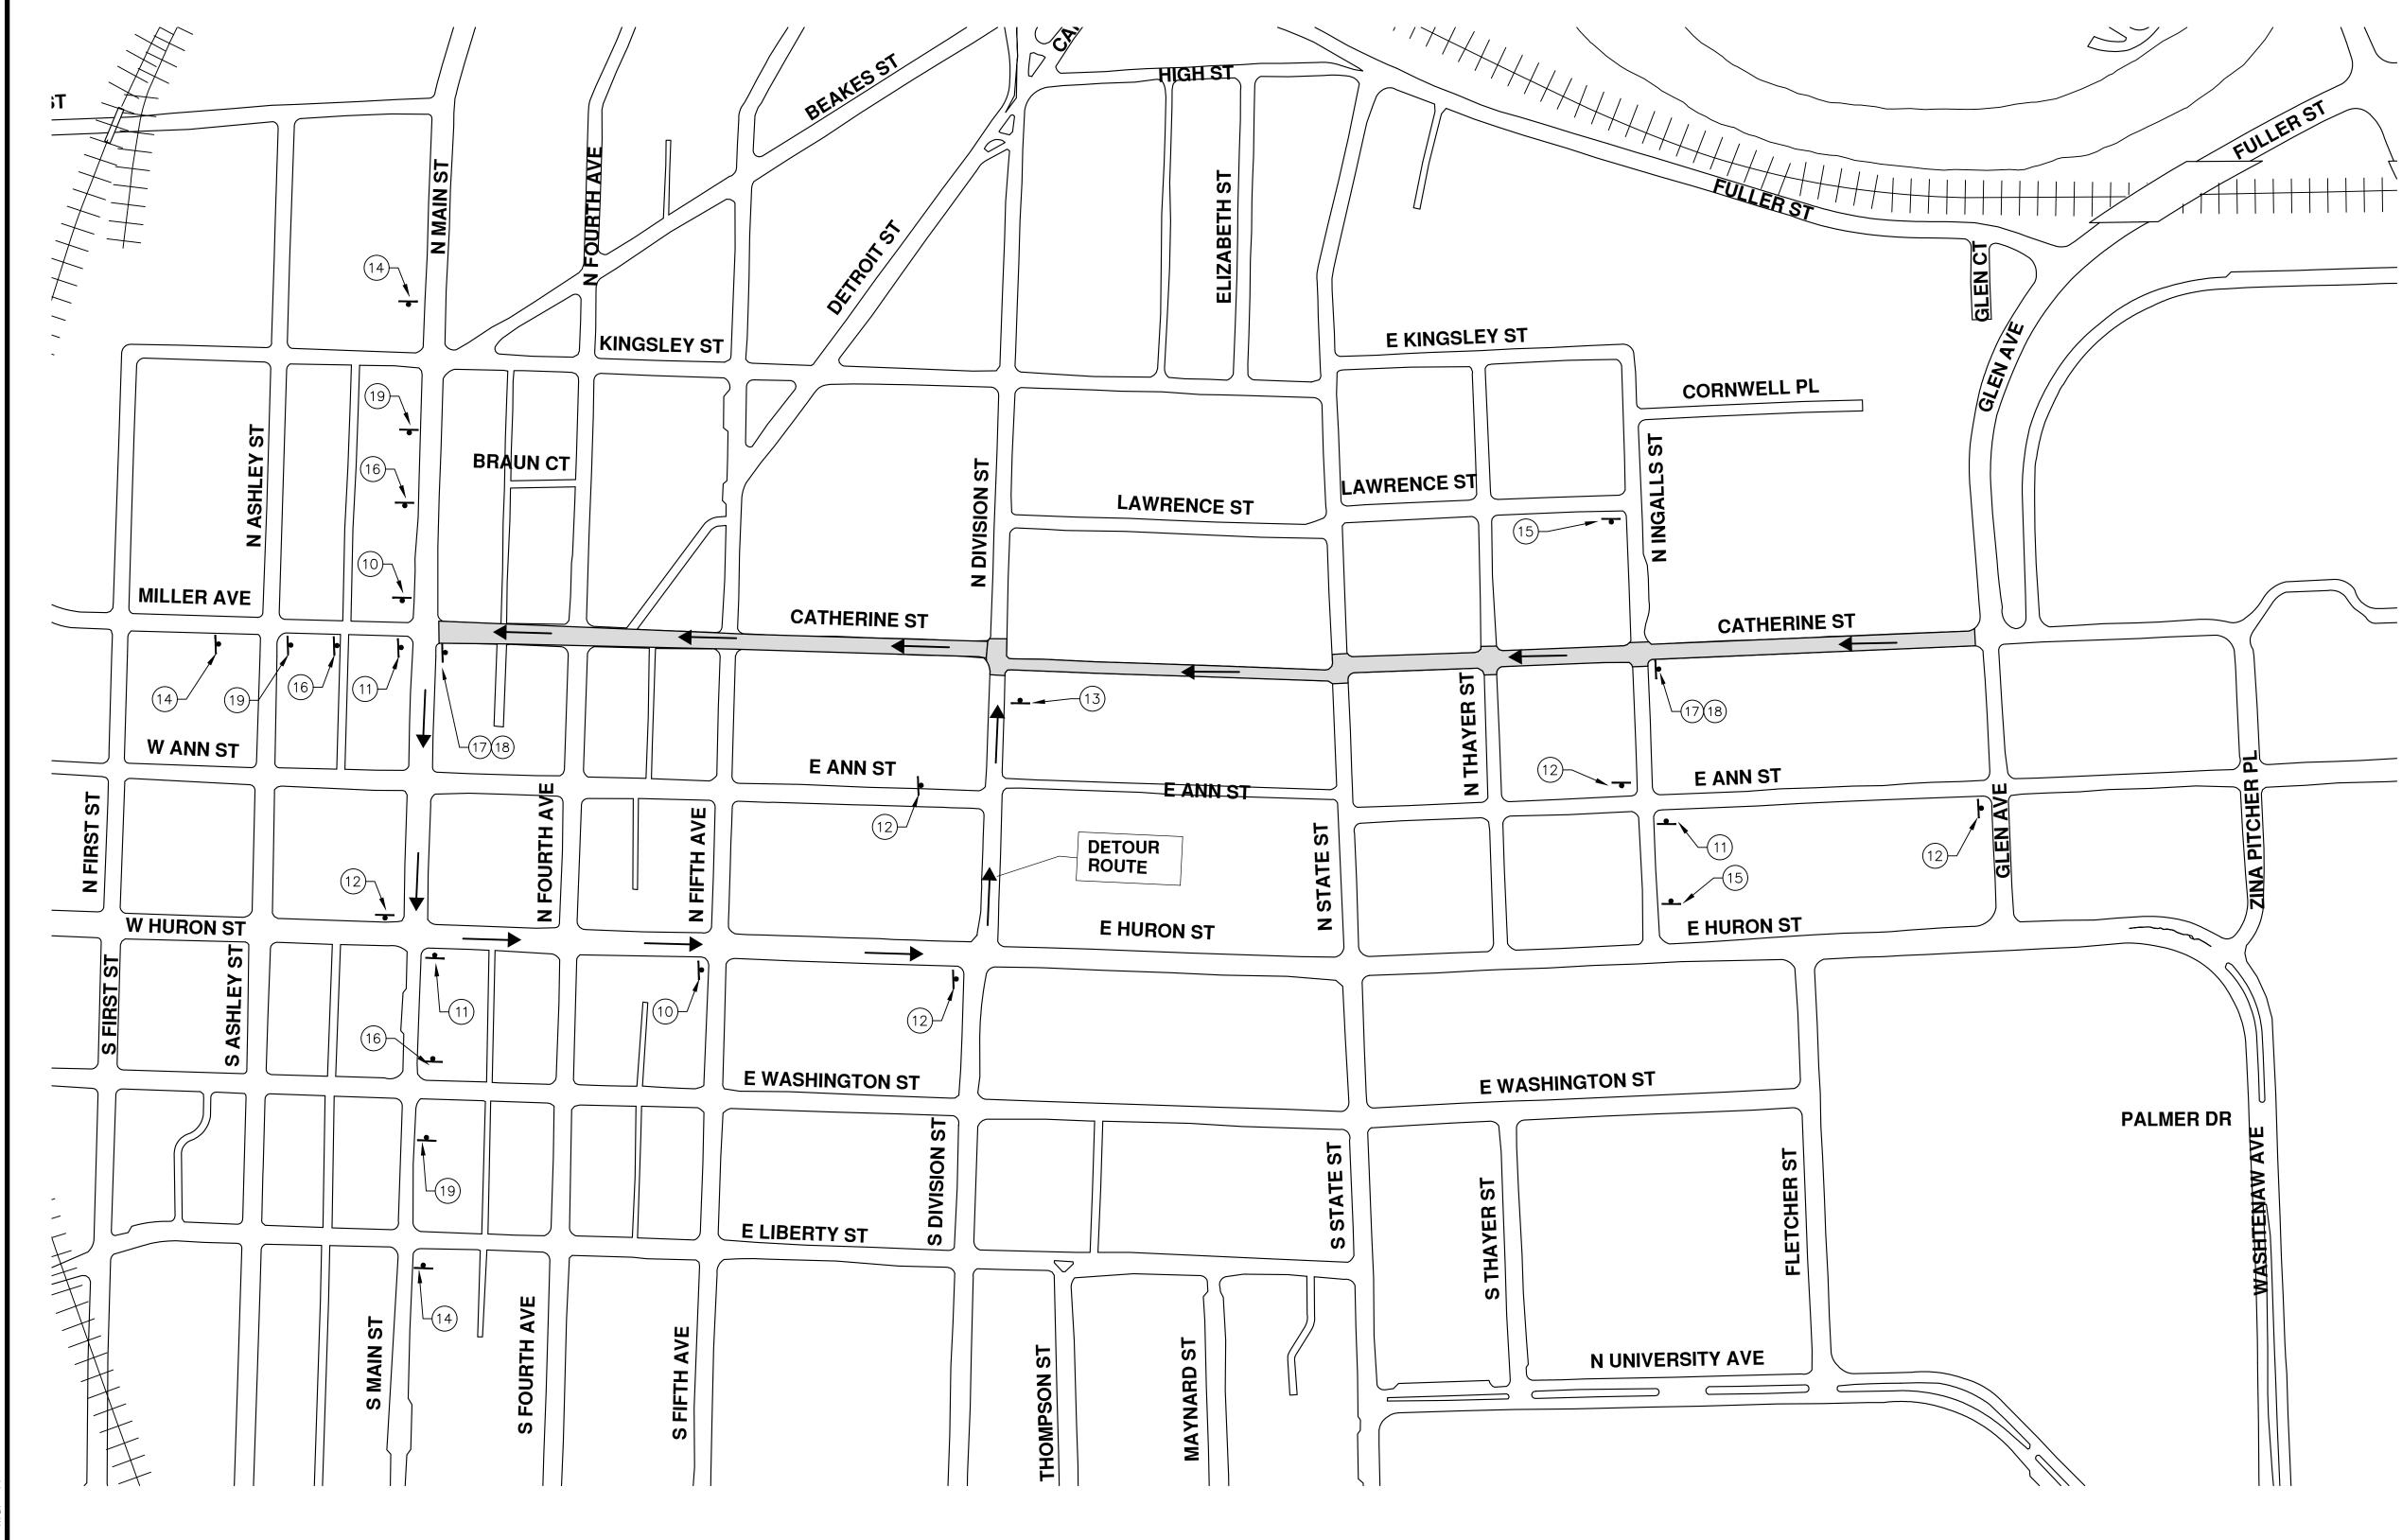


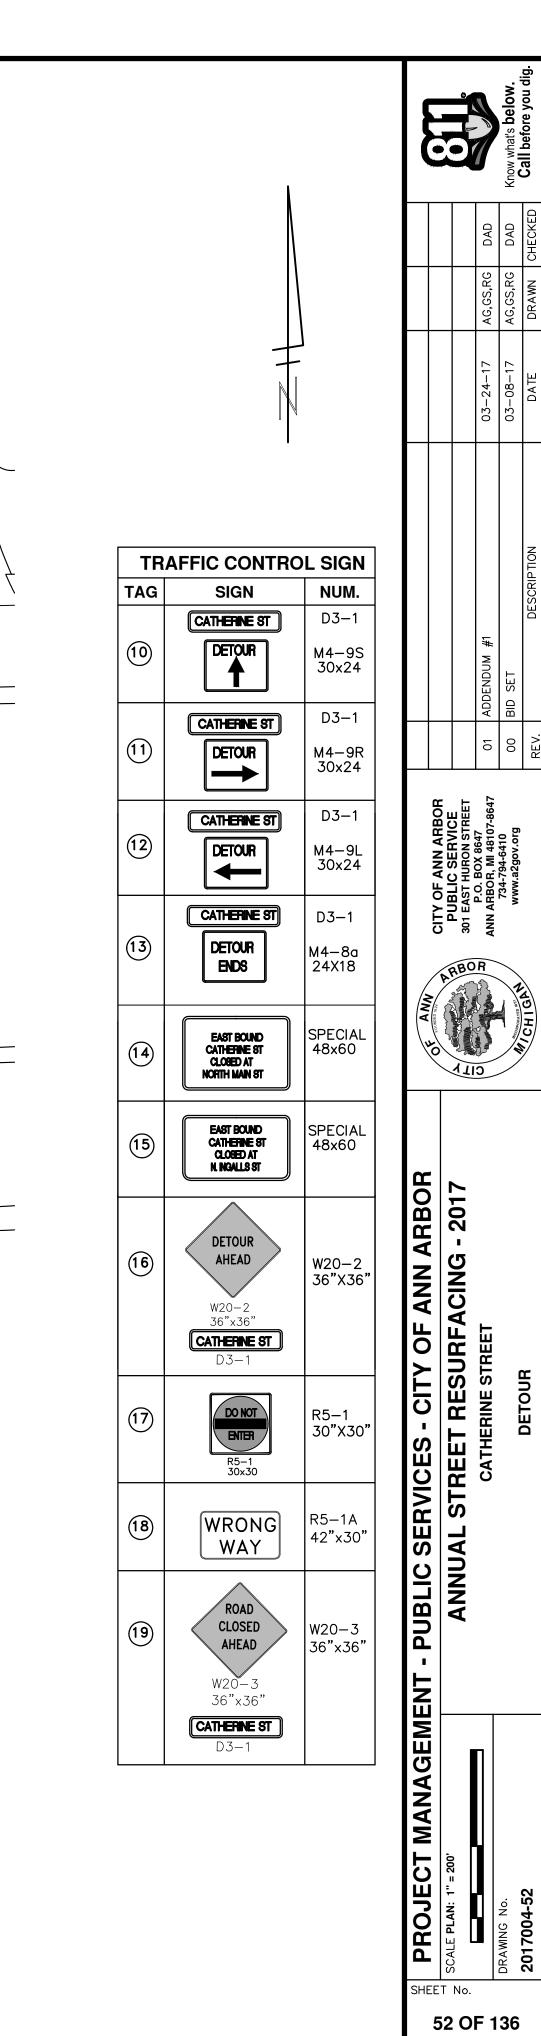

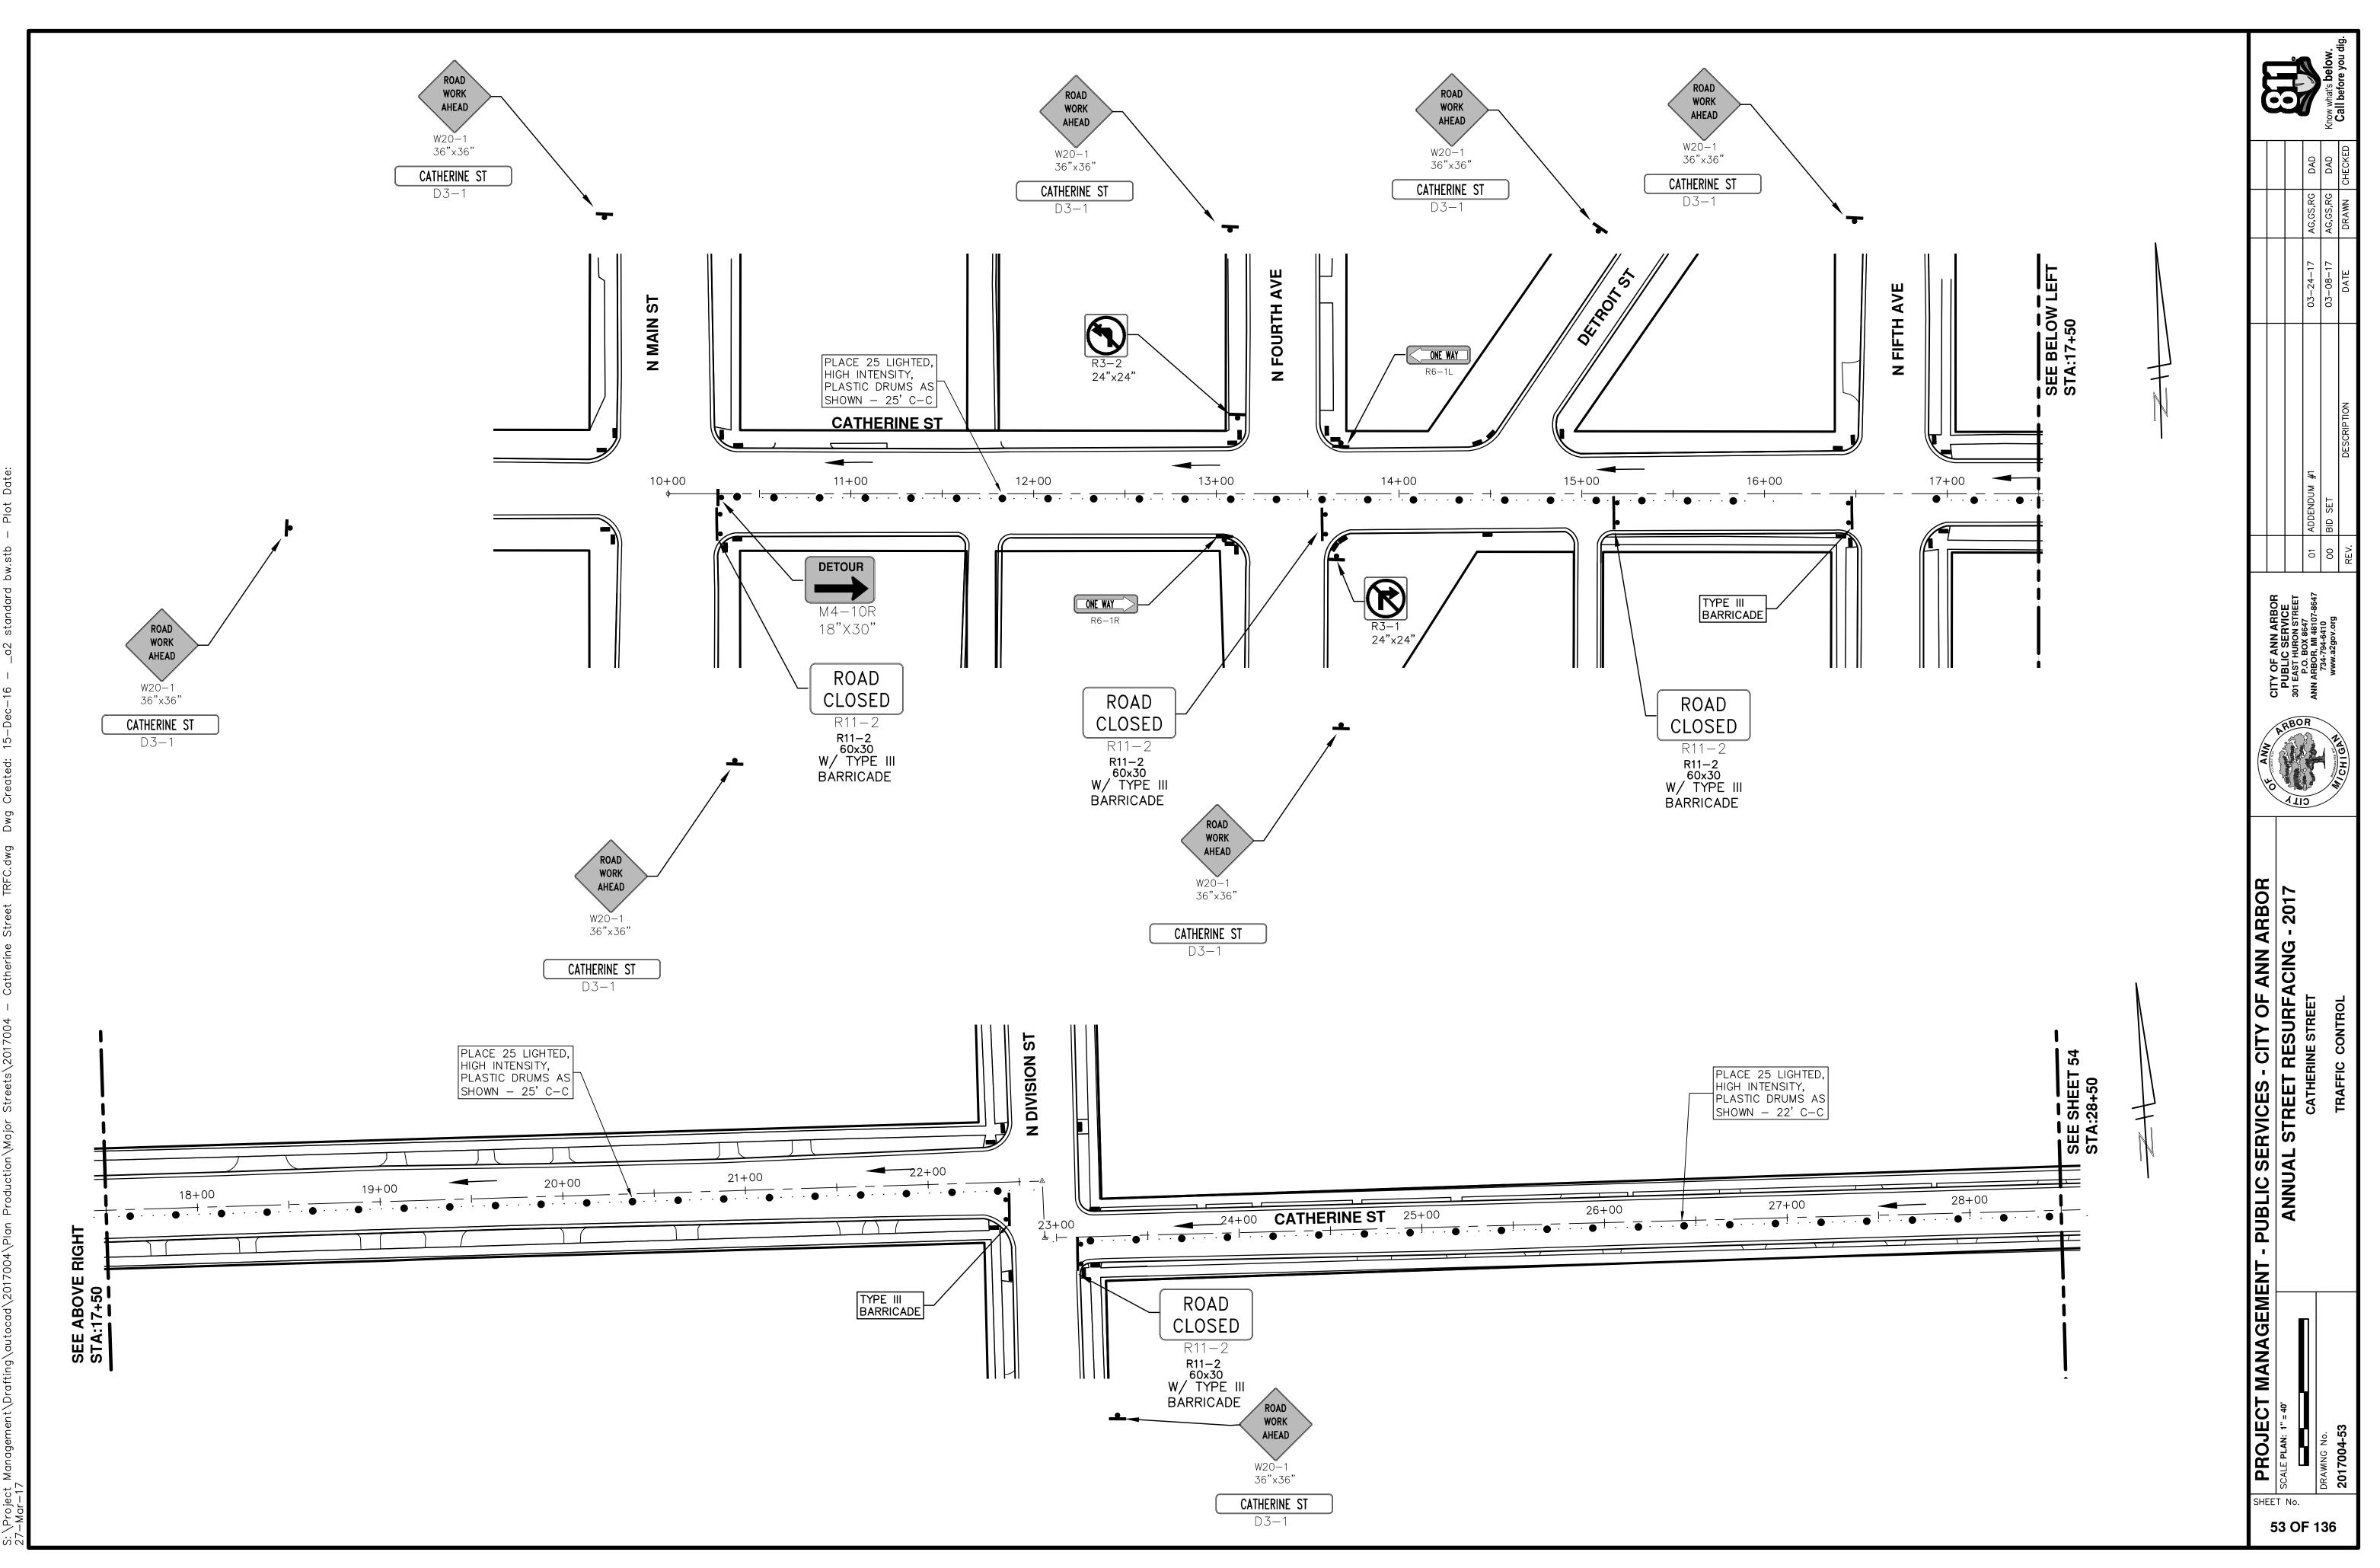


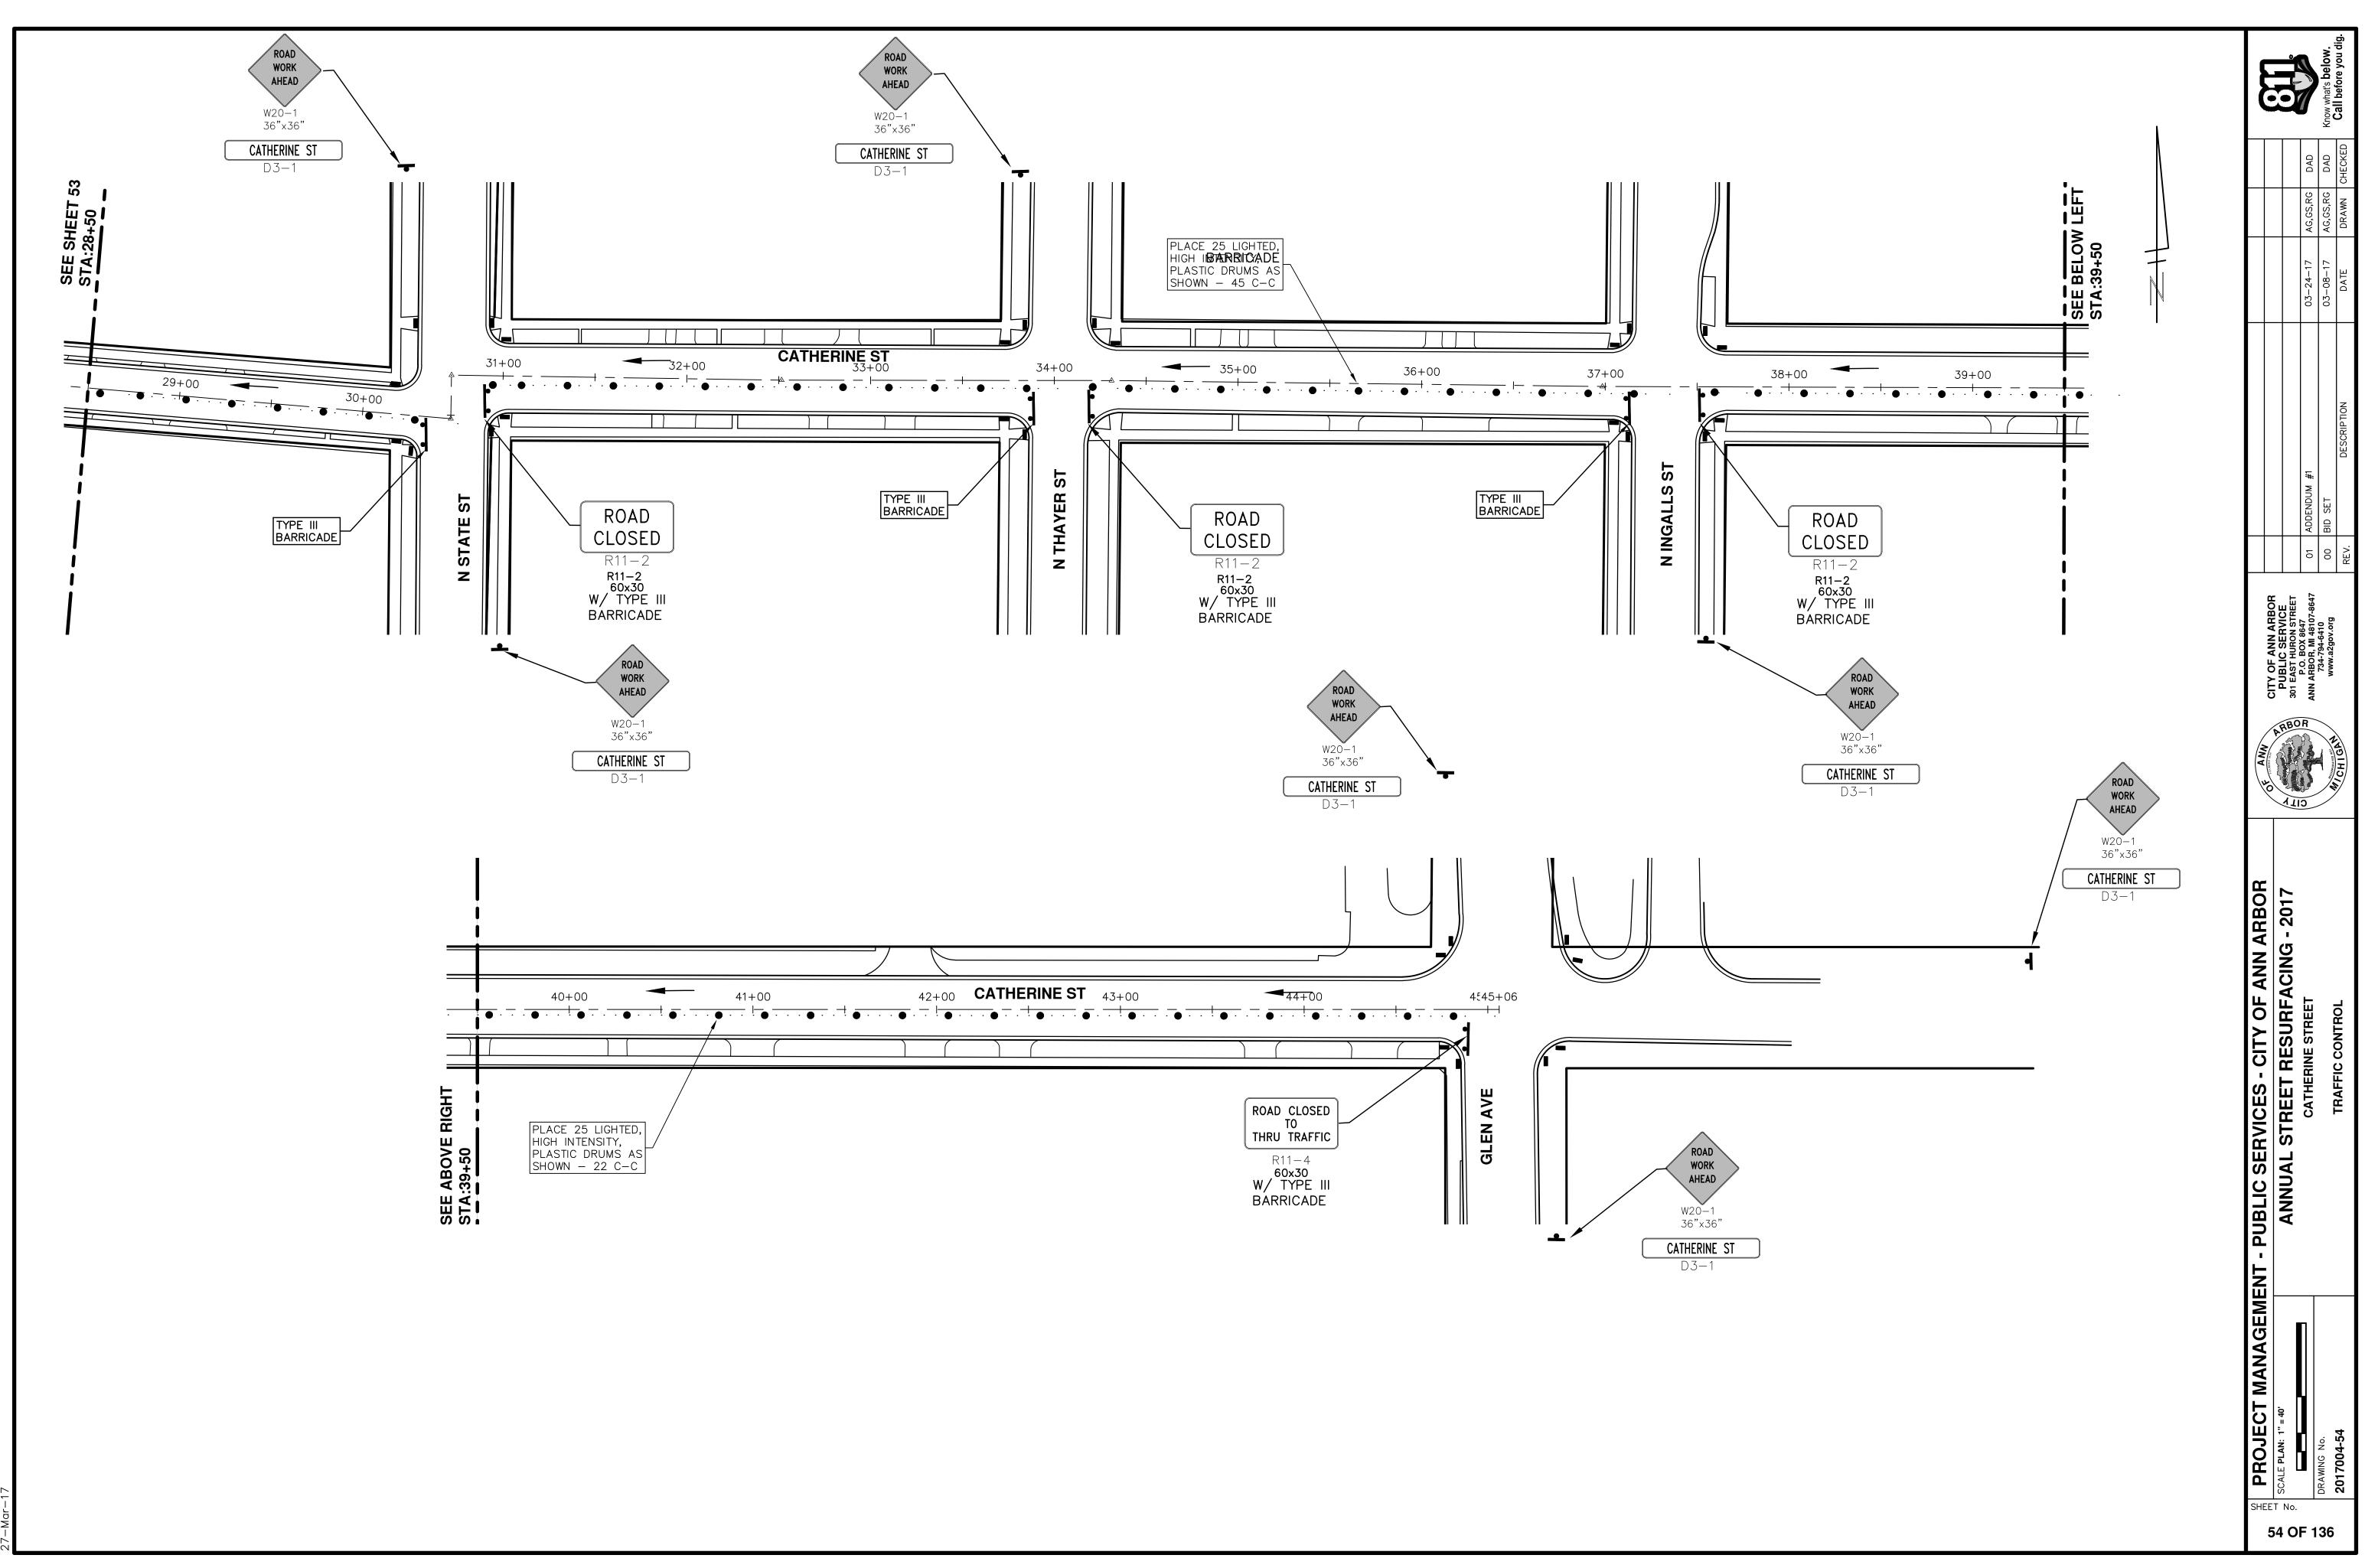


Da

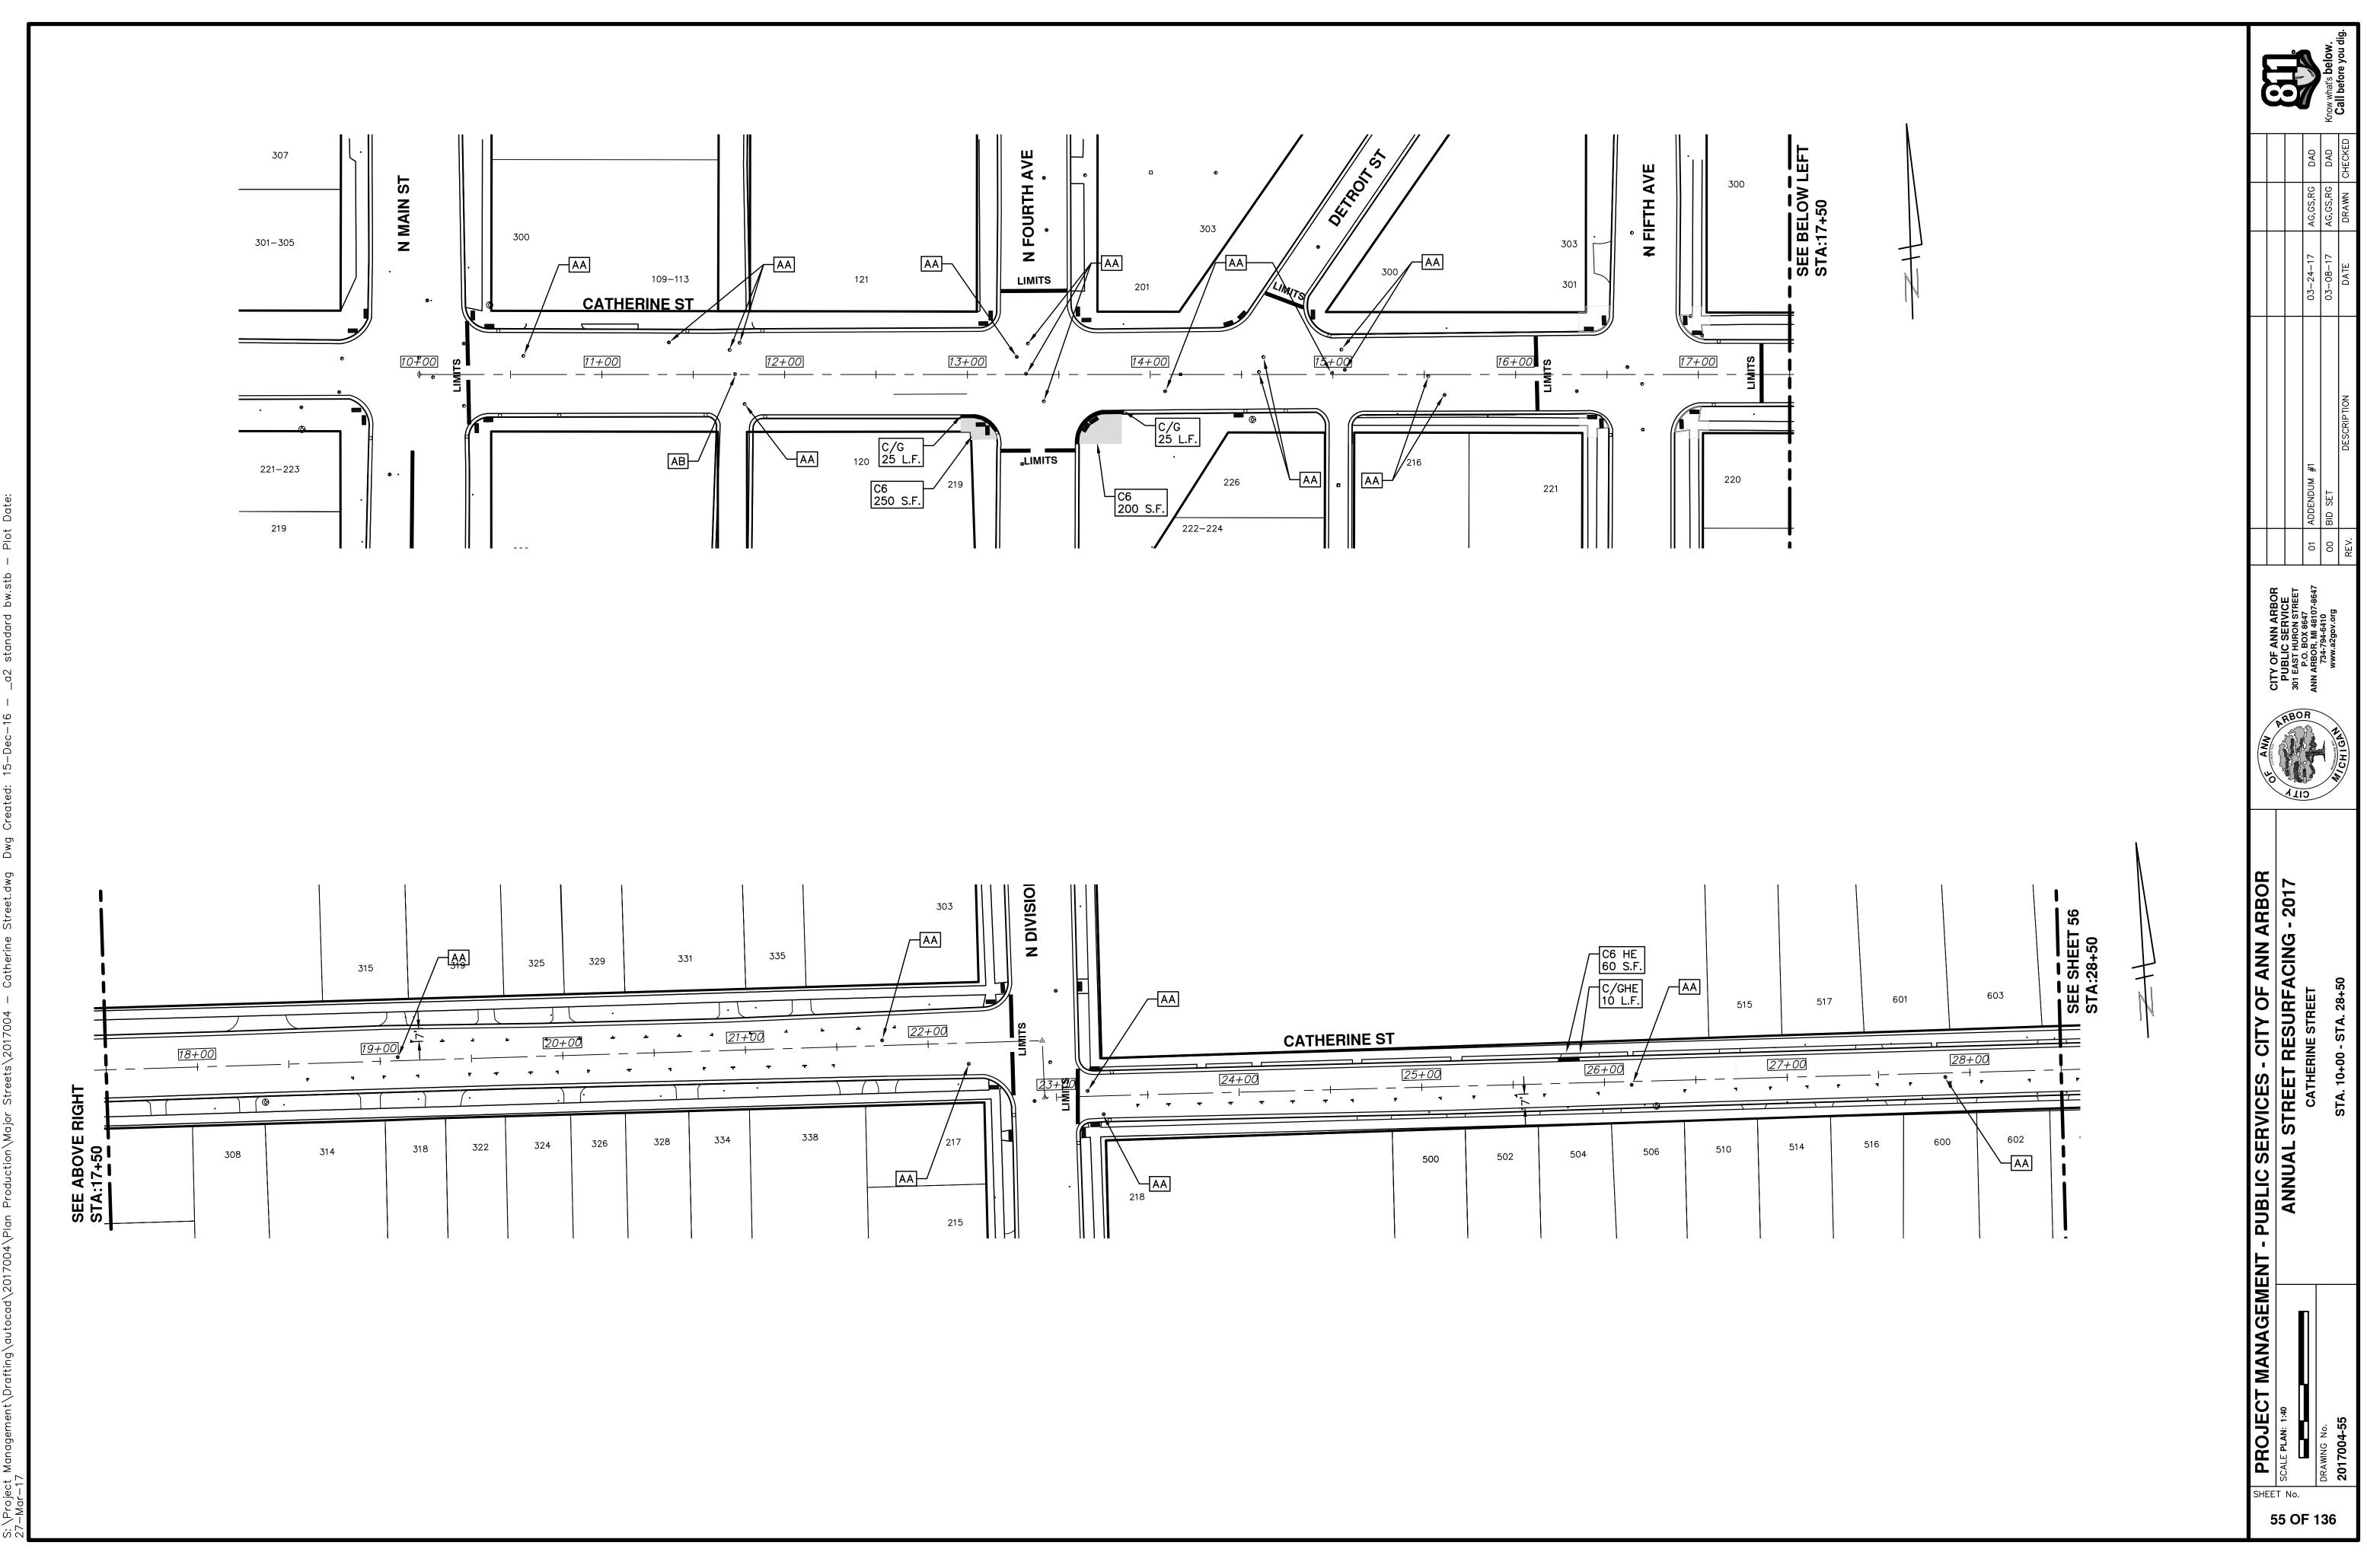



\Proje

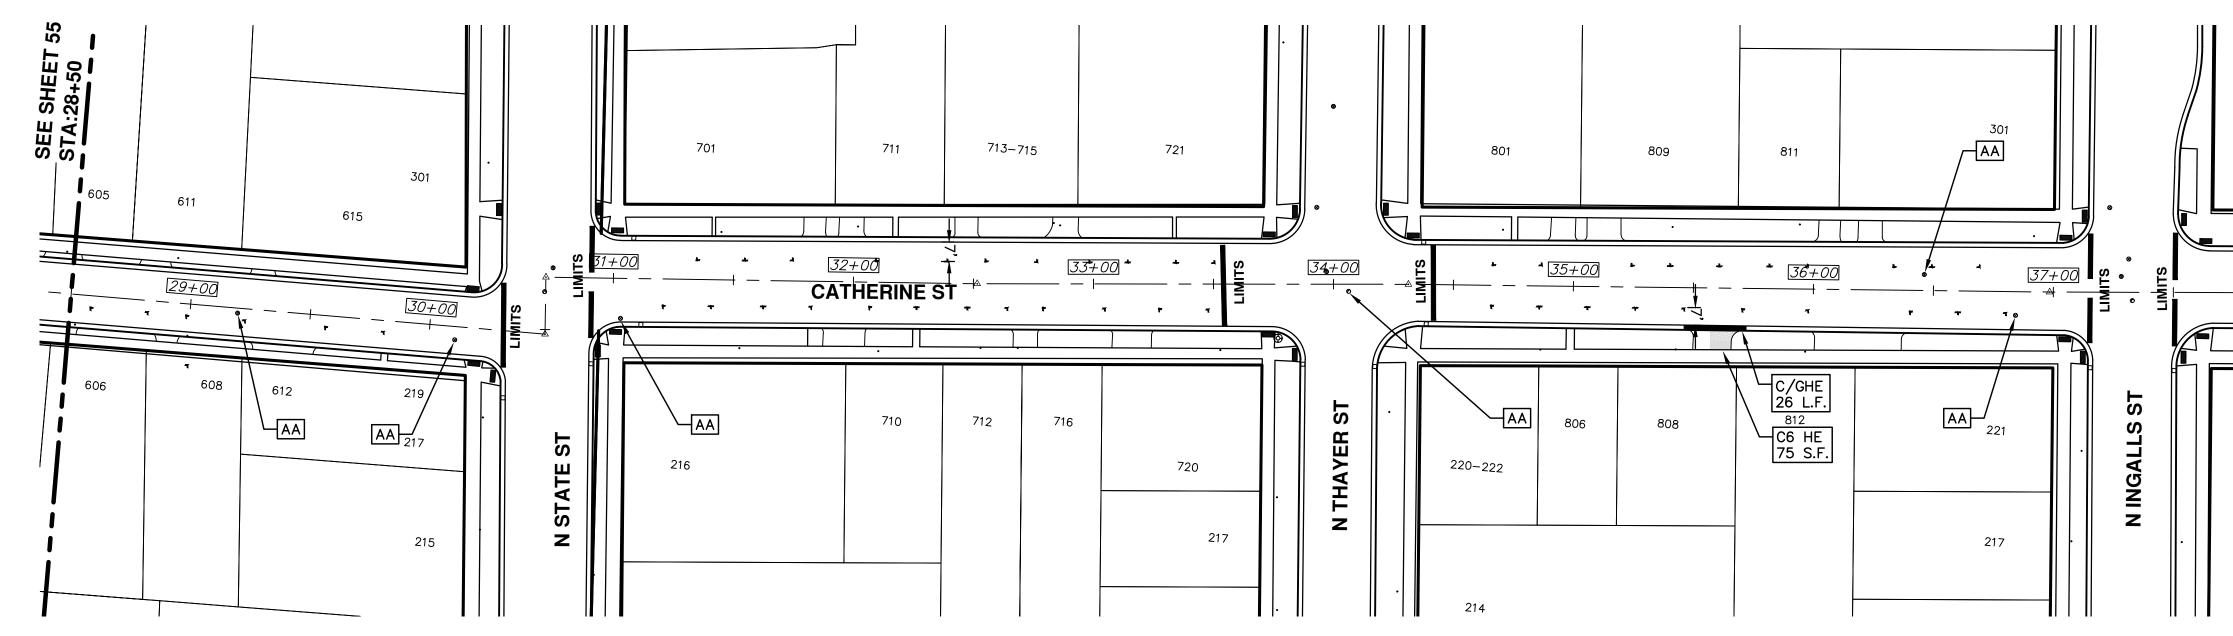

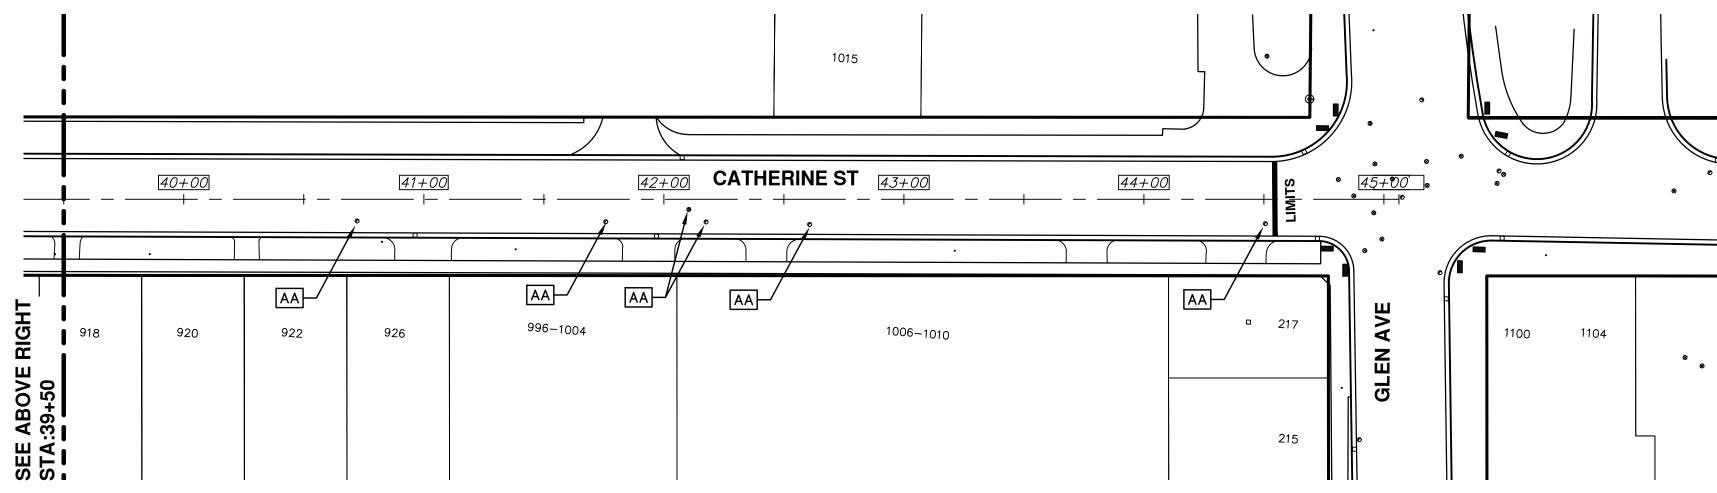





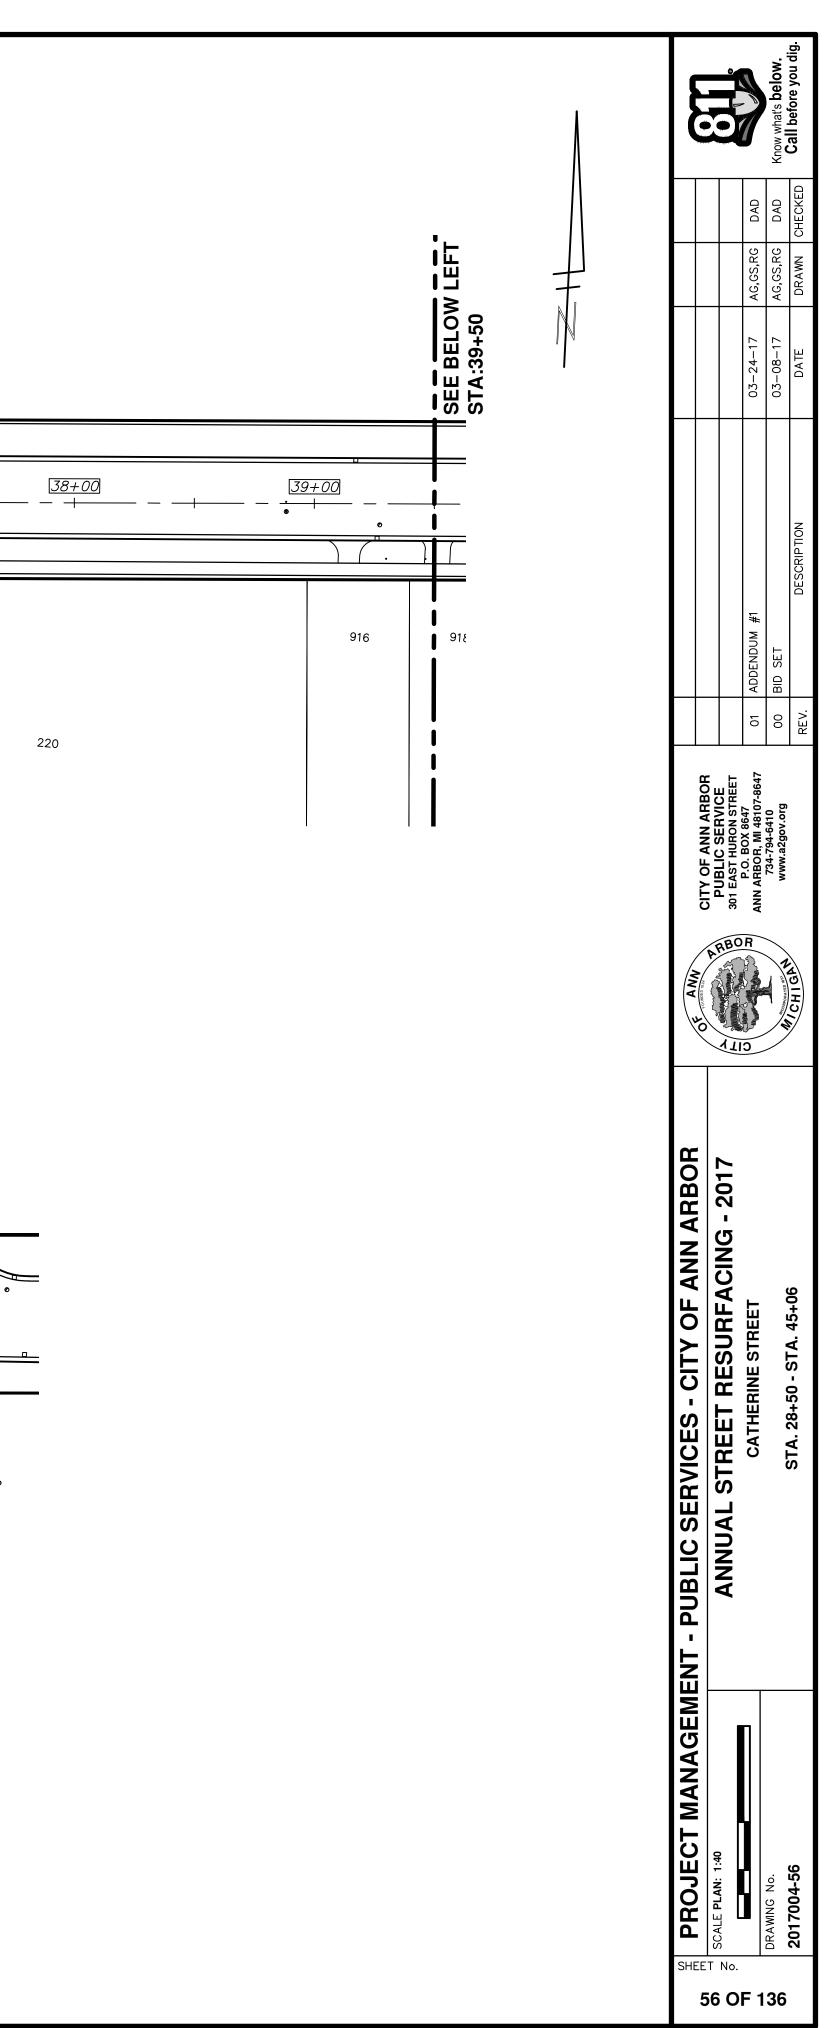

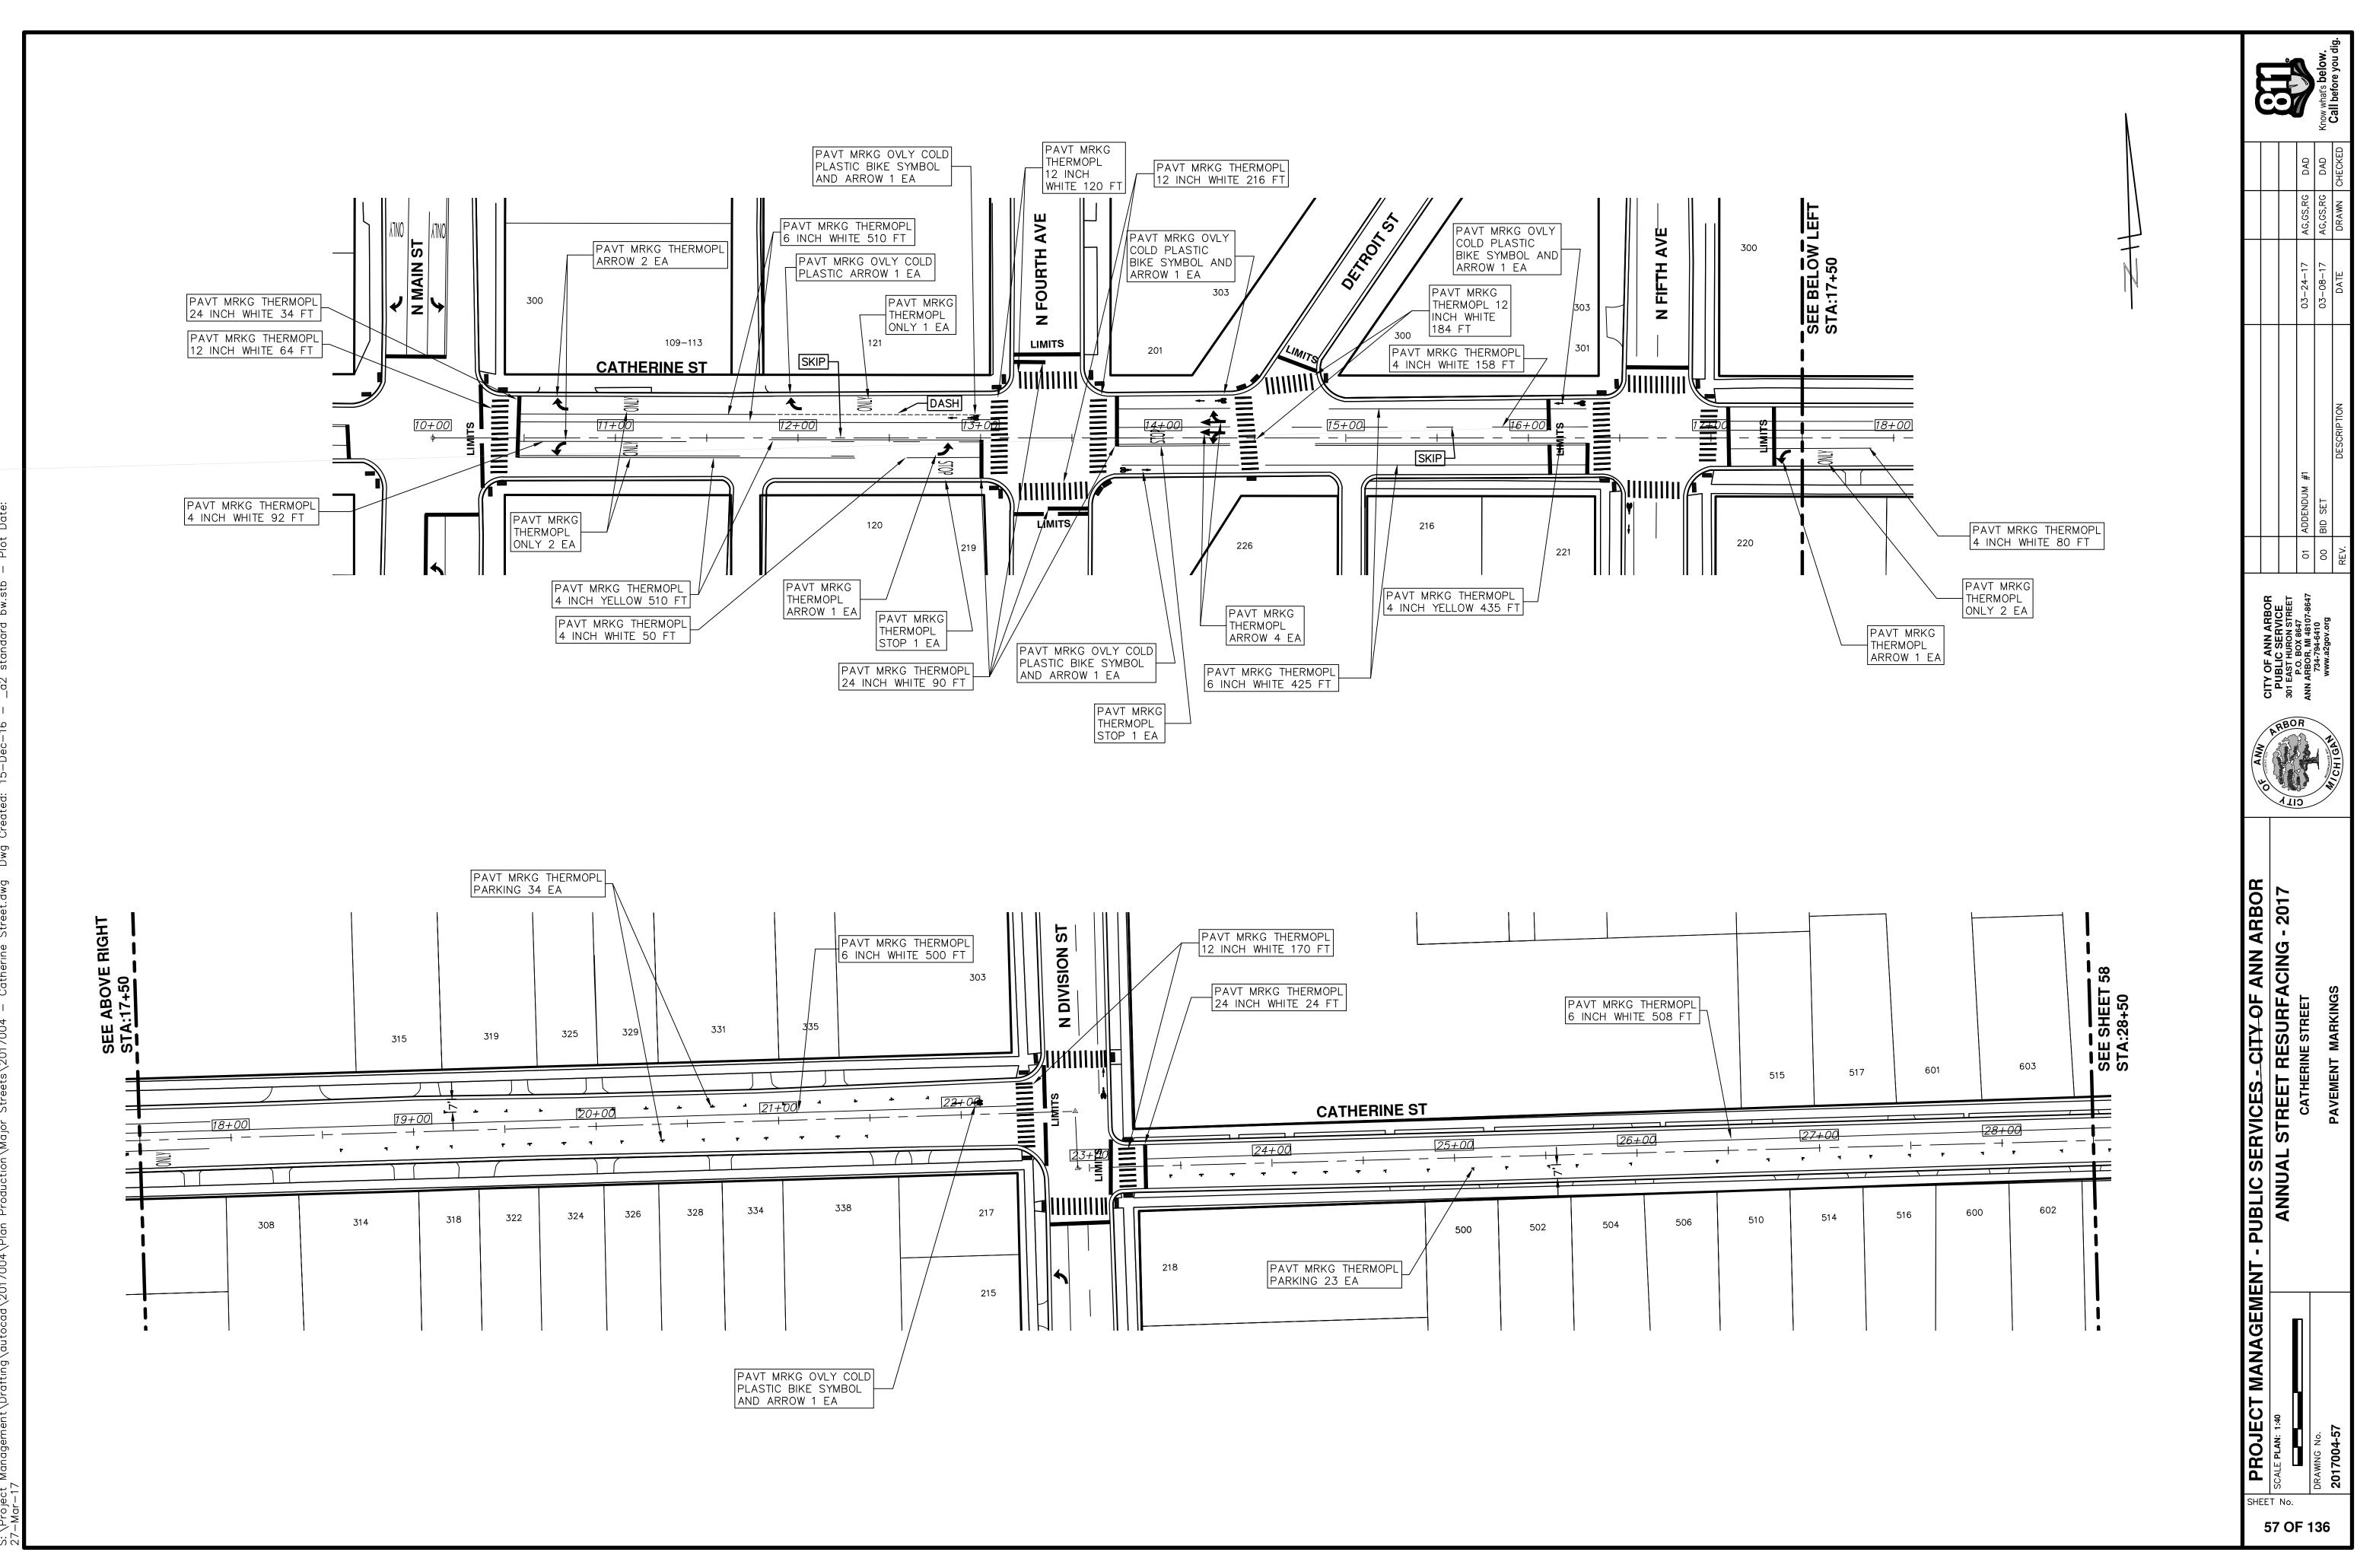


 \Box

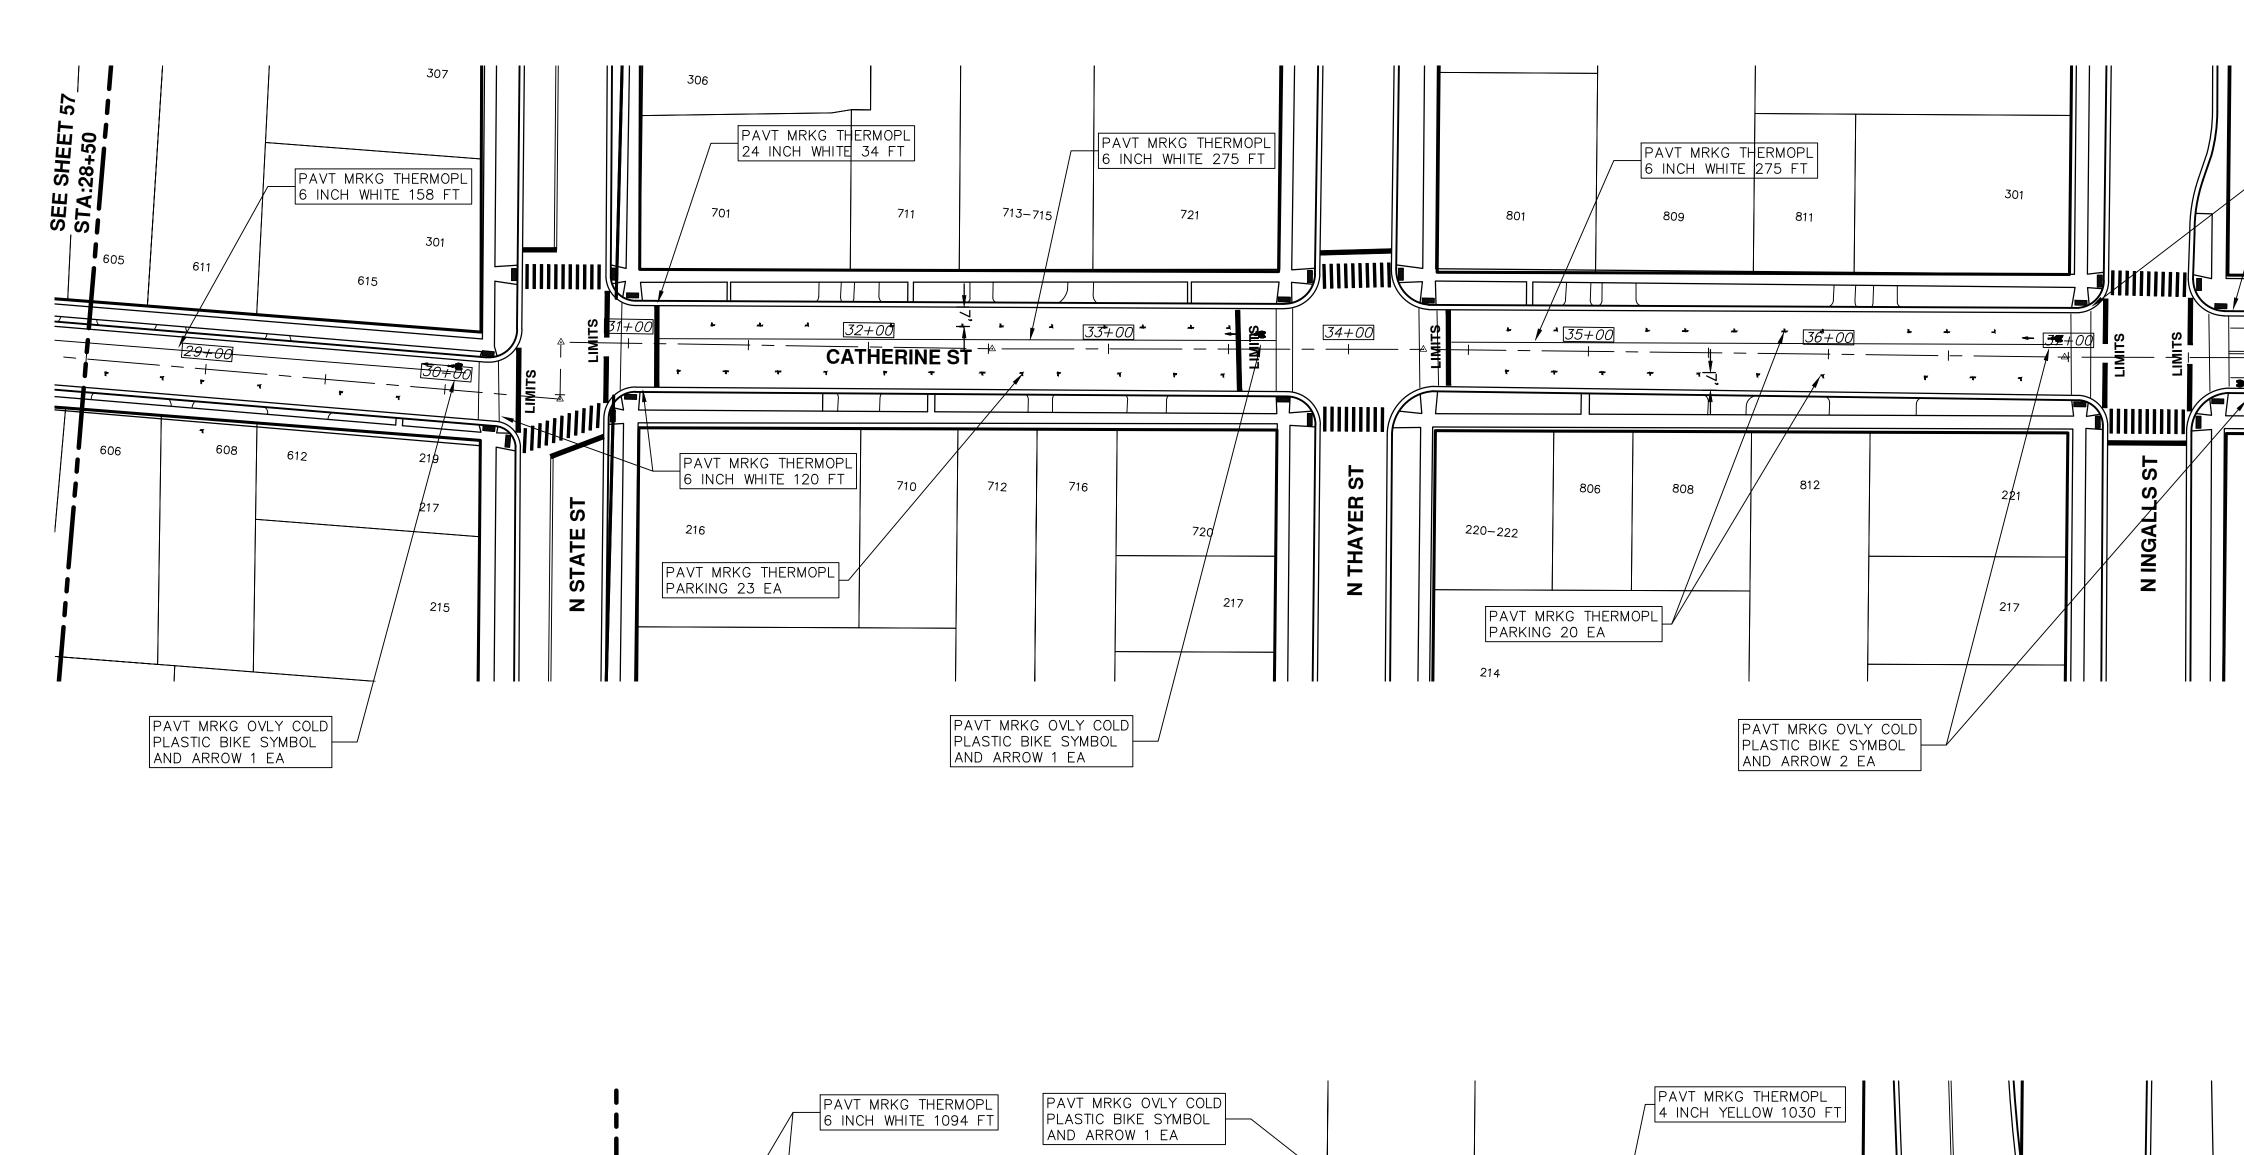

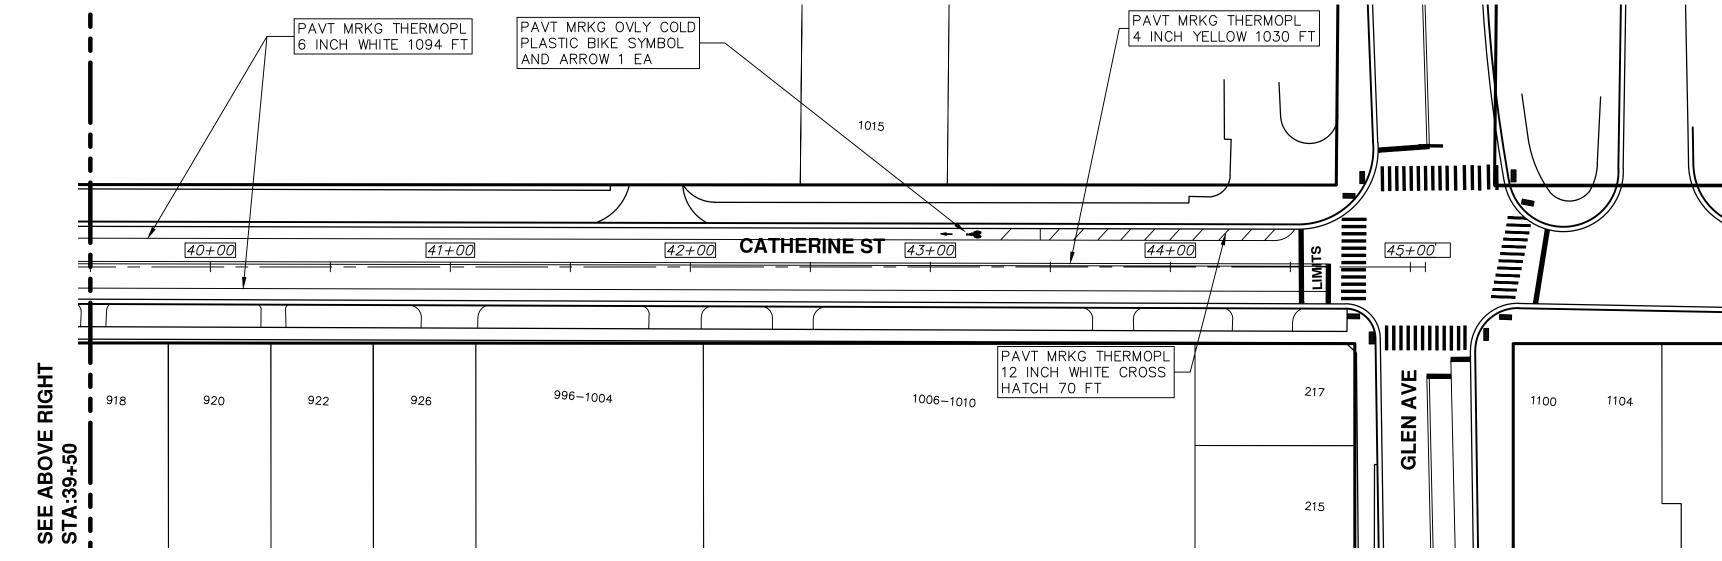

0

ல்

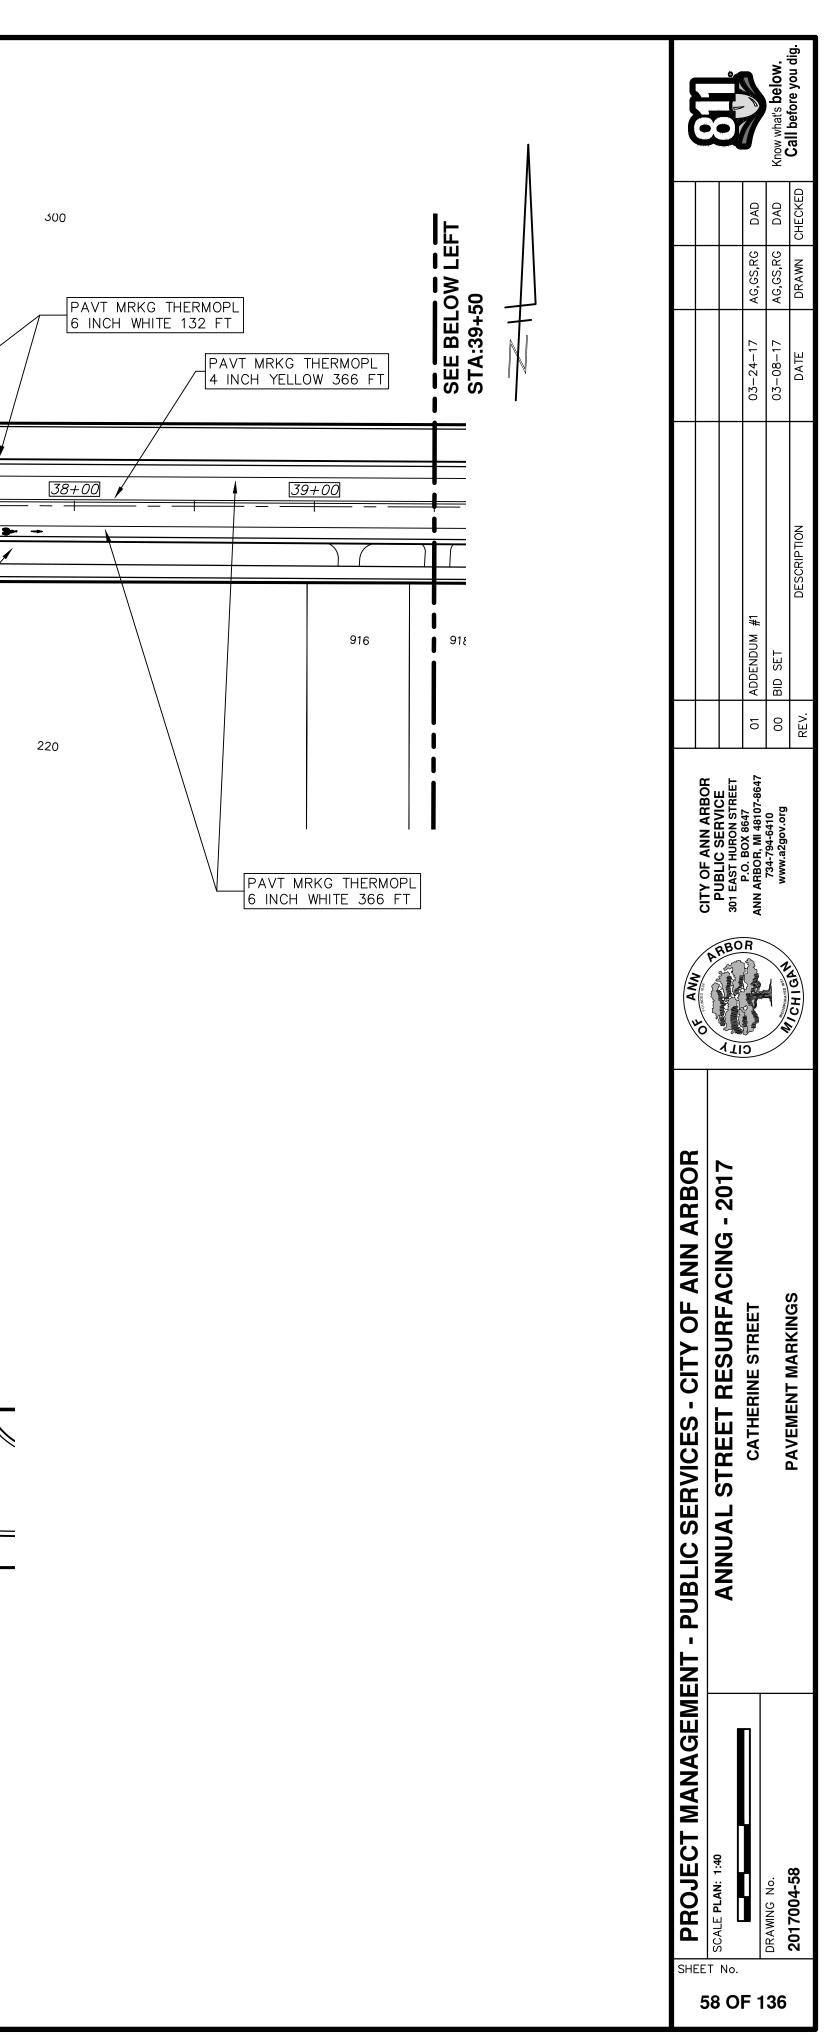



CITY OF ANN ARBOR PROJECT MANAGEMENT PROJECT LOCATION: CHURCH STREET

Item Code	Item Description	Units	Quantity
2047001	_Curb, Gutter, and Curb and Gutter, Any Type, Rem	Ft	40.000
2047011	_Sidewalk, Sidewalk Ramp, and Driveway Approach, Any Thickness, Rem	Syd	50.000
2080020	Erosion Control, Inlet Protection, Fabric Drop	Ea	6.000
5010003	Cold Milling HMA Surface	Ton	395.000
5010005	HMA Surface, Rem	Syd	9.000
5010703	HMA, LVSP	Ton	395.000
5017050	_HMA Surface, Around Structure Cover, Rem	Ea	14.000
6027021	_Flowable Fill	Cyd	1.481
8027001	_Curb and Gutter, Conc	Ft	40.000
8037001	_Detectable Warning Surface, Modified	Ft	10.000
8037010	_Sidewalk Ramp, Conc, 6 inch, Modified	Sft	150.000
8037010	_Sidewalk, Conc, 4 inch, Modified	Sft	300.000
8110520	Pavt Mrkg, Wet Retrflec, Thermopl, 4 inch, White	Ft	210.000
8110524	Pavt Mrkg, Wet Retrflec, Thermopl, 4 inch, Yellow	Ft	1,675.000
8117001	_Pavt Mrkg, Wet Retrflec, Thermopl, 12 inch, Crosswalk	Ft	288.000
8117001	_Pavt Mrkg, Wet Retrflec, Thermopl, 24 inch, Stop Bar	Ft	45.000
8117050	_Pavt Mrkg, Wet Retrflec, Thermopl, Thru and Lt Turn Arrow Sym	Ea	4.000
8117050	_Pavt Mrkg, Wet Retrflec, Thermopl, Thru and Rt Turn Arrow Sym	Ea	4.000
8120012	Barricade, Type III, High Intensity, Double Sided, Lighted, Furn	Ea	2.000
8120013	Barricade, Type III, High Intensity, Double Sided, Lighted, Oper	Ea	2.000
8120140	Lighted Arrow, Type C, Furn	Ea	2.000
8120141	Lighted Arrow, Type C, Oper	Ea	2.000
8120260	Plastic Drum, High Intensity, Lighted, Fum	Ea	45.000
8120261	Plastic Drum, High Intensity, Lighted, Oper	Ea	45.000
8120331	Sign, Portable, Changeable Message, Oper	Ea	2.000
8120350	Sign, Type B, Temp, Prismatic, Furn	Sft	377.000
8120351	Sign, Type B, Temp, Prismatic, Oper	Sft	377.000

KEY	ASSOCIATED PAY ITEM(S)
	_Dr Structure, Adj, Case 1, Modified
AA	_Dr Structure, Adj, Case 2, Modified
	_Dr Structure, Temp Lowering, Modified
	_Dr Structure, Temp Lowering, Modified
AB	• _Gate Box, Adj, Case 1
	• _Gate Box, Adj, Case 2
	Monument Box Adjust
ADST	_Dr Structure, Adj, Add Depth, Modified
AK	_Dr Structure, Adj, Case 1, Modified
	 _Sidewalk, Sidewalk Ramp, and Driveway Approach, Any Thickness, Rem
C4	 _Grading, Sidewalk
	_Sidewalk, Conc, 4 inch, Modified
C4HE	• _Sidewalk, Sidewalk Ramp, and Driveway Approach, Any Thickness, Rem
	 _Grading, Sidewalk
	Cement
	_Sidewalk, Conc, 4 inch, Modified
	• _Sidewalk, Sidewalk Ramp, and Driveway Approach, Any Thickness, Rem
	• _Grading, Sidewalk
C6	 _Grading, Sidewalk Ramp
00	Detectable Warning Surface, Modified
	 _Sidewalk Ramp, Conc, 6 inch, Modified
	_Sidewalk, Conc, 6 inch, Modified
C8	 _Grading, Driveway Approach
00	Driveway, Nonreinf Conc, 8 inch, Modified
	 _Sidewalk, Sidewalk Ramp, and Driveway Approach, Any Thickness, Rem
	 _Grading, Driveway Approach
	• _Grading, Sidewalk
	_Grading, Sidewalk Ramp
C HE	Cement
OTIL	 _Driveway, Nonreinf Conc, 6 inch, Modified
	 _Driveway, Nonreinf Conc, 8 inch, Modified
	 _Detectable Warning Surface, Modified
	 _Sidewalk Ramp, Conc, 6 inch, Modified
	 _Sidewalk, Conc, 6 inch, Modified
C/G	 _Curb, Gutter, and Curb and Gutter, Any Type, Rem
0/0	_Curb and Gutter, Conc
	 _Curb, Gutter, and Curb and Gutter, Any Type, Rem
C/GHE	Cement
	 _Driveway Opening, Conc, Det M, Modified
CP	 _Grading, Sidewalk
0	 _Sidewalk, Conc, 4 inch, Modified
CR	 _Sidewalk, Sidewalk Ramp, and Driveway Approach, Any Thickness, Rem
	Dr Structure, Rem
DS	Sewer, Rem, Less than 24 inch
	Dr Structure, 24 inch dia
	Dr Structure, Rem
DSDI	Sewer, Rem, Less than 24 inch
	_Dr Structure, Double Inlet
PT	_Dr Structure, Point
	Dr Structure Cover, Type B
RRA	_Dr Structure Cover, Type B, Special
	 _Dr Structure, Adj, Case 1, Modified
	Dr Structure, Temp Lowering, Modified
	Dr Structure Cover, Type K
RRK	_Dr Structure, Adj, Case 1, Modified
RS	_Dr Structure, Reconstruct
	Plastic Drum, High Intensity, Lighted, Furn
YPE II	Plastic Drum, High Intensity, Lighted, Oper
	Barricade, Type III, High Intensity, Double Sided, Lighted, Furn
YPE III	

ITB No. 4477 FILE No. 2017-004

	LEGEND		
SYMBOL	DESCRIPTION		
S	EXISTING SANITARY SEWER MANHOLE		
(r)	EXISTING STORM SEWER MANHOLE		
\otimes	EXISTING WATER MAIN VALVE IN WELL		
+	WATER MAIN GATE VALVE IN BOX		
+Q+	FIRE HYDRANT		
9	MICHCON GAS CO. VALVE BOX/WELL		
t	AMERITECH TELEPHONE VAULT		
e	ELECTRIC MANHOLE		
•	SOIL BORING		
	EXISTING STORM SEWER INLET		
٥	MONUMENT BOX		
	REMOVE AND REPLACE CONC. SIDEWALK		
	PLACE CONCRETE SIDEWALK		
	REMOVE & REPLACE CONC. CURB & GUTTER		
	CONSTRUCTION LIMITS		
	6" WRAPPED UNDERDRAIN		
	REMOVE CONCRETE SIDEWALK		
	SUBGRADE UNDERCUT		

Quantity | Sign Code | Description

D3-1

R5-1

SP-1

Street Name Sign

M4-10R |Detour Arrow (Right) Sign

M4-9L Detour Sign (w/Left Arrow)

M4-9R |Detour Sign (w/Right Arrow)

M4-9S |Detour Sign (w/Thru Arrow)

Do Not Enter Sign

R11-2 Road Closed Sign ("Road Closed")

R11-4 Road Closed Sign ("Road Closed To Thru Traffic")

M4-8a End Detour Sign

R5-1A Wrong Way Sign

W20-2 Detour Ahead

Special Sign

W20-3 Road Closed Ahead

W20-1 Road Work Ahead Sign

26.0

1.0

1.0

5.0

1.0

10.0

2.0

2.0

1.0

1.0

2.0

5.0

3.0

3.0

QUANTITIES

Sign, Type B, Temp, Prismatic

CONSTRUCTION METHOD AND SEQUENCING

WORK ON THIS STREET INCLUDES, E ACCORDANCE WITH THE PLANS AND TWO (2) PHASE CONSTRUCTION. PI AUTHORIZED OR DIRECTED BY THE CURRENTLY IN PLACE, LANE CLOSURE

- PHASE
- 1. IMPLEMENT MAINTENANCE OF TRA CONTROL MEASURES.
- 2. CONDUCT REMOVAL WORK RELATE COLDMILLING.
- 3. INSTALL PROPOSED DRAINAGE STR
- 4. PERFORM ALL CONCRETE WORK,
- 5. REMOVE 2 INCHES OF EXISTING I
- 6. PERFORM ALL JOINT AND CRACK REQUIRED.
- 7. CLEAN PAVEMENT AND PLACE 2

<u>PHASE II</u>

- 8. REPEAT ITEMS 1 THRU 4 IN THE
- 9. REMOVE 2 INCHES OF EXISTING H
- 10. PERFORM ALL JOINT AND CRACK REQUIRED.
- 11. CLEAN PAVEMENT AND PLACE 2
- 12. CLEAN PAVEMENT AND PLACE HM
- 13. CLEAN PAVEMENT AND COMPLETE
- 14. COMPLETE ALL MISCELLANEOUS CO
- 15. REMOVE ALL TRAFFIC CONTROL DI

Area (sft)

4.000 6.000

3.000

5.000

5.000

5.000

6.250

6.000

8.000

12.500

20.000

9.000

9.000

9.000

TOTAL

Total

Area 104.000

6.000

3.000

25.000

5.000

50.000

12.500

12.000

8.000

12.500

40.000

45.000

27.000

27.000 377.000



ANN ARBOR, MICHIGAN 48107-8647

734-794-6410 www.a2gov.org




SHEET No.

2017004-


STRE

R


HUR

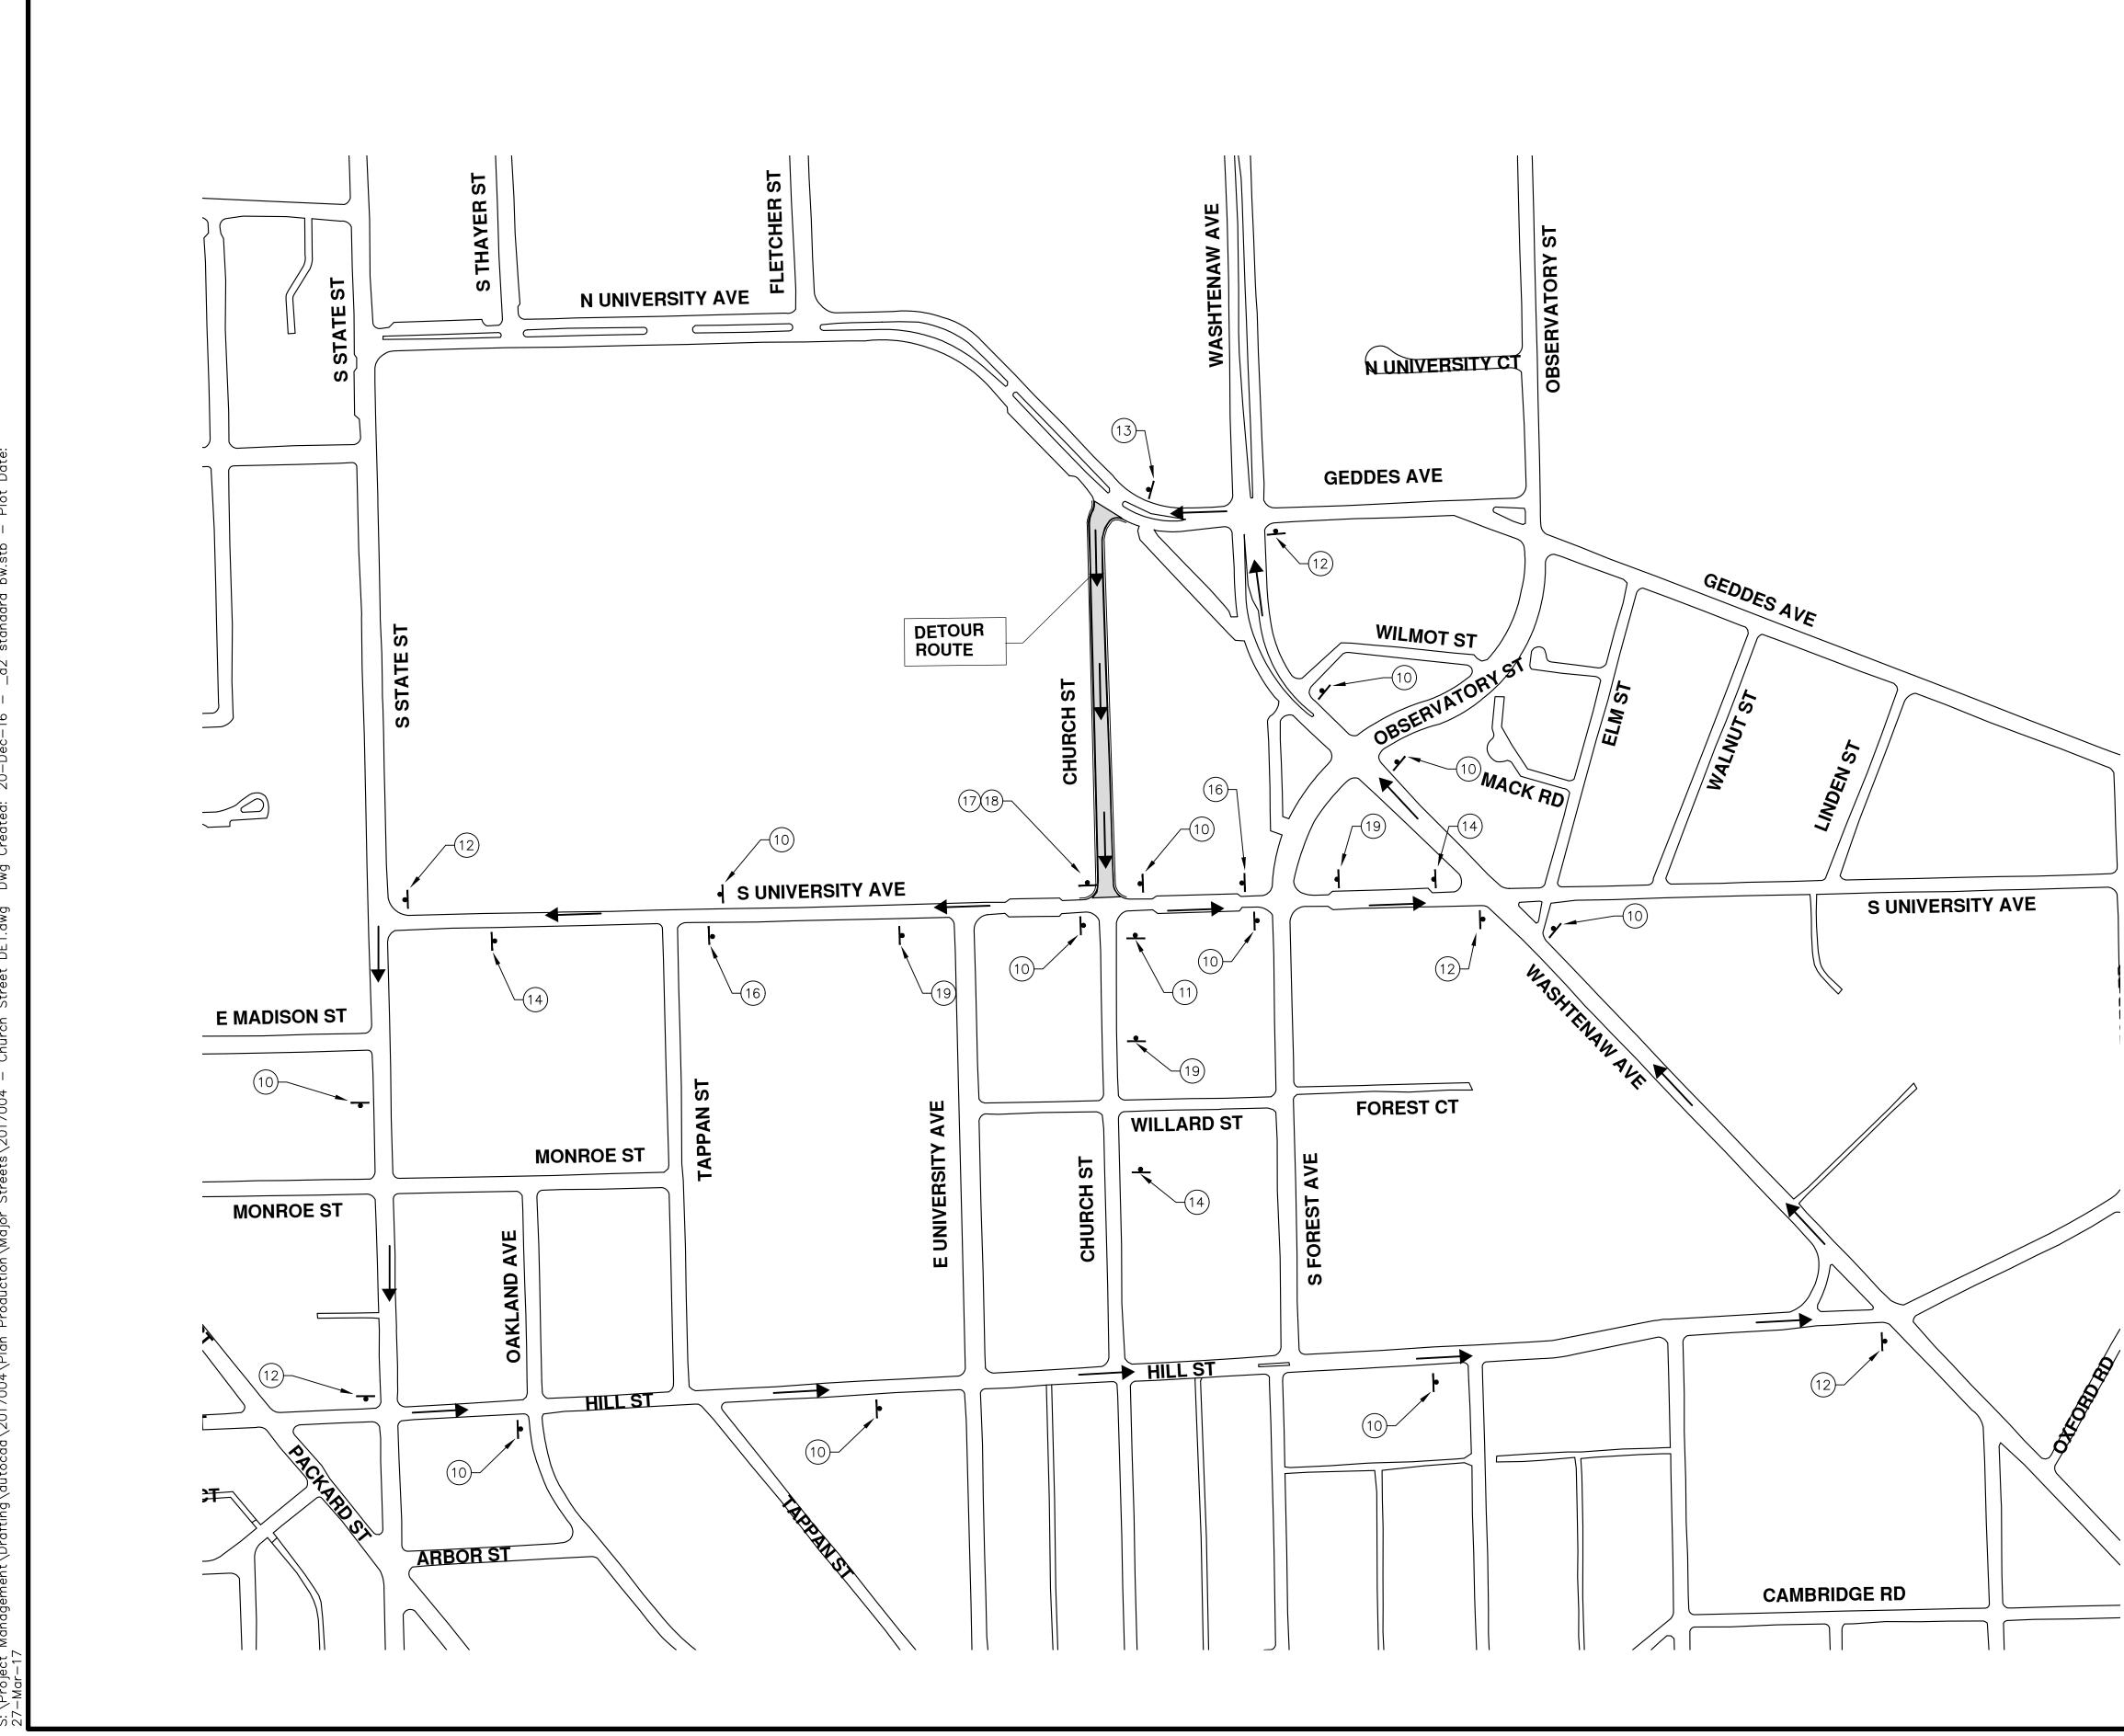



TR	AFFIC CONTRO	L SIGN
TAG	SIGN	NUM.
	CHURCH ST	D3—1
10	DETOUR	M4-9S 30x24
	CHURCH ST	D3—1
11		M4-9R 30x24
	CHURCH ST	D3—1
12		M4-9L 30x24
	CHURCH ST	D3-1
13	DETOUR ENDS	M4—8a 24X18
(14)	NORTH BOUND CHURCH ST CLOSED AT SOUTH UNVERSITY	SPECIAL 48x60
(15)	CHURCH ST CLOSED	SPECIAL 48x60
(16)	DETOUR AHEAD W20-2 36"x36" CHJRCH ST D3-1	W20-2 36"X36"
17	DO NOT BNTER R5-1 30x30	R5–1 30"X30"
(18)	WRONG WAY	R5–1A 42"x30"
(19)	ROAD CLOSED AHEAD W20-3 36"×36" CHURCH ST D3-1	W20-3 36"X36"

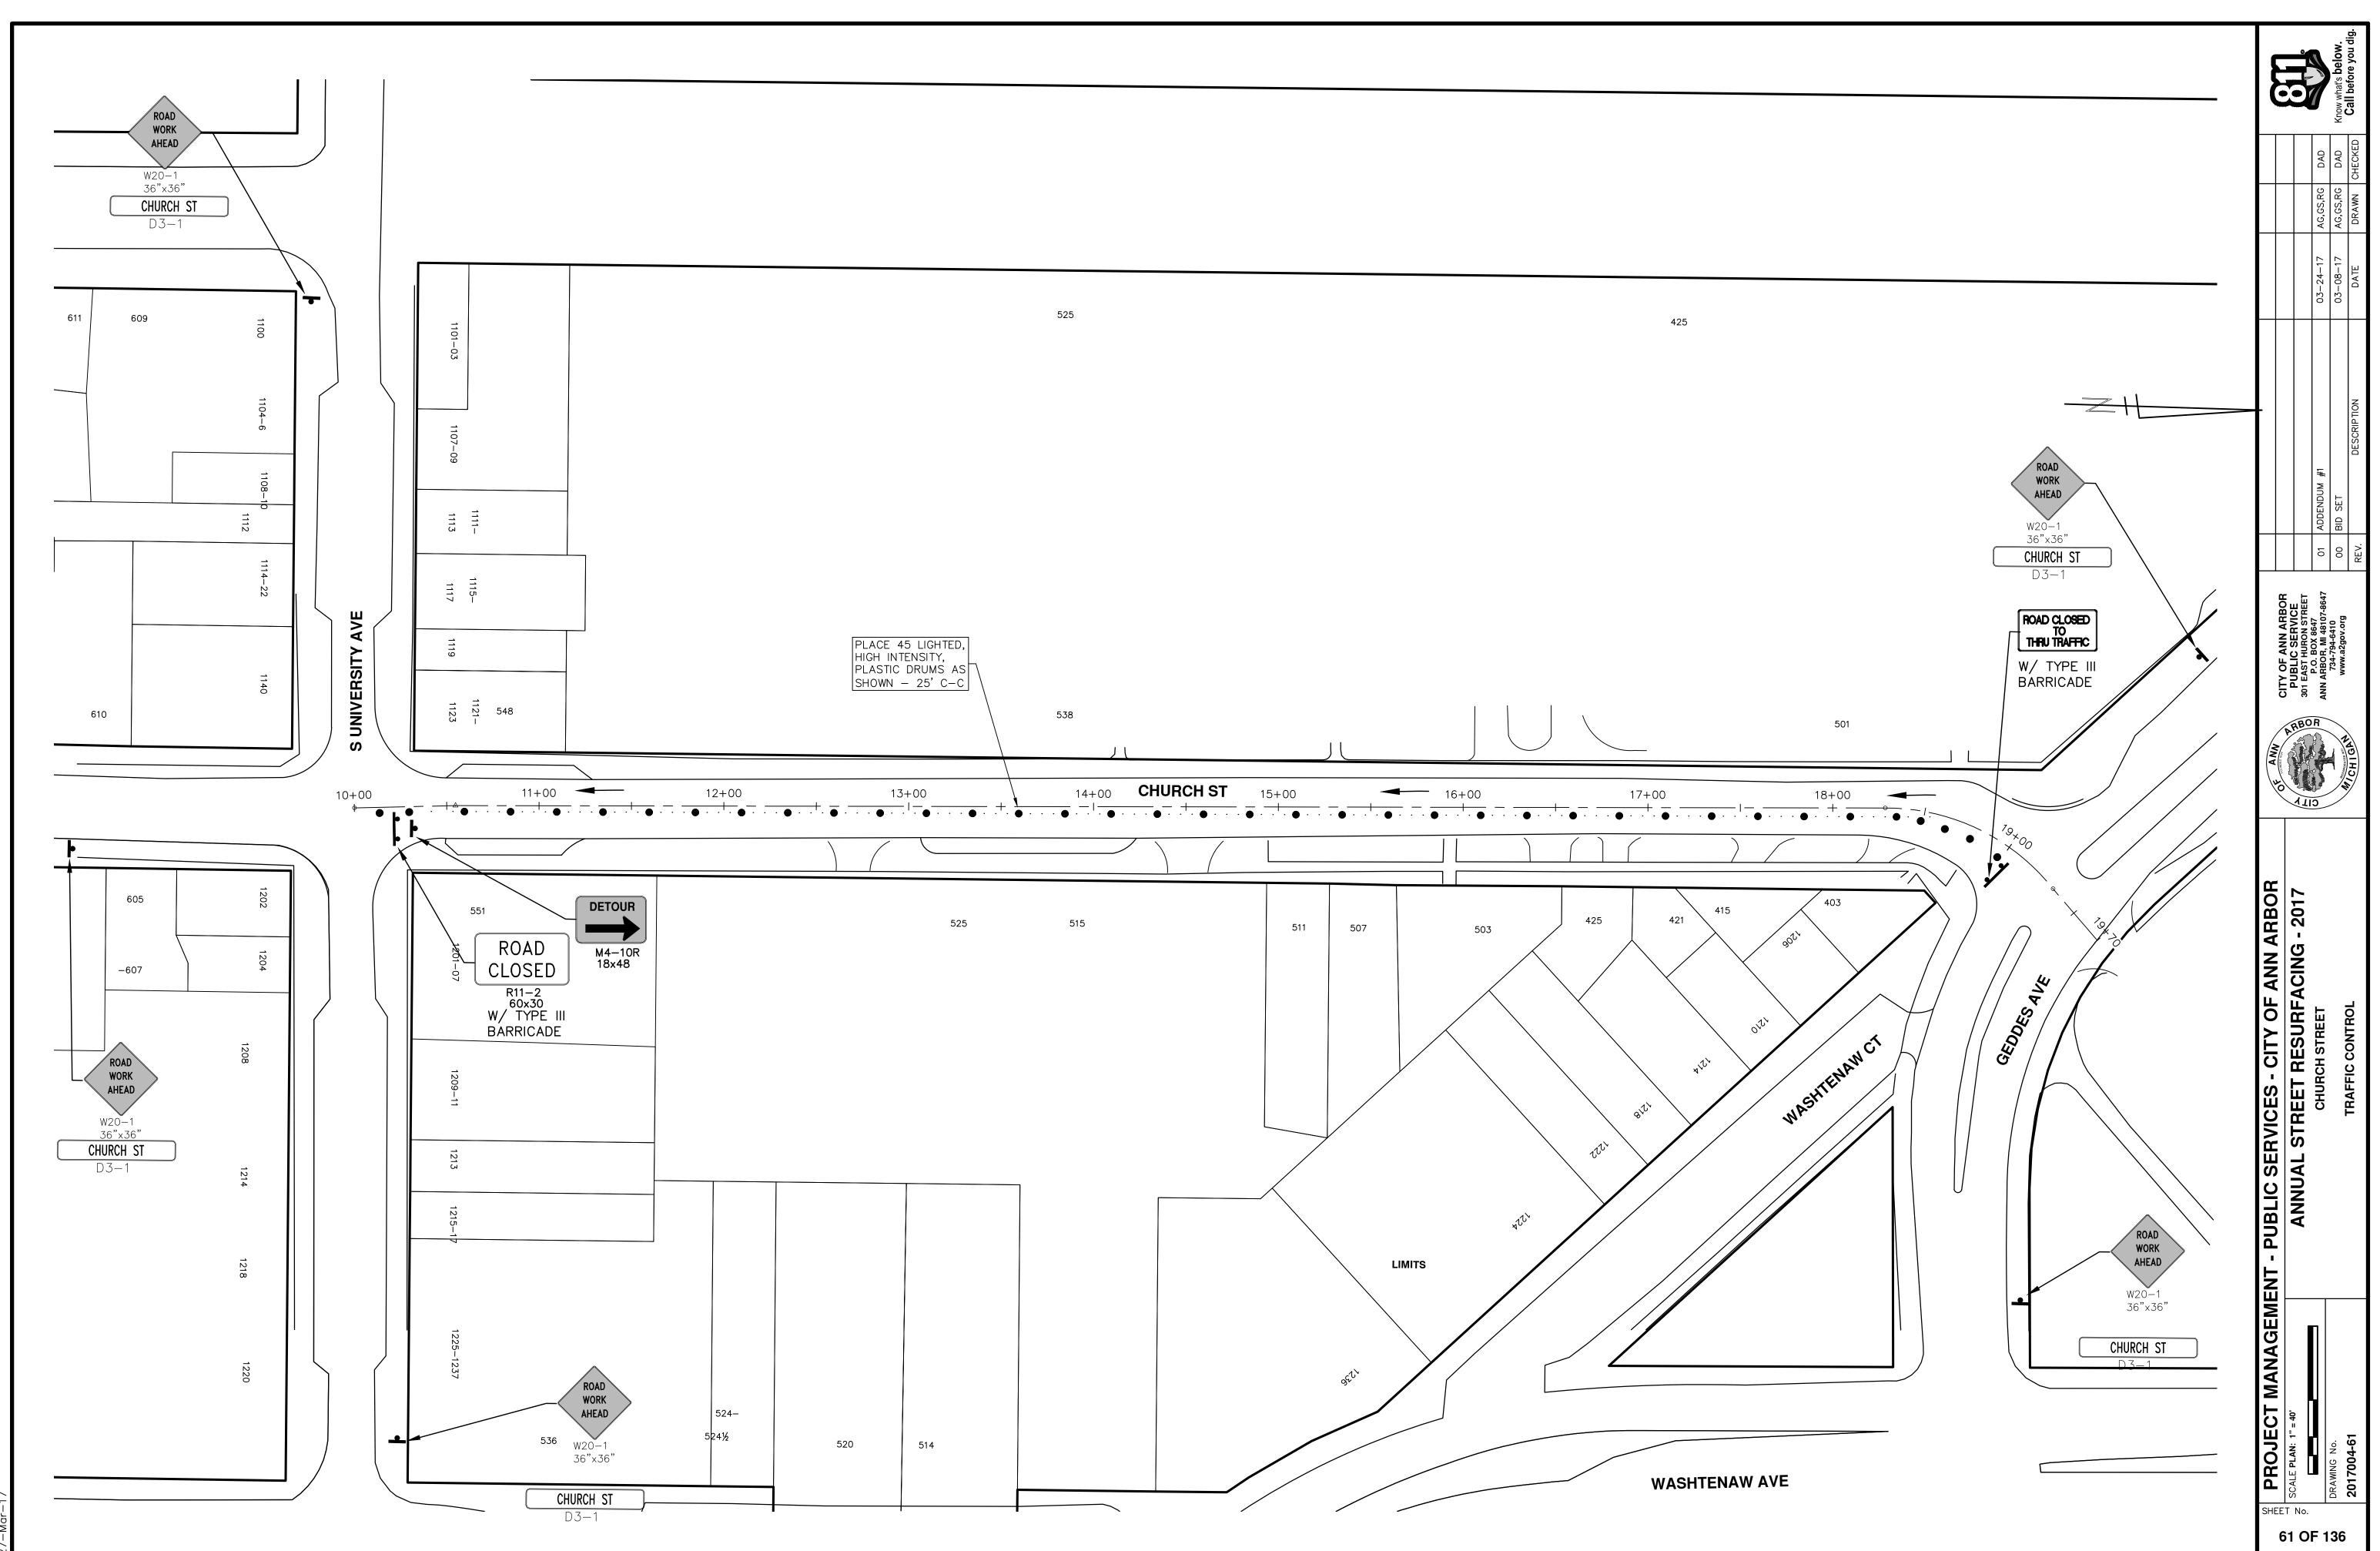

 \Box ∖Proje '-Mari iii

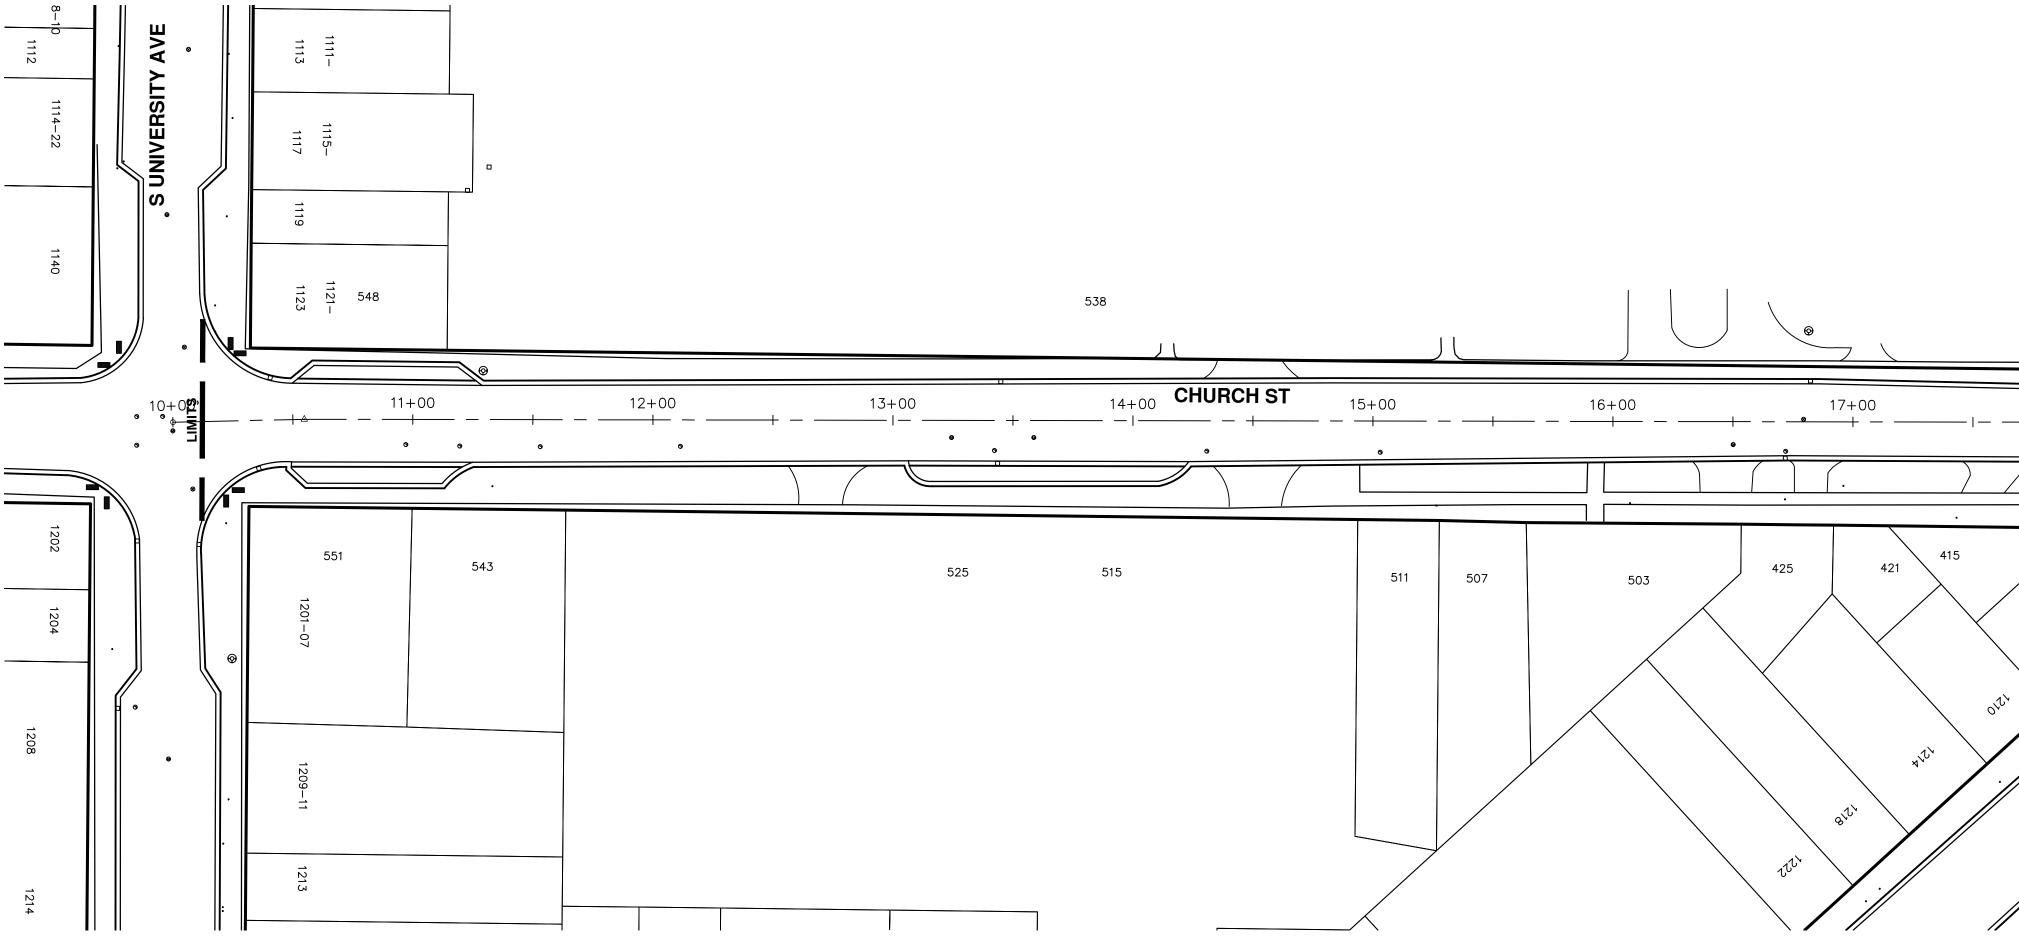

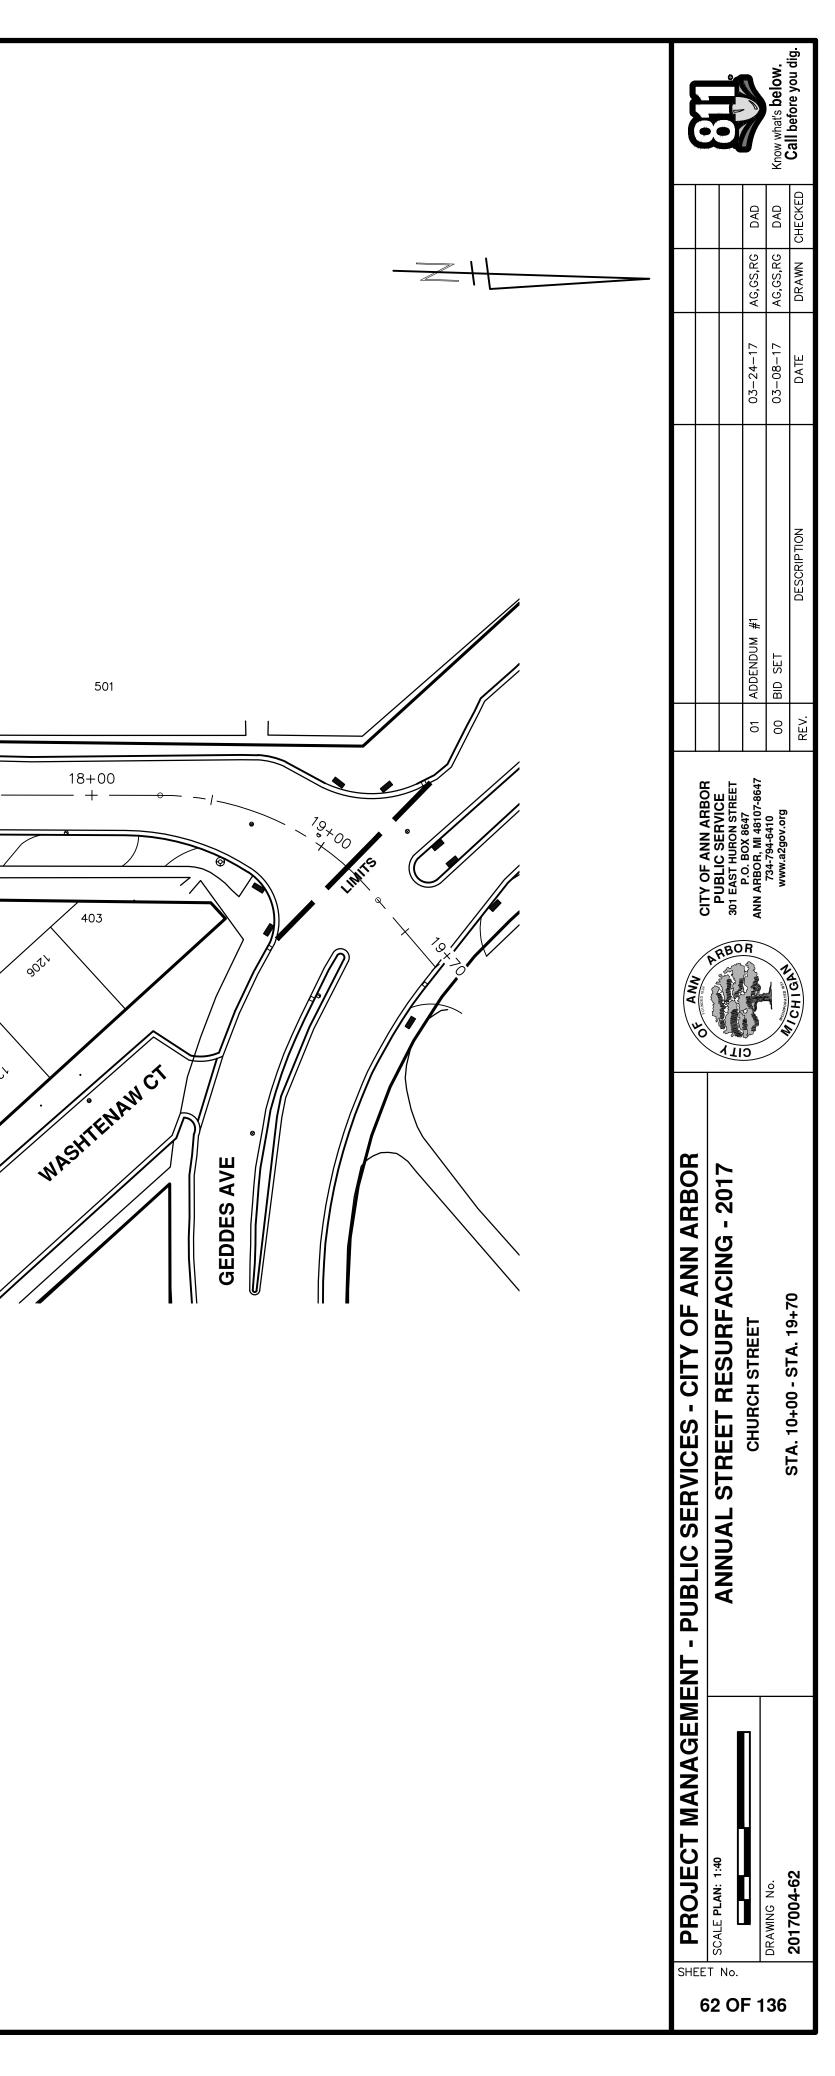

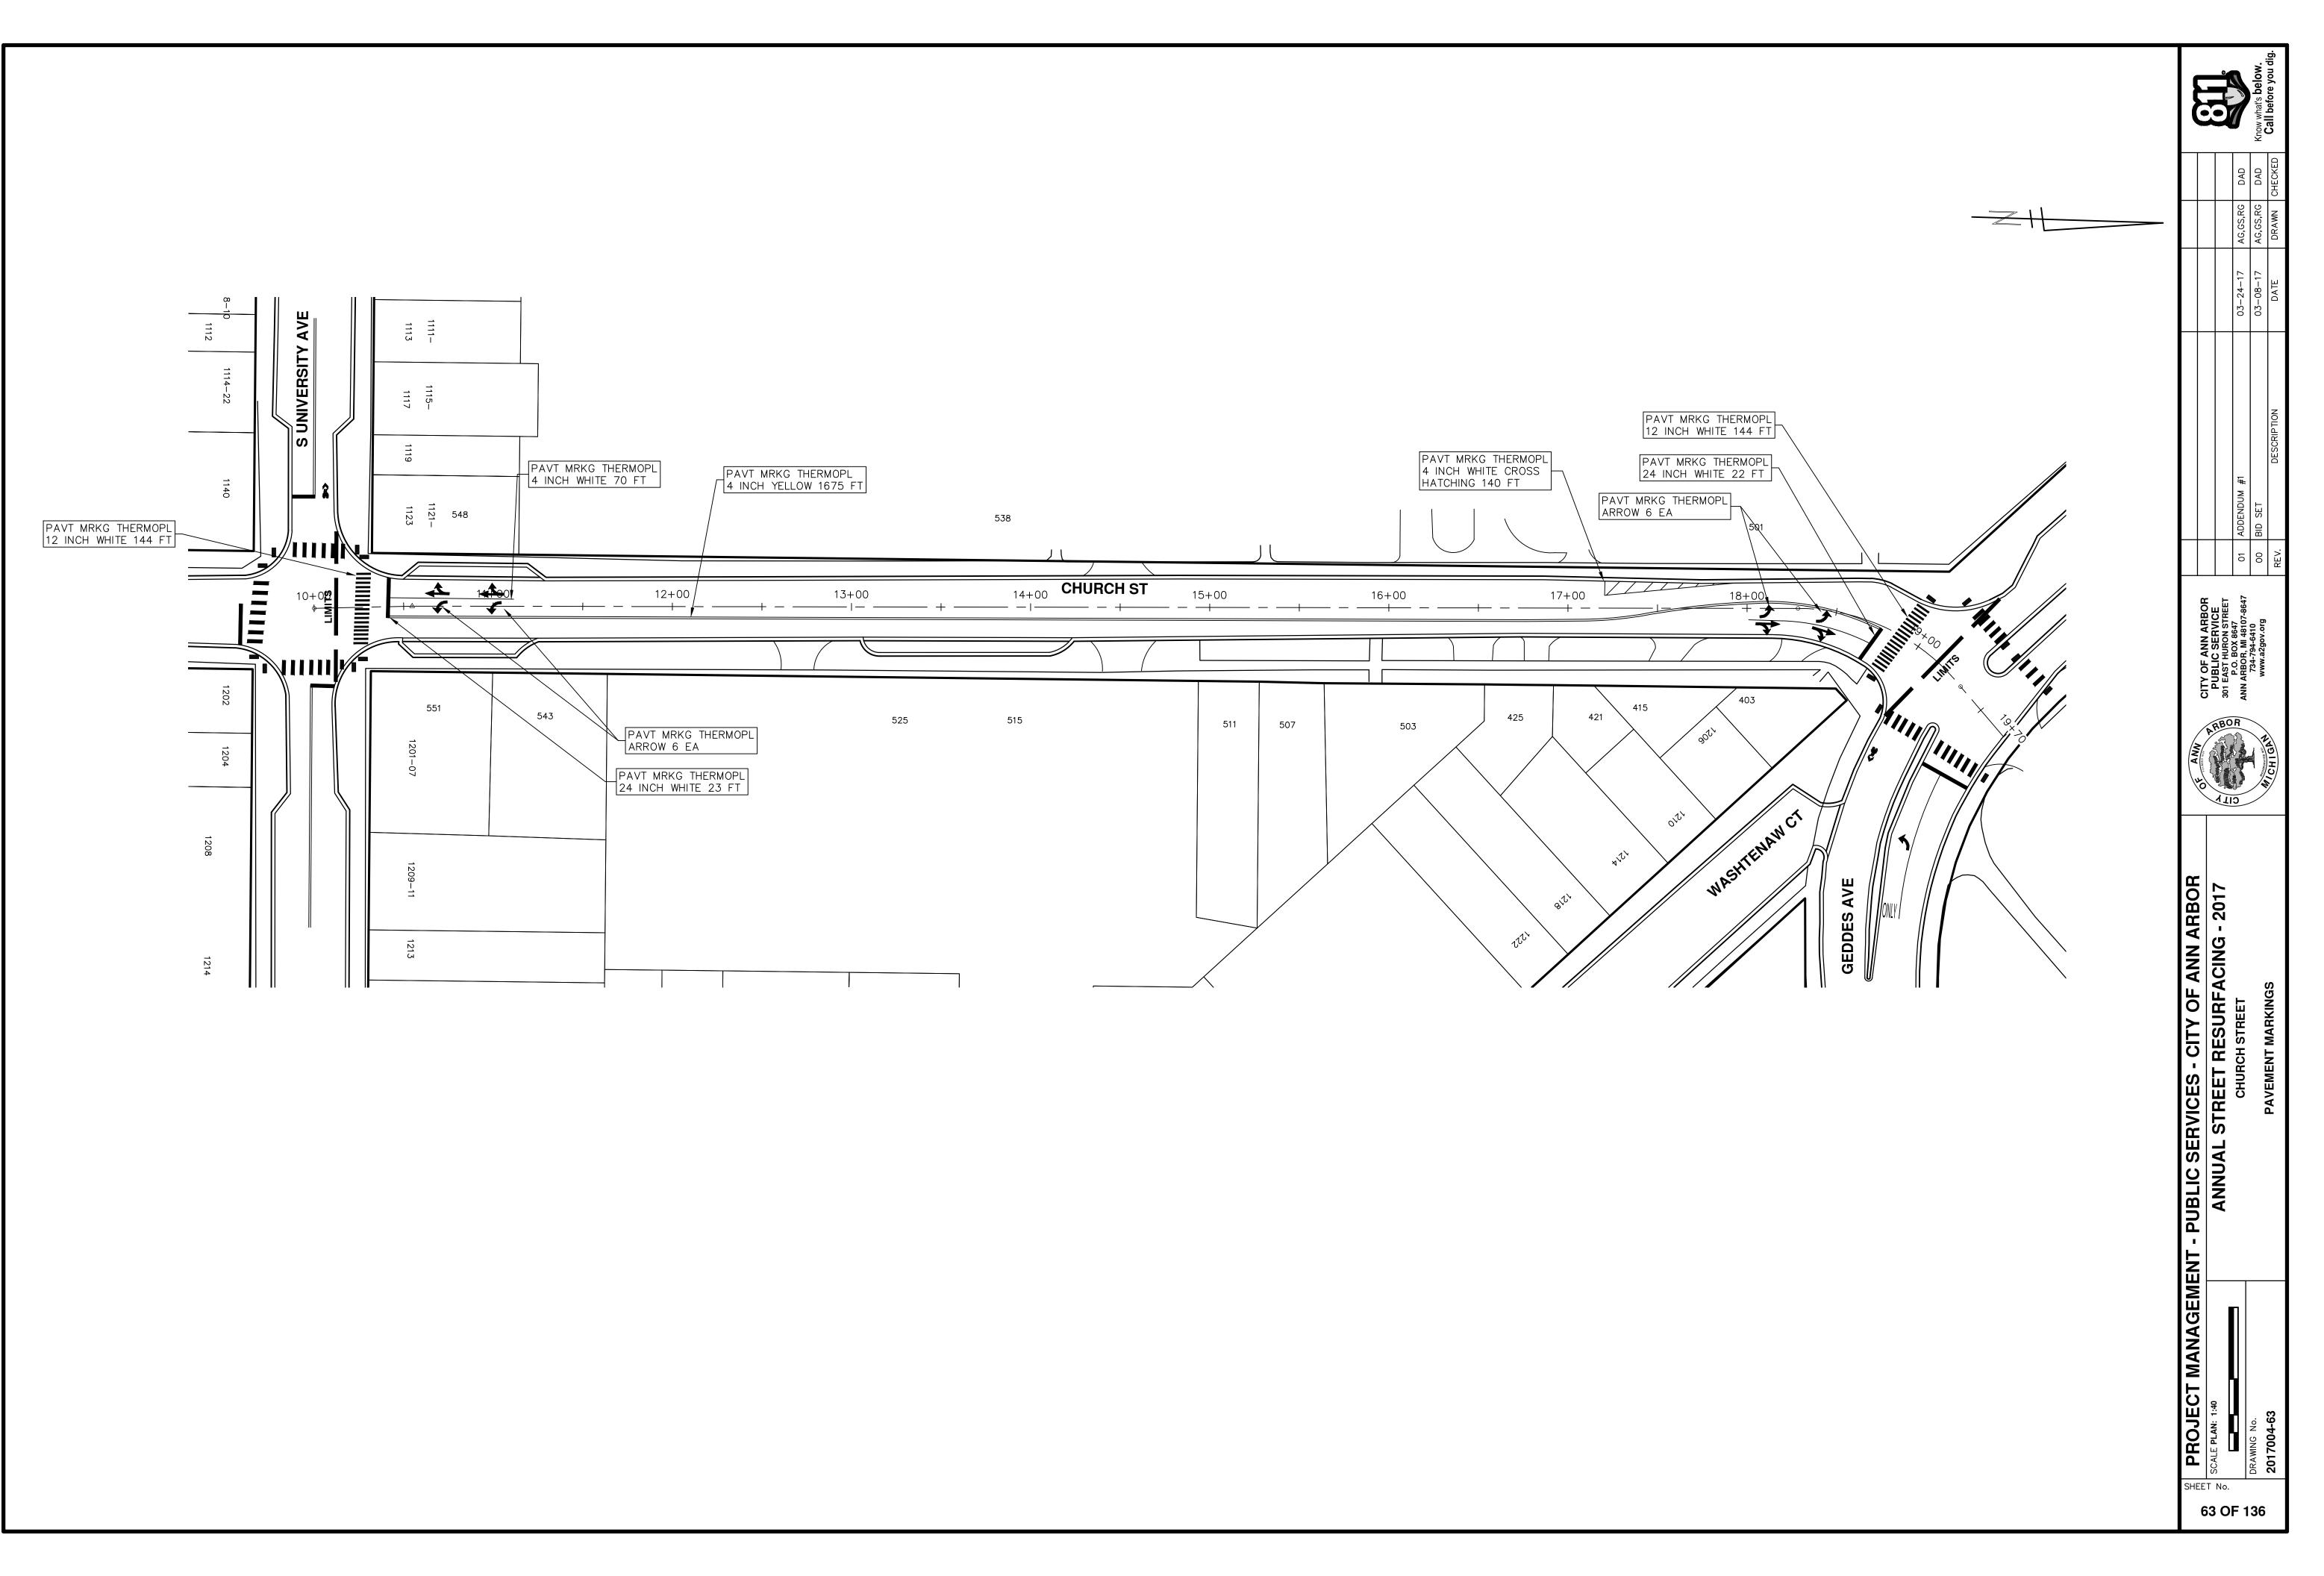



LOCATION: GREEN ROAD NON-MOTORIZED PATH

	QUANTITIES		
Item Code	Item Description	Units	Quantity
2057011	_Grading, Sidewalk	Syd	198.00
2057011	_Machine Grading, Special	Syd	524.44
5010005	HMA Surface, Rem	Syd	839.27
8060040	Shared use Path, HMA	Ton	848.40
8120012	Barricade, Type III, High Intensity, Double Sided, Lighted, Furn	Ea	16.00
8120013	Barricade, Type III, High Intensity, Double Sided, Lighted, Oper	Ea	16.00
8120140	Lighted Arrow, Type C, Furn	Ea	1.00
8120141	Lighted Arrow, Type C, Oper	Ea	1.00
8120260	Plastic Drum, High Intensity, Lighted, Furn	Ea	70.00
8120261	Plastic Drum, High Intensity, Lighted, Oper	Ea	70.00
8120330	Sign, Portable, Changeable Message, Furn	Ea	1.00
8120331	Sign, Portable, Changeable Message, Oper	Ea	1.00
8120350	Sign, Type B, Temp, Prismatic, Furn	Sft	161.00
8120351	Sign, Type B, Temp, Prismatic, Oper	Sft	161.00
8167011	_Slope Restoration	Syd	2,304.00

KEY	
NEI	ASSOCIATED PAY ITEM(S)
AA	_Dr Structure, Adj, Case 1, Modified _Dr Structure, Adj, Case 2, Modified
	_Dr Structure, Adj, Case 2, Modified
	Dr Structure, Temp Lowering, Modified
	_Dr Structure, Temp Lowering, Modified
AB	• _Gate Box, Adj, Case 1
	• _Gate Box, Adj, Case 2
	Monument Box Adjust
ADST	_Dr Structure, Adj, Add Depth, Modified
AK	_Dr Structure, Adj, Case 1, Modified
	• _Sidewalk, Sidewalk Ramp, and Driveway Approach, Any Thickness, Rem
C4	• _Grading, Sidewalk
	_Sidewalk, Conc, 4 inch, Modified
	•_Sidewalk, Sidewalk Ramp, and Driveway Approach, Any Thickness, Rem
C4HE	 _Grading, Sidewalk
	Cement
	 _Sidewalk, Conc, 4 inch, Modified
	• _Sidewalk, Sidewalk Ramp, and Driveway Approach, Any Thickness, Rem
	_Grading, Sidewalk
C6	 _Grading, Sidewalk Ramp
0	 _Detectable Warning Surface, Modified
	 _Sidewalk Ramp, Conc, 6 inch, Modified
	 Sidewalk, Conc, 6 inch, Modified
00	Grading, Driveway Approach
C8	_Driveway, Nonreinf Conc, 8 inch, Modified
	 Sidewalk, Sidewalk Ramp, and Driveway Approach, Any Thickness, Rem
	• Grading, Driveway Approach
	• _Grading, Sidewalk
	• _Grading, Sidewalk Ramp
	Cement
C HE	Driveway, Nonreinf Conc, 6 inch, Modified
	Detectable Warning Surface, Modified
	_Sidewalk Ramp, Conc, 6 inch, Modified
	_Sidewalk, Conc, 6 inch, Modified
C/G	• _Curb, Gutter, and Curb and Gutter, Any Type, Rem
	_Curb and Gutter, Conc
	• _Curb, Gutter, and Curb and Gutter, Any Type, Rem
C/GHE	Cement
	Driveway Opening, Conc, Det M, Modified
CP	• _Grading, Sidewalk
	_Sidewalk, Conc, 4 inch, Modified
CR	• _Sidewalk, Sidewalk Ramp, and Driveway Approach, Any Thickness, Rem
	Dr Structure, Rem
DS	Sewer, Rem, Less than 24 inch
	Dr Structure, 24 inch dia
	Dr Structure, Rem
DSDI	Sewer, Rem, Less than 24 inch
	_Dr Structure, Double Inlet
PT	_Dr Structure, Point
	Dr Structure Cover, Type B
	_Dr Structure Cover, Type B, Special
RRA	• _Dr Structure, Adj, Case 1, Modified
	• _Dr Structure, Temp Lowering, Modified
Dr Structure Cover, Type K	
RRK	• _Dr Structure, Adj, Case 1, Modified
RS	
Кð	Dr Structure, Reconstruct
YPE II	Plastic Drum, High Intensity, Lighted, Furn
	Plastic Drum, High Intensity, Lighted, Oper
	Barricade, Type III, High Intensity, Double Sided, Lighted, Furn
YPE III	 Barricade, Type III, High Intensity, Double Sided, Lighted, Oper

CITY OF ANN ARBOR PROJECT MANAGEMENT

ITB No. 4477 FILE No. 2017004

	LEGEND
SYMBOL	DESCRIPTION
<u>s</u>	EXISTING SANITARY SEWER MANHOLE
	EXISTING STORM SEWER MANHOLE
\otimes	EXISTING WATER MAIN VALVE IN WELL
+	WATER MAIN GATE VALVE IN BOX
+Q+	FIRE HYDRANT
(g)	MICHCON GAS CO. VALVE BOX/WELL
t	AMERITECH TELEPHONE VAULT
e	ELECTRIC MANHOLE
\bullet	SOIL BORING
	EXISTING STORM SEWER INLET
•	MONUMENT BOX
	REMOVE AND REPLACE CONC. SIDEWALK
	PLACE CONCRETE SIDEWALK
	REMOVE & REPLACE CONC. CURB & GUTTER
	CONSTRUCTION LIMITS
·	6" WRAPPED UNDERDRAIN
	REMOVE CONCRETE SIDEWALK
	SUBGRADE UNDERCUT

CONSTRUCTION METHOD AND SEQUENCING

WORK ON THIS HMA PATH INCLUDES, BUT IS NOT LIMITED TO, THE FOLLOWING ITEMS. COMPLE ACCORDANCE WITH THE PLANS AND SPECIFICATIONS, AS DIRECTED BY THE ENGINEER, AND UTILIZING A TWO (2) PHASE APPROACH TO CONSTRUCT THE PATH ON ONE SIDE OF THE ROADWAY AND THEN OTHER SIDE. PERFORM THE WORK IN THE ORDER INDICATED BELOW UNLESS OTHERWISE AUTHORIZED OR DIRECTED BY THE ENGINEER. COMPLETE ITEMS 7 THRU 9 UTILIZING THE M.O.T. PLAN CURRENTLY IN PLACE LANE CLOSURES, AND FLAG CONTROL OPERATIONS AS DIRECTED BY THE ENGINEER

<u>PHASE I</u>

- CONTROL MEASURES.
- 2. CONDUCT PAVEMENT REMOVAL WORK.
- DIRECTED.
- 5. CLEAN PAVEMENT AND PLACE 3 INCH TOP COURSE HMA MIX (36A).

<u>PHASE II</u>

- 6. REPEAT ITEMS 1 THRU 5 IN THE ORDER SHOWN SHOWN ABOVE.
- 8. COMPLETE ALL SLOPE RESTORATION.
- 9. COMPLETE ANY MISCELLANEOUS WORK AND ALL CLEAN UP.
- 10. REMOVE ALL TRAFFIC CONTROL DEVICES, AND MISS DIG FLAGS.

QUANTITIES Sign, Type B, Temp, Prismatic				
Quantity	Sign Code	Description	Area (sft)	Total Area
11.0	D3-1	Street Name Sign	4.000	44.000
1.0	W4-2 (R)	Right Lane Ends Sign	9.000	9.000
1.0	W9-3 (R)	Right Lane Closed Ahead Sign	9.000	9.000
11.0	W20-1	Road Work Ahead Sign	9.000	99.000
		•	TOTAL	161.000

PROTECTION OF UNDERGROUND UTILITIES AND IN CONFORMANCE WITH PUBLIC ACT OF 2013, THE CONTRACTOR SHALL CALL 811 OR 1-800-482-7171 A MINIMUM OF EE FULL WORKING DAYS, EXCLUDING SATURDAYS, SUNDAYS, AND HOLIDAYS, PRIOR BEGINNING EACH EXCAVATION IN AREAS WHERE PUBLIC UTILITIES HAVE NOT BEEN VIOUSLY LOCATED. MEMBERS WILL THUS BE ROUTINELY NOTIFIED. THIS DOES NOT EVE THE CONTRACTOR OF THE RESPONSIBILITY OF NOTIFYING UTILITY OWNERS MAY NOT BE A PART OF THE "MISS DIG" ALERT SYSTEM.

UNDERGROUND LOCATIONS SHOWN FOR NATURAL GAS, TELEPHONE, ELECTRICAL POWER, CABLE TV AND FIBER OPTIC LINES ARE APPROXIMATE. THE CITY OF ANN ARBOR ASSUMES NO RESPONSIBILITY FOR THEIR ACCURATE REPRESENTATION IN THIS DRAWING. MISS DIG MUST BE CONTACTED PRIOR TO CONSTRUCTION TO LOCATE THESE UTILITIES.

THE IMPROVEMENTS COVERED BY THESE PLANS SHALL BE PERFORMED IN ACCORDANCE WITH MICHIGAN DEPARTMENT OF TRANSPORTATION (MDOT) 2012 STANDARD SPECIFICATIONS FOR CONSTRUCTION, INCLUDING REFERENCED MDOT PUBLICATIONS, AND THE PROJECT CONTRACT DOCUMENTS.



1. IMPLEMENT MAINTENANCE OF TRAFFIC (M.O.T.) PLAN, AND INSTALL SOIL EROSION AND SEDIMENTATION

3. PLACE, GRADE, SHAPE AND COMPACT BASE MATERIAL AS REQUIRED.


4. PERFORM ALL JOINT AND CRACK CLEANOUT. HMA/HAND PATCHING, UNDERCUTS AND/OR BASE REPAIRS AS


7. PLACE, GRADE, SHAPE, AND COMPACT ANY EMBANKMENT MATERIAL AS REQUIRED


TES:


PROJECT MANAGEMENT SERVICES UNIT **CITY OF ANN ARBOR PUBLIC SERVICES** 301 EAST HURON STREET, P.O. BOX 8647 ANN ARBOR. MICHIGAN 48107-8647 734-794-6410 www.a2gov.org

ROJECT MANAGEMENT - PUBLIC SERVICES - CITY OF ANN ARBOR	PROJECT DESCRIPTION ANNUAL STREET RESURFACING - 2017	GREEN ROAD NON-MOTORIZED PATH
PROJECT MANAGEME		DRAWING No. 2017004-64

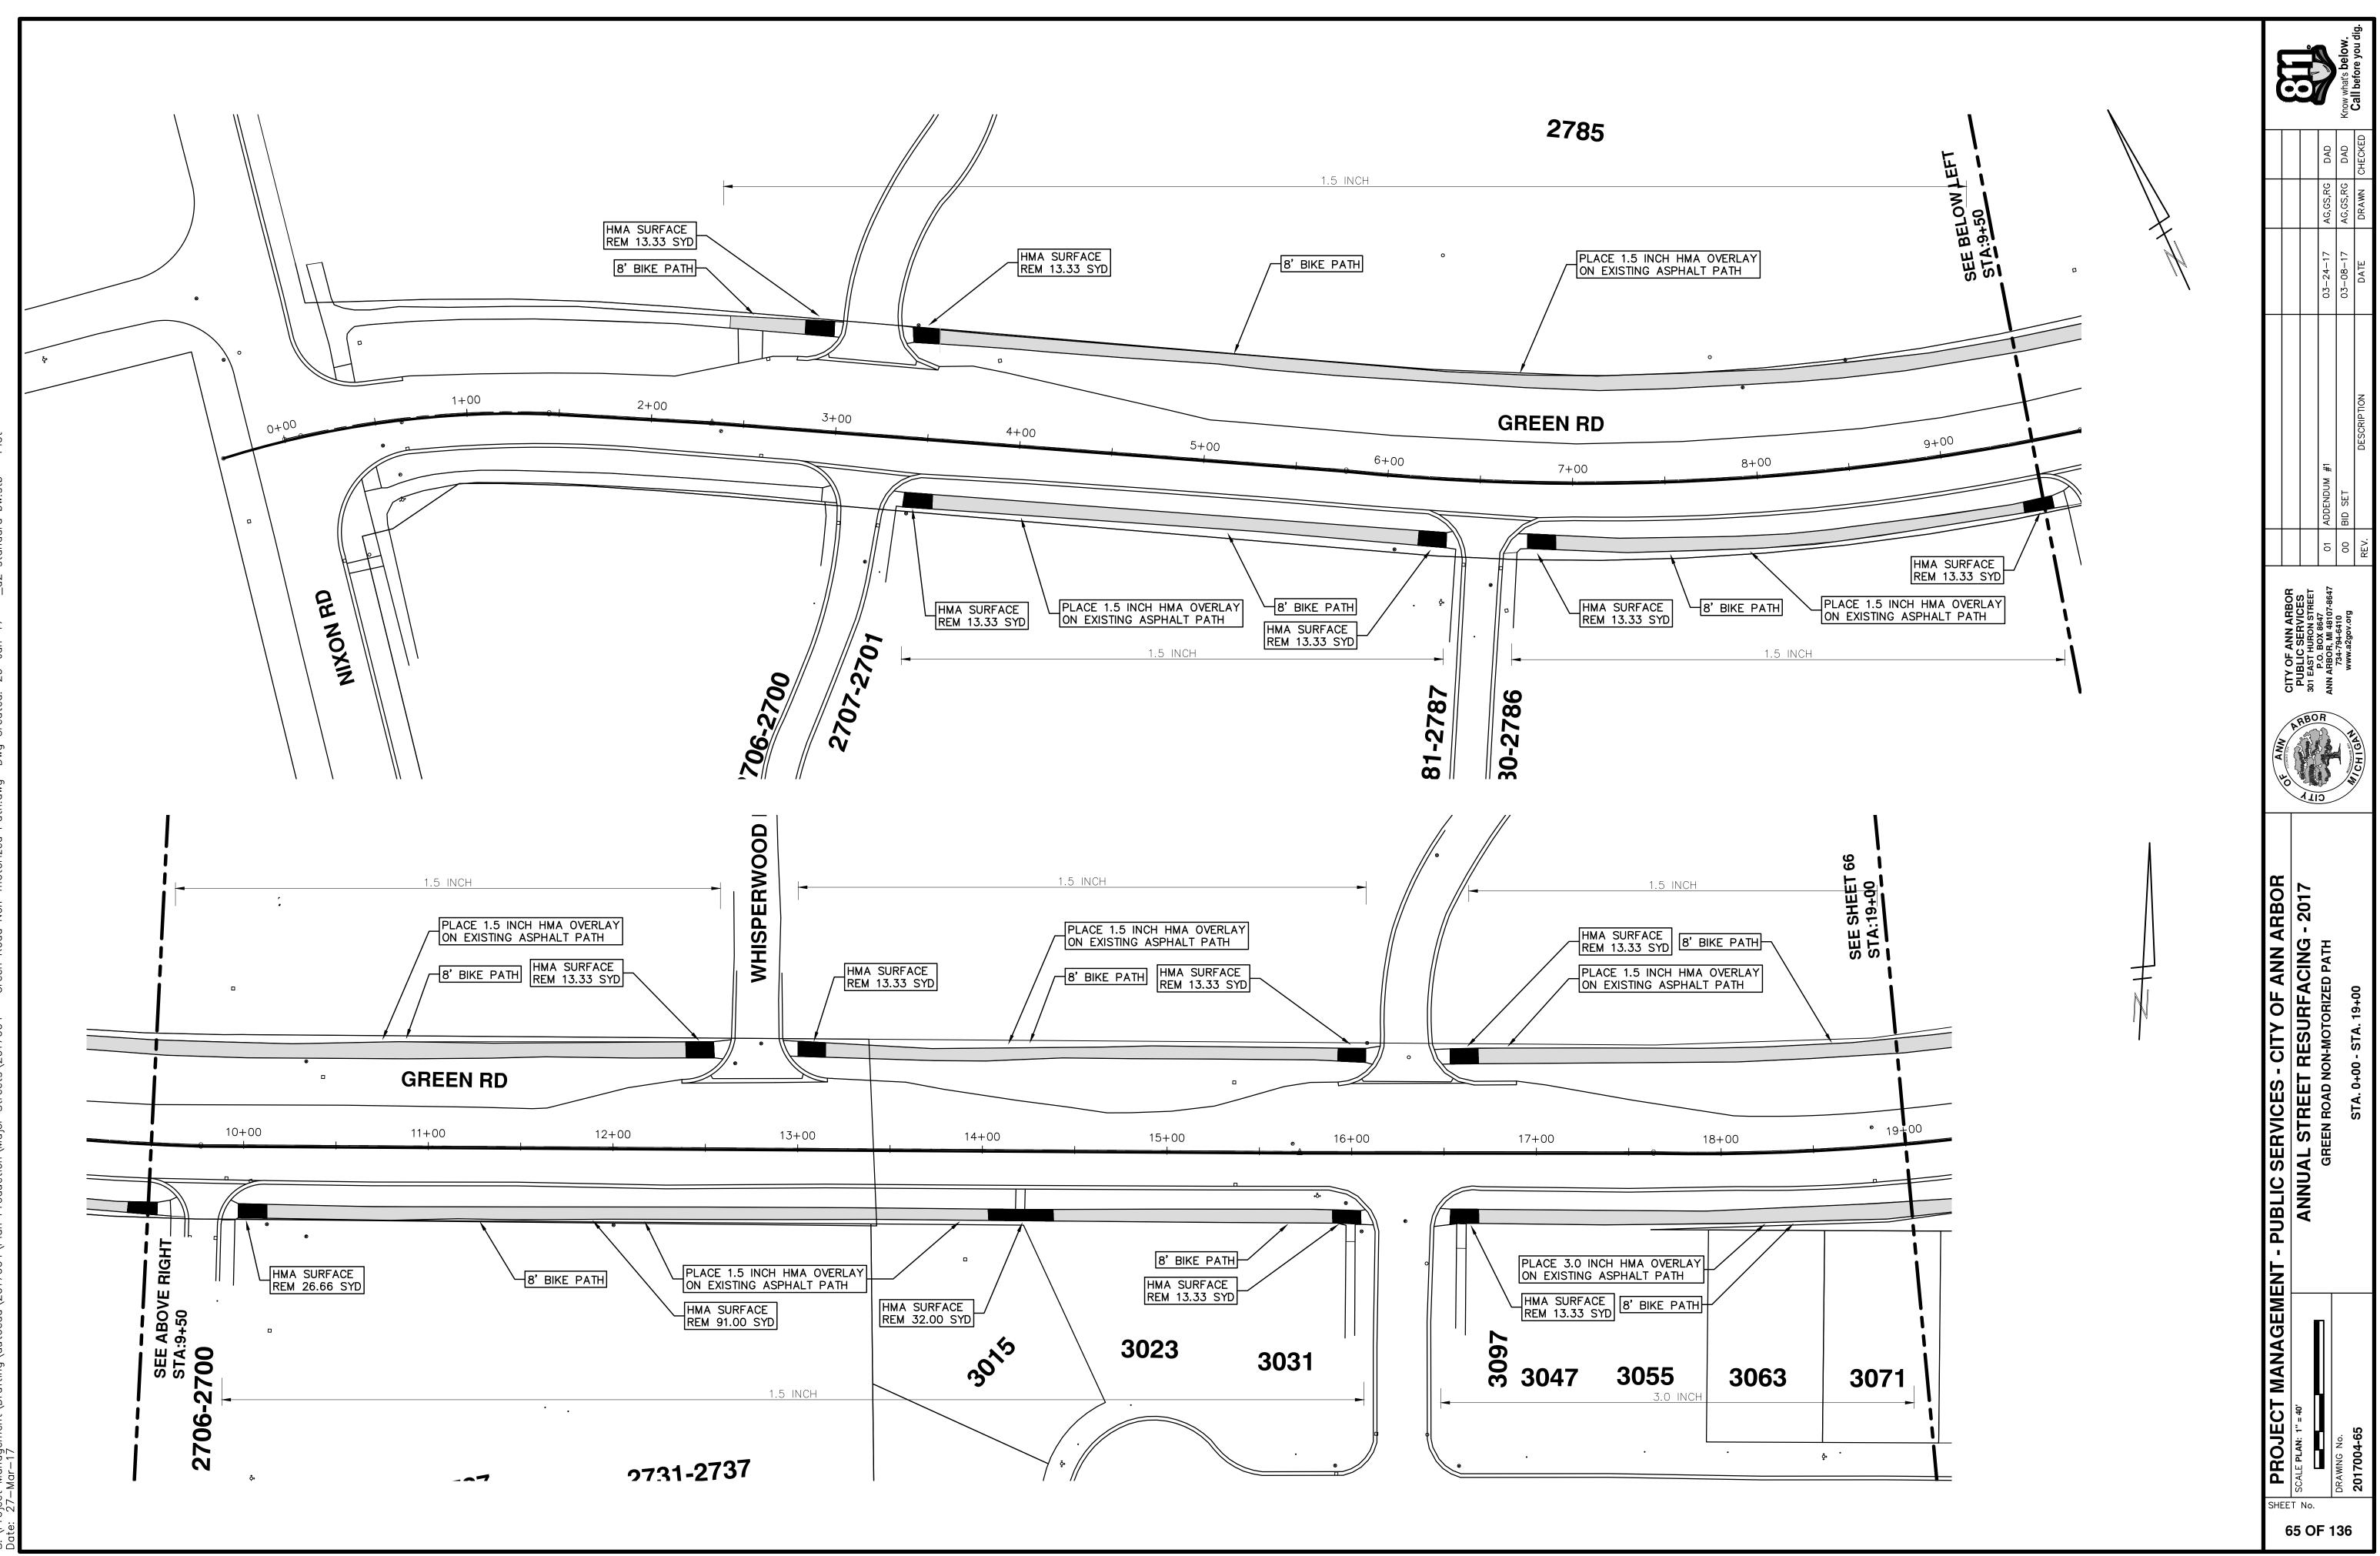

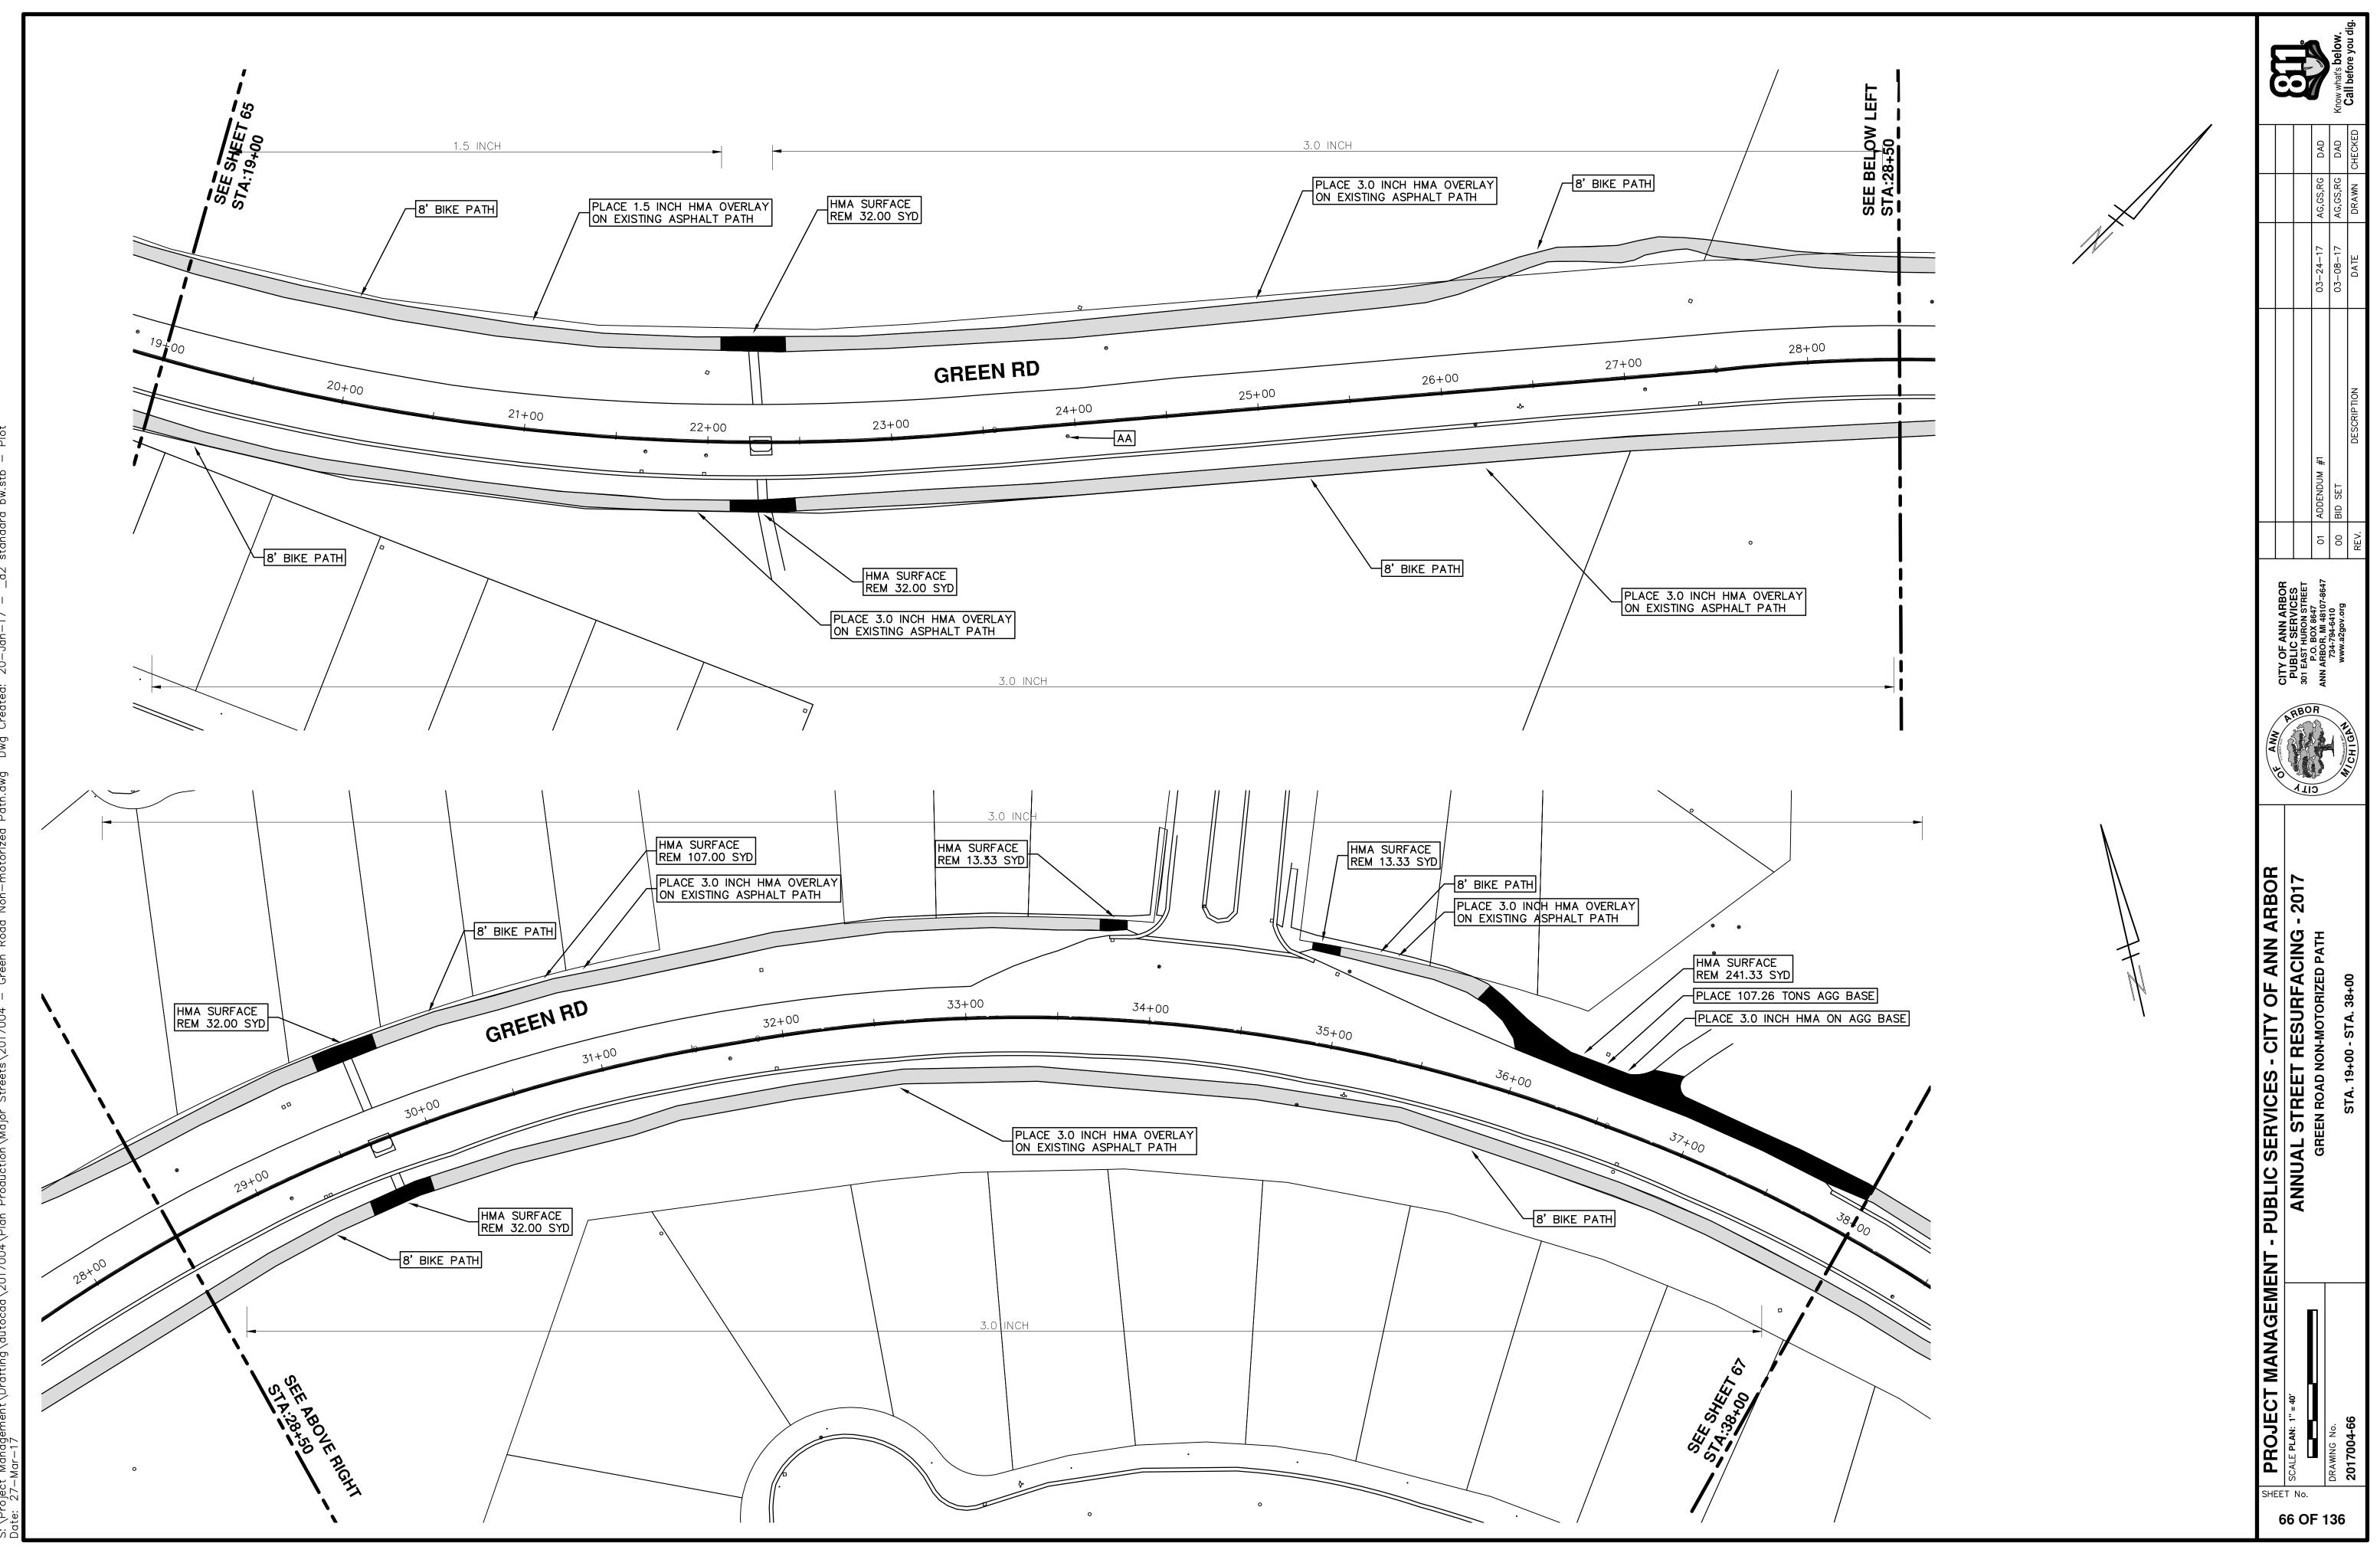

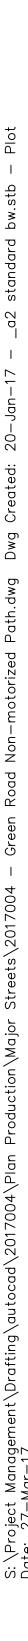

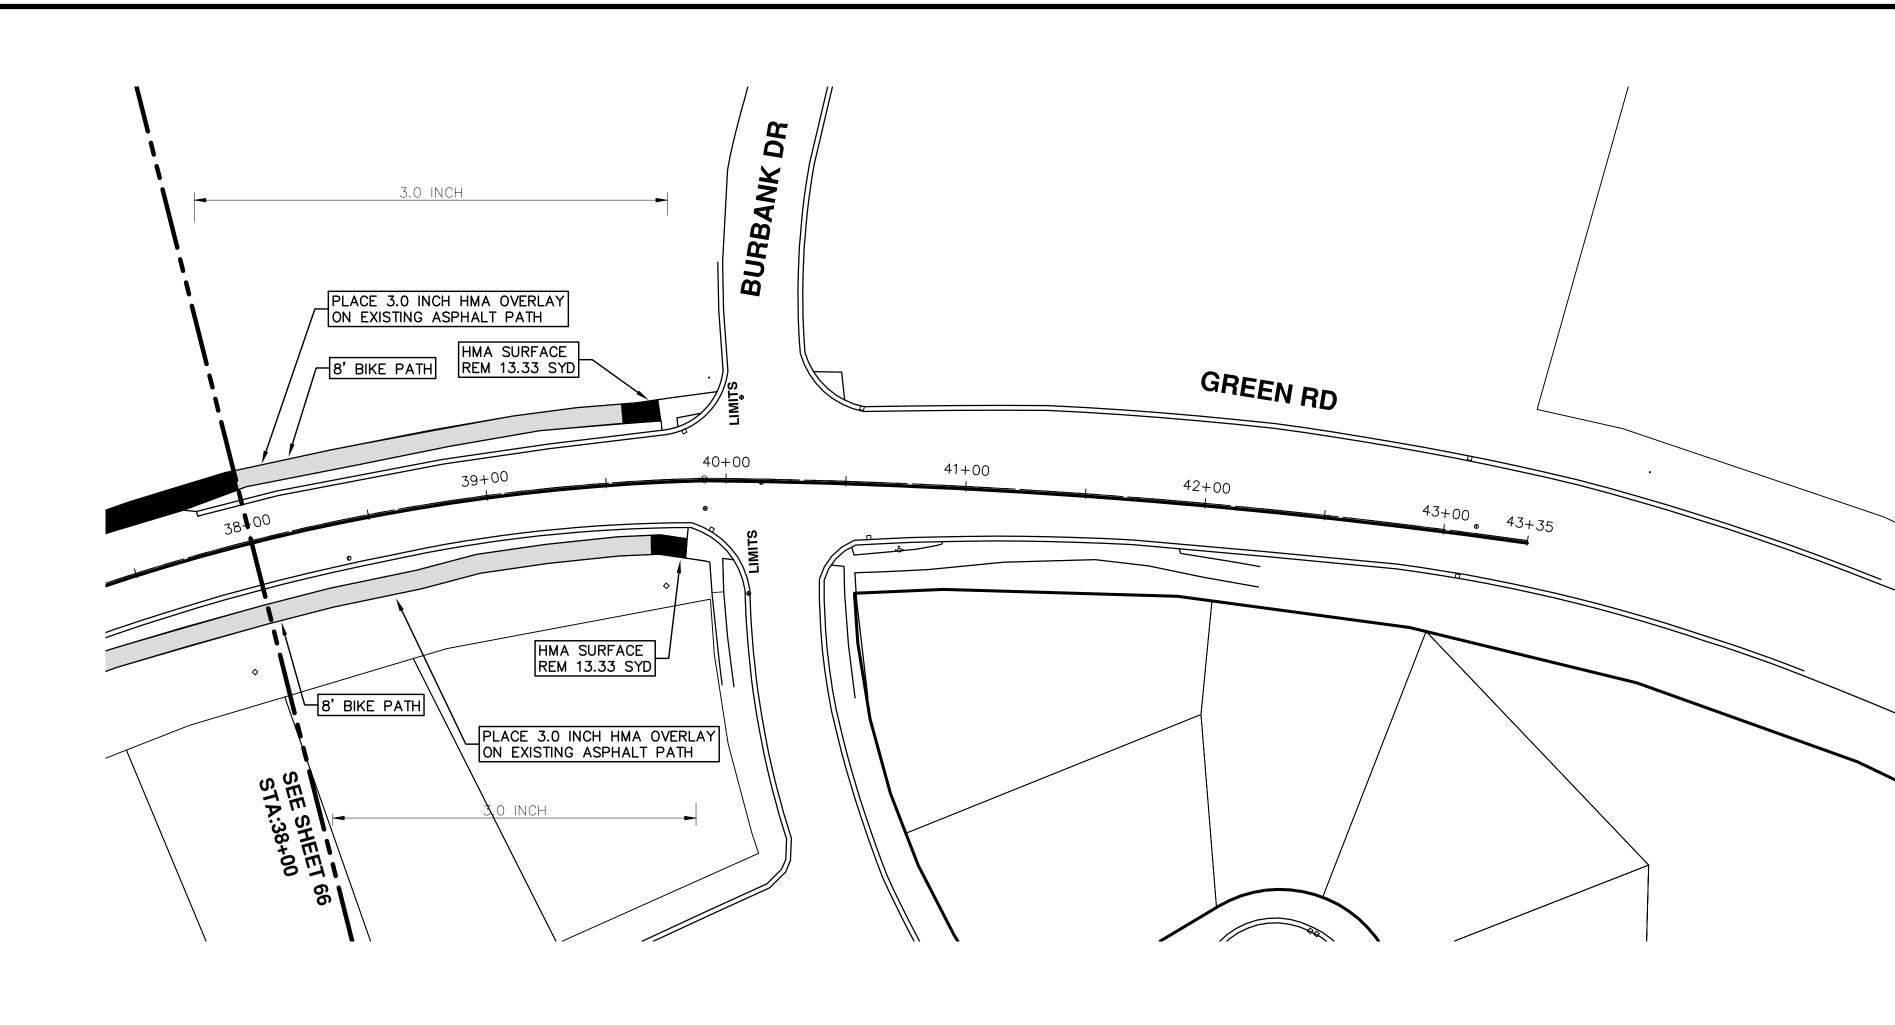

E		Know what's below. Call before you dig.
	S,RG DAD	S,RG DAD WN CHECKED
	03-24-17 AG,GS,RG	03-08-17 AG,GS,RG DATE DRAWN
	03-	03-
		DESCRIPTION
	ADDENDUM #1	BID SET DE
	0	00 B REV.
AMN	ABOR	INVESSION OF A
	ANNUAL STREET RESURFACING - 2017 GREEN ROAD NON-MOTORIZED PATH	STA. 38+00 - STA. 43+35
	SCALE PLAN: 1" = 40'	DRAWING No. 2017004-67



CITY OF ANN ARBOR PROJECT MANAGEMENT PROJECT LOCATION: HILL STREET CONSTRUCTION MET

tem Code	Item Description	Units	Quantity
2030011	Dr Structure, Rem	Ea	5.0
2030015	Sewer, Rem, Less than 24 inch	Ft	50.0
2047001	_Curb, Gutter, and Curb and Gutter, Any Type, Rem	Ft	565.0
2047011	_Sidewalk, Sidewalk Ramp, and Driveway Approach, Any Thickness, Rem	Syd	89.0
2057011	_Grading, Driveway Approach	Syd	16.0
2057011	_Grading, Sidewalk	Syd	23.0
2057011	_Grading, Sidewalk Ramp	Syd	50.0
2057011	_Machine Grading, Special	Syd	5,353.0
2057021	_Subgrade Undercutting, Type IIA	Cyd	495.0
2080020	Erosion Control, Inlet Protection, Fabric Drop	Ea	16.0
4020987	Sewer, CI IV, 12 inch, Tr Det B	Ft	50.0
4030200	Dr Structure, 24 inch dia	Ea	5.0
4037050	_Dr Structure Cover, Type B, Modified	Ea	15.0
4030050	_Dr Structure Cover, Type K, Modified	Ea	5.0
4037050	_Dr Structure, Adj, Case 1, Modified	Ea	21.0
4037050	_Dr Structure, Temp Lowering, Modified	Ea	19.0
5010003	Cold Milling HMA Surface	Ton	1,210.0
5010005	HMA Surface, Rem	Syd	143.0
5010061	HMA, Approach	Ton	93.0
5010703	HMA, LVSP	Ton	1,210.0
5017031	_Cold Milling for Curb Reveal	Ton	4.
5017050	HMA Surface, Around Structure Cover, Rem	Ea	14.
6027021	_Flowable Fill	Cyd	20.
6030005	Cement	Ton	2.
8017011	Driveway, Nonreinf Conc, 6 inch, Modified	Syd	16.0
8027001	_Curb and Gutter, Conc	Ft	577.0
8027001	_Driveway Opening, Conc, Det M, Modified	Ft	139.0
8037001	_Detectable Warning Surface, Modified	Ft	10.0
8037010		Sft	442.0
8037010	_Sidewalk, Conc, 4 inch, Modified	Sft	200.0
8110049	Pavt Mrkg, Ovly Cold Plastic, Direction Arrow Sym, Bike	Ea	5.0
8110058	Pavt Mrkg, Ovly Cold Plastic, Bike, Small Sym	Ea	5.0
8110079	Pavt Mrkg, Ovly Cold Plastic, Sharrow Symbol	Ea	1.(
8110520	Pavt Mrkg, Wet Retrflec, Thermopl, 4 inch, White	Ft	2,400.0
8110521	Pavt Mrkg, Wet Retrflec, Thermopl, 6 inch, White	Ft	2,261.0
8117001	Pavt Mrkg, Wet Retrflec, Thermopl, 6 inch, Crosswalk	Ft	130.0
8117001	_Pavt Mrkg, Wet Retrflec, Thermopl, 24 inch, Stop Bar	Ft	64.
8120012	Barricade, Type III, High Intensity, Double Sided, Lighted, Furn	Ea	5.0
8120013	Barricade, Type III, High Intensity, Double Sided, Lighted, Oper	Ea	5.
8120260	Plastic Drum, High Intensity, Lighted, Furn	Ea	60.
8120261	Plastic Drum, High Intensity, Lighted, Oper	Ea	60.
8120330	Sign, Portable, Changeable Message, Furn	Ea	2.0
8120331	Sign, Portable, Changeable Message, Oper	Ea	2.0
8120350	Sign, Type B, Temp, Prismatic, Furn	Sft	258.0
8120351	Sign, Type B, Temp, Prismatic, Oper	Sft	258.0
8127050	_No Parking Sign	Ea	6.0
8167011	Slope Restoration		208.0
8230431	Gate Box, Adj, Case 1	Syd Ea	208.0

KEY	ASSOCIATED PAY ITEM(S)
	 _Dr Structure, Adj, Case 1, Modified
AA	 _Dr Structure, Adj, Case 2, Modified
	 _Dr Structure, Temp Lowering, Modified
	 _Dr Structure, Temp Lowering, Modified
AB	• _Gate Box, Adj, Case 1
AB	• _Gate Box, Adj, Case 2
	_Monument Box Adjust
ADST	 _Dr Structure, Adj, Add Depth, Modified
AK	 _Dr Structure, Adj, Case 1, Modified
	• _Sidewalk, Sidewalk Ramp, and Driveway Approach, Any Thickness, Rem
C4	• _Grading, Sidewalk
	 _Sidewalk, Conc, 4 inch, Modified
	• _Sidewalk, Sidewalk Ramp, and Driveway Approach, Any Thickness, Rem
	 Grading, Sidewalk
C4HE	• Cement
	 _Sidewalk, Conc, 4 inch, Modified
	
	• Grading, Sidewalk
00	Grading, Sidewalk Ramp
C6	Detectable Warning Surface, Modified
	Sidewalk Ramp, Conc, 6 inch, Modified
	Sidewalk, Conc, 6 inch, Modified
00	Grading, Driveway Approach
C8	_Driveway, Nonreinf Conc, 8 inch, Modified
	 _Sidewalk, Sidewalk Ramp, and Driveway Approach, Any Thickness, Rem
	 Grading, Driveway Approach
	Grading, Sidewalk
	_Grading, Sidewalk Ramp
	Cement
C HE	
	 Driveway, Nonreinf Conc, 8 inch, Modified
	Detectable Warning Surface, Modified
	 _Sidewalk, Conc, 6 inch, Modified
C/G	• _Curb and Gutter, Conc
	_Curb and Gutter, Conc _Curb, Gutter, and Curb and Gutter, Any Type, Rem
C/GHE	Cement
JULE	_Driveway Opening, Conc, Det M, Modified
	Grading, Sidewalk
CP	
CP	 Sidewalk, Conc, 4 inch, Modified Sidewalk, Sidewalk, Pamp, and Driveway, Approach, Apy Thickness, Pom
CR	 Sidewalk, Sidewalk Ramp, and Driveway Approach, Any Thickness, Rem Dr Structure, Rom
De	Dr Structure, Rem Sower, Rem Loss than 24 inch
DS	Sewer, Rem, Less than 24 inch Dr Structure, 24 inch die
	Dr Structure, 24 inch dia
	Dr Structure, Rem
DSDI	Sewer, Rem, Less than 24 inch
D.T.	_Dr Structure, Double Inlet
PT	_Dr Structure, Point
	Dr Structure Cover, Type B
RRA	_Dr Structure Cover, Type B, Special
	_Dr Structure, Adj, Case 1, Modified
	_Dr Structure, Temp Lowering, Modified
RRK	Dr Structure Cover, Type K
	_Dr Structure, Adj, Case 1, Modified
RS	_Dr Structure, Reconstruct
YPE II	Plastic Drum, High Intensity, Lighted, Furn
	Plastic Drum, High Intensity, Lighted, Oper
YPE III	Barricade, Type III, High Intensity, Double Sided, Lighted, Furn
11	• Barricade, Type III, High Intensity, Double Sided, Lighted, Oper

ITB No. 4477 FILE No. 2017-004

LEGEND				
SYMBOL	DESCRIPTION			
S	EXISTING SANITARY SEWER MANHOLE			
\bigcirc	EXISTING STORM SEWER MANHOLE			
\otimes	EXISTING WATER MAIN VALVE IN WELL			
+	WATER MAIN GATE VALVE IN BOX			
+ Ç +	FIRE HYDRANT			
9	MICHCON GAS CO. VALVE BOX/WELL			
t	AMERITECH TELEPHONE VAULT			
e	ELECTRIC MANHOLE			
\bullet	SOIL BORING			
	EXISTING STORM SEWER INLET			
•	MONUMENT BOX			
	REMOVE AND REPLACE CONC. SIDEWALK			
	PLACE CONCRETE SIDEWALK			
	REMOVE & REPLACE CONC. CURB & GUTTER			
	CONSTRUCTION LIMITS			
<u> </u>	6" WRAPPED UNDERDRAIN			
	REMOVE CONCRETE SIDEWALK			
	SUBGRADE UNDERCUT			

WORK ON THIS STREET INCLUDES, E WITH THE PLANS AND SPECIFICATION CONSTRUCTION. PERFORM THE WOR THE ENGINEER. COMPLETE ITEMS 11 CONTROL OPERATIONS AS DIRECTED

PHASE I


- 1. IMPLEMENT MAINTENANCE OF TRA MEASURES.
- 2. CONDUCT REMOVAL WORK RELAT
- 3. INSTALL PROPOSED DRAINAGE S
- 4. PERFORM ALL CONCRETE WORK,
- 5. TEMPORARY LOWER ALL STRUCTU MONUMENT BOXES WITH EXCEPTI STRUCTURES SHALL COLDMILLED
- REMOVE 4 INCHES OF EXISTING 6. TO BE DETERMINED BY THE ENG
- 7. PERFORM ALL JOINT AND CRACK
- 8. GRADE, SHAPE, AND COMPACT

9. CLEAN PAVEMENT AND PLACE 2 <u>PHASE II</u>


- 10. REPEAT ITEMS 1 THRU 9 IN THE
- 11. ADJUST ALL STRUCTURE COVERS
- 12. CLEAN PAVEMENT AND PLACE 2
- 13. CLEAN PAVEMENT AND PLACE H
- 14. CLEAN PAVEMENT AND COMPLET
- 15. COMPLETE ALL MISCELLANEOUS
- 16. REMOVE ALL TRAFFIC CONTROL

QUANTITIES Sign, Type B, Temp, Prismatic					
21.0	D3-1	Street Name Sign	4.000	84.000	
1.0	M4-10R	Detour Arrow (Right) Sign	6.000	6.000	
1.0	M4-8a	End Detour Sign	3.000	3.000	
3.0	M4-9L	Detour Sign (w/Left Arrow)	5.000	15.000	
4.0	M4-9R	Detour Sign (w/Right Arrow)	5.000	20.000	
5.0	M4-9S	Detour Sign (w/Thru Arrow)	5.000	25.000	
2.0	R5-1	Do Not Enter Sign	6.250	12.500	
2.0	R5-1A	Wrong Way Sign	6.000	12.000	
3.0	R11-2	Road Closed Sign ("Road Closed")	8.000	24.000	
1.0	R11-4	Road Closed Sign ("Road Closed To Thru Traffic")	12.500	12.500	
2.0	R3-1	Movement Prohibition Sign ("No Right Turn")	4.000	8.000	
20.0	R3-2	Movement Prohibition Sign ("No Left Turn")	5.000	100.000	
2.0	R6-1L	One Way (Left) Sign	3.000	6.000	
4.0	R6-1R	One Way (Right) Sign	3.000	12.000	
7.0	SP-1	Special Sign	20.000	140.000	
9.0	W20-1	Road Work Ahead Sign	9.000	81.000	
1.0	W20-2	Detour Ahead	9.000	9.000	
2.0	W20-3	Road Closed Ahead	9.000	18.000	
			TOTAL	588.000	




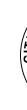


	L L		Know what's below. Call before you dig.
HOD AND SEQUENCING BUT IS NOT LIMITED TO, THE FOLLOWING ITEMS. COMPLETE THE WORK IN ACCORDANCE ONS, AS DIRECTED BY THE ENGINEER, AND UTILIZING PART WOTH TWO (2) PHAS KK IN THE ORDER INDICATED BELOW UNLESS OTHERWISE AUTHORIZED OR DIRECTED BY THRU 16 UTILIZING THE M.O.T. PLAN CURRENTLY IN PLACE, LANE CLOSURES, AND FLAC BY THE ENGINEER. AFFIC (M.O.T.) PLAN, AND INSTALL SOIL EROSION AND SEDIMENTATION CONTROL TED TO PAVEMENT, DRAINAGE, AND CONCRETE ITEMS WITH EXCEPTION TO COLDMILLING. TRUCTURES, STORM SEWER, AND UNDERDRAIN AS REQUIRED.			
INCLUDING RESTORATION. URE COVERS LOCATED WITHIN THE EXISTING PAVEMENT AREA, INCLUDING GATE AND ON TO THE SEGMENT BETWEEN N INGALLS STREET AND GLEN AVENUE, WHICH AROUND.			
HMA SURFACE BY COLDMILLING. THIS MAY INCLUDE GRANULAR BASE MATERIAL. DEPTH INEER. PROOF ROLL WITH FULLY LOADED TRUCK.			
C CLEANOUT. HMA/HAND PATCHING, UNDERCUTS AND/OR BASE REPAIRS AS REQUIRED. THE EXISTING BASE MATERIAL AS REQUIRED.			
INCH LEVELING COURSE HMA MIX (LVSP).	RBOR		
CORDER SHOWN SHOWN ABOVE. 5, INCLUDING GATE AND MONUMENT BOXES, TO THEIR FINISH ELEVATION. INCH TOP COURSE HMA MIX (LVSP). MA APPROACHES AS REQUIRED. TE ALL PAVEMENT MARKINGS. CONSTRUCTION INCLUDING ALL CLEAN UP AND FINAL RESTORATION. DEVICES, AND MISS DIG FLAGS.	SERVICES - CITY OF ANN AR	AL STREET RESURFACING - 2017	HILL STREET
TES:		ANNUAL	
PROTECTION OF UNDERGROUND UTILITIES AND IN CONFORMANCE WITH PUBLIC ACT OF 2013, THE CONTRACTOR SHALL CALL 811 OR 1-800-482-7171 A MINIMUM OF EE FULL WORKING DAYS, EXCLUDING SATURDAYS, SUNDAYS, AND HOLIDAYS, PRIOR BEGINNING EACH EXCAVATION IN AREAS WHERE PUBLIC UTILITIES HAVE NOT BEEN VIOUSLY LOCATED. MEMBERS WILL THUS BE ROUTINELY NOTIFIED. THIS DOES NOT EVE THE CONTRACTOR OF THE RESPONSIBILITY OF NOTIFYING UTILITY OWNERS MAY NOT BE A PART OF THE "MISS DIG" ALERT SYSTEM.	ENT - PUBLIC	PROJECT DESCRIPTION	
ER, CABLE TV AND FIBER OPTIC LINES ARE APPROXIMATE. THE CITY OF ANN OR ASSUMES NO RESPONSIBILITY FOR THEIR ACCURATE REPRESENTATION IN THIS WING. MISS DIG MUST BE CONTACTED PRIOR TO CONSTRUCTION TO LOCATE THESE ITIES.	MANAGEMENT		
IMPROVEMENTS COVERED BY THESE PLANS SHALL BE PERFORMED IN ACCORDANCE MICHIGAN DEPARTMENT OF TRANSPORTATION (MDOT) 2012 STANDARD CIFICATIONS FOR CONSTRUCTION, INCLUDING REFERENCED MDOT PUBLICATIONS, AND PROJECT CONTRACT DOCUMENTS.	PROJECT MAN		^{No.})4-68
PROJECT MANAGEMENT SERVICES UNIT CITY OF ANN ARBOR PUBLIC SERVICES 301 EAST HURON STREET, P.O. BOX 8647 ANN ARBOR, MICHIGAN 48107-8647 734-794-6410 www.a2gov.org	SHEE	T No. 8 OF -	DRAWING 201700

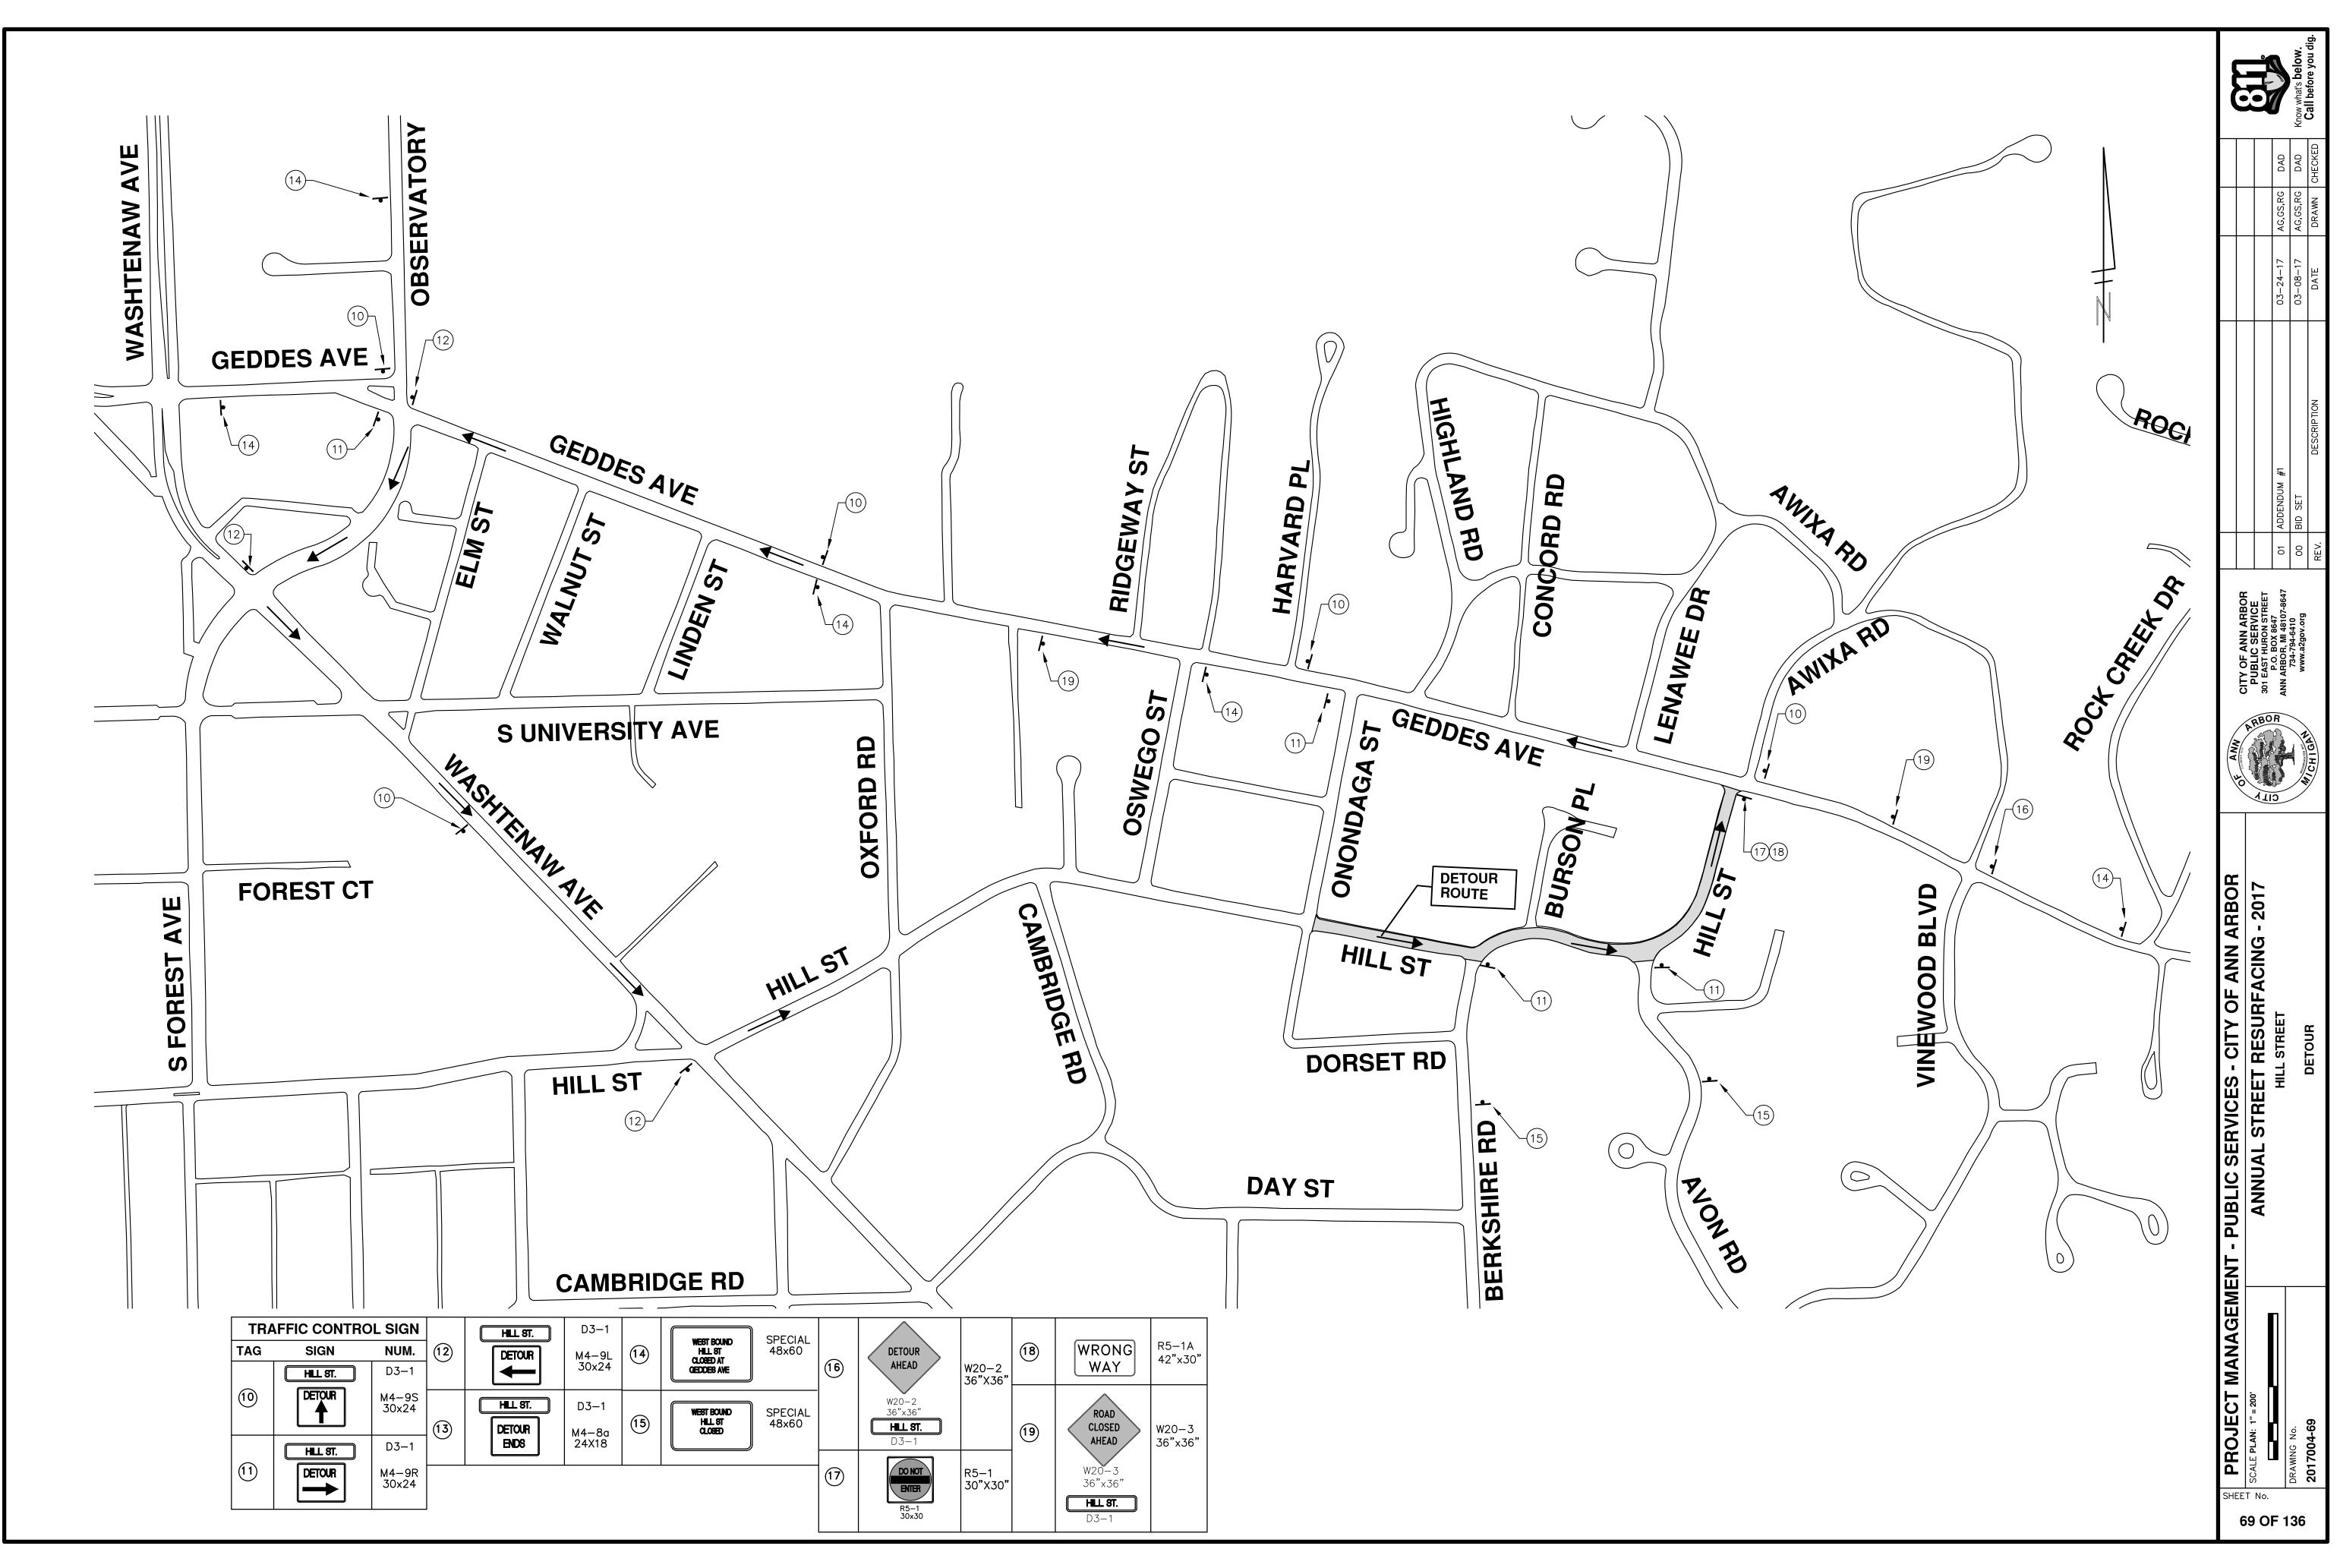


.

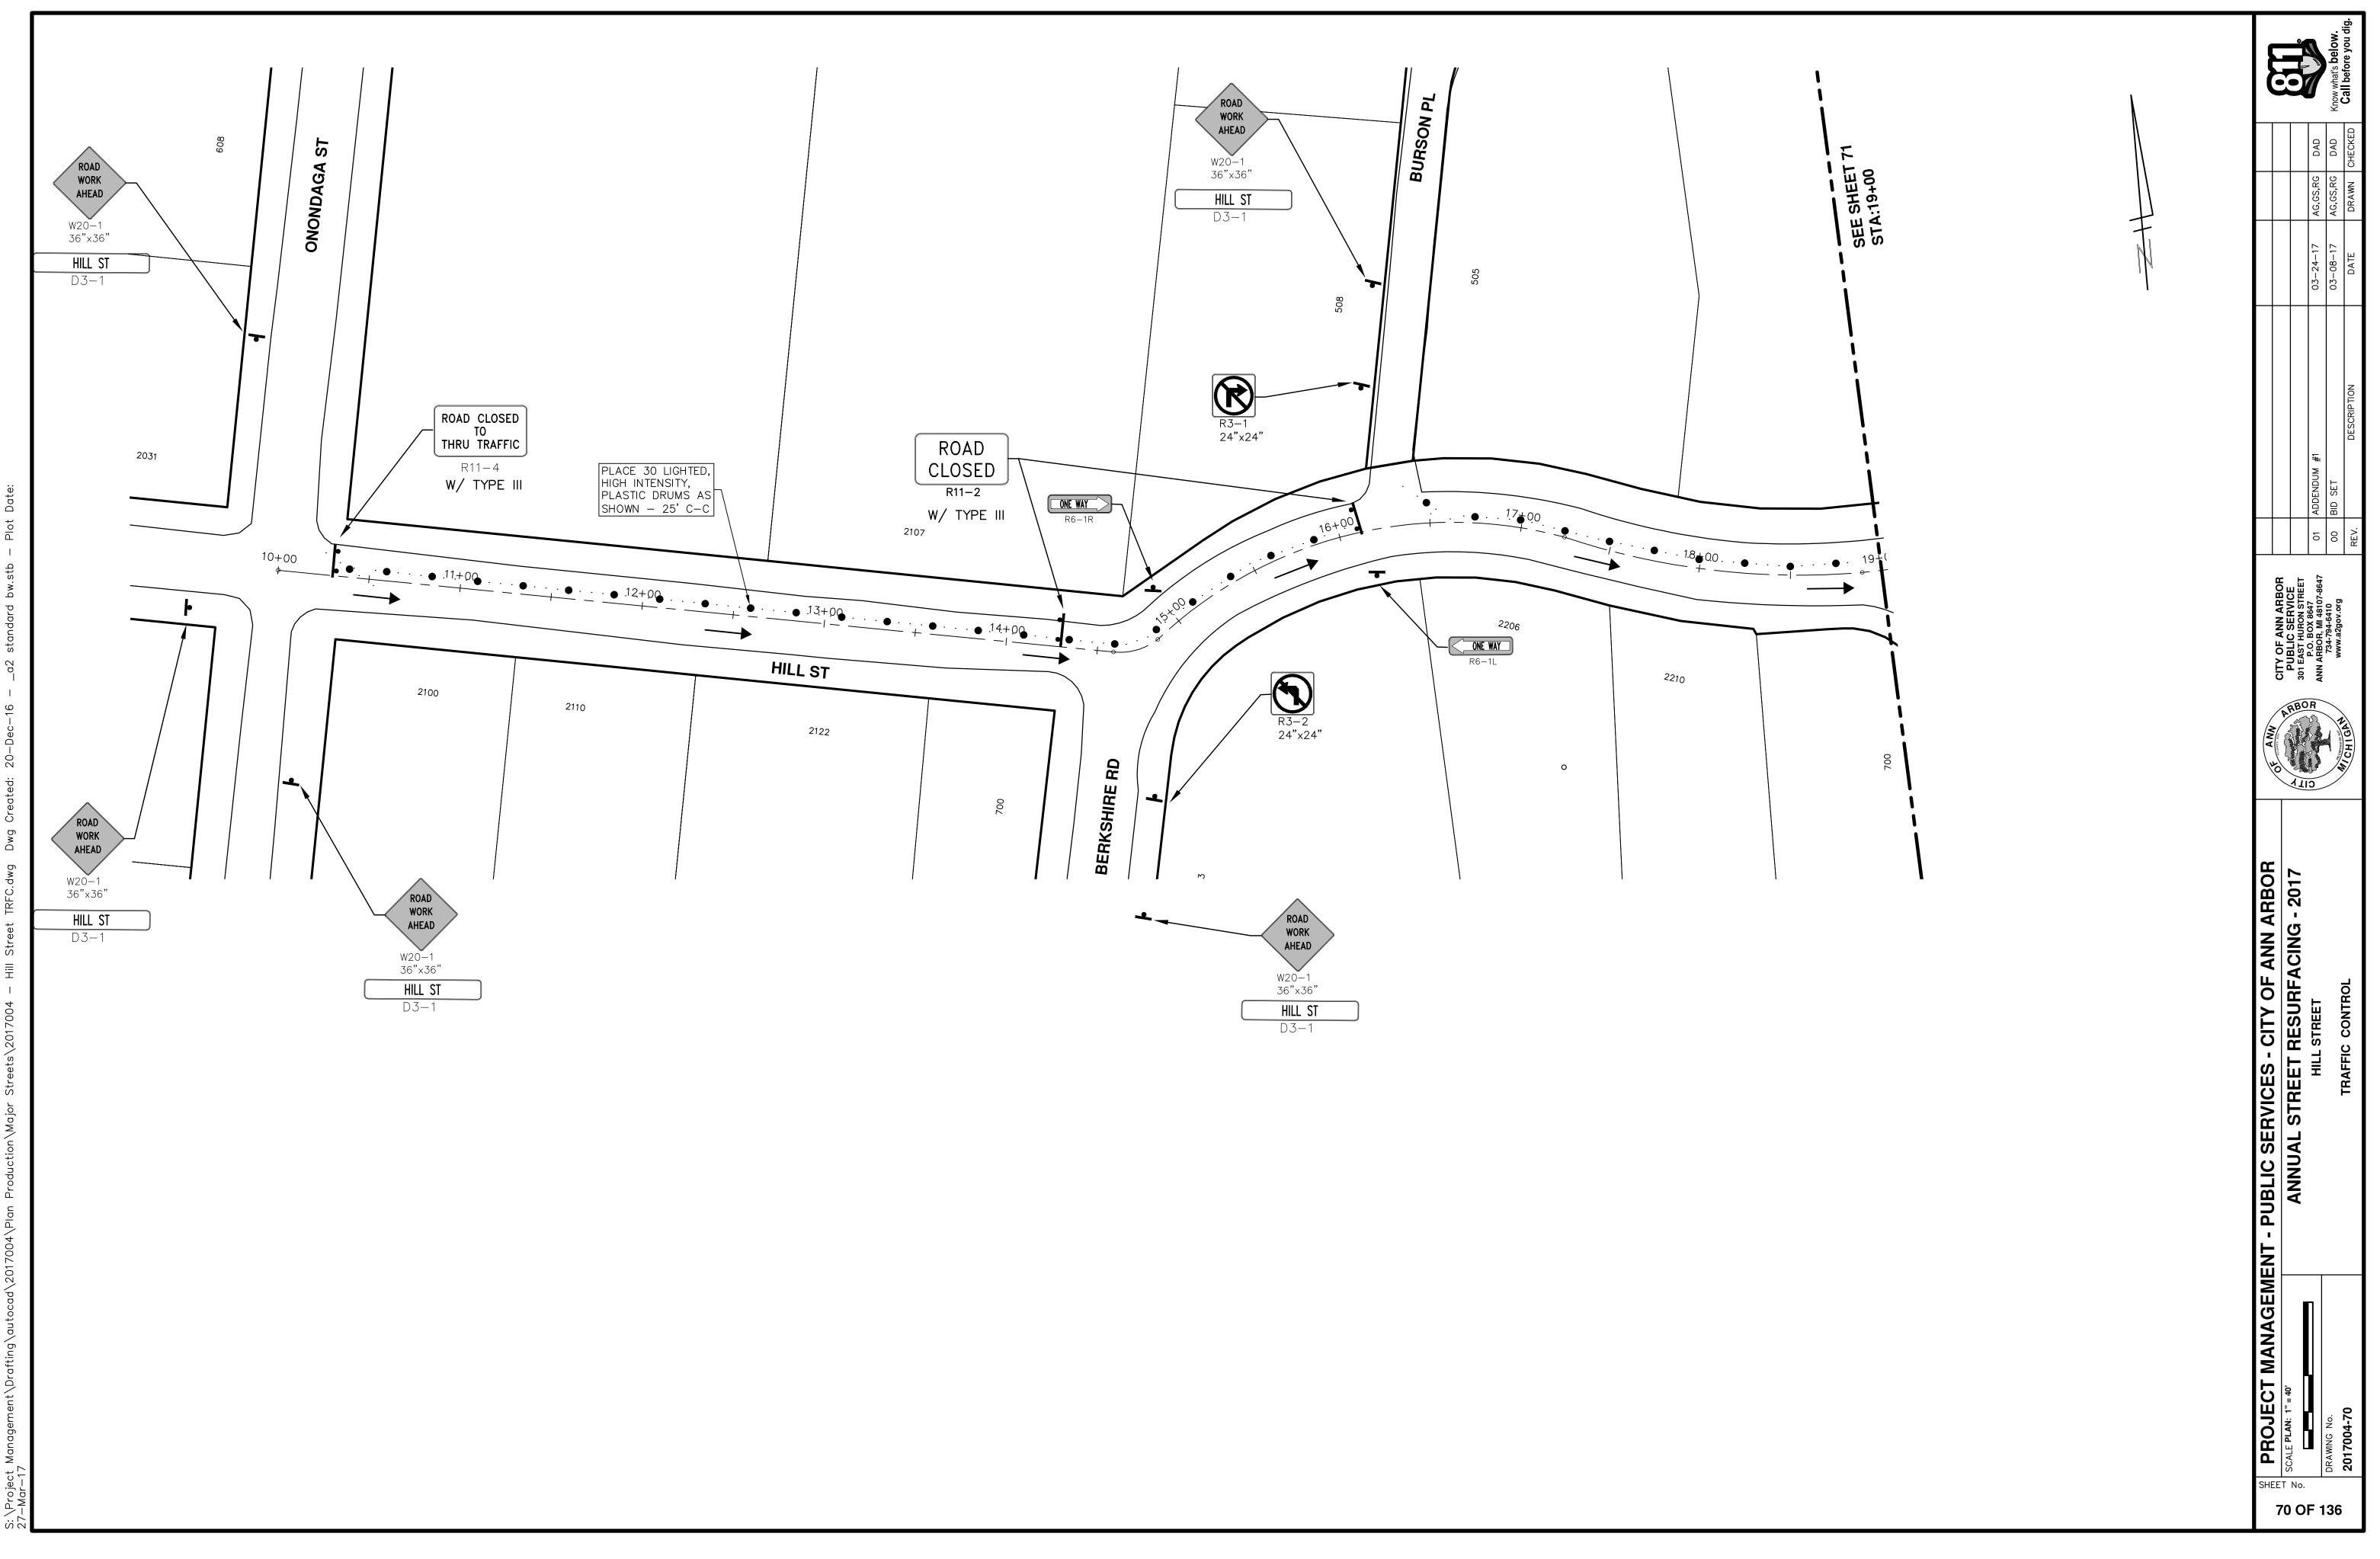


Dwg δ C Str 40

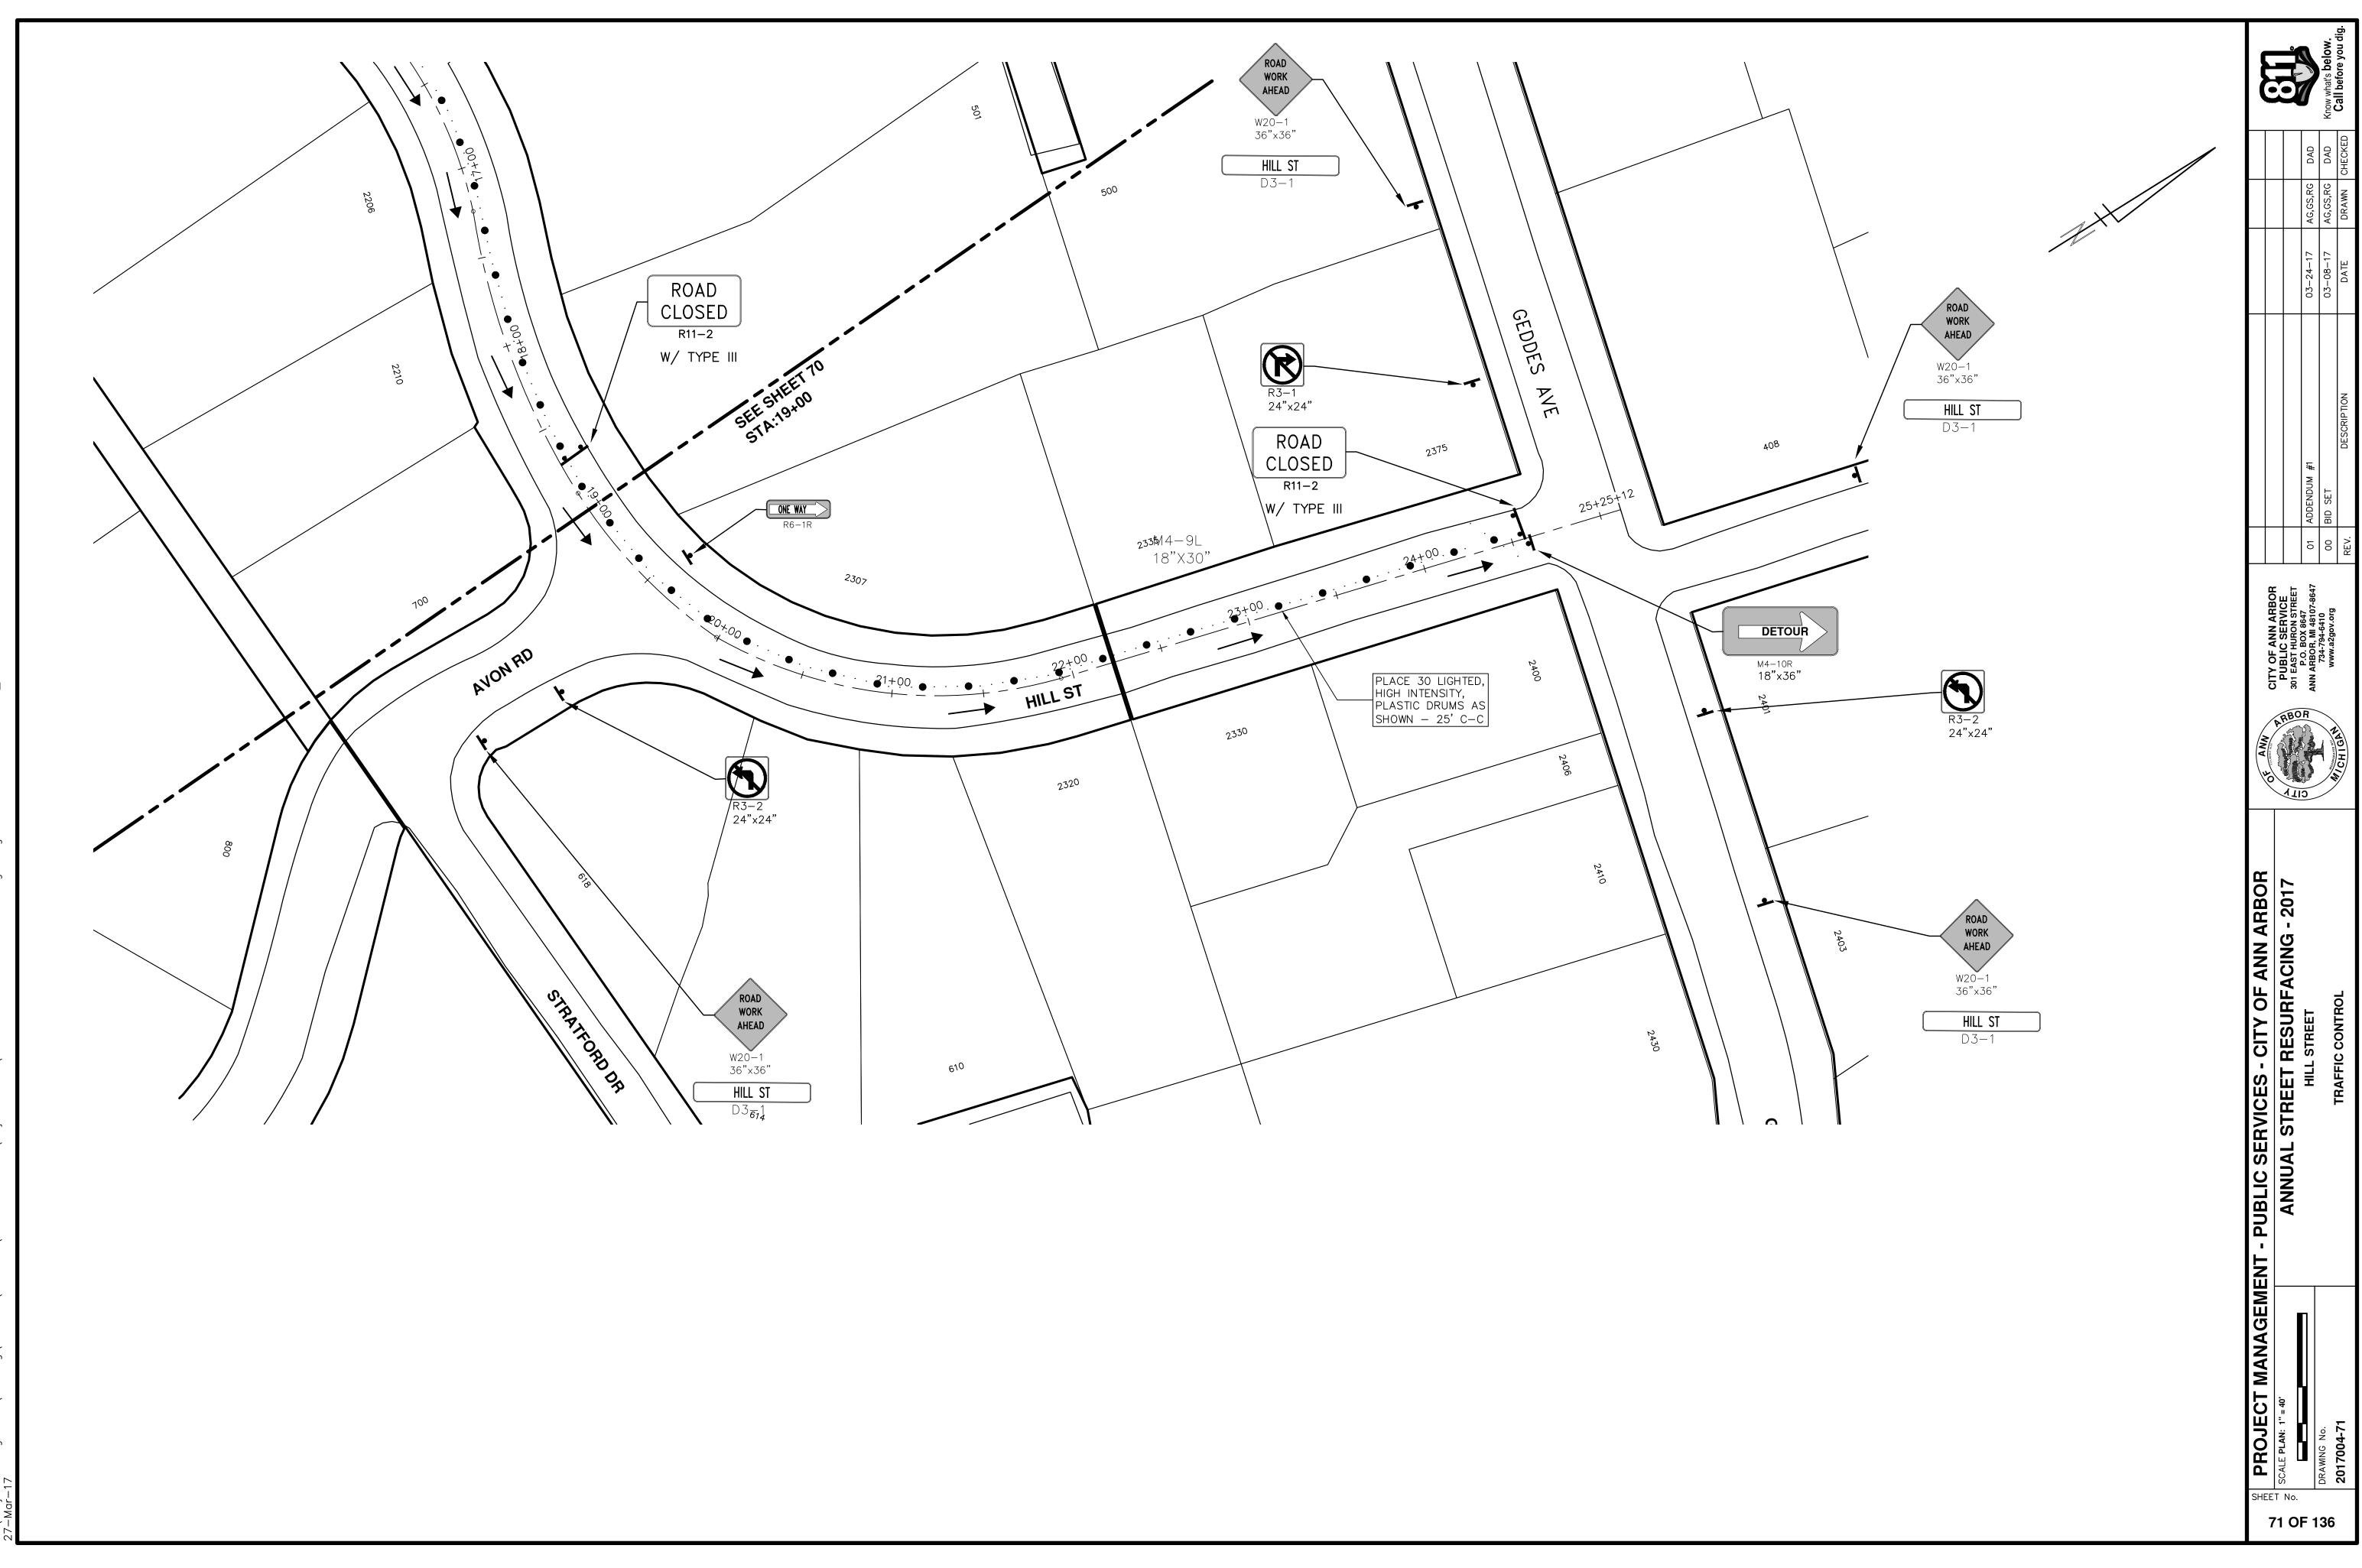

Str 40 \Project 7-Mar-17 S'N

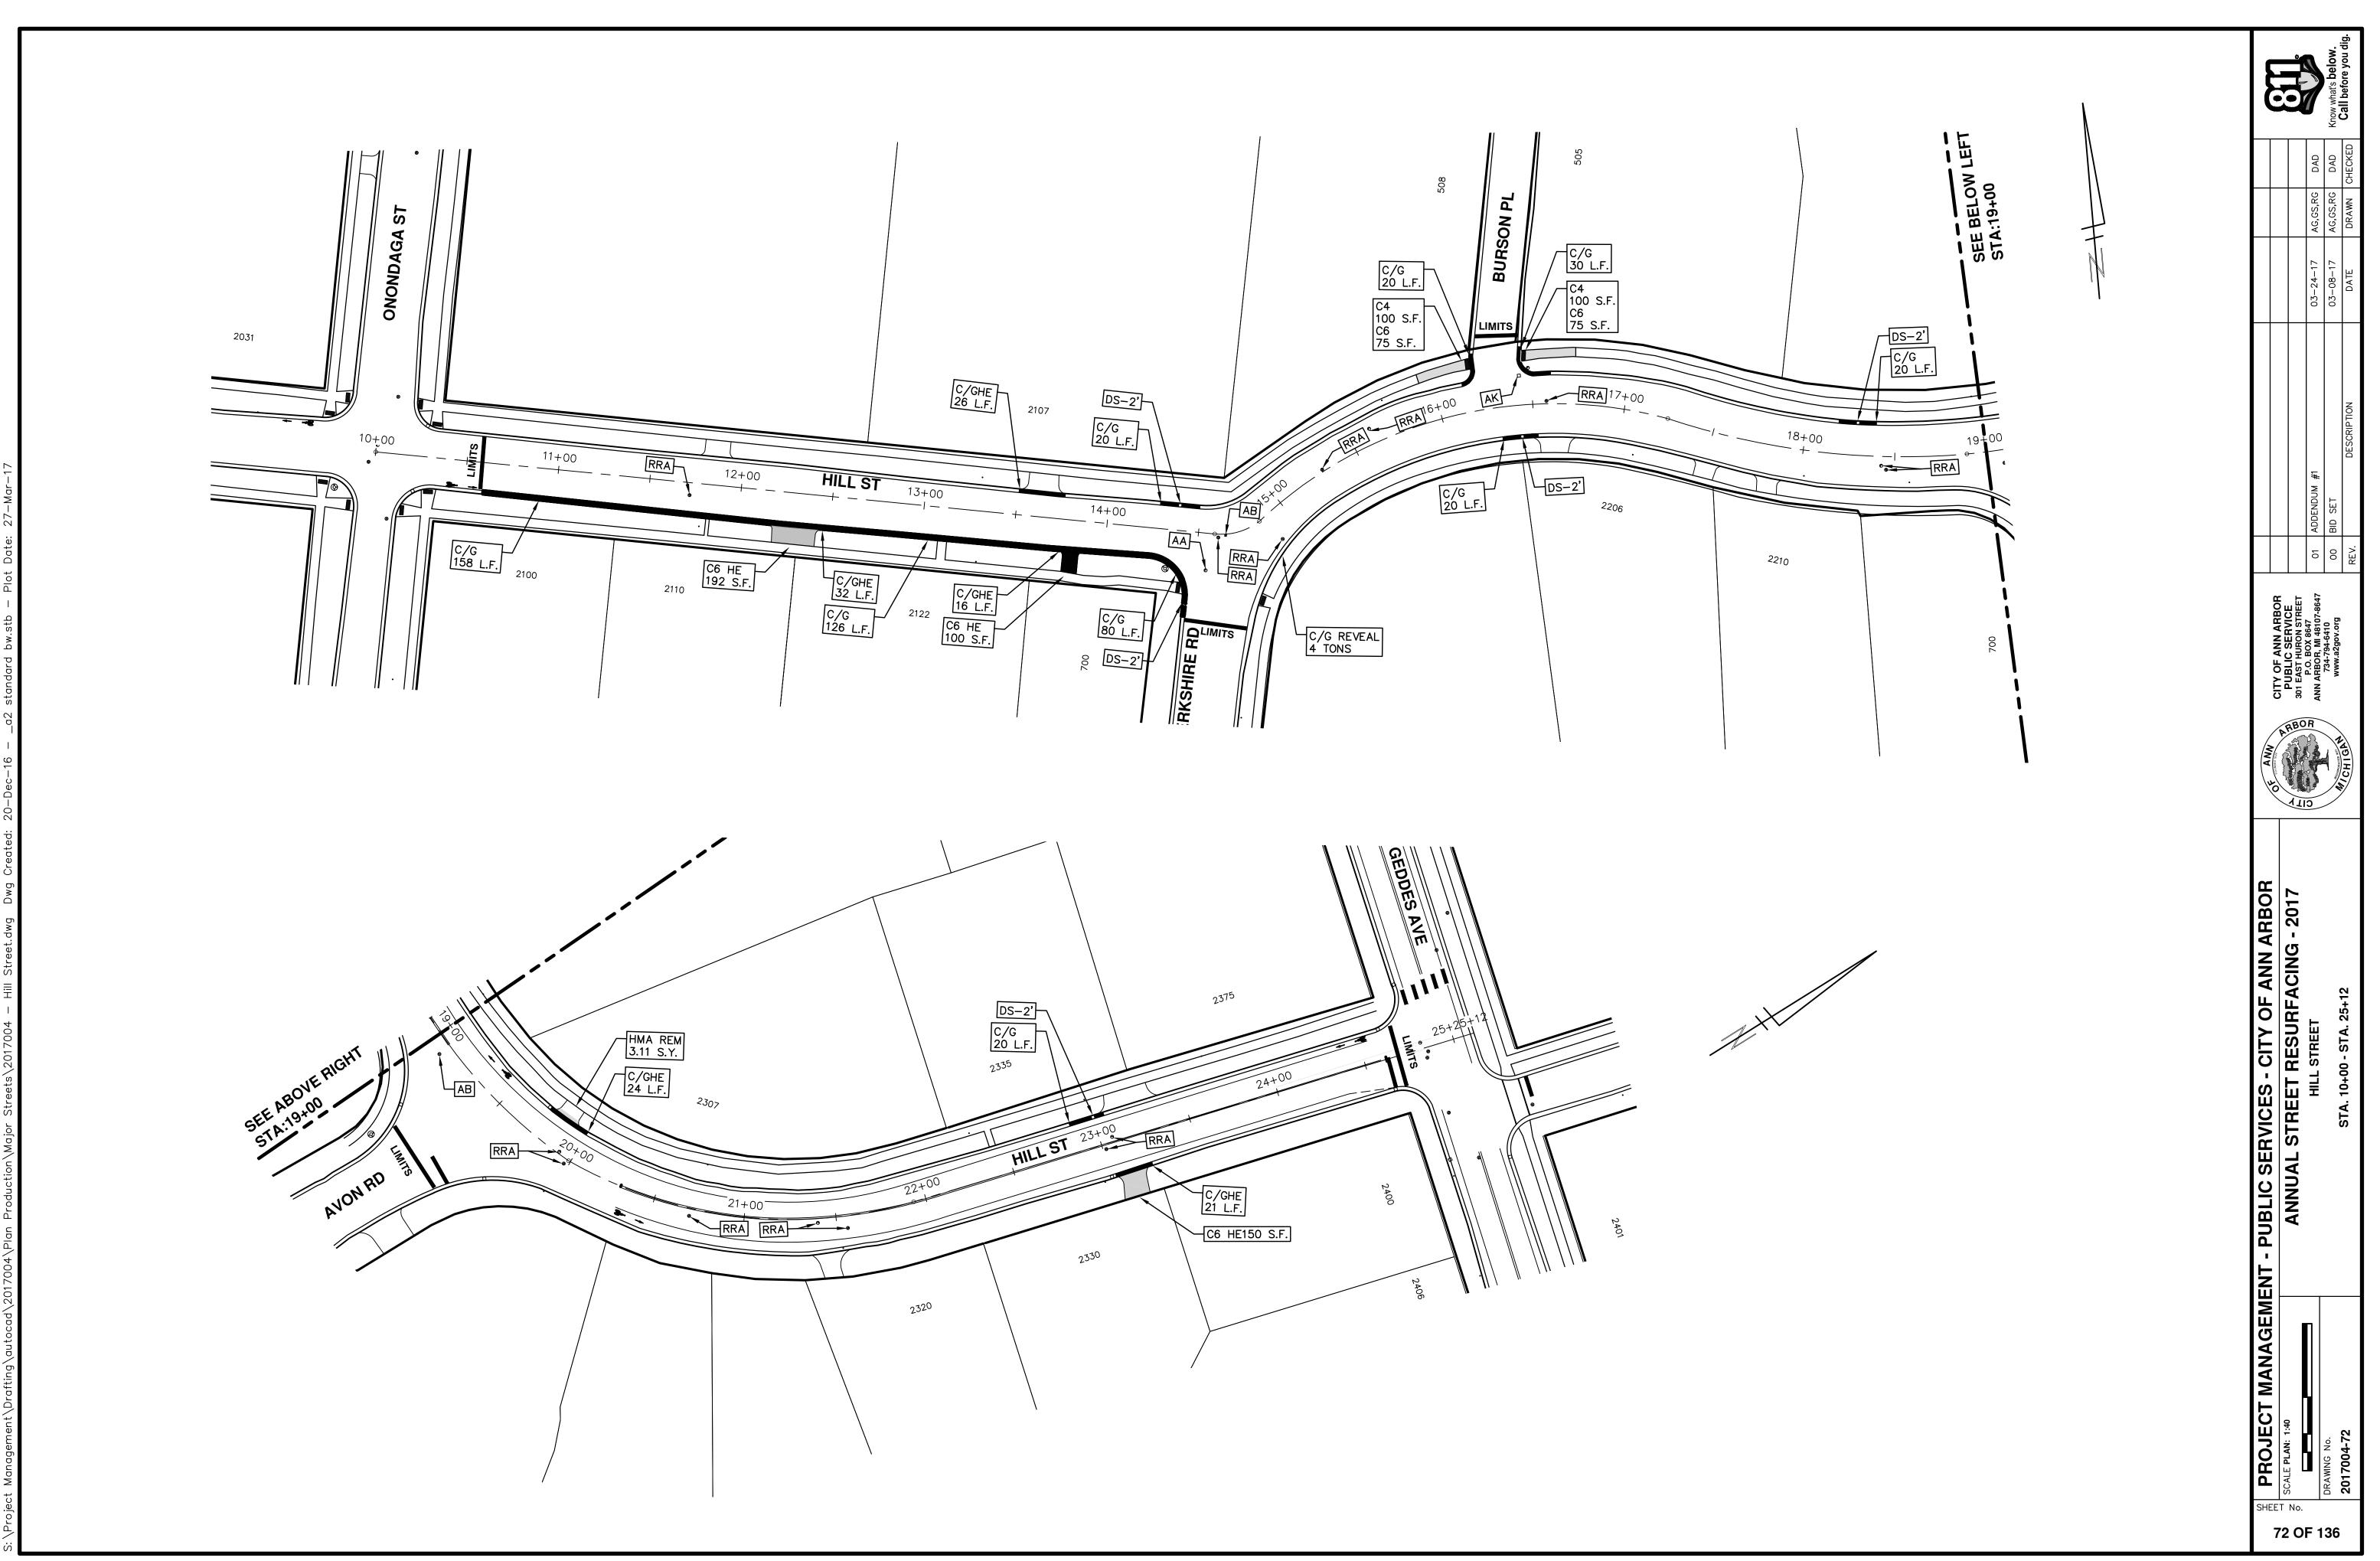

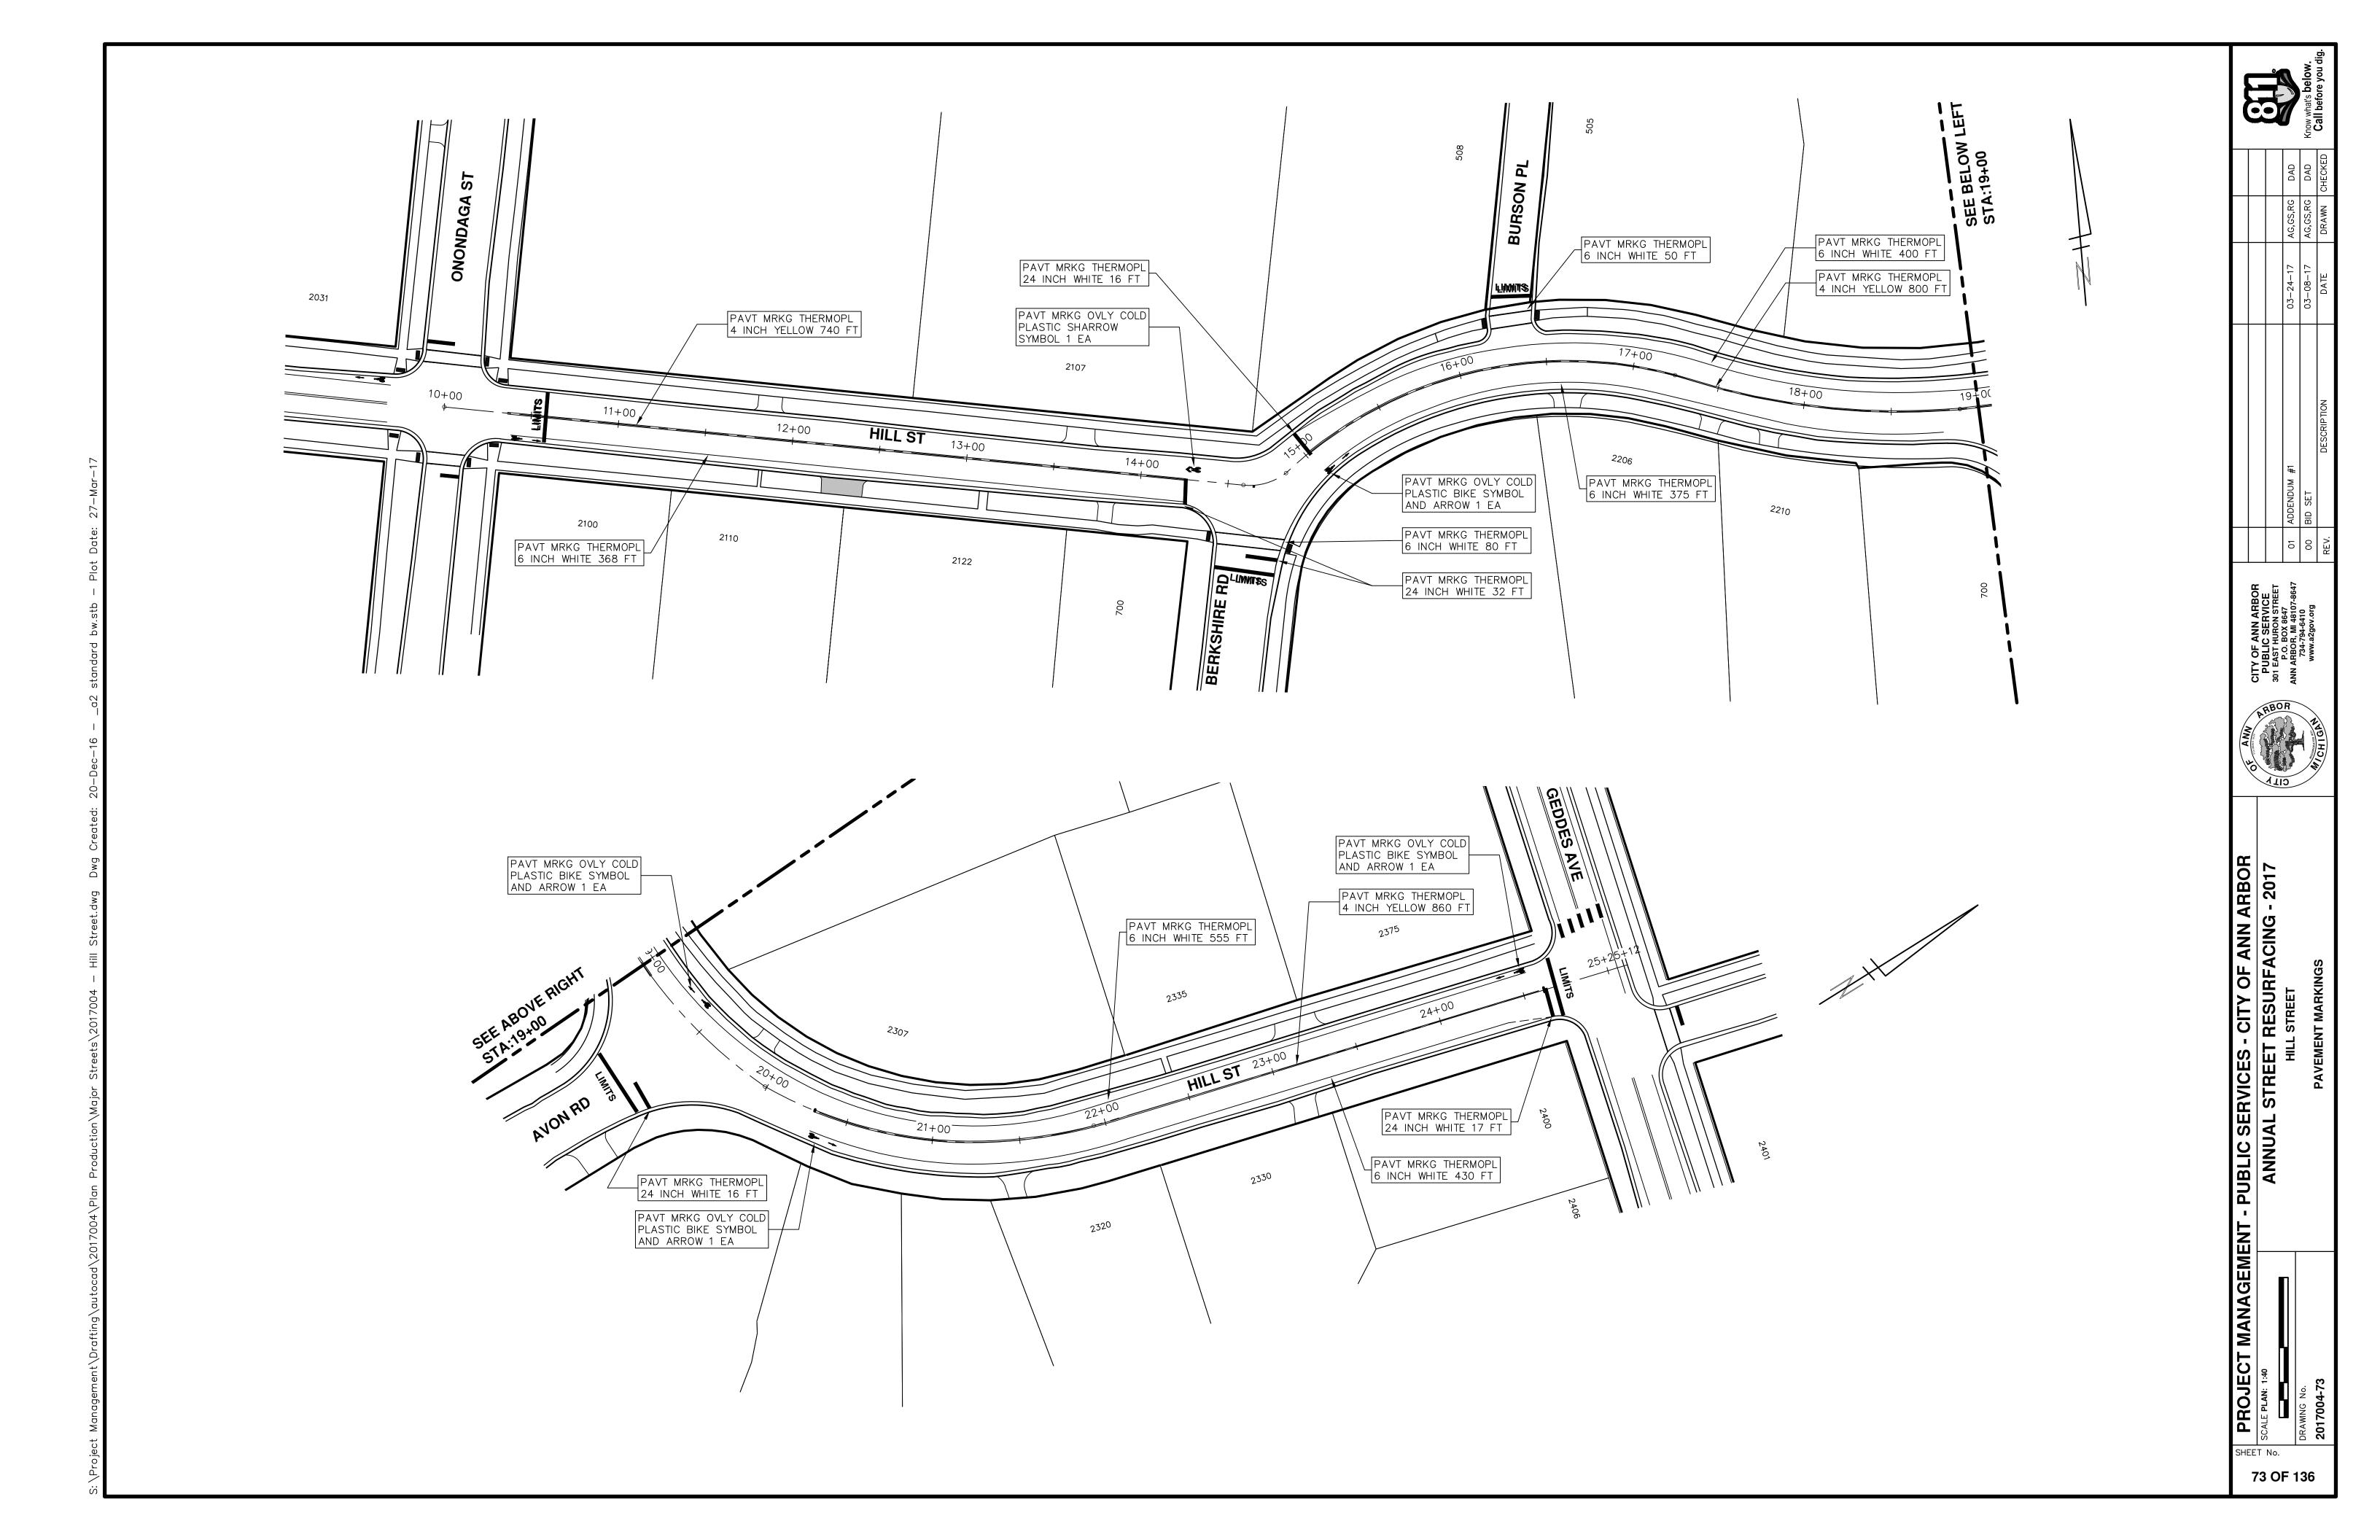



CITY OF ANN ARBOR PROJECT MANAGEMENT PROJECT LOCATION: MILLER AVENUE ITB No. 4477 FILE No. 2017-004 **CONSTRUCTION METHOD AND SEQUENCING**

	QUANTITIES		
ltem Code	Item Description	Units	Quantity
2047001	_Curb, Gutter, and Curb and Gutter, Any Type, Rem	Ft	692.000
2047011	_Sidewalk, Sidewalk Ramp, and Driveway Approach, Any Thickness, Rem	Syd	200.000
2057011	_Grading, Sidewalk	Syd	6.000
2057011	_Grading, Sidewalk Ramp	Syd	17.000
2057021	_Subgrade Undercutting, Type IIA	Cyd	188.000
2080020	Erosion Control, Inlet Protection, Fabric Drop	Ea	7.000
4037050	_Dr Structure, Adj, Case 1, Modified	Ea	1.000
5010003	Cold Milling HMA Surface	Ton	1,275.000
5010005	HMA Surface, Rem	Syd	16.000
5010057	HMA, 5E3	Ton	1,275.000
5017050	_HMA Surface, Around Structure Cover, Rem	Ea	4.000
6027021	_Flowable Fill	Cyd	25.630
6030005	Cement	Ton	1.000
8027001	_Curb and Gutter, Conc	Ft	50.000
8027001	_Driveway Opening, Conc, Det M, Modified	Ft	20.000
8037001	_Detectable Warning Surface, Modified	Ft	5.000
8037010	_Sidewalk Ramp, Conc, 6 inch, Modified	Sft	150.000
8037010	_Sidewalk, Conc, 4 inch, Modified	Sft	50.000
8050020	Curb Vertical, HMA	Ft	622.000
8110520	Pavt Mrkg, Wet Retrflec, Thermopl, 4 inch, White	Ft	4,735.000
8110524	Pavt Mrkg, Wet Retrflec, Thermopl, 4 inch, Yellow	Ft	5,068.000
8117001	_Pavt Mrkg, Wet Retrflec, Thermopl, 12 inch, Crosswalk	Ft	240.000
8117001	_Pavt Mrkg, Wet Retrflec, Thermopl, 24 inch, Stop Bar	Ft	70.000
8117050	_Pavt Mrkg, Wet Retrflec, Thermopl, Only	Ea	3.000
8117050	_Pavt Mrkg, Wet Retrflec, Thermopl, Thru Arrow Sym	Ea	2.000
8117050	_Pavt Mrkg, Wet Retrflec, Thermopl, Lt Turn Arrow Sym	Ea	1.000
8117050	_Pavt Mrkg, Wet Retrflec, Thermopl, Rt Turn Arrow Sym	Ea	1.000
8117050	_Pavt Mrkg, Wet Retrflec, Thermopl, Thru Arrow Sym	Ea	2.000
8120012	Barricade, Type III, High Intensity, Double Sided, Lighted, Fum	Ea	7.000
8120013	Barricade, Type III, High Intensity, Double Sided, Lighted, Oper	Ea	7.000
8120140	Lighted Arrow, Type C, Furn	Ea	1.000
8120141	Lighted Arrow, Type C, Oper	Ea	1.000
8120260	Plastic Drum, High Intensity, Lighted, Fum	Ea	140.000
8120261	Plastic Drum, High Intensity, Lighted, Oper	Ea	140.000
8120331	Sign, Portable, Changeable Message, Oper	Ea	2.000
8120350	Sign, Type B, Temp, Prismatic, Furn	Sft	407.500
8120351	Sign, Type B, Temp, Prismatic, Oper	Sft	407.500
8127050	_No Parking Sign	Ea	41.000
8167011	Slope Restoration	Syd	254.000

	CONSTRUCTION KEY
KEY	ASSOCIATED PAY ITEM(S)
	Dr Structure, Adj, Case 1, Modified
AA	• Dr Structure, Adj, Case 2, Modified
	Dr Structure, Temp Lowering, Modified
	Dr Structure, Temp Lowering, Modified
	• _Gate Box, Adj, Case 1
AB	• Gate Box, Adj, Case 2
	Monument Box Adjust
ADST	_Dr Structure, Adj, Add Depth, Modified
AK	_Dr Structure, Adj, Case 1, Modified
	• _Sidewalk, Sidewalk Ramp, and Driveway Approach, Any Thickness, Rem
C4	• _Grading, Sidewalk
	 _Sidewalk, Conc, 4 inch, Modified
	• _Sidewalk, Sidewalk Ramp, and Driveway Approach, Any Thickness, Rem
C4HE	_Grading, Sidewalk
UTIL	• Cement
	• _Sidewalk, Conc, 4 inch, Modified
	• _Sidewalk, Sidewalk Ramp, and Driveway Approach, Any Thickness, Rem
	• _Grading, Sidewalk
C6	_Grading, Sidewalk Ramp
00	 _Detectable Warning Surface, Modified
	 _Sidewalk Ramp, Conc, 6 inch, Modified
	_Sidewalk, Conc, 6 inch, Modified
C8	 _Grading, Driveway Approach
	Driveway, Nonreinf Conc, 8 inch, Modified
	• _Sidewalk, Sidewalk Ramp, and Driveway Approach, Any Thickness, Rem
	 _Grading, Driveway Approach
	• _Grading, Sidewalk
	• _Grading, Sidewalk Ramp
CHE	• Cement
	Driveway, Nonreinf Conc, 6 inch, Modified
	 _Driveway, Nonreinf Conc, 8 inch, Modified
	 _Detectable Warning Surface, Modified
	 _Sidewalk Ramp, Conc, 6 inch, Modified
	_Sidewalk, Conc, 6 inch, Modified
C/G	 _Curb, Gutter, and Curb and Gutter, Any Type, Rem
	_Curb and Gutter, Conc
	• _Curb, Gutter, and Curb and Gutter, Any Type, Rem
C/GHE	• Cement
	Driveway Opening, Conc, Det M, Modified
CP	• _Grading, Sidewalk
	Sidewalk, Conc, 4 inch, Modified
CR	Sidewalk, Sidewalk Ramp, and Driveway Approach, Any Thickness, Rem
	Dr Structure, Rem
DS	Sewer, Rem, Less than 24 inch Dr Structure, 24 inch die
	Dr Structure, 24 inch dia
DODI	Dr Structure, Rem
DSDI	Sewer, Rem, Less than 24 inch Dr. Structure, Double lalet
рт	Dr Structure, Double Inlet
PT	_Dr Structure, Point
	Dr Structure Cover, Type B
RRA	_Dr Structure Cover, Type B, Special
	_Dr Structure, Adj, Case 1, Modified
	_Dr Structure, Temp Lowering, Modified
RRK	Dr Structure Cover, Type K
	_Dr Structure, Adj, Case 1, Modified
RS	_Dr Structure, Reconstruct
TYPE II	Plastic Drum, High Intensity, Lighted, Furn
	Plastic Drum, High Intensity, Lighted, Oper
TYPE III	Barricade, Type III, High Intensity, Double Sided, Lighted, Furn
	 Barricade, Type III, High Intensity, Double Sided, Lighted, Oper

, mounou
<
I, Modified
t
ty, Lighted, Furn
ty, Lighted, Oper
tensity, Double Sided, Lighted, Furn
and a second

	LEGEND
SYMBOL	DESCRIPTION
S	EXISTING SANITARY SEWER MANHOLE
(7)	EXISTING STORM SEWER MANHOLE
\otimes	EXISTING WATER MAIN VALVE IN WELL
+	WATER MAIN GATE VALVE IN BOX
+Ŷ+	FIRE HYDRANT
(g)	MICHCON GAS CO. VALVE BOX/WELL
t	AMERITECH TELEPHONE VAULT
e	ELECTRIC MANHOLE
\bullet	SOIL BORING
	EXISTING STORM SEWER INLET
٥	MONUMENT BOX
	REMOVE AND REPLACE CONC. SIDEWALK
	PLACE CONCRETE SIDEWALK
	REMOVE & REPLACE CONC. CURB & GUTTER
	CONSTRUCTION LIMITS
<u> </u>	6" WRAPPED UNDERDRAIN
	REMOVE CONCRETE SIDEWALK
	SUBGRADE UNDERCUT

VORK ON THIS STREET INCLUDES, BU ACCORDANCE WITH THE PLANS AND SP TWO (2) PHASE CONSTRUCTION. PEF AUTHORIZED OR DIRECTED BY THE CURRENTLY IN PLACE, LANE CLOSURES

- <u>PHASE I</u>
- 1. IMPLEMENT MAINTENANCE OF TRAF CONTROL MEASURES.
- 2. CONDUCT REMOVAL WORK RELATED COLDMILLING.
- 3. INSTALL PROPOSED DRAINAGE STRU
- 4. PERFORM ALL CONCRETE WORK, IN
- 5. REMOVE 2 INCHES OF EXISTING HM
- 6. PERFORM ALL JOINT AND CRACK C REQUIRED.
- 7. CLEAN PAVEMENT AND PLACE 2 IN

<u>PHASE II</u>

- 8. REPEAT ITEMS 1 THRU 6 IN THE OF
- 9. REMOVE 2 INCHES OF EXISTING HM
- 10. PERFORM ALL JOINT AND CRACK C REQUIRED.
- 11. CLEAN PAVEMENT AND PLACE 2 IN
- 12. CLEAN PAVEMENT AND PLACE HMA
- 13. CLEAN PAVEMENT AND COMPLETE
- 14. COMPLETE ALL MISCELLANEOUS CO
- 15. REMOVE ALL TRAFFIC CONTROL DE

NOT

		QUANTITIES			
	Sign, Type B, Temp, Prismatic				
Quantity	Sign Code	Description	Area (sft)	Total Area	
17.0	D3-1	Street Name Sign	4.000	68.000	
1.0	M4-10R	Detour Arrow Sign	6.000	6.000	
1.0	M4-8a	End Detour Sign	3.000	3.000	
1.0	M4-9L	Detour Sign (w/Left Arrow)	5.000	5.000	
2.0	M4-9R	Detour Sign (w/Right Arrow)	5.000	10.000	
4.0	M4-9S	Detour Sign (w/Thru Arrow)	5.000	20.000	
2.0	R5-1	Do Not Enter Sign	6.250	12.500	
2.0	R5-1A	Wrong Way Sign	6.000	12.000	
6.0	R11-2	Road Closed Sign ("Road Closed")	10.000	60.000	
2.0	R3-1	Movement Prohibition Sign ("No Right Turn")	4.000	8.000	
3.0	R3-2	Movement Prohibition Sign ("No Left Turn")	4.000	12.000	
1.0	R6-1 L	One Way (Left) Sign	3.000	3.000	
3.0	R6-1R	One Way (Right) Sign	3.000	9.000	
4.0	SP-1	Special Sign	20.000	80.000	
7.0	W20-1	Road Work Ahead Sign	9.000	63.000	
2.0	W20-2	Detour Ahead Sign	9.000	18.000	
2.0	W20-3	Road Closed Ahead Sign	9.000	18.000	
			TOTAL	407.50	






THE PROJECT CONTRACT DOCUMENTS.	PROJECT		RAWING No.
THE IMPROVEMENTS COVERED BY THESE PLANS SHALL BE PERFORMED IN ACCORDANCE WITH MICHIGAN DEPARTMENT OF TRANSPORTATION (MDOT) 2012 STANDARD SPECIFICATIONS FOR CONSTRUCTION, INCLUDING REFERENCED MDOT PUBLICATIONS, AND			
THE UNDERGROUND LOCATIONS SHOWN FOR NATURAL GAS, TELEPHONE, ELECTRICAL POWER, CABLE TV AND FIBER OPTIC LINES ARE APPROXIMATE. THE CITY OF ANN ARBOR ASSUMES NO RESPONSIBILITY FOR THEIR ACCURATE REPRESENTATION IN THIS DRAWING. MISS DIG MUST BE CONTACTED PRIOR TO CONSTRUCTION TO LOCATE THESE UTILITIES.	MANAGEMENT	<u>u</u>	
NOTES: FOR PROTECTION OF UNDERGROUND UTILITIES AND IN CONFORMANCE WITH PUBLIC ACT 174 OF 2013, THE CONTRACTOR SHALL CALL 811 OR 1-800-482-7171 A MINIMUM OF THREE FULL WORKING DAYS, EXCLUDING SATURDAYS, SUNDAYS, AND HOLIDAYS, PRIOR TO BEGINNING EACH EXCAVATION IN AREAS WHERE PUBLIC UTILITIES HAVE NOT BEEN PREVIOUSLY LOCATED. MEMBERS WILL THUS BE ROUTINELY NOTIFIED. THIS DOES NOT RELIEVE THE CONTRACTOR OF THE RESPONSIBILITY OF NOTIFYING UTILITY OWNERS WHO MAY NOT BE A PART OF THE "MISS DIG" ALERT SYSTEM.	- PUBLIC	PROJECT DESCRIPTION	
OL DEVICES, AND MISS DIG FLAGS.	SERVICE	ANNUAL	
JS CONSTRUCTION INCLUDING ALL CLEAN UP AND FINAL RESTORATION.	S		Σ
LETE ALL PAVEMENT MARKINGS.	В В	STREET	MILLE
E HMA APPROACHES AS REQUIRED.	0 -	-	ER A
E 2 INCH TOP COURSE HMA MIX (MAJOR STREETS).	CITY	RESUR	AVEN
ACK CLEANOUT. HMA/HAND PATCHING, UNDERCUTS AND/OR BASE REPAIRS AS	OF /	RFACING -	NUE
NG HMA SURFACE BY COLDMILLING.	ANN	5 7	
THE ORDER SHOWN SHOWN ABOVE.		2017	
E 2 INCH TOP COURSE HMA MIX (MAJOR STREETS).	ARBOR		
ACK CLEANOUT. HMA/HAND PATCHING, UNDERCUTS AND/OR BASE REPAIRS AS			
NG HMA SURFACE BY COLDMILLING.			
RK, INCLUDING RESTORATION.			
E STRUCTURES, STORM SEWER, AND UNDERDRAIN AS REQUIRED.			
LATED TO PAVEMENT, DRAINAGE, AND CONCRETE ITEMS WITH EXCEPTION TO			
TRAFFIC (M.O.T.) PLAN, AND INSTALL SOIL EROSION AND SEDIMENTATION			
S, BUT IS NOT LIMITED TO, THE FOLLOWING ITEMS. COMPLETE THE WORK IN ND SPECIFICATIONS, AS DIRECTED BY THE ENGINEER, AND UTILIZING PART WIDTH PERFORM THE WORK IN THE ORDER INDICATED BELOW UNLESS OTHERWISE THE ENGINEER. COMPLETE ITEMS 12 THRU 14 UTILIZING THE M.O.T. PLAN SURES, AND FLAG CONTROL OPERATIONS AS DIRECTED BY THE ENGINEER.			


ANN ARBOR, MICHIGAN 48107-8647 734-794-6410 www.a2gov.org

SHEET No. 74 OF 136

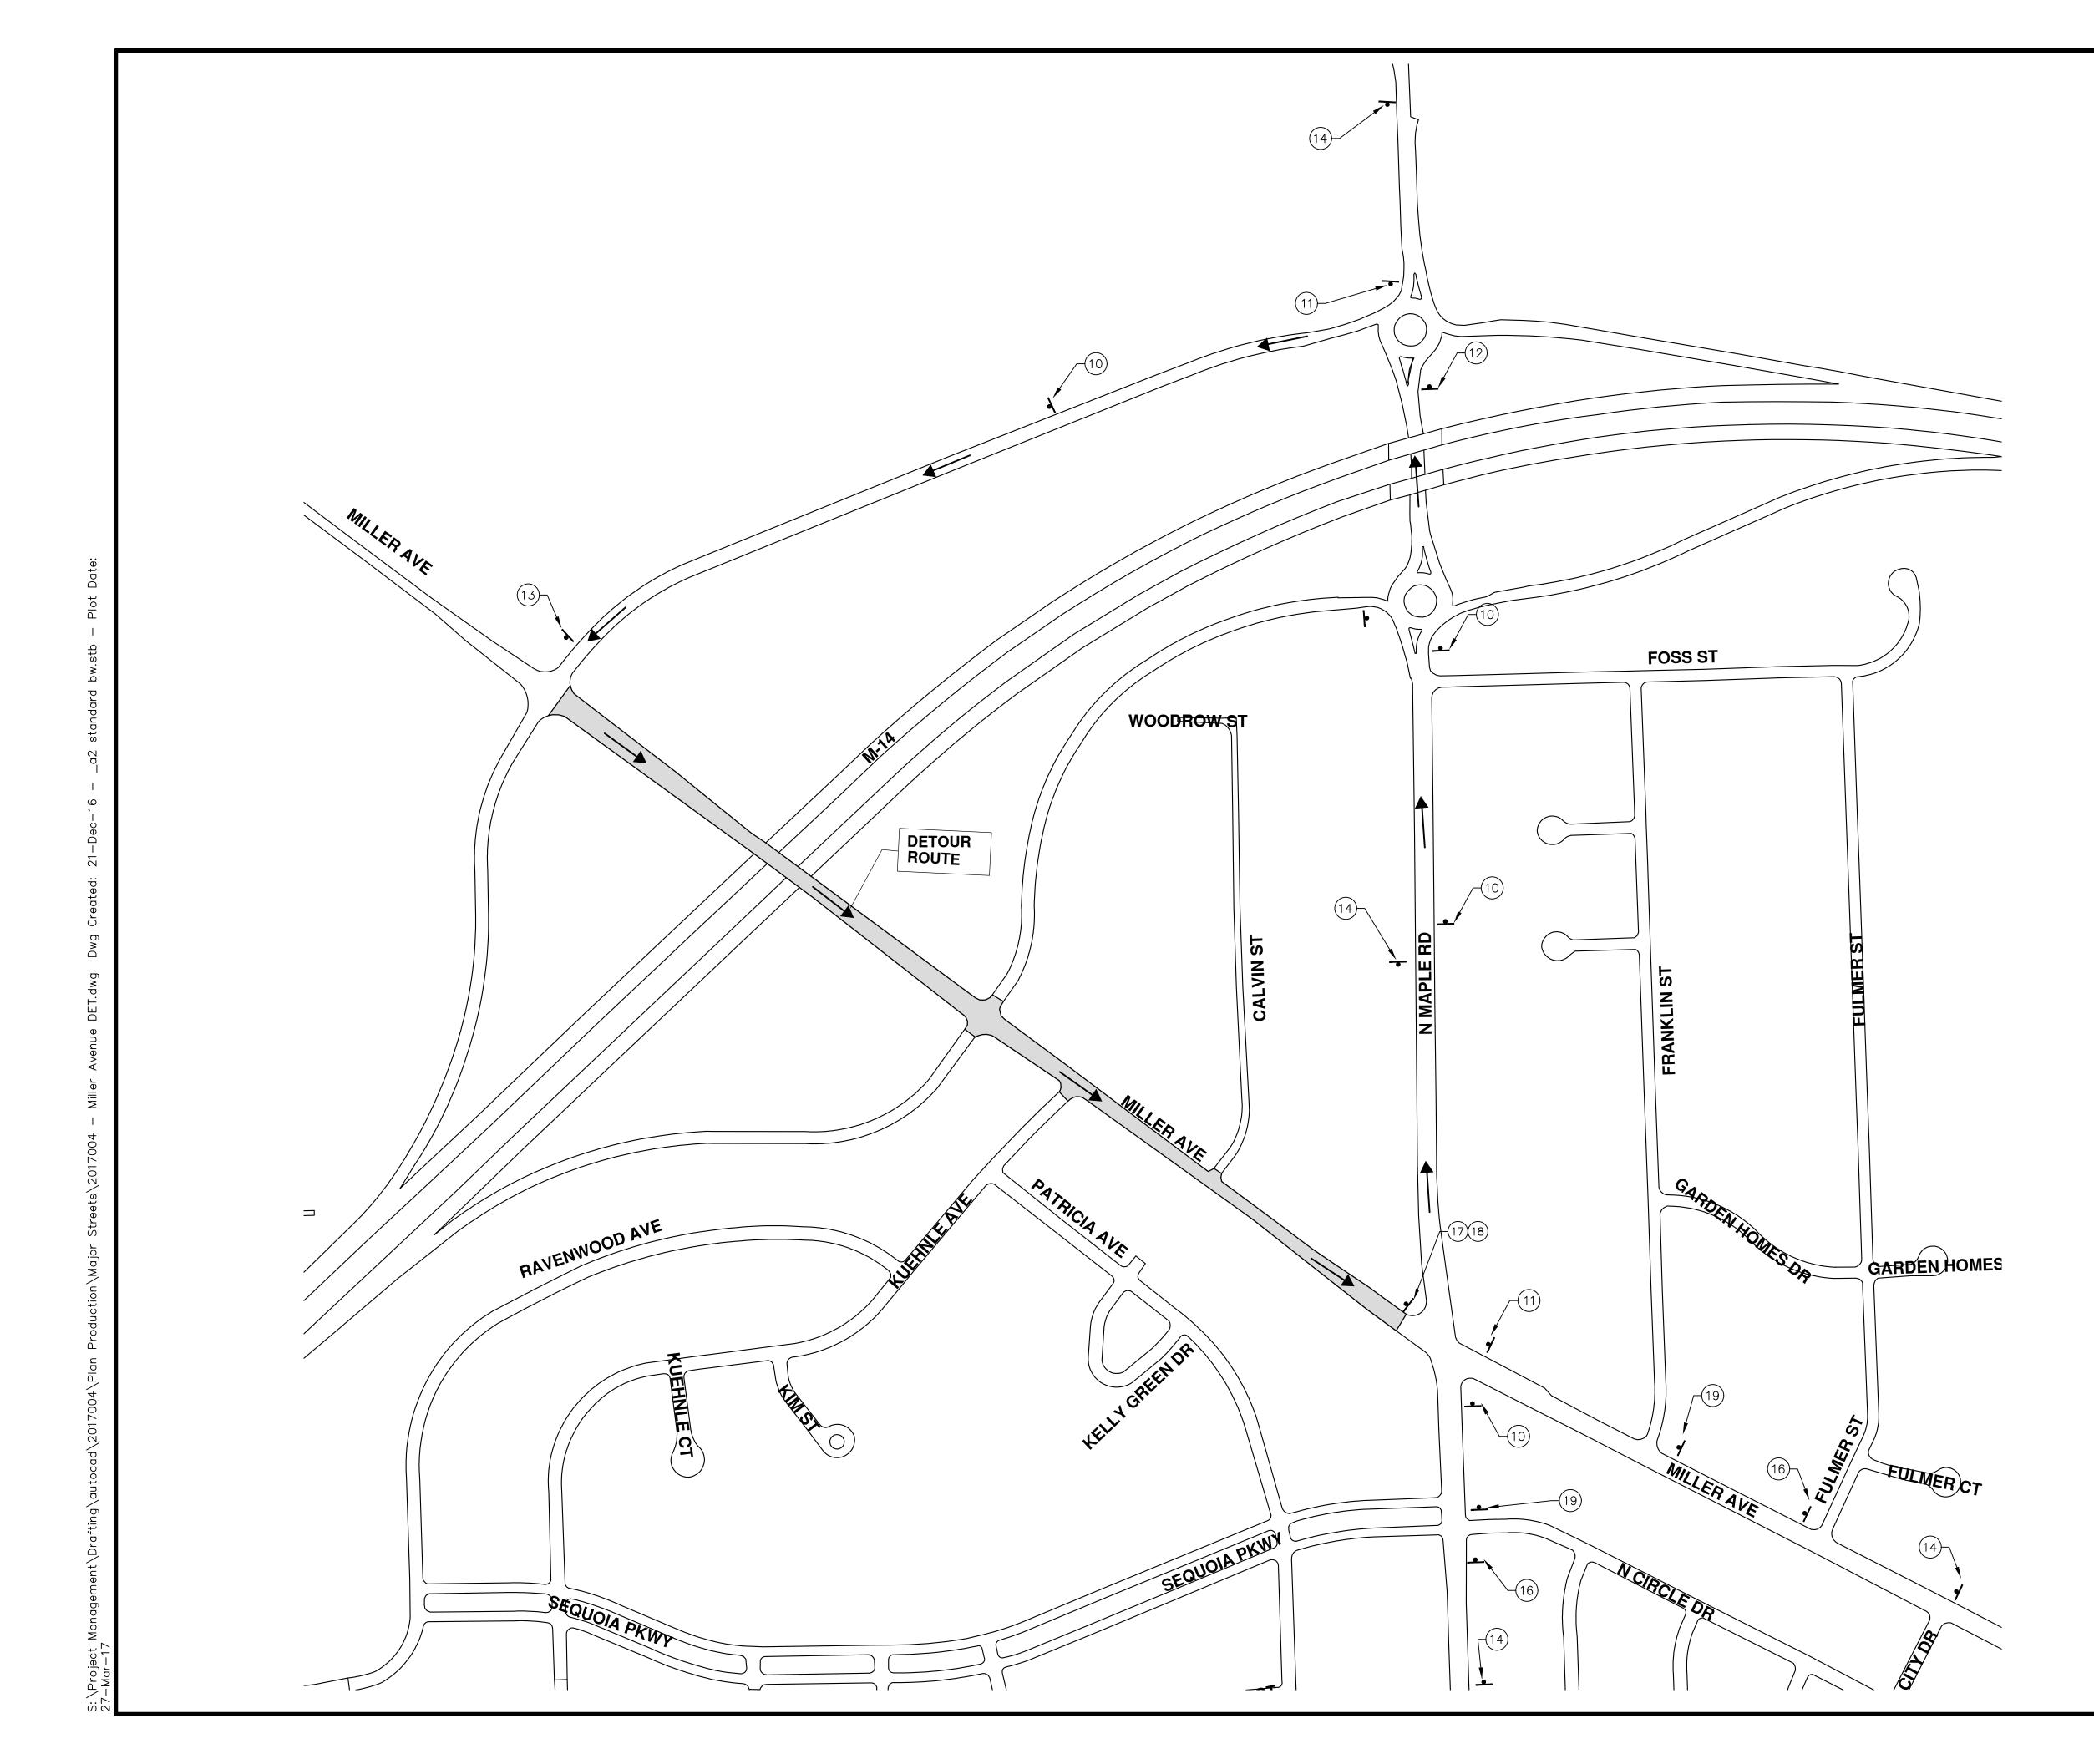


SH	PROJECT MANAGEME	VAGEMENT - PUBLIC SERVICES - CITY OF ANN ARBOR	ANN						
T No	SCALE PLAN: 1" = 200'	ANNUAL STREET RESURFACING - 2017							
_			ANN ARBOR, MI 48107-8647	5	01 AUDENDUM #1	03-24-1/	AG,GS,RG	DAD	
	DRAWING No.		734-794-6410	00	BID SET	03-08-17	AG,GS,RG	G DAD	Know what's below.
	2017004-75	DETOUR	MUNICHIGAN WWW.42901.019		DESCRIPTION	DATE			Call before you dig.
				REV.					,

TR	AFFIC CONTRO	L SIGN
TAG	SIGN	NUM.
	(MILLER AVE)	D3-1
10	DETOUR	M4-9S 30x24
		D3-1
11		M4-9R 30x24
		D3-1
12	DETOUR	M4-9L 30x24
		D3-1
13	DETOUR ENDS	M4—8a 24X18
(14)	WEST BOUND MILLER AVE CLORED AT MAPLE RD	SPECIAL 48x60
(15)	WEST BOUND MILLER AVE CLOBED	SPECIAL 48x60
16	DETOUR AHEAD W20-2 36"x36" MLLER AVE D3-1	W20-2 36"X36"
(17)	DO NOT BNTER R5-1 30x30	R5–1 30"X30"
(18)	WRONG WAY	R5–1A 42"x30"
(19)	ROAD CLOSED AHEAD W20-3 36"×36"	W20-3 36"x36"
	D3-1	

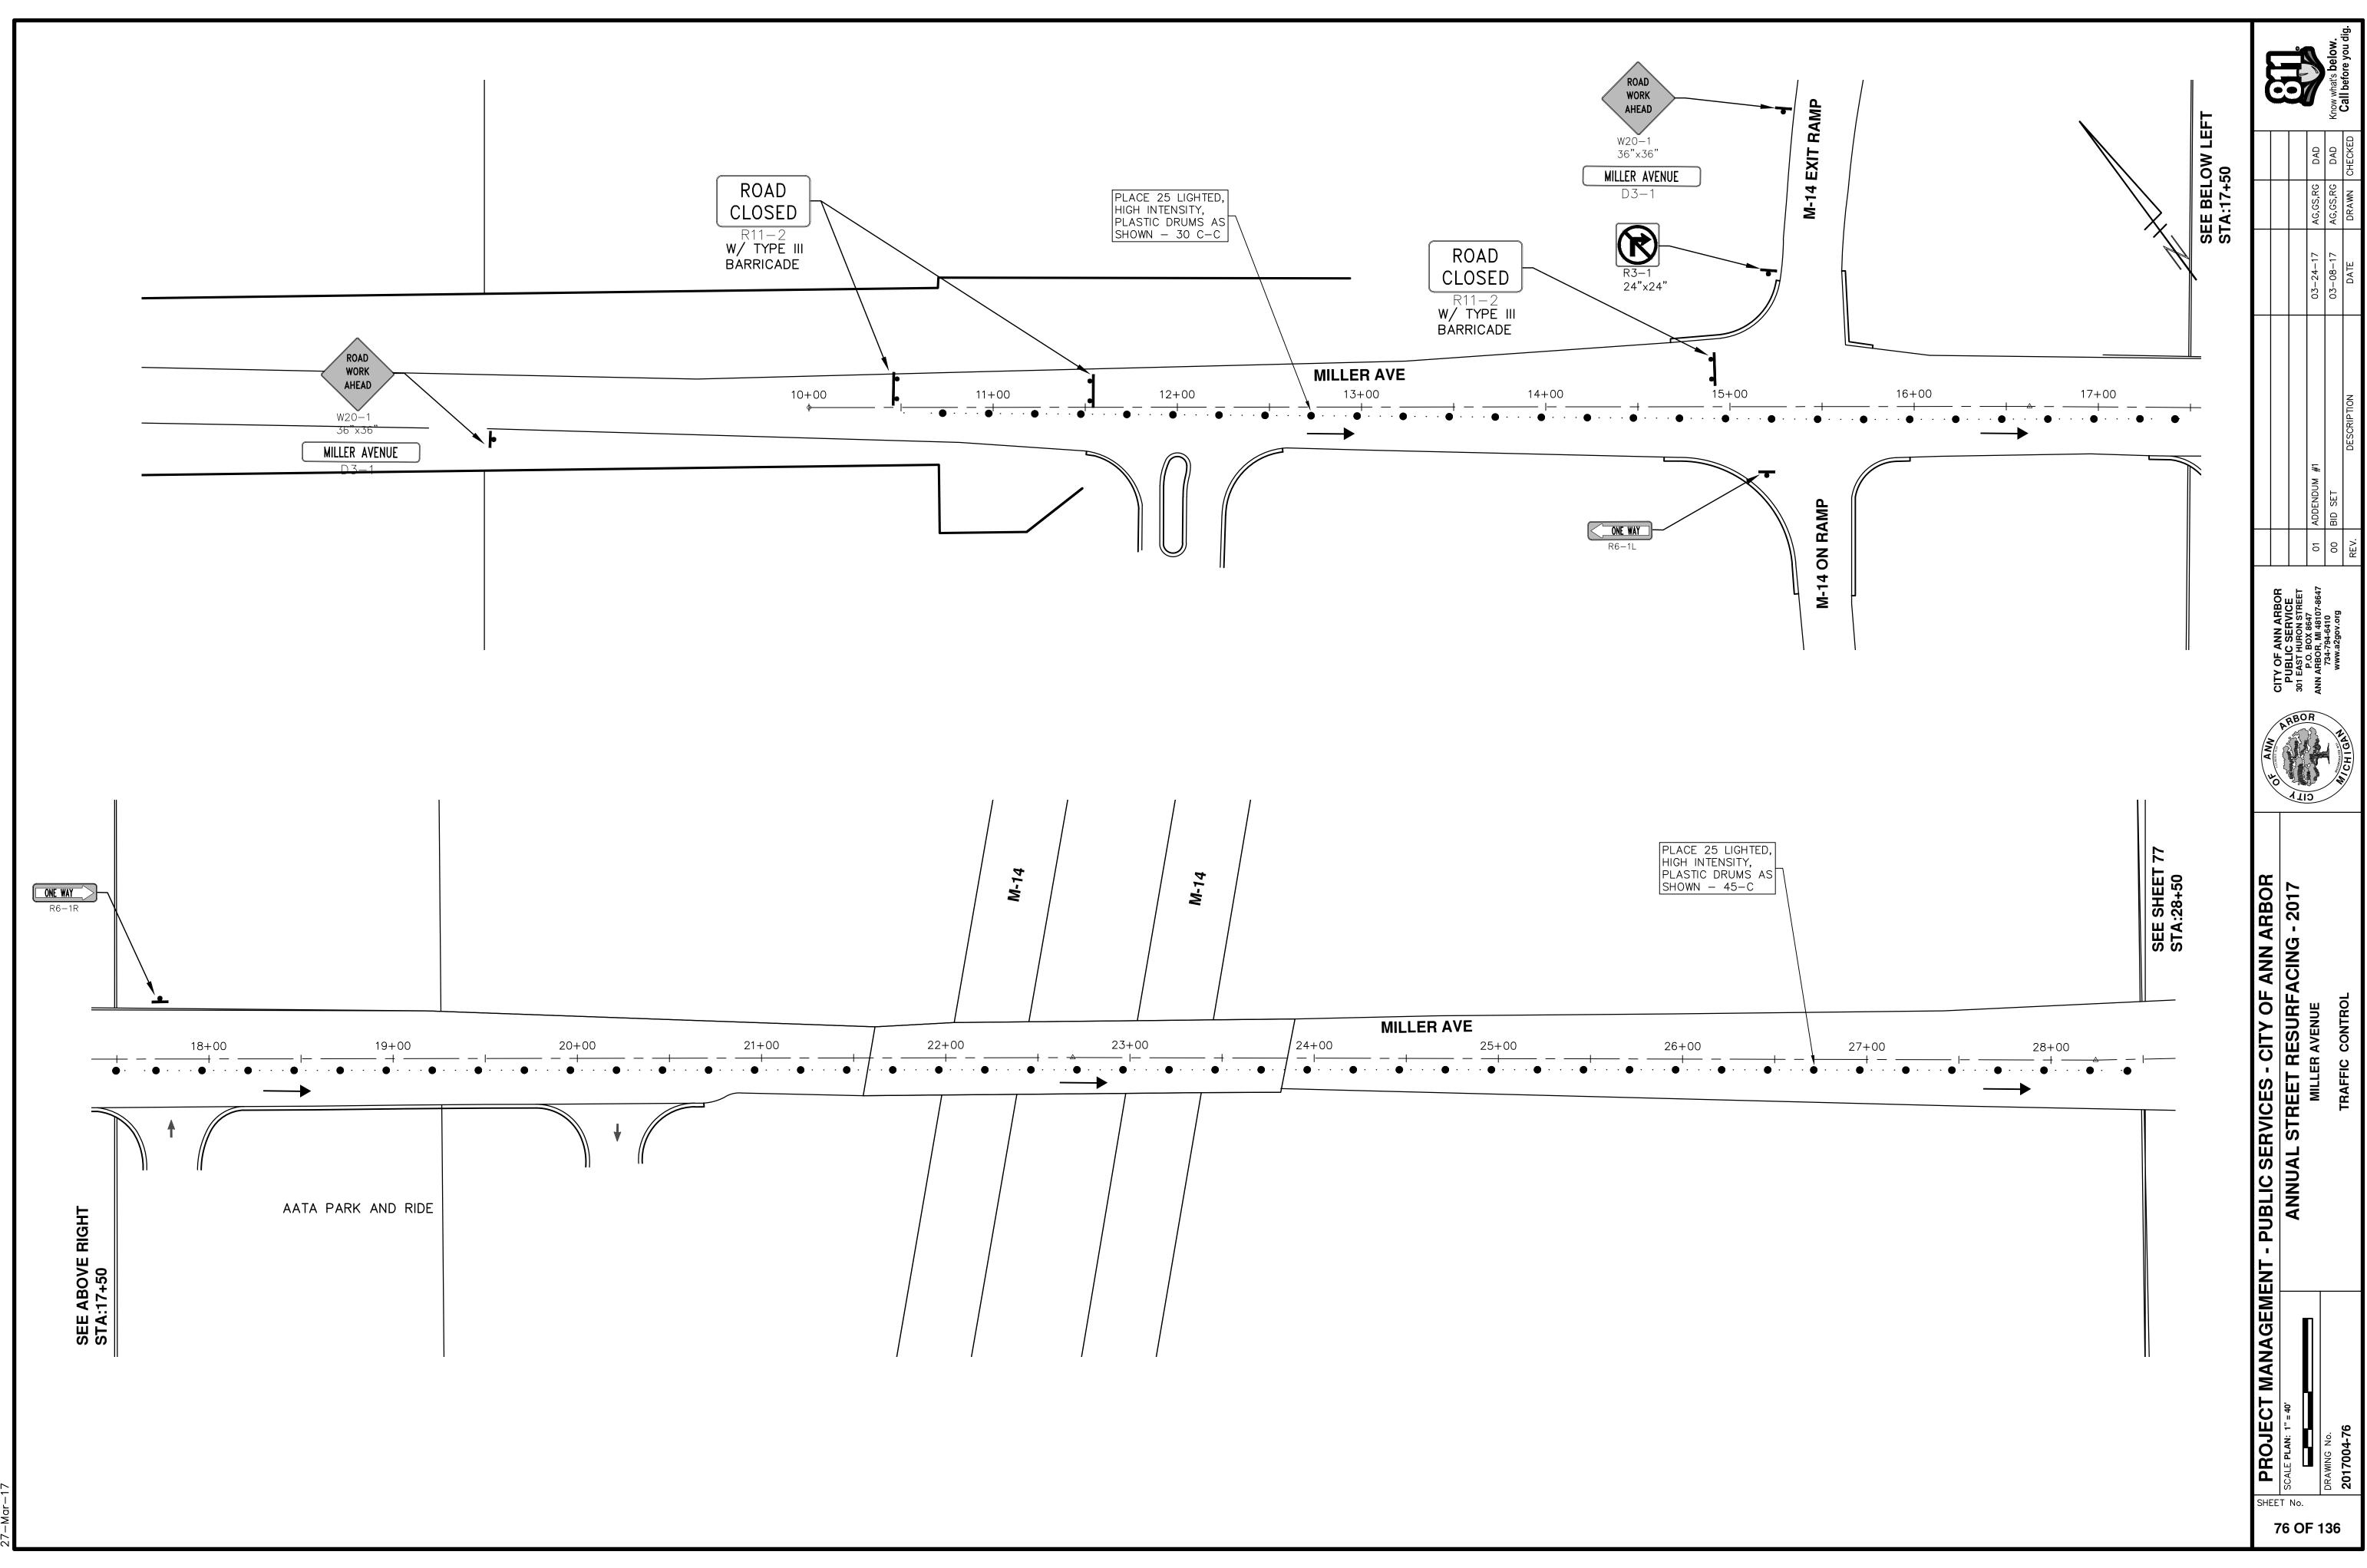



Ó

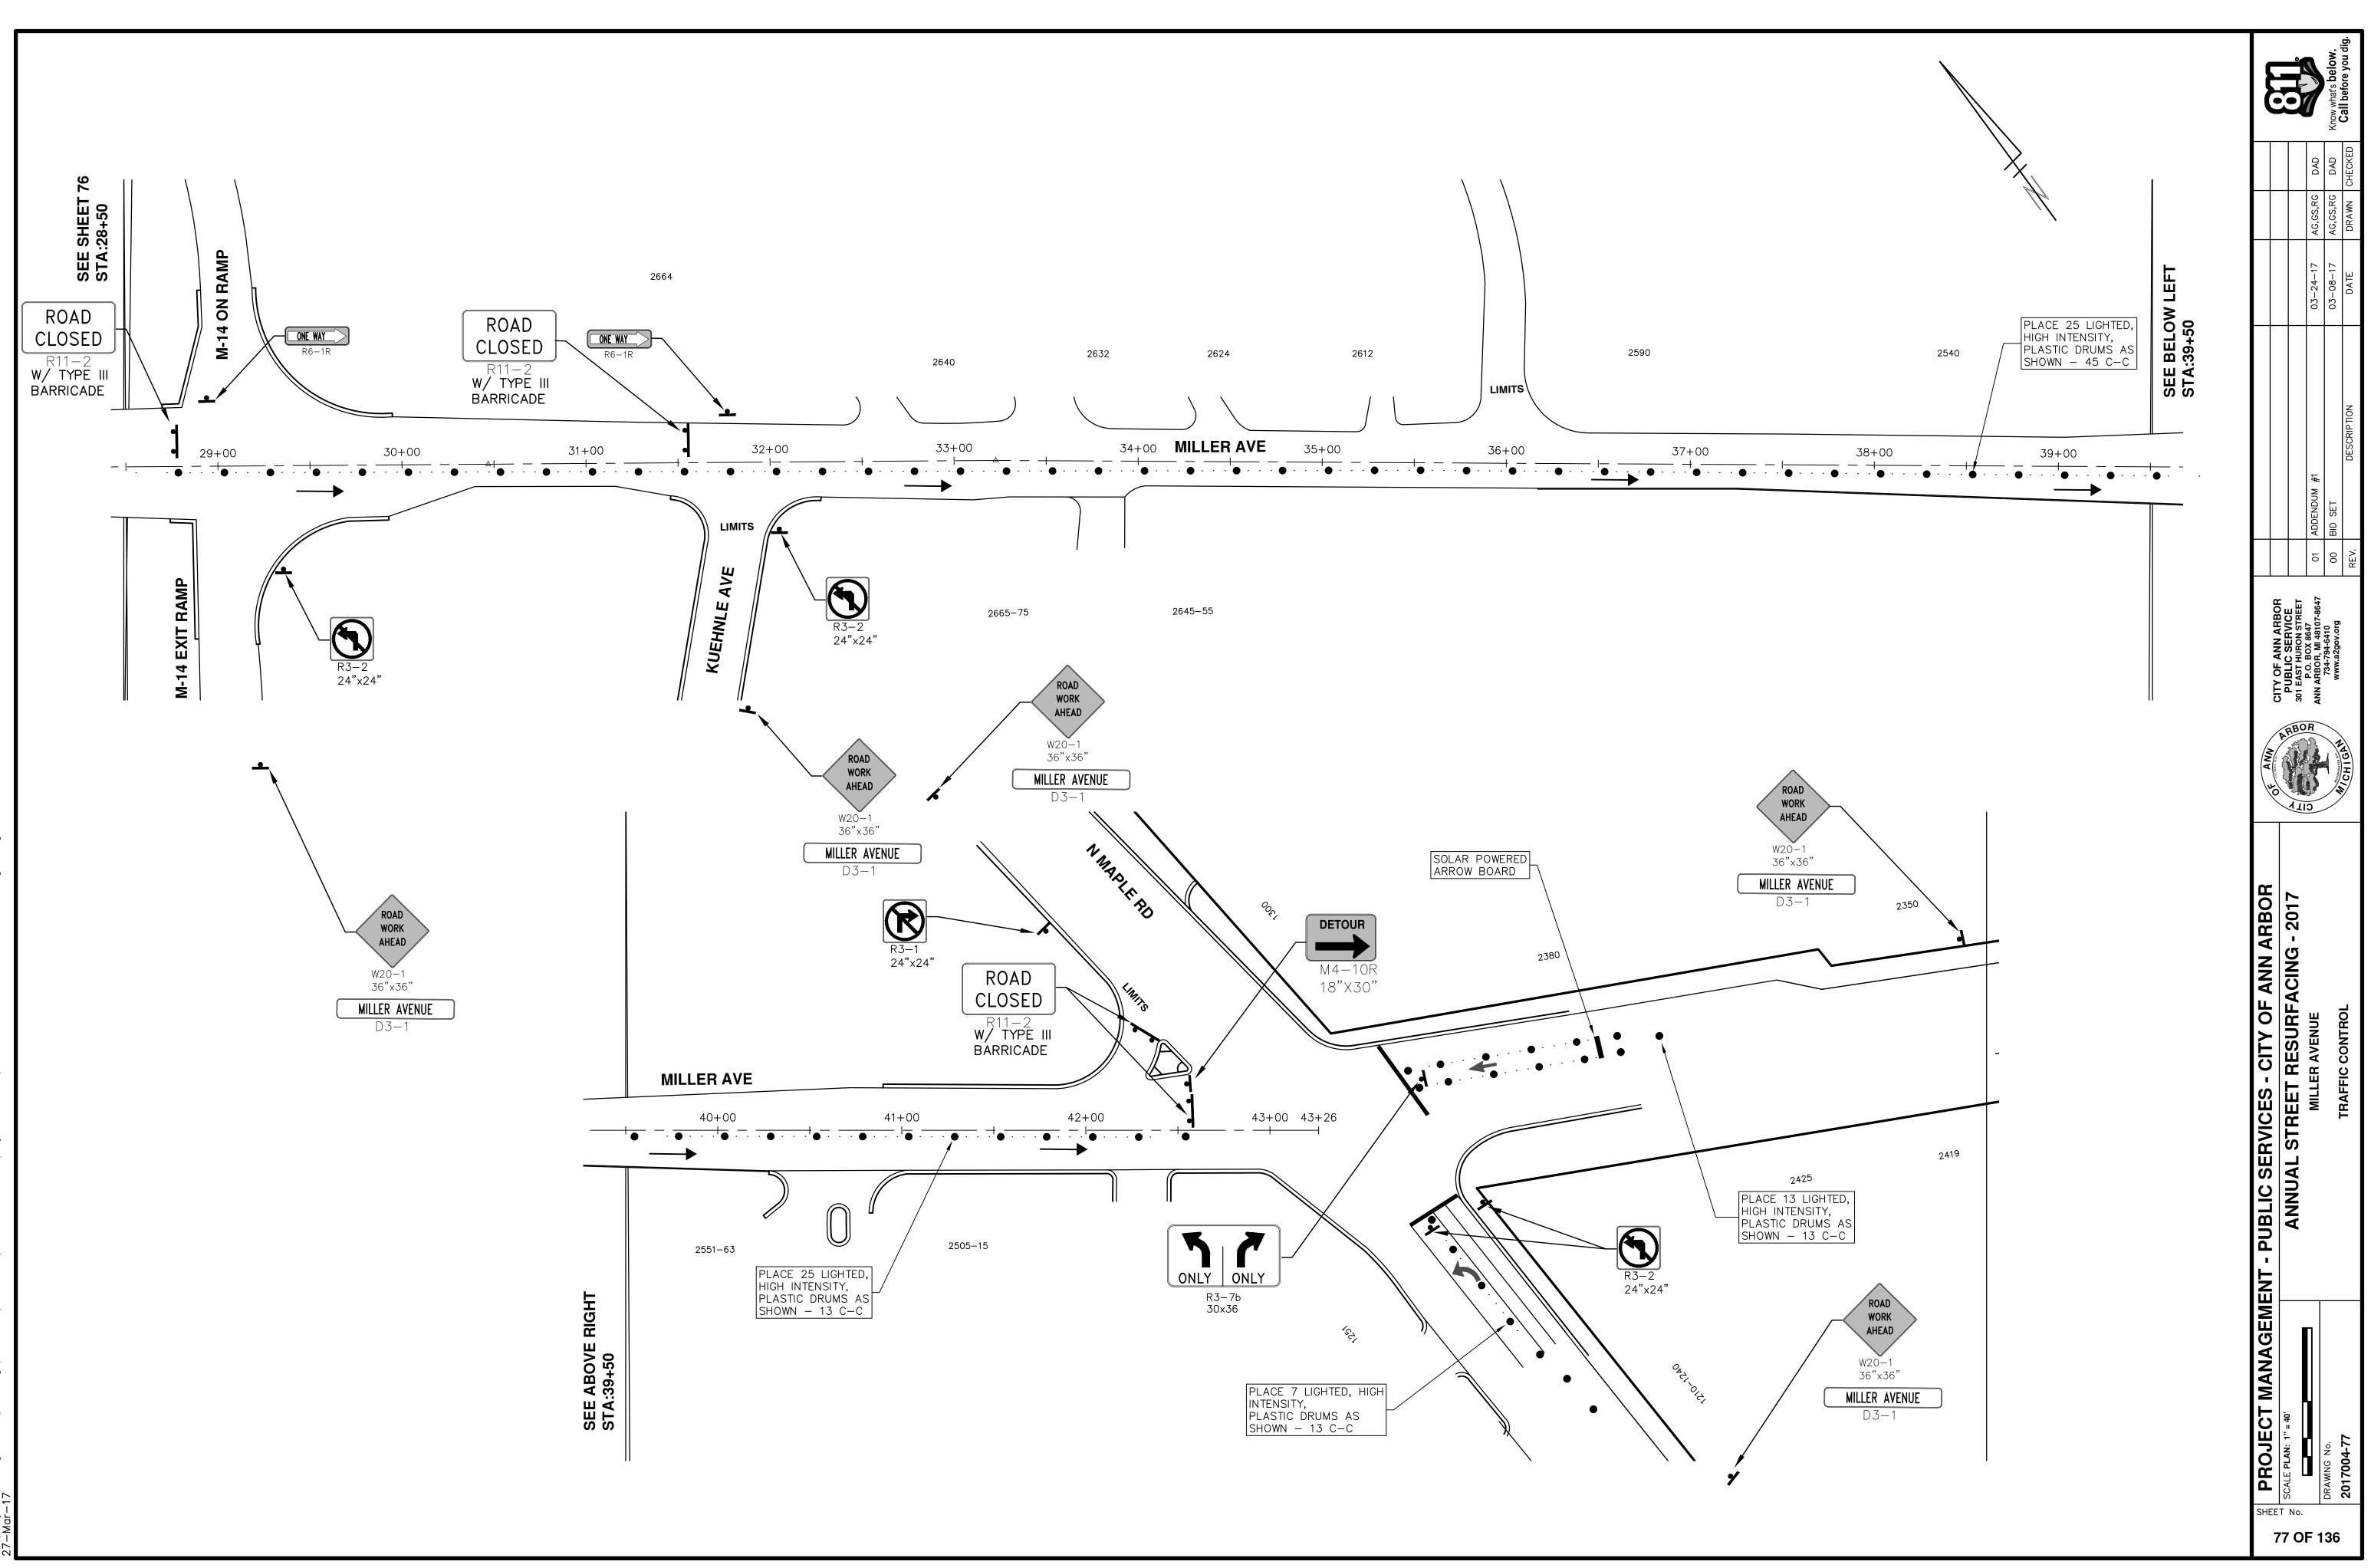


Õ


<u>`</u>0

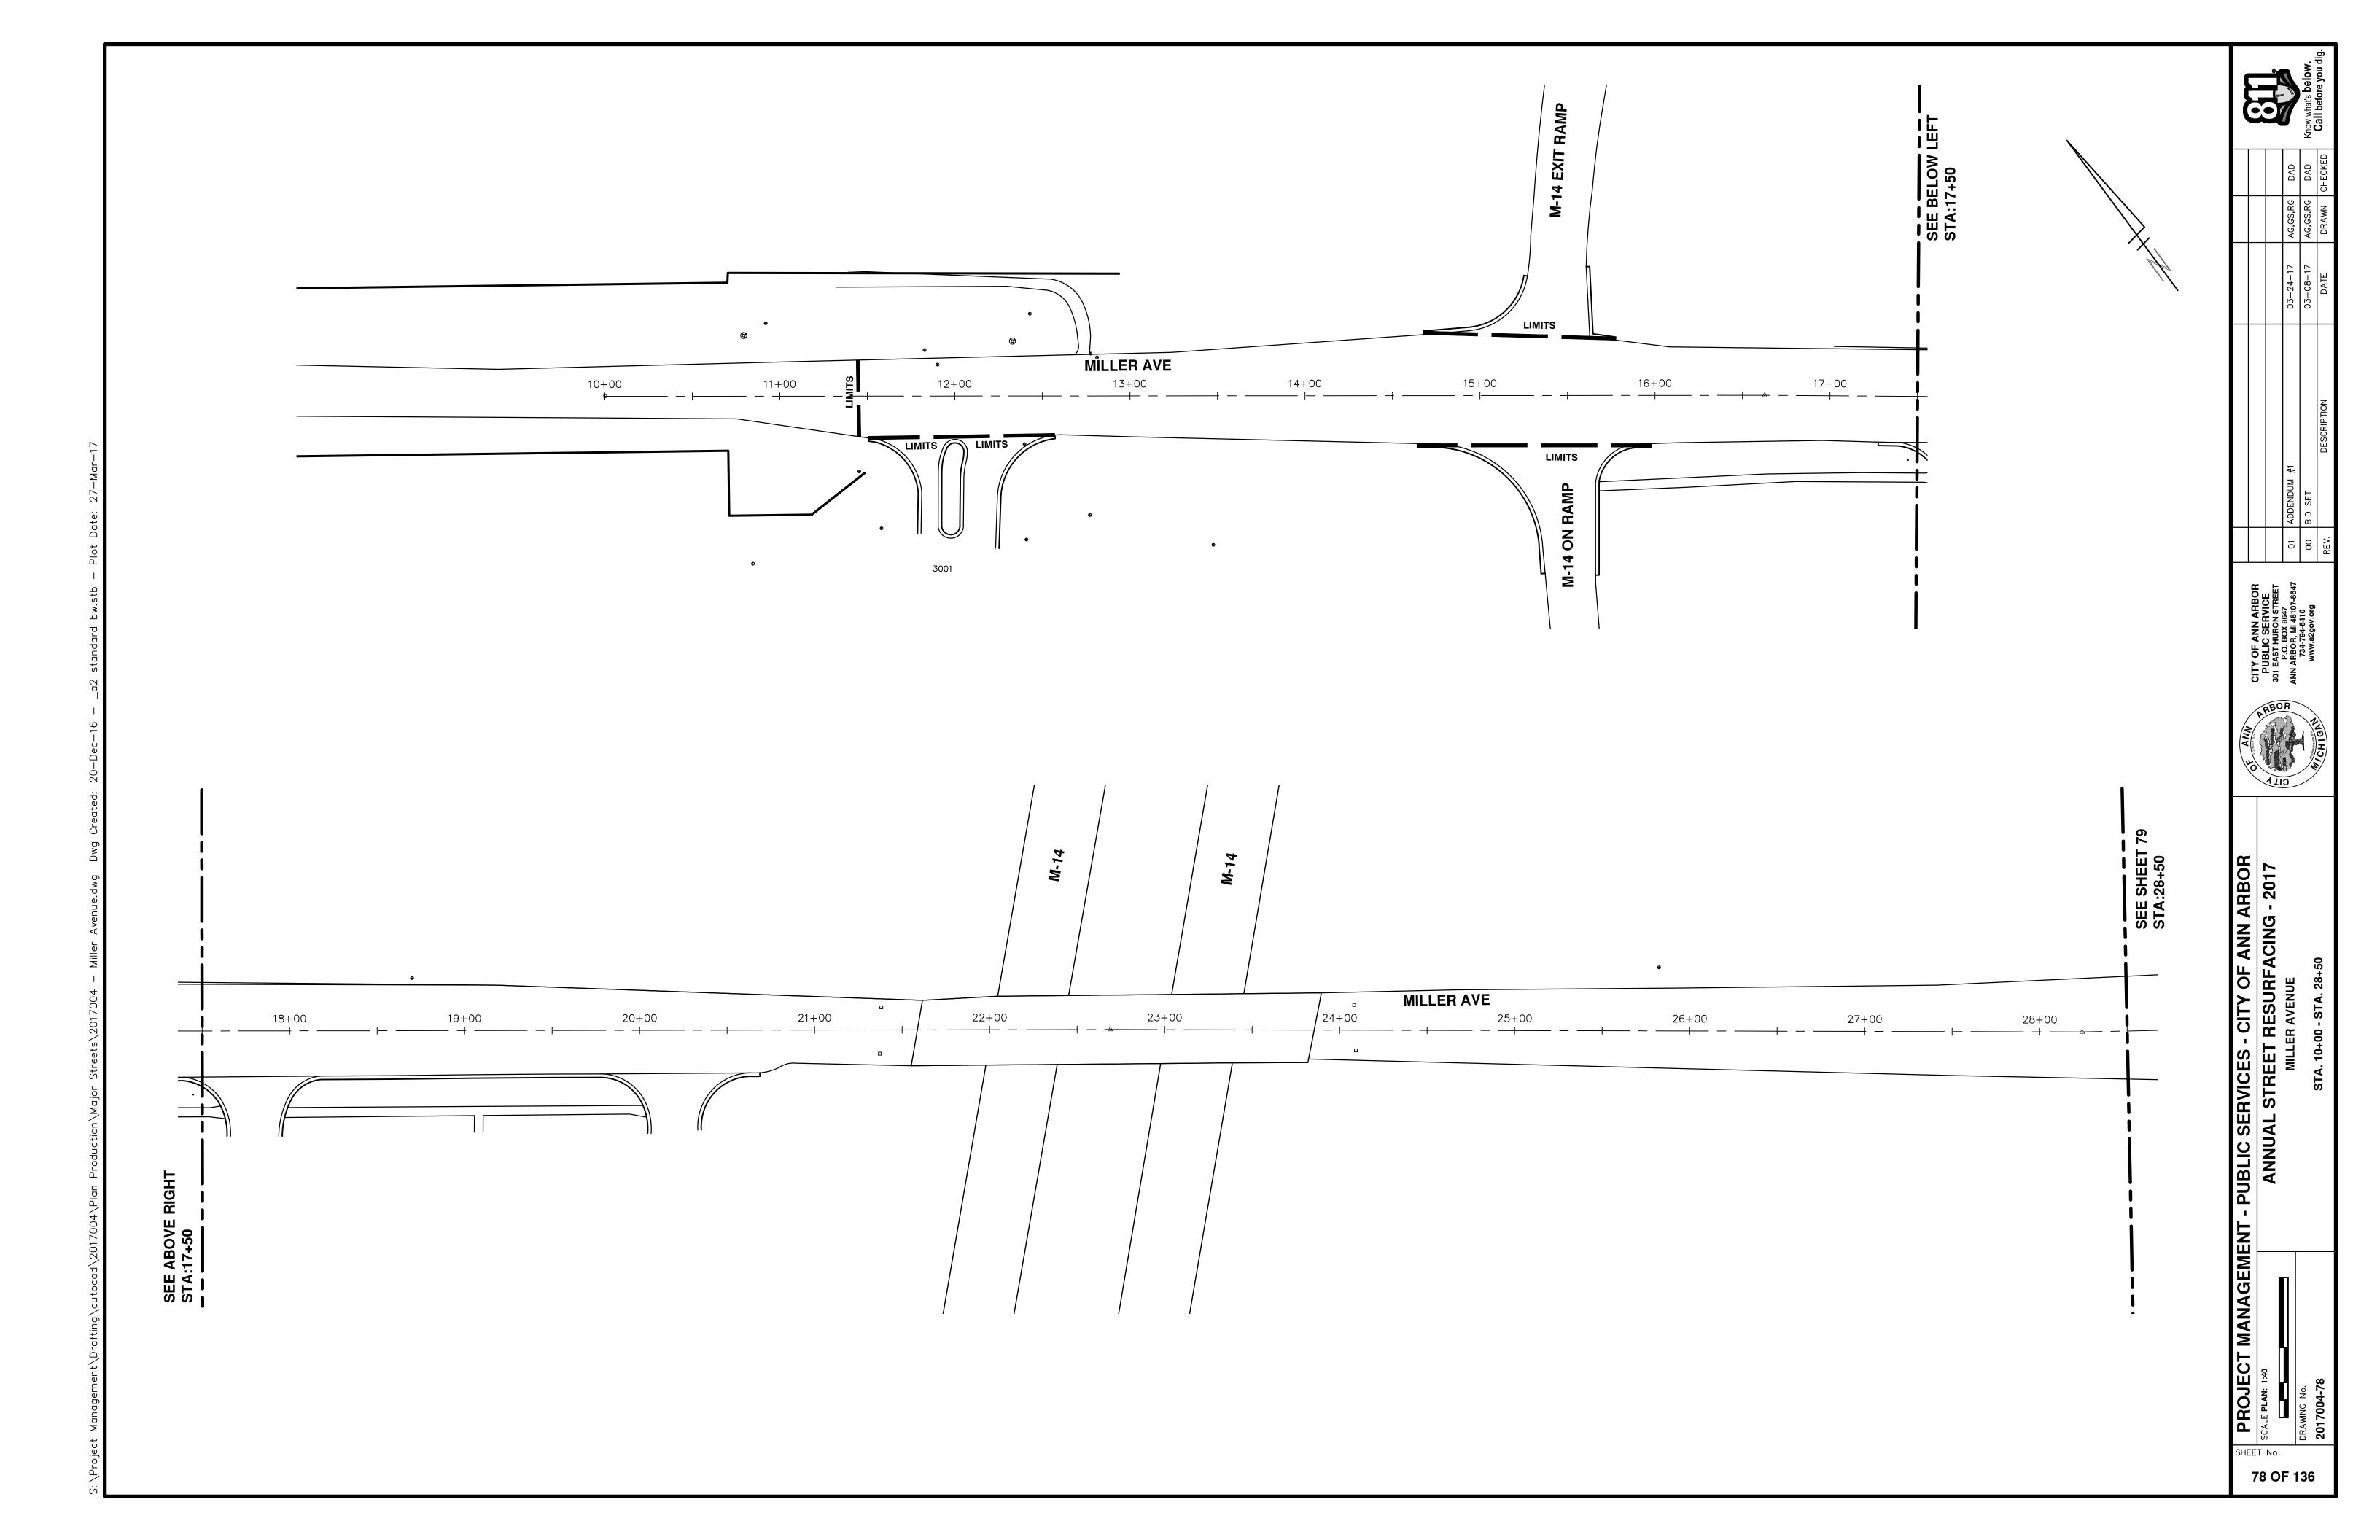

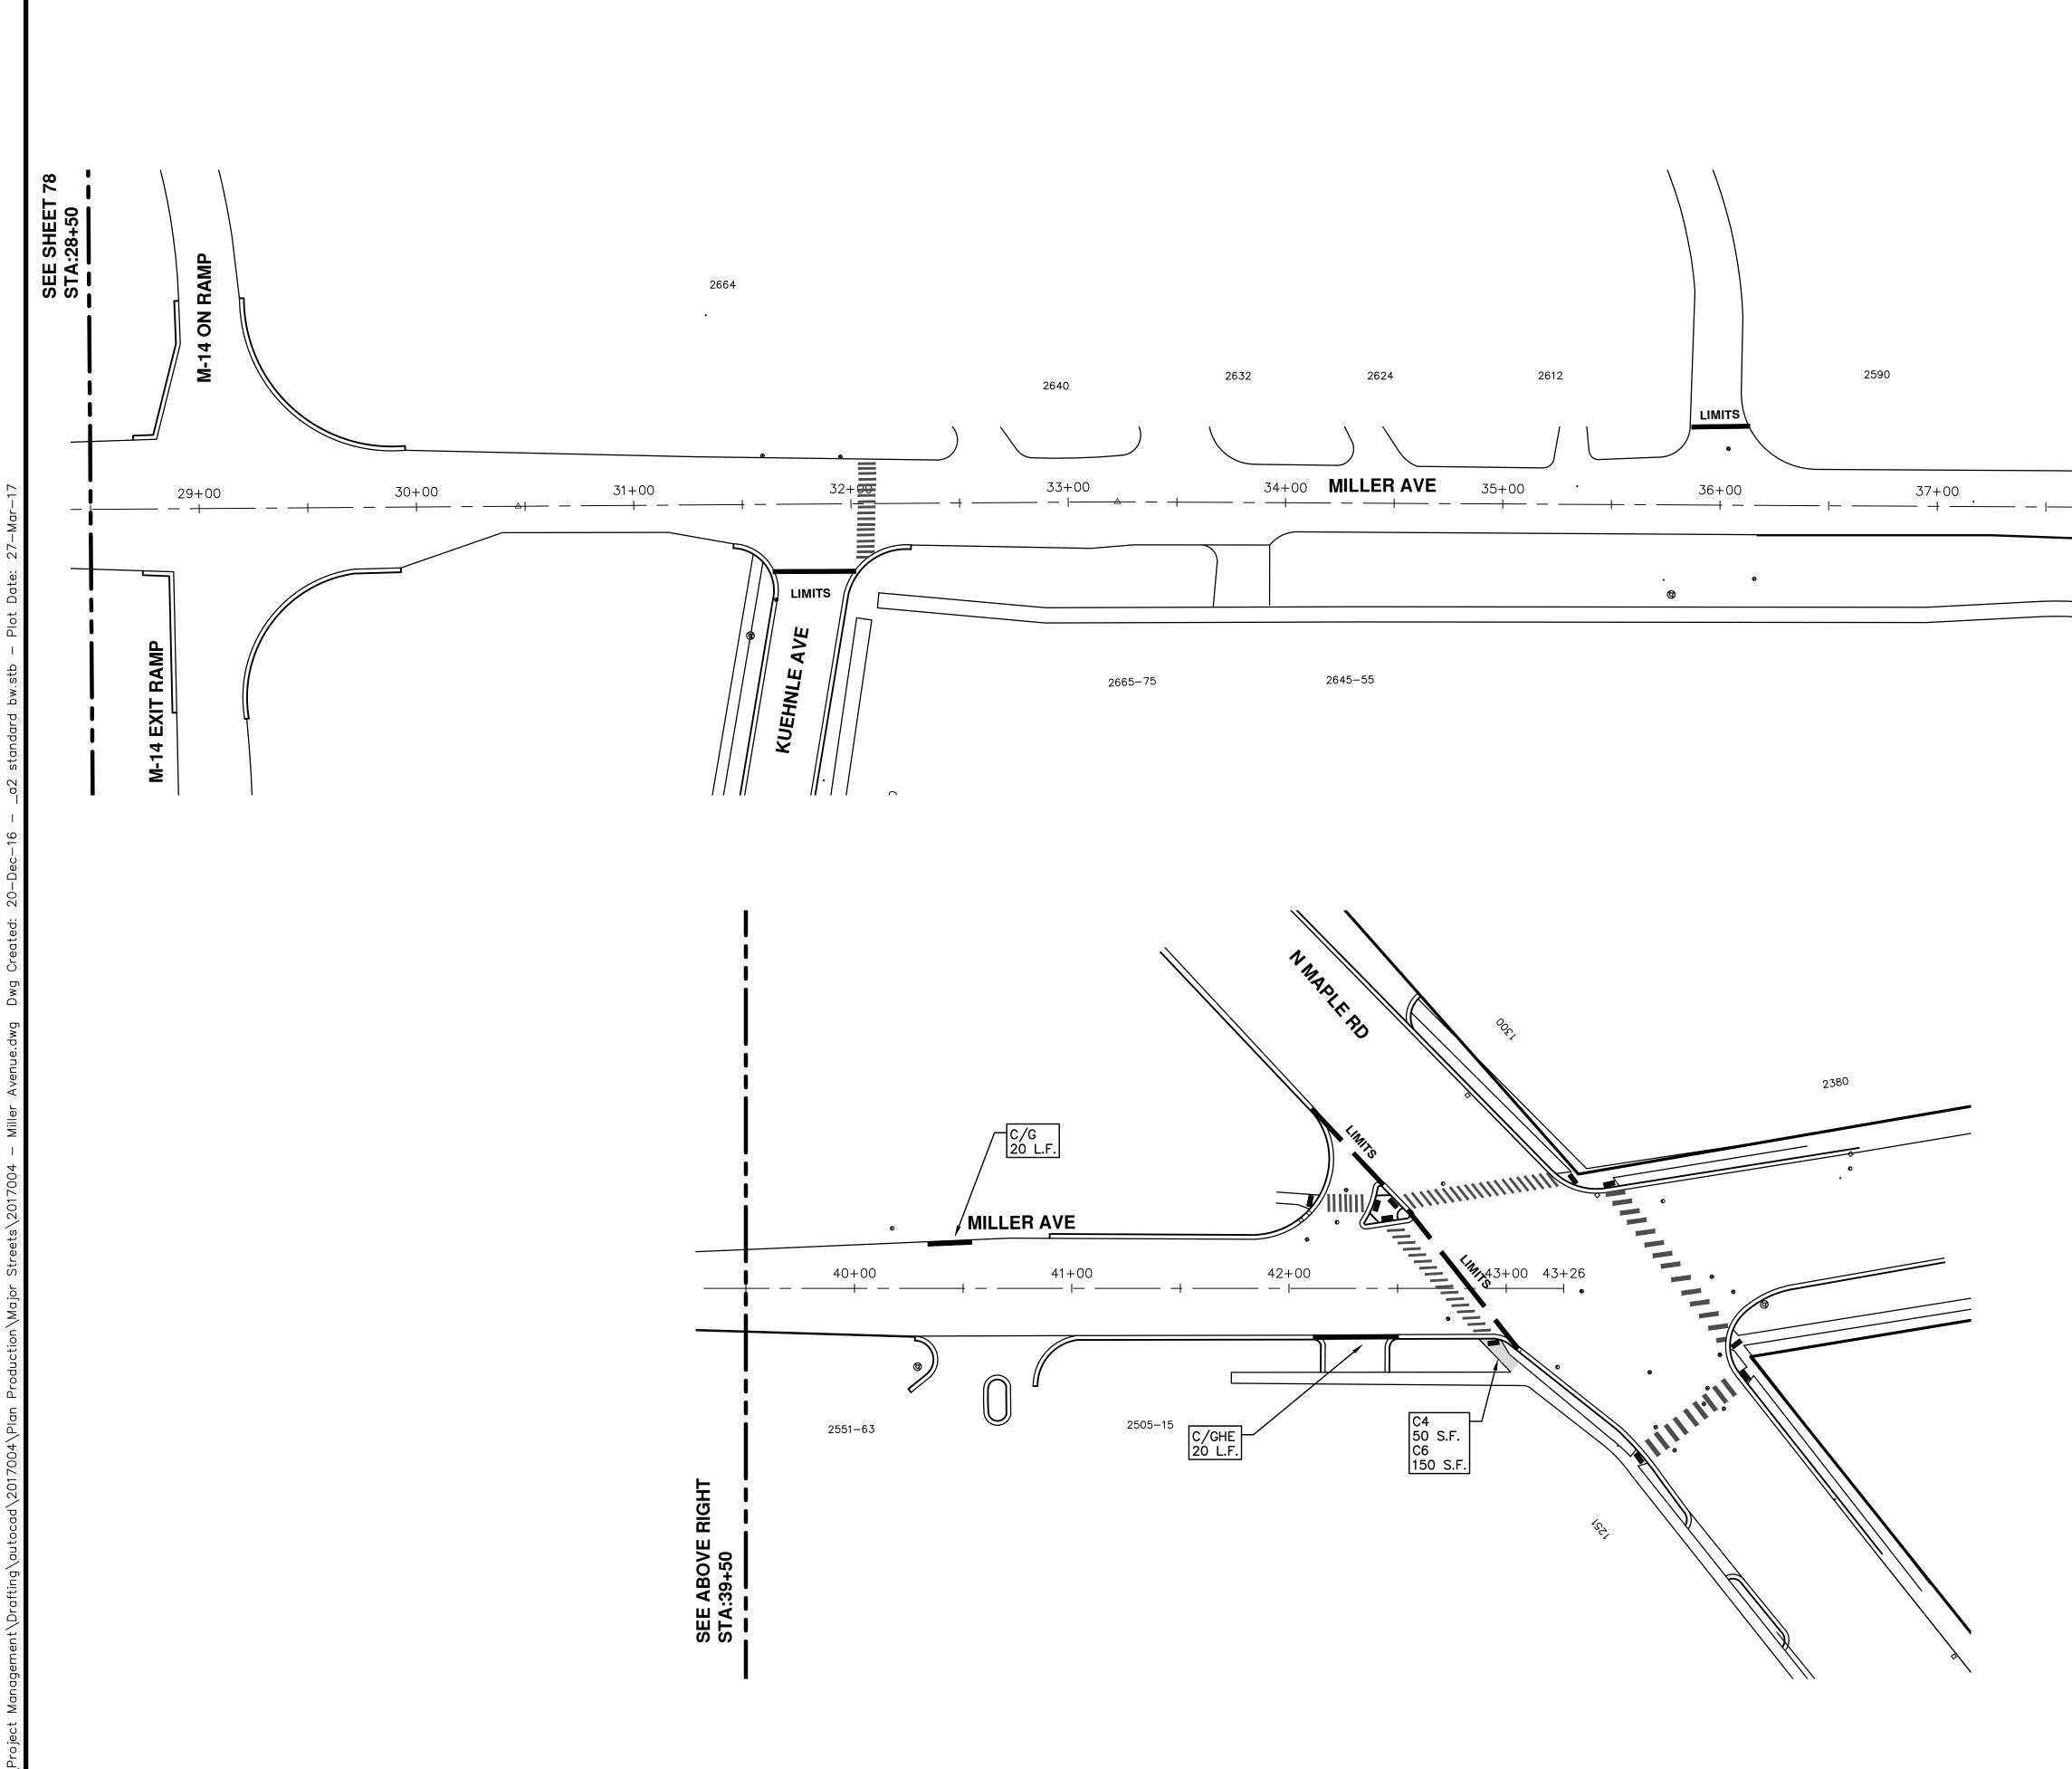

			Know what's below. Call before you dig.
			CHECKED C
			AG,GS,RG D DRAWN CHE
		03-24-17	03-08-17 DATE
2540 LEIN ICE 2540 E			
6			DESCRIP TION
<u>38+00</u> <u>39+00</u> <u>-</u>		DUM #1	
		ADD	00 BID SET REV.
BIT C/G 622 L.F.			
	CITY OF ANN ARBOR PUBLIC SERVICE	201 E431 HONON 31 HEET P.O. BOX 8647 ANN ARBOR, MI 48107-8647 734-794-6410	www.a2gov.org
	CITY PUJ		
	ANN		MICHIGAN
	E L		
	IBLIC SERVICES - CITY OF ANN ARBOI ANNUAL STREET RESURFACING - 2017		
			+26
	ESURF	MILLER AVENUE	STA. 28+50 - STA. 43+26
	ES - C EET R	MILLER	A. 28+50
	ERVIC		ST
	ANAGEMENT - PUBLIC SERVICES - CITY OF ANN ARBOR ANNUAL STREET RESURFACING - 2017		
	PROJECT M	Ŋ	62
	PROJEC	DRAWING NO.	2017004-79
	SHEET No		-

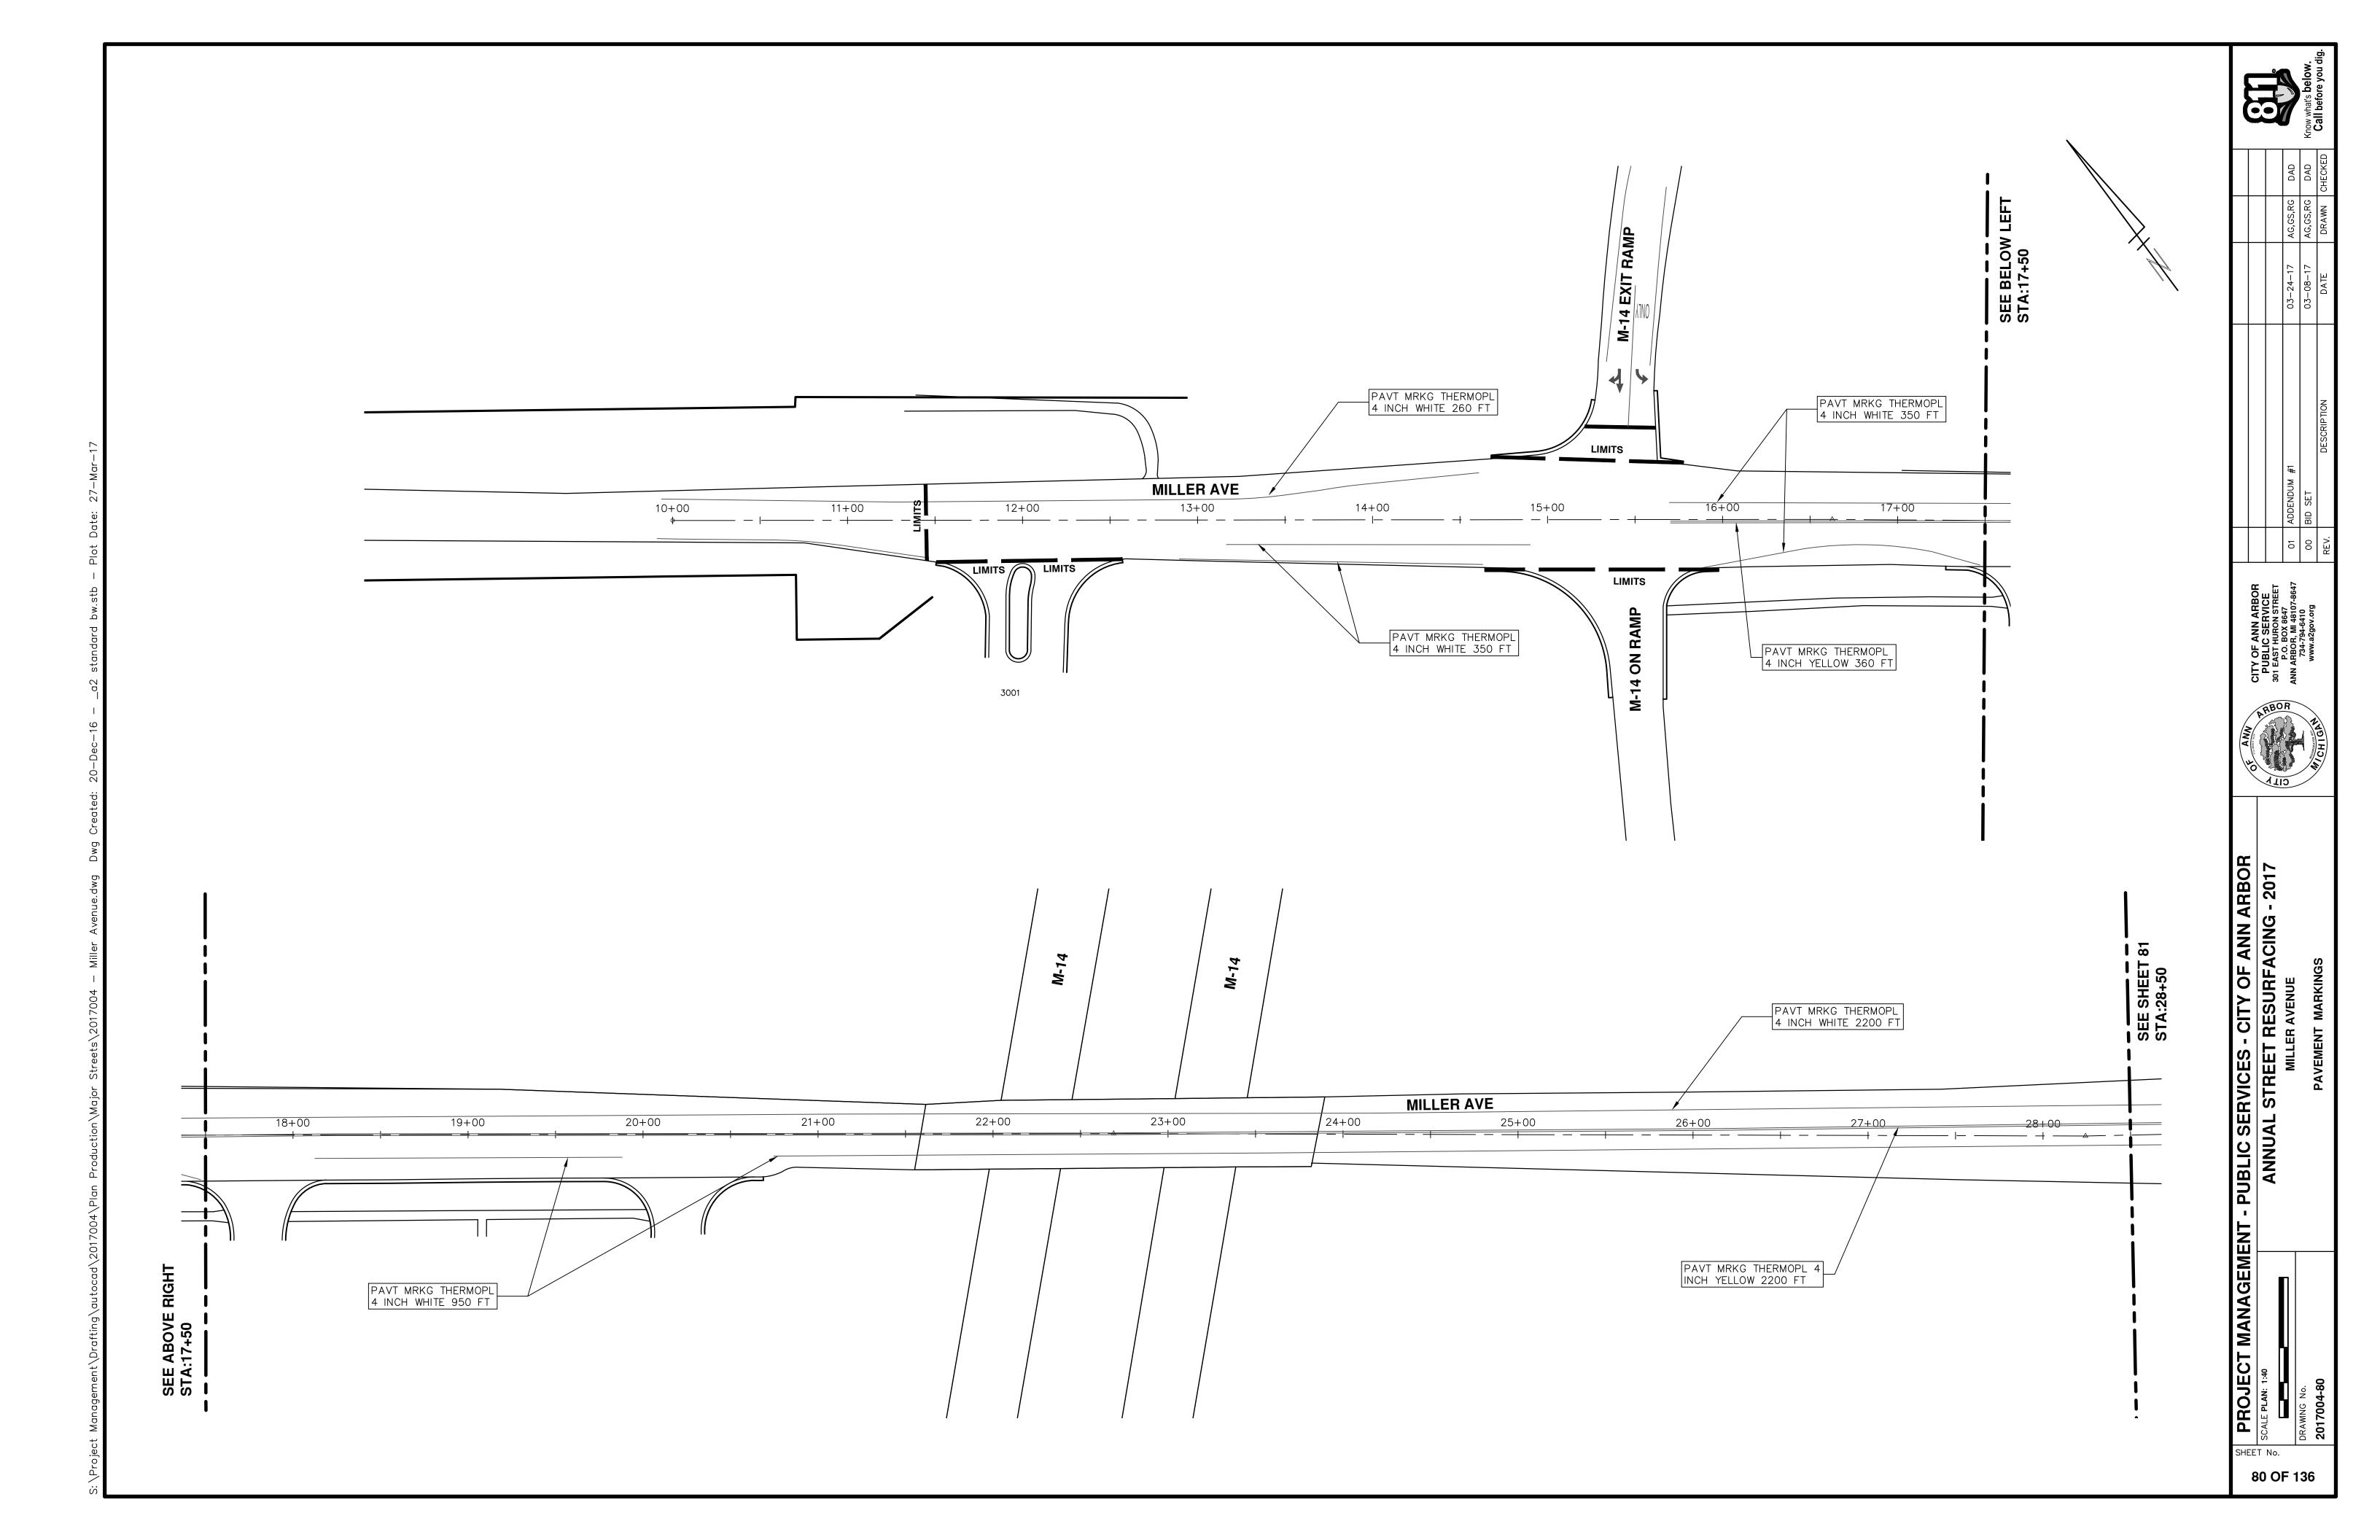

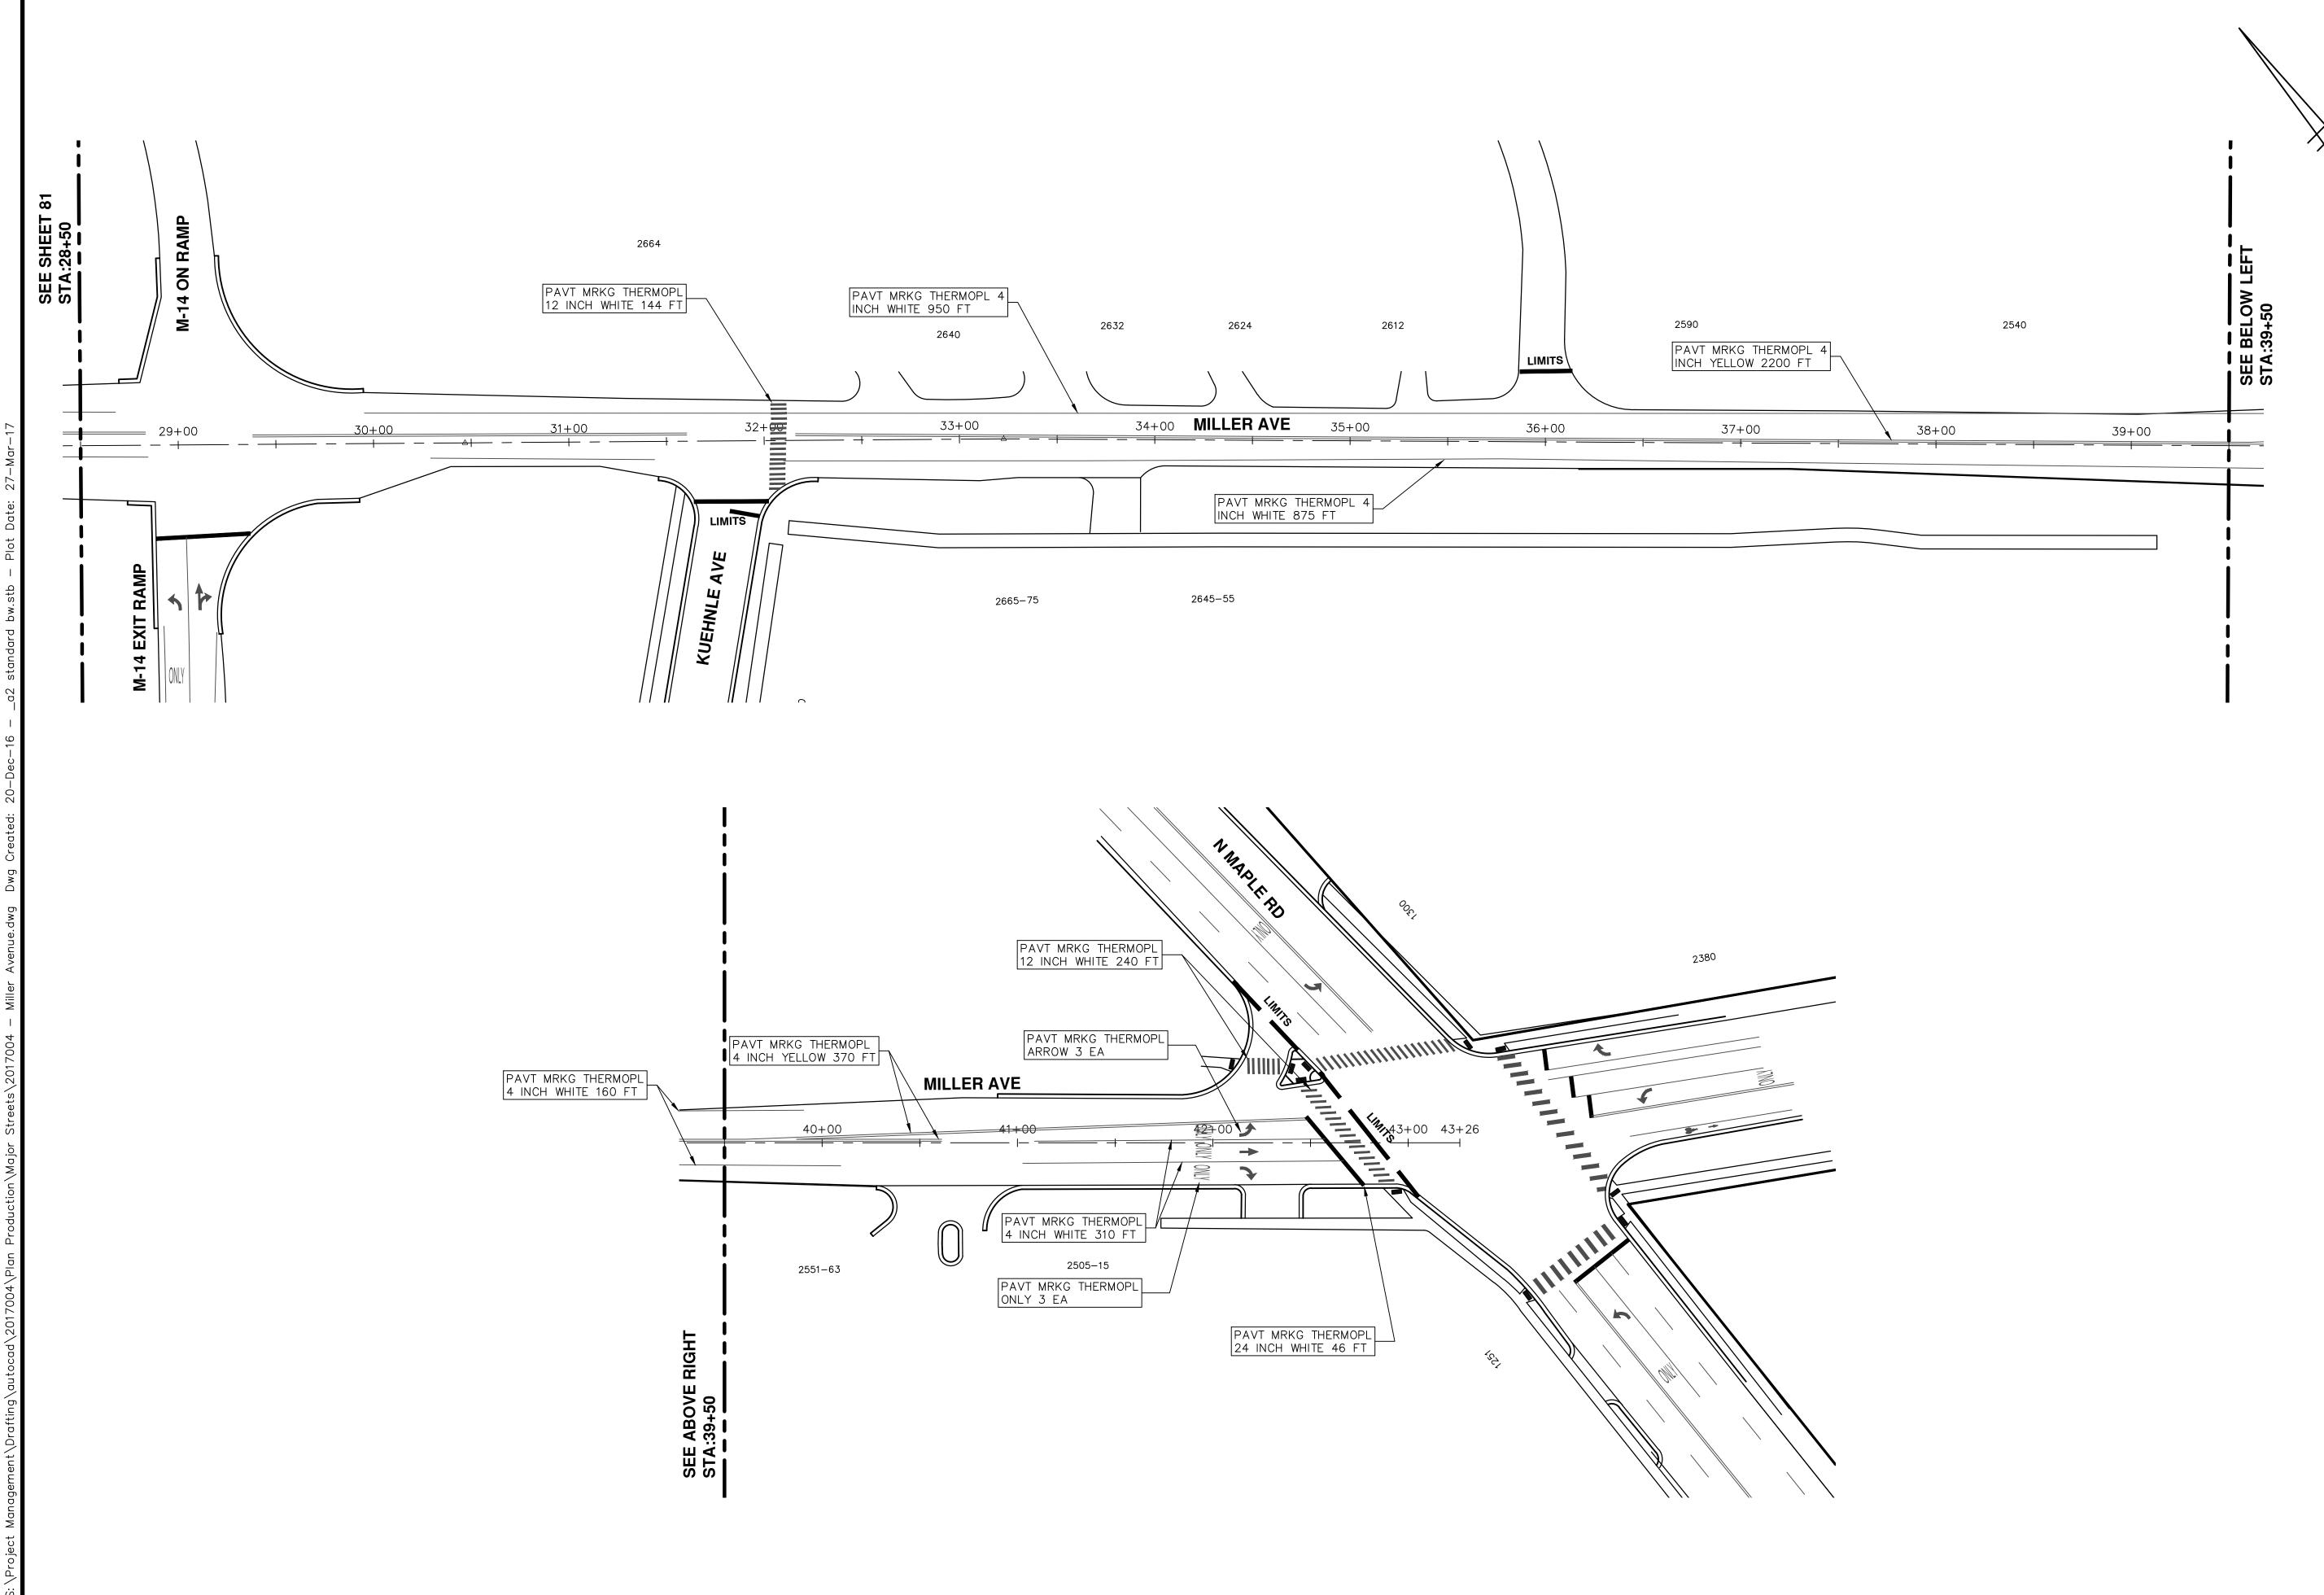

		Know what's below.
		DAD DAD CHECKED
		AG,GS,RG AG,GS,RG AG,GS,RG DRAWN
		03-24-17 03-08-17 DATE
2540	SEE BELOW LEFT STA:39+50	
39+00		DESCRIPTION
		ADDENDUM #1 BID SET
		00 B REV.
		CITY OF ANN ARBOR DECITY OF ANN ARBOR PUBLIC SERVICE 301 EAST HURON STREET P.O. BOX 8647 ANN ARBOR, MI 48107-8647 734-794-6410 www.a2gov.org
		ANAGEMENT - PUBLIC SERVICES - CITY OF ANN ARBOR ANNUAL STREET RESURFACING - 2017 MILLER AVENUE PAVEMENT MARKINGS
		PROJECT MANAGEME

ROJE		
PRC	Quantity 7.000	Units Ea
	56.000	 Ft
	1,337.000	Ft
	1,783.000	Syd
	3,314.000	Syd
	5.000	Ea
	239.000	Cyd
	303.000	Cyd
	138.000	Cyd
	401.000	Syd
	118.000	Syd
	174.000	Cyd
	17.000	Ea
	1,823.000	Syd

	CON
KEY	ASSOCIATED PAY ITEM
AA	 Dr Structure, Adj, Case
	 _Dr Structure, Temp Lov
	_Dr Structure, Temp Lov
AB	Gate Box, Adj, Case 1 Gate Box, Adj, Case 2
	 _Gate Box, Adj, Case 2 _Monument Box Adjust
ADST	_Dr Structure, Adj, Add
AK	 Dr Structure, Adj, Case
	 _Sidewalk, Sidewalk Ra
C4	• _Grading, Sidewalk
	Sidewalk, Conc, 4 inch Sidewalk, Sidewalk, Da
	 _Sidewalk, Sidewalk Ra _Grading, Sidewalk
C4HE	Cement
	 _Sidewalk, Conc, 4 inch
	 _Sidewalk, Sidewalk Ra
	 _Grading, Sidewalk
C6	 _Grading, Sidewalk Ram
	Detectable Warning Su
	 _Sidewalk Ramp, Conc, Sidewalk Cana, Cinck
	 _Sidewalk, Conc, 6 inch _Grading, Driveway Apprendict
C8	 _Grading, Driveway Apple _Driveway, Nonreinf Con
	 _Sidewalk, Sidewalk Ra
	 Grading, Driveway Appl
	 _Grading, Sidewalk
	 _Grading, Sidewalk Ram
C HE	Cement
	Driveway, Nonreinf Con
	 _Detectable Warning Su _Sidewalk Ramp, Conc,
	 _Sidewalk, Conc, 6 inch
010	Curb, Gutter, and Curb
C/G	 _Curb and Gutter, Conc
	 _Curb, Gutter, and Curb
C/GHE	Cement
	Driveway Opening, Con Orading, Cidawalk
CP	 _Grading, Sidewalk _Sidewalk, Conc, 4 inch
CR	 _Sidewalk, Sidewalk Ra
	Dr Structure, Rem
DS	• Sewer, Rem, Less than
	 Dr Structure, 24 inch dia
	Dr Structure, Rem
DSDI	Sewer, Rem, Less than
PT	 _Dr Structure, Double In _Dr Structure, Point
ГІ	Dr Structure Cover, Type
	_Dr Structure Cover, Type
RRA	 Dr Structure, Adj, Case
	 Dr Structure, Temp Lov
RRK	 Dr Structure Cover, Type
	_Dr Structure, Adj, Case
RS	Dr Structure, Reconstru
TYPE II	 Plastic Drum, High Inten Plastic Drum, High Inten
-	 Barricade, Type III, High
TYPE III	 Barricade, Type III, High

ltem Code	QUANTITIES Item Description	Units	Quantity
2030011	Dr Structure, Rem	Ea	7.00
2030015	Sewer, Rem, Less than 24 inch	Ft	56.00
2047001	_Curb, Gutter, and Curb and Gutter, Any Type, Rem	Ft	1,337.00
047011	_Conc Pavt, Any Thickness, Rem	Syd	1,783.00
2047011	_Sidewalk, Sidewalk Ramp, and Driveway Approach, Any Thickness, Rem	Syd	3,314.00
2047050	_Exploratory Excavation (0-10' Deep) Tr Det I	Ea	5.00
2050010	Embankment, CIP	Cyd	239.00
2050016	Excavation, Earth	Cyd	303.00
2050023 2057011	Granular Material, CI II	Cyd	138.00
2057011	_Grading, Sidewalk Grading, Sidewalk Ramp	Syd Syd	401.00
2057011	Subgrade Undercutting, Type IIA	Cyd	174.00
2037021	Erosion Control, Inlet Protection, Fabric Drop	Ea	174.00
3027011	Aggregate Base, 8 inch, 21AA	Syd	1,823.00
3027021	_Aggregate Base, CIP, 21AA	Cyd	25.00
3087011	Geosynthetic Paving Layer	Syd	9,929.00
4020987	Sewer, CI IV, 12 inch, Tr Det B	Ft	72.00
4030200	Dr Structure, 24 inch dia	Ea	6.00
4037050	_Dr Structure Cover, Type B, Modified	Ea	22.00
4037050	_Dr Structure Cover, Type K, Modified	Ea	13.00
4037050	_Dr Structure, Adj, Case 1, Modified	Ea	85.00
4037050	_Dr Structure, Adj, Case 2, Modified	Ea	2.00
4037050	_Dr Structure, Point	Ea	5.00
4037050	_Dr Structure, Temp Lowering, Modified	Ea	72.00
5010003	Cold Milling HMA Surface	Ton	3,768.00
5010005	HMA Surface, Rem	Syd Ton	1,302.00 357.00
5010025 5010045	Hand Patching HMA, 3E3	Ton Ton	287.00
5010045	HMA, 3E3 HMA, 4E3	Ton	1,739.00
5010057	HMA, 5E3	Ton	942.00
5010061	HMA, Approach	Ton	292.00
5010020	Pvmt Joint and Crack Repr, Detail 7	Ft	240.00
5010021	Pvmt Joint and Crack Repr, Detail 8	Ft	120.00
5017031	_HMA, Wedging, 36A	Ton	21.00
5017031	_Cold Milling for Curb Reveal	Ton	180.00
6030005	Cement	Ton	1.00
8027001	_Curb and Gutter, Conc	Ft	1,664.00
8027001	_Driveway Opening, Conc, Det M, Modified	Ft	110.00
8037001	_Detectable Warning Surface, Modified	Ft	160.00
8037001	Detectable Warning Surface, Cast Iron	Ft	80.00
8037001	_Fence, Protective, Modified	Ft	1,000.00
3037010	_Sidewalk Ramp, Conc, 8 inch, Modified	Sft	1,058.00
8037010	Sidewalk, Conc, 8 inch, Modified	Sft	3,601.00
8110049	Pavt Mrkg, Ovly Cold Plastic, Direction Arrow Sym, Bike	Ea	7.00
3110058	Pavt Mrkg, Ovly Cold Plastic, Bike, Small Sym Pavt Mrkg, Ovly Cold Plastic, Sharrow Symbol	Ea	10.00
8110079 8110450	Recessing Pavement Markings, Longit	Ea Ft	3.00 3,127.00
8110450 8110451	Recessing Pavement Markings, Longit Recessing Pavement Markings, Transv	Sft	2,744.00
8110500	Pavt Mrkg, Wet Retrflec, Polyurea, 4 inch, White	Ft	910.00
8110501	Pavt Mrkg, Wet Retrilec, Polyurea, 6 inch, White	Ft	1,903.00
8110504	Pavt Mrkg, Wet Retrilec, Polyurea, 4 inch, Yellow	Ft	314.00
8117001	_Pavt Mrkg, Wet Retrflec, Polyurea, 24 inch, Stop Bar	Ft	403.00
8117001	Pavt Mrkg, Wet Retrflec, Polyurea, 12 inch, Crosswalk	Ft	1,756.00
8117001	_Pavt Mrkg, Wet Retrflec, Polyurea, 4 inch, Parking Sym, White	Ft	512.00
8117050	_Pavt Mrkg, Wet Retrflec, Polyurea, Lt Turn Arrow Sym	Ea	2.00
8117050	_Pavt Mrkg, Wet Retrflec, Polyurea, Only	Ea	4.00
8117050	_Pavt Mrkg, Wet Retrflec, Polyurea, Rt Turn Arrow Sym	Ea	1.00
8117050	_Pavt Mrkg, Wet Retrflec, Polyurea, Thru Arrow Sym	Ea	1.00
8120012	Barricade, Type III, High Intensity, Double Sided, Lighted, Furn	Ea	21.00
8120013	Barricade, Type III, High Intensity, Double Sided, Lighted, Oper	Ea	21.00
8120030	Channelizing Device, 42 inch, Furn	Ea	48.00
8120031	Channelizing Device, 42 inch, Oper	Ea	48.00
8120140	Lighted Arrow, Type C, Furn	Ea	2.00
8120141	Lighted Arrow, Type C, Oper	Ea	2.00
8120260 8120261	Plastic Drum, High Intensity, Lighted, Furn	Ea Ea	201.00
8120261 8120330	Plastic Drum, High Intensity, Lighted, Oper Sign, Portable, Changeable Message, Furn	Ea	4.00
8120330	Sign, Portable, Changeable Message, Furn	Ea	4.00
8120350	Sign, Type B, Temp, Prismatic, Fum	Sft	1,002.00
8120351	Sign, Type B, Temp, Prismatic, Oper	Sft	1,002.00
8127050	_No Parking Sign	Ea	5.00
8120245	Pavt Mrkg, Wet Retrflec, Type R, Tape, 4 inch, White, Temp	Ft	1,260.00
8120310	Sign Cover	Ea	26.00
8197050	_Handhole Assembly, 12 Inch x 18 inch	Ea	2.00
8197050	Handhole Assembly, 17 Inch x 30 inch	Ea	2.00
8197050	_Handhole Assembly, 24 inch x 36 inch	Ea	2.00
8167011	_Slope Restoration	Syd	143.00
8217050	_Monument Box Adjust	Ea	5.00
8230431	Gate Box, Adj, Case 1	Ea	23.00

Ea

Ea

23.000

18.000

14.000

8257050 Install Parking Meters

8257050 Remove Parking Meters

JF ANN ARBOR CT MANAGEMENT **JECT LOCATION: JIVISION STREET**

3 No. 4477 FILE No. 2017-004

NSTRUCTION KEY
M(S)
se 1, Modified
se 2, Modified
owering, Modified
owering, Modified
1
2
z t
-
Depth, Modified
se 1, Modified
amp, and Driveway Approach, Any Thickness, Rem
h, Modified
amp, and Driveway Approach, Any Thickness, Rem
h, Modified
amp, and Driveway Approach, Any Thickness, Rem
,
mp
mp unface Modified
urface, Modified
c, 6 inch, Modified
h, Modified
proach
nc, 8 inch, Modified
amp, and Driveway Approach, Any Thickness, Rem
proach
mp
nc, 6 inch, Modified
nc, 8 inch, Modified
urface, Modified
c, 6 inch, Modified
h, Modified
b and Gutter, Any Type, Rem
0
b and Gutter, Any Type, Rem
nc, Det M, Modified
h, Modified
amp, and Driveway Approach, Any Thickness, Rem
o Od inch
n 24 inch
a
n 24 inch
nlet
be B
/pe B, Special
se 1, Modified
owering, Modified
be K
se 1, Modified
ruct
ensity, Lighted, Furn
ensity, Lighted, Oper
h Intensity, Double Sided, Lighted, Furn
h Intensity, Double Sided, Lighted, Oper

TOUOTION VE

	LEGEND
SYMBOL	DESCRIPTION
<u>s</u>	EXISTING SANITARY SEWER MANHOLE
	EXISTING STORM SEWER MANHOLE
\otimes	EXISTING WATER MAIN VALVE IN WELL
+	WATER MAIN GATE VALVE IN BOX
+Q+	FIRE HYDRANT
(g)	MICHCON GAS CO. VALVE BOX/WELL
t	AMERITECH TELEPHONE VAULT
e	ELECTRIC MANHOLE
\bullet	SOIL BORING
	EXISTING STORM SEWER INLET
•	MONUMENT BOX
	REMOVE AND REPLACE CONC. SIDEWALK
	PLACE CONCRETE SIDEWALK
	REMOVE & REPLACE CONC. CURB & GUTTER
	CONSTRUCTION LIMITS
	6" WRAPPED UNDERDRAIN
	REMOVE CONCRETE SIDEWALK
	SUBGRADE UNDERCUT

		Sign, Type B, Temp, Prismatic		
Quantity	Sign Code	Description	Area (sft)	Total Area
63.0	D3-1	Street Name Sign	1.500	94.50
2.0	G20-2	End Raod Work Sign	4.500	9.00
2.0	M4-10(L)	Detour Sign (Left Arrow)	6.000	12.00
1.0	M4-10(R)	Detour Sign (Right Arrow)	6.000	6.00
4.0	M4-8a	End Detour Sign	3.000	12.00
8.0	M4-9L	Detour Sign (w/Left Arrow)	5.000	40.00
9.0	M4-9R	Detour Sign (w/Right Arrow)	5.000	45.00
7.0	M4-9S	Detour Sign (w/Thru Arrow)	5.000	35.00
8.0	R11-2	Road Closed Sign ("Road Closed")	10.000	80.00
5.0	R11-4	Road Closed Sign ("Road Closed To Thru Traffic")	12.500	62.50
4.0	R3-1	Movement Prohibition Sign ("No Right Turn")	4.000	16.00
2.0	R3-2	Movement Prohibition Sign ("No Left Turn")	4.000	8.00
1.0	R3-5(L)	Mandatory Movement Sign (Left Turn Only)	7.500	7.50
1.0	R3-6	Optional Movement Sign (Thru and Right Turn)	7.500	7.50
1.0	R3-6	Optional Movement Sign (Thru and Left Turn)	7.500	7.50
2.0	R5-18cLA	Special Regulatory Sign ("Work Zone Begins/Traffic Fines Doubled")	17.500	35.00
1.0	SP-1	Special Sign ("Liberty St Closed at Division")	12.500	12.50
2.0	SP-1	Special Sign ("Washington St Closed at Division")	12.500	25.00
1.0	W1-4	Reverse Curve Sign	9.000	9.00
2.0	W1-6	One-Direction Large Arrow Sign	8.000	16.00
2.0	W4-2(R)	Right Lane Ends Sign	9.000	18.00
2.0	W9-3	Center Lane Closed Ahead Sign	9.000	18.00
21.0	W20-1	Road Work Ahead Sign	16.000	336.00
4.0	W20-2	Detour Ahead Sign	9.000	36.00
6.0	W20-3	Road Closed Ahead Sign	9.000	54.00
		·	TOTAL	1002.0

CONSTRUCTION METHOD AND SEQUENCING


SEE DETAILED SPECIFICATION FOR MAINTAINING TRAFFIC FOR CONSTRUCTION STAGING/SEQUENCING INFORMATION RELATED TO THE PROPOSED WORK ON SOUTH DIVISION STREET.

NOTES:

UTILITIES.





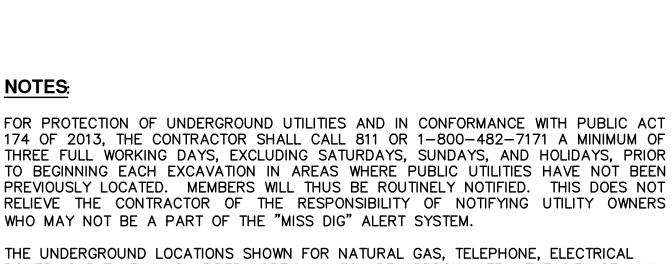

THE UNDERGROUND LOCATIONS SHOWN FOR NATURAL GAS, TELEPHONE, ELECTRICAL POWER, CABLE TV AND FIBER OPTIC LINES ARE APPROXIMATE. THE CITY OF ANN ARBOR ASSUMES NO RESPONSIBILITY FOR THEIR ACCURATE REPRESENTATION IN THIS DRAWING. MISS DIG MUST BE CONTACTED PRIOR TO CONSTRUCTION TO LOCATE THESE

THE IMPROVEMENTS COVERED BY THESE PLANS SHALL BE PERFORMED IN ACCORDANCE WITH MICHIGAN DEPARTMENT OF TRANSPORTATION (MDOT) 2012 STANDARD SPECIFICATIONS FOR CONSTRUCTION, INCLUDING REFERENCED MDOT PUBLICATIONS, AND THE PROJECT CONTRACT DOCUMENTS.



PROJECT MANAGEMENT SERVICES UNIT CITY OF ANN ARBOR PUBLIC SERVICES 301 EAST HURON STREET, P.O. BOX 8647 ANN ARBOR, MICHIGAN 48107-8647 734-794-6410 www.a2gov.org



CONSTRUCTION NOTES:

- 1. Driveways and entrances to buildings, real property, and the like shall not be blocked except for short durations and only when approved by the Engineer. Vehicular and pedestrian access shall be maintained at all times. It shall be the Contractor's responsibility to coordinate all necessary driveway closures with the property owner(s) and resident(s) in the areas of construction.
- 2. The location and depth of all existing utilities and service leads are to be field verified by the Contractor prior to construction.
- 3. Location and depth of utilities as depicted on the plans is approximate and shown according to the best information available. It is the Contractor's responsibility to excavate ahead and adjust depth of conflict utilities accordingly. Any damage to utilities is the Contractor's responsibility to avoid and/or repair as necessary.
- 4. The Contractor is to take special care to protect the existing water main and be responsible for maintaining consistent water service.
- 5. During non-working hours no trench shall remain open; any open trench shall be properly secured with protective fencing. This work shall be included in the item of work "General Conditions".
- Trenches for new water services shall be excavated to MIOSHA and City of Ann Arbor Field Services requirements.
- 7. City of Ann Arbor Field Services will install the corporation and copper service lead(s) to transfer the connection(s). If an existing water service is found to be failing or is not copper, the lead will be replaced to the curb box by Field Services.
- 8. For the installation of corporations, or any other related activities, the Contractor shall not receive additional compensation for delays due to the scheduling of or coordination with the City of Ann Arbor Field Services.
- 9. The Contractor shall backfill trenches in accordance with Trench Detail specified on plans. This work shall be included in the item of work "Excavate and Backfill for Water Service Tap and Lead". All concrete removals and replacements required for this work will be paid for separately.
- 10. All ductile iron pipe and fittings shall be polyethylene wrapped per ANSI/AWWA C105/A21.5.
- 11. Cor-blu bolts to be used at all mechanical water main joints at hydrants and Megalug fittings
- 12. The Contractor shall construct, flush, and bacteriologically test the water main per Detailed Specification "Water Main Installation and Testing" and as approved by the Engineer. All chlorinated water shall be discharged directly into an approved sanitary sewer. The Contractor shall supply all necessary hoses, fittings and the like to accomplish this work.
- 13. Water main fittings, other than those specifically listed as separate pay items, which are required to complete the work, such as blow-off assemblies, concrete thrust blocks, solid sleeves and mechanical plugs, shall not be paid for separately, but shall be included in the pipe pay items.
- 14. Postal delivery and refuse pickup service shall be maintained at all times by the Contractor.
- 15. All fittings, hydrants, valves and castings removed during construction are the property

of the City of Ann Arbor. The Contractor within 48 hours shall deliver to City of Ann Arbor Field Operations and Maintenance Facility at the W.R. Wheeler Service Center located at 4251 Stone School Road.

- 16. Where street curbs are undermined due to construction activities, they shall be removed and replaced as directed by the Engineer.
- 17. The Contractor shall be responsible for the continuous maintenance of the temporary road surface and soil erosion control measures within the construction area until the full completion of the project. This work shall be included in the item of work "General Conditions".
- 18. All curb, sidewalk, driveway approach removals shall be approved by Engineer before the work is done.
- 19. Sawed sewer pipe connections shall be coupled with a Fernco flexible coupling and a stainless steel shear ring.
- 20. The location of material stock piles and on-site staging areas to be approved by the Engineer.
- 21. For mainline paving, the width of the mat for each pass of the paver shall be not less than 10.5' or greater than 15', as directed by the Engineer. The Engineer will direct the layout of the longitudinal joints during construction.
- 22. All structures shall receive new castings as directed by the Engineer, as specified on the standard casting schedule. The existing castings are the property of the City of Ann Arbor. The Contractor shall deliver to City of Ann Arbor Field Operations and Maintenance Facility at the W.R. Wheeler Service Center located at 4251 Stone School Road.
- 23. Payment for drainage structure sumps, where specified, shall be included in the payment for the various drainage structure sizes and or types.
- 24. Where sewer pipes of different sizes or materials are joined, Fernco flexible couplings with stainless steel shear rings shall be used. The Contractor's purchase price for these devices, including shipping, shall be paid as an extra. Prior to payment for this item, the Contractor shall submit receipts for the Engineer's review and approval. All other costs associated with the installation of these devices shall be included in the payment for the sewer.
- 25. Where sewer and water main are to be removed & replaced or added, all pipe shall be installed using Trench Detail I, Modified detailed in the specifications or shown on Plans. Backfill for sewer and water construction shall be MDOT Granular Material, Class II, Modified.
- 26. Existing street name, guide, and regulatory signs, and mailboxes which conflict with the proposed construction shall be removed prior to construction, stored in a manner which will prevent damage, and re-set in locations as paid for separately, but shall be included in "General Conditions."
- 27. The pay item of Earth Excavation and Embankment (CIP) shall be paid at plan quantity unless the Engineer determines that there has been a significant change from the work shown on the plans. See the 2012 MDOT Standard Specifications for Construction, section 109.01 for more details.

<u>GENERA</u>	L			
NOTIFY	THE	CITY	OF	А
THE PR	OJEC	:Т. F	10H	۱E:

- GRADE.
- SITUATIONS THAT PROMOTE EROSION.

- ADJACENT PROPERTIES.

12. TREE PROTECTION FENCING MUST REMAIN INTACT UNTIL RESTORATION OF THE SITE IS COMPLETE. SEQUENCE OF EROSION CONTROL MEASURES:

1.	INCLU	CONT SOIL JDE I OURS	ERO NSPE	SION	0
SA	MPLE	SOIL	ERO	SION	I
1.	1.	NSTAI	L SI	LT	FE

	EARTH MOVING
1.2.	STRIP AND STO
1.3.	INSTALL WATER FILTERS SHALL
1.4.	PERFORM PAVEN
1.5.	CONTINUALLY M DRAINAGE AND

- 1.7. CLEAN OUT STORM SEWER SYSTEMS.

- PRIOR TO FINAL INSPECTION

NOTE: THIS SEQUENCE IS FOR INFORMATION ONLY. IT IS INTENDED TO SHOW THE SEQUENCE OF CONSTRUCTION WITH RESPECT TO THE SOIL EROSION AND SEDIMENTATION CONTROL MEASURES. THE CONTRACTOR IS RESPONSIBLE FOR SUBMITTING THEIR OWN DETAILED CONSTRUCTION SEQUENCE AND SCHEDULE TO THE ENGINEER FOR REVIEW, COMMENT, AND APPROVAL. TEMPORARY SEEDING:

1. SEED IN ACCORDANCE WITH PROJECT DRAWINGS AND SPECIFICATIONS.

BM #	ELEV	DESCRIPTION
1	860.321	NW ANCHOR BOLT FOR LIGHT POLE/SUPPORT POLE FOR SIGNALS @ SE CORNER OF DIVISION & HURON.
2	862.912	TOP NORTH SIDE OF CONC. BASE FOR PED. POLE @ N.E. CORNER OF DIVISION AND WASHINGTON.
3	864.071	TOP EAST SIDE OF CONC. BASE FOR PED. POLE @ N.W. CORNER OF DIVISION AND LIBERTY.
4	866.285	NW ANCHOR BOLT FOR LIGHT POLE ON EAST SIDE OF DIVISION @ HOUSE #333
5	866.820	NE ANCHOR BOLT FOR LIGHT POLE/SIGNAL SUPPORT POLE @ NW CORNER OF DIVISION & WILLIAM.
6	867.032	SE ANCHOR BOLT FOR LIGHT POLE ON WEST SIDE OF DIVISION @ HSE #414
7	869.096	SET RR SPIKE IN WEST SIDE OF LIGHT POLE @ NE CORNER OF DIVISION & JEFFERSON.
8	869.567	SET RR SPIKE IN WEST SIDE OF LIGHT POLE ON EAST SIDE OF DIVISION ACROSS THE STREET FROM HSE #518
9	867.483	SET RR SPIKE IN EAST SIDE OF LIGHT POLE ON WEST SIDE OF DIVISION @ NORTH SIDE OF CORNER PARK AREA.
10	860.114	SE ANCHOR BOLT FOR MAST ARM POLE ON WEST SIDE OF DIVISION @ PACKARD AND MADISON.

NN ARBOR SOIL EROSION CONTROL OFFICE 48 HOURS PRIOR TO BEGINNING WORK ON : 734-794-6265

THE CONTRACTOR SHALL IMPLEMENT AND MAINTAIN THE SOIL EROSION CONTROL MEASURES AS SHOWN ON THE PLANS AND AS DIRECTED BY THE ENGINEER AT ALL TIMES DURING CONSTRUCTION. ANY MODIFICATIONS OR ADDITIONS TO THE SOIL EROSION CONTROL MEASURES DUE TO CONSTRUCTION OR CHANGED CONDITIONS SHALL BE AS DIRECTED AND APPROVED BY THE ENGINEER.

ALL SOIL EROSION AND SEDIMENTATION CONTROL WORK SHALL CONFORM TO THE PERMIT REQUIREMENTS OF THE CITY OF ANN ARBOR, CITY ORDINANCE CHAPTER 63, CITY OF ANN ARBOR STANDARDS DIVISION VII, THE LAWS OF THE STATE OF MICHIGAN, AND THE REQUIREMENTS OF THE CONTRACT DOCUMENTS.

DAILY, OR AFTER ANY STORM EVENT, INSPECTIONS OF EROSION CONTROL MEASURES SHALL BE MADE BY THE CONTRACTOR. PERIODIC INSPECTIONS MAY BE MADE BY THE ENGINEER TO DETERMINE THE EFFECTIVENESS OF EROSION AND SEDIMENTATION CONTROL MEASURES. ANY NECESSARY CORRECTIONS SHALL BE MADE WITHOUT DELAY, AND WITHOUT ADDITIONAL COST TO THE CITY OF ANN ARBOR.

EROSION AND SEDIMENTATION FROM WORK ON THE SITE SHALL BE CONTAINED ON THE SITE AND NOT BE ALLOWED TO COLLECT ON ANY OFF-SITE AREAS, ROADWAYS OR WATERWAYS.

5. ALL MUD/SOIL TRACKED ONTO ROADWAYS FROM THE SITE DUE TO CONSTRUCTION, SHALL BE PROMPTLY REMOVED BY THE CONTRACTOR. IF SO ORDERED, THE CONTRACTOR SHALL PROVIDE AND OPERATE A VACUUM-TYPE STREET SWEEPER, AT NO ADDITIONAL COST TO THE CITY OF ANN ARBOR, WITHIN FOUR (4) HOURS OF BEING SO ORDERED.

RESTORATION OF ALL DISTURBED AREAS, INCLUDING PLACEMENT OF TOPSOIL, SEED, FERTILIZER AND MULCH AND/OR SOD SHALL BE PERFORMED WITHIN FIVE (5) DAYS OF THE COMPLETION OF FINAL

7. CONSTRUCTION OPERATIONS SHALL BE SCHEDULED AND PERFORMED SO THAT PREVENTATIVE SOIL EROSION CONTROL MEASURES ARE IN PLACE PRIOR TO EXCAVATION IN CRITICAL AREAS AND TEMPORARY STABILIZATION MEASURES ARE IN PLACE IMMEDIATELY FOLLOWING BACKFILLING OPERATIONS. SPECIAL PRECAUTIONS WILL BE TAKEN IN THE USE OF CONSTRUCTION EQUIPMENT TO PREVENT

9. PROPER DUST CONTROL SHALL BE MAINTAINED DURING CONSTRUCTION BY USE OF WATER TRUCKS AND/OR DUST PALLATIVE AS REQUIRED.

10. THE CONTRACTOR SHALL BE RESPONSIBLE FOR MAINTAINING ALL TEMPORARY SOIL EROSION CONTROL MEASURES AND REMOVAL OF SOME MEASURES UPON AUTHORIZED COMPLETION OF THE PROJECT FINAL COMPLETION OF PROJECT WILL NOT BE AUTHORIZED UNTIL ALL SITE WORK AND UTILITY CONSTRUCTION IS COMPLETE AND ALL SOILS ARE STABILIZED.

11. THE CONTRACTOR SHALL NOT GRADE INTO ADJACENT PROPERTIES. SILT AND PROTECTIVE FENCE SHALL BE INSTALLED AND MAINTAINED TO PREVENT GRADING, EROSION AND SEDIMENTATION INTO THE

> IS TO SUBMIT TO THE ENGINEER. A SEQUENCE OF CONSTRUCTION WITH RESPECT TO CONTROL MEASURES FOR REVIEW, COMMENT AND APPROVAL. THIS SCHEDULE IS TO IN AND REPAIR OF ALL TEMPORARY EROSION CONTROL MEASURES DAILY AND WITHIN TORM EVENT.

AND SEDIMENTATION CONTROL INSTALLATION MINIMUM REQUIREMENTS: ENCE, TREE PROTECTION FENCING, MUD MATS, INLET FILTERS ON EXISTING DRAINAGE FEATURES, AND ALL OTHER TEMPORARY SOIL EROSION CONTROLS, PRIOR TO ANY CLEARING OR OPERATION.

CKPILE TOPSOIL. STABILIZE STOCKPILE AS REQUIRED.

MAIN, STORM SEWERS, AND OTHER ENCLOSED DRAINAGE FEATURES. NEW INLET BE INSTALLED IMMEDIATELY FOLLOWING INSTALLATION OF NEW DRAINAGE INLETS. MENT REPAIR AND CONSTRUCTION OF SIDEWALK AND CURB AND GUTTER.

MAINTAIN EROSION AND SEDIMENTATION CONTROL MEASURES, AS REQUIRED TO ALLOW SEDIMENT REMOVAL. REMOVE ANY ACCUMULATED SEDIMENT IMEDIATELY.

1.6. INSTALL SLOPE RESTORATION IN ALL DISTURBED AREAS.

1.8. REMEDY ANY NOTED DEFECTS TO THE SATISFACTION OF THE CITY OF ANN ARBOR'S SOIL EROSION AND SEDIMENTATION CONTROL OFFICIAL.

1.9. ALL TEMP. SOIL EROSION CONTROL MEASURES MUST BE REMOVED, WITH ENGINEERS APPROVAL,

directed by the Engineer. This work will not be 2. ANY DISTURBED AREA NOT PAVED, SEEDED, MULCHED, SODDED OR BUILT UPON BY NOVEMBER 15TH OR JUNE 30TH IS TO BE TEMPORARILY STABILIZED PER SPECIFICATIONS.

PERMI PRIOR

LANE CLC

"NO PARK

RIGHT-OF

PERMI ARBOF

M.D.E.Q. W PERMIT

M.D.O.T. R

CONT

PUE WATER

SANITARY

STORM

FORESTRY

SIGNS

SIGNALS STREET LI

GAS

PRI

ELECTRIC

CABLE

PHONE

FIBER OPT


MISCE

AGGREG/ **BRICK PAV EROSION** EMBANKM EXCAVATIC GEOSYNTH GRANULAF HAND PAT PAVEMENT PAVEMENT **POINT EXIS** PROTECTI


								aig.
ITS REQUIRED T				<u>ן ן</u>		Į	below.	re you u
R TO THE BEGINI PERMIT	NING OF C	ISSUING AU		3			Know what's below.	
OSURE PERMIT*		CITY OF ANN ARBOR			and a strange of		κηο Κηον	ັ
KING" SIGNS PERMIT*		PROJECT MANAGEMEN	IT UNIT			DAD	DAD	CHECKED
			IT UNIT					-
F-WAY PERMIT*		CITY OF ANN ARBOR CUSTOMER SERVICE				AG,GS,RG	AG,GS,RG	DRAWN
*	NO COST TO	CONTRACTOR		〕┠┼		<	<	
						-24-17	-08-17	DATE
ITS REQUIRED T R PRIOR TO THE] -		03	03	
PERMIT		ISSUING AU	JTHORITY					
WATER MAIN CONSTRUCTI	ON	MICHIGAN DEPARTMENT		1				N
RIGHT-OF-WAY PERMIT		MICHIGAN DEPARTMENT	OF TRANSPORTATION					DESCRIP TION
ACT INFORMATI	ON			i		M #1		
IBLIC UTILITIES		OWNER	CONTACT]		ADDENDUM	SET	
			DAN WOODEN (734) 794–6350	▏┠┼		ADI	BID	
1			MARK COZART (734) 794-6350			01	8	REV.
		IONS SERVICE UNIT	MATT WALDSMITH		ΞοË	647		
Y		SERVICE CENTER SCHOOL ROAD	(734) 794–6350 STEVEN GOEBEL		CILY OF ANN ARBOR PUBLIC SERVICES 301 EAST HURON STREET	OX 8647 MI 48107-8647	0410 v.org	
			(734) 794–6350		OF AND LIC SEI ST HURC	0. BOX 30R, MI	/34-/34-0410 www.a2gov.org	
IGHTS			CHUCK FOJTIK (734) 794–6361		PUBL 301 EAS	P.O. BOX 8647 ANN ARBOR, MI 4810	~ ^	
		OWNER	CONTACT	╡┃゛	-			
	DTE ENERGY		ROBERT CZAPIEWSKI		ARBO	r Pr	1	i)
	3150 E. MICH YPSILANTI TO	IGAN AVE, WNSHIP, MI 48198	(734) 544–7818	ANN			CORPORATED 1851	CHIGH
	DTE ENERGY WESTERN WAY 8001 HAGGER BELLEVILLE, M		CLAY COMBEE (734) 397-4112	40		0	-m	?
	COMCAST 27800 FRANK SOUTHFIELD,		RON SUTHERLAND (313) 999–8300					
	AT&T 550 S. MAPLI ANN ARBOR,		(734) 996–2135	RBOR	2017			
TIC	MCI 2800 N. GLEN RICHARDSON,		DEAN BOYERS (972) 729-6016	ANN AF	- DNIC			
				Ь	REET RESURFACING	EET		-
					ESU	S DIVISION STREET		
				4 8 4	L R	ISIO		י ב ב
ITEM DE ATE BASE, C.I.P., 21AA	ESCRIPTION		QUANTITY 25 CYD	CES		S DIV	Ũ	D
			23 010			3		

LLANEOUS QUANTITES	
ITEM DESCRIPTION	QUANTITY
ATE BASE, C.I.P., 21AA	25 CYD
VERS, REMOVE AND REPLACE, ANY TYPE	500 SFT
CONTROL, INLET PROTECTION, FABRIC DROP	17 EA
IENT, CIP	239 CYD
ION, EARTH	303 CYD
HETIC PAVING LAYER	9,929 SYD
R MATERIAL, CL II	138 CYD
CHING, HMA LVSP	346 TONS
T JOINT AND CRACK REPAIR - DETAIL 7	240 FT
T JOINT AND CRACK REPAIR - DETAIL 8	120 FT
STING STRUCTURE	5 EA
	1000 FT




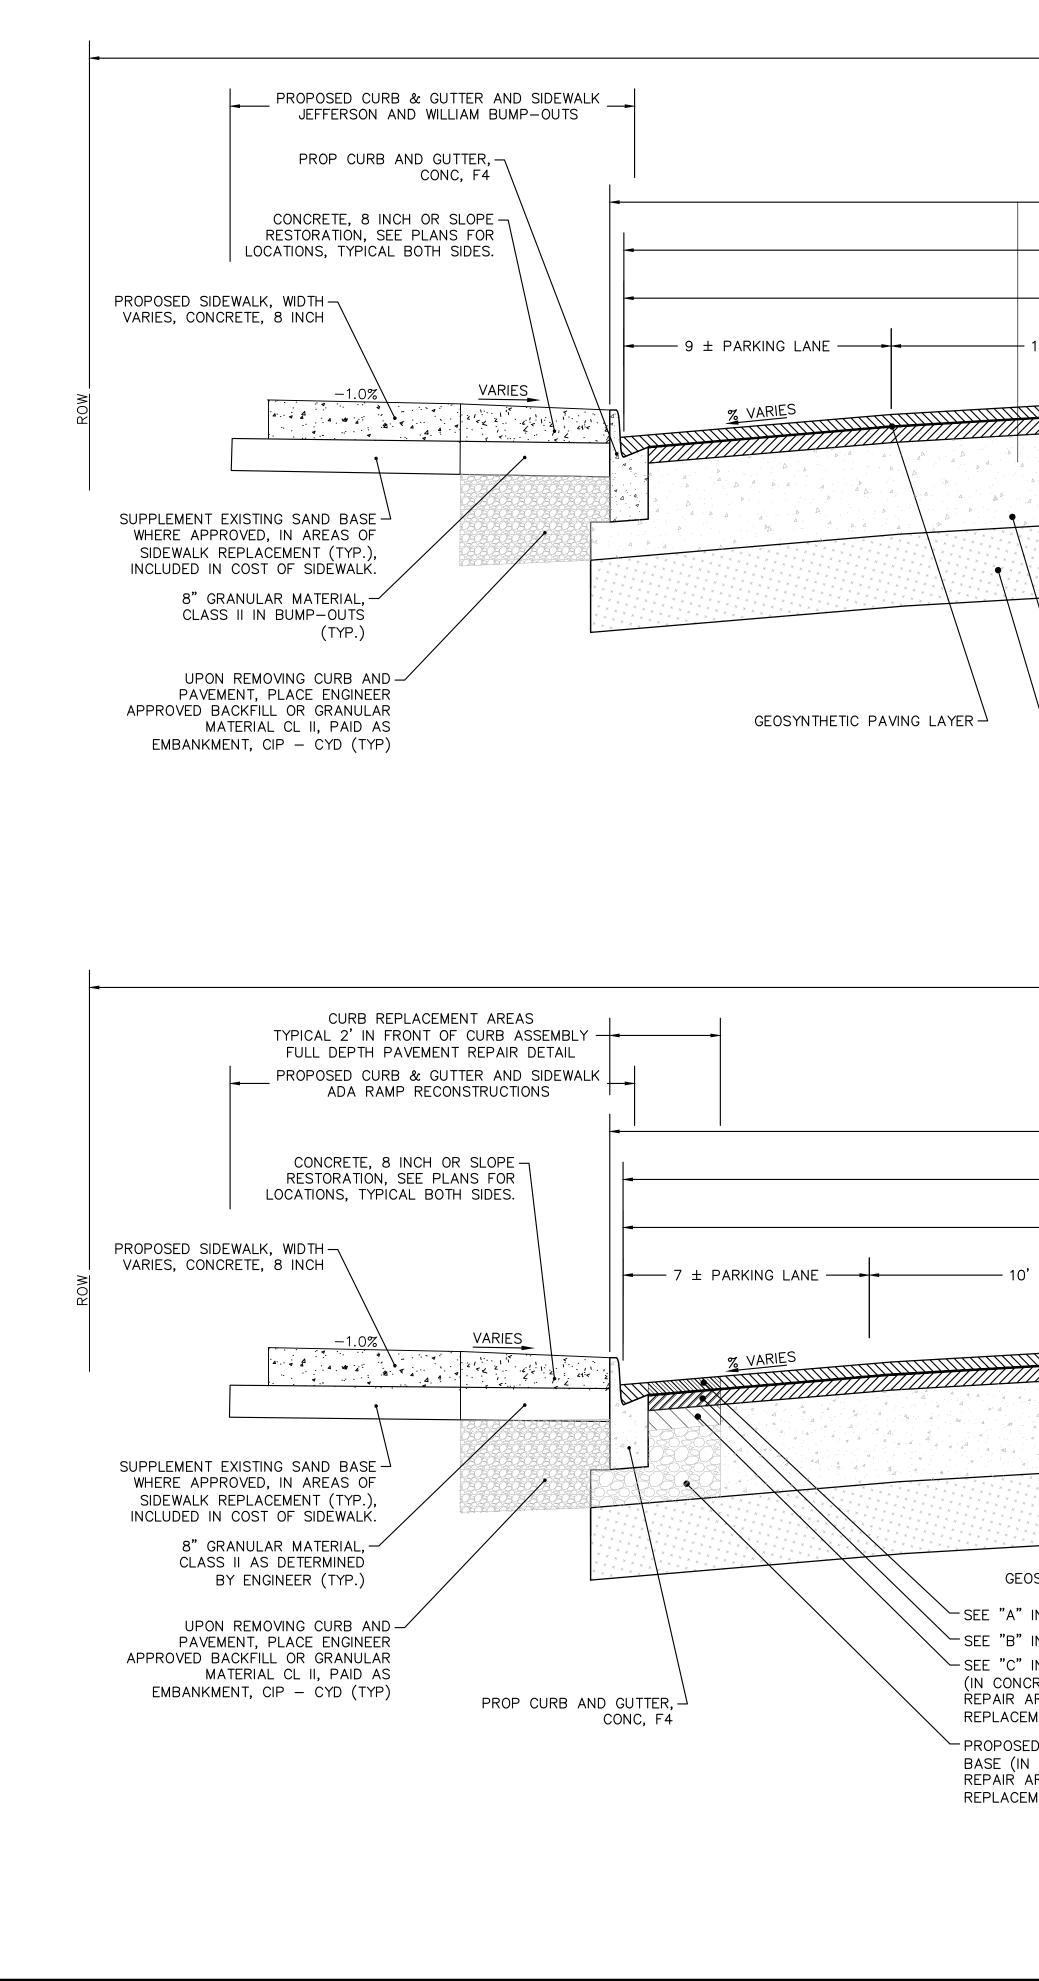

		- 66'			
			FULL DEPTH PAVEMENT R PROPOSED TRENCH FOR JEFFERSON TO WI	WATER MAIN	PROP(JEF
	43+/-	- B/CB/C			
	- COLD-MILLING BIT	UMINOUS PAVEMENT, 4" ——			
	42'+/-	FACE – FACE –			
10' LANE		— 10' LANE ————	6' BIKING LANE	- 7' PARKING LANE -	
% VARIES				VARIES	<u>%</u> V
		<td></td> <td></td> <td></td>			
	* * * * * * * * * * * * * * * * * * * *	* * * * * * * * * * * * * * * * * * * *			* * * * * * * * * * * * * * * * * * * *
		SEE "A" IN TABLE		**************************************	* * * * * * * * * * * * * * * * * * * *
EXISTING 10"± CONC		SEE "B" IN TABLE SEE "C" IN TABLE	PROPOSED 8" 21AA BASE (IN WATERMA CONCRETE PAVEMEI	IN TRENCH,	
EXISTING 10" 2NS SAN	CONC	(IN WATERMAIN TRENCH, CRETE PAVEMENT REPAIR AREAS, AND CONCRETE	AREAS, AND CURB AREAS)		\backslash
		REPLACEMENT AREAS)			VATERMAIN ON EXISTING
		SION ST			
		SECTION			
		3 TO 13+50 .T.S.			
		- 66'			
					PROP
	43+/-	- B/CB/C			
		UMINOUS PAVEMENT, 4" ——			
	I.	FACE – FACE – I			
LANE	1C)' LANE	10' LANE	5' BIKING LANE	
<u>% VARIE</u> S				VARIES	<u>%</u> V
* * * * * * * * * * * * * * * * * * *		* * * * * * * * * * * * * * * * * * *			
SYNTHETIC PAVING LAYER		SEE "A" IN TABLE		***************************************	* * * * * * * * * * * * * * * * * * *
IN TABLE	,	SEE "B" IN TABLE		STING 10"± CONCRETE BASE W IAINING VARIABLE DEPTH HMA	ітн \
IN TABLE IN TABLE			└─ EXIST	ING 10" 2NS SAND SUBBASE	
RETE PAVEMENT REAS AND CURB	S. DIVI	SION ST		TYI	
MENT AREAS) D 8" 21AA LIMESTONE		SECTION	ITI	EM MIX	APPLICA
CONCRETE PAVEMENT REAS, AND CURB MENT AREAS)	<u>STA. 13+</u>	50 TO POE		A HMA, 5E3	165 LB/
	N.	.T.S.		B HMA, 4E3 C HMA, 3E3	275 LB/ 410 LB/

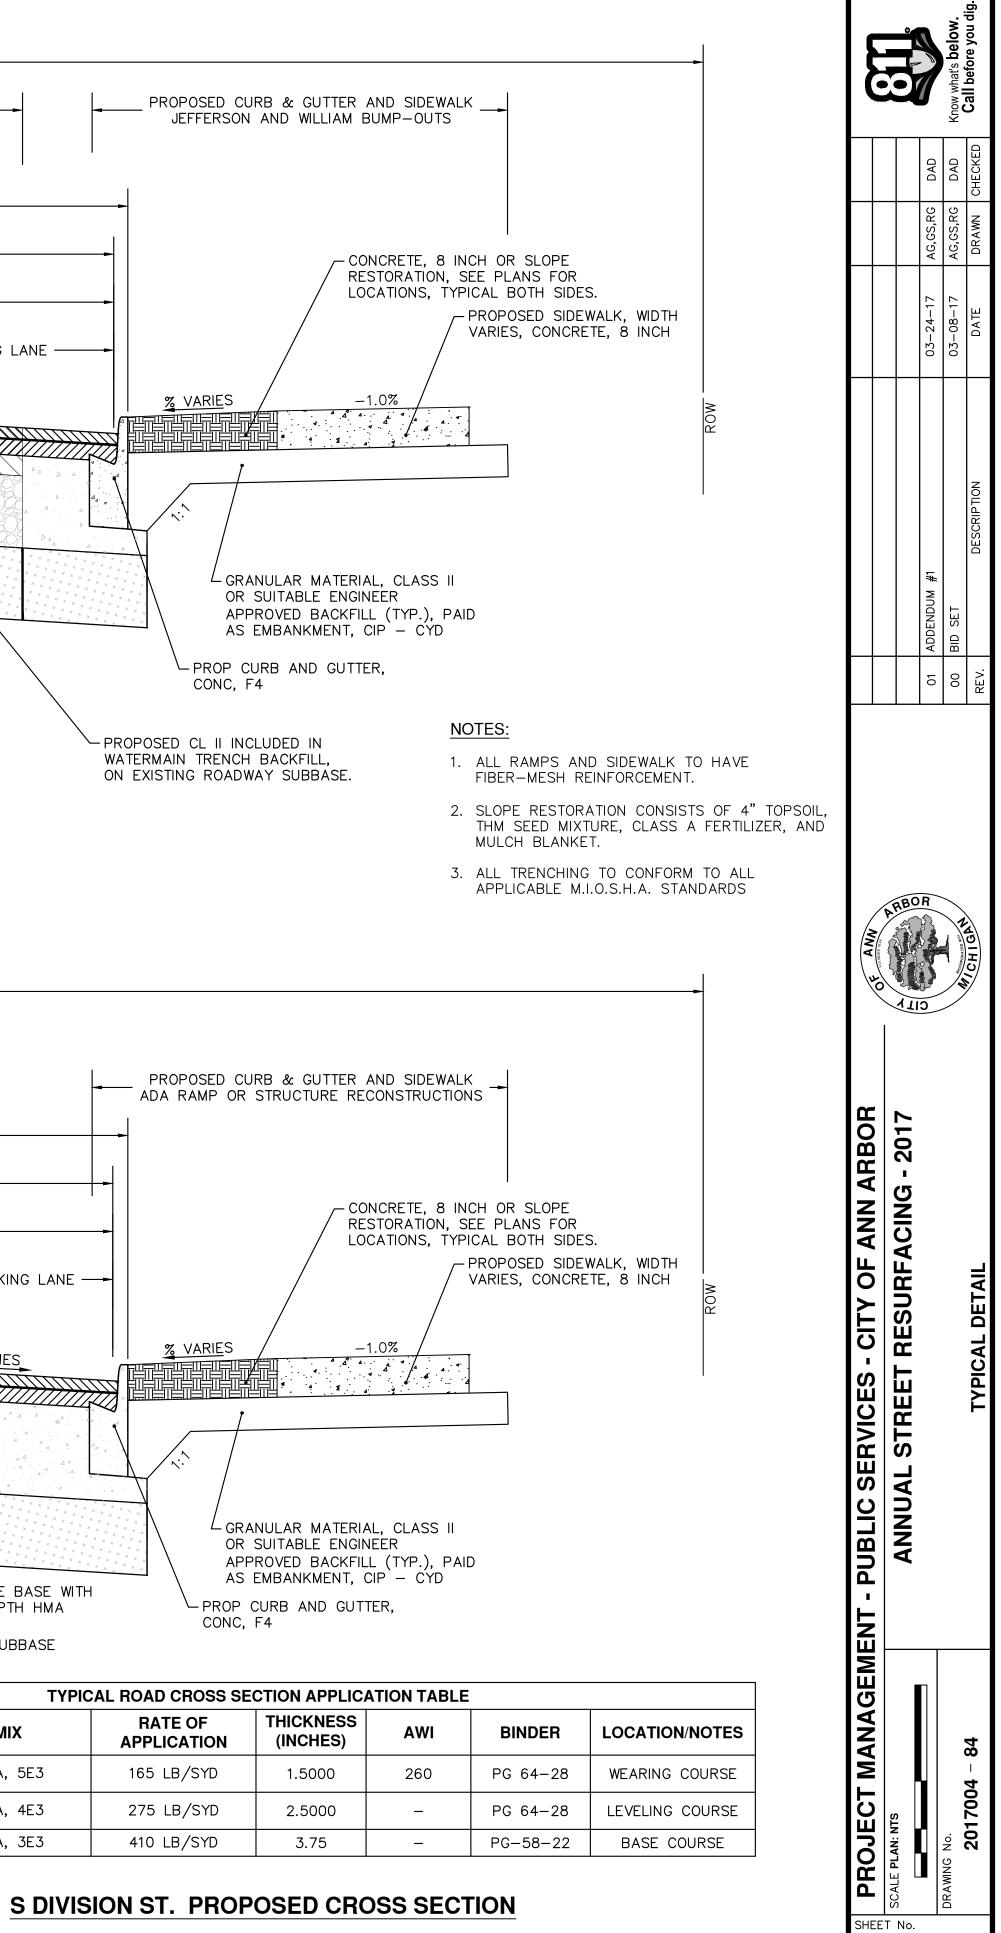


84 ^o⊧ 136

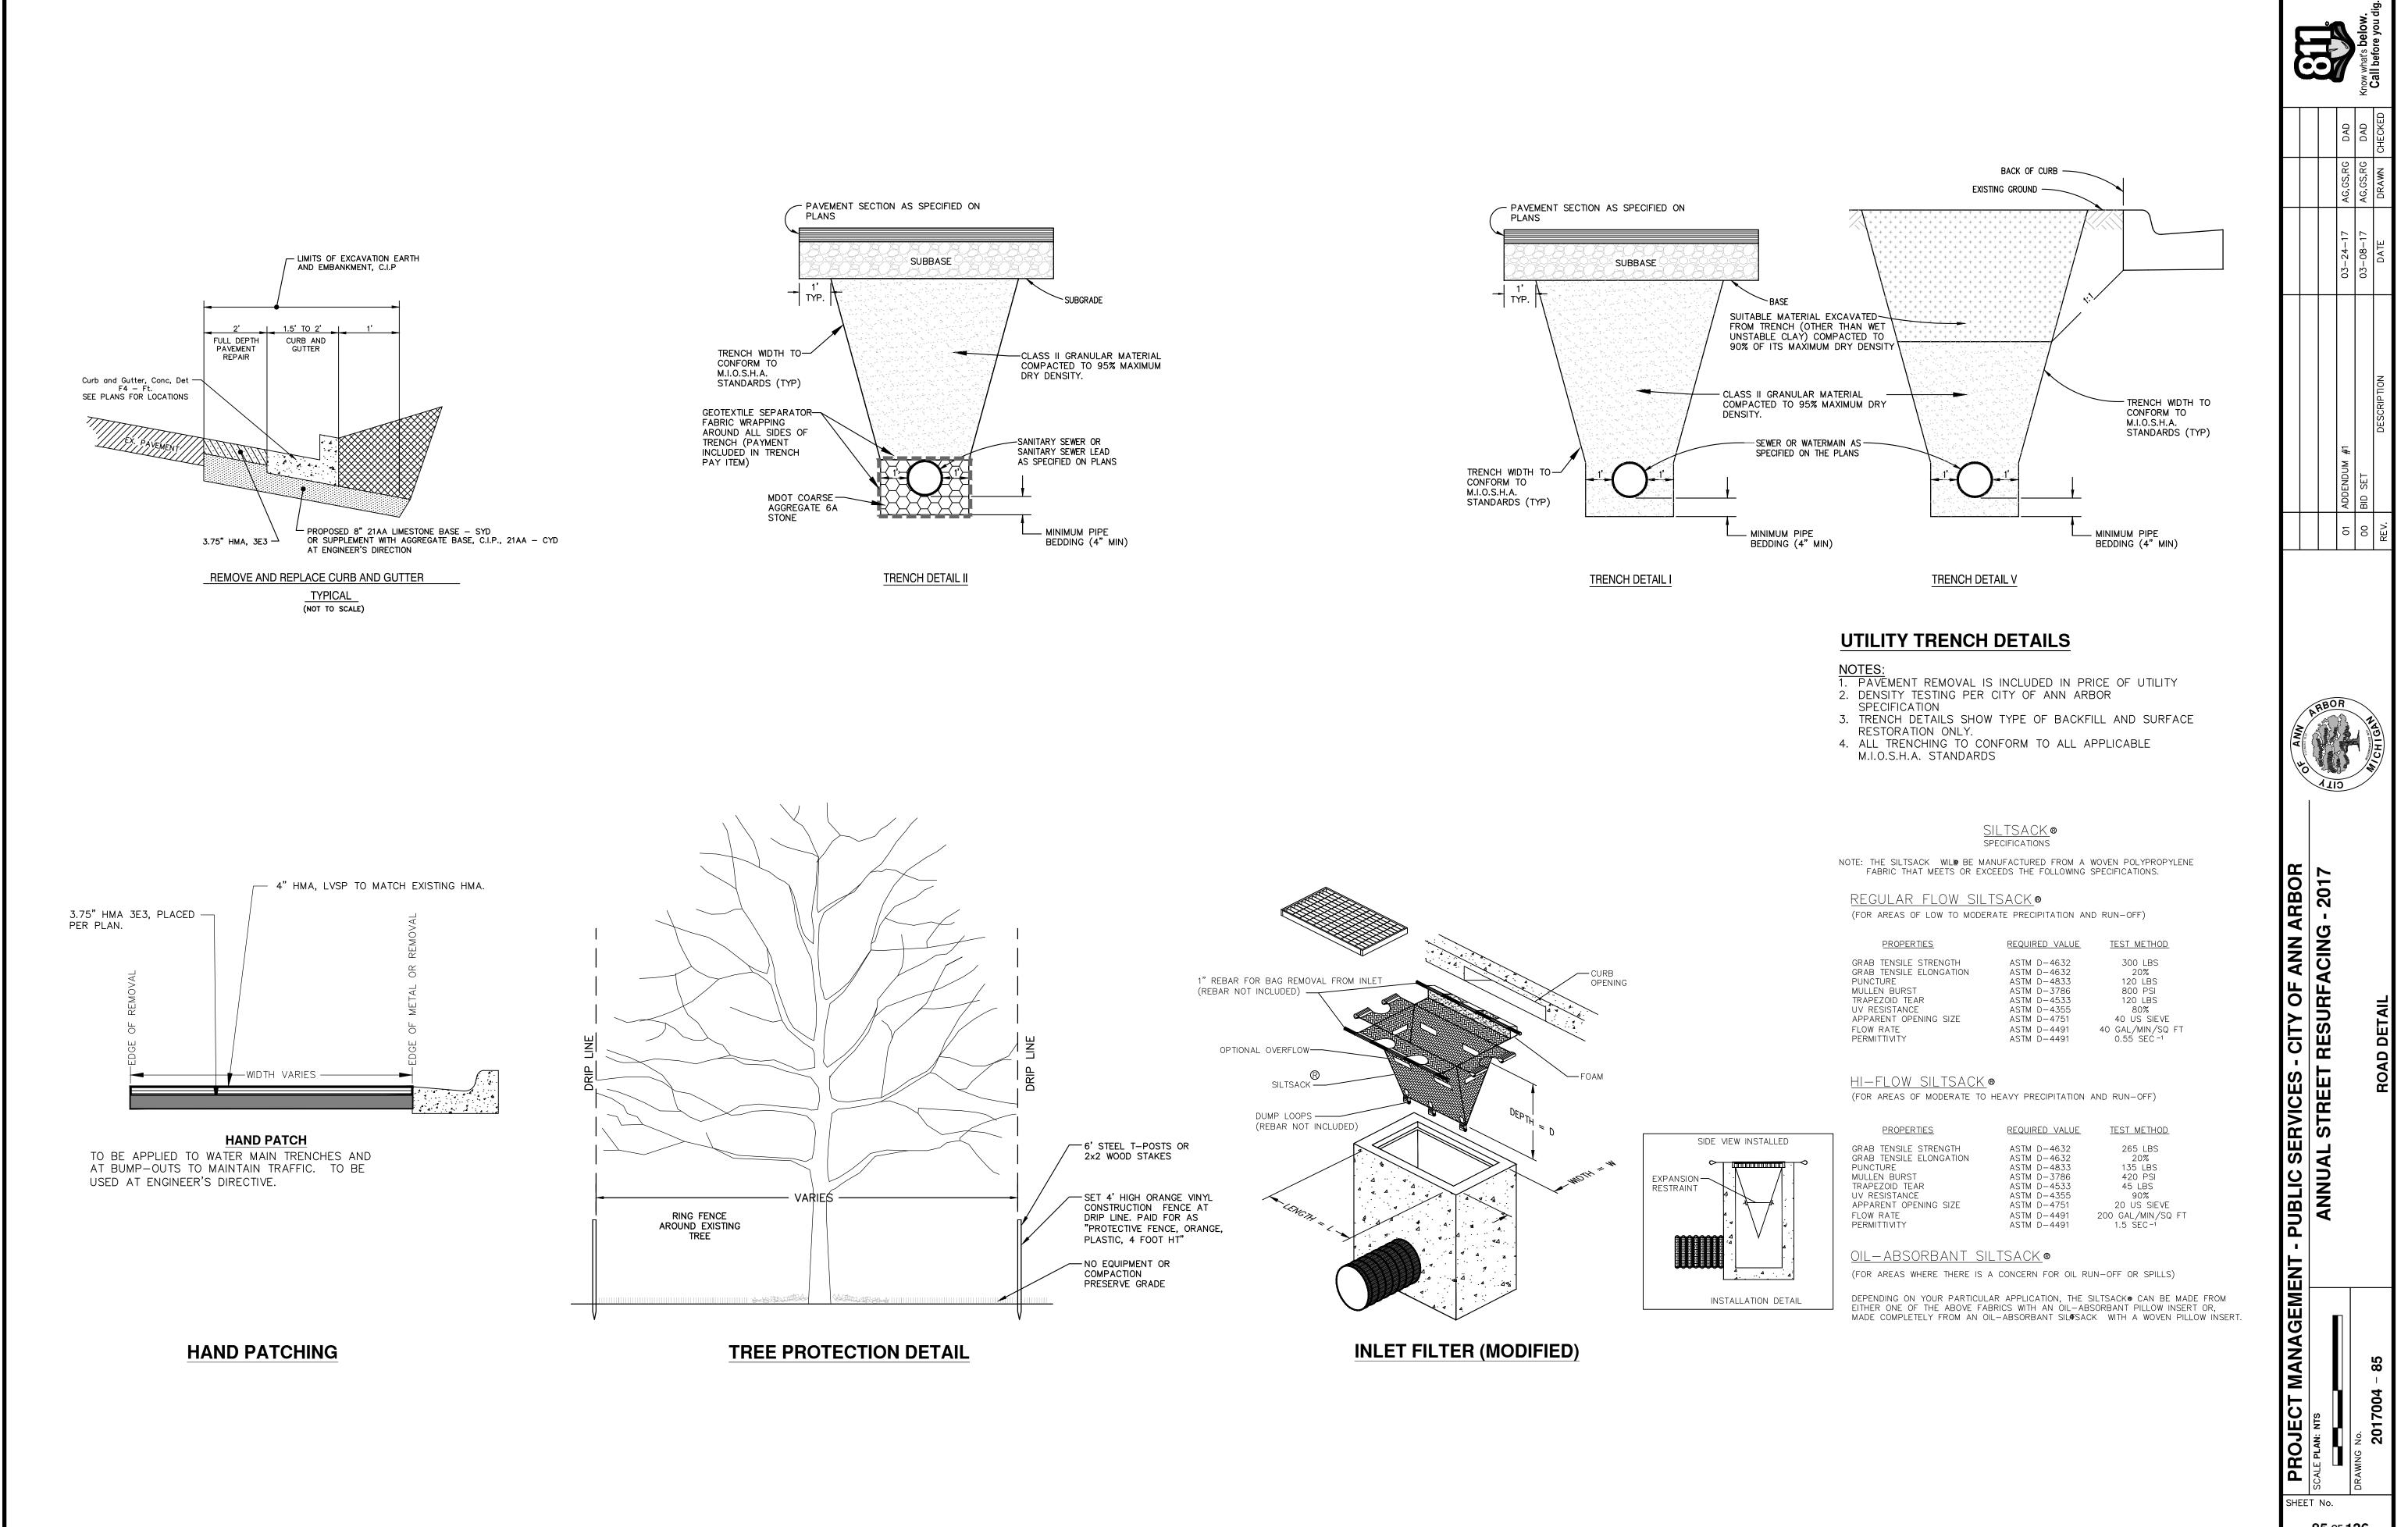



85 ^o⊧ 136

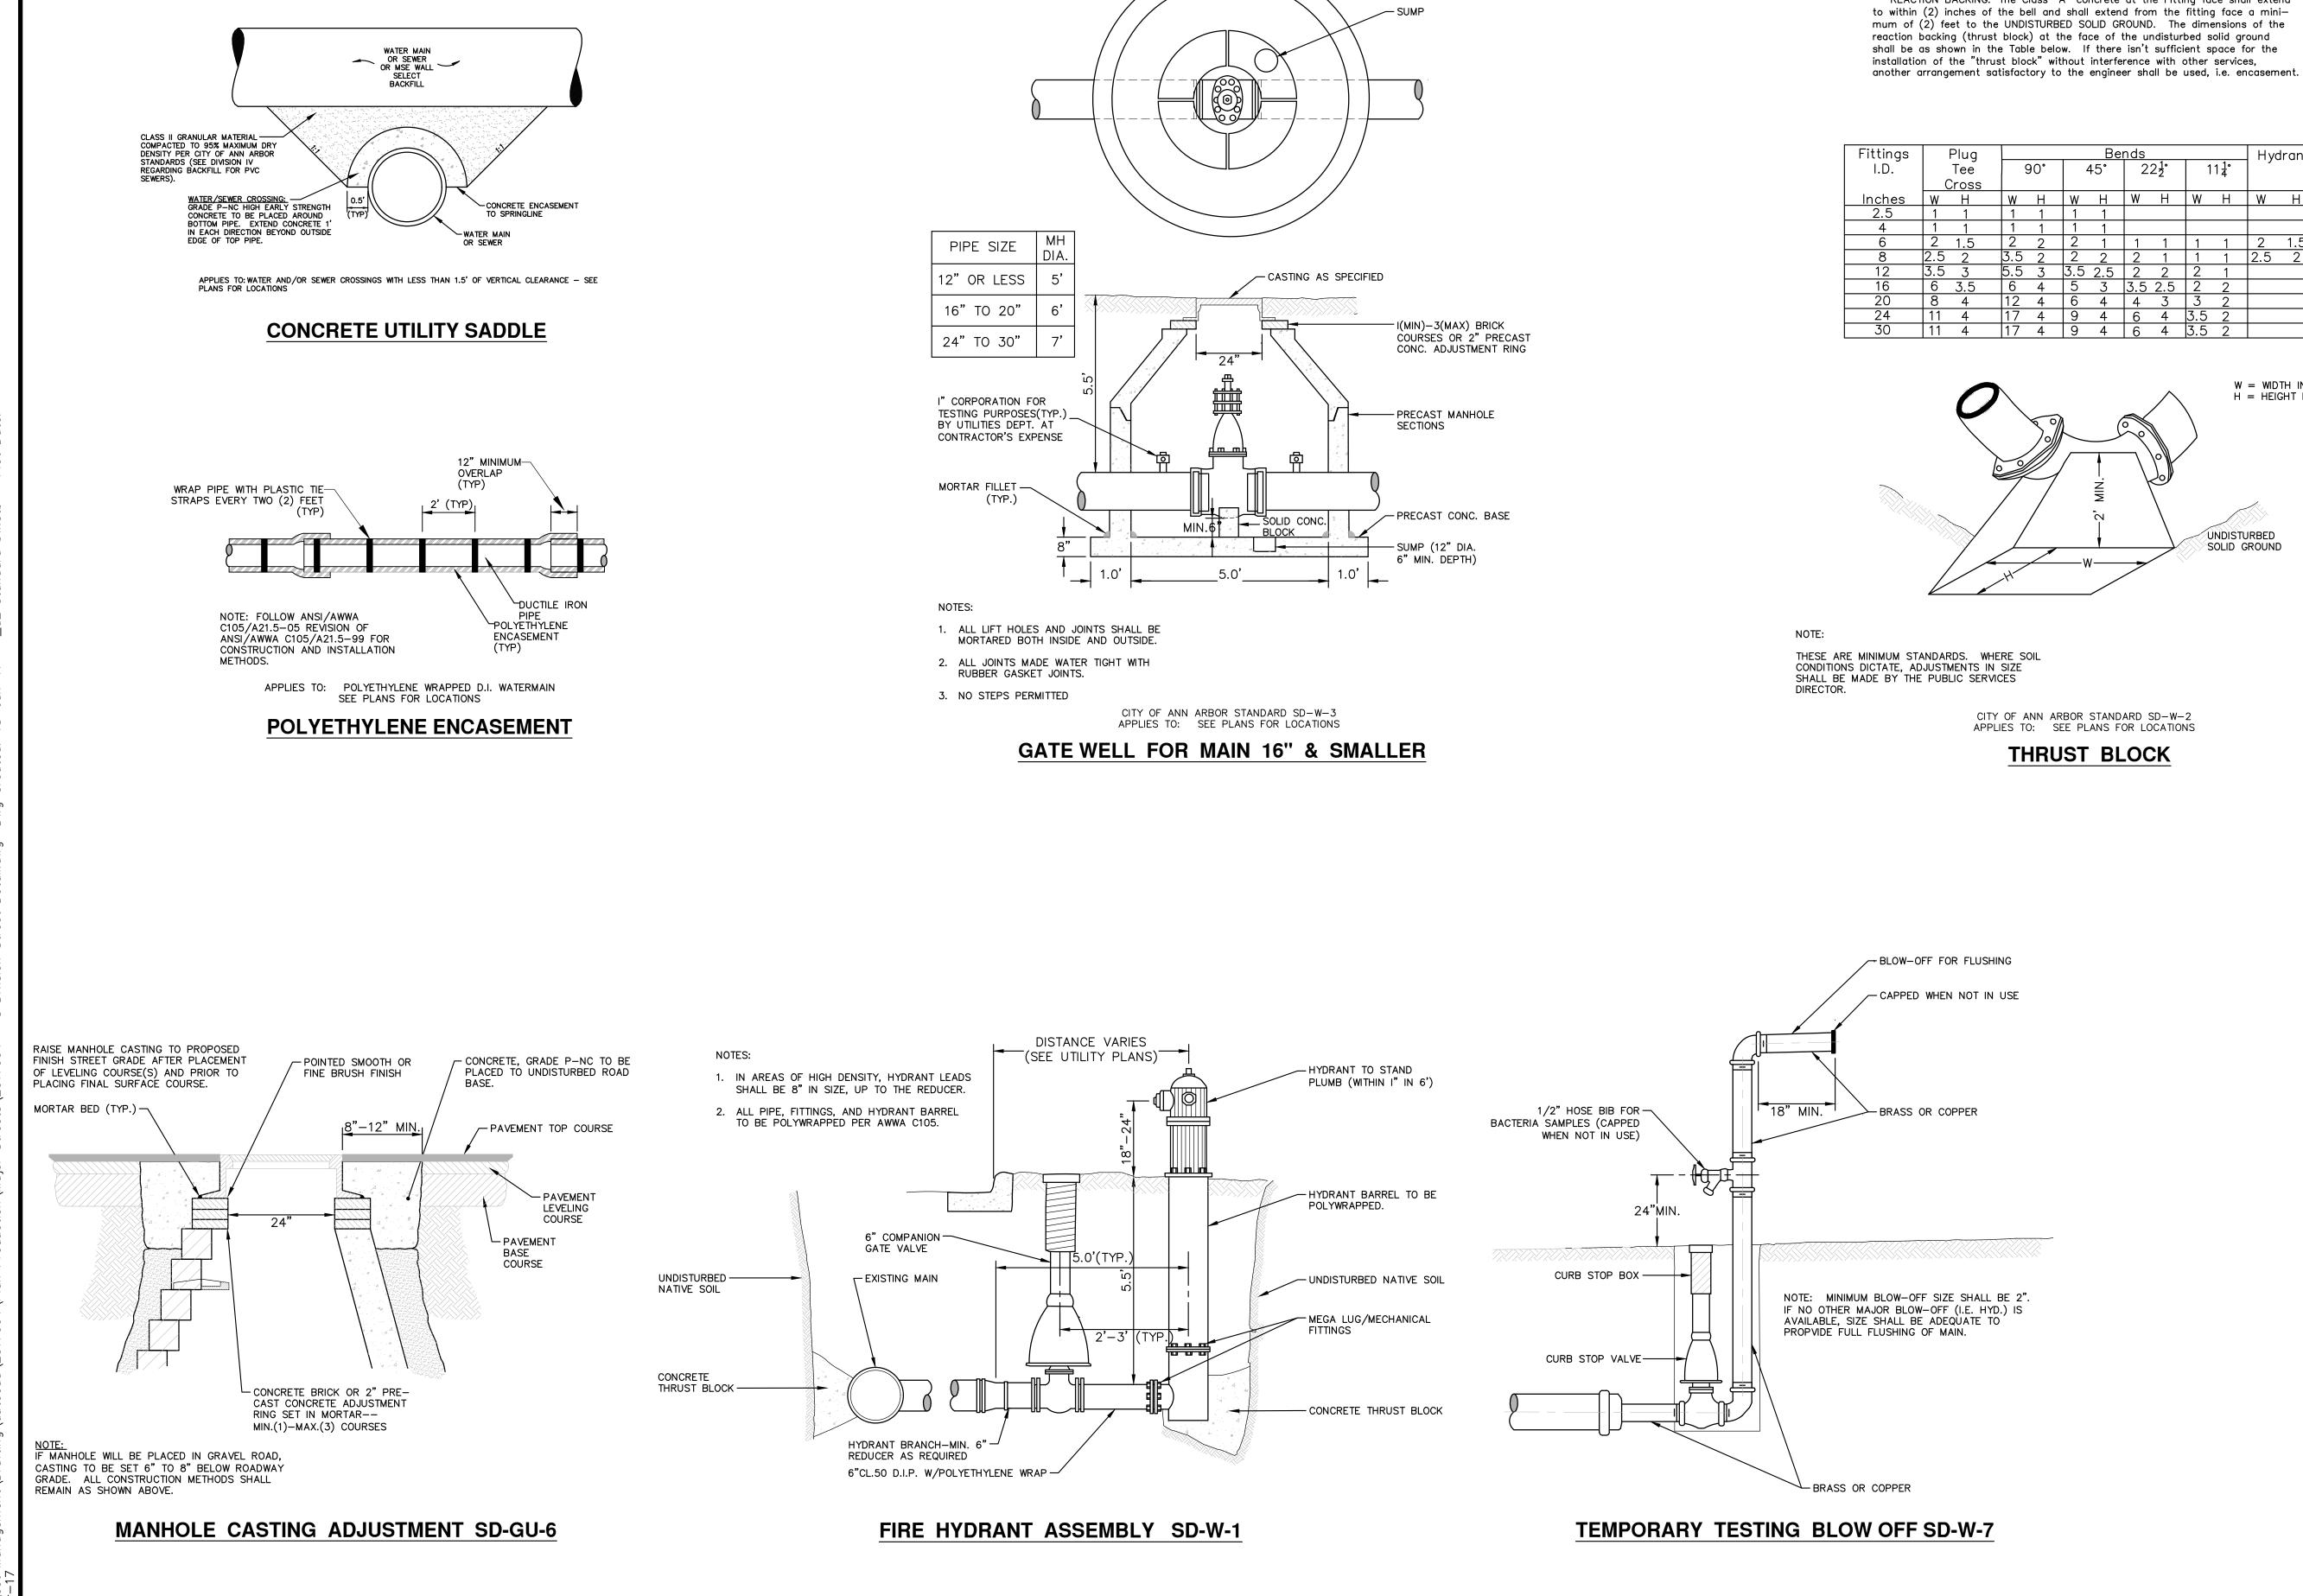

<u>PLAN VIEW</u>


W = WIDTH IN FEET H = HEIGHT IN FEET


Jg	Bends								Hvo	Irant
e	9	90°		45°	2	$2\frac{1}{2}^{\circ}$	1	1 <u></u> 4°		
ss						-		•		
-	W	Н	W	Н	W	Н	W	Н	W	Η
1	1	1	1	1						
1	1	1	1	1						
5	2	2	2	1	1	1	1	1	2	1.5
2	3.5	2	2	2	2	1	1	1	2.5	2
3	5.5	3	3.5	2.5	2	2	2	1		
.5	6	4	5	3	3.5	2.5	2	2		
1	12	4	6	4	4	3	3	2		
1	17	4	9	4	6	4	3.5	2		
1	17	4	9	4	6	4	3.5	2		


REACTION BACKING: The Class "A" concrete at the Fitting face shall extend


MINIMUM STANDARDS

	E PROJECT MANAGEME	MANAGEMENT - PUBLIC SERVICES - CITY OF ANN ARBOR	AM						
36			the grantsh of						
	_ SCALE : NTS								
0	No.	ANNUAL STREET RESURFACING - 2017	BO						
F				01 A	ADDENDUM #1	03-24-17	AG,GS,RG	DAD	
1									
3	URAWING NO.		A PROPAGATED AND	00 B	BID SET	03-08-17	AG,GS,RG	DAD	Know what's below
6	2017004-86 –	WATER DETAIL	W/CHIGN	REV.	DESCRIPTION	DATE	DRAWN	DRAWN CHECKED	Call before you dig.

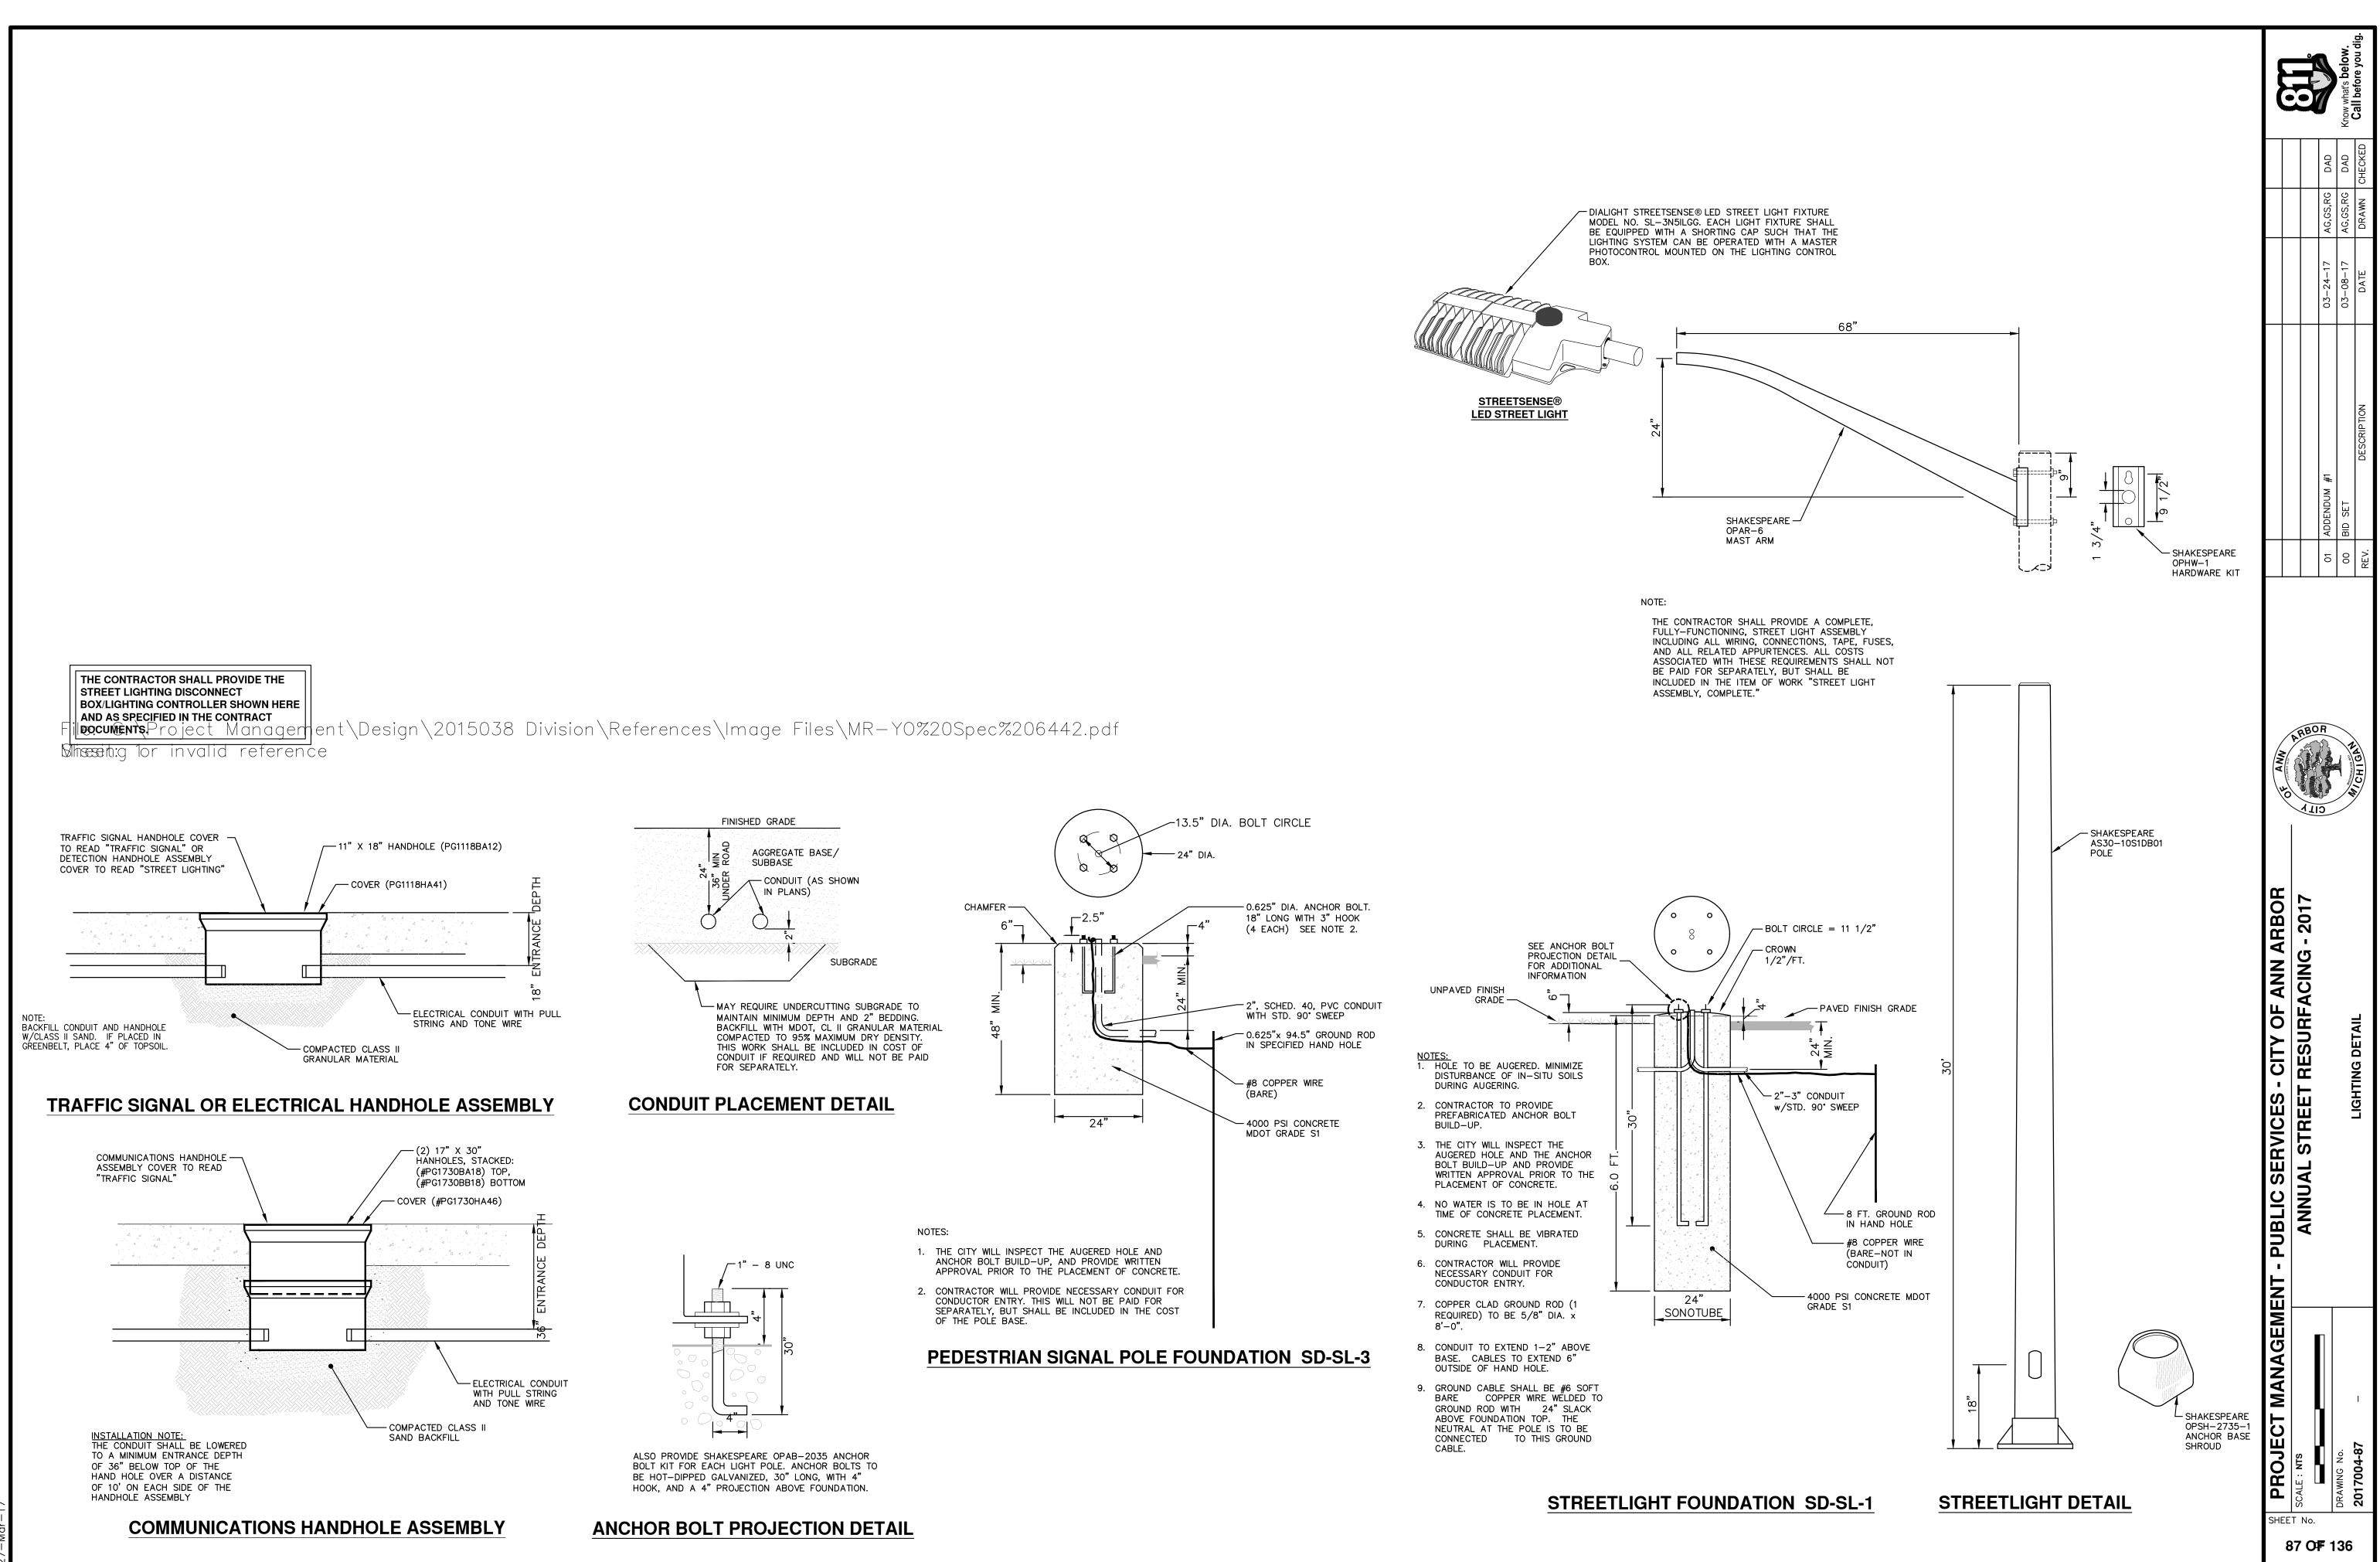

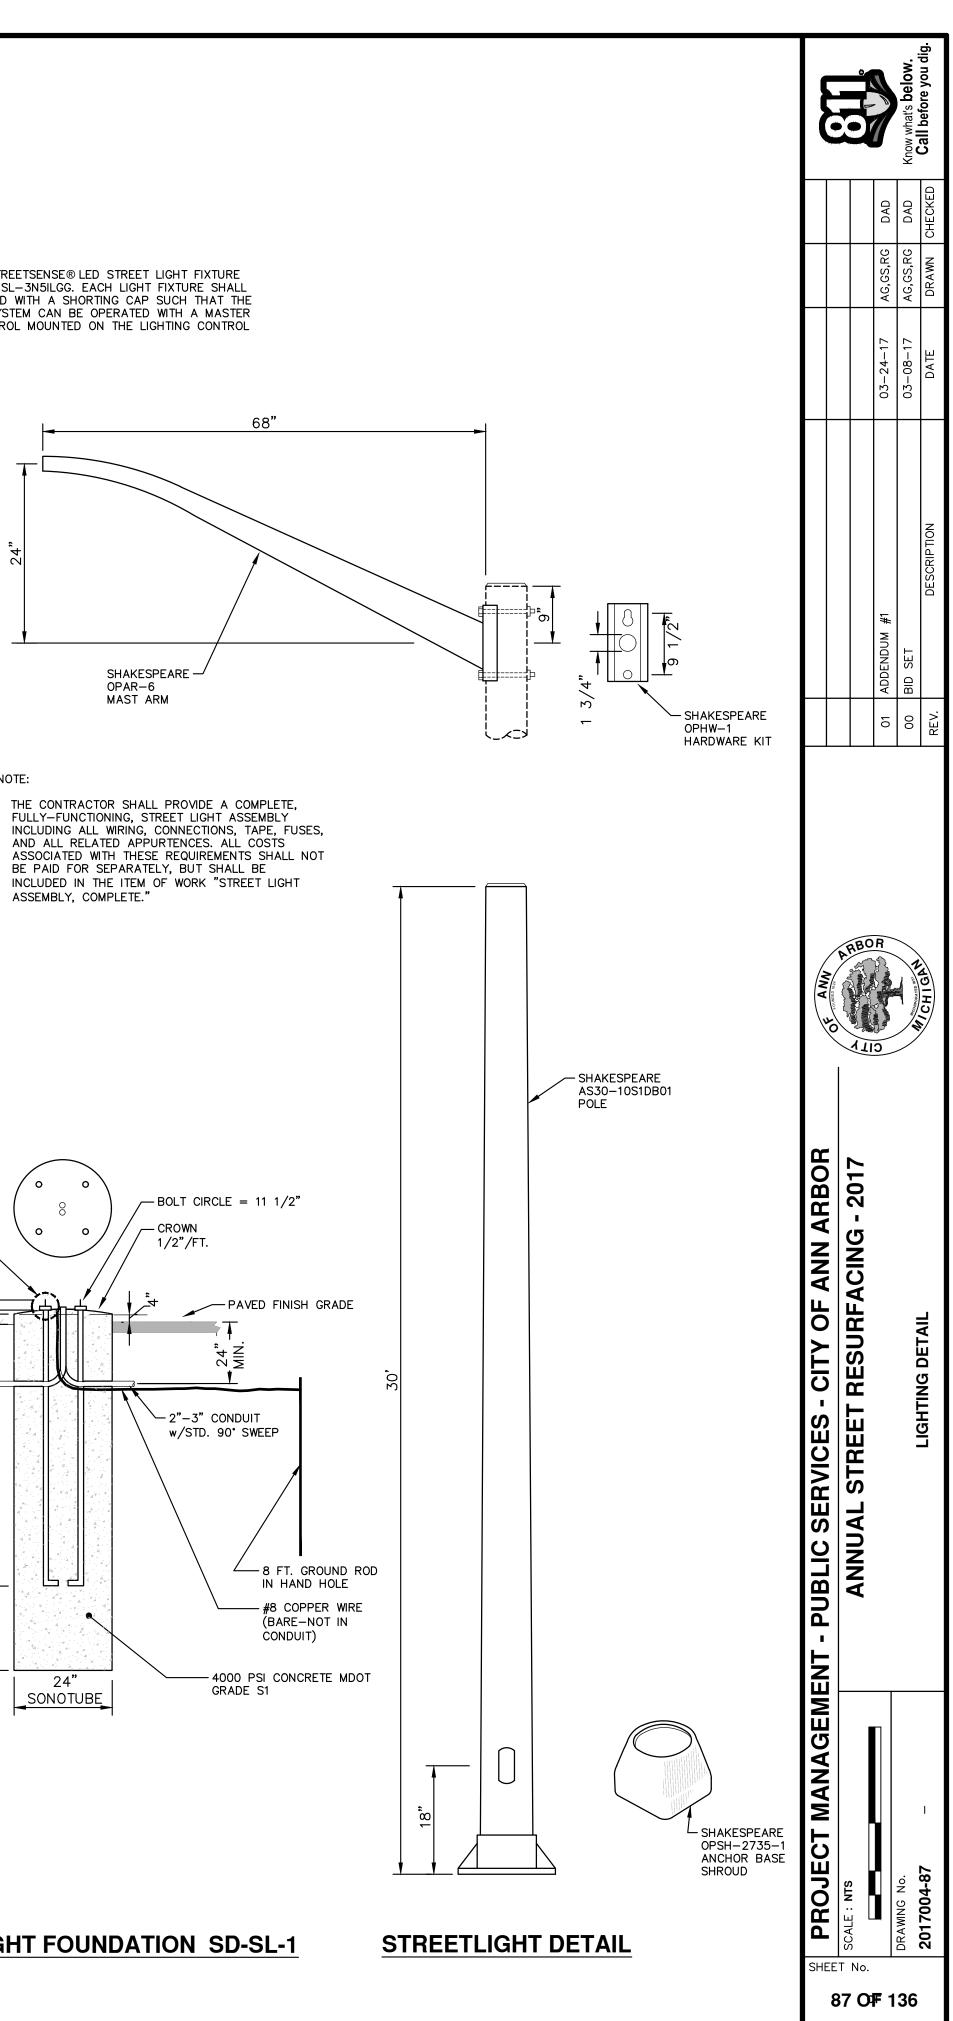

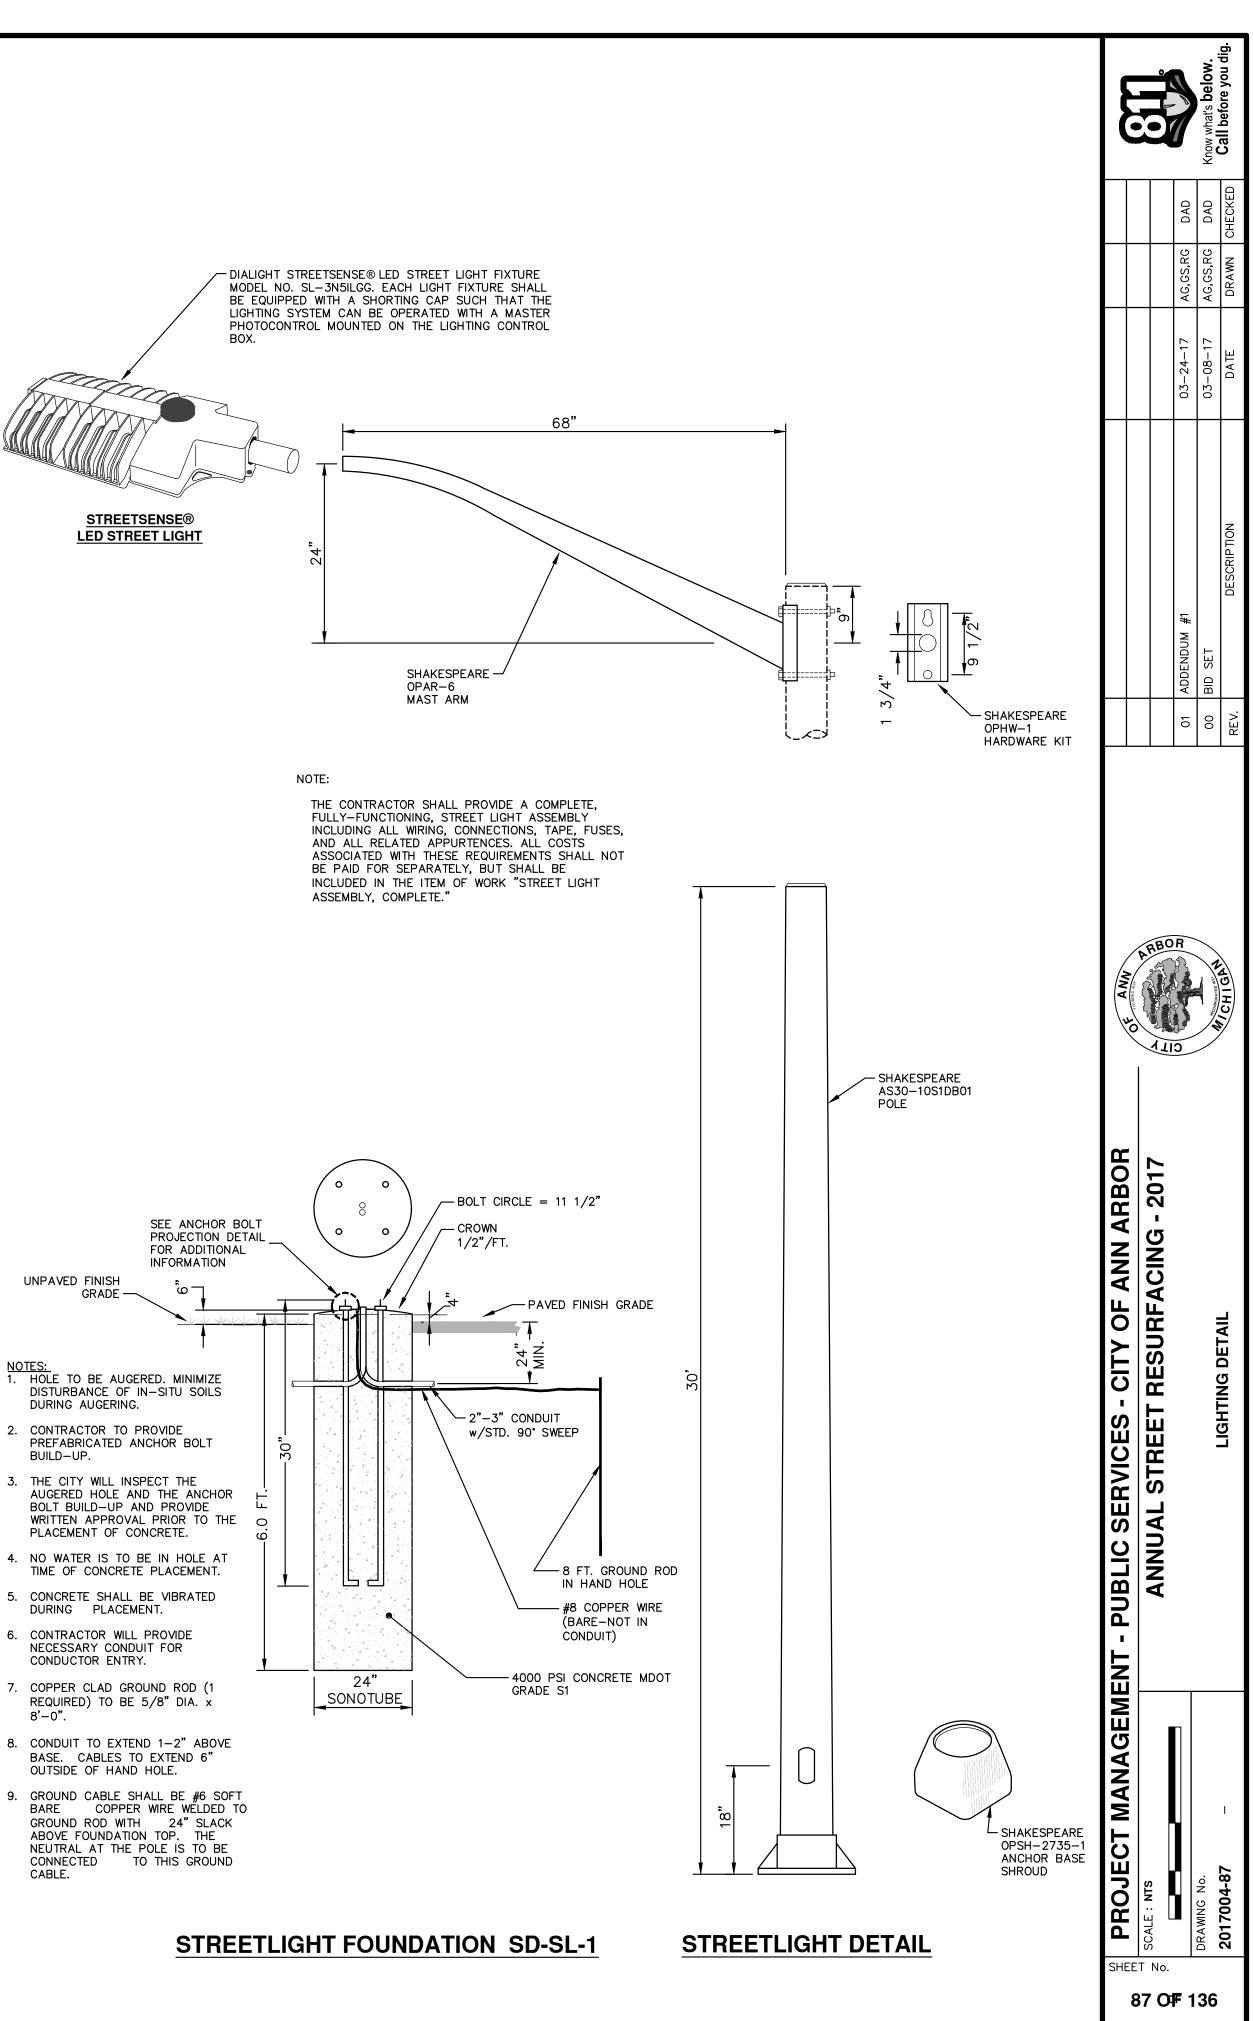

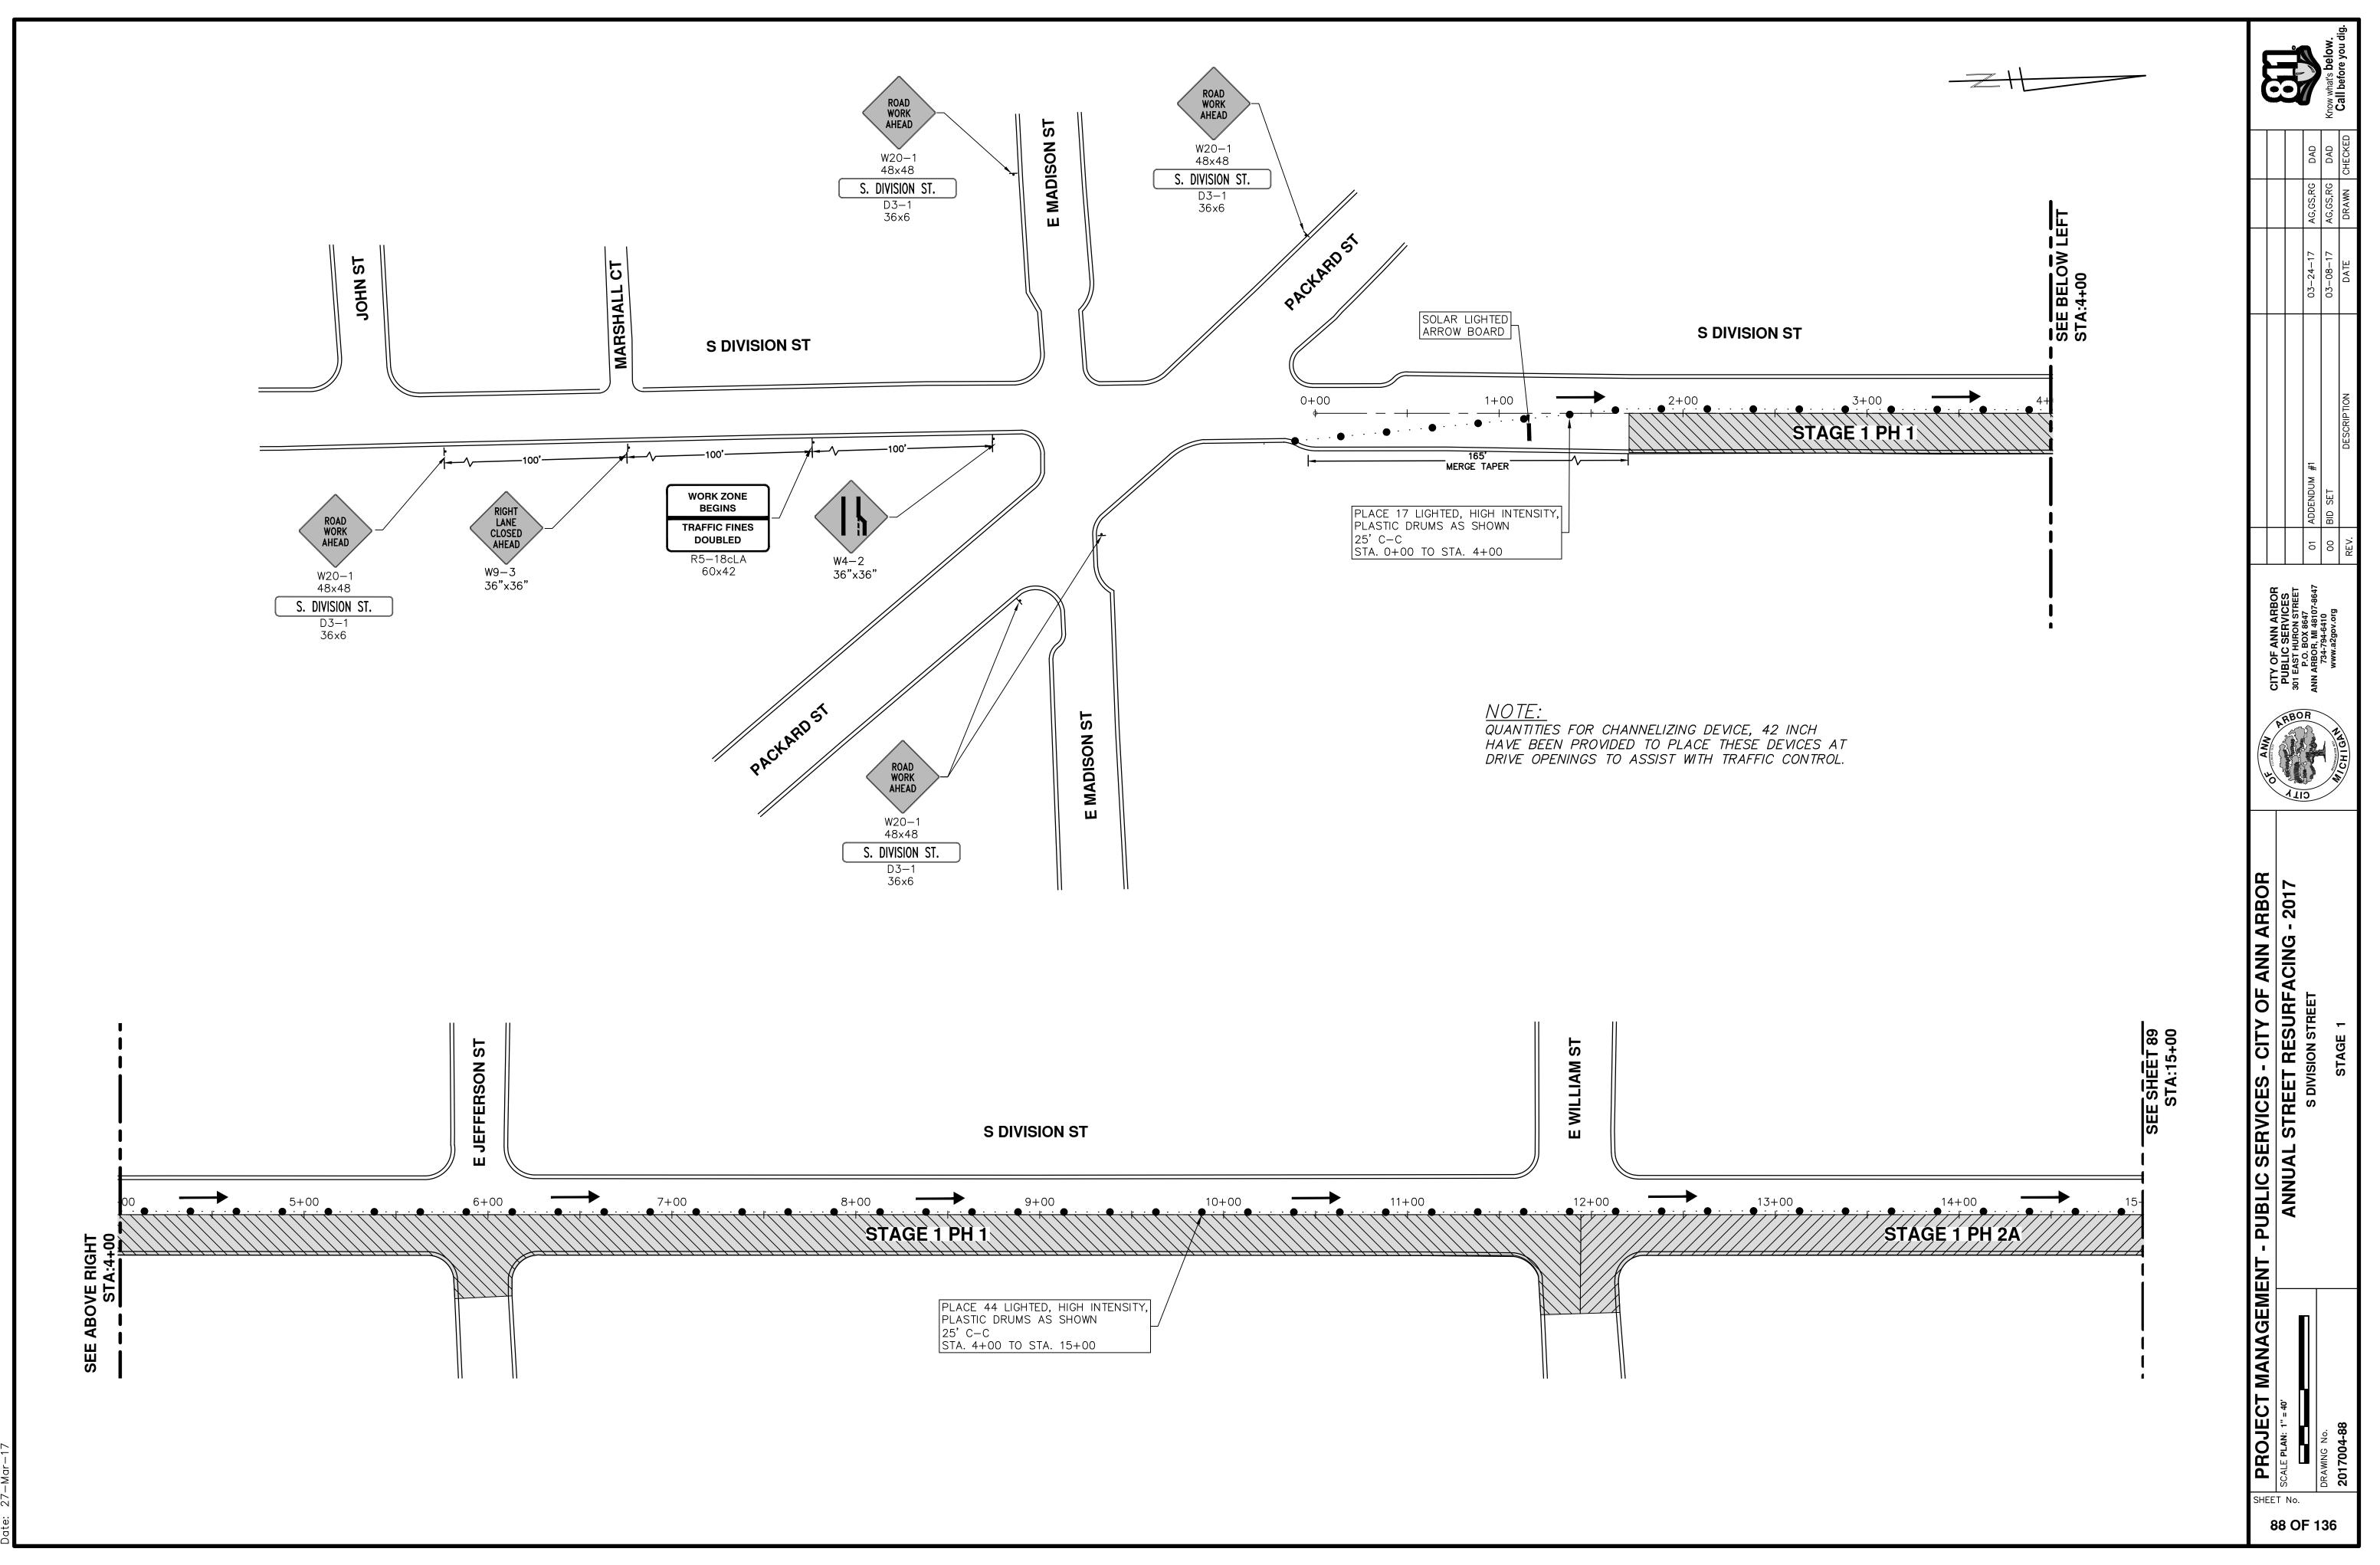



STAGING NOTES:


STAGING NOTES:


STAGE I

- PHASE 1
- 1. INSTALL LEAD IN TRAFFIC CONTROL DEVICES AND SIGNING
- 2. CLOSE DIVISION PART-WIDTH BETWEEN PACKARD AND WILLIAM
- 3. CONTACT FIELD SERVICES TO COORDINATE REMOVAL OF THE TRAFFIC DETECTION PUCKS IN ALL OF THE INTERSECTIONS
- 4. CONSTRUCT WATER MAIN AND BUMPOUT AT THE SOUTHEAST QUADRANT OF JEFFERSON/DIVISION AND COMPLETE CURB REPAIRS WITHIN THIS PHASE.
- 5. UPON PASSING WATER MAIN TESTS, CONSTRUCT WATER SERVICE LEADS PART WIDTH AND RESTORE TRENCHES.
- BEGIN CONSTRUCTION OF BUMPOUT AT THE NORTHEAST QUADRANT OF JEFFERSON/DIVISION.
- PHASE 2
- 1. IMPLEMENT LANE CLOSURES AND DETOURS FOR WILLIAMS, LIBERTY AND WASHINGTON AND EXTEND PART-WIDTH CLOSURE OF DIVISION TO EAST HURON
- 2. CONSTRUCT BUMPOUTS AND COMPLETE CURB REPAIRS.
- PLACE HAND PATCHING, HMA LVSP TO RESTORE PEDESTRIAN AND VEHICLE TRAFFIC PRIOR TO SHIFTING TRAFFIC ON INTERSECTING SIDESTREETS.
- MAINTAIN LANE CLOSURES ON SIDESTREETS THRU THE REMAINDER OF THE PROJECT.
- PHASE 3
 - 1. LOWER STRUCTURES IF NOT COMPLETED DURING PREVIOUS PHASE
 - 2. PLACE SIGNS AND TRAFFIC CONTROL DEVICES TO CLOSE SOUTH LANE OF EAST HURON
 - 3. MILL HMA FROM POB TO EAST HURON (POE)
- 4. COMPLETE ANY DETAIL 7 AND 8 JOINT REPAIRS NECESSARY
- 5. PLACE HMA LEVELING FROM POB TO POE
- 6. RAISE ALL STRUCTURES
- 7. INSTALL GEOSYNTHETIC PAVING LAYER FROM POB TO POE
- 8. PLACE HMA TOP COURSE FROM POB TO POE
- 9. REMOVE LANE CLOSURE FROM EAST HURON
- *10. INSTALL TEMPORARY STOP BARS*

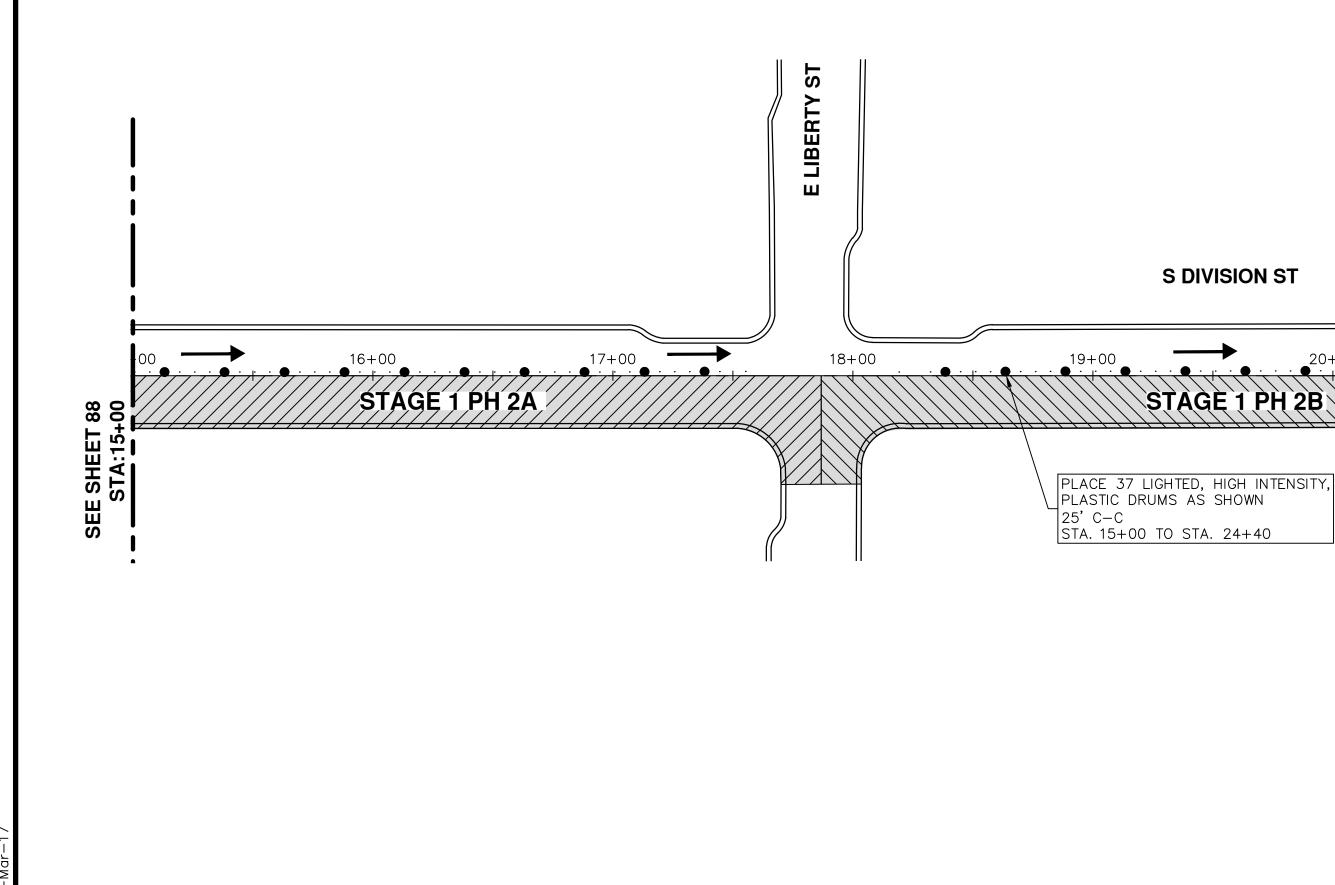

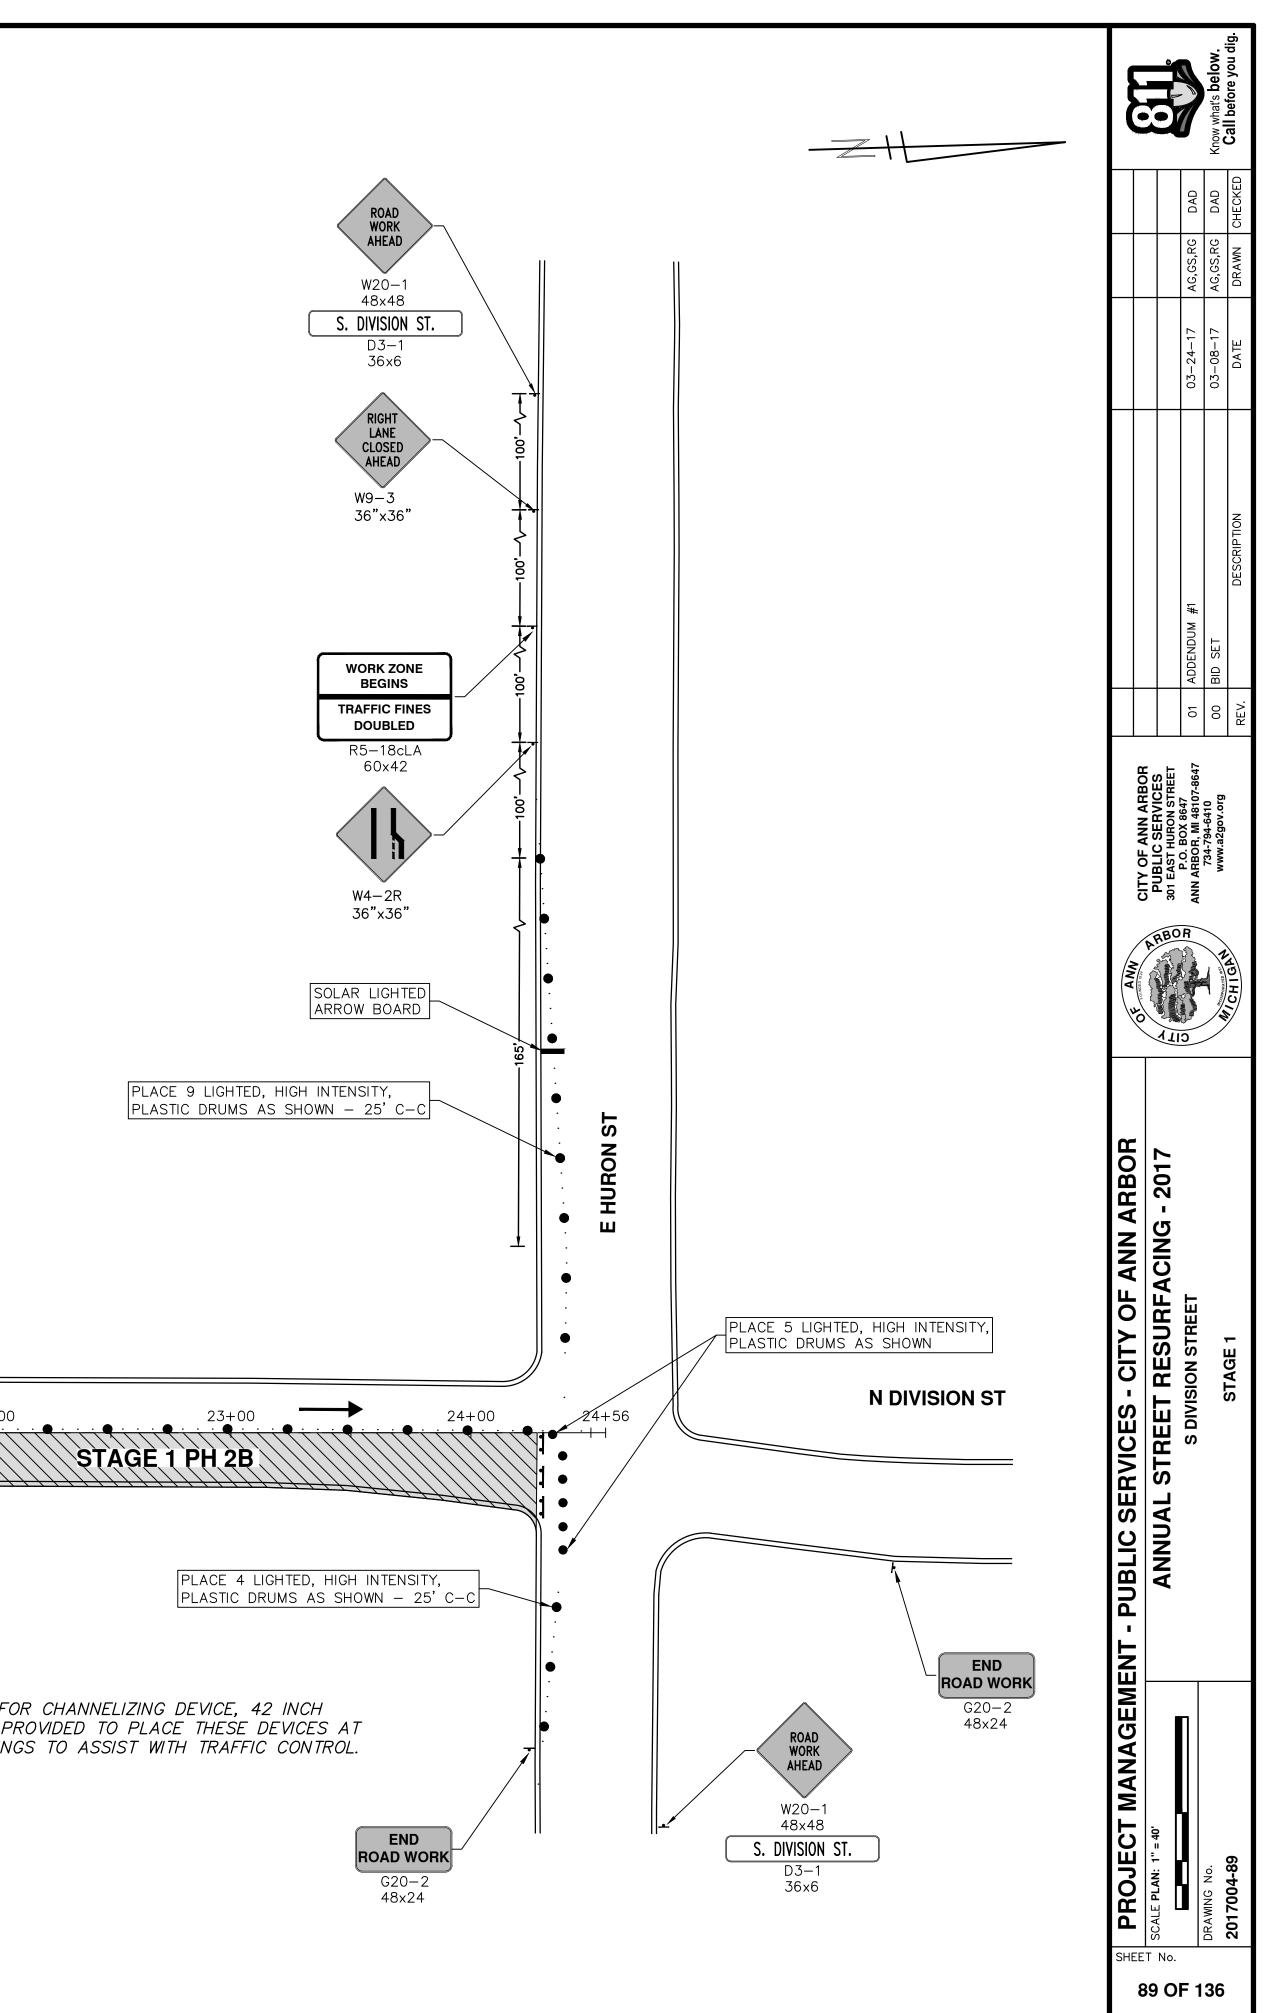


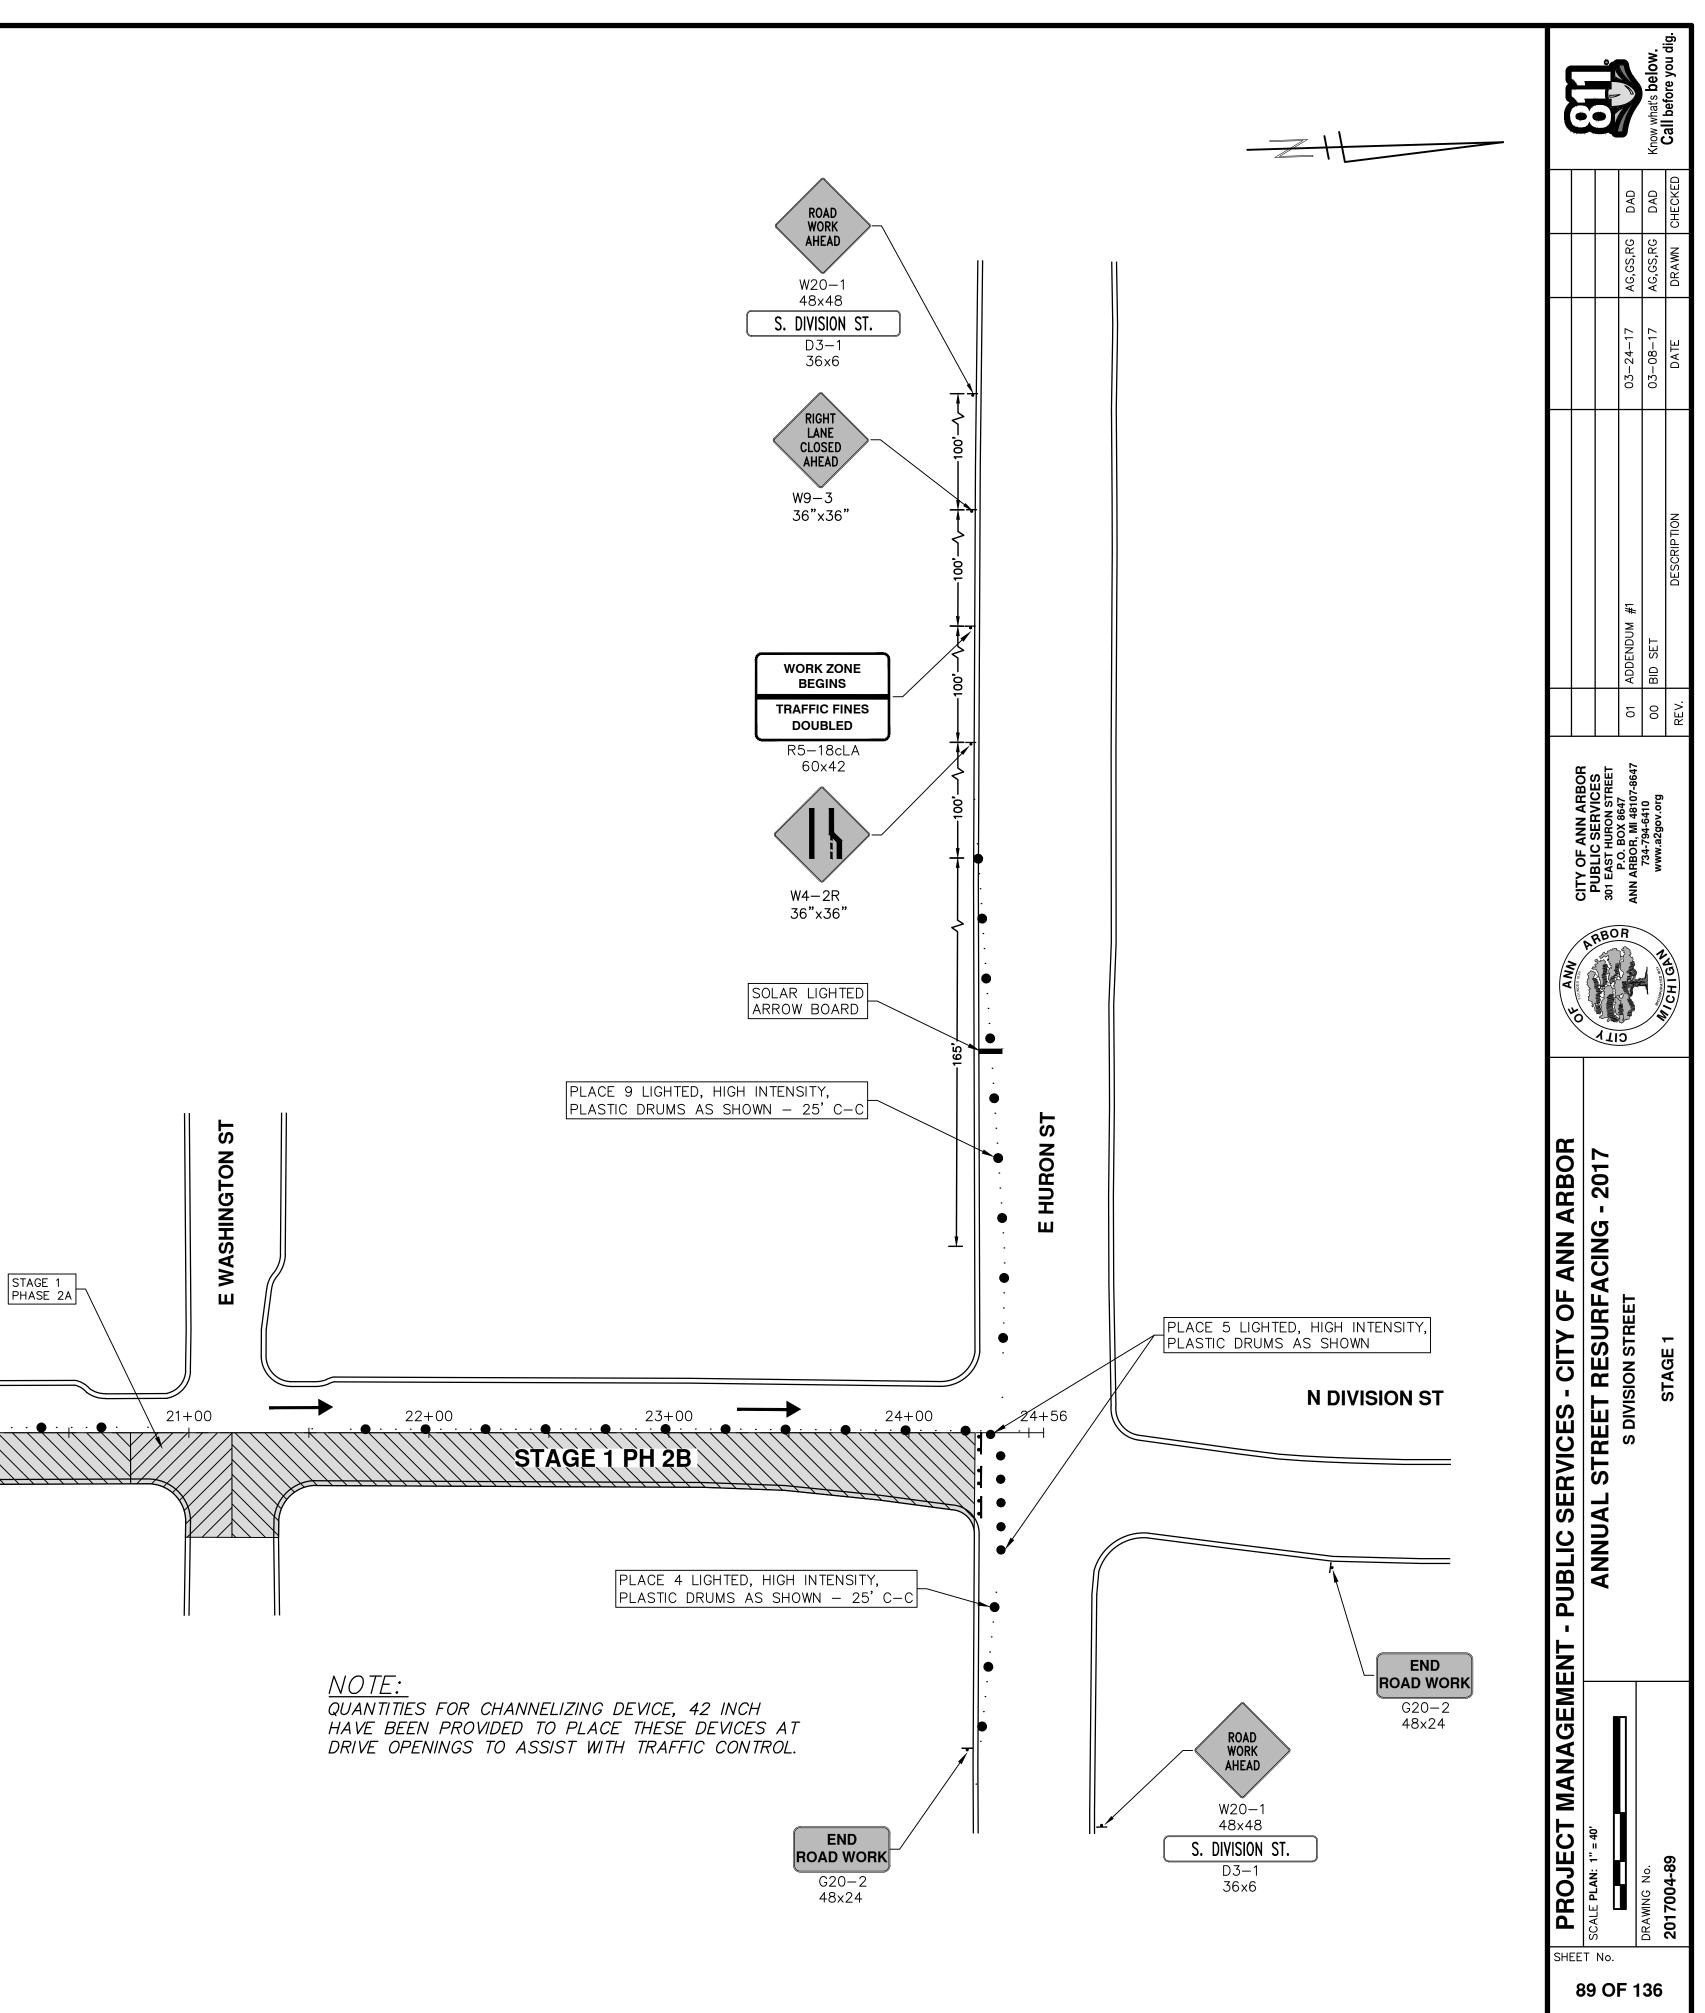


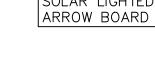


S DIVISION ST


STAGE 1 PH 28

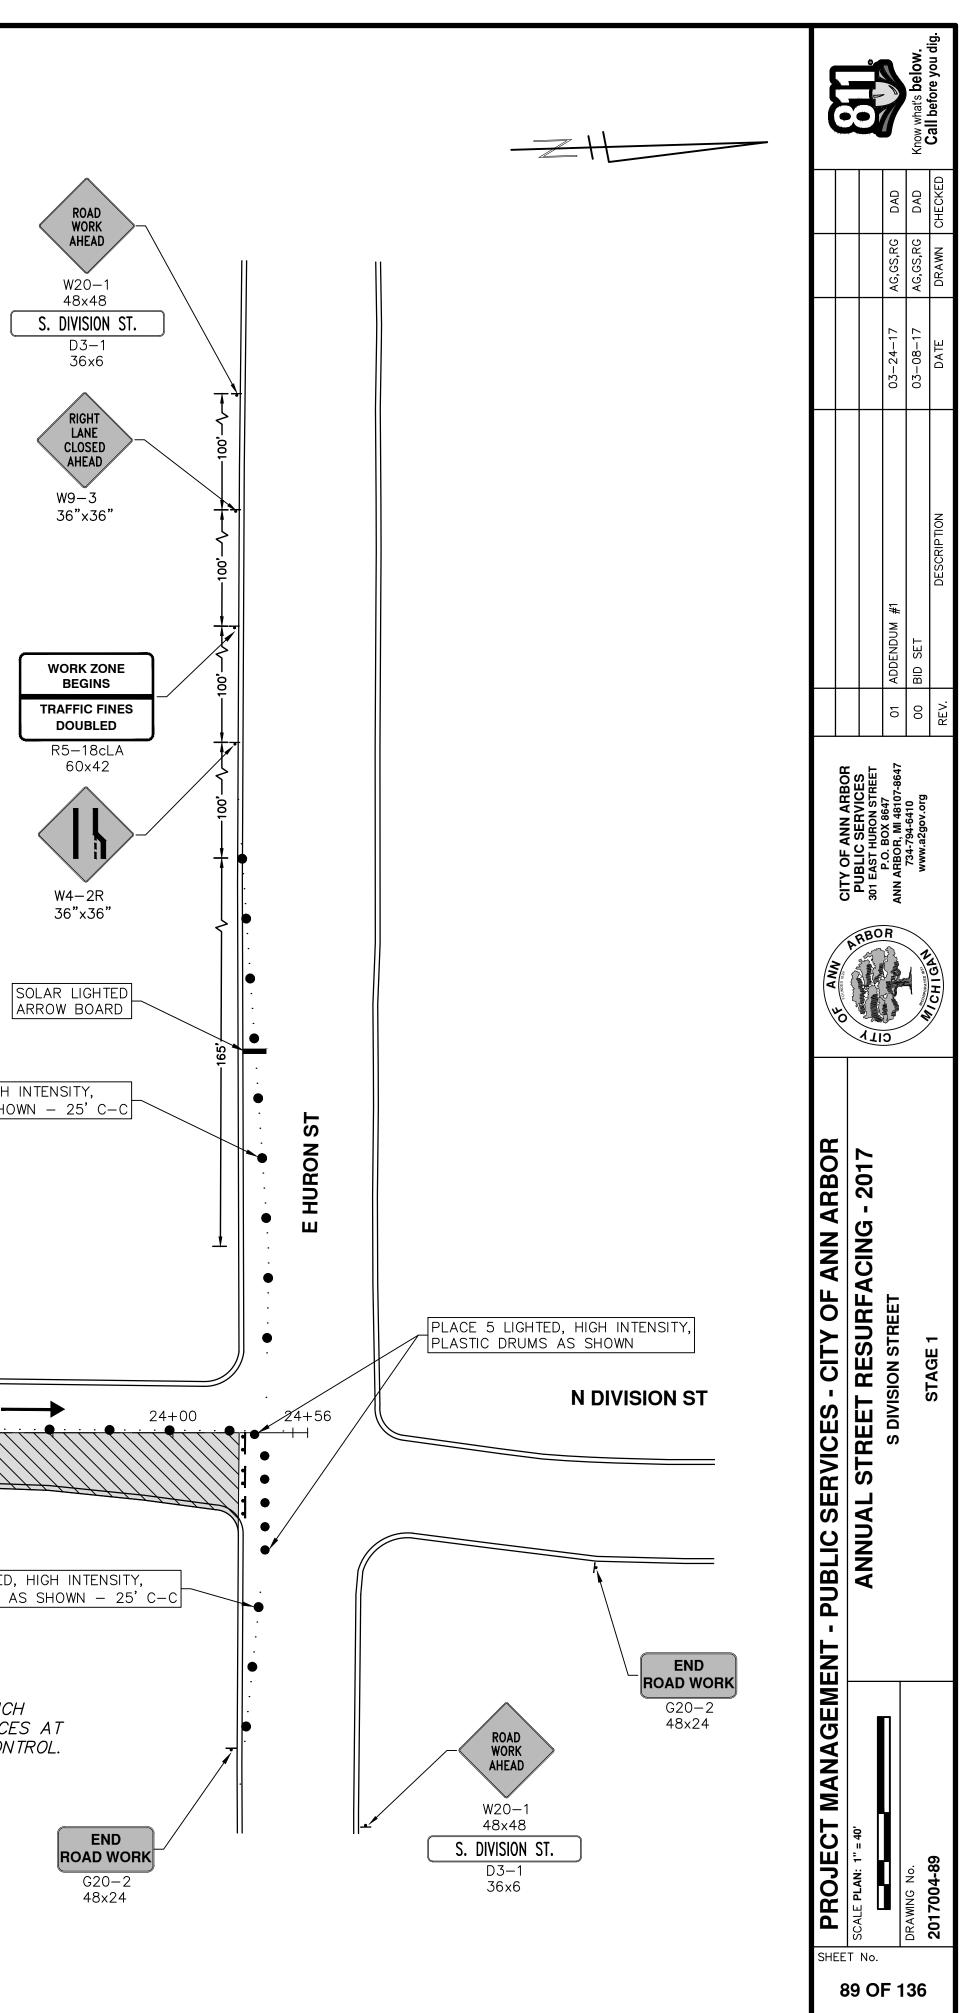


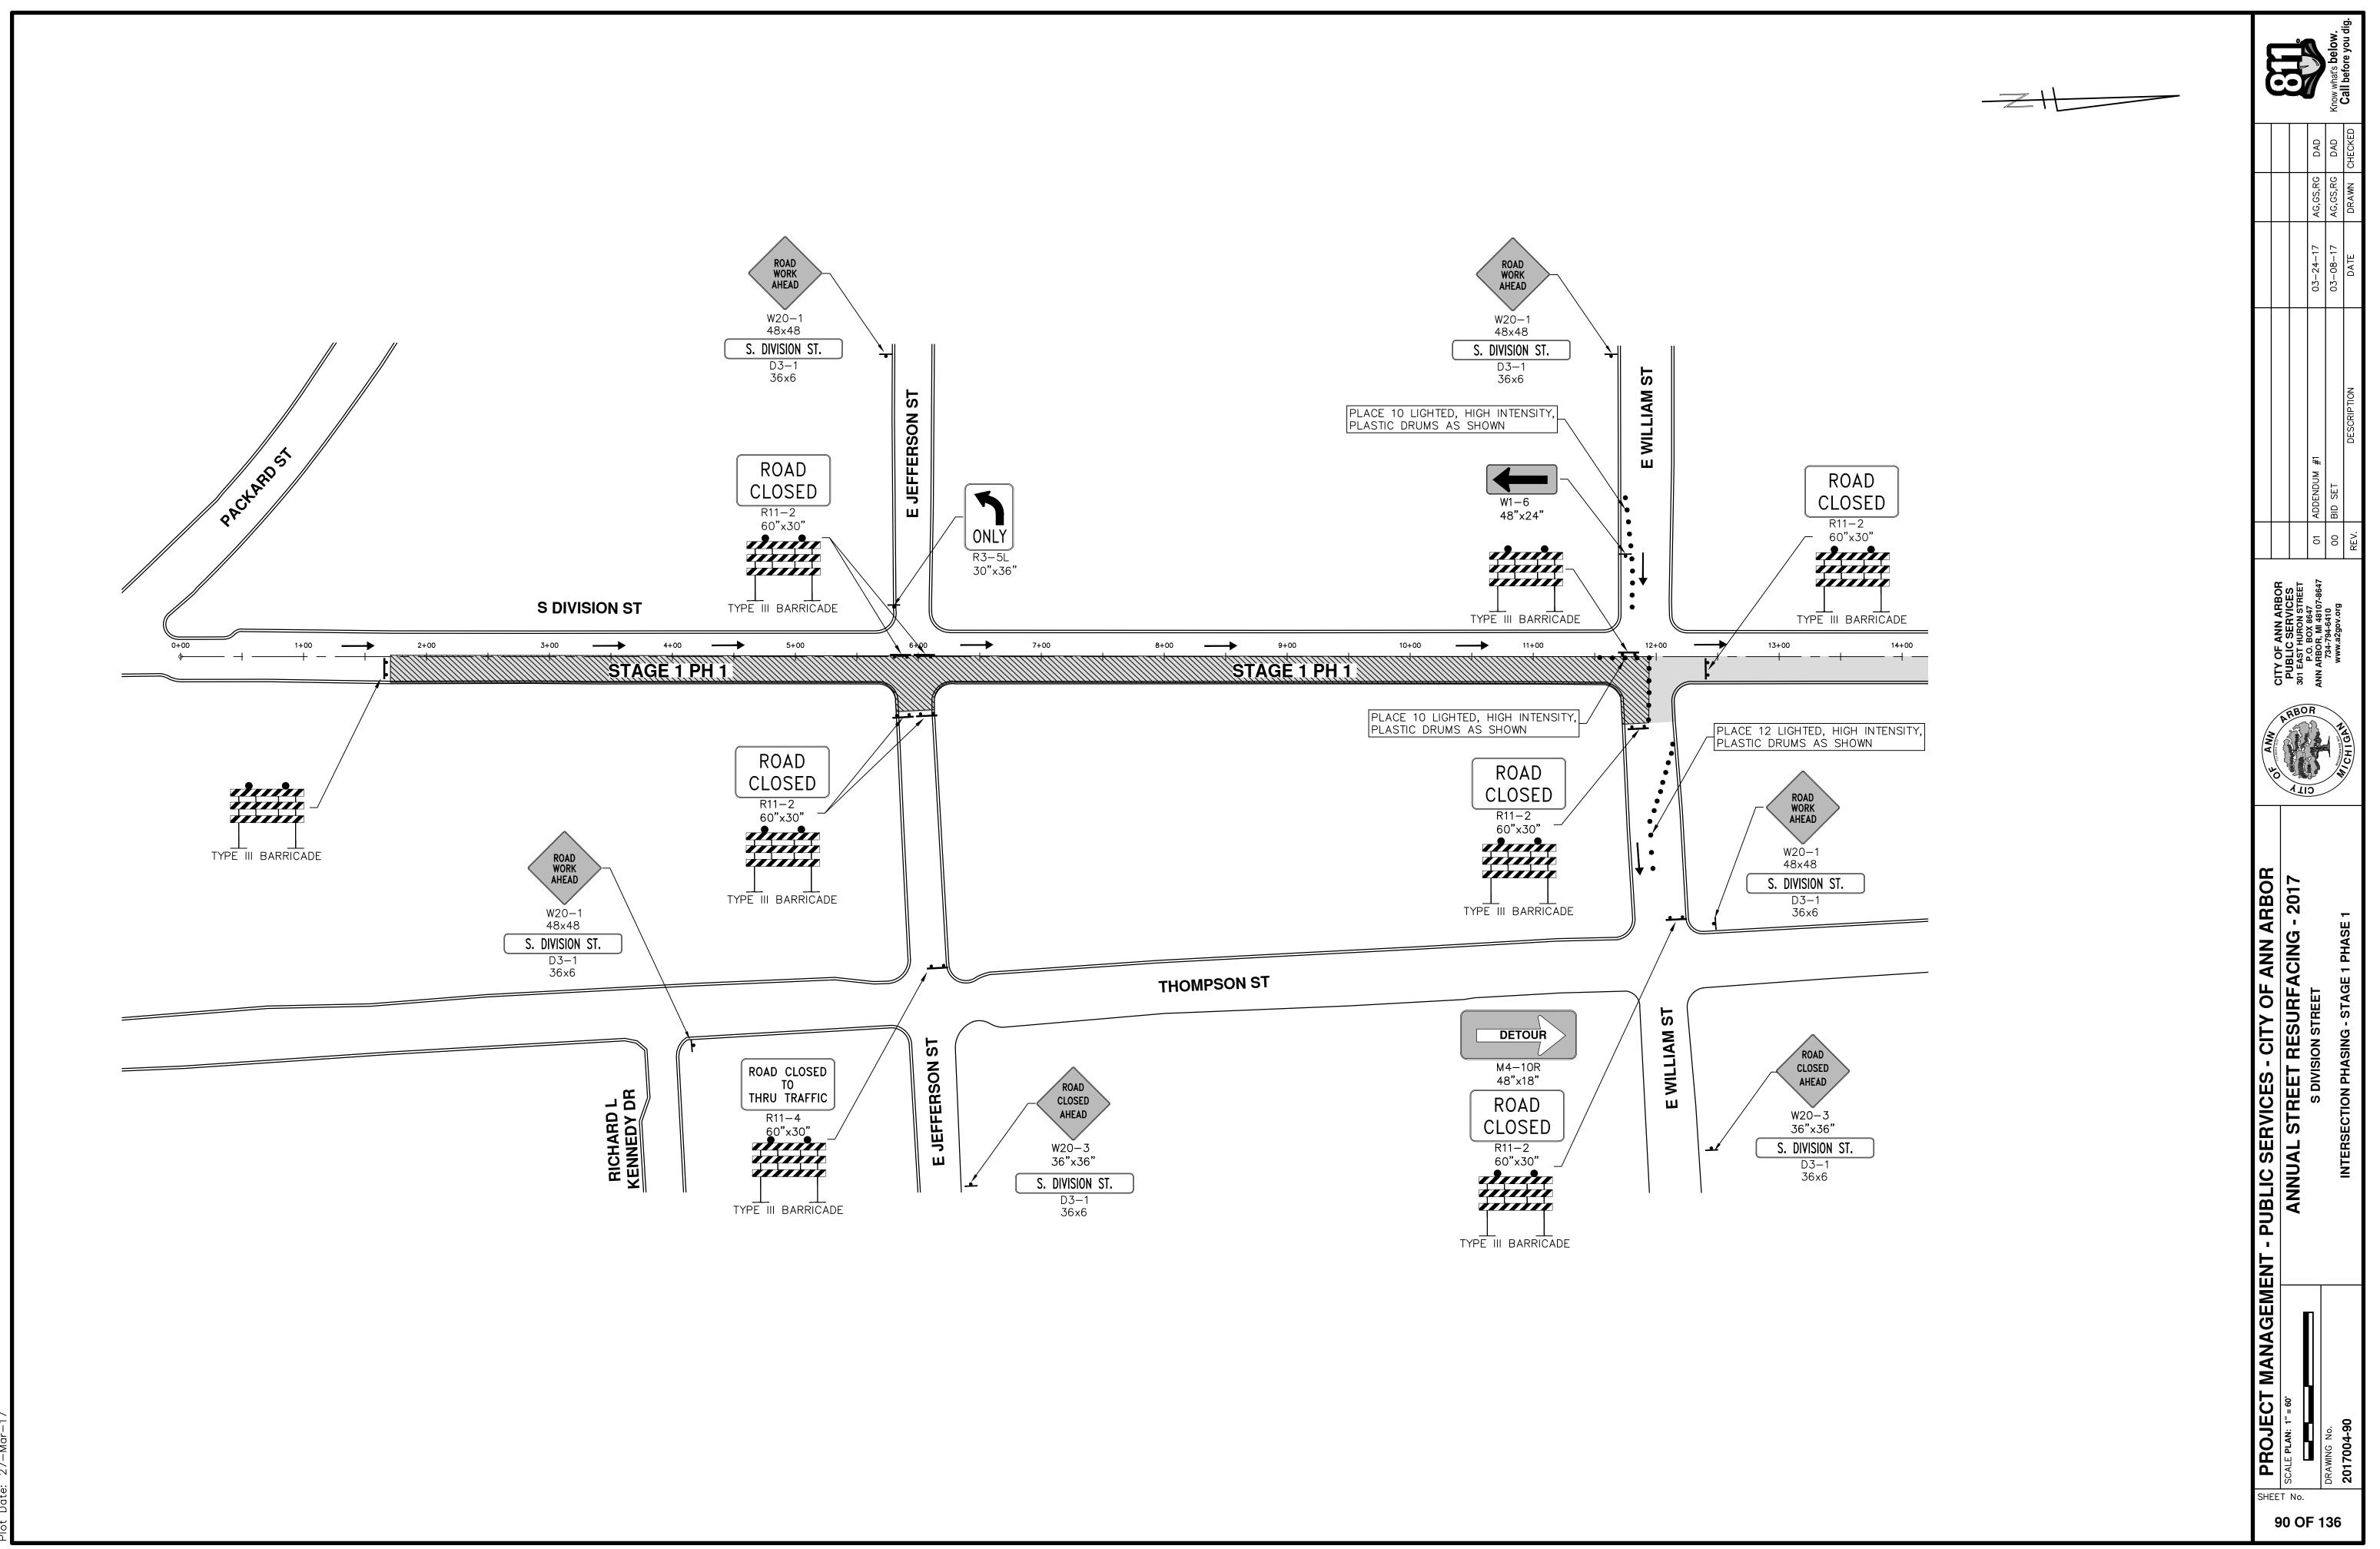


roject' ا~ر i

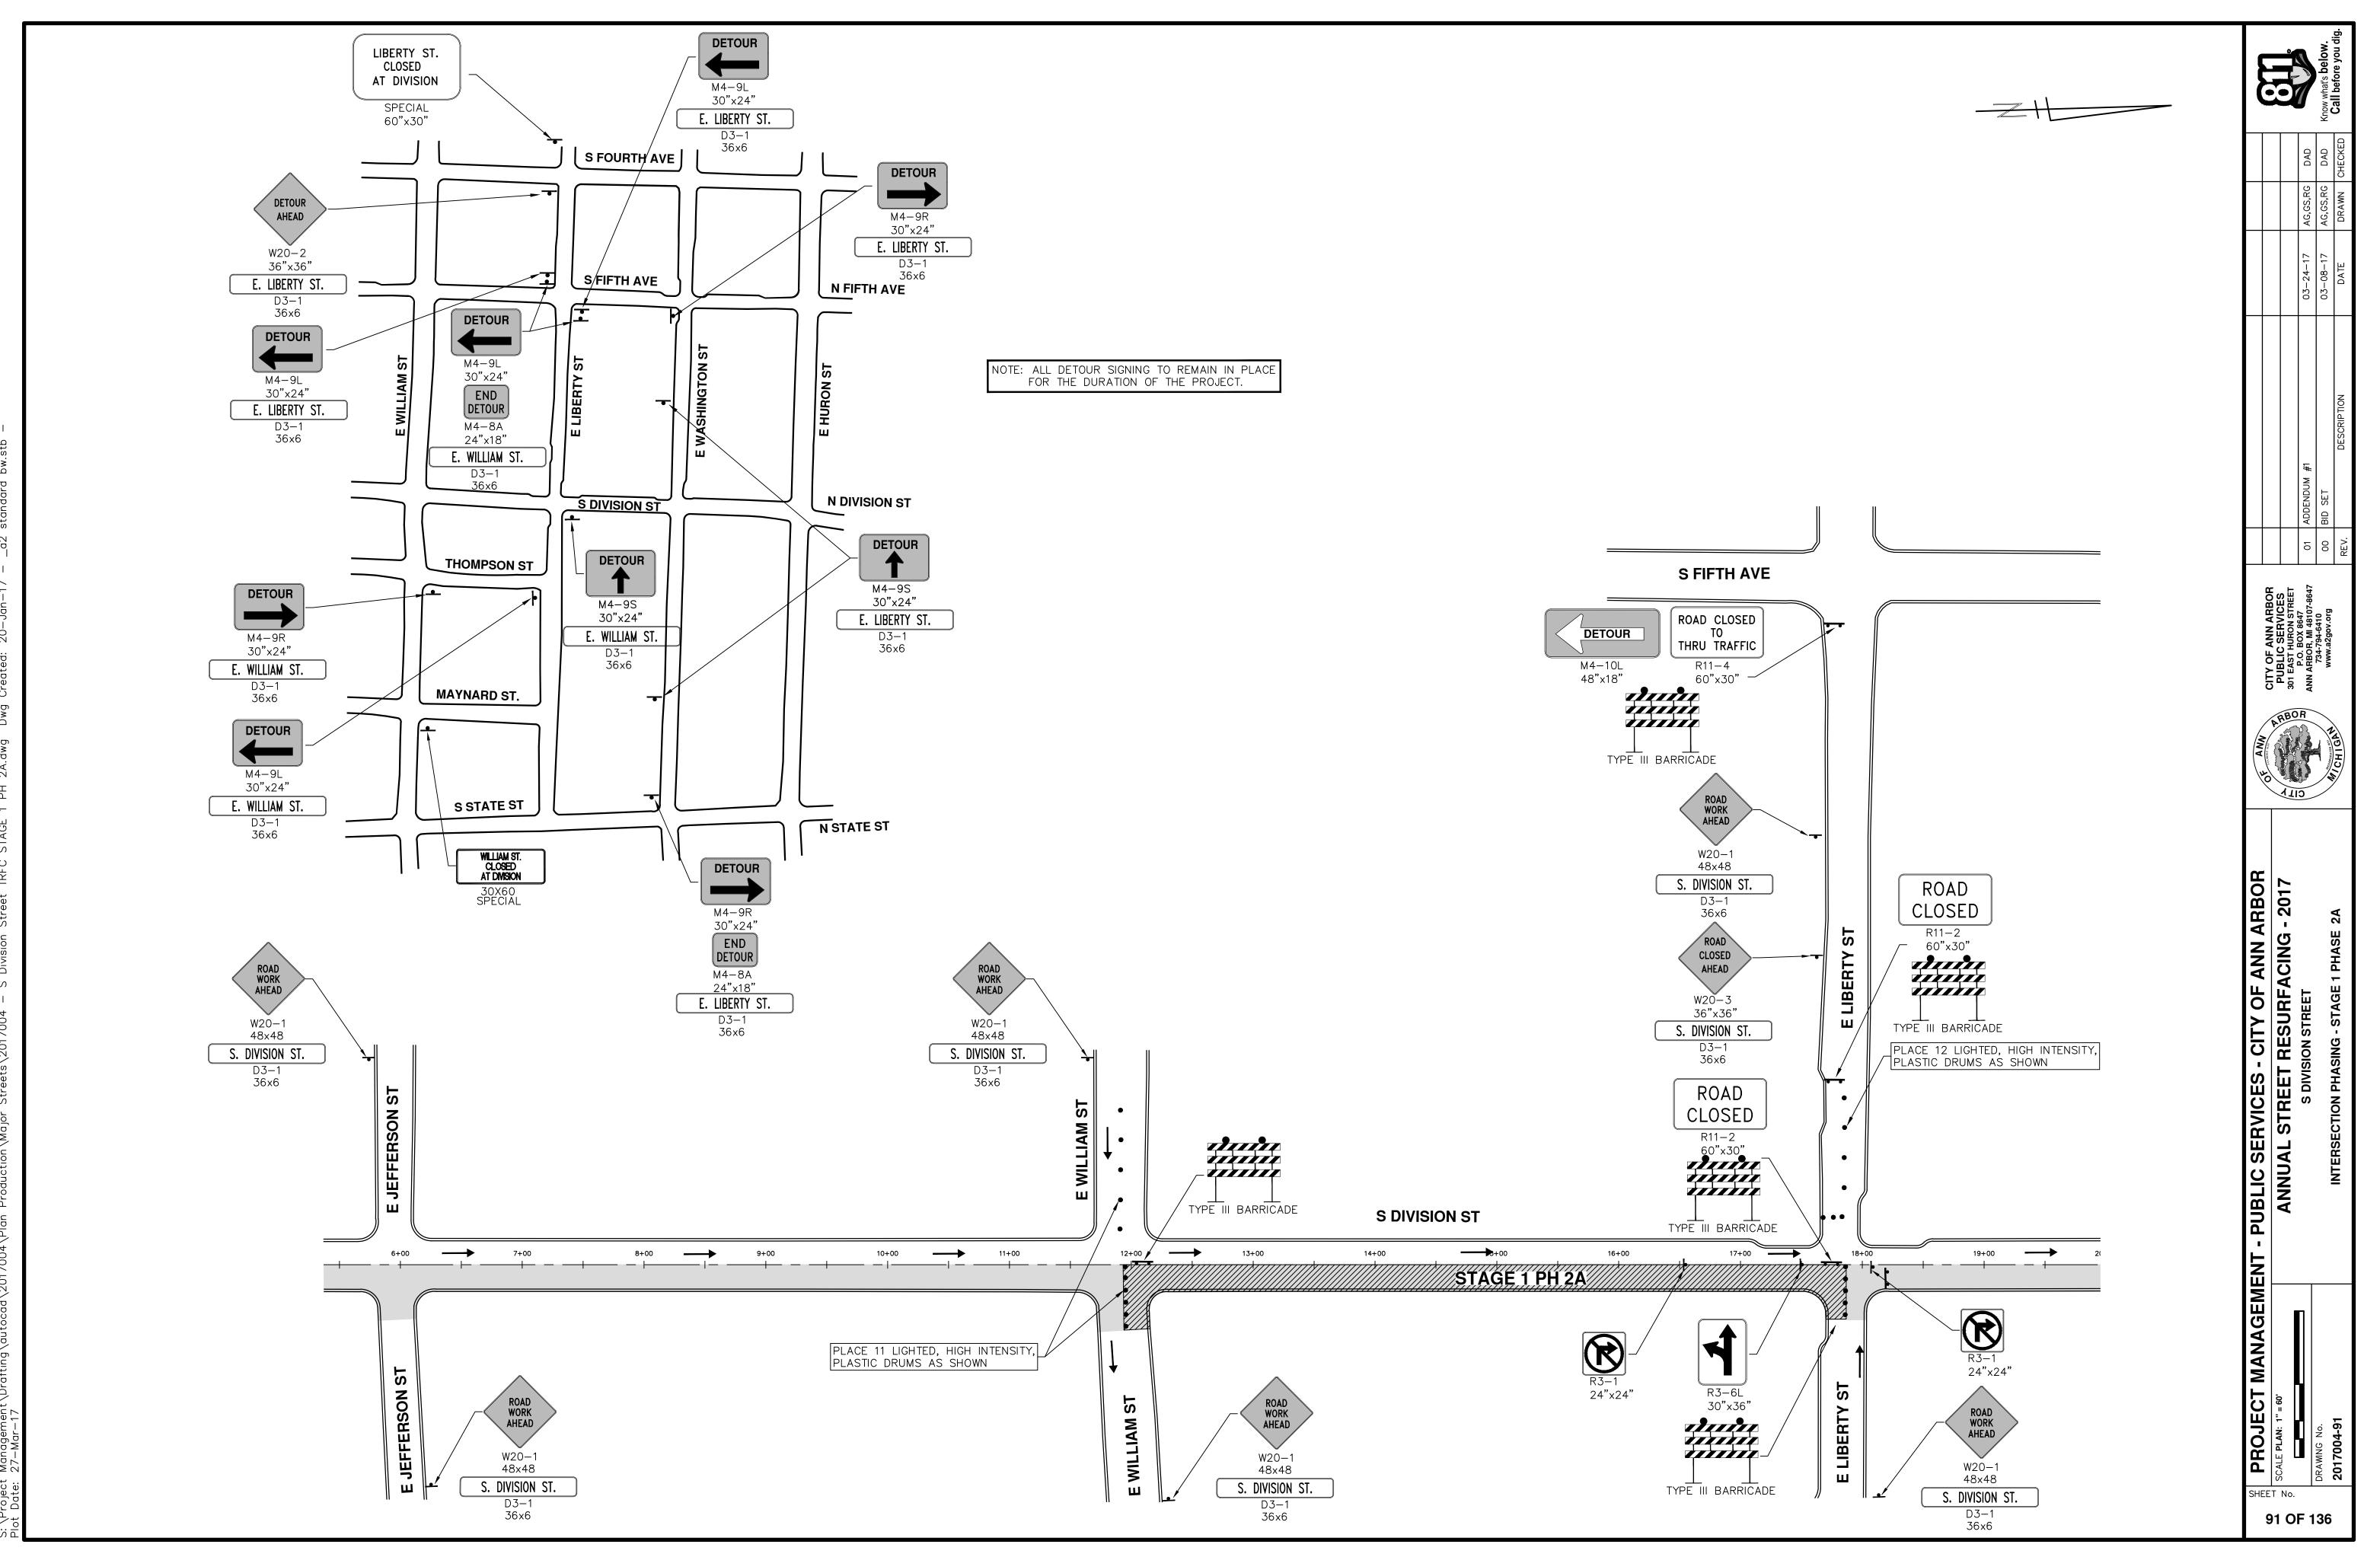

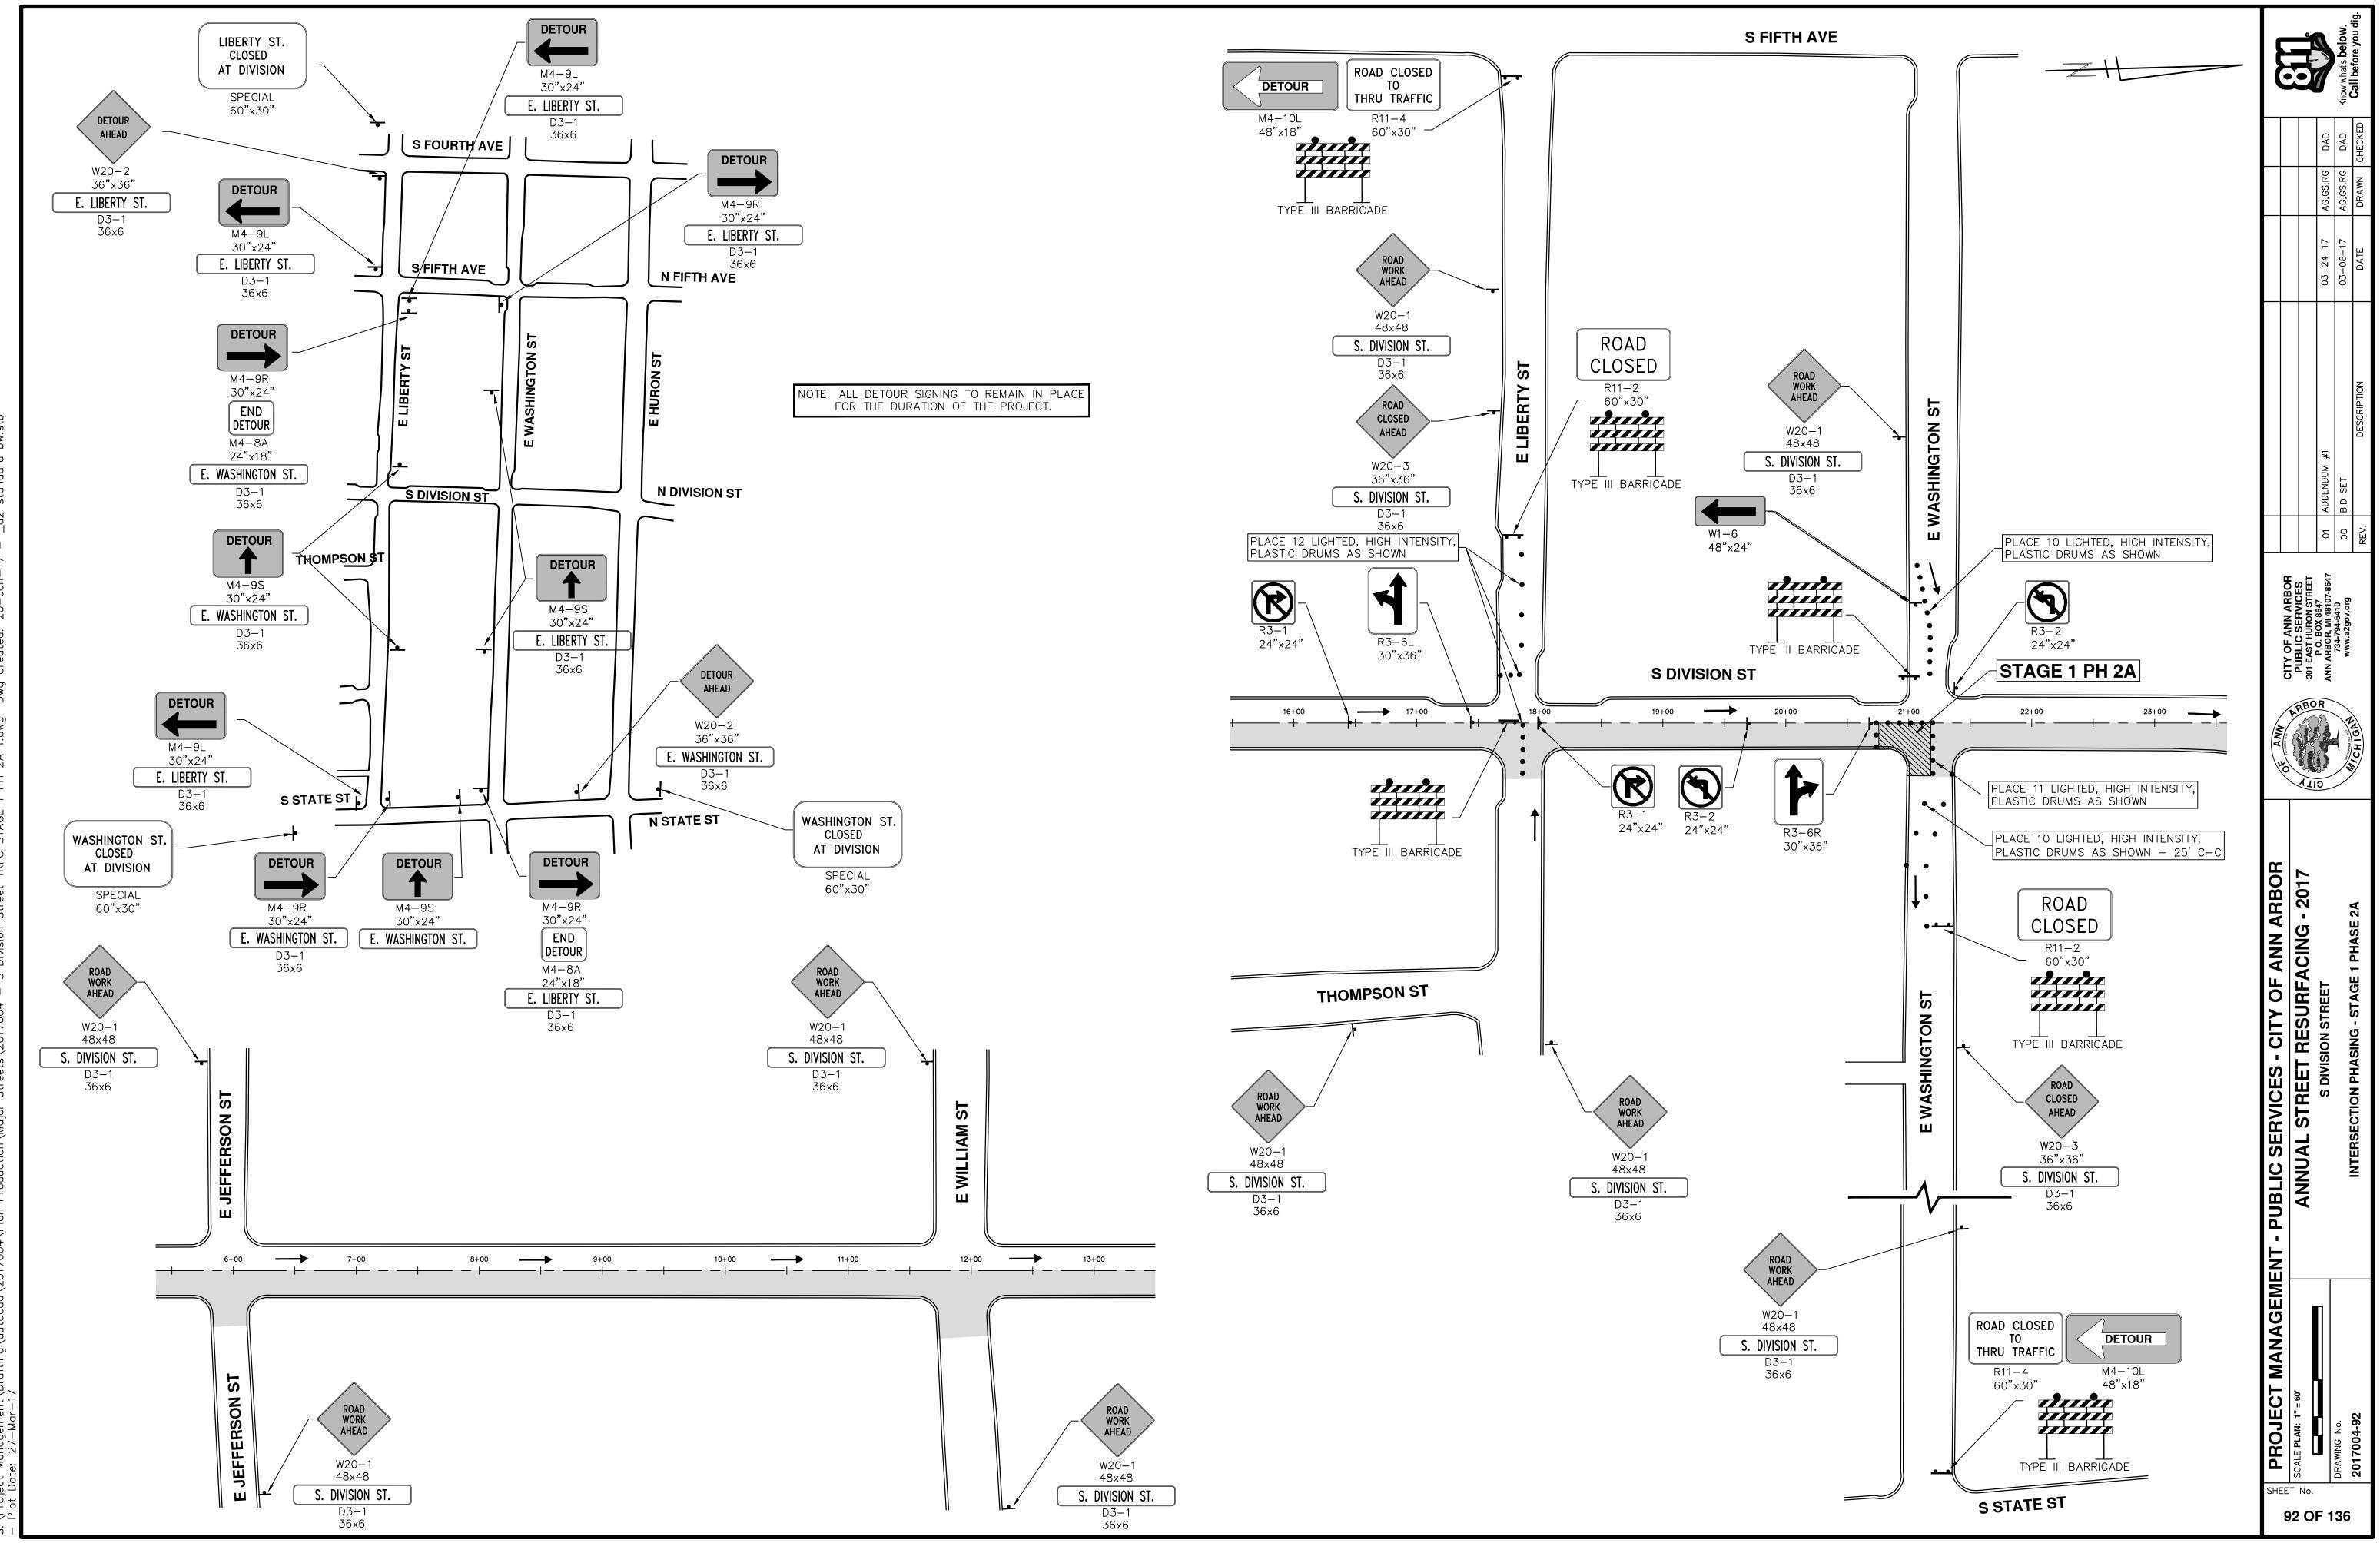


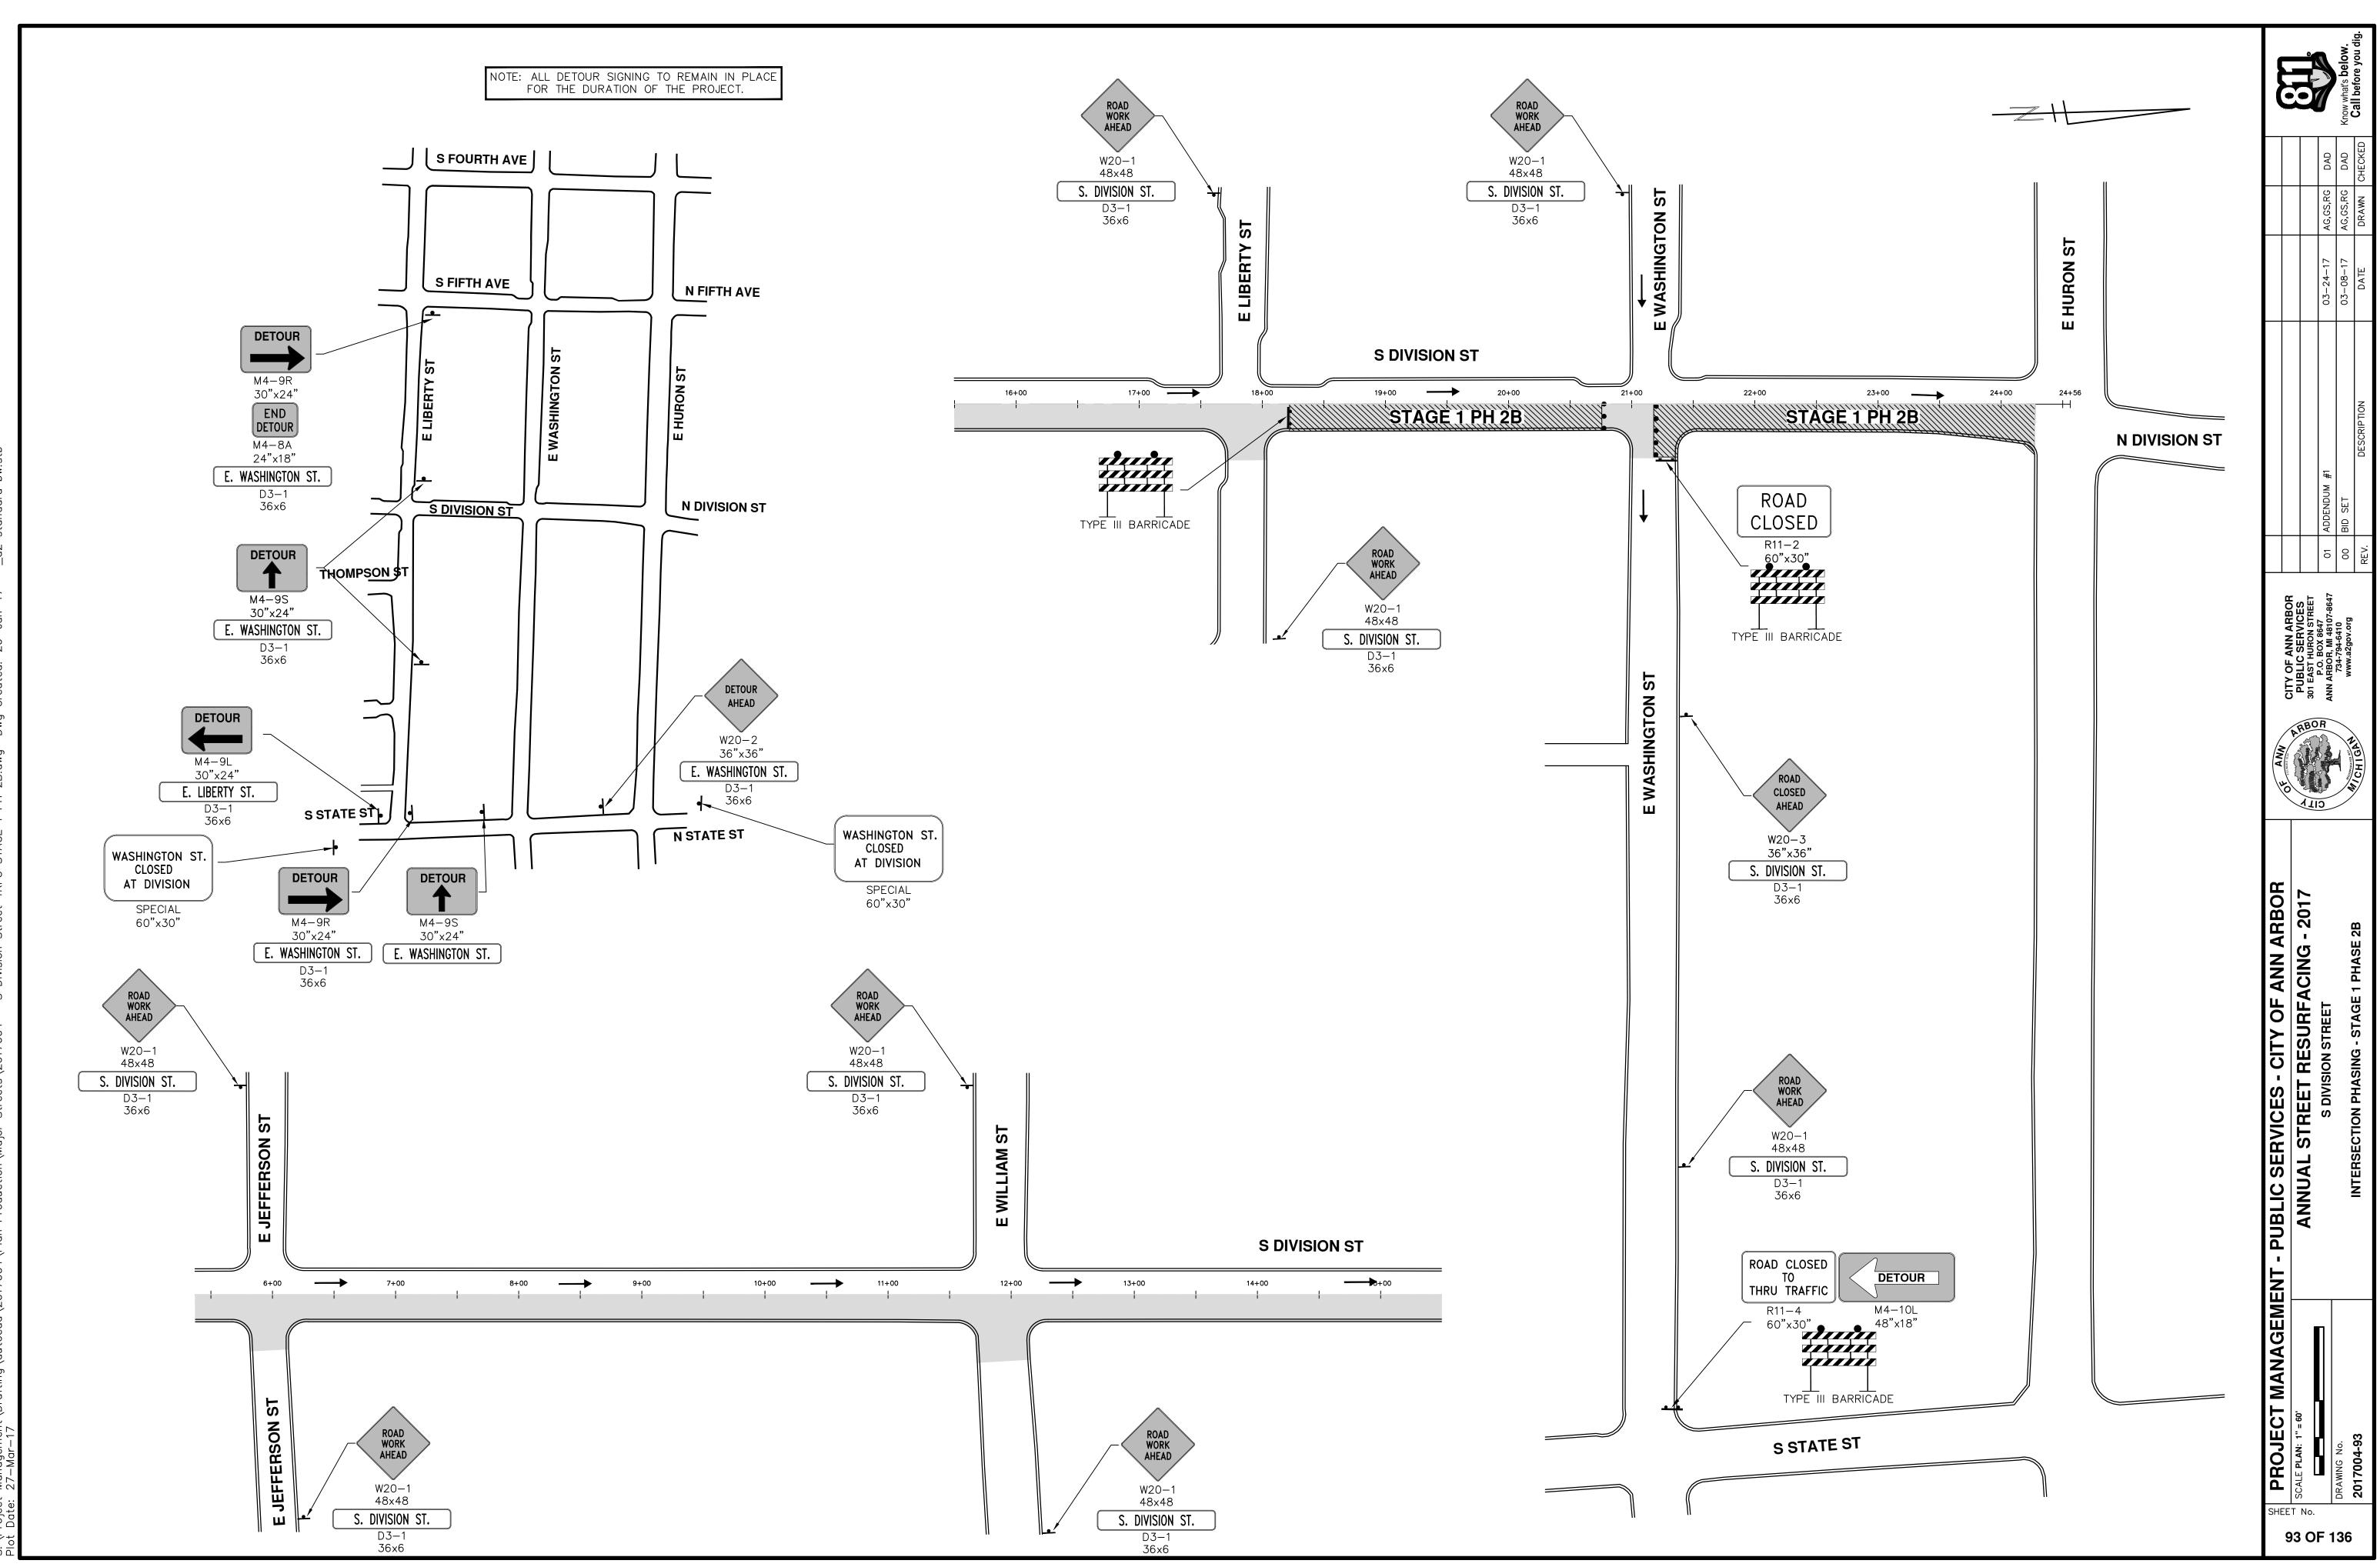


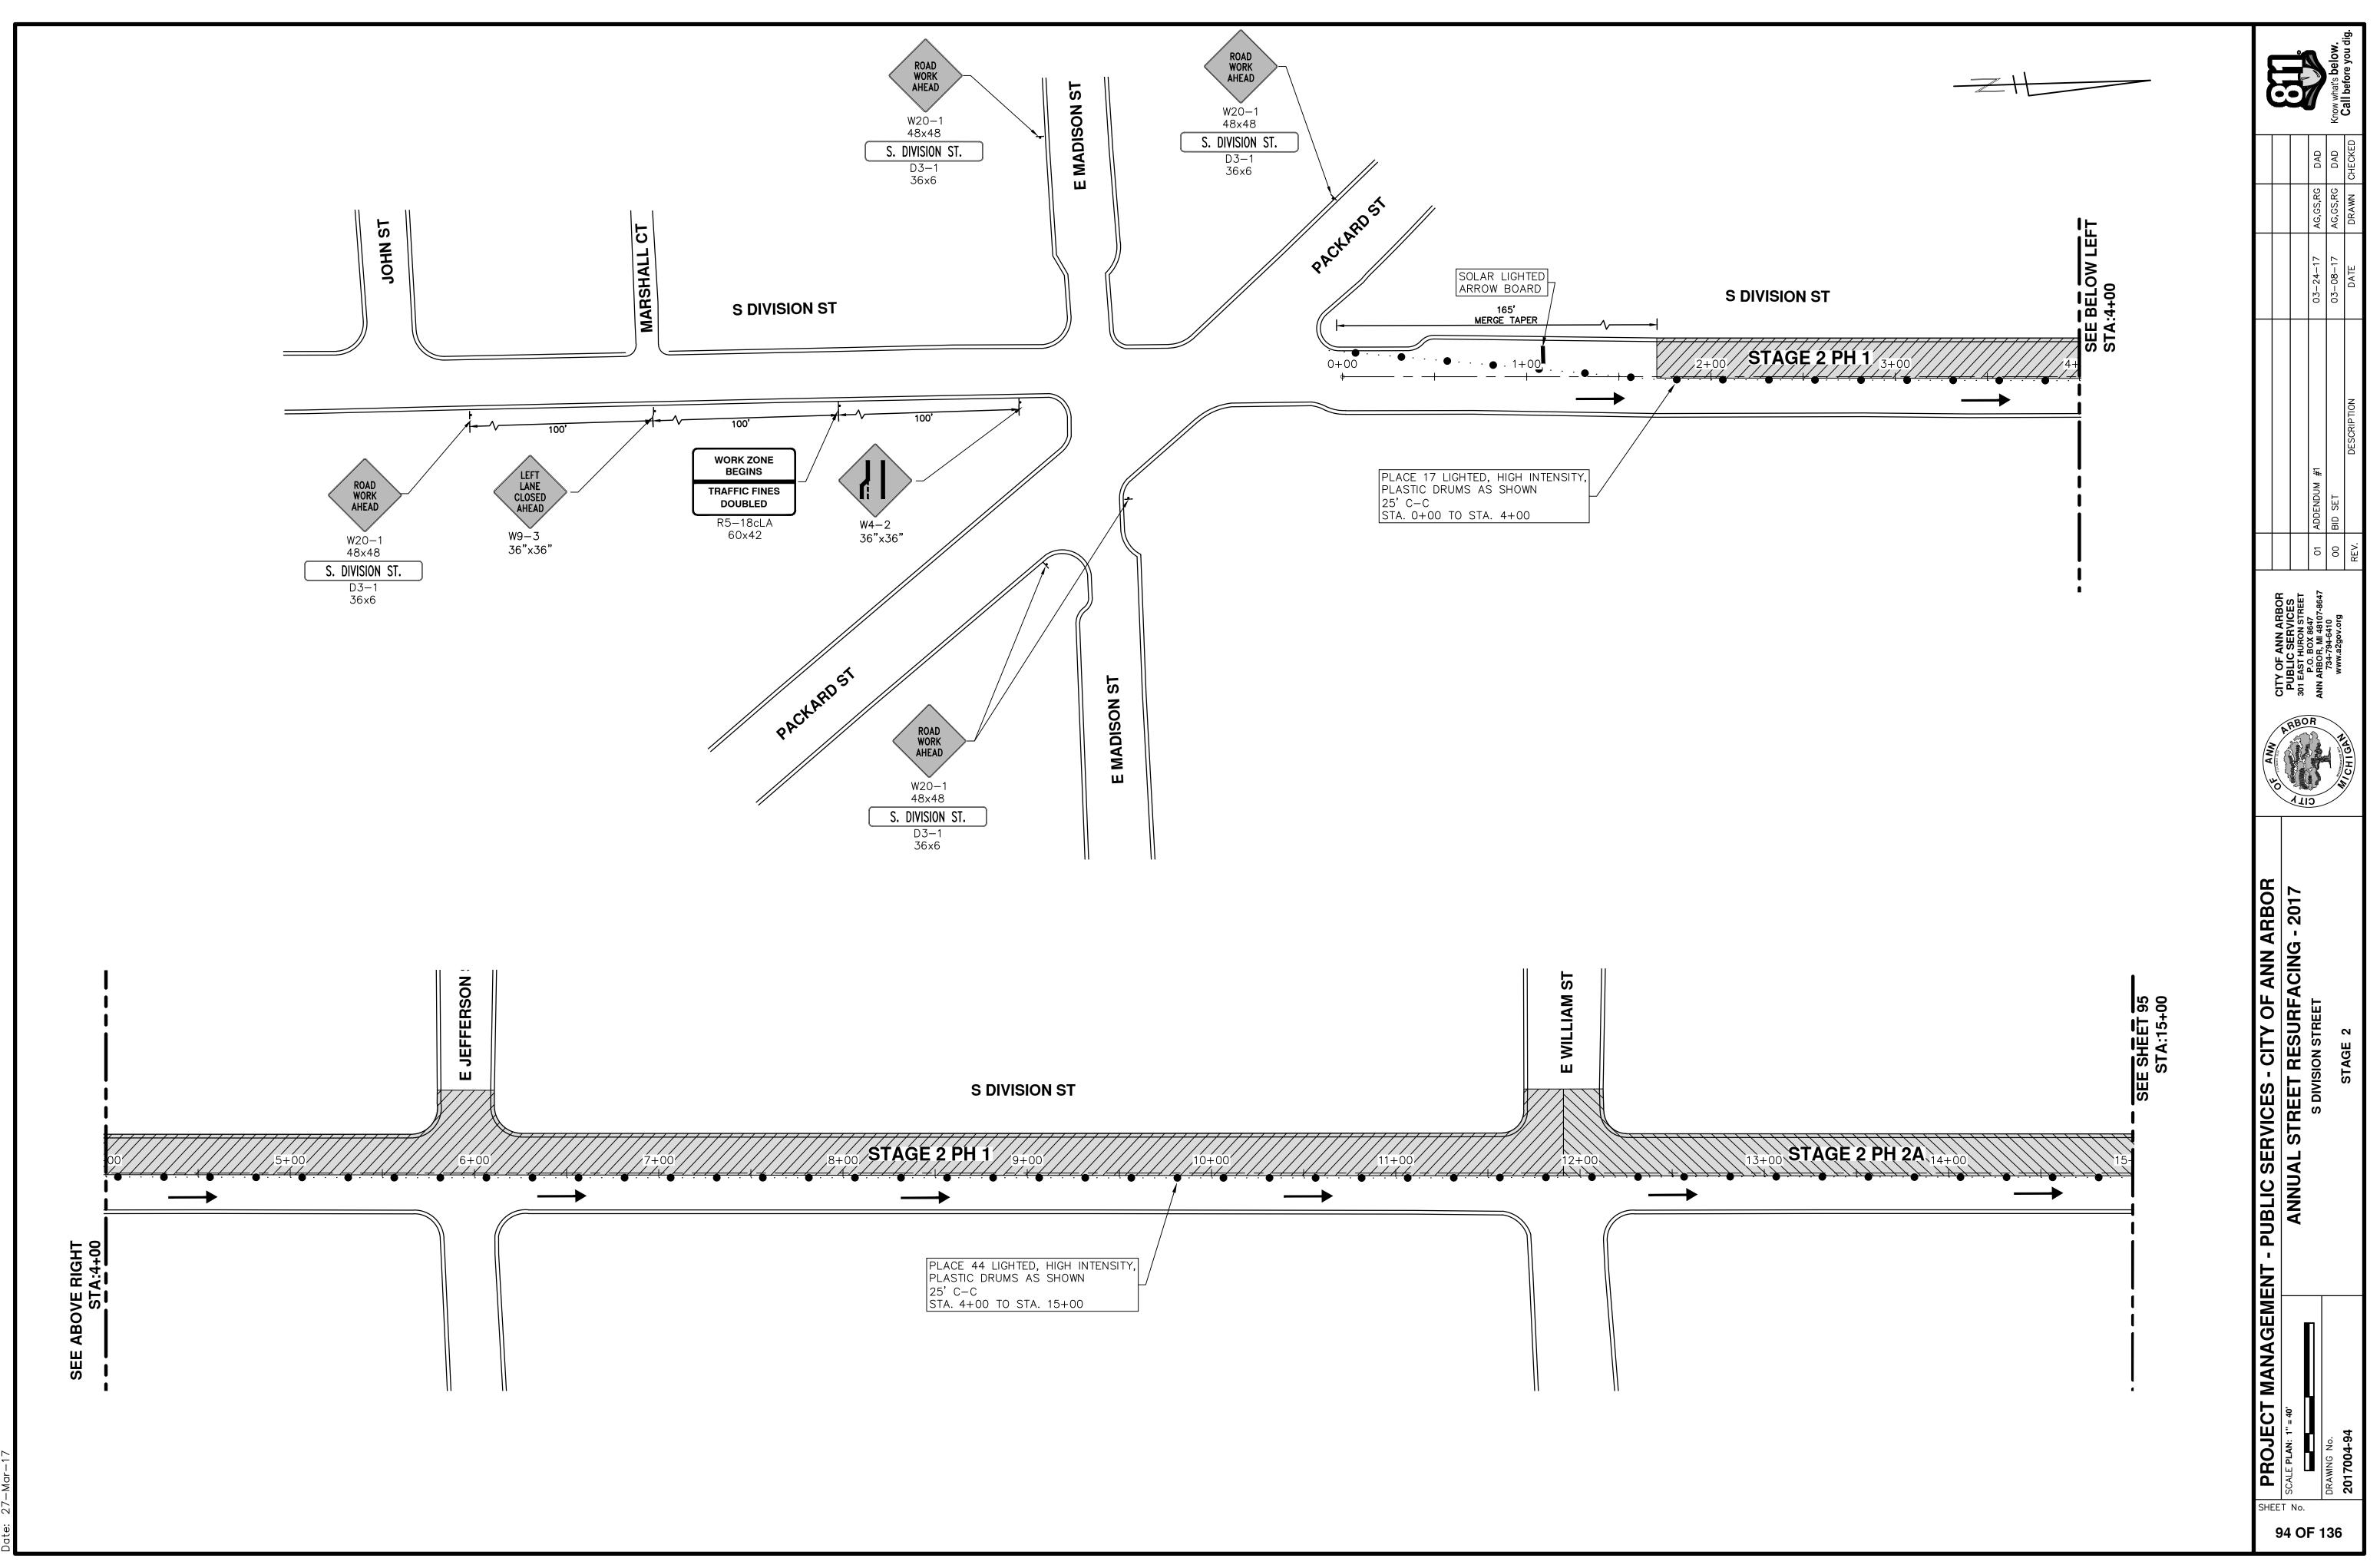



- QUADRANT OF WILLIAM/DIVISION
 - SIDESTREETS.


- - SIDESTREETS.

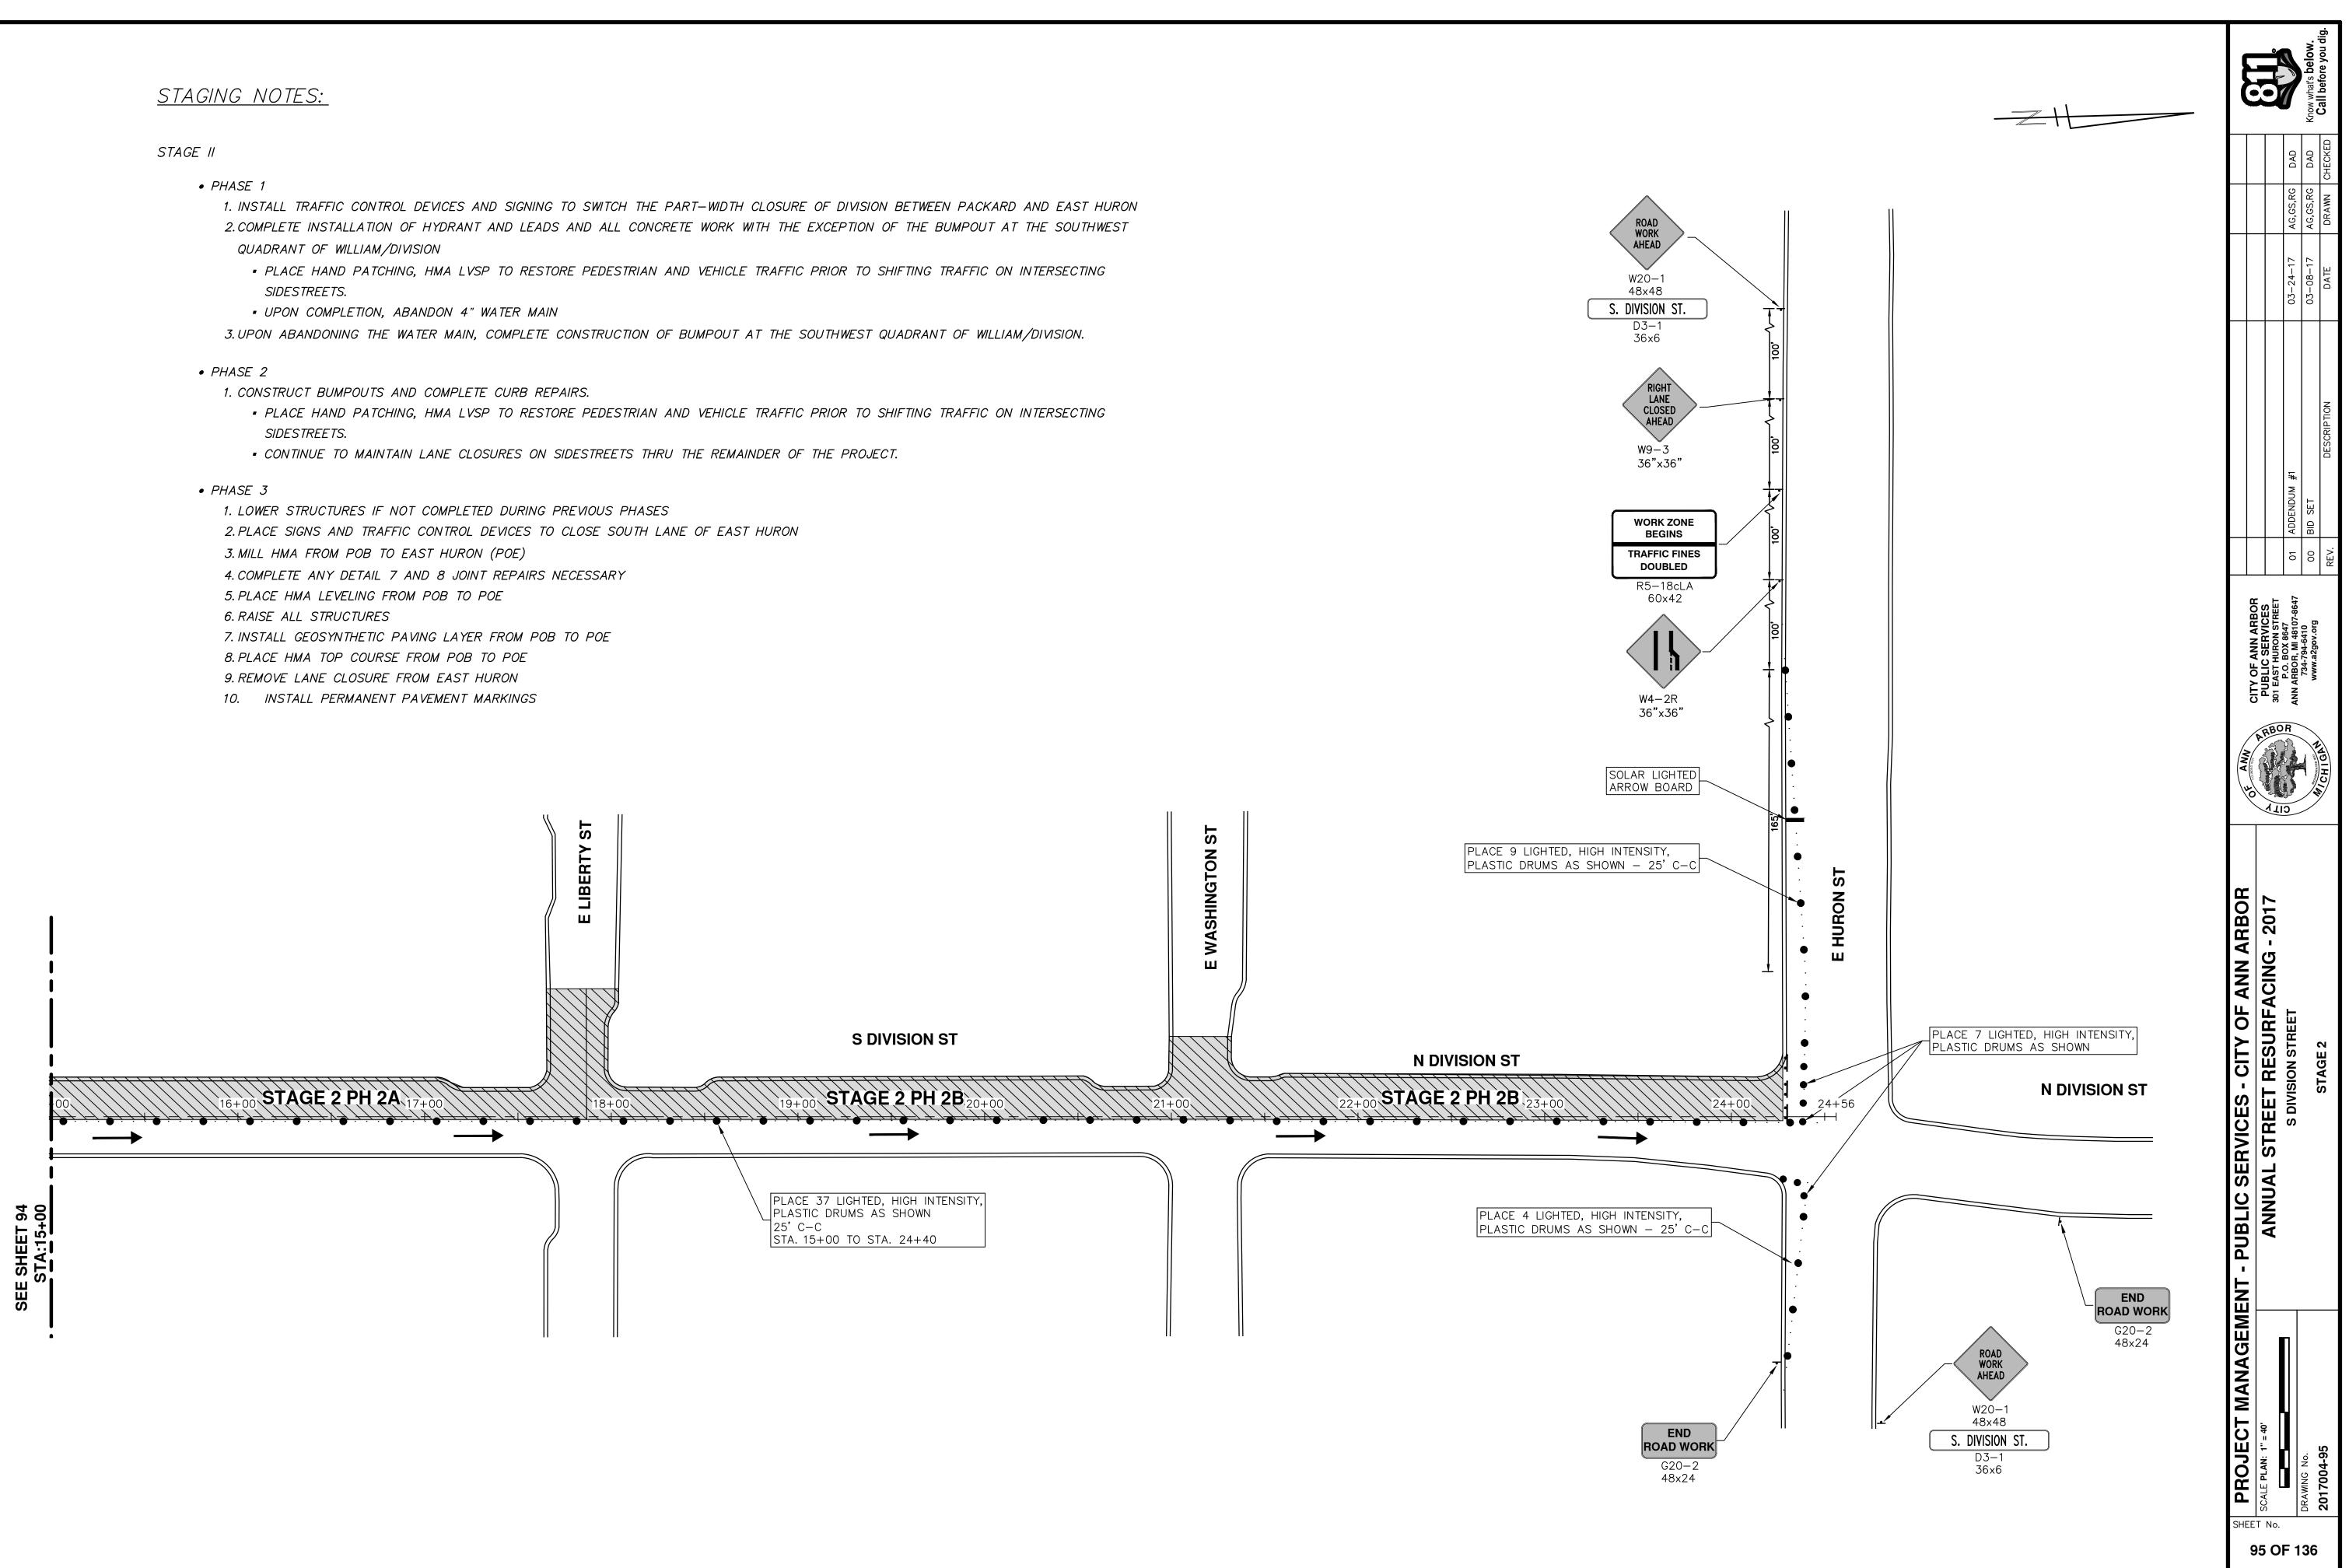


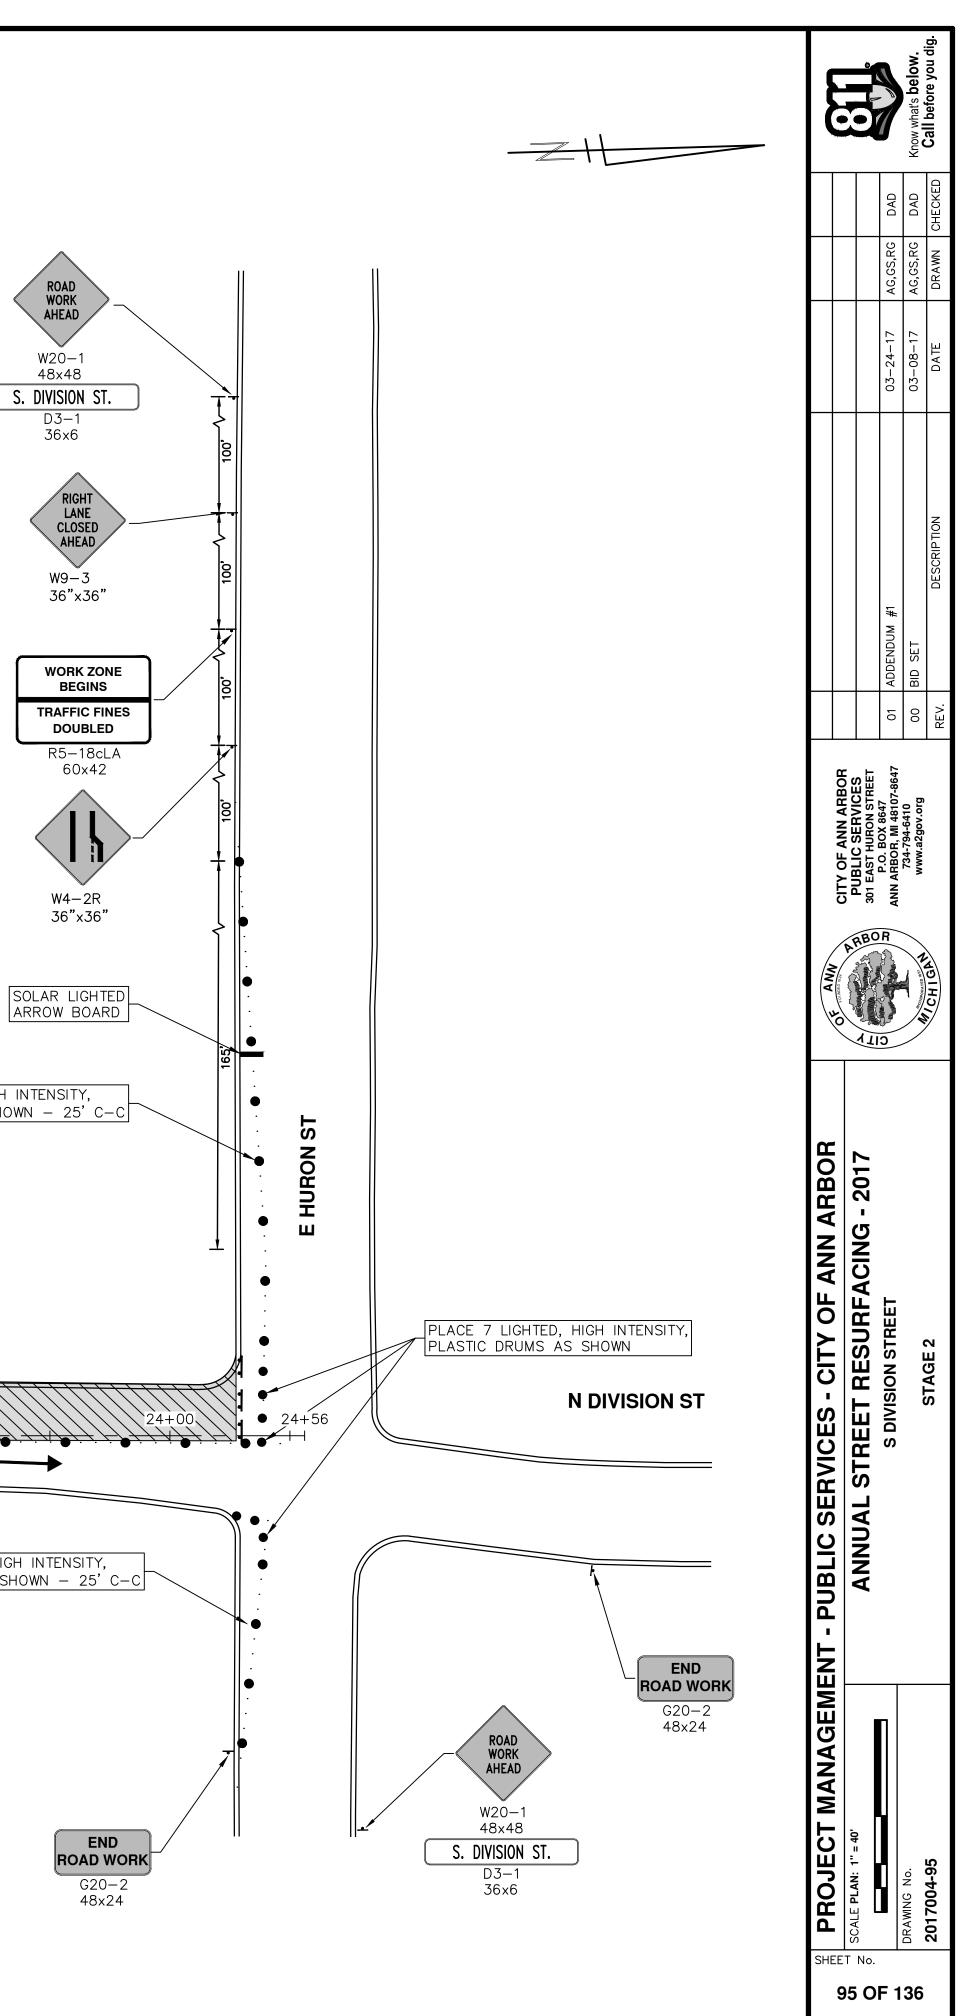


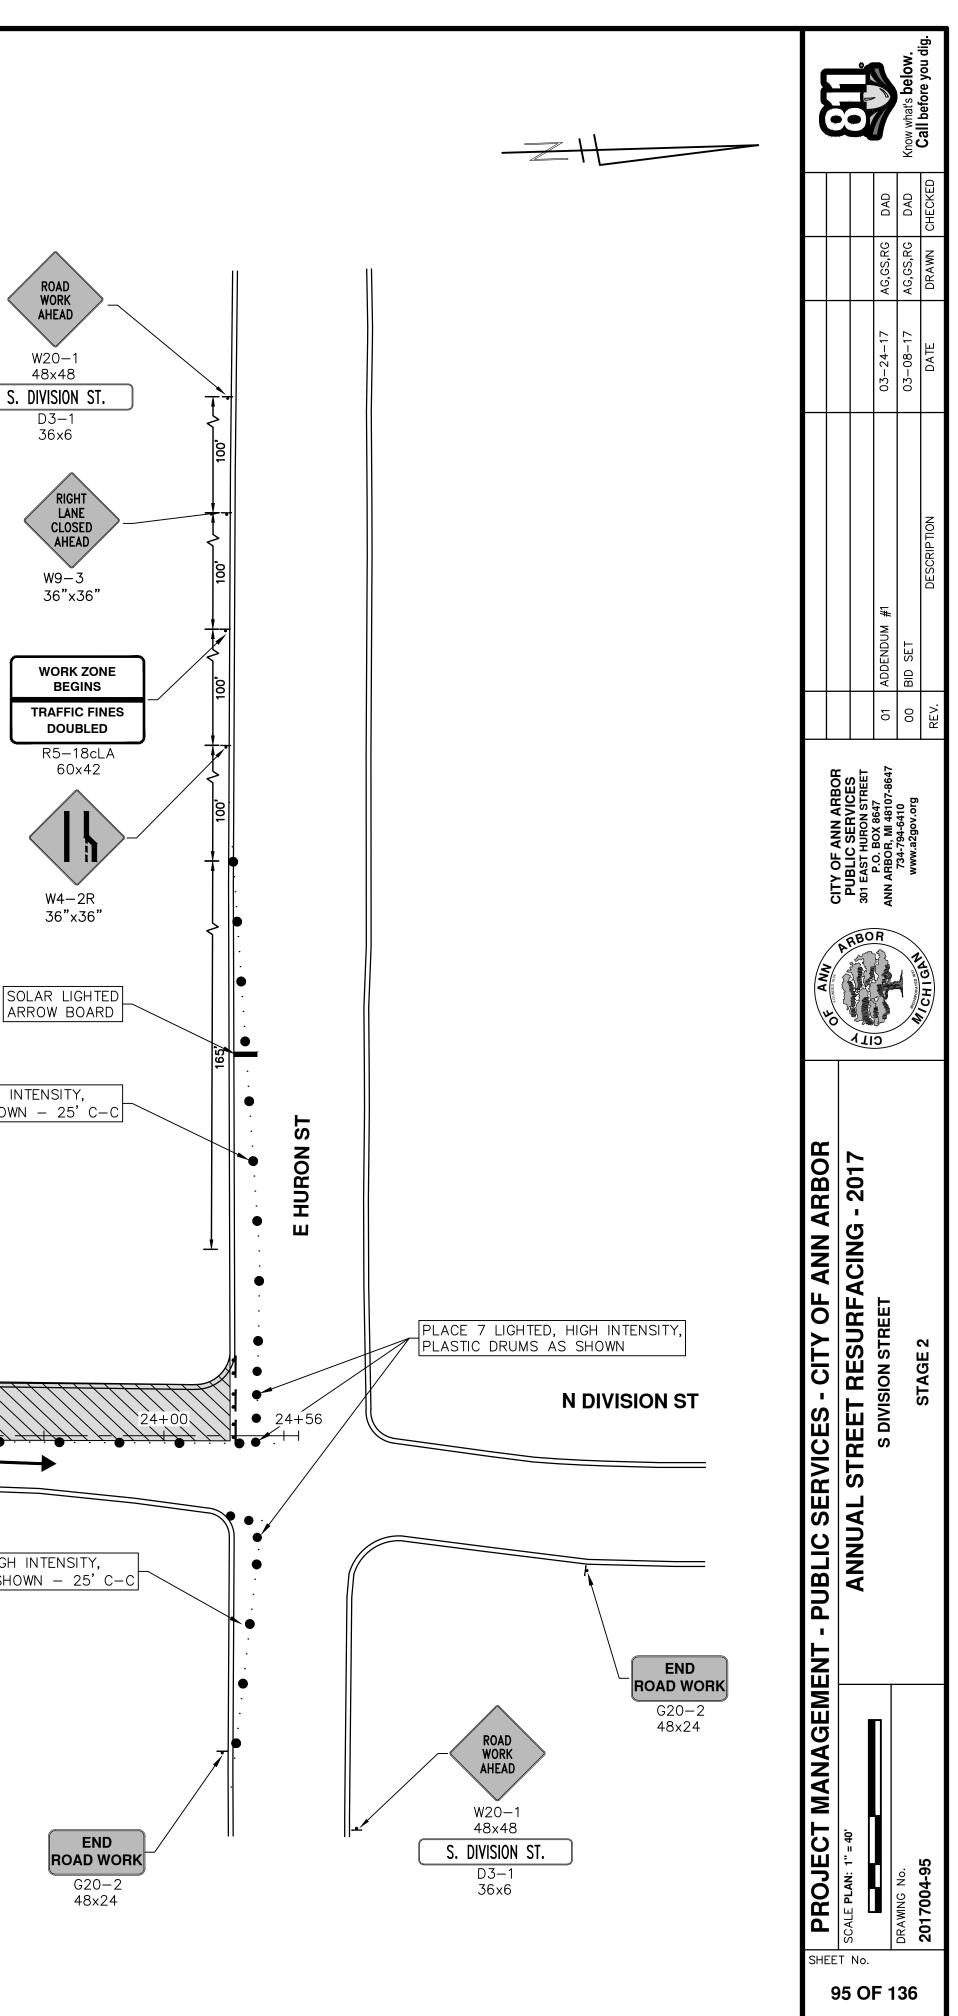


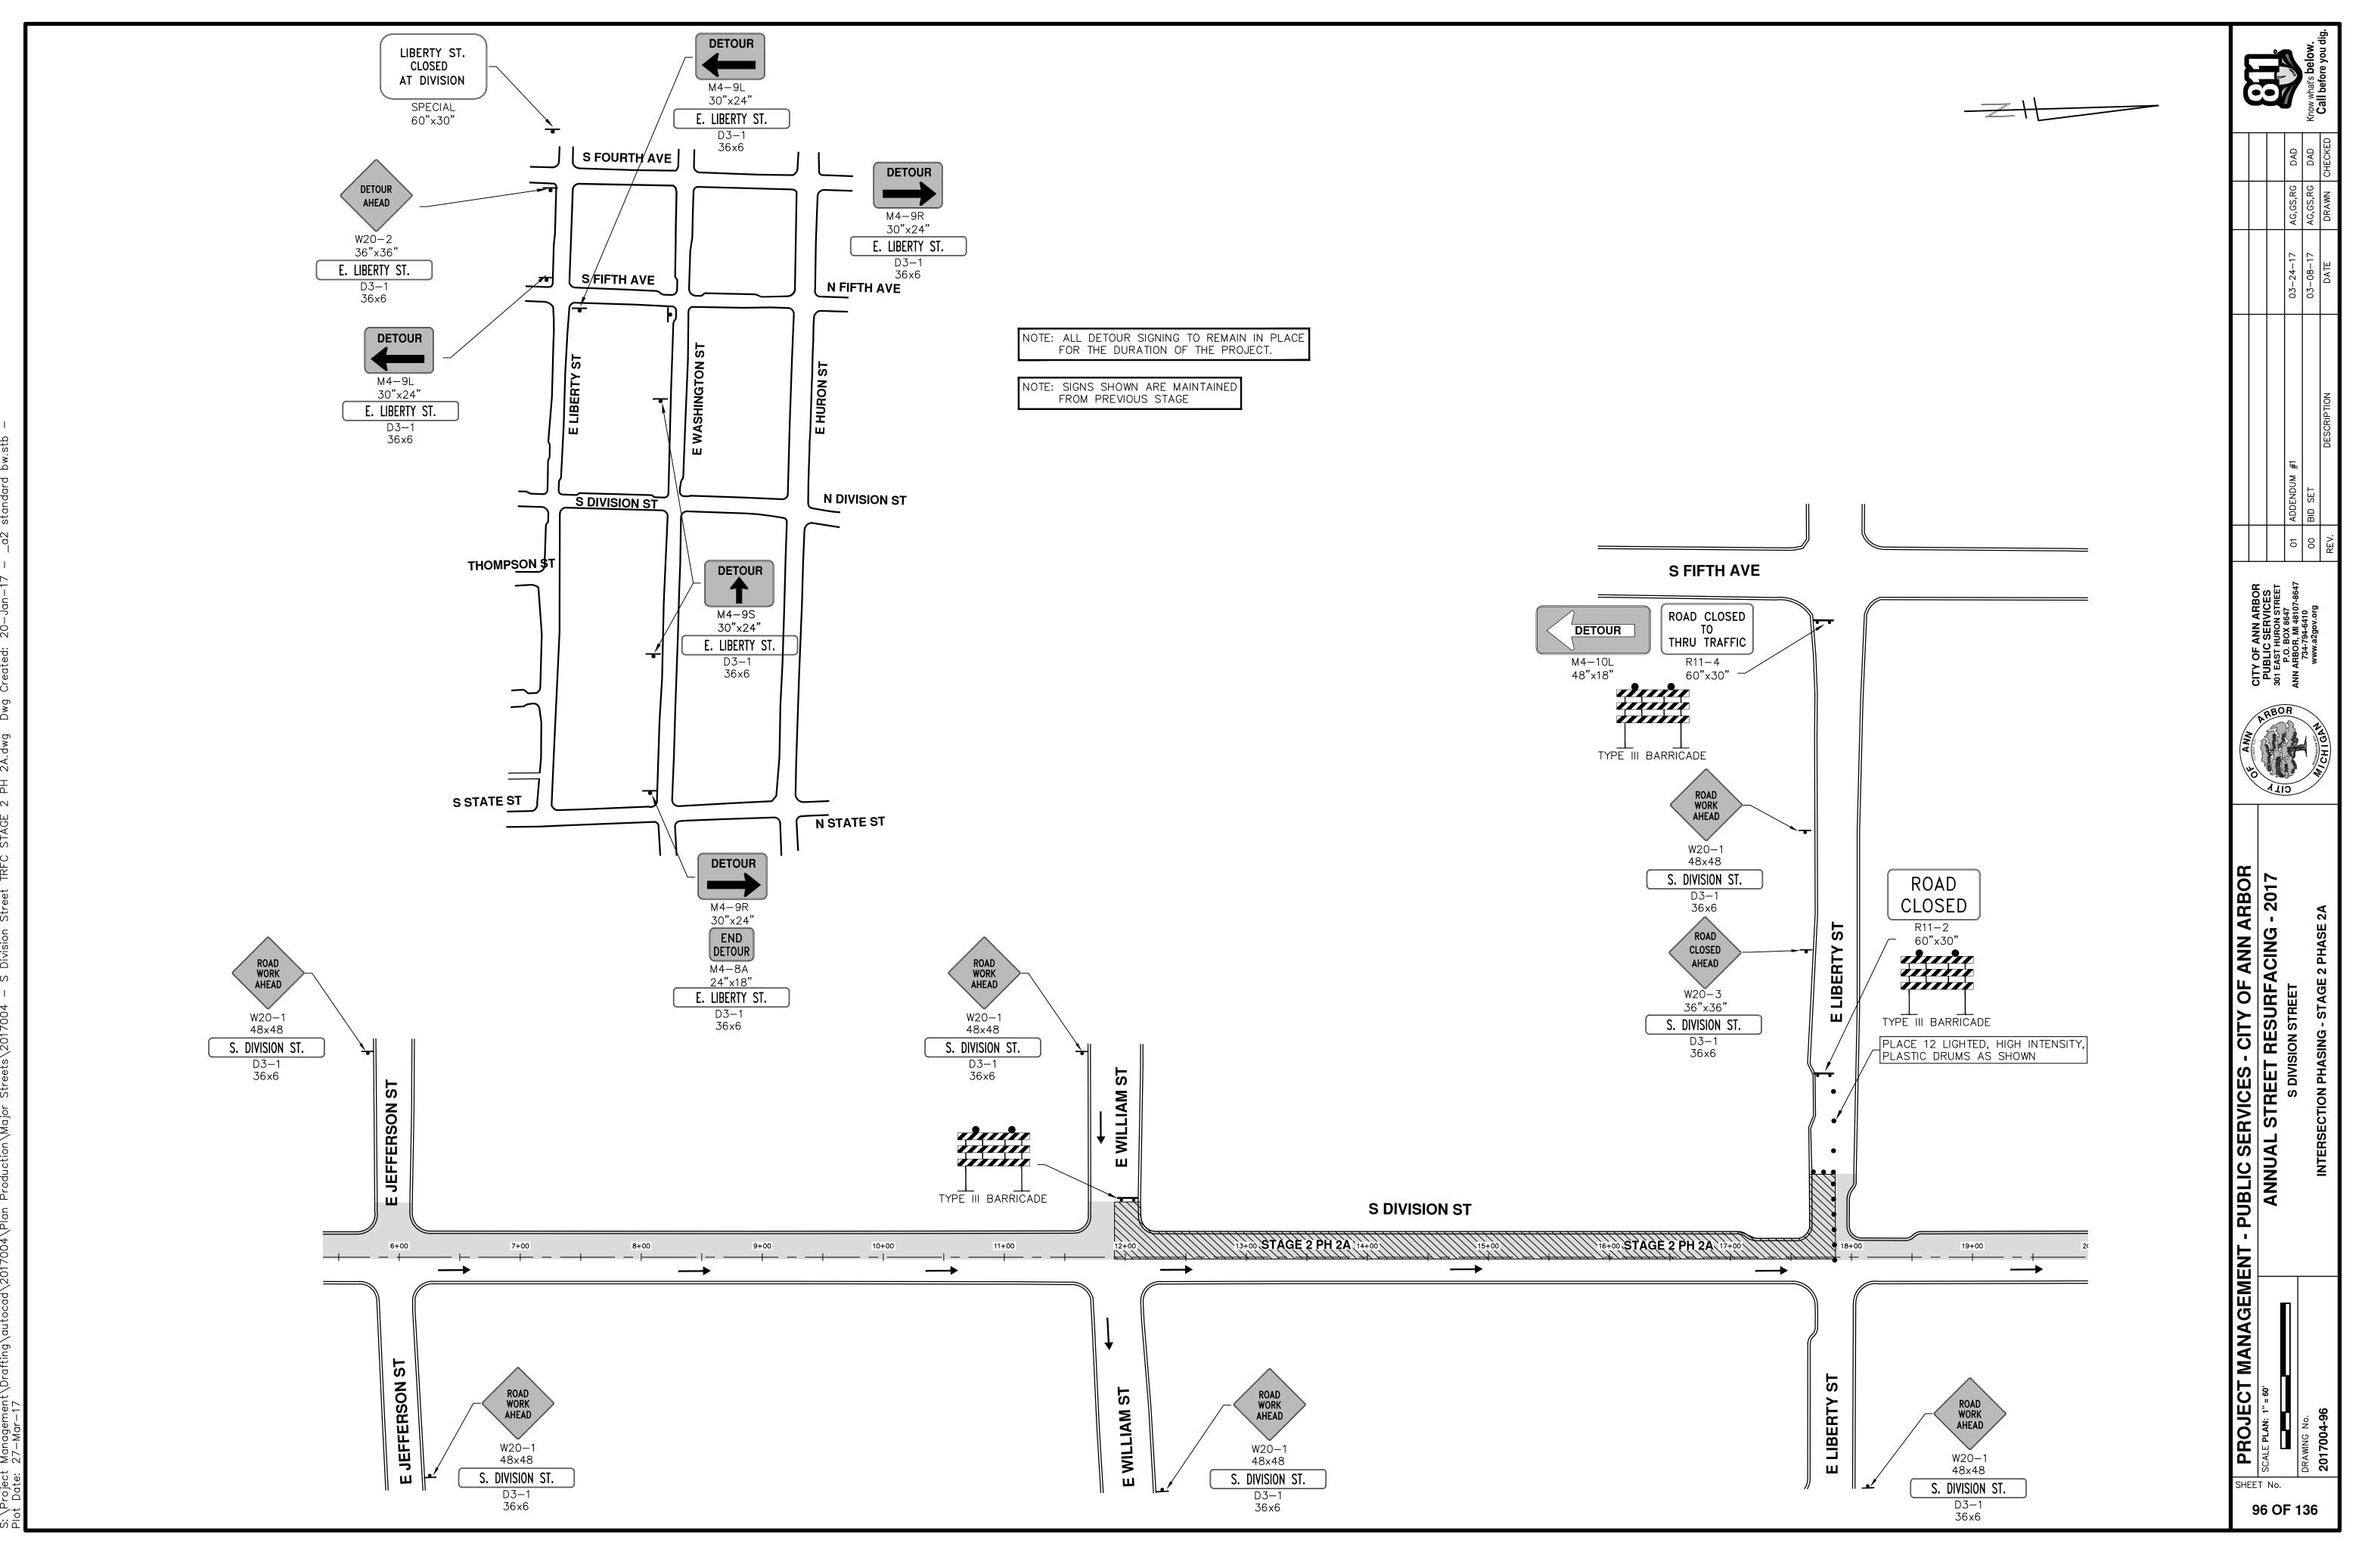

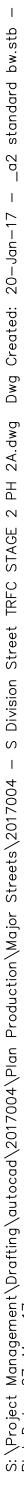


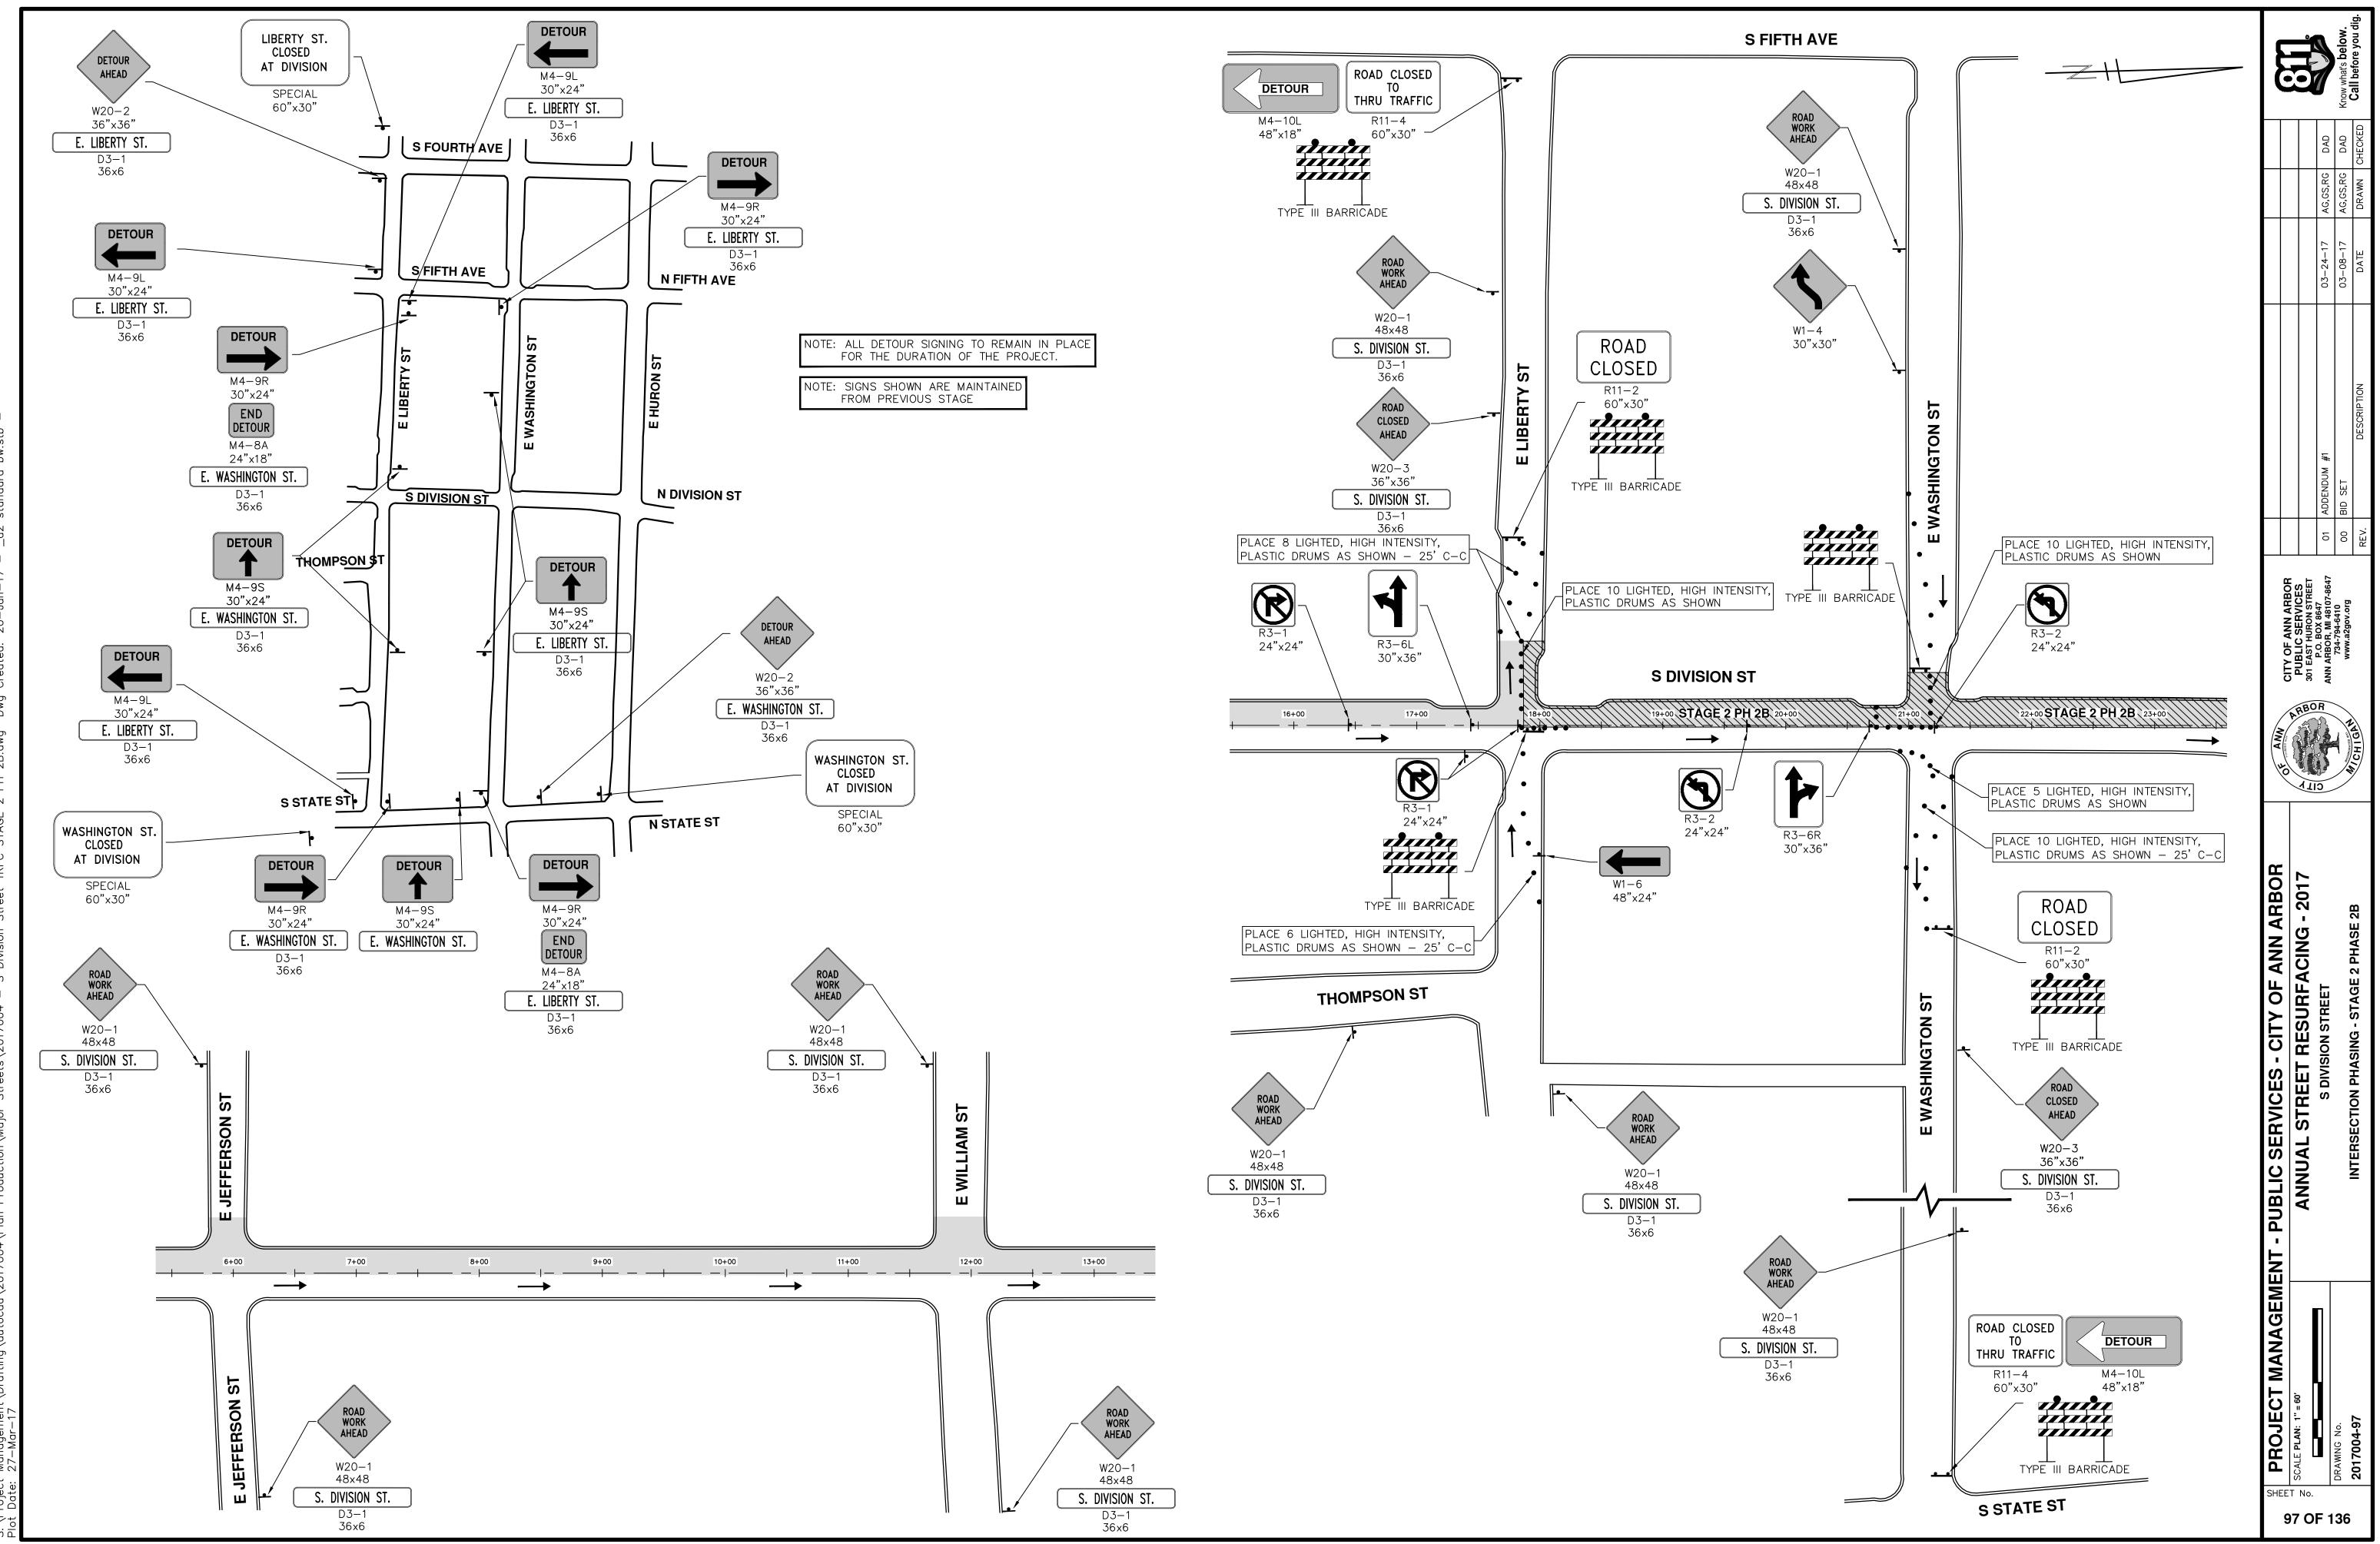

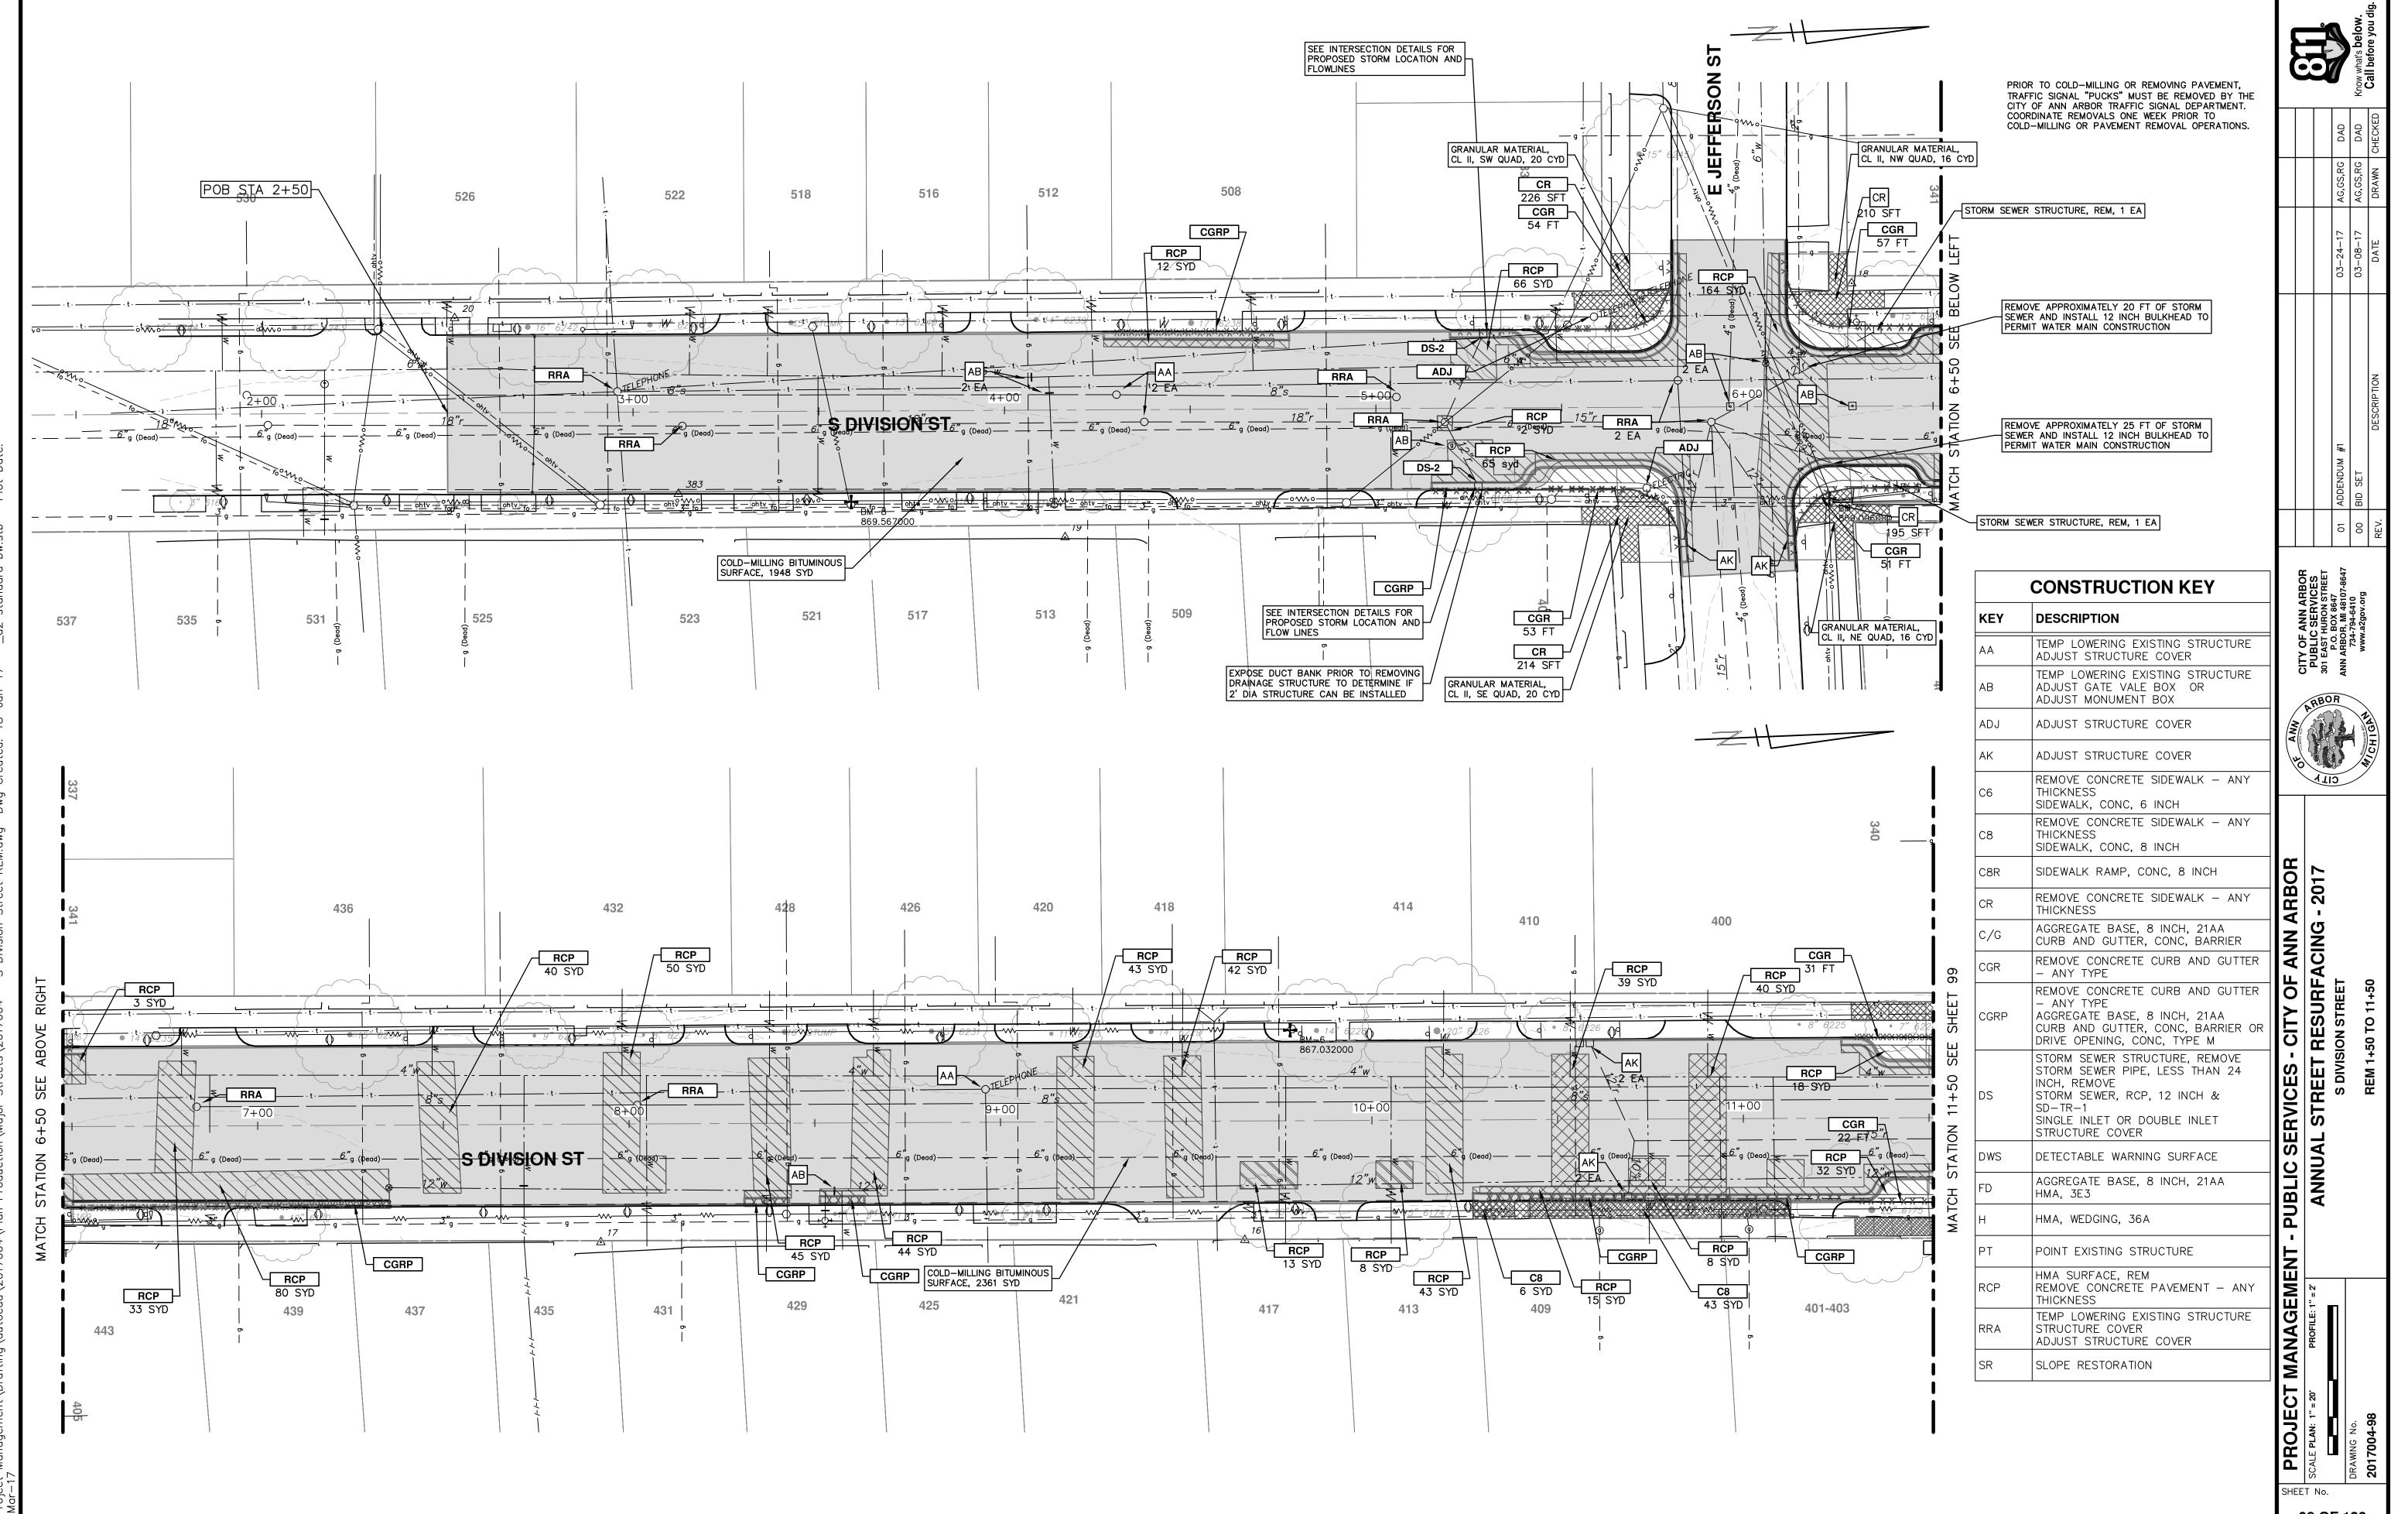

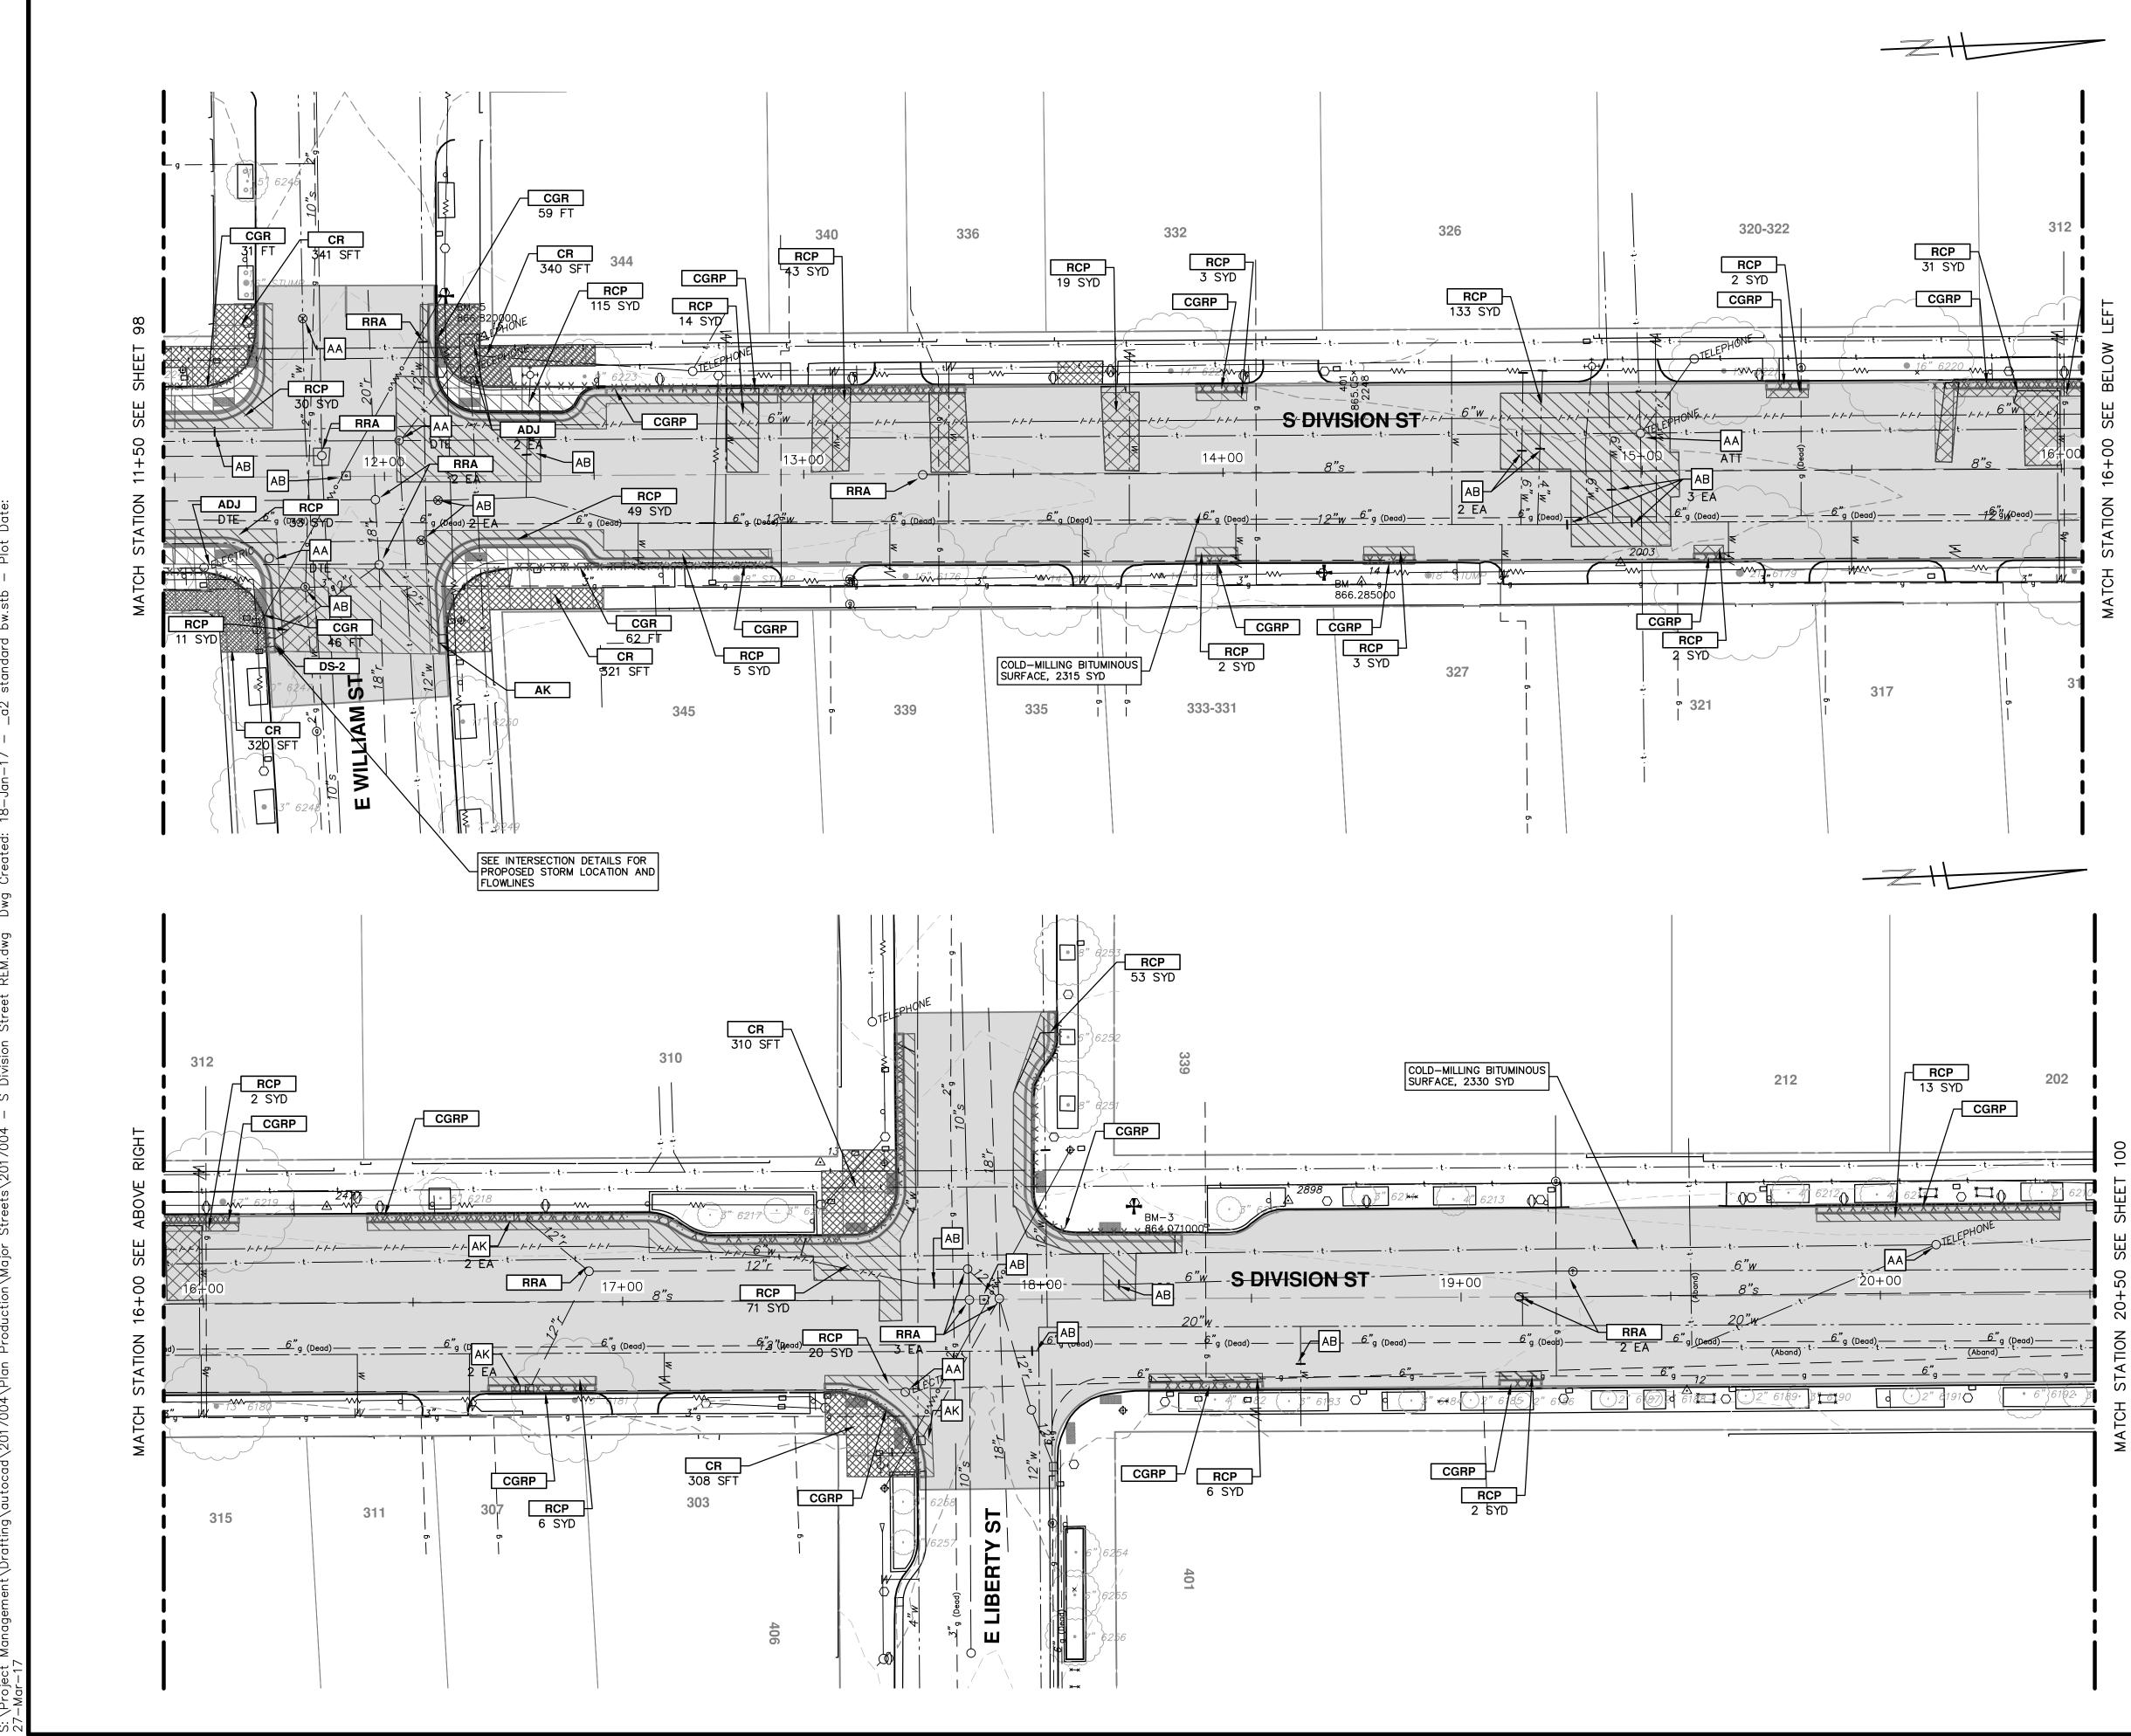


PRIOR TO COLD-MILLING OR REMOVING PAVEMENT, TRAFFIC SIGNAL "PUCKS" MUST BE REMOVED BY THE CITY OF ANN ARBOR TRAFFIC SIGNAL DEPARTMENT. COORDINATE REMOVALS ONE WEEK PRIOR TO COLD-MILLING OR PAVEMENT REMOVAL OPERATIONS.

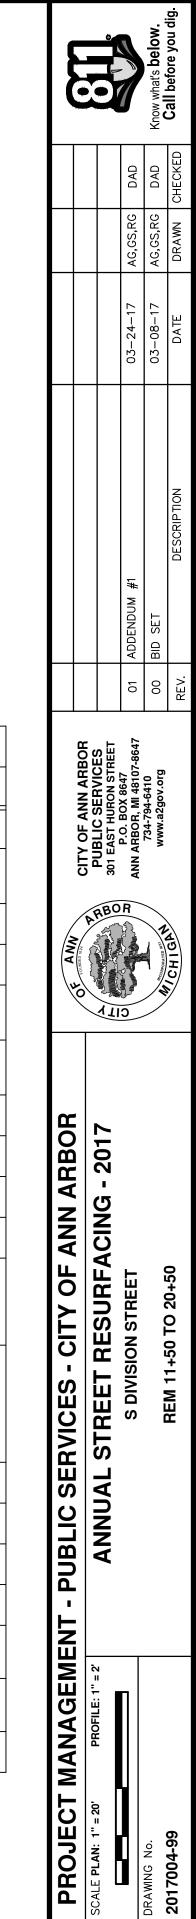

	CONSTRUCTION KEY
KEY	DESCRIPTION
АА	TEMP LOWERING EXISTING STRUCTURE ADJUST STRUCTURE COVER
AB	TEMP LOWERING EXISTING STRUCTURE ADJUST GATE VALE BOX OR ADJUST MONUMENT BOX
ADJ	ADJUST STRUCTURE COVER
AK	ADJUST STRUCTURE COVER
C6	REMOVE CONCRETE SIDEWALK – ANY THICKNESS SIDEWALK, CONC, 6 INCH
C8	REMOVE CONCRETE SIDEWALK – ANY THICKNESS SIDEWALK, CONC, 8 INCH
C8R	SIDEWALK RAMP, CONC, 8 INCH
CR	REMOVE CONCRETE SIDEWALK - ANY THICKNESS
C/G	AGGREGATE BASE, 8 INCH, 21AA CURB AND GUTTER, CONC, BARRIER
CGR	REMOVE CONCRETE CURB AND GUTTER - ANY TYPE
CGRP	REMOVE CONCRETE CURB AND GUTTER – ANY TYPE AGGREGATE BASE, 8 INCH, 21AA CURB AND GUTTER, CONC, BARRIER OF DRIVE OPENING, CONC, TYPE M
DS	STORM SEWER STRUCTURE, REMOVE STORM SEWER PIPE, LESS THAN 24 INCH, REMOVE STORM SEWER, RCP, 12 INCH & SD-TR-1 SINGLE INLET OR DOUBLE INLET STRUCTURE COVER
DWS	DETECTABLE WARNING SURFACE
FD	AGGREGATE BASE, 8 INCH, 21AA HMA, 3E3
н	HMA, WEDGING, 36A
PT	POINT EXISTING STRUCTURE
RCP	HMA SURFACE, REM REMOVE CONCRETE PAVEMENT – ANY THICKNESS
RRA	TEMP LOWERING EXISTING STRUCTURE STRUCTURE COVER ADJUST STRUCTURE COVER
SR	SLOPE RESTORATION


99 OF 136


SHEET No.

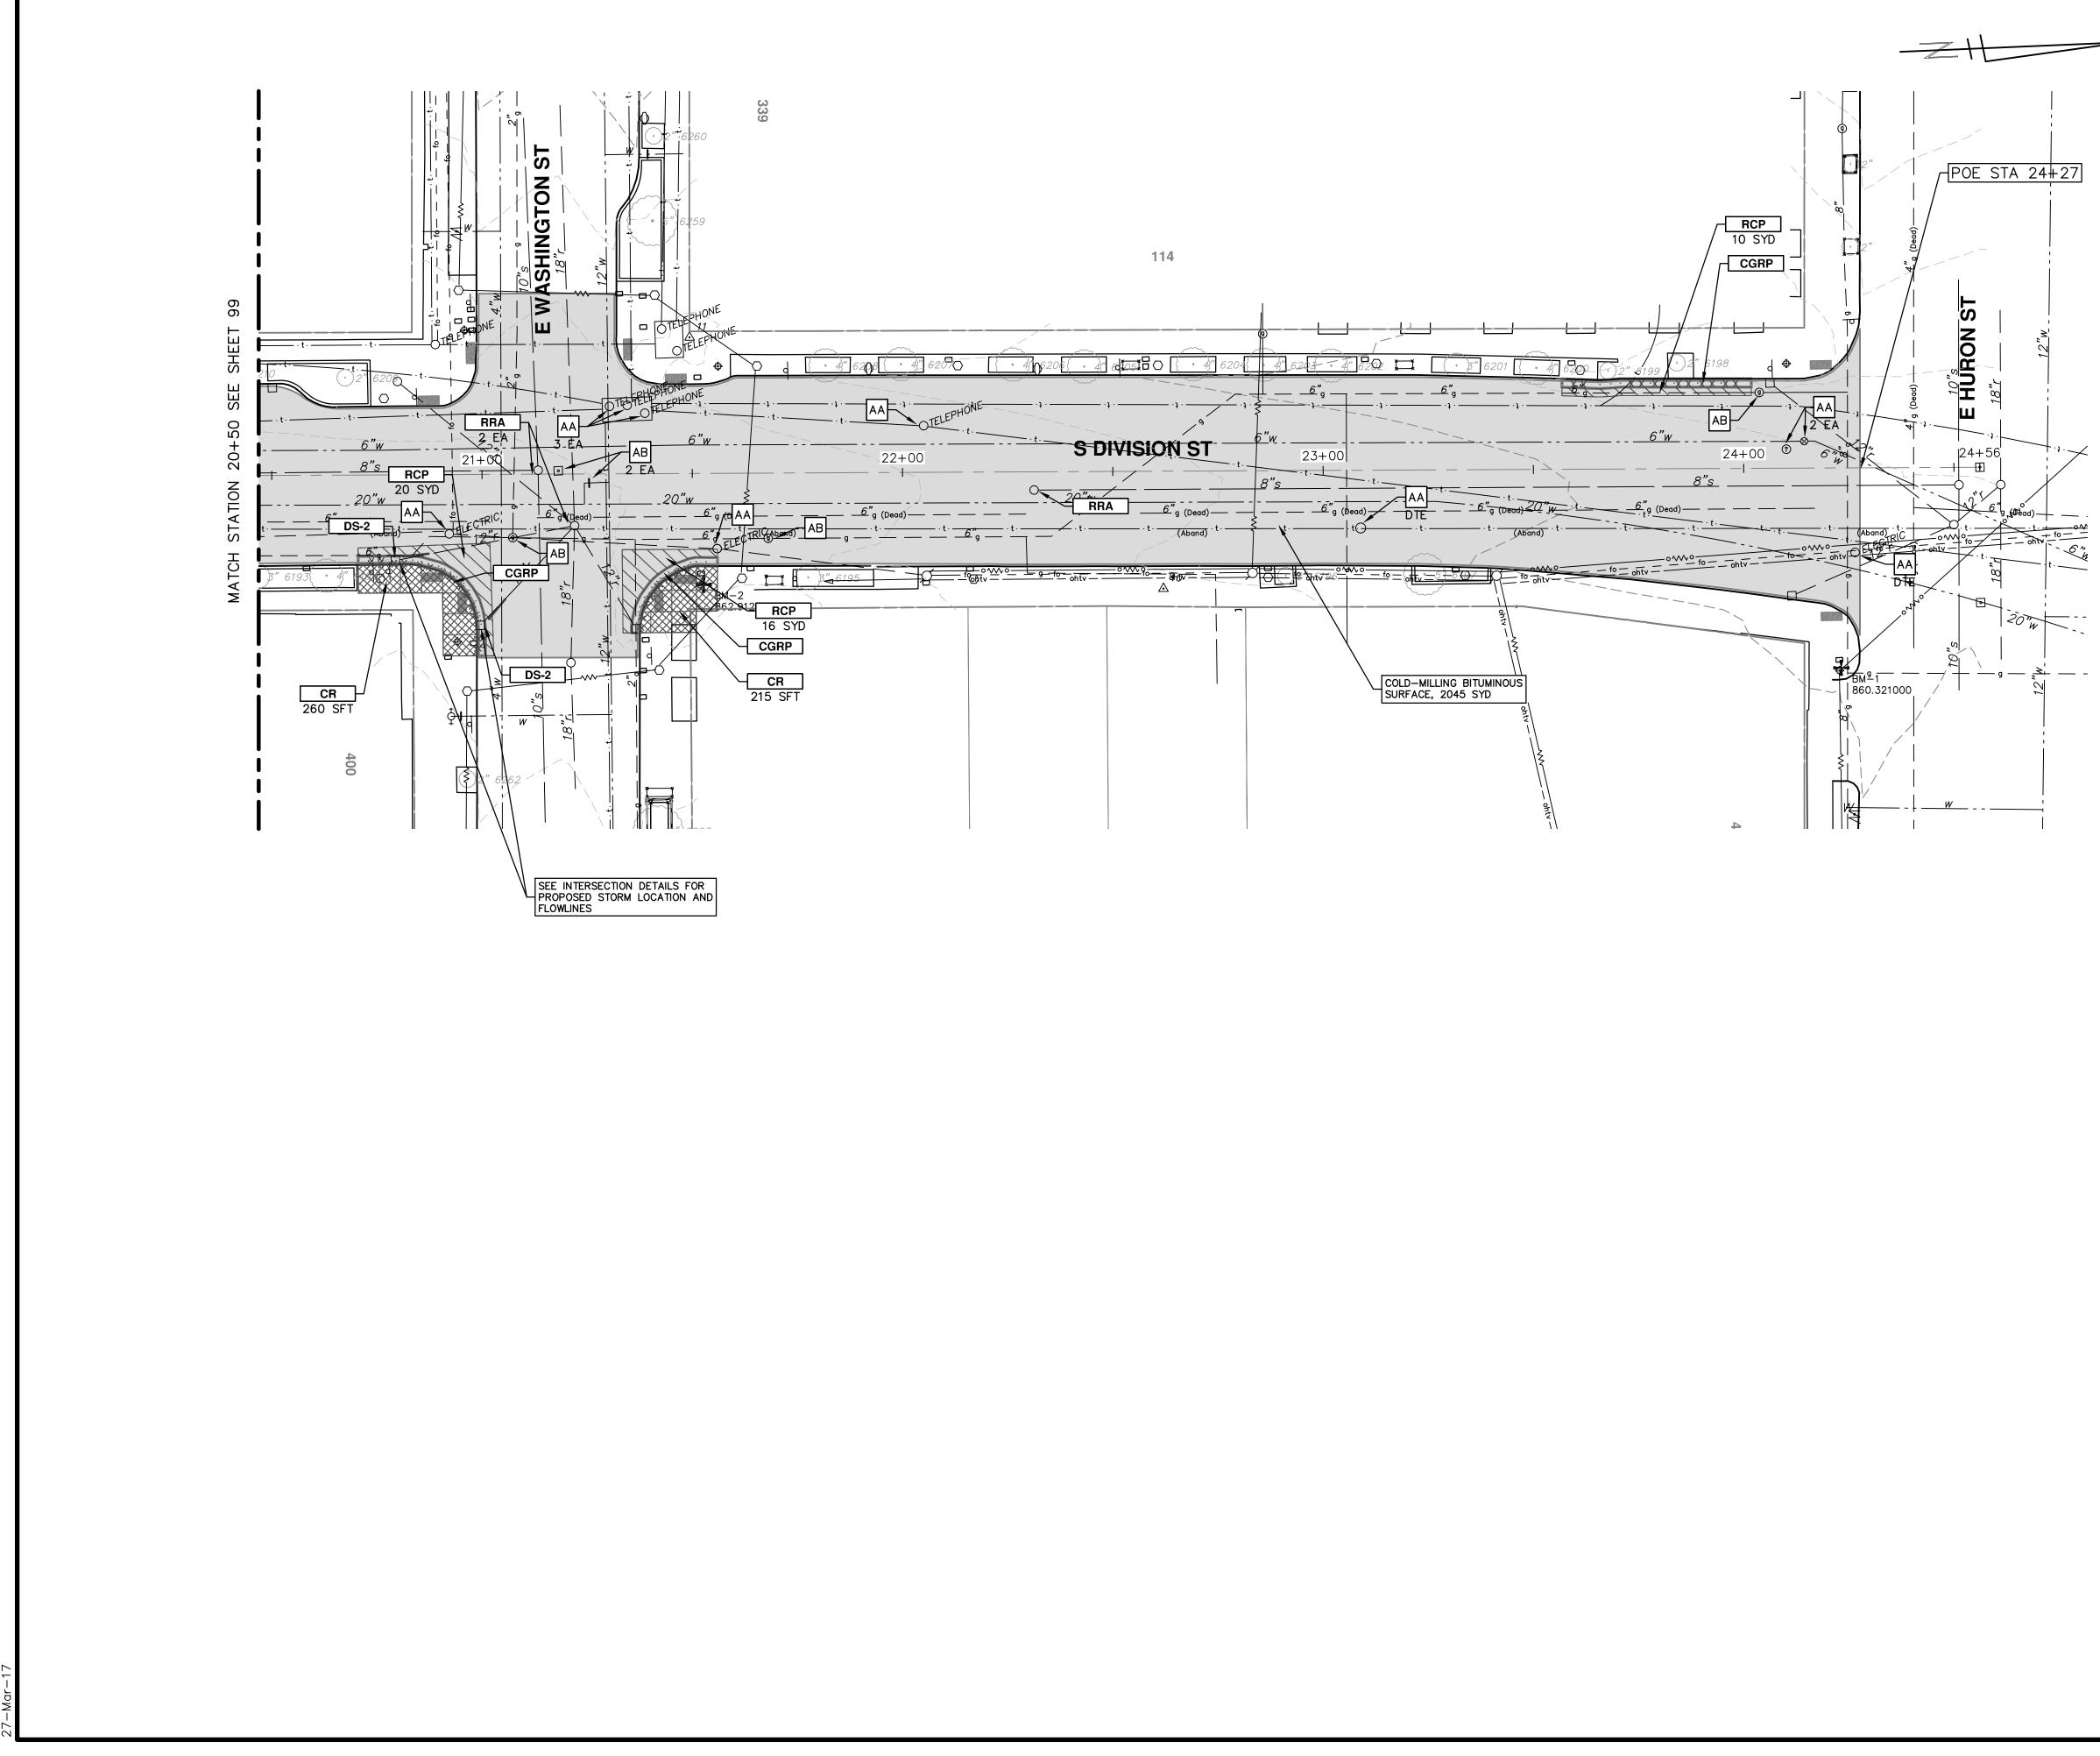


 \Box S S: \Project 27-Mar-17 PRIOR TO COLD-MILLING OR REMOVING PAVEMENT, TRAFFIC SIGNAL "PUCKS" MUST BE REMOVED BY THE CITY OF ANN ARBOR TRAFFIC SIGNAL DEPARTMENT. COORDINATE REMOVALS ONE WEEK PRIOR TO COLD-MILLING OR PAVEMENT REMOVAL OPERATIONS.


	CONSTRUCTION KEY
KEY	DESCRIPTION
АА	TEMP LOWERING EXISTING STRUCTURE ADJUST STRUCTURE COVER
AB	TEMP LOWERING EXISTING STRUCTURE ADJUST GATE VALE BOX OR ADJUST MONUMENT BOX
ADJ	ADJUST STRUCTURE COVER
АК	ADJUST STRUCTURE COVER
C6	REMOVE CONCRETE SIDEWALK – ANY THICKNESS SIDEWALK, CONC, 6 INCH
C8	REMOVE CONCRETE SIDEWALK – ANY THICKNESS SIDEWALK, CONC, 8 INCH
C8R	SIDEWALK RAMP, CONC, 8 INCH
CR	REMOVE CONCRETE SIDEWALK – ANY THICKNESS
C/G	AGGREGATE BASE, 8 INCH, 21AA CURB AND GUTTER, CONC, BARRIER
CGR	REMOVE CONCRETE CURB AND GUTTER - ANY TYPE
CGRP	REMOVE CONCRETE CURB AND GUTTER – ANY TYPE AGGREGATE BASE, 8 INCH, 21AA CURB AND GUTTER, CONC, BARRIER OR DRIVE OPENING, CONC, TYPE M
DS	STORM SEWER STRUCTURE, REMOVE STORM SEWER PIPE, LESS THAN 24 INCH, REMOVE STORM SEWER, RCP, 12 INCH & SD-TR-1 SINGLE INLET OR DOUBLE INLET STRUCTURE COVER
DWS	DETECTABLE WARNING SURFACE
FD	AGGREGATE BASE, 8 INCH, 21AA HMA, 3E3
Н	HMA, WEDGING, 36A
PT	POINT EXISTING STRUCTURE
RCP	HMA SURFACE, REM REMOVE CONCRETE PAVEMENT — ANY THICKNESS
RRA	TEMP LOWERING EXISTING STRUCTURE STRUCTURE COVER ADJUST STRUCTURE COVER
SR	SLOPE RESTORATION

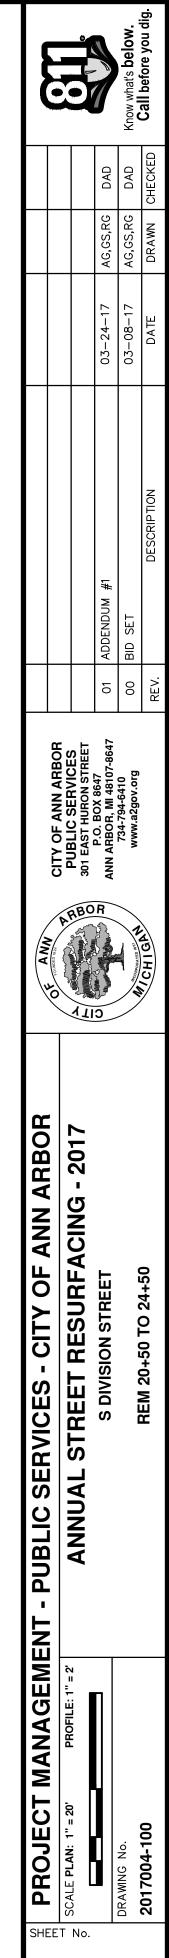

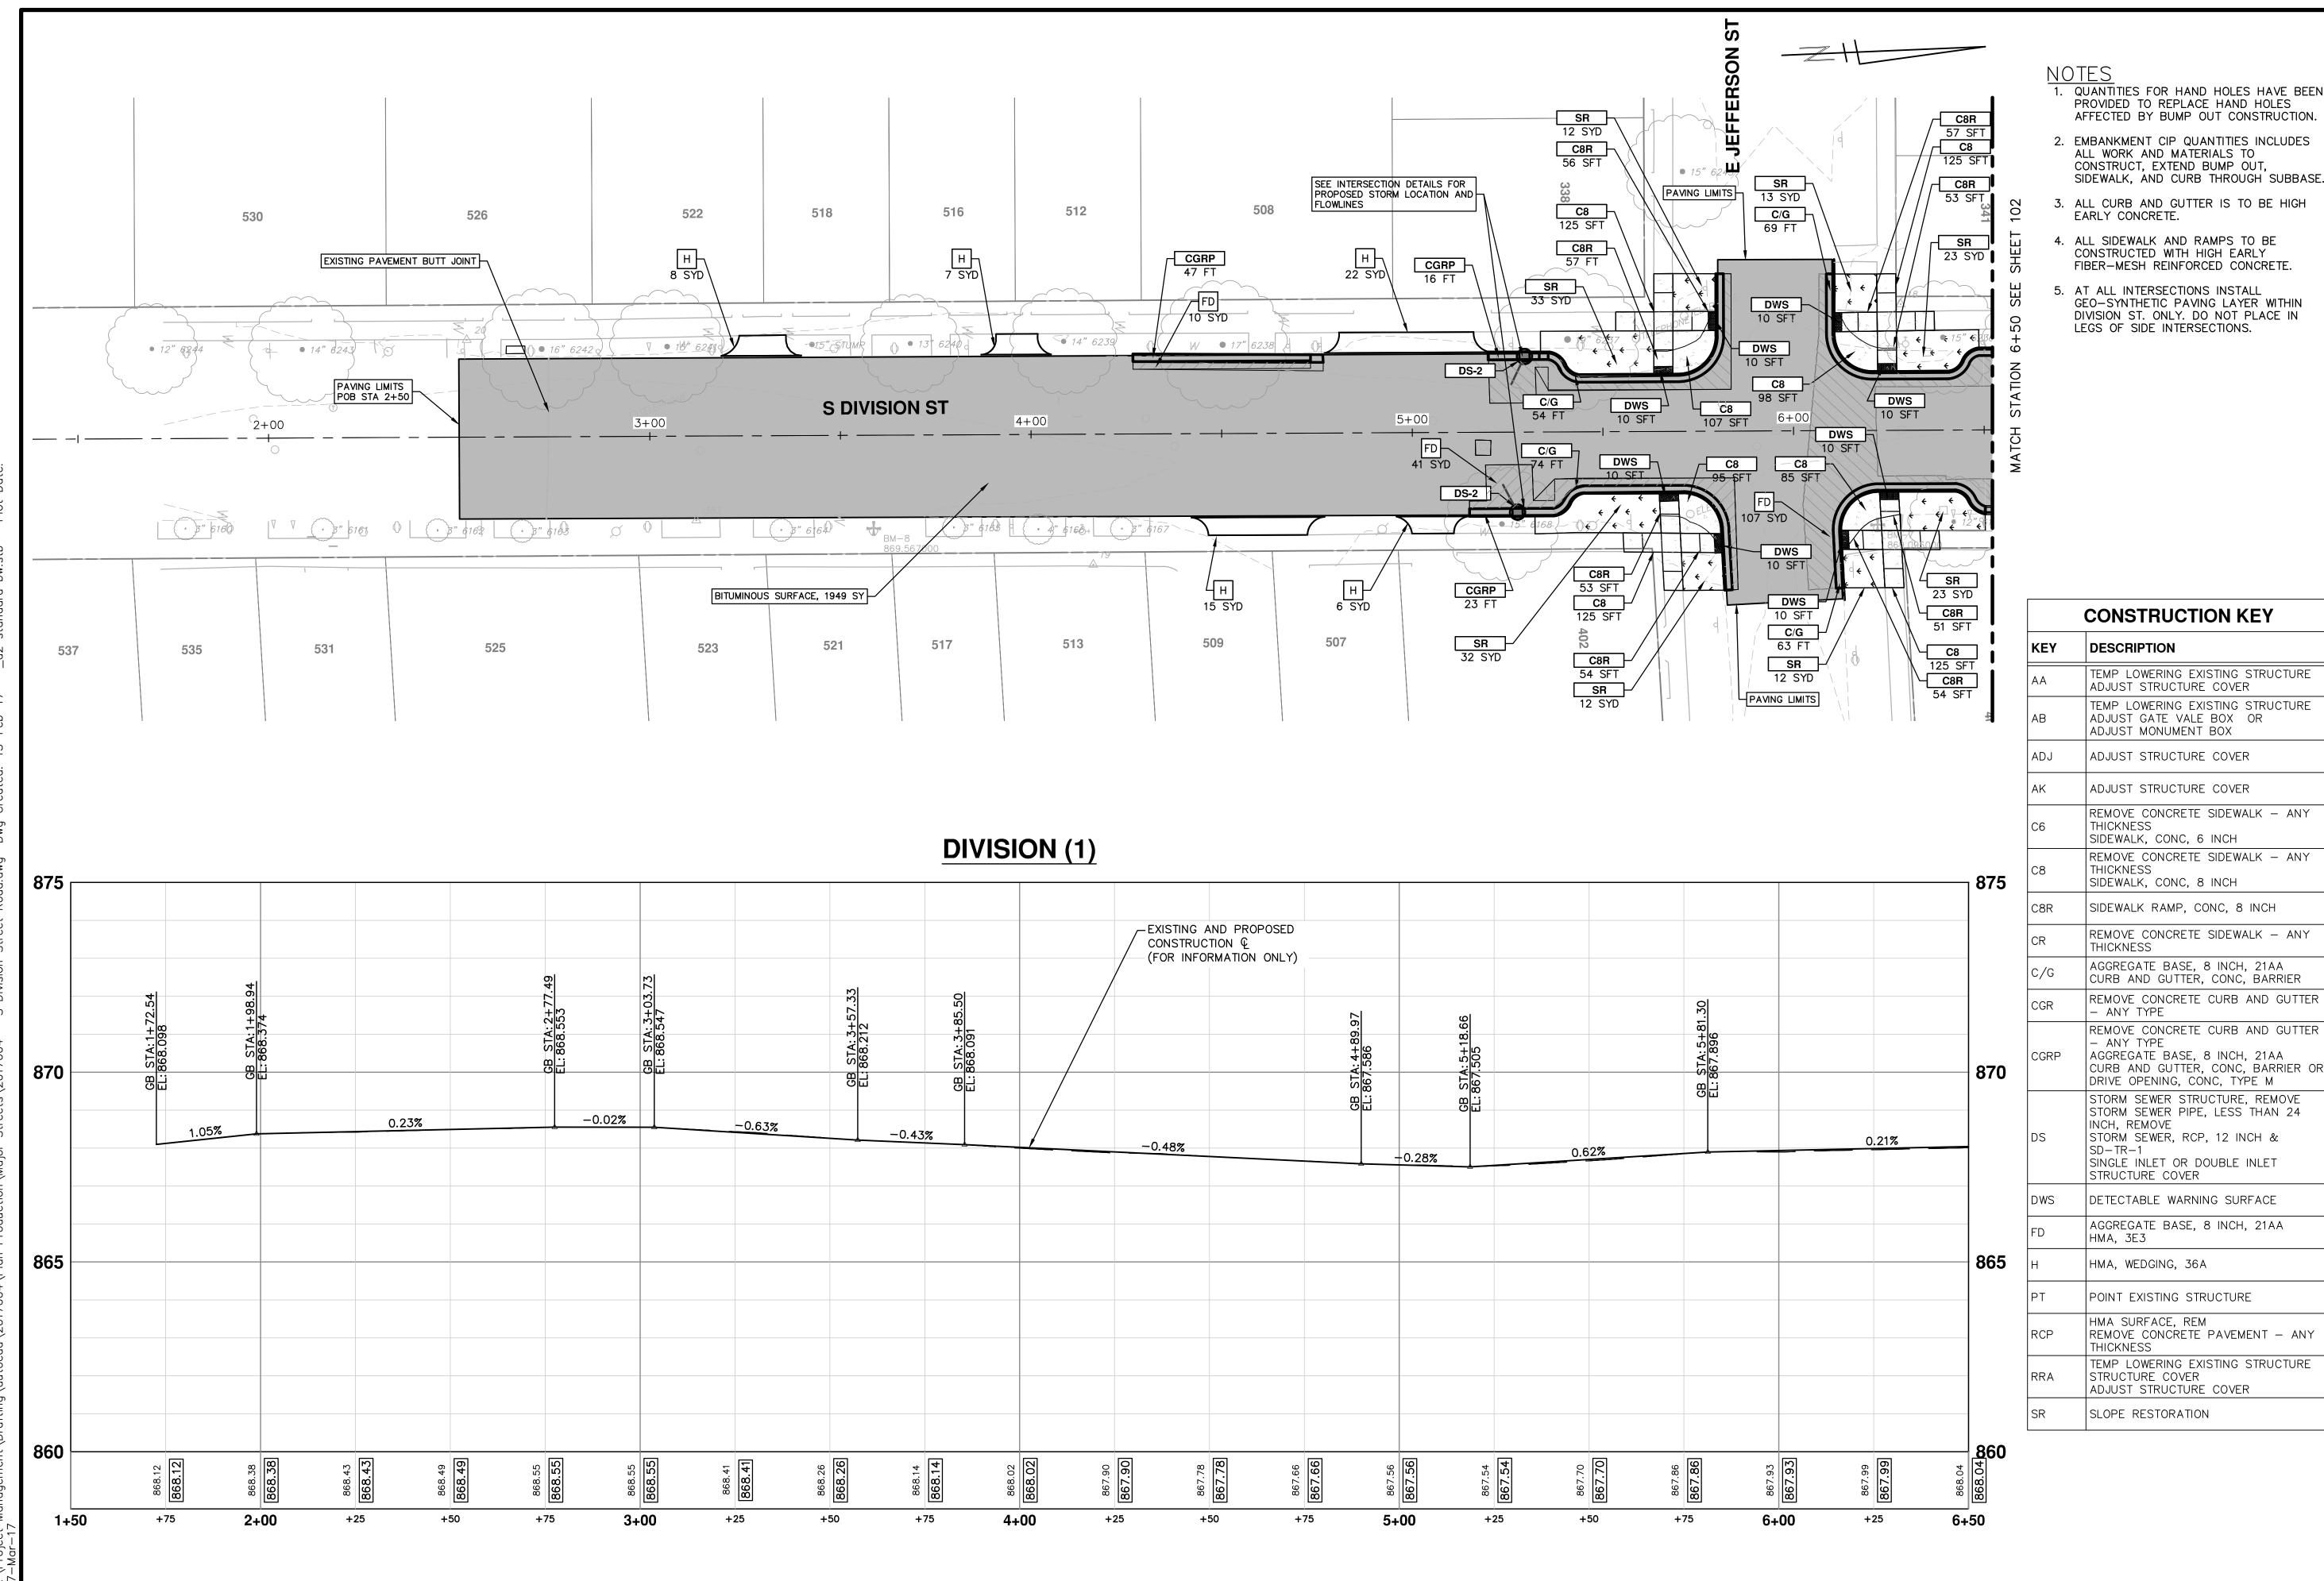


EL: 868.212 EI: 868.212 -0.43	% GB STA: 3+85.50 EL: 868.091		-EXISTING A CONSTRUC (FOR INFOR	AND PROPOSED TION & RMATION ONLY)	<u>GB STA: 4+89.97</u> EL: 867.586	-0.28%	0.6	2%	CB STA: 5+81.30 EL: 867.896	
868.14		868.02 867.90		867.78 867.66		867.56 867.54	867.54 867.70			867.93
+7	⁷⁵ 4 +	•00 +	25 +	50 +	⁷⁵ 5 +	•00 +:	25 +	50 +7	75 6+	00

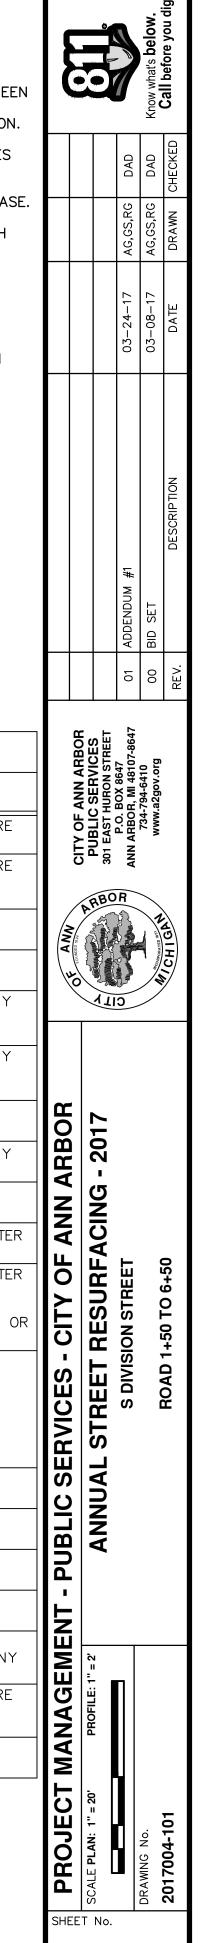

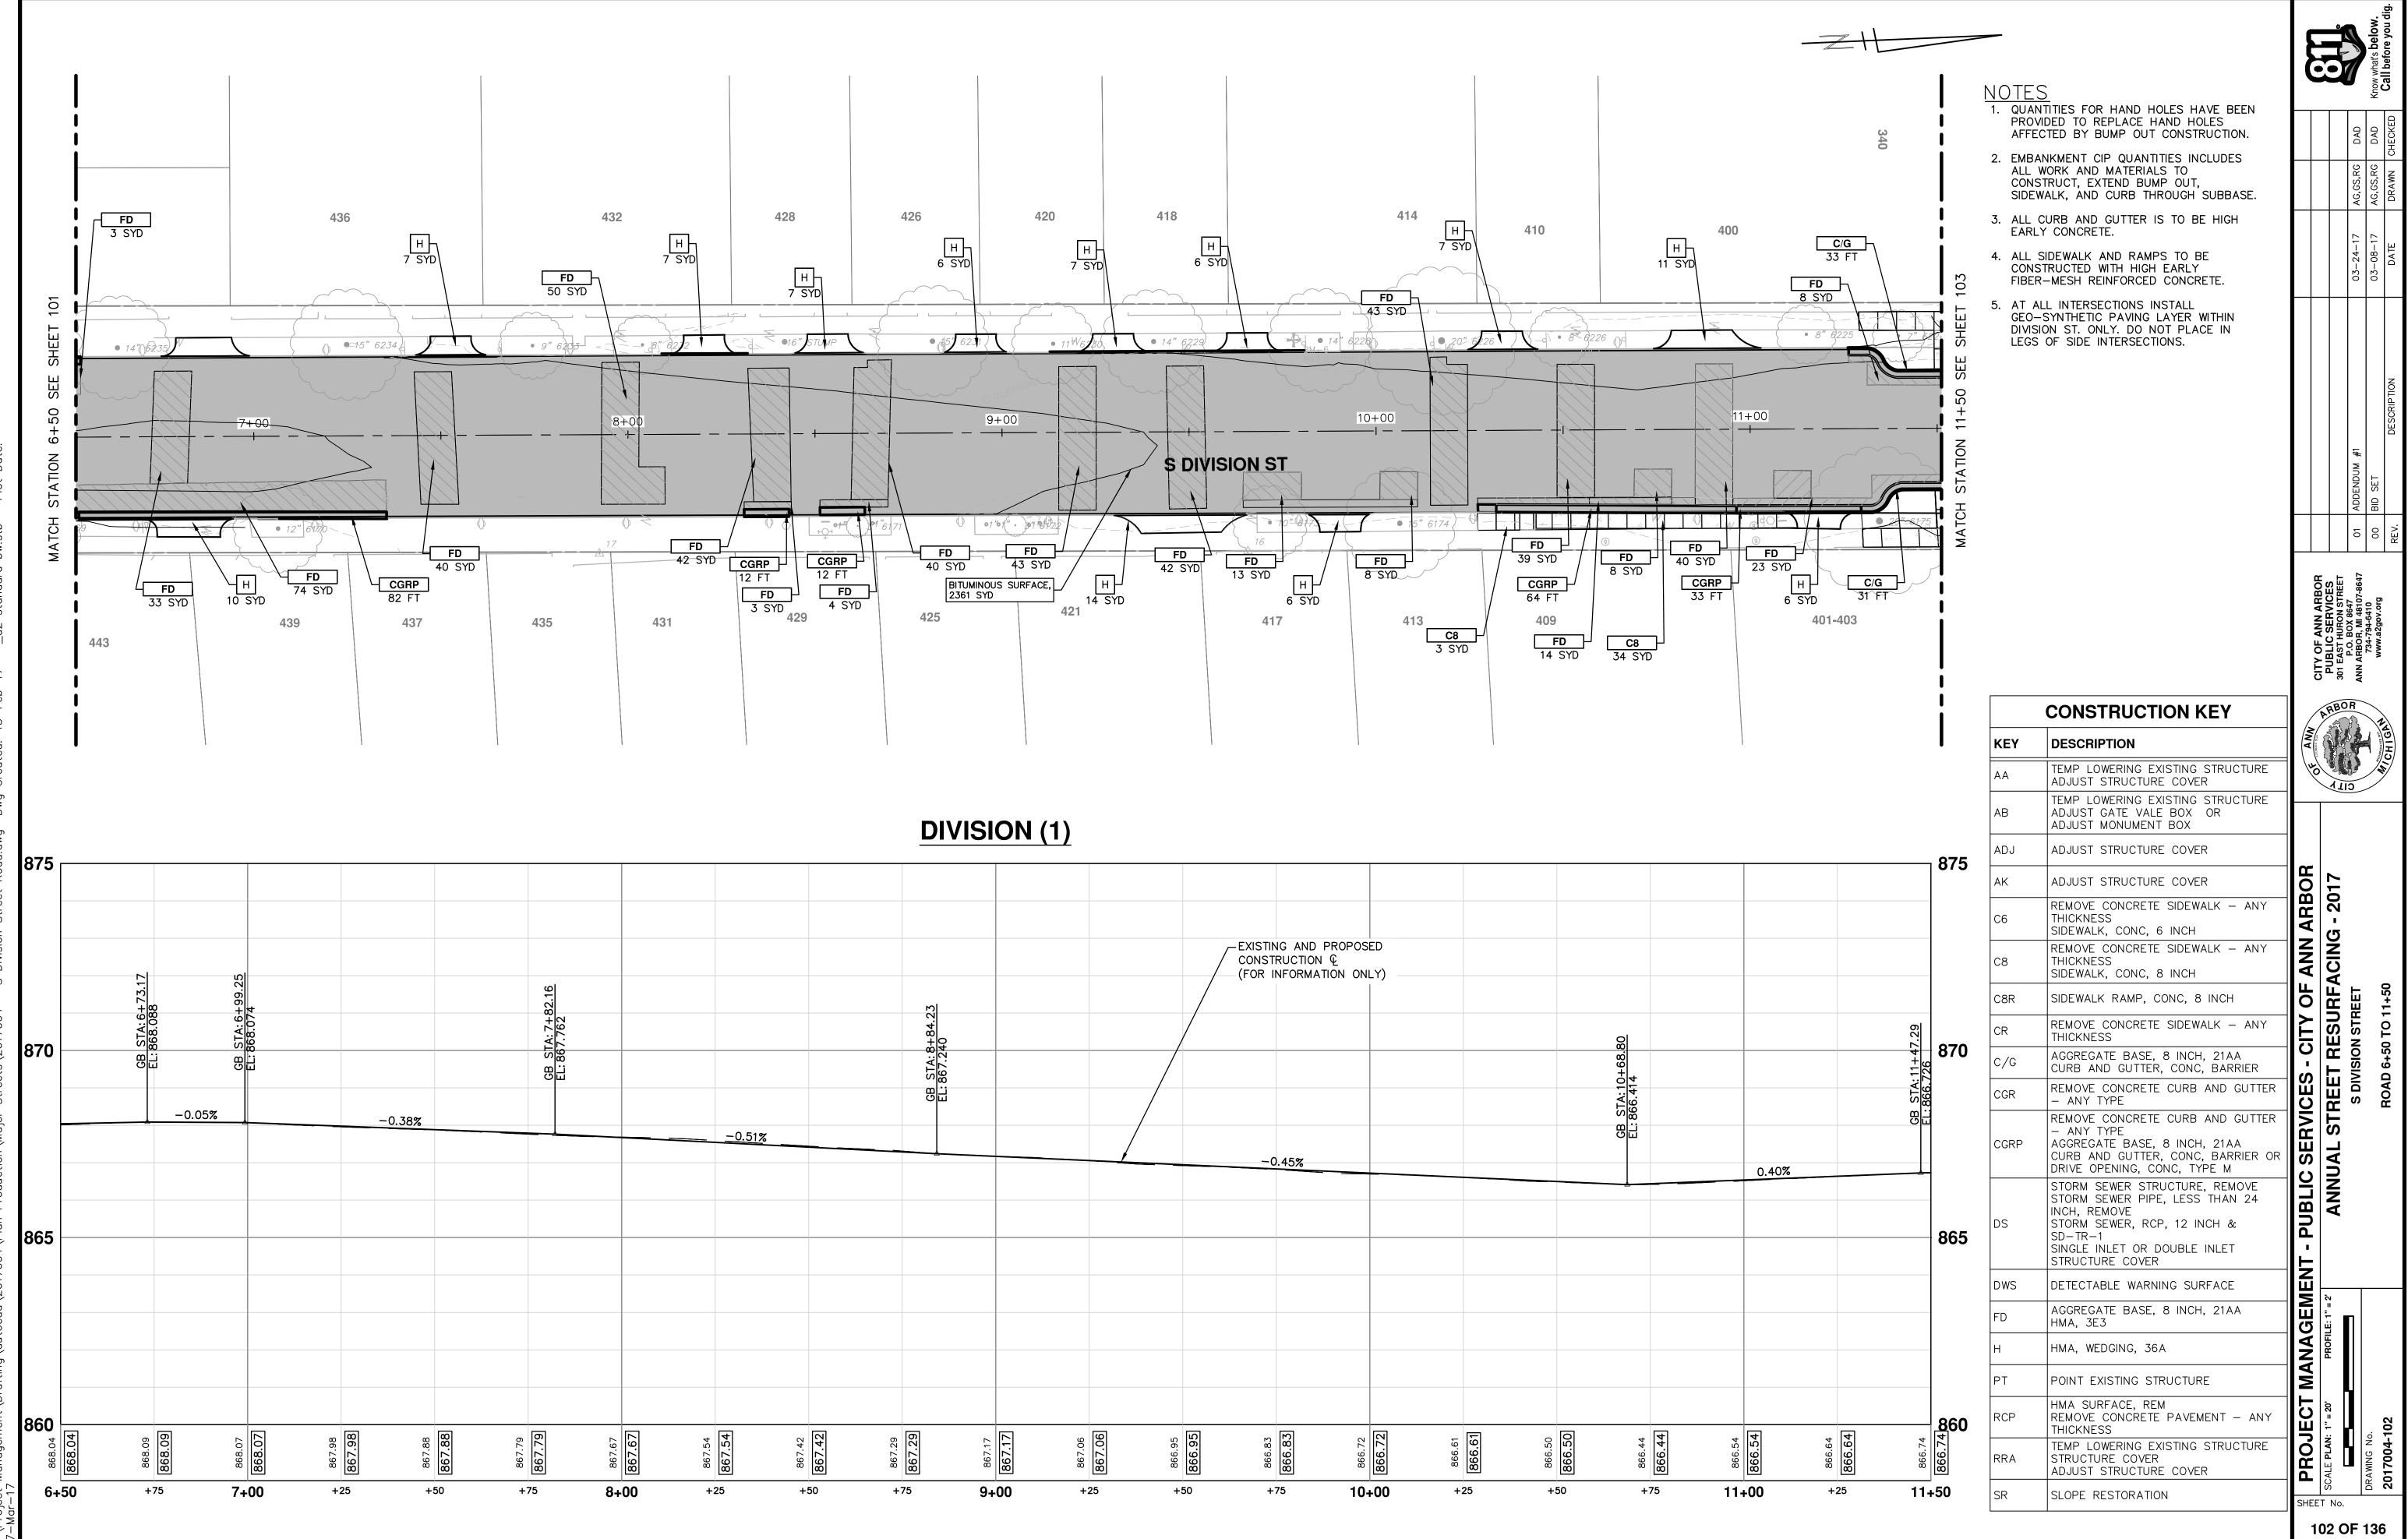

S

+7	75 9 .	+00	+25	+50 +	-75 10	+00 +	25 +	50 +	75 11+	+00
867.29	867.29	867.17	867.06 867.06	866.83	866.83 866.72	866.72 866.61	866.61 866.50	866.50 866.44	866.44 866.54	866.54
			/		0.45%					0.40%
								CB S EL: 86		
	GB ST EL: 867							GB STA: 10+68.80 EL: 866.414		
	CB_STA: 8+84.23 EL: 867.240		/	/				<u>38.80</u>		
	23									
				EXISTI CONST (FOR	NG AND PROPOS TRUCTION € INFORMATION ON	ED LY)				
					1					

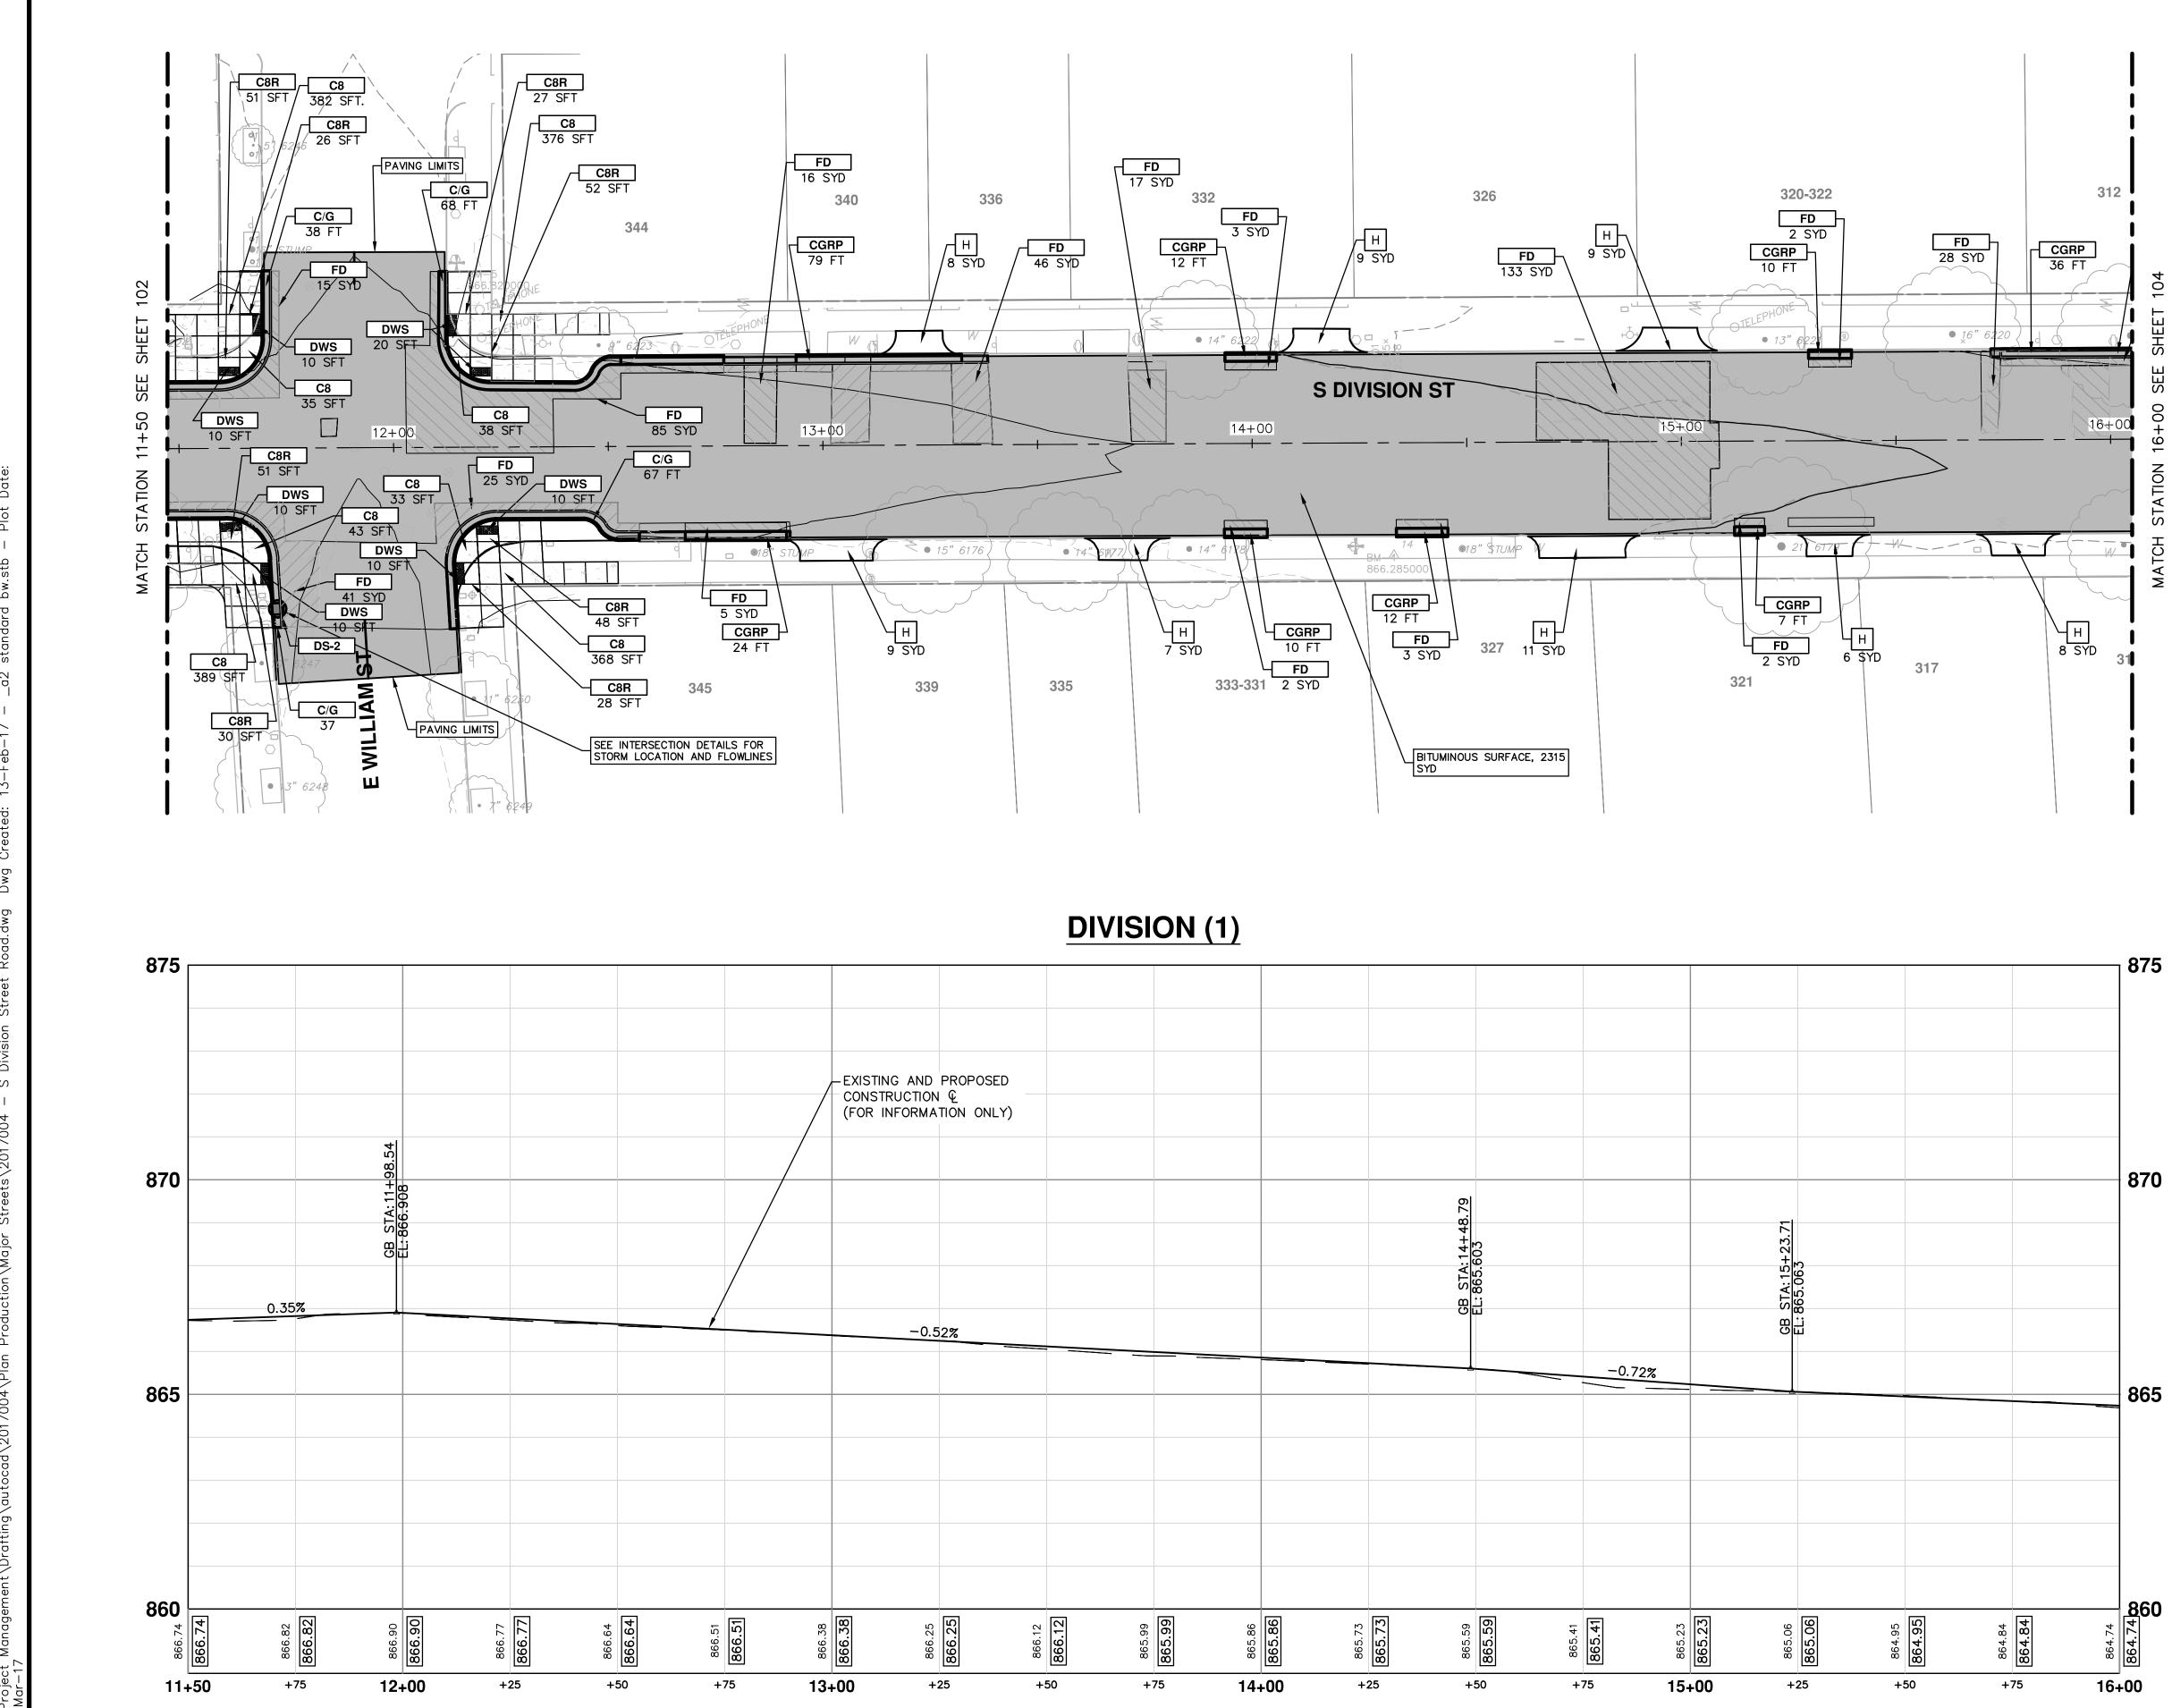

0 *i*

+!	50 +	.75 14 -	+00 +	25 +	50 +	⁷⁵ 15 -	+00 +	25 +!	50 +7	75
866.12	866.12 865.99	865.99 865.86	865.86 865.73	865.73 865.59	865.59 865.41	865.41 865.23	865.23 865.06	865.06 864.95	864.95 864.84	864.84
						-0.72%				
				8			B STA			
				GB STA:14+	65.603		CB STA: 15+23.71	<u></u>		
				14+48.79			. 71			
ONLY)										
POSED										
				1	1				1	


NOTES

0

0

- 1. QUANTITIES FOR HAND HOLES HAVE BEEN PROVIDED TO REPLACE HAND HOLES AFFECTED BY BUMP OUT CONSTRUCTION.
- 2. EMBANKMENT CIP QUANTITIES INCLUDES ALL WORK AND MATERIALS TO CONSTRUCT, EXTEND BUMP OUT, SIDEWALK, AND CURB THROUGH SUBBASE.
- 3. ALL CURB AND GUTTER IS TO BE HIGH EARLY CONCRETE.
- 4. ALL SIDEWALK AND RAMPS TO BE CONSTRUCTED WITH HIGH EARLY FIBER-MESH REINFORCED CONCRETE.
- 5. AT ALL INTERSECTIONS INSTALL GEO-SYNTHETIC PAVING LAYER WITHIN DIVISION ST. ONLY. DO NOT PLACE IN LEGS OF SIDE INTERSECTIONS.
- 6. ON WILLIAM AND DIVISION INTERSECTION QUADRANTS ONLY, DETECTABLE WARNING SURFACE (DWS) SHALL BE CAST IRON. (80 SFT).


KEY	DESCRIPTION
АА	TEMP LOWERING EXISTING STRUCTURE ADJUST STRUCTURE COVER
АВ	TEMP LOWERING EXISTING STRUCTURE ADJUST GATE VALE BOX OR ADJUST MONUMENT BOX
ADJ	ADJUST STRUCTURE COVER
АК	ADJUST STRUCTURE COVER
C6	REMOVE CONCRETE SIDEWALK – ANY THICKNESS SIDEWALK, CONC, 6 INCH
С8	REMOVE CONCRETE SIDEWALK – ANY THICKNESS SIDEWALK, CONC, 8 INCH
C8R	SIDEWALK RAMP, CONC, 8 INCH
CR	REMOVE CONCRETE SIDEWALK – ANY THICKNESS
C/G	AGGREGATE BASE, 8 INCH, 21AA CURB AND GUTTER, CONC, BARRIER
CGR	REMOVE CONCRETE CURB AND GUTTER - ANY TYPE
CGRP	REMOVE CONCRETE CURB AND GUTTER – ANY TYPE AGGREGATE BASE, 8 INCH, 21AA CURB AND GUTTER, CONC, BARRIER OR DRIVE OPENING, CONC, TYPE M
DS	STORM SEWER STRUCTURE, REMOVE STORM SEWER PIPE, LESS THAN 24 INCH, REMOVE STORM SEWER, RCP, 12 INCH & SD-TR-1 SINGLE INLET OR DOUBLE INLET STRUCTURE COVER
DWS	DETECTABLE WARNING SURFACE
FD	AGGREGATE BASE, 8 INCH, 21AA HMA, 3E3
н	HMA, WEDGING, 36A
PT	POINT EXISTING STRUCTURE
RCP	HMA SURFACE, REM REMOVE CONCRETE PAVEMENT – ANY THICKNESS
RRA	TEMP LOWERING EXISTING STRUCTURE STRUCTURE COVER ADJUST STRUCTURE COVER
SR	SLOPE RESTORATION

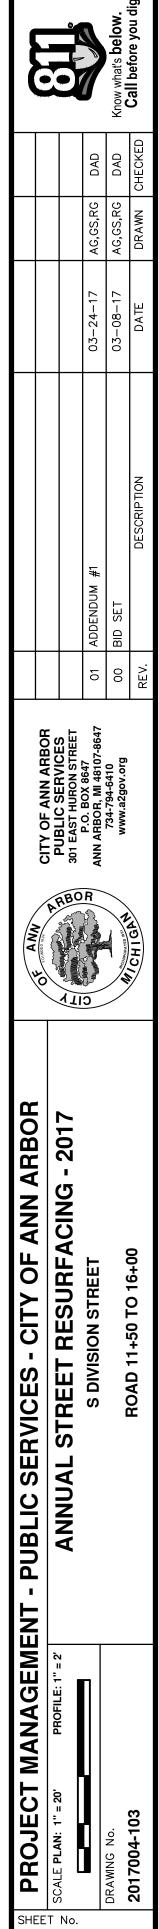

103 OF 136


870

<mark>860 8</mark>

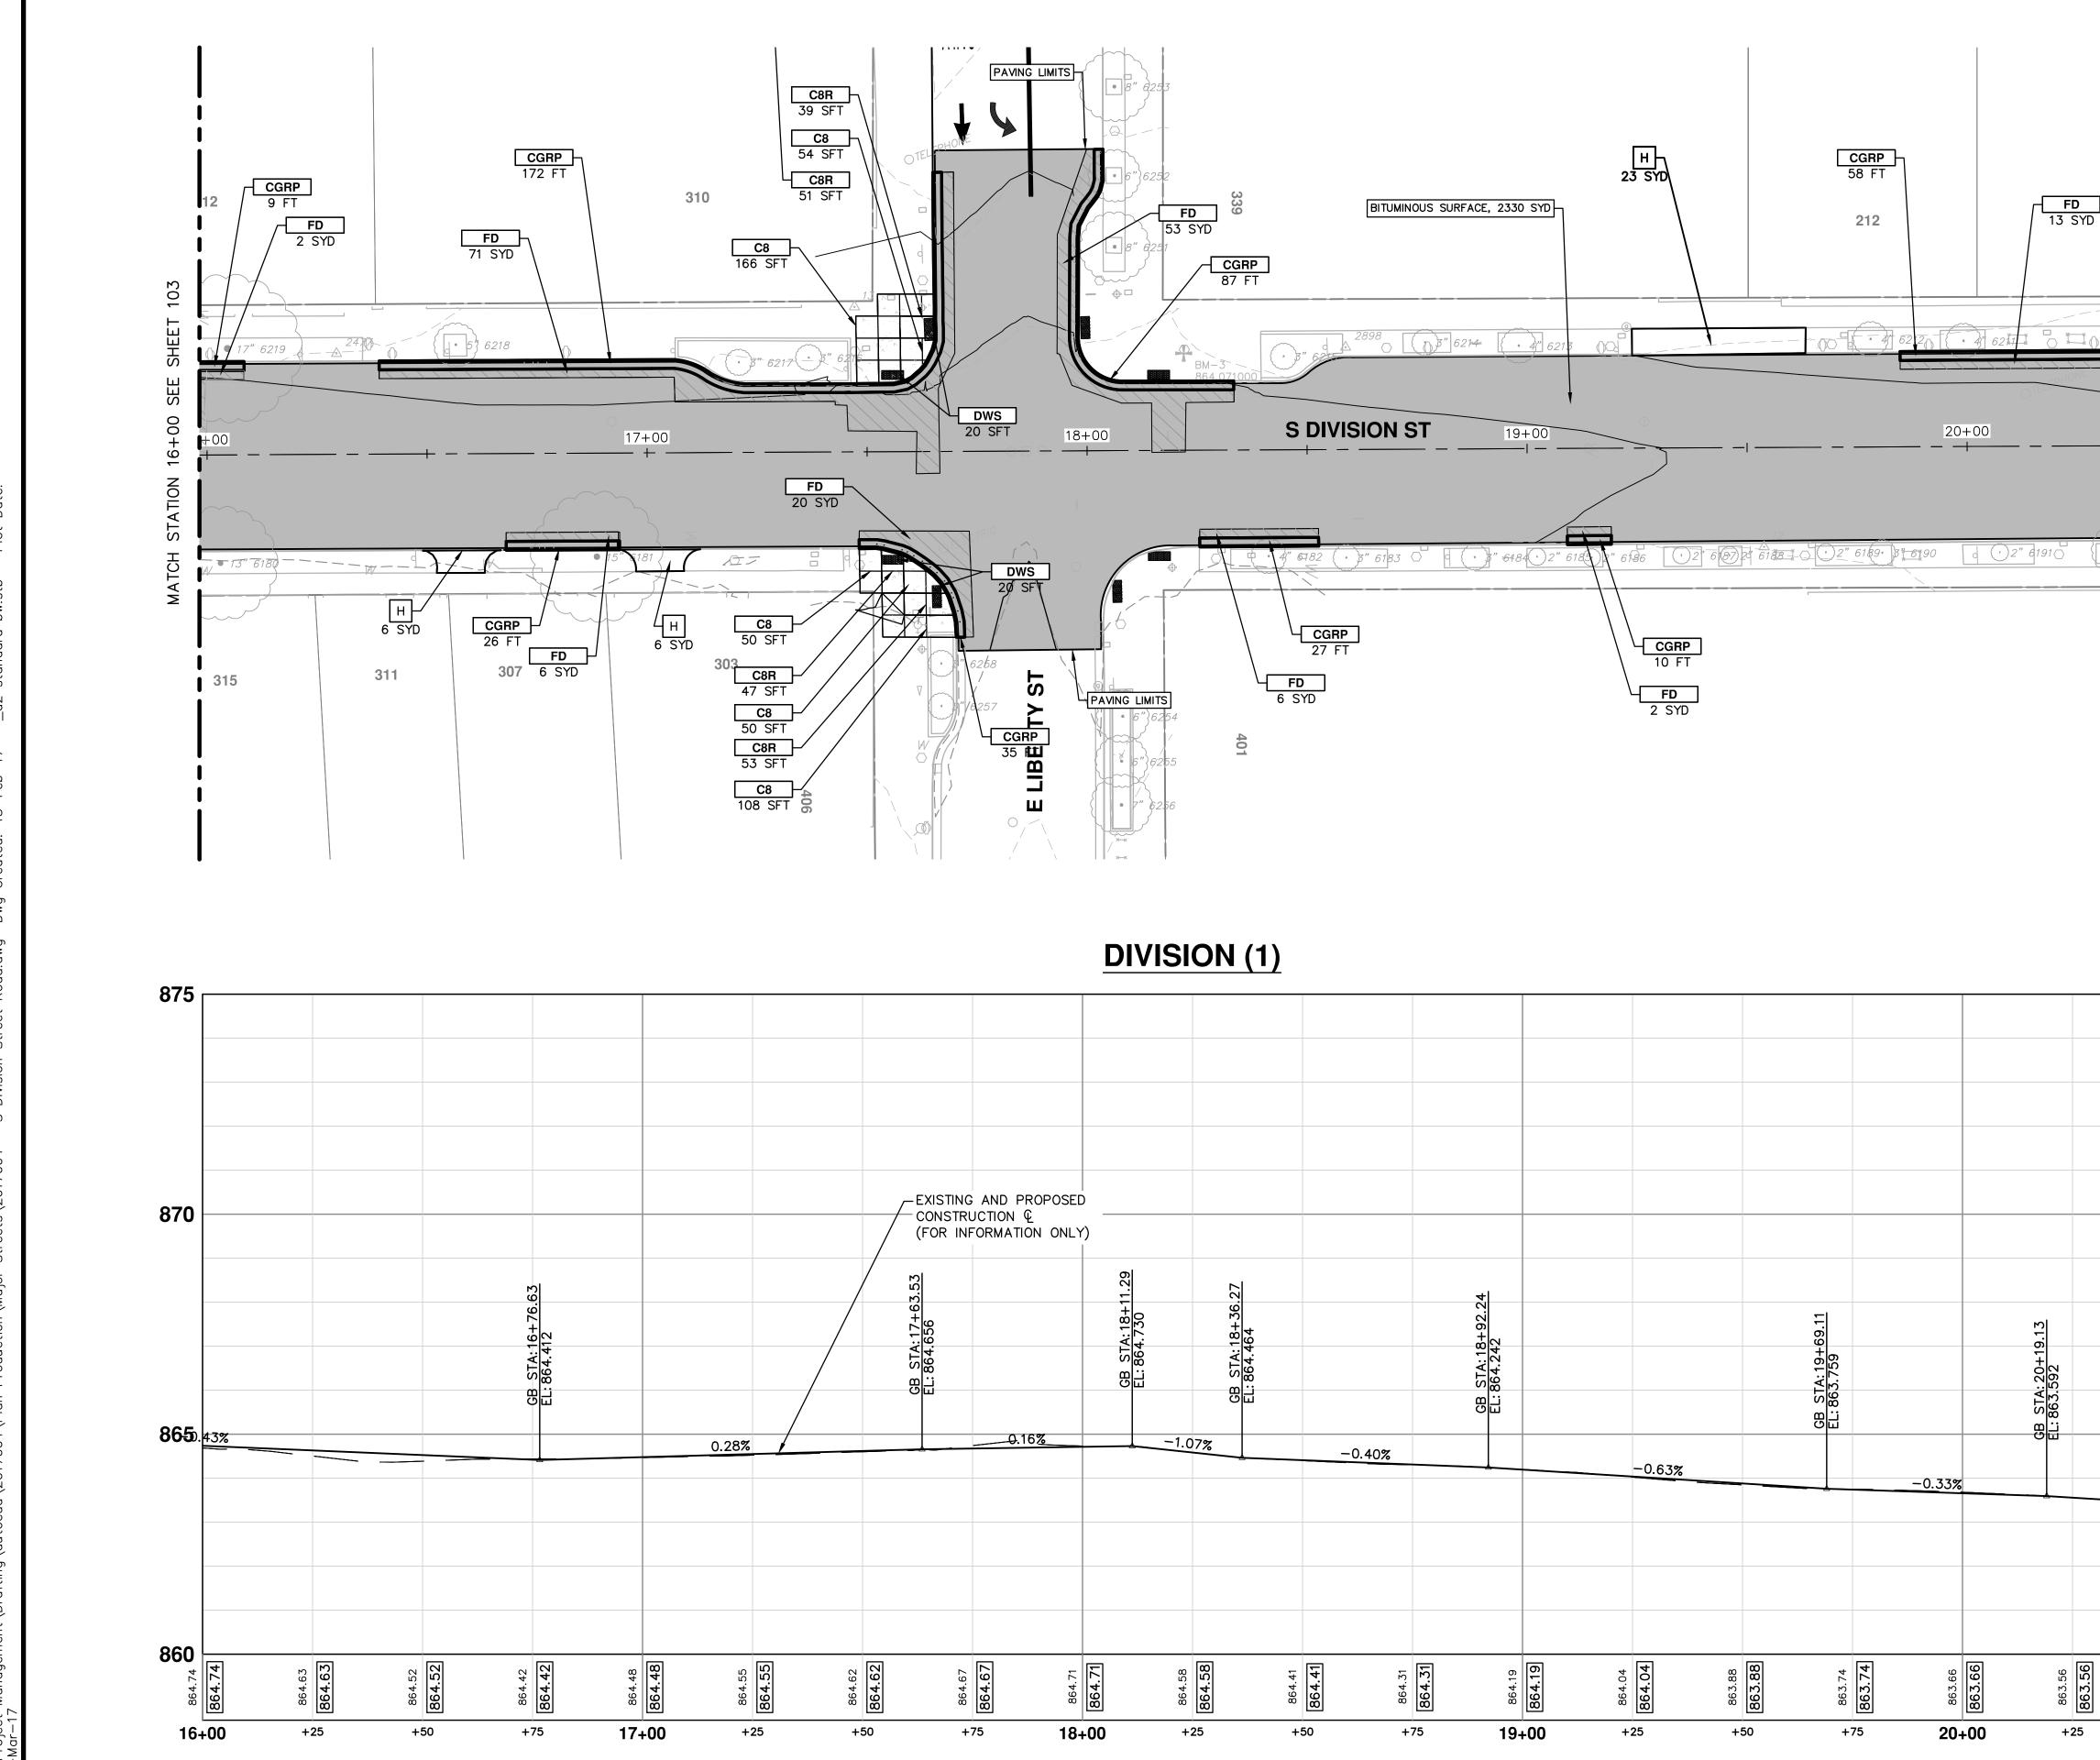

+75 19+00 +25 +50 +75 20+00 +25
864.31 864.19 864.19 864.19 864.04 863.88 863.88 863.66 863.74 863.74 863.66 863.66 863.66 863.66 863.56 863.56 863.56 863.56
$ \begin{bmatrix} 1 & 1 \\ 1 & 2 \\ 1$
CB STA:18+92.24 EL:864.242 EL:864.242 EL:863.759 EL:863.759 EL:863.592 EL:863.592
Image: second



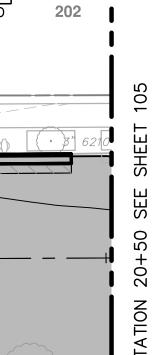

• 6"{619

Ś

Ц Ц

∢


Σ

875 ⊓

NOTES

- 1. QUANTITIES FOR HAND HOLES HAVE BEEN PROVIDED TO REPLACE HAND HOLES AFFECTED BY BUMP OUT CONSTRUCTION.
- 2. EMBANKMENT CIP QUANTITIES INCLUDES ALL WORK AND MATERIALS TO CONSTRUCT, EXTEND BUMP OUT, SIDEWALK, AND CURB THROUGH SUBBASE.
- 3. ALL CURB AND GUTTER IS TO BE HIGH EARLY CONCRETE.
- ALL SIDEWALK AND RAMPS TO BE CONSTRUCTED WITH HIGH EARLY FIBER-MESH REINFORCED CONCRETE.
- 5. AT ALL INTERSECTIONS INSTALL GEO-SYNTHETIC PAVING LAYER WITHIN DIVISION ST. ONLY. DO NOT PLACE IN LEGS OF SIDE INTERSECTIONS.


	CONSTRUCTION KEY
KEY	DESCRIPTION
АА	TEMP LOWERING EXISTING STRUCTURE ADJUST STRUCTURE COVER
AB	TEMP LOWERING EXISTING STRUCTURE ADJUST GATE VALE BOX OR ADJUST MONUMENT BOX
ADJ	ADJUST STRUCTURE COVER
AK	ADJUST STRUCTURE COVER
C6	REMOVE CONCRETE SIDEWALK – ANY THICKNESS SIDEWALK, CONC, 6 INCH
C8	REMOVE CONCRETE SIDEWALK – ANY THICKNESS SIDEWALK, CONC, 8 INCH
C8R	SIDEWALK RAMP, CONC, 8 INCH
CR	REMOVE CONCRETE SIDEWALK – ANY THICKNESS
C/G	AGGREGATE BASE, 8 INCH, 21AA CURB AND GUTTER, CONC, BARRIER
CGR	REMOVE CONCRETE CURB AND GUTTER - ANY TYPE
CGRP	REMOVE CONCRETE CURB AND GUTTER – ANY TYPE AGGREGATE BASE, 8 INCH, 21AA CURB AND GUTTER, CONC, BARRIER OR DRIVE OPENING, CONC, TYPE M
DS	STORM SEWER STRUCTURE, REMOVE STORM SEWER PIPE, LESS THAN 24 INCH, REMOVE STORM SEWER, RCP, 12 INCH & SD-TR-1 SINGLE INLET OR DOUBLE INLET STRUCTURE COVER
DWS	DETECTABLE WARNING SURFACE
FD	AGGREGATE BASE, 8 INCH, 21AA HMA, 3E3
Н	HMA, WEDGING, 36A
PT	POINT EXISTING STRUCTURE
RCP	HMA SURFACE, REM REMOVE CONCRETE PAVEMENT – ANY THICKNESS
RRA	TEMP LOWERING EXISTING STRUCTURE STRUCTURE COVER ADJUST STRUCTURE COVER
SR	SLOPE RESTORATION

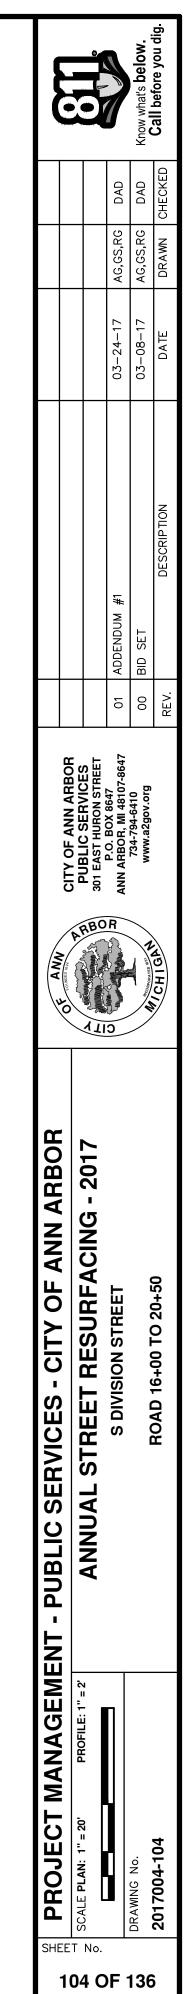


870 865 -0.61%

863.40 863.40**8**

20+50

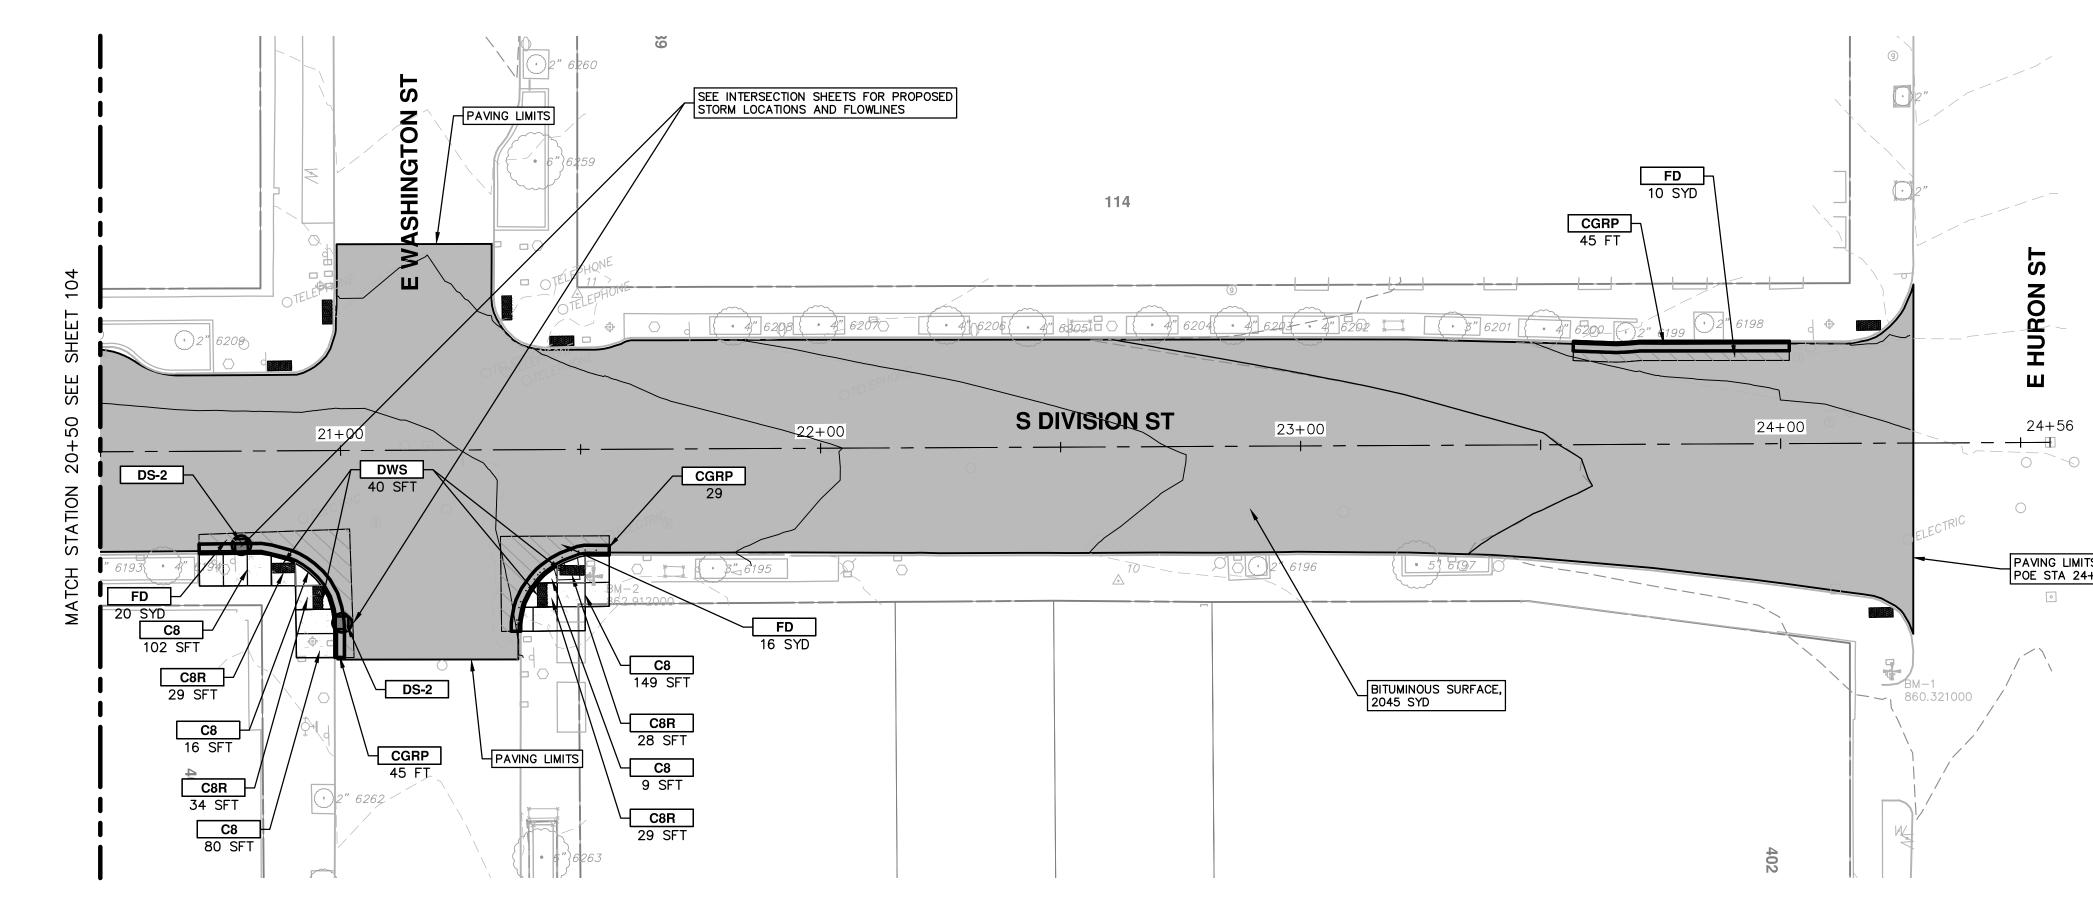

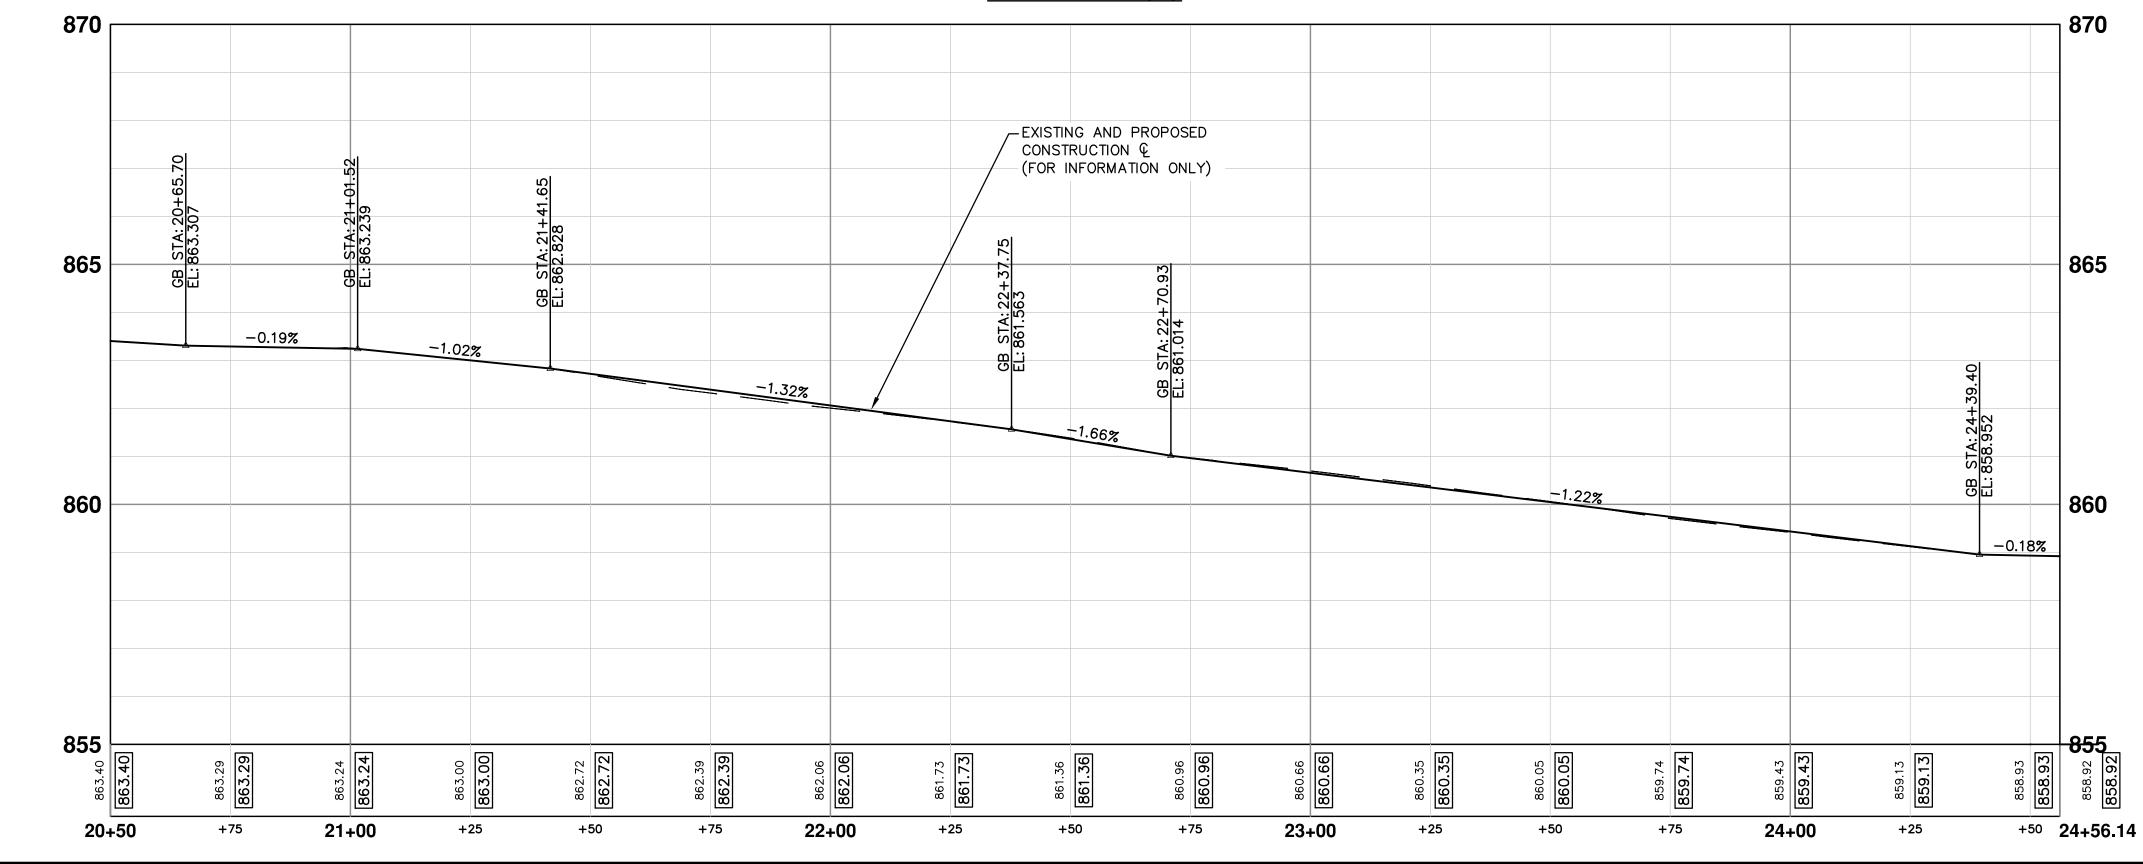


DIVISION (1)

NOTES


- 1. QUANTITIES FOR HAND HOLES HAVE BEEN PROVIDED TO REPLACE HAND HOLES AFFECTED BY BUMP OUT CONSTRUCTION.
- 2. EMBANKMENT CIP QUANTITIES INCLUDES ALL WORK AND MATERIALS TO CONSTRUCT, EXTEND BUMP OUT, SIDEWALK, AND CURB THROUGH SUBBASE.
- 3. ALL CURB AND GUTTER IS TO BE HIGH EARLY CONCRETE.
- 4. ALL SIDEWALK AND RAMPS TO BE CONSTRUCTED WITH HIGH EARLY FIBER-MESH REINFORCED CONCRETE.
- 5. AT ALL INTERSECTIONS INSTALL GEO-SYNTHETIC PAVING LAYER WITHIN DIVISION ST. ONLY. DO NOT PLACE IN LEGS OF SIDE INTERSECTIONS.

TS	
4+28	


	CONSTRUCTION KEY
KEY	DESCRIPTION
AA	TEMP LOWERING EXISTING STRUCTURE ADJUST STRUCTURE COVER
AB	TEMP LOWERING EXISTING STRUCTURE ADJUST GATE VALE BOX OR ADJUST MONUMENT BOX
ADJ	ADJUST STRUCTURE COVER
AK	ADJUST STRUCTURE COVER
C6	REMOVE CONCRETE SIDEWALK – ANY THICKNESS SIDEWALK, CONC, 6 INCH
C8	REMOVE CONCRETE SIDEWALK – ANY THICKNESS SIDEWALK, CONC, 8 INCH
C8R	SIDEWALK RAMP, CONC, 8 INCH
CR	REMOVE CONCRETE SIDEWALK – ANY THICKNESS
C/G	AGGREGATE BASE, 8 INCH, 21AA CURB AND GUTTER, CONC, BARRIER
CGR	REMOVE CONCRETE CURB AND GUTTER - ANY TYPE
CGRP	REMOVE CONCRETE CURB AND GUTTER – ANY TYPE AGGREGATE BASE, 8 INCH, 21AA CURB AND GUTTER, CONC, BARRIER OR DRIVE OPENING, CONC, TYPE M
DS	STORM SEWER STRUCTURE, REMOVE STORM SEWER PIPE, LESS THAN 24 INCH, REMOVE STORM SEWER, RCP, 12 INCH & SD-TR-1 SINGLE INLET OR DOUBLE INLET STRUCTURE COVER
DWS	DETECTABLE WARNING SURFACE
FD	AGGREGATE BASE, 8 INCH, 21AA HMA, 3E3
Н	HMA, WEDGING, 36A
PT	POINT EXISTING STRUCTURE
RCP	HMA SURFACE, REM REMOVE CONCRETE PAVEMENT – ANY THICKNESS
RRA	TEMP LOWERING EXISTING STRUCTURE STRUCTURE COVER ADJUST STRUCTURE COVER
SR	SLOPE RESTORATION

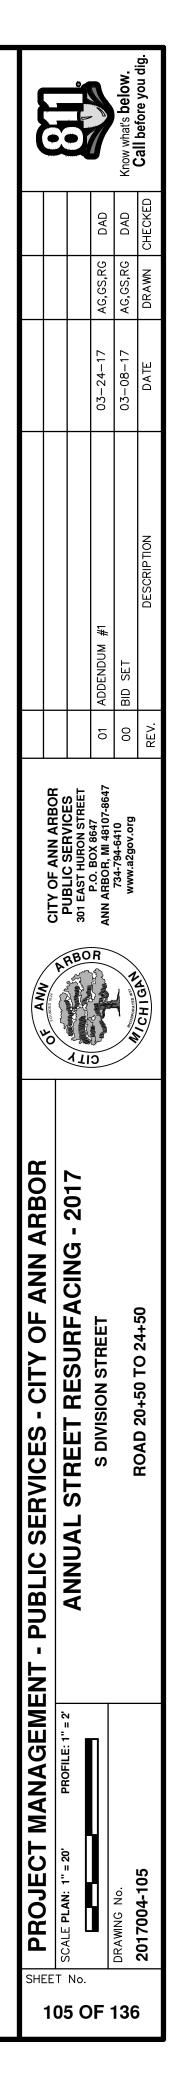


858.92 **85**8.92 **858.92**

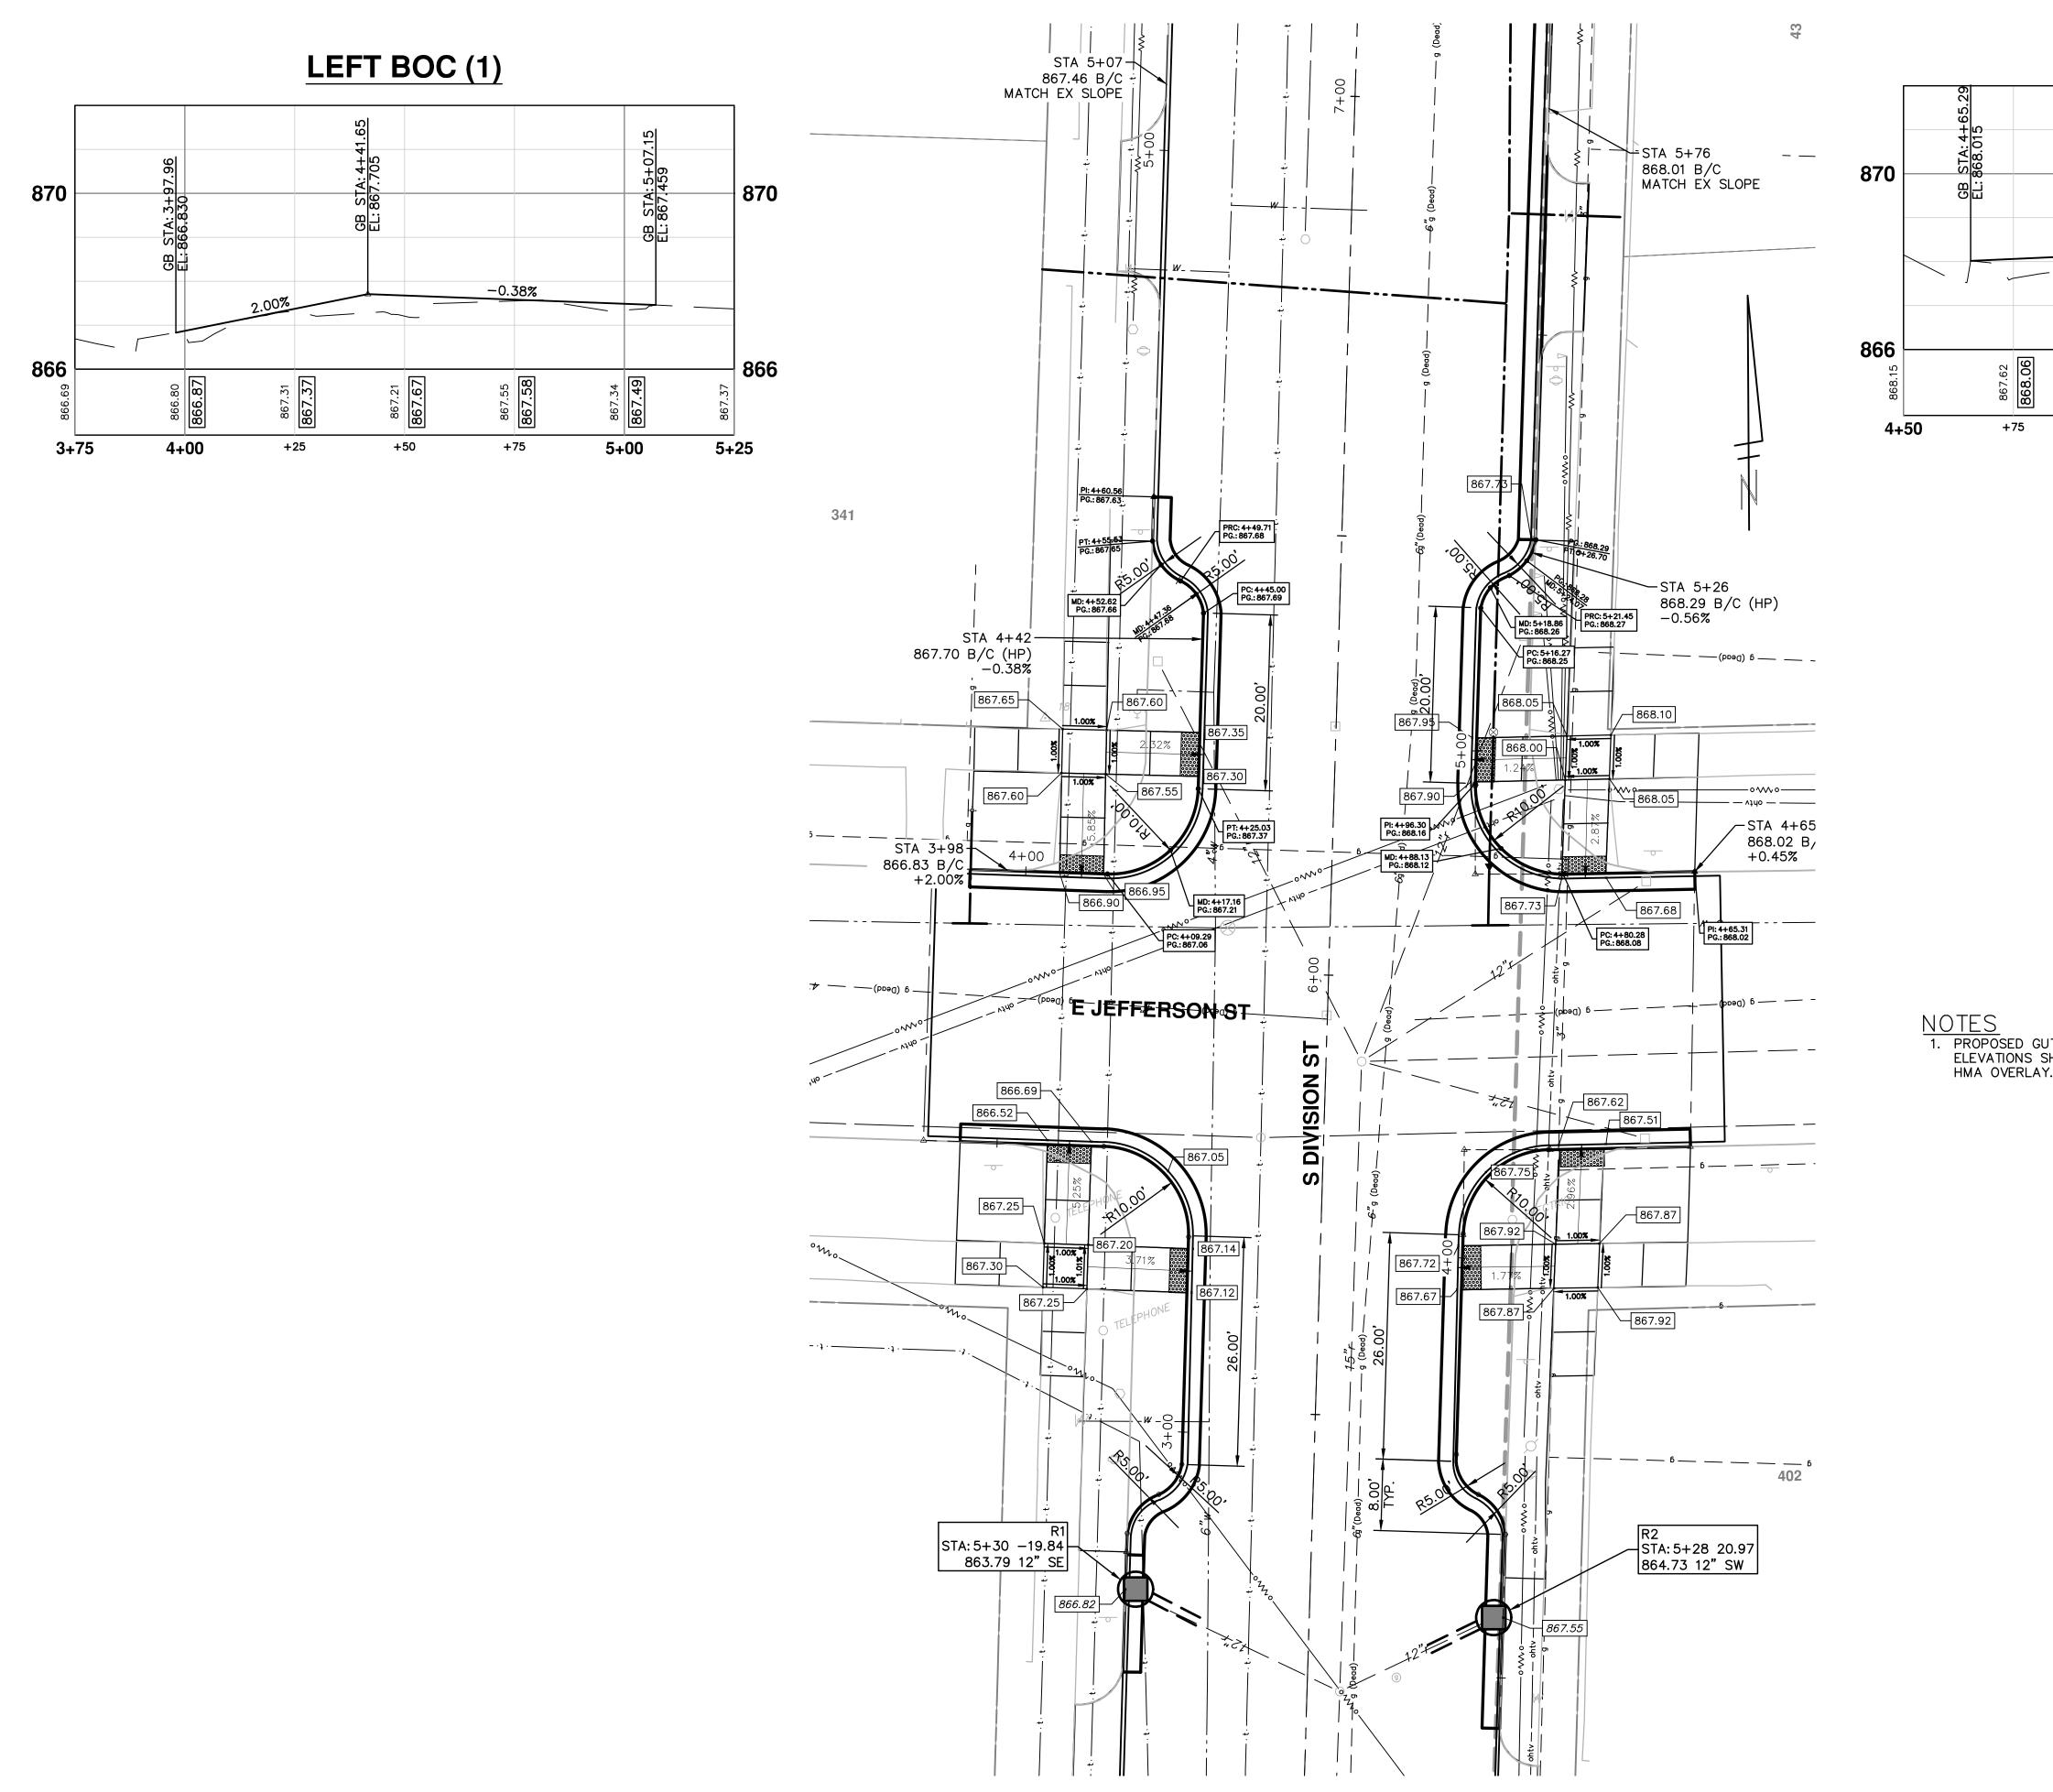




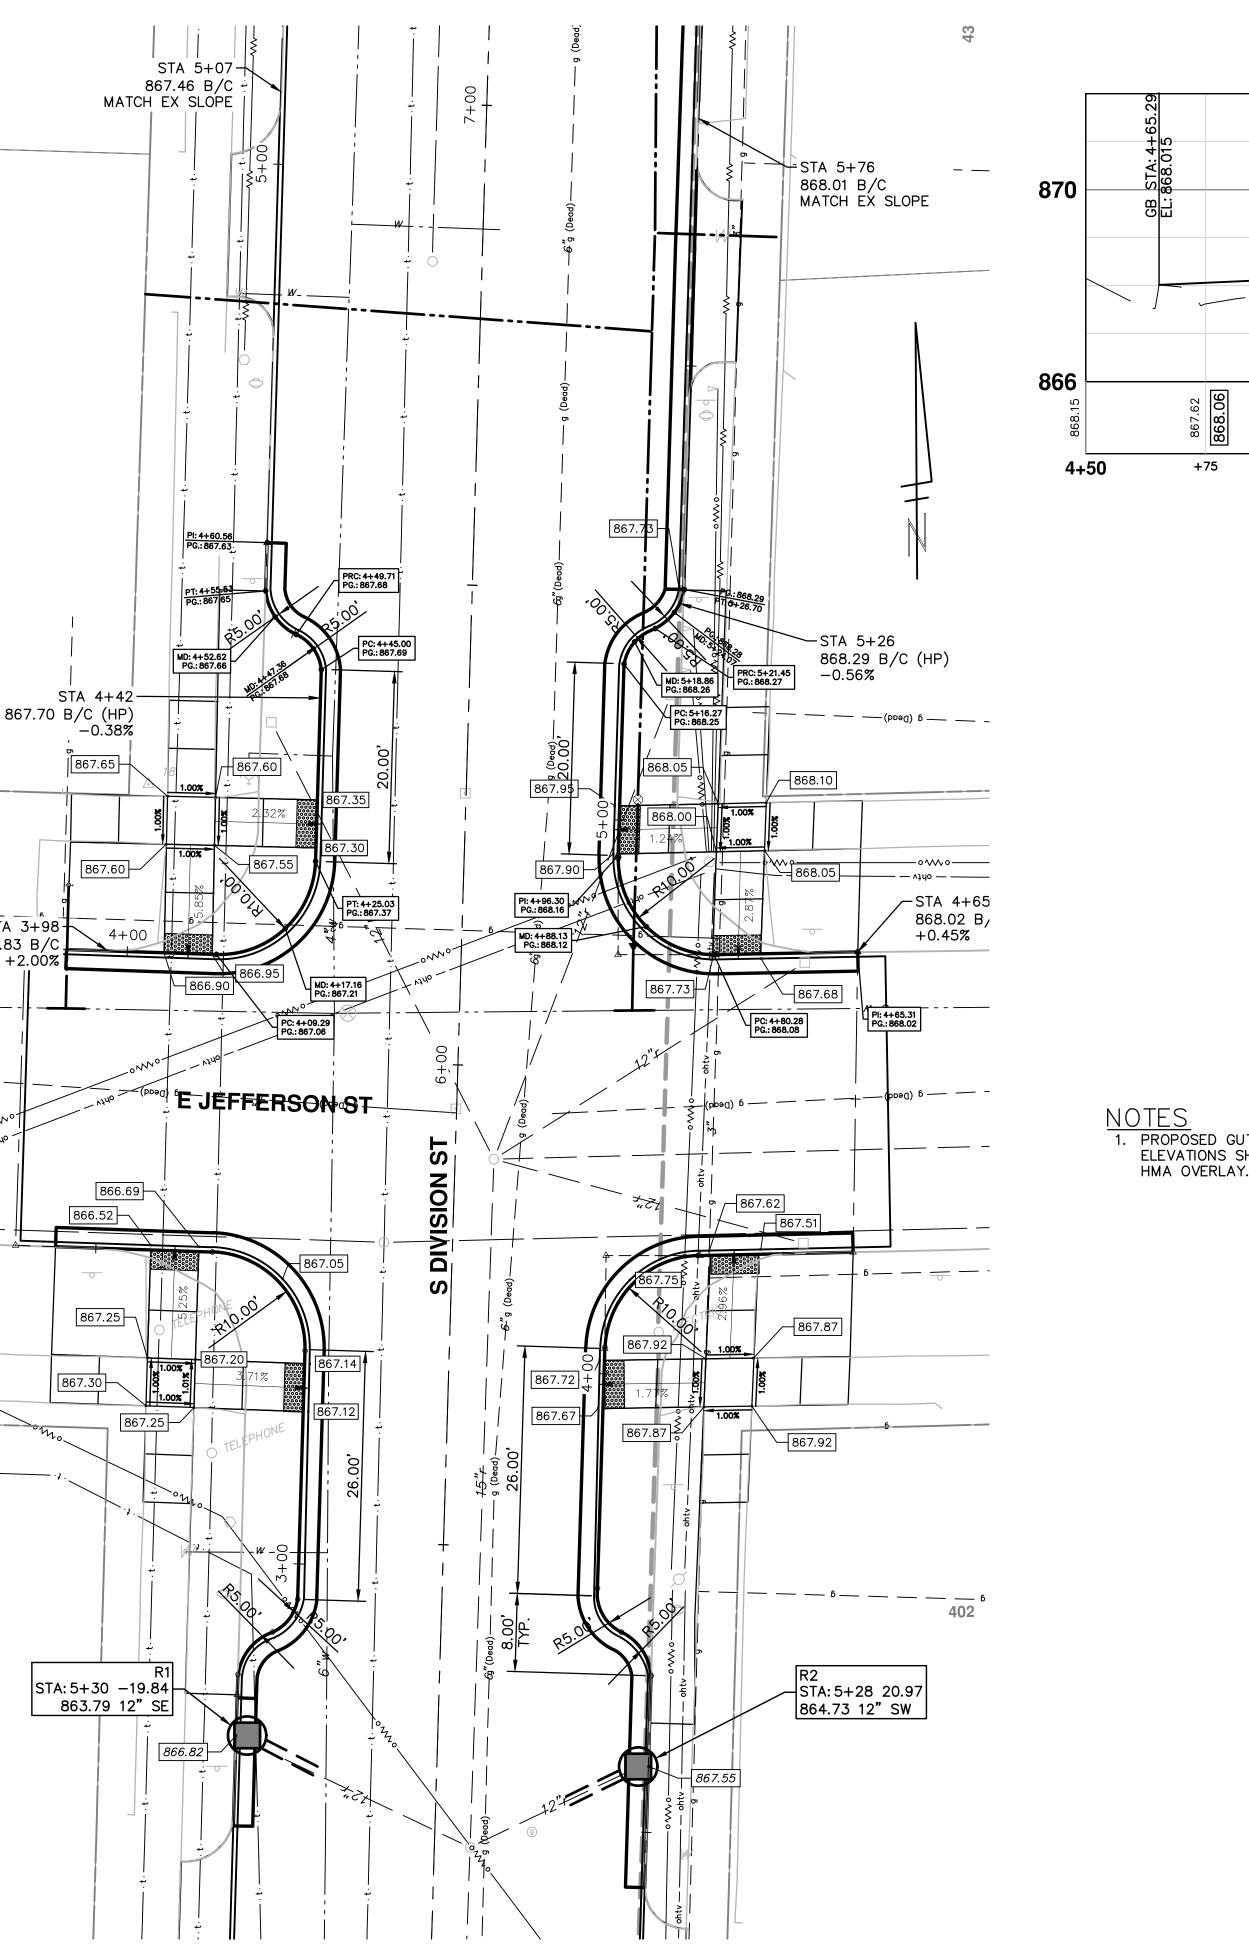

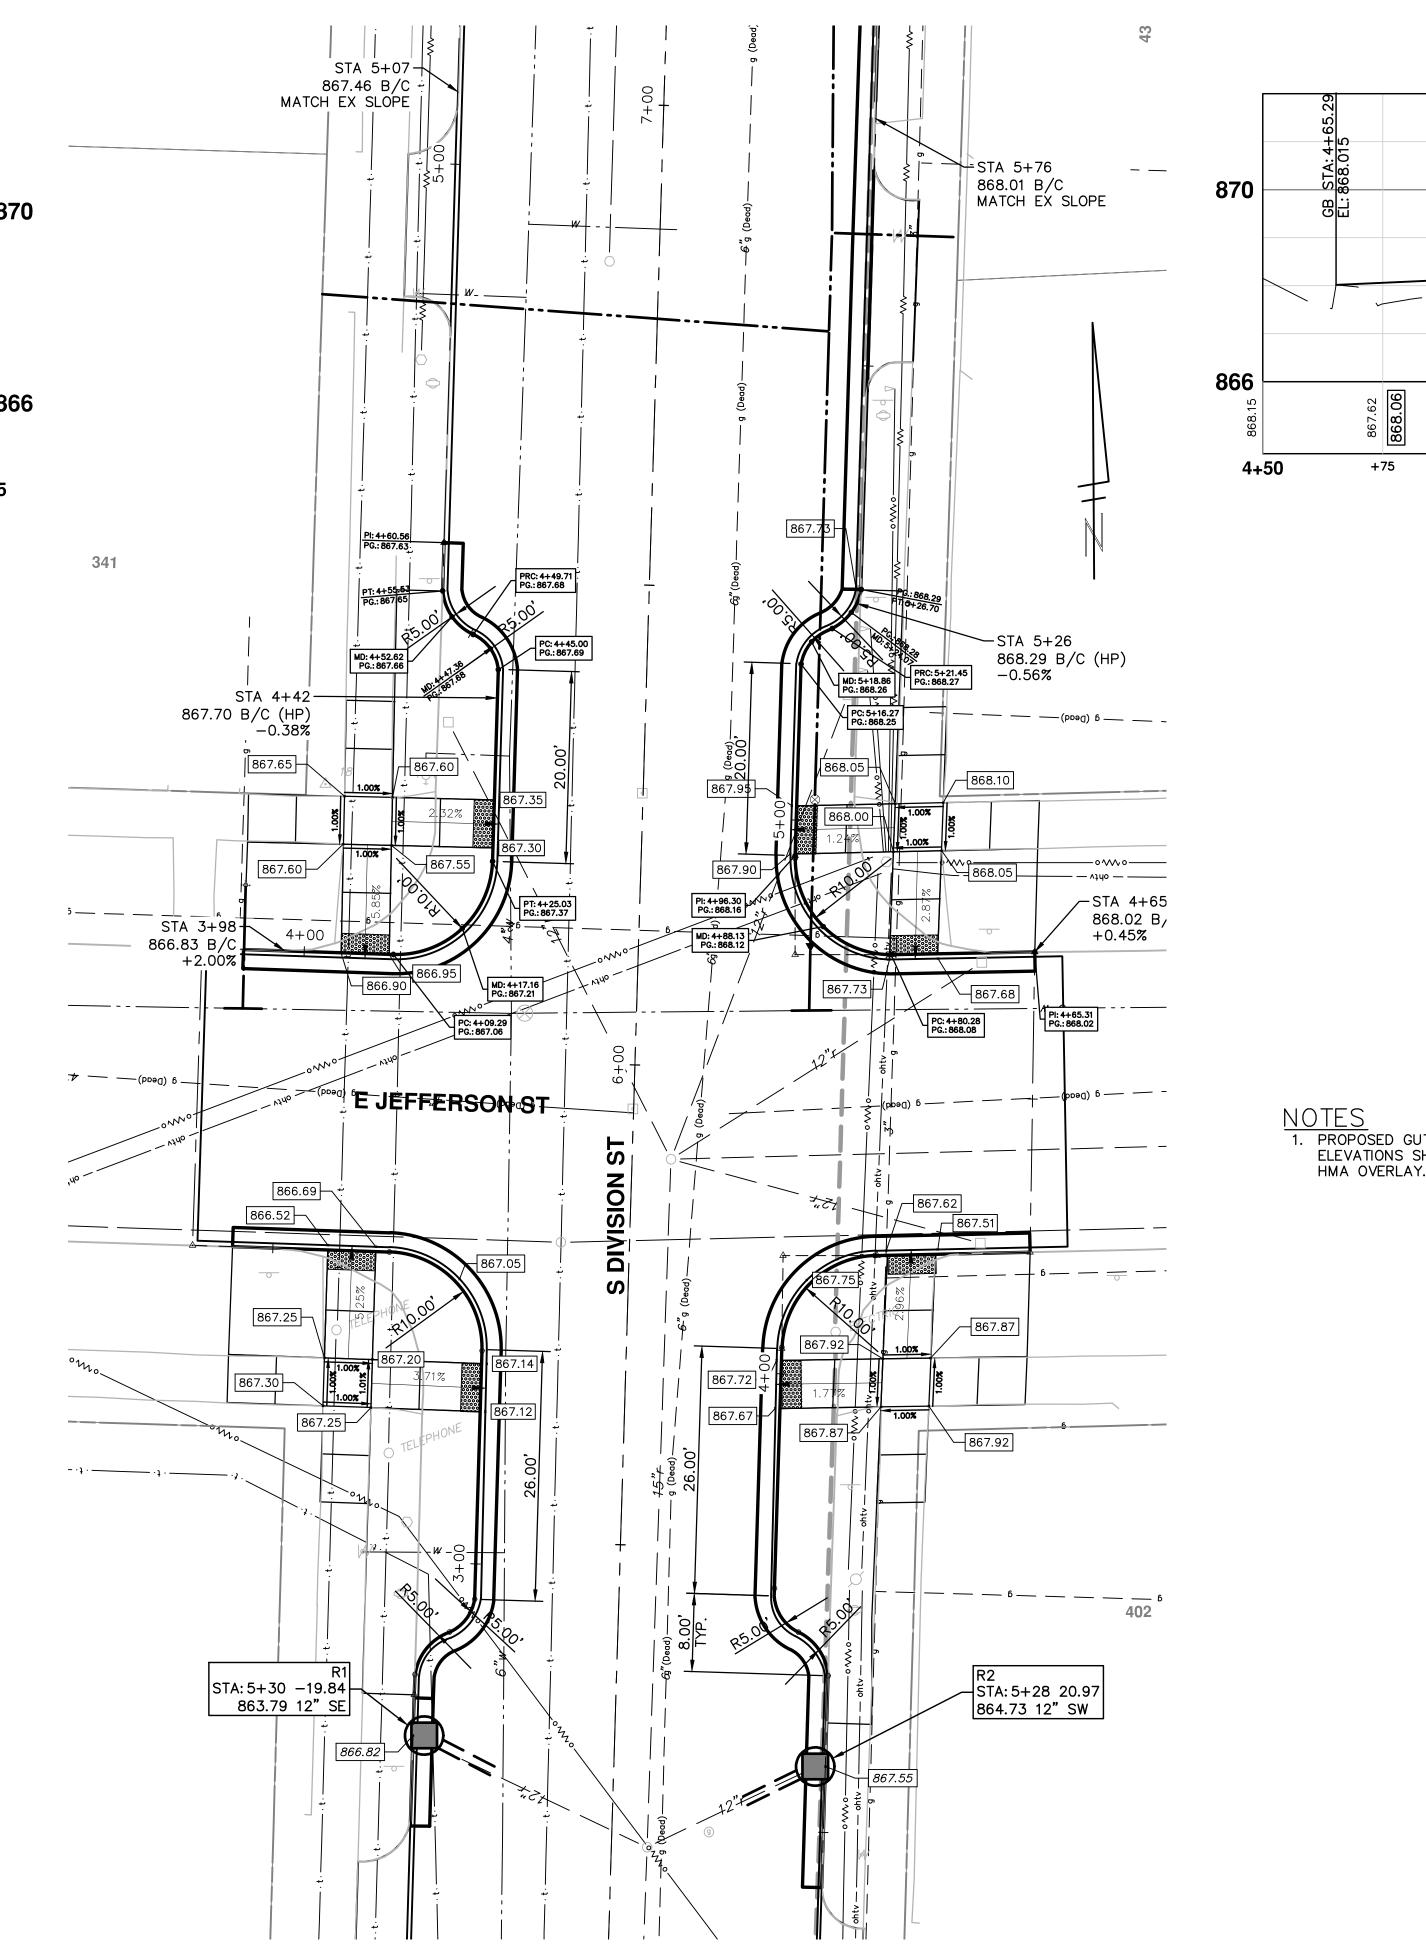

ல்

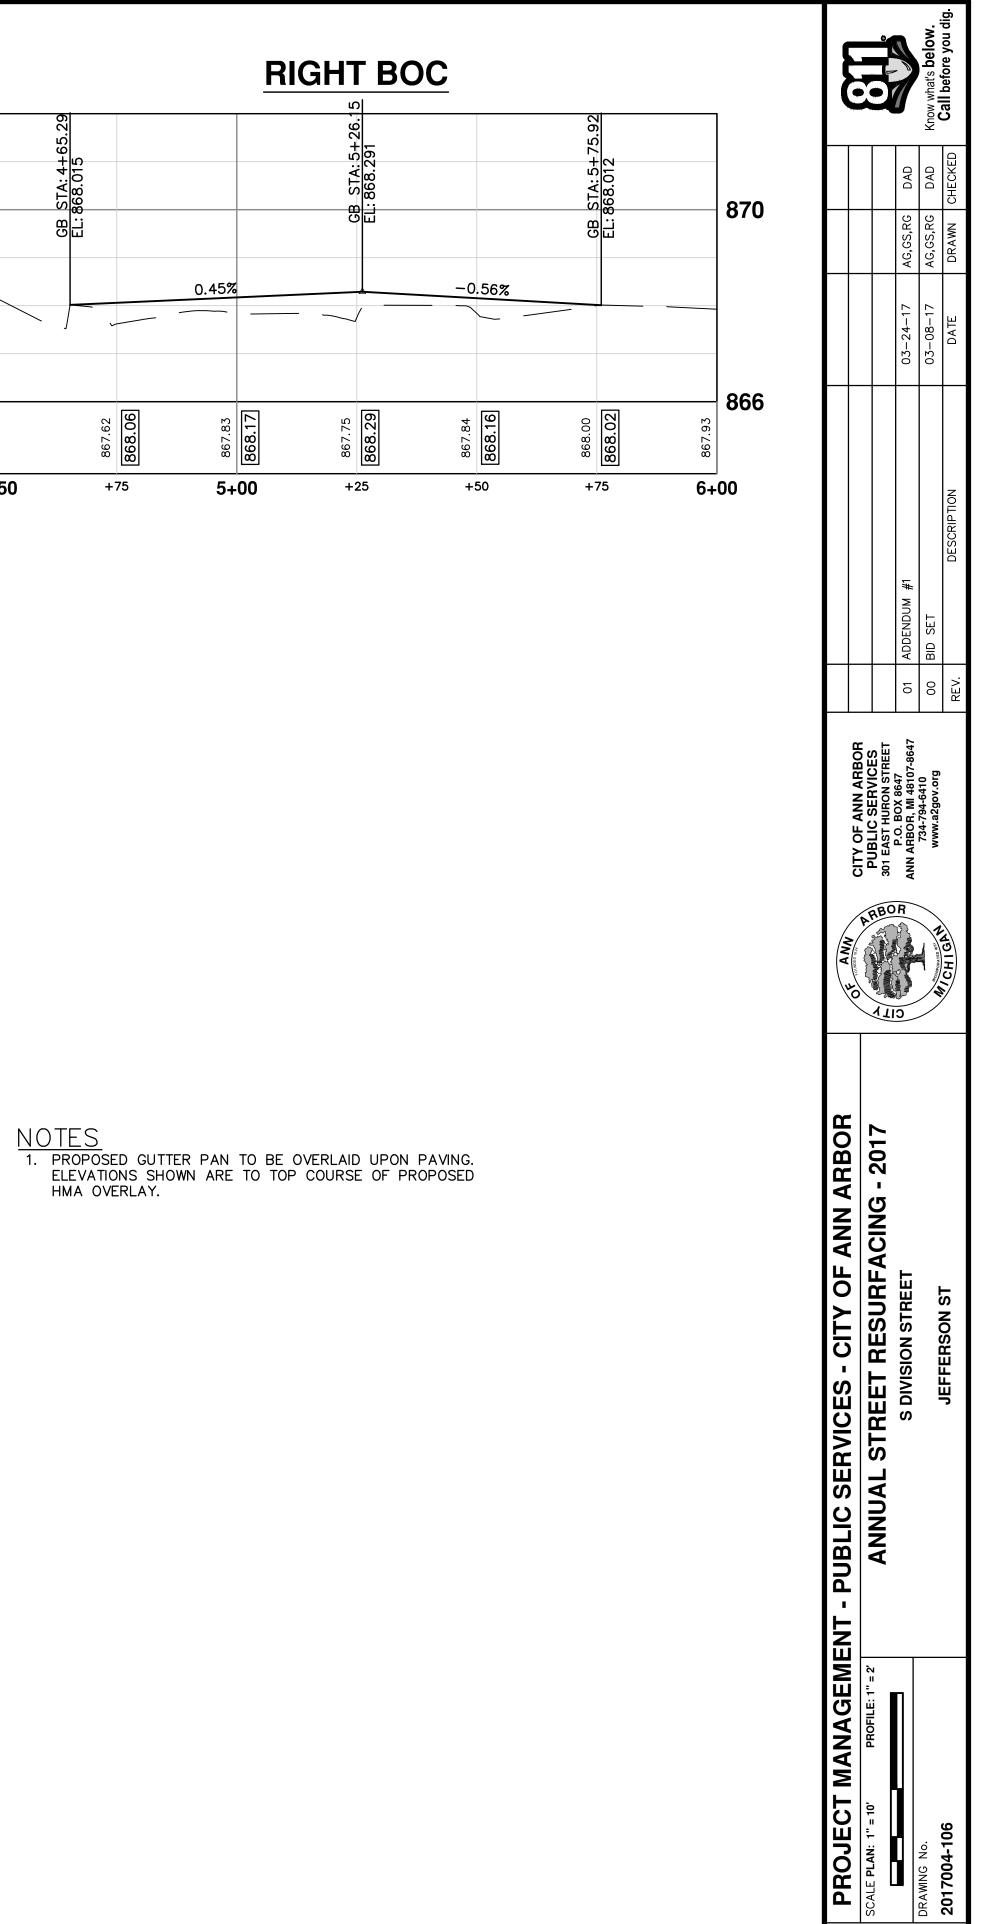


0.45%

867.83 **868.17**

5+00

SHEET No.

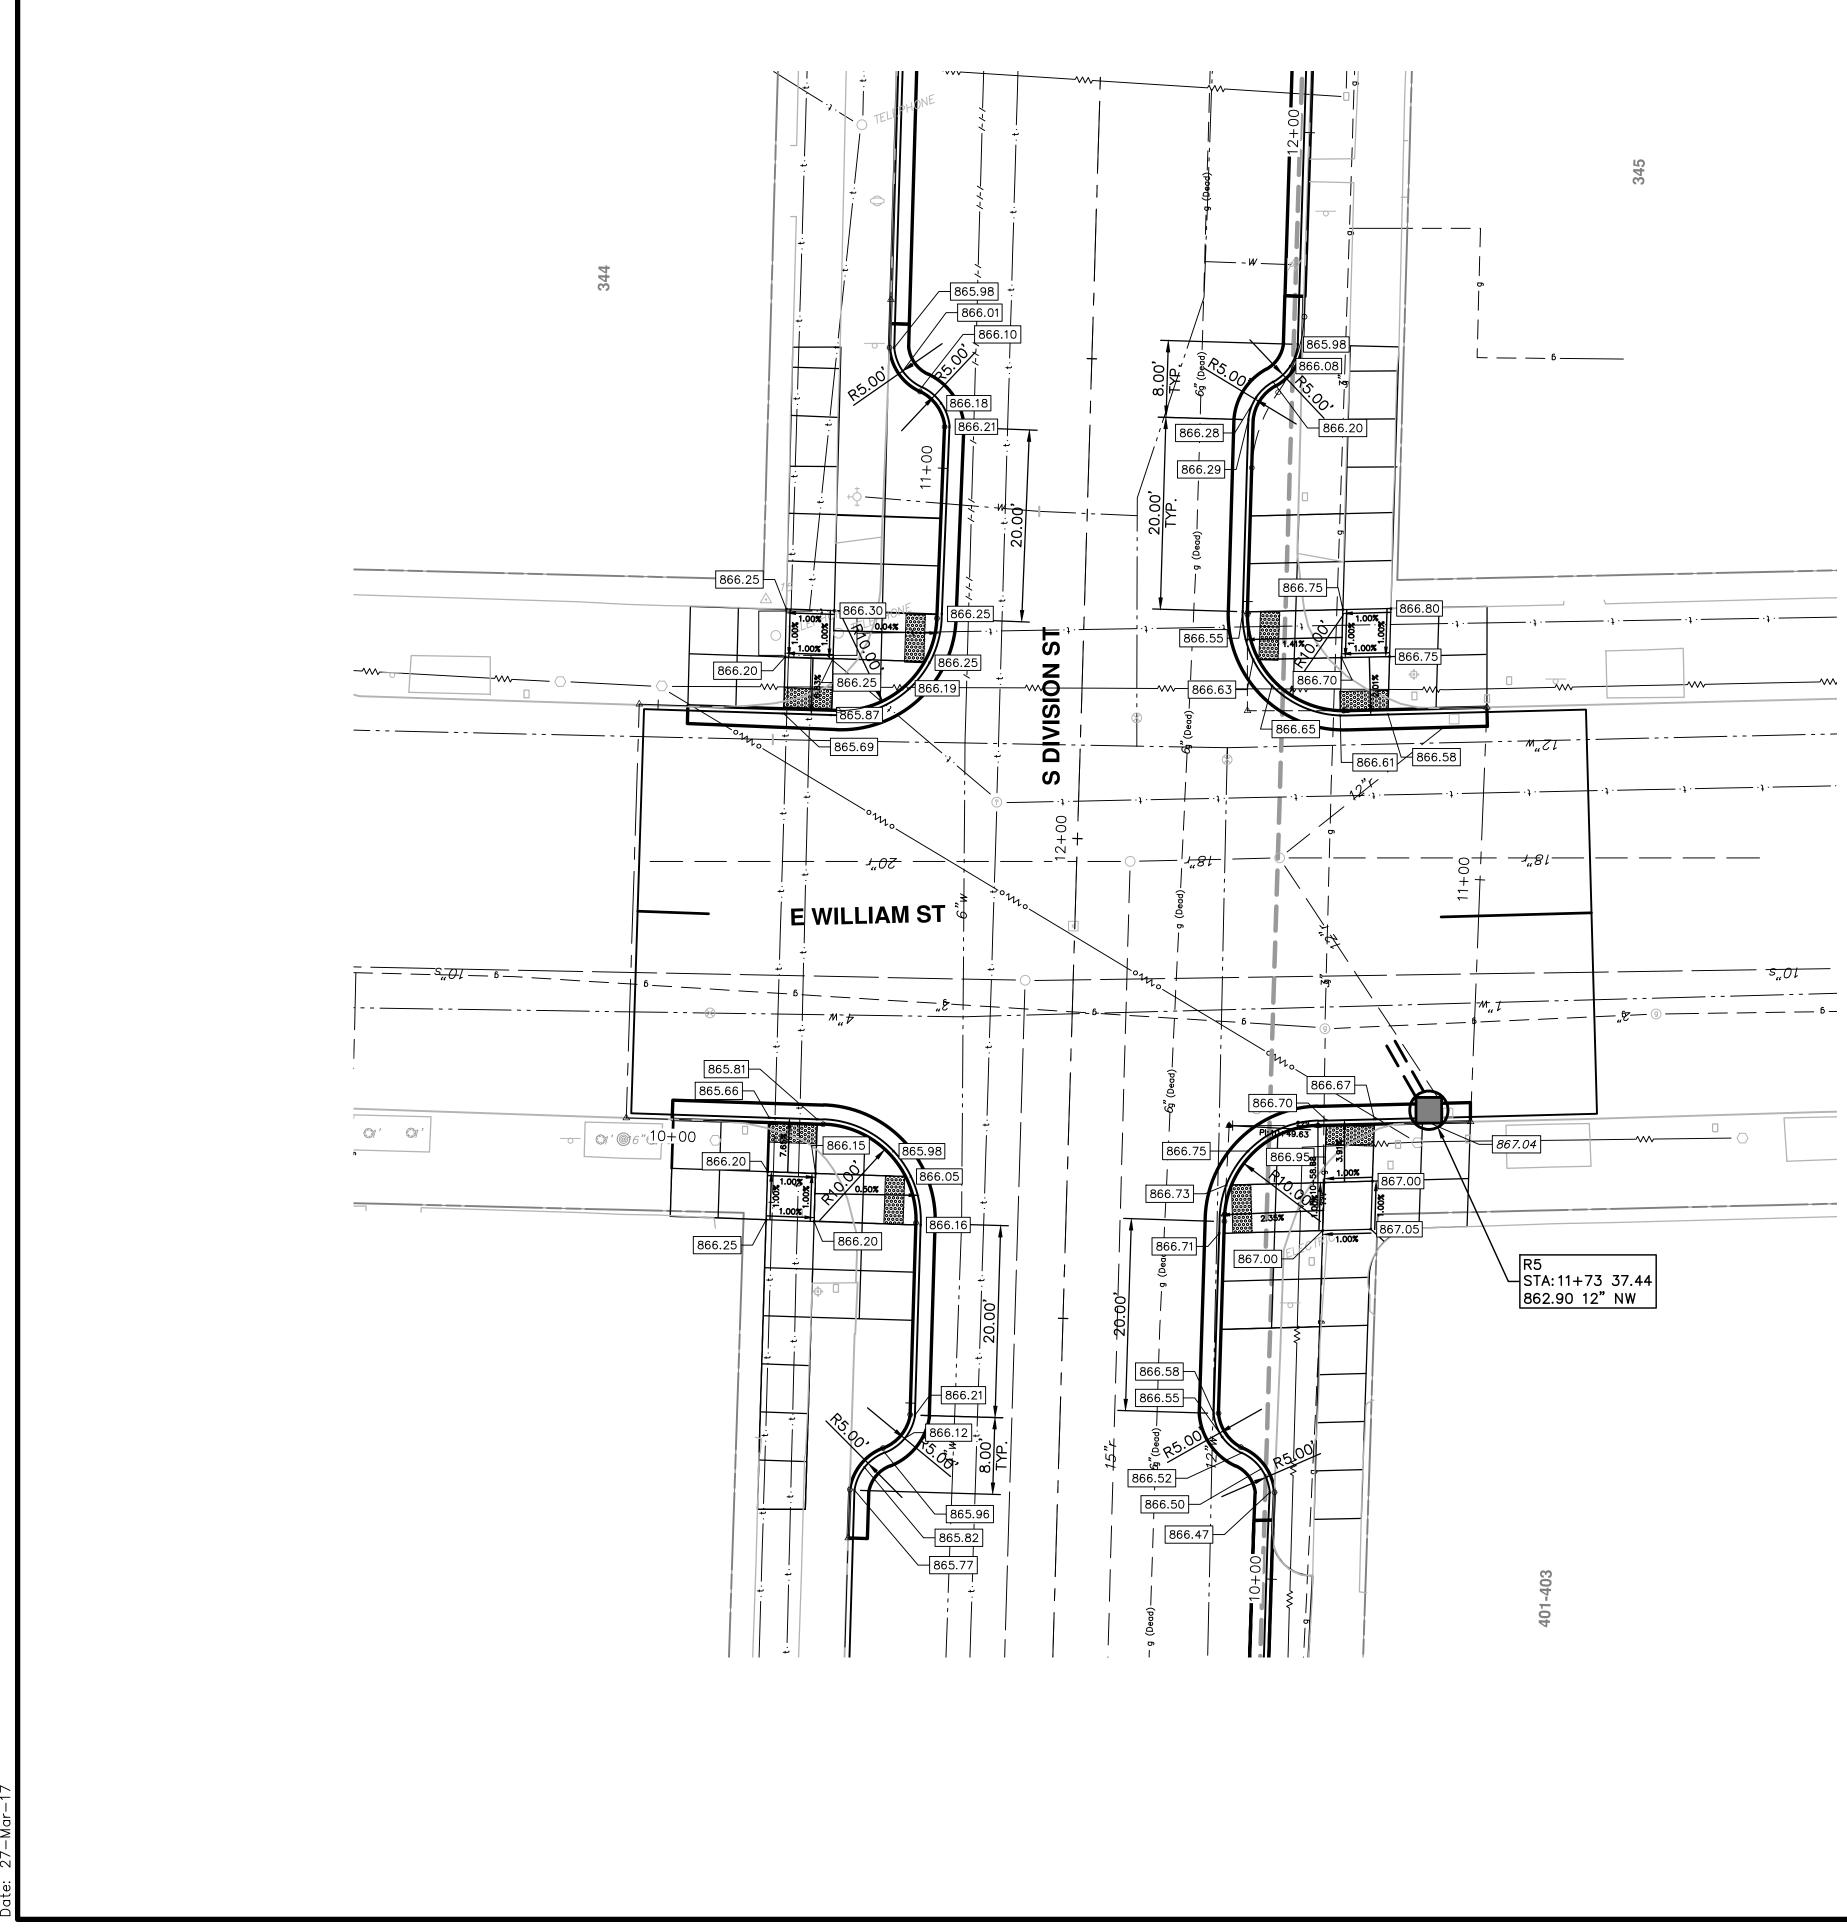



ι.



- <u>NOTES</u> 1. PROPOSED GUTTER PAN TO BE OVERLAID UPON PAVING. ELEVATIONS SHOWN ARE TO TOP COURSE OF PROPOSED HMA OVERLAY.
- 2. ON WILLIAM AND DIVISION INTERSECTION QUADRANTS ONLY, DETECTABLE WARNING SURFACE (DWS) SHALL BE CAST IRON. (80 SFT).


PROJECT MA	NAGEMENT - PUBLIC SERVICES - CITY OF ANN ARBOR	ANN						
SCALE PLAN: 1" = 10'	VINITAL STDEET DECLIDEACING 2017							X
	AINIVAL OTALET REJUNTAVING - 2017	E ST HURON STREET			_			
	S DIVISION STREET	O (2000 8647 P.O. BOX 8647 ANN ARBOR, MI 48107-8647	01	01 ADDENDUM #1	03-24-17	AG,GS,RG	DAD	
DRAWING No.		734-794-6410 www.a2gov.org	00	00 BID SET	03-08-17	AG,GS,RG	DAD	Know what's below.
2017004-107	E WILLIAM SI	CHIGN	REV.	DESCRIPTION	DATE	DRAWN CHECKED	CHECKED	Call before you dig.

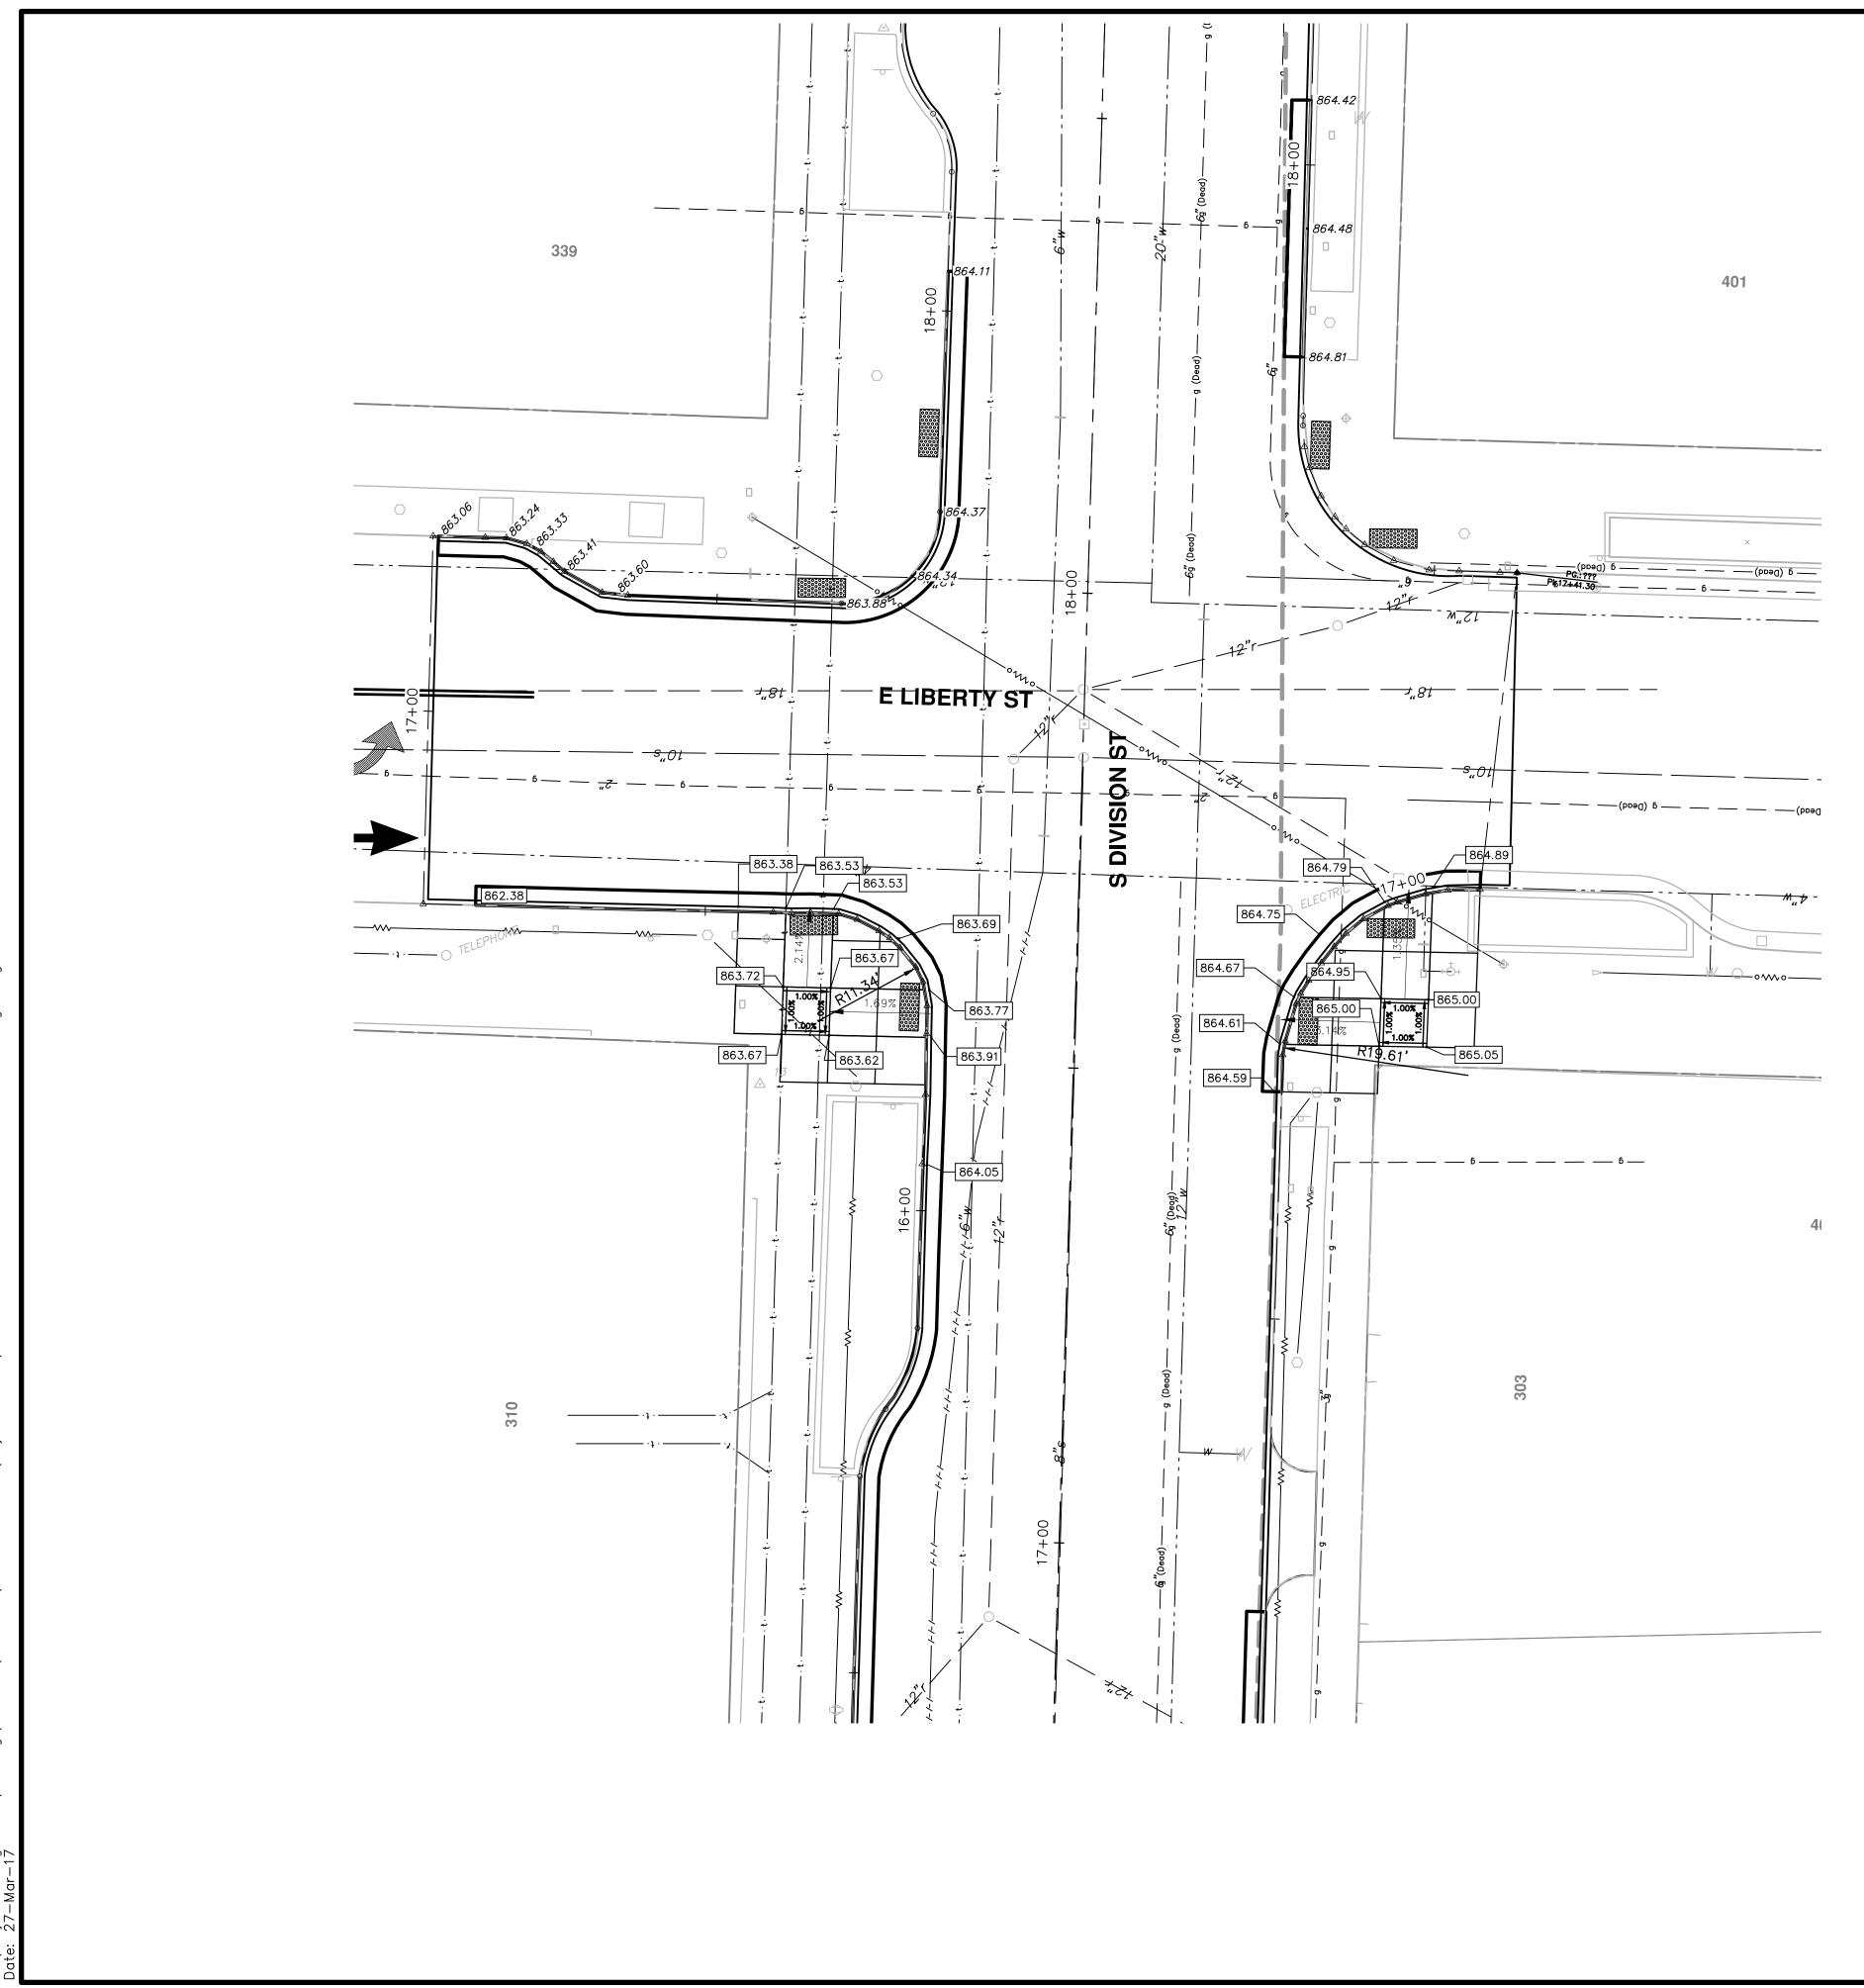


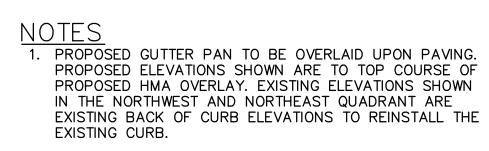

				I					
PROJECT MANAGEM		NAGEMENT - PUBLIC SERVICES - CITY OF ANN ARBOR	AW						
			CITY OF ANN ARROR						
⁴ SCALF PLAN. 1" = 10'	-								
		ANNUAL STREET RESURFACING - 2017							
		S DIVISION STREET	ANN ARBOR, MI 48107-8647	6	01 ADDENDUM #1	03-24-17	AG,GS,RG	DAD	
DRAWING No.			734-794-6410	C	DO BID SET	03-08-17	AG.GS.RG	DAD	Know what's below.
			BIOVORAZIOV.OI	>					
201/004-108		E LIBERTY OI	CHIGH.	REV.	DESCRIPTION	DATE	DRAWN CHECKED	CHECKED	vali perore you aig.


1. PROPOSED GUTTER PAN TO BE OVERLAID UPON PAVING. PROPOSED ELEVATIONS SHOWN ARE TO TOP COURSE OF PROPOSED HMA OVERLAY. EXISTING ELEVATIONS SHOWN IN THE NORTHWEST AND NORTHEAST QUADRANT ARE

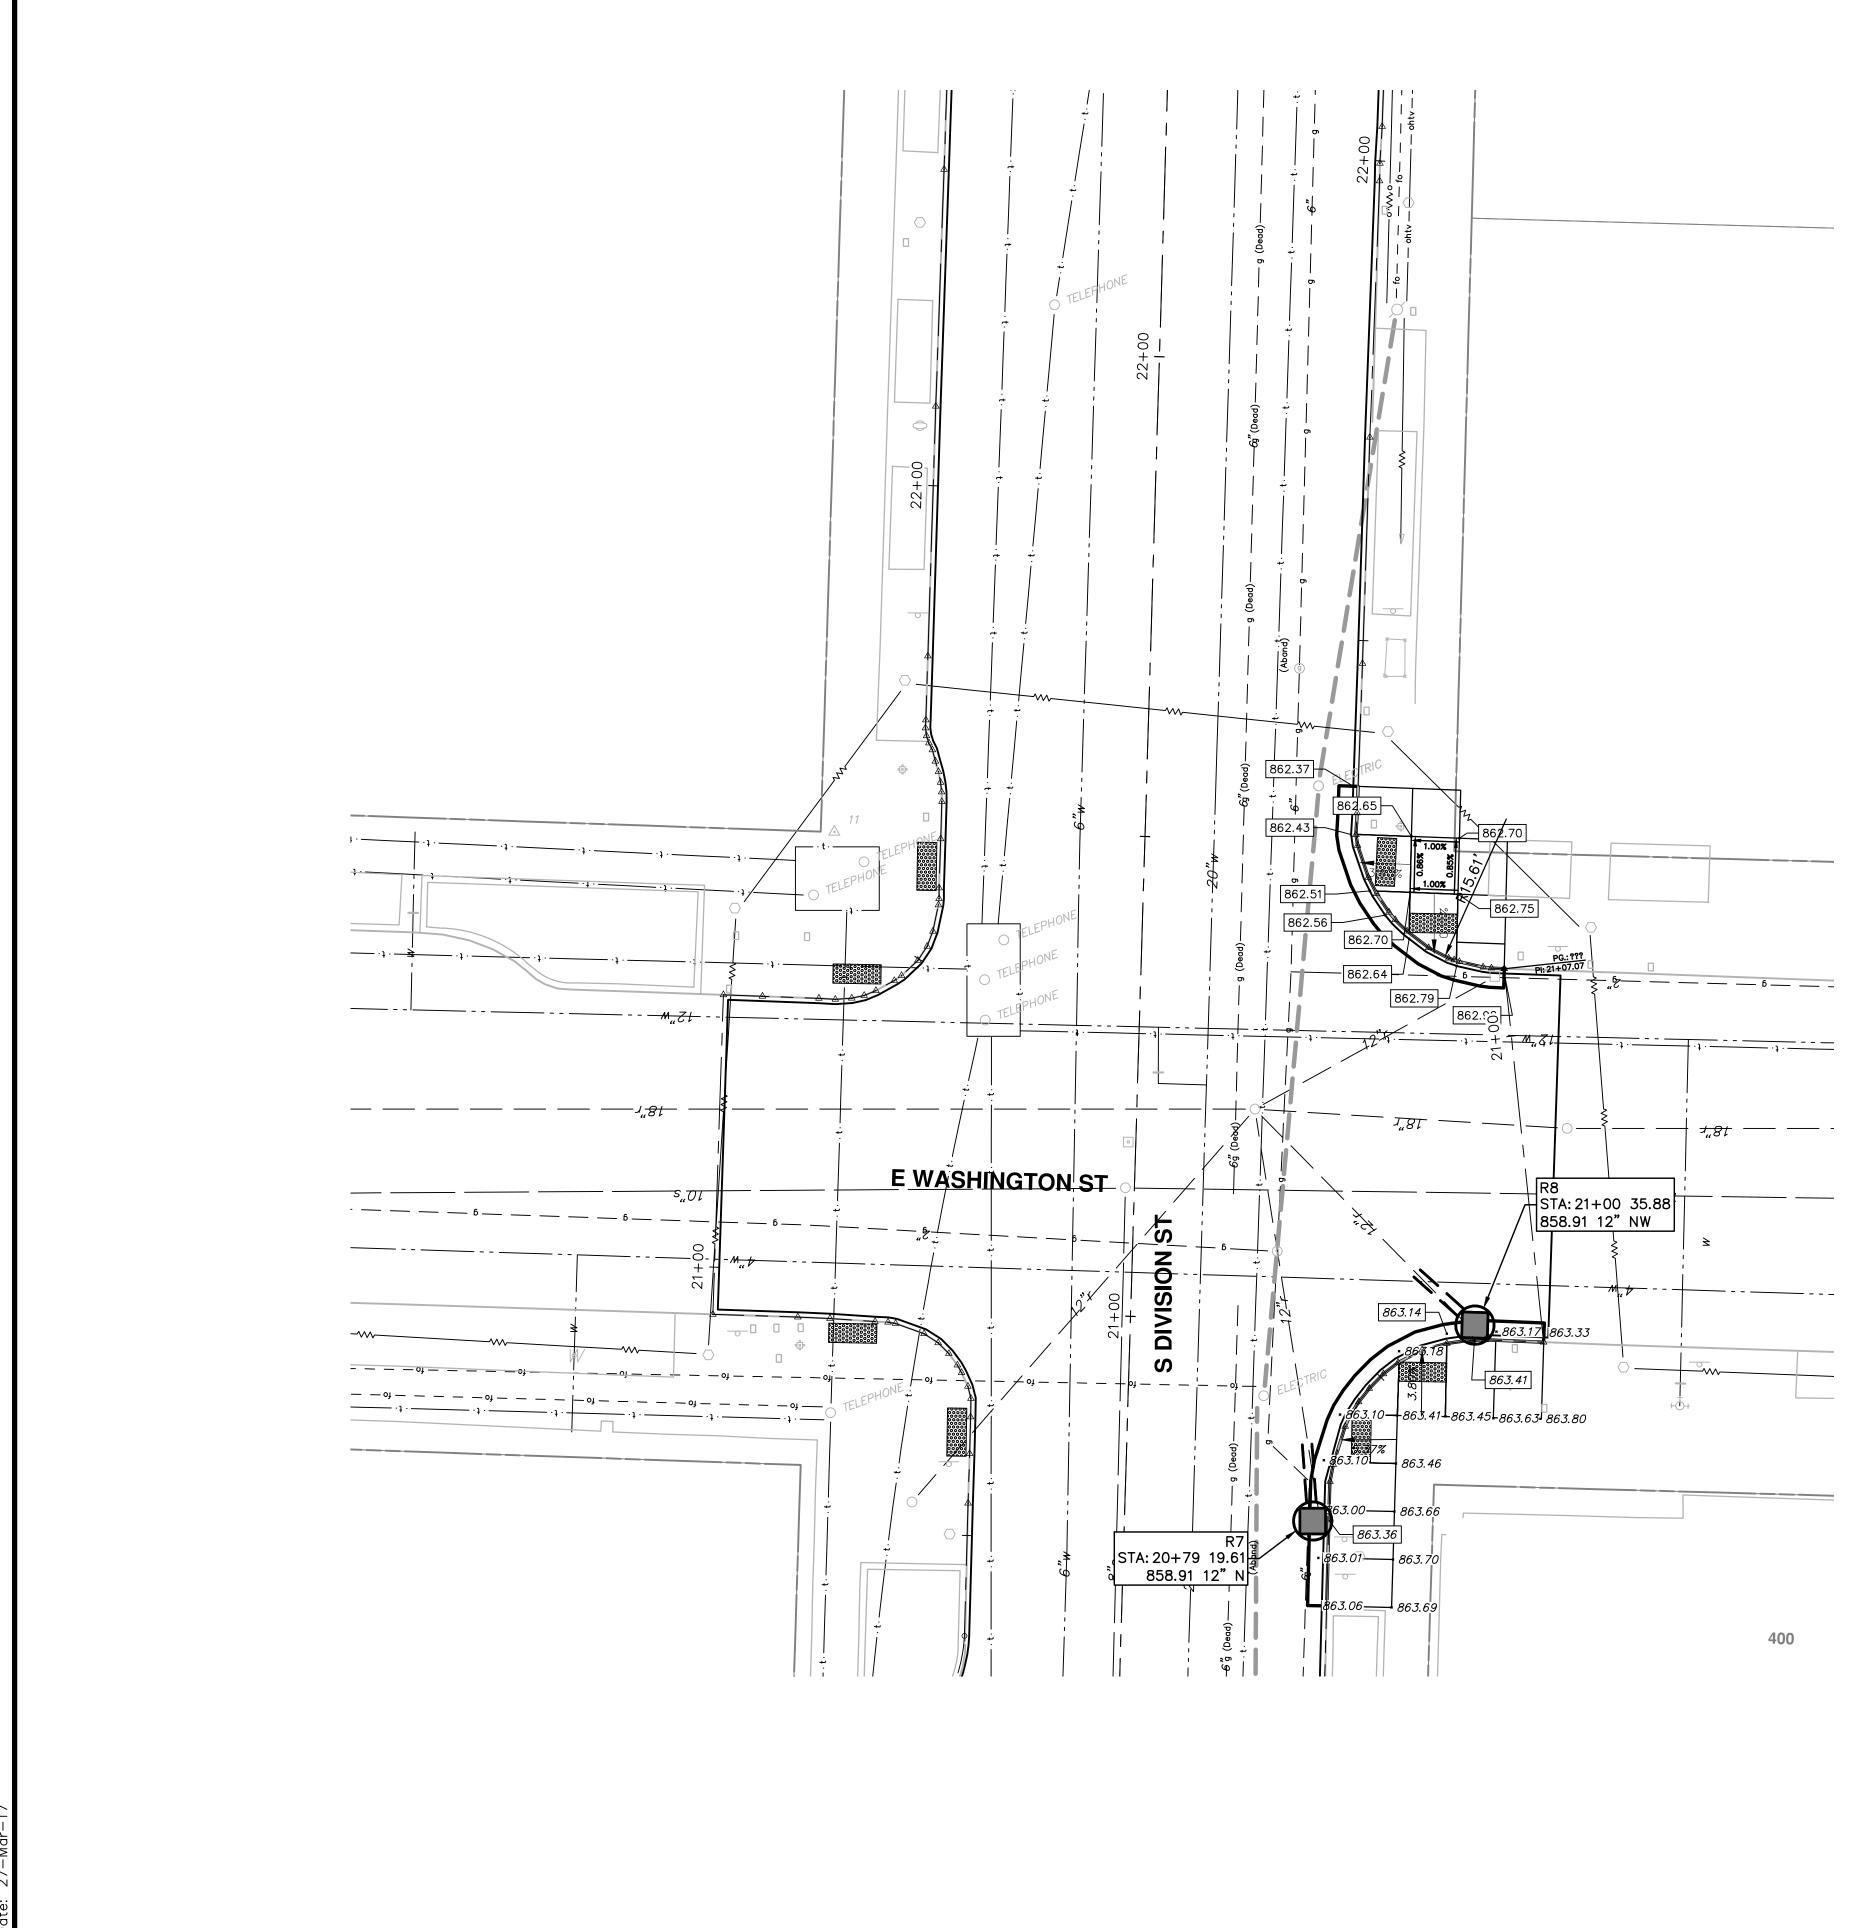


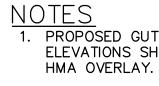



SHE	PROJECT N	IANAGEMENT - PUBLIC SERVICES - CITY OF ANN ARBOR	ANN						8
T 09	1 SCALE PLAN: 1" = 10'								
Nc 9 (ANNUAL STREET RESURFACING - 2017							
F		S DIVISION STREET	O ANN AROR MI 48107-8647	6	ADDENDUM #1	03-24-17	AG,GS,RG	DAD	
1	DRAWING NO								
3(WWW.a2dov.ord	8	00 BID SET	03-08-17	AG, GS, RG DAD	DAD	Know what's Delow
6									– Call hefere von die
-	2017004-103		- CHI MA	REV.	DESCRIPTION	DATE	DRAWN	DRAWN CHECKED	


1. PROPOSED GUTTER PAN TO BE OVERLAID UPON PAVING. ELEVATIONS SHOWN ARE TO TOP COURSE OF PROPOSED HMA OVERLAY.

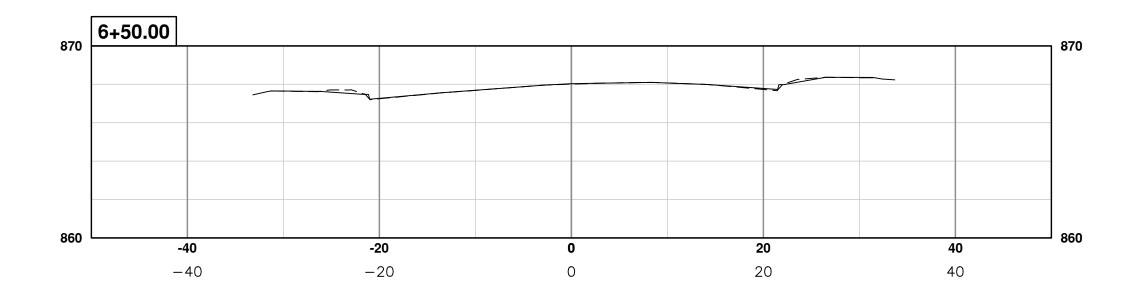


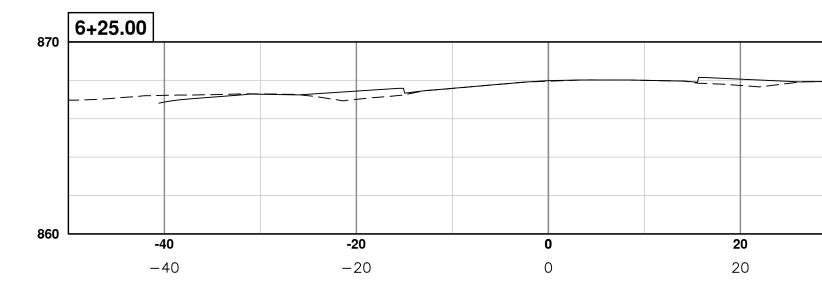


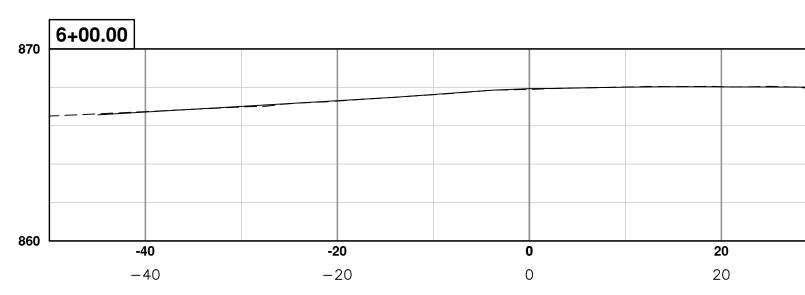


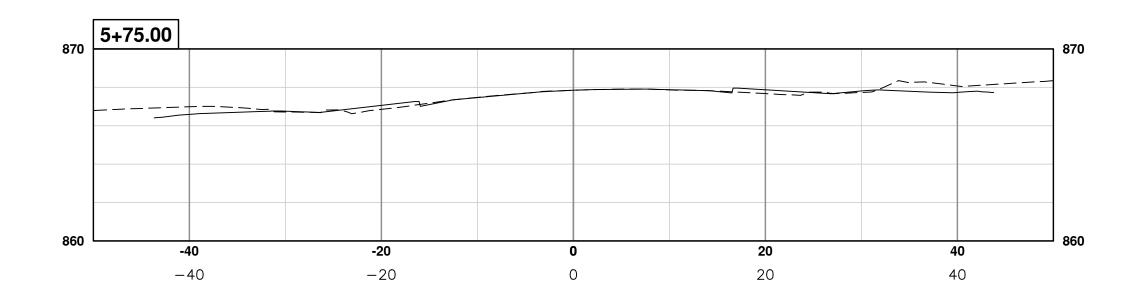


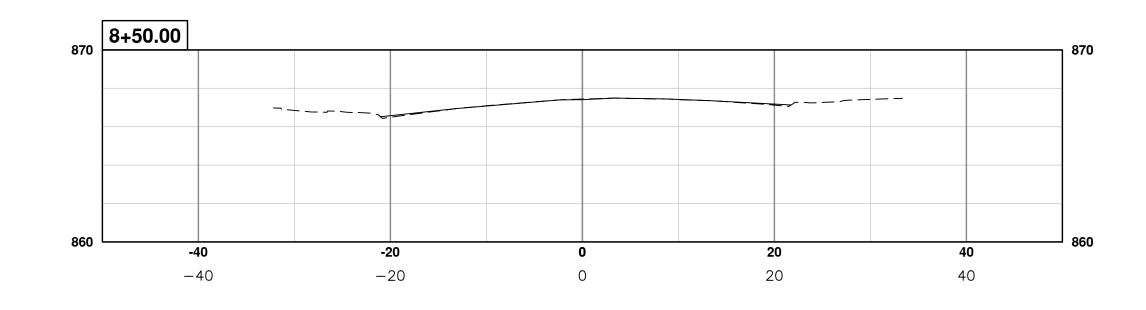


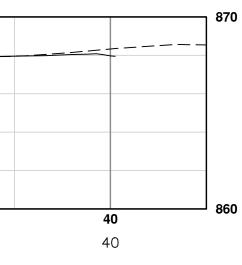

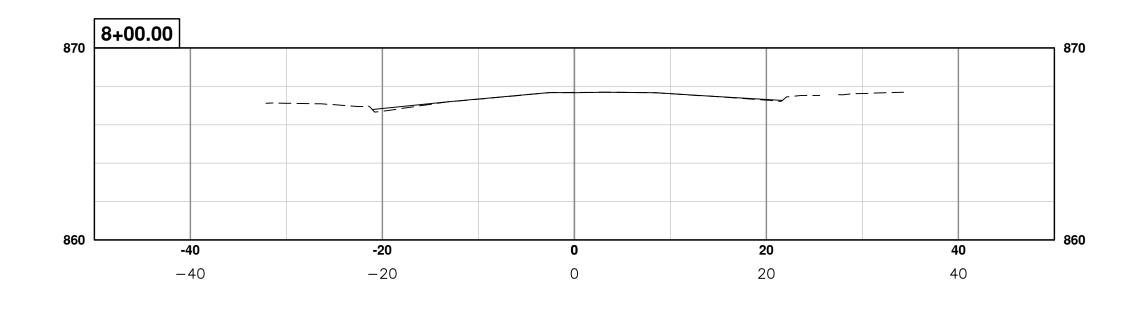

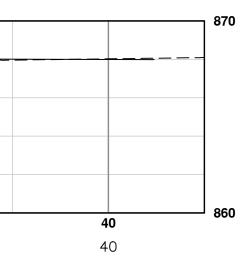

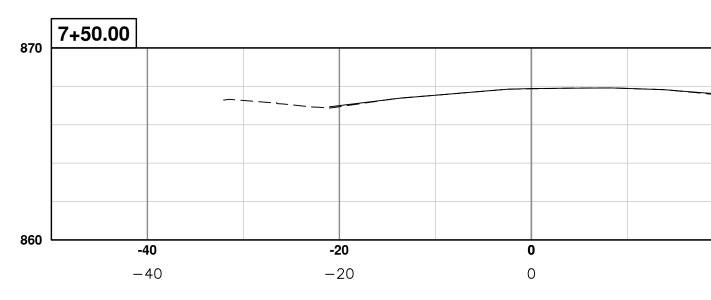


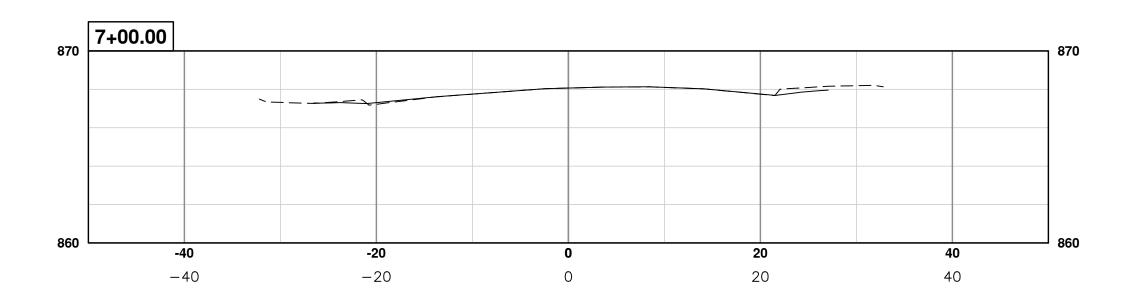

-				
J 860	0	4	0	20
	0	4 4	0	2 (2(


870


ξ		AG, GS, RG DAD	AG,GS,RG DAD Know what's below.	DRAWN CHECKED Call before you dig.
		03-24-17 AG,	03-08-17 AG,	DATE DR
		01 ADDENDUM #1	00 BID SET	REV. DESCRIPTION
OF AWN CITY OF ANN ABOD	PUBLIC SERVICES 101 DI AUDUN ANDUN PUBLIC SERVICES 301 EAST HURON STREET	O O BOX 8647 ANN ARBOR, MI 48107-8647 ANN ARBOR, MI 48107-8647	734-794-6410 WWW.a2gov.org	WICHIGH.
ANAGEMENT - PUBLIC SERVICES - CITY OF ANN ARBOR	ANNUAL STREET RESURFACING - 2017	S DIVISION STREET		SECI 5+75 10 8+50
PROJECT M	SCALE PLAN: 1" = 10' PROFILE: 1" = 5'		DRAWING No.	2017004-110

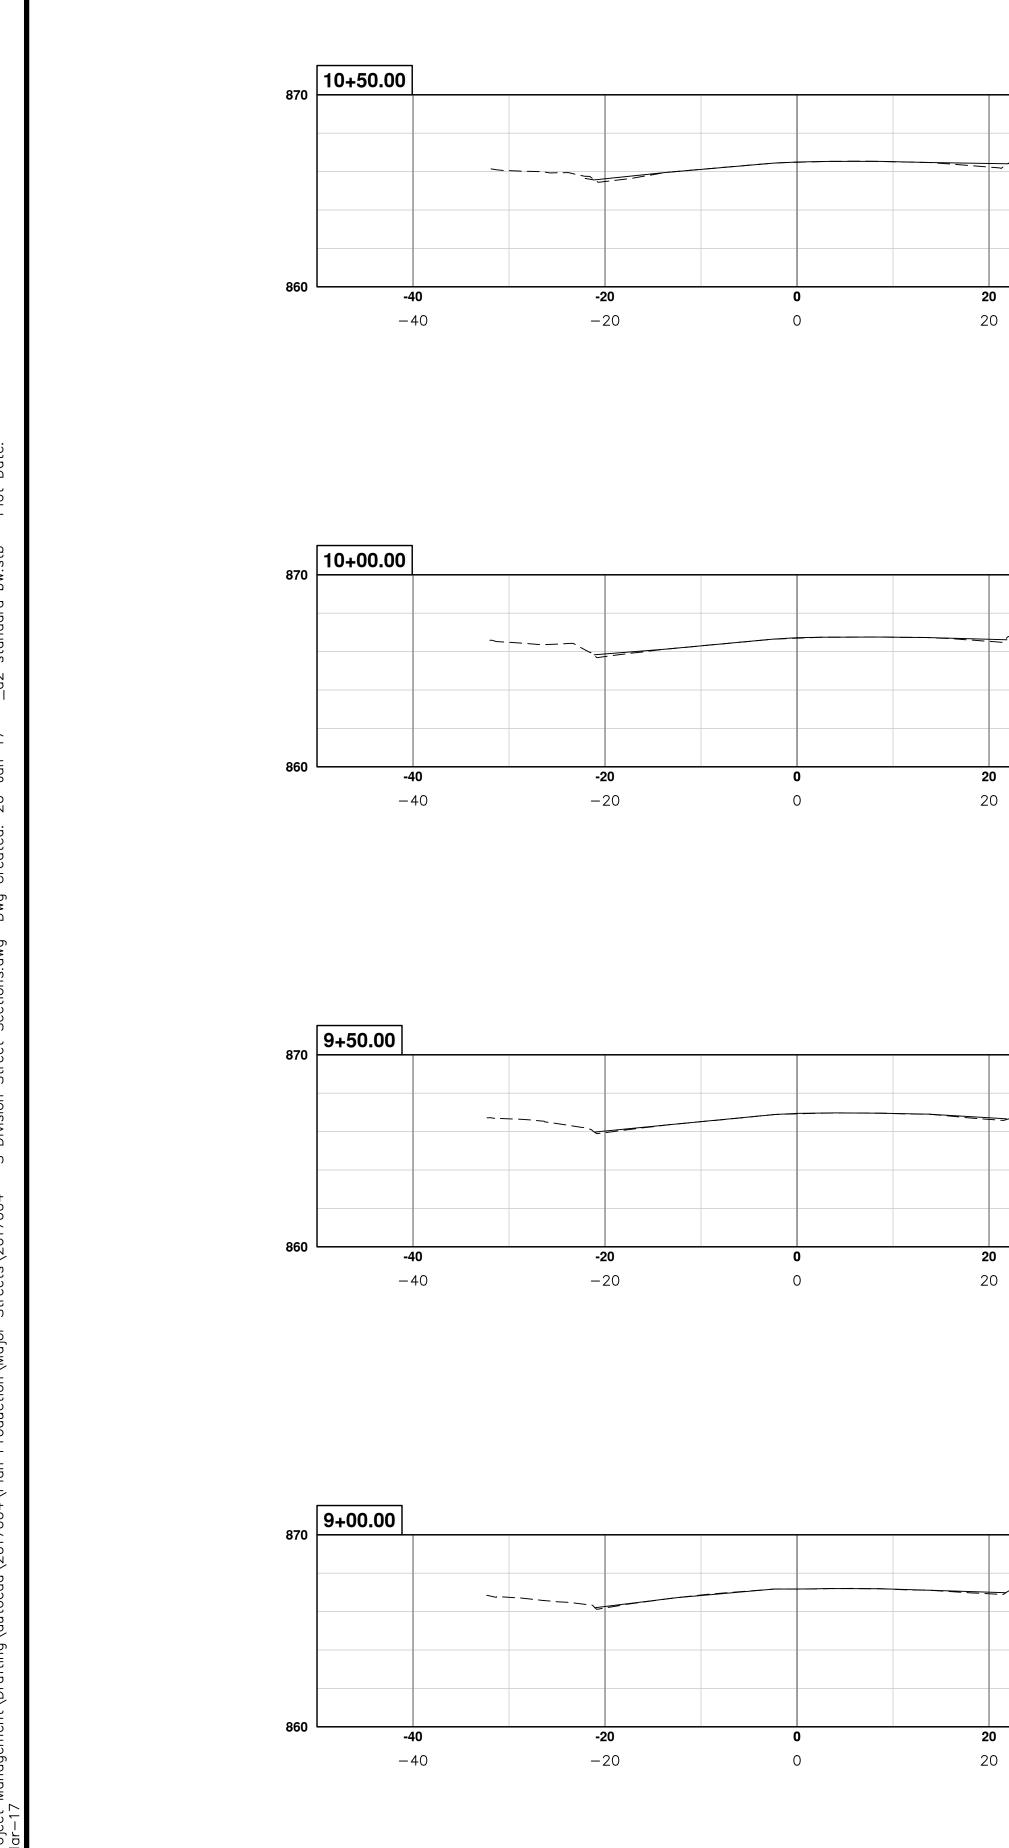



Proj


ல்

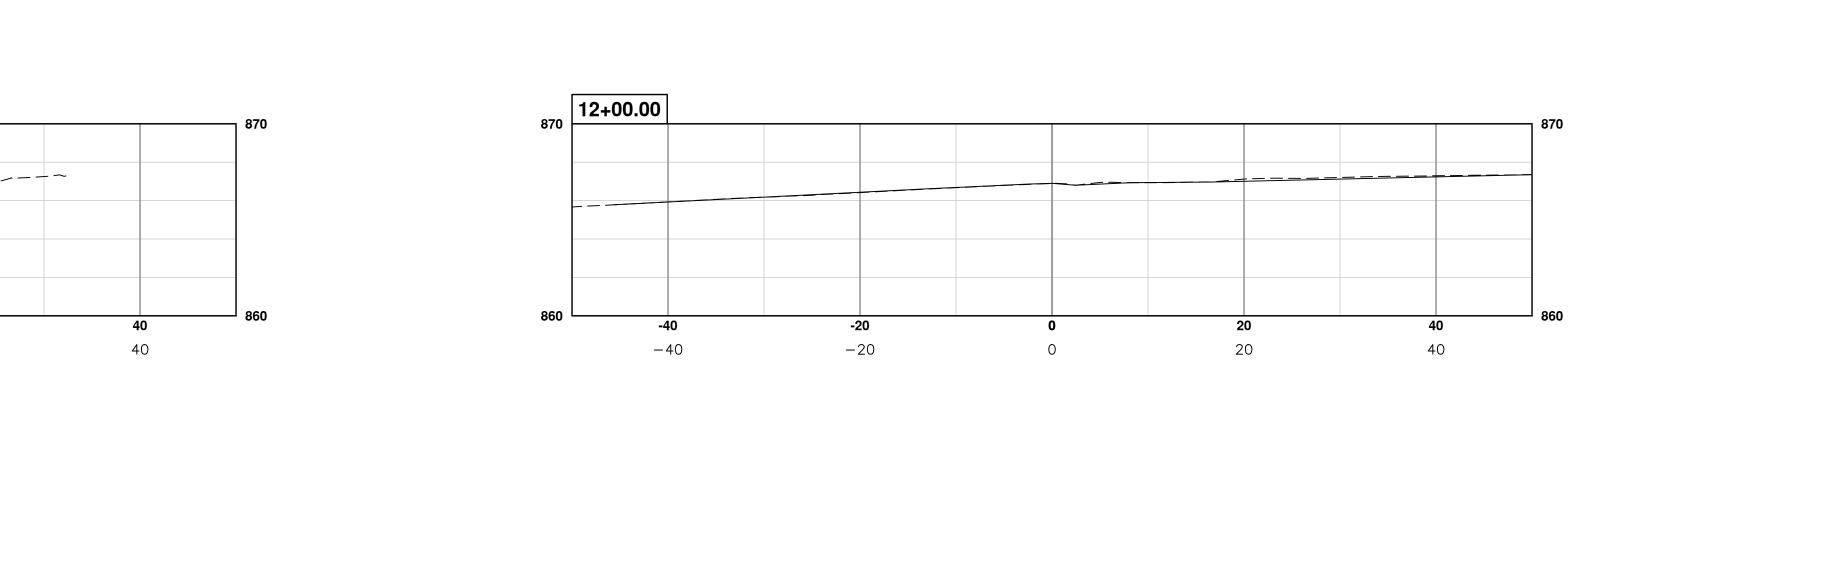


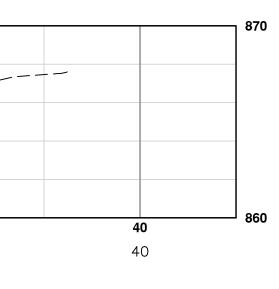


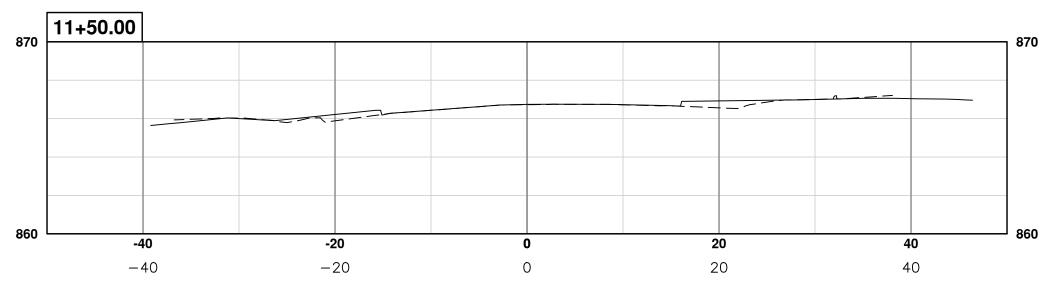

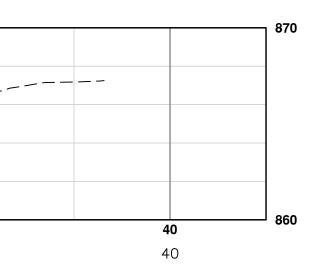


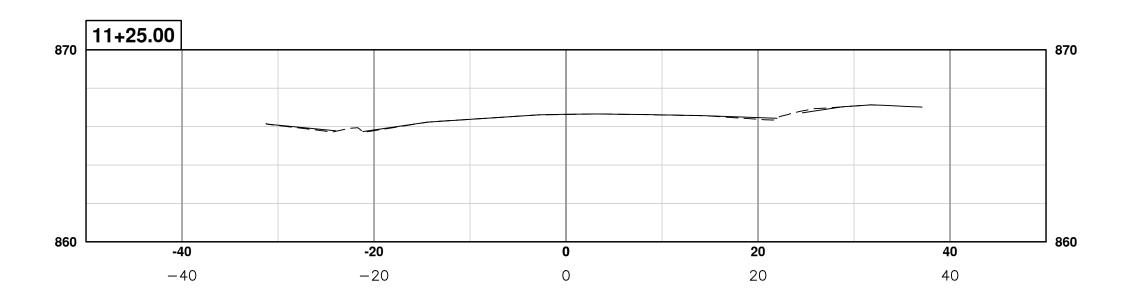


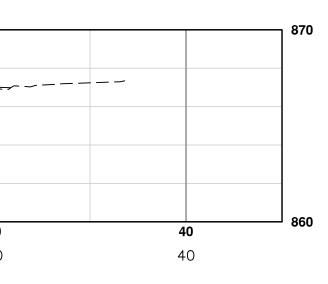


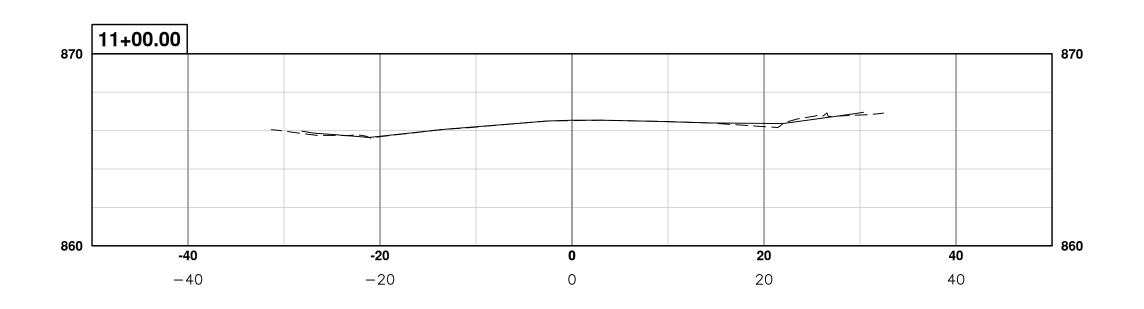



				Know what's below.	Call before you dig.
			DAD	DAD	DRAWN CHECKED
			AG,GS,RG	AG,GS,RG	DRAWN
			03-24-17	03-08-17	DATE
			ADDENDUM #1	BID SET	DESCRIPTION
			01	00	REV.
AN	CITY OF ANN ARBOR	EVENDED 301 EAST HURON STREET	O BOX 8647 ANN ARBOR, MI 48107-8647	734-794-6410 WWW.a2gov.org	V/CHIGH
T MANAGEMENT - PUBLIC SERVICES - CITY OF ANN ARBOR	· /	ANNUAL STREET RESURFACING - 2017	S DIVISION STREET		SECI 9400 10 12400
		No.		DRAWNG No.	2017004-111

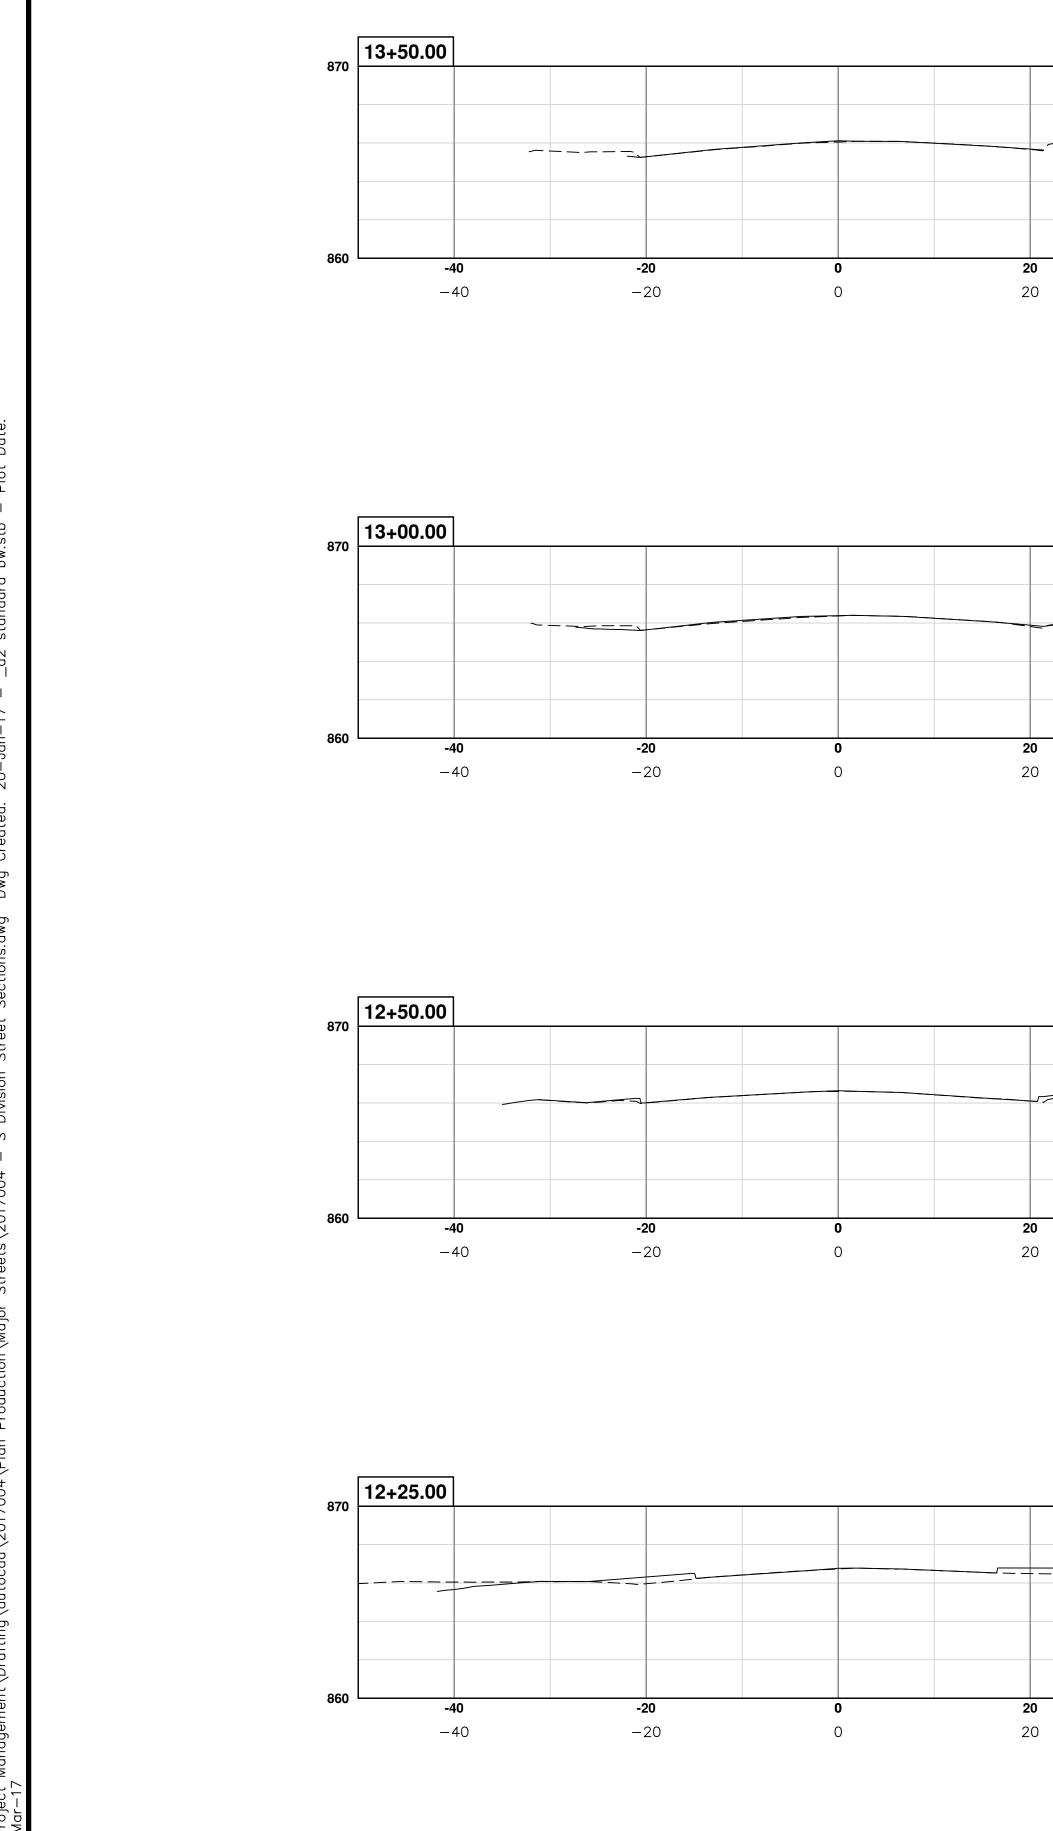


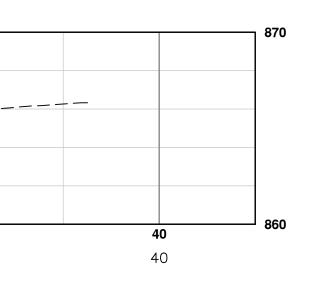


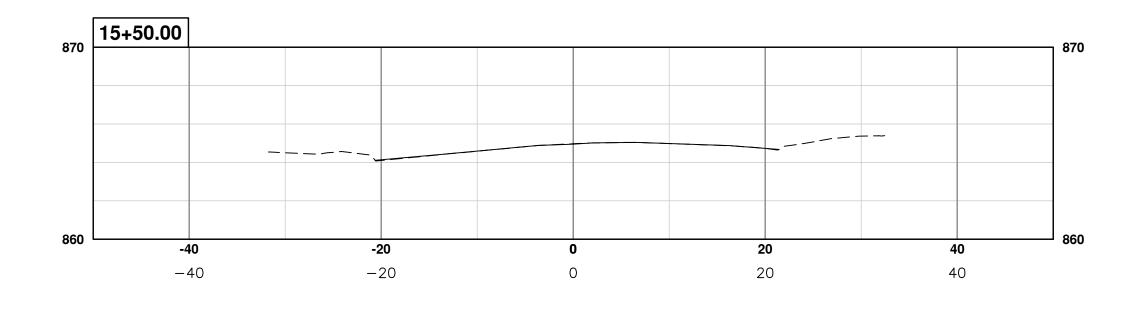


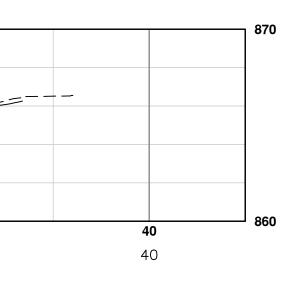


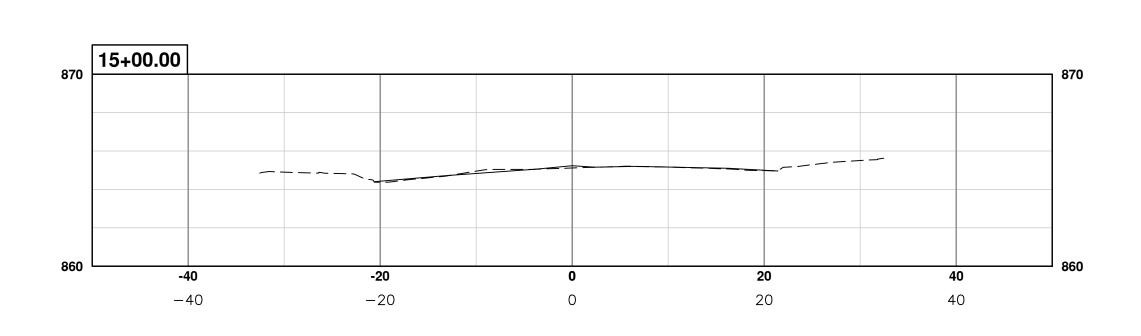


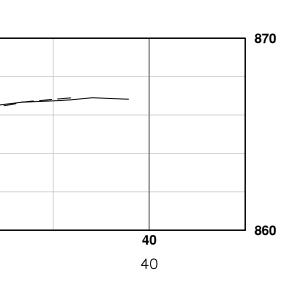


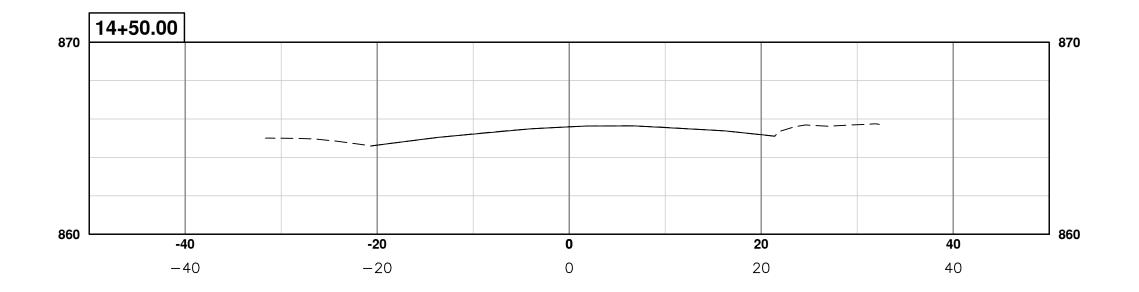


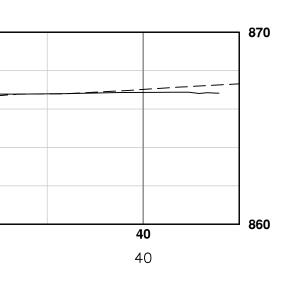

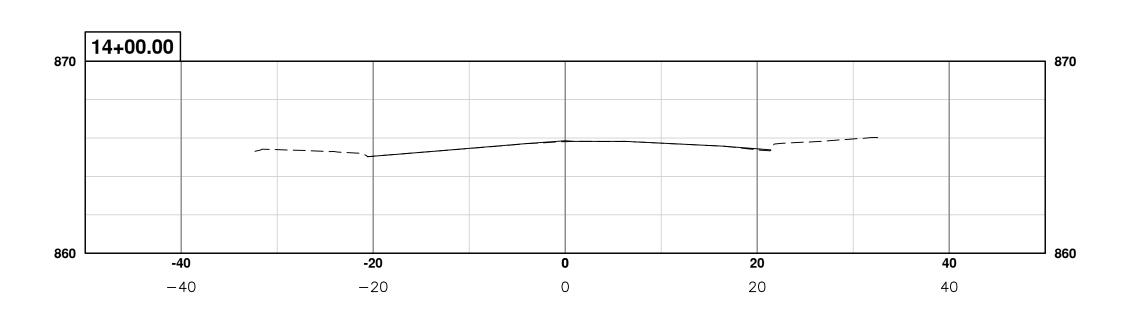


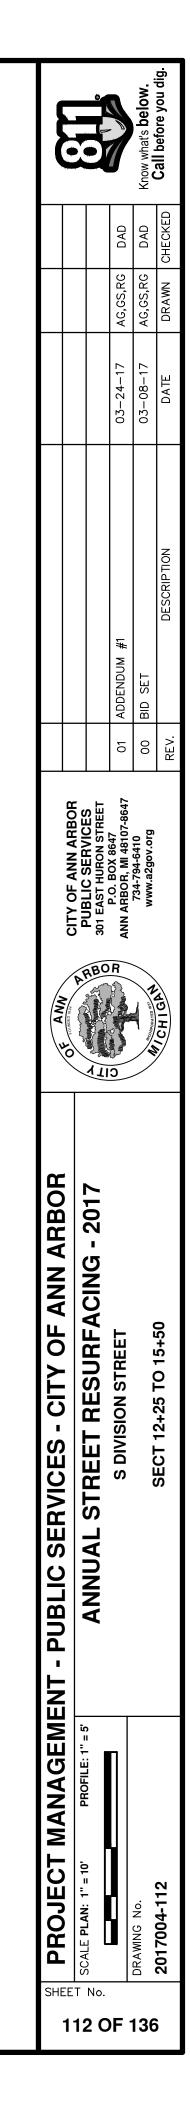


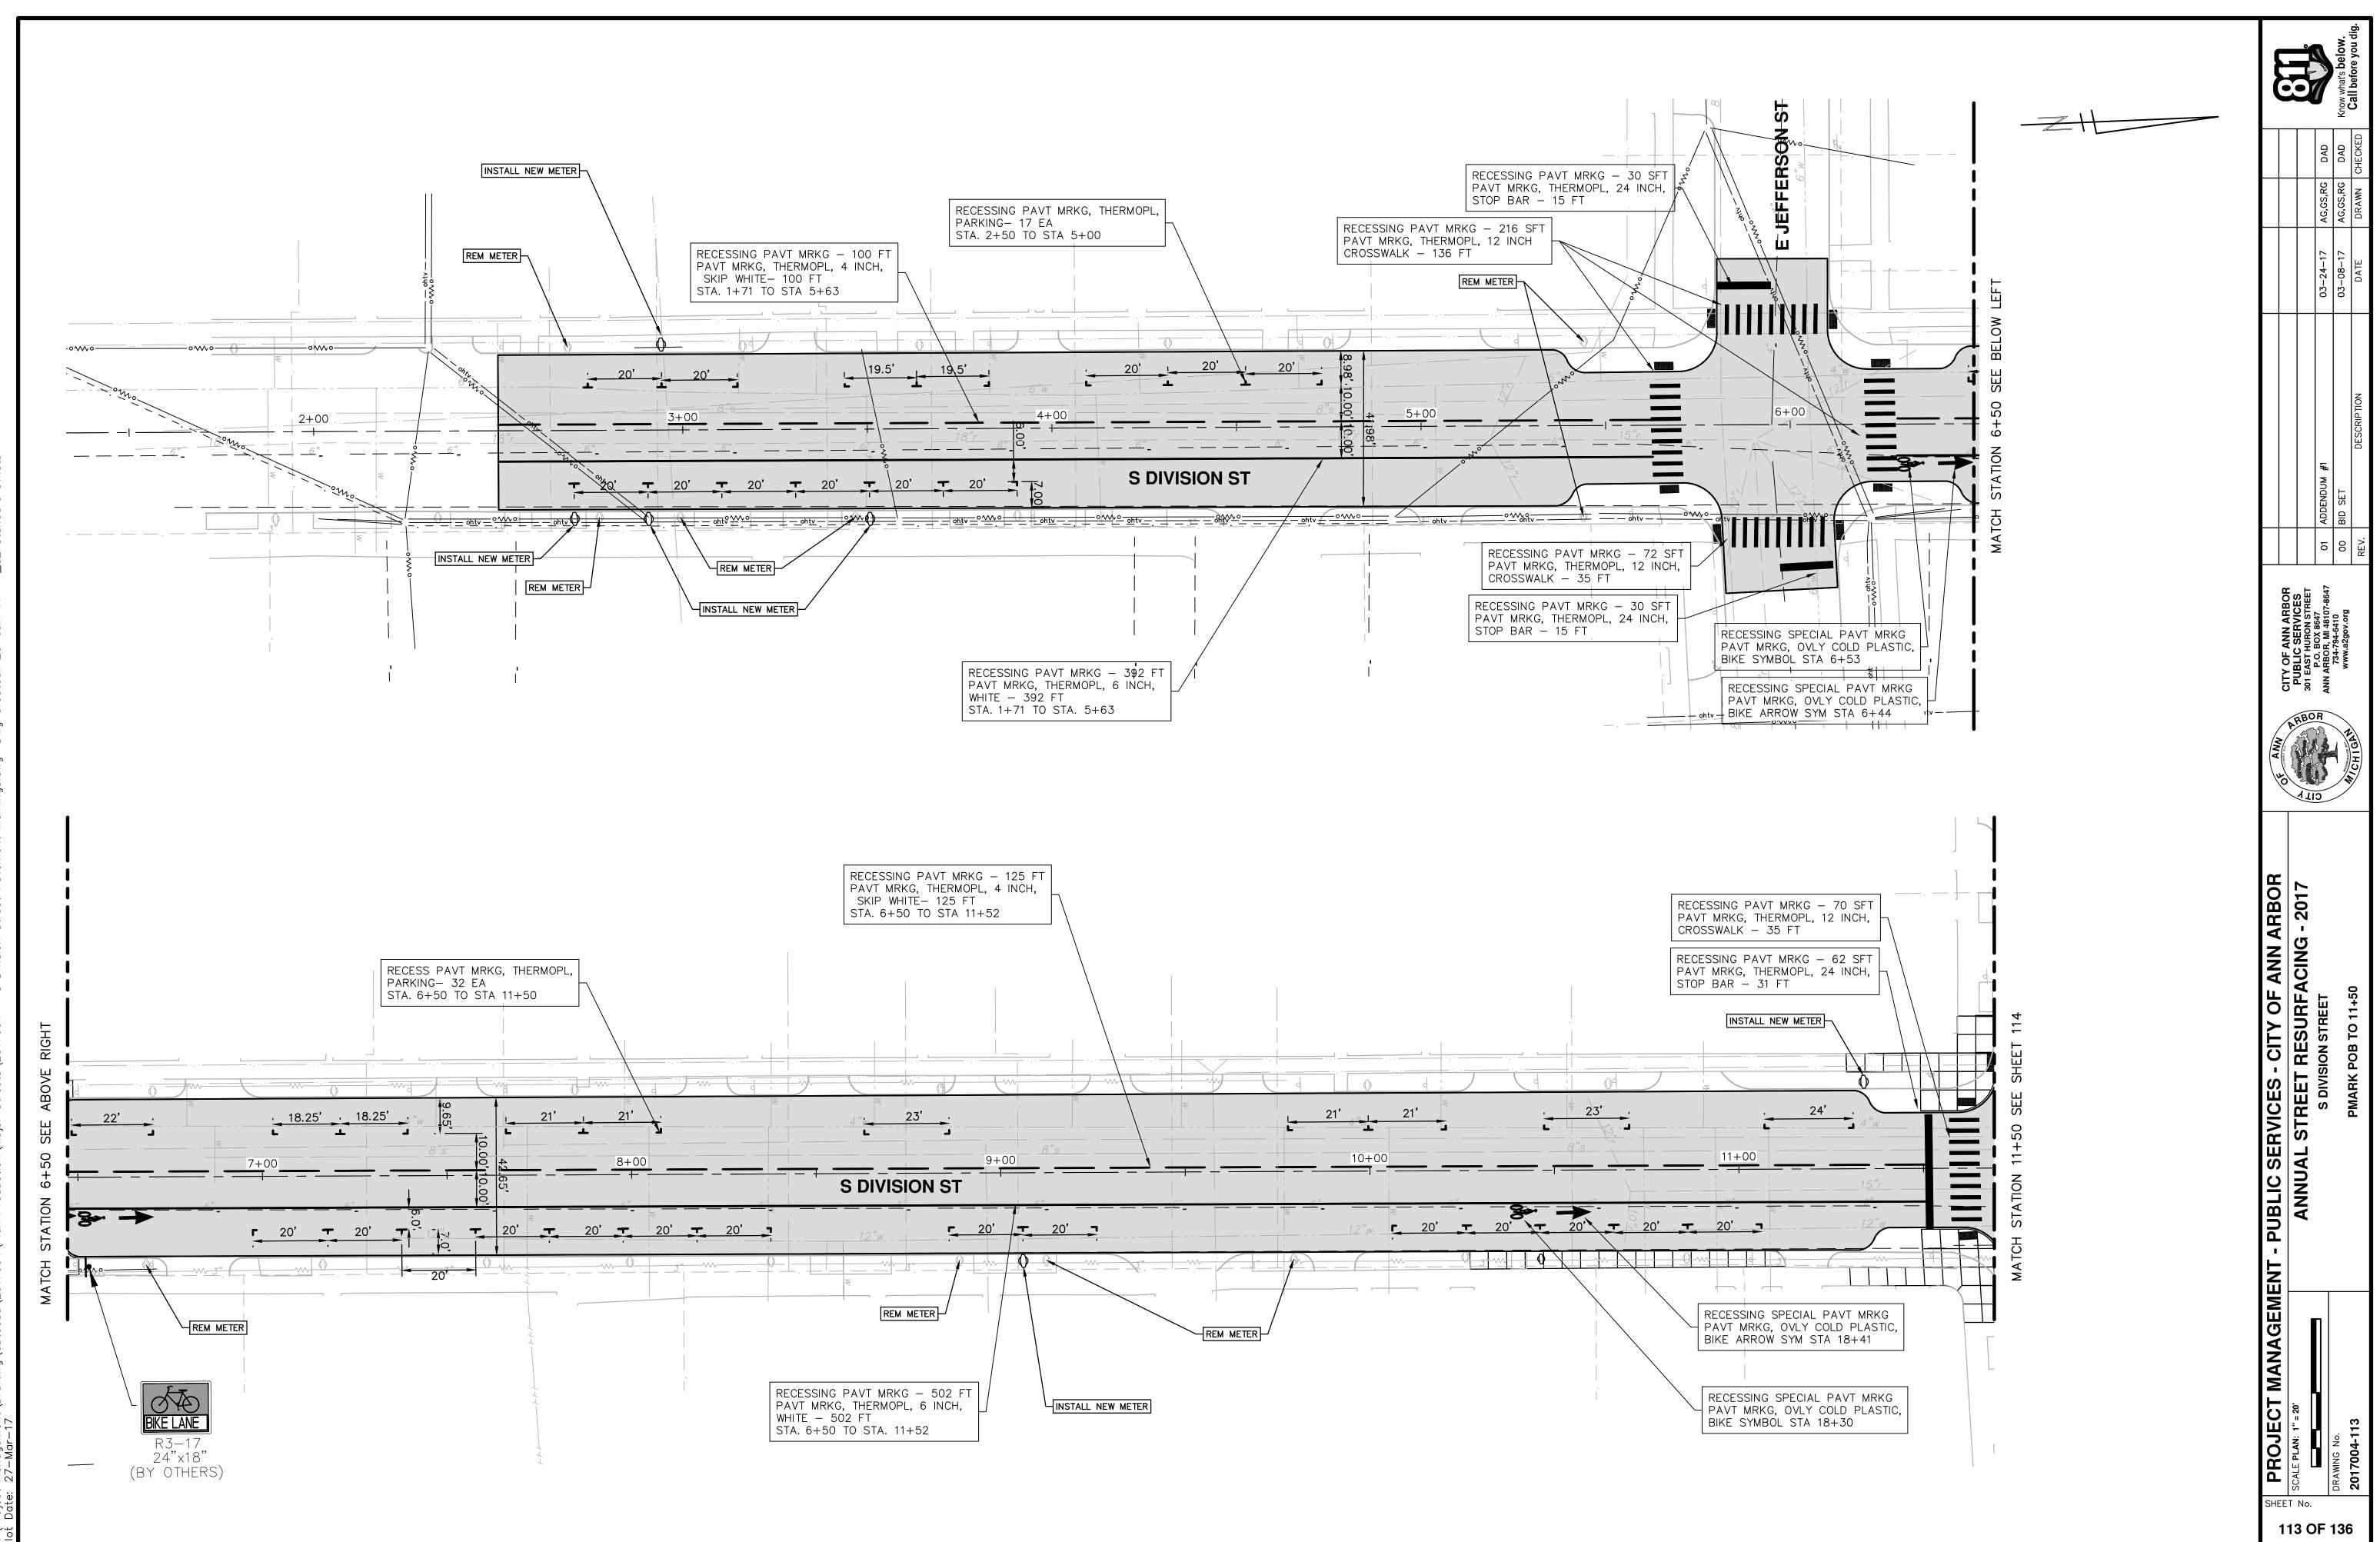

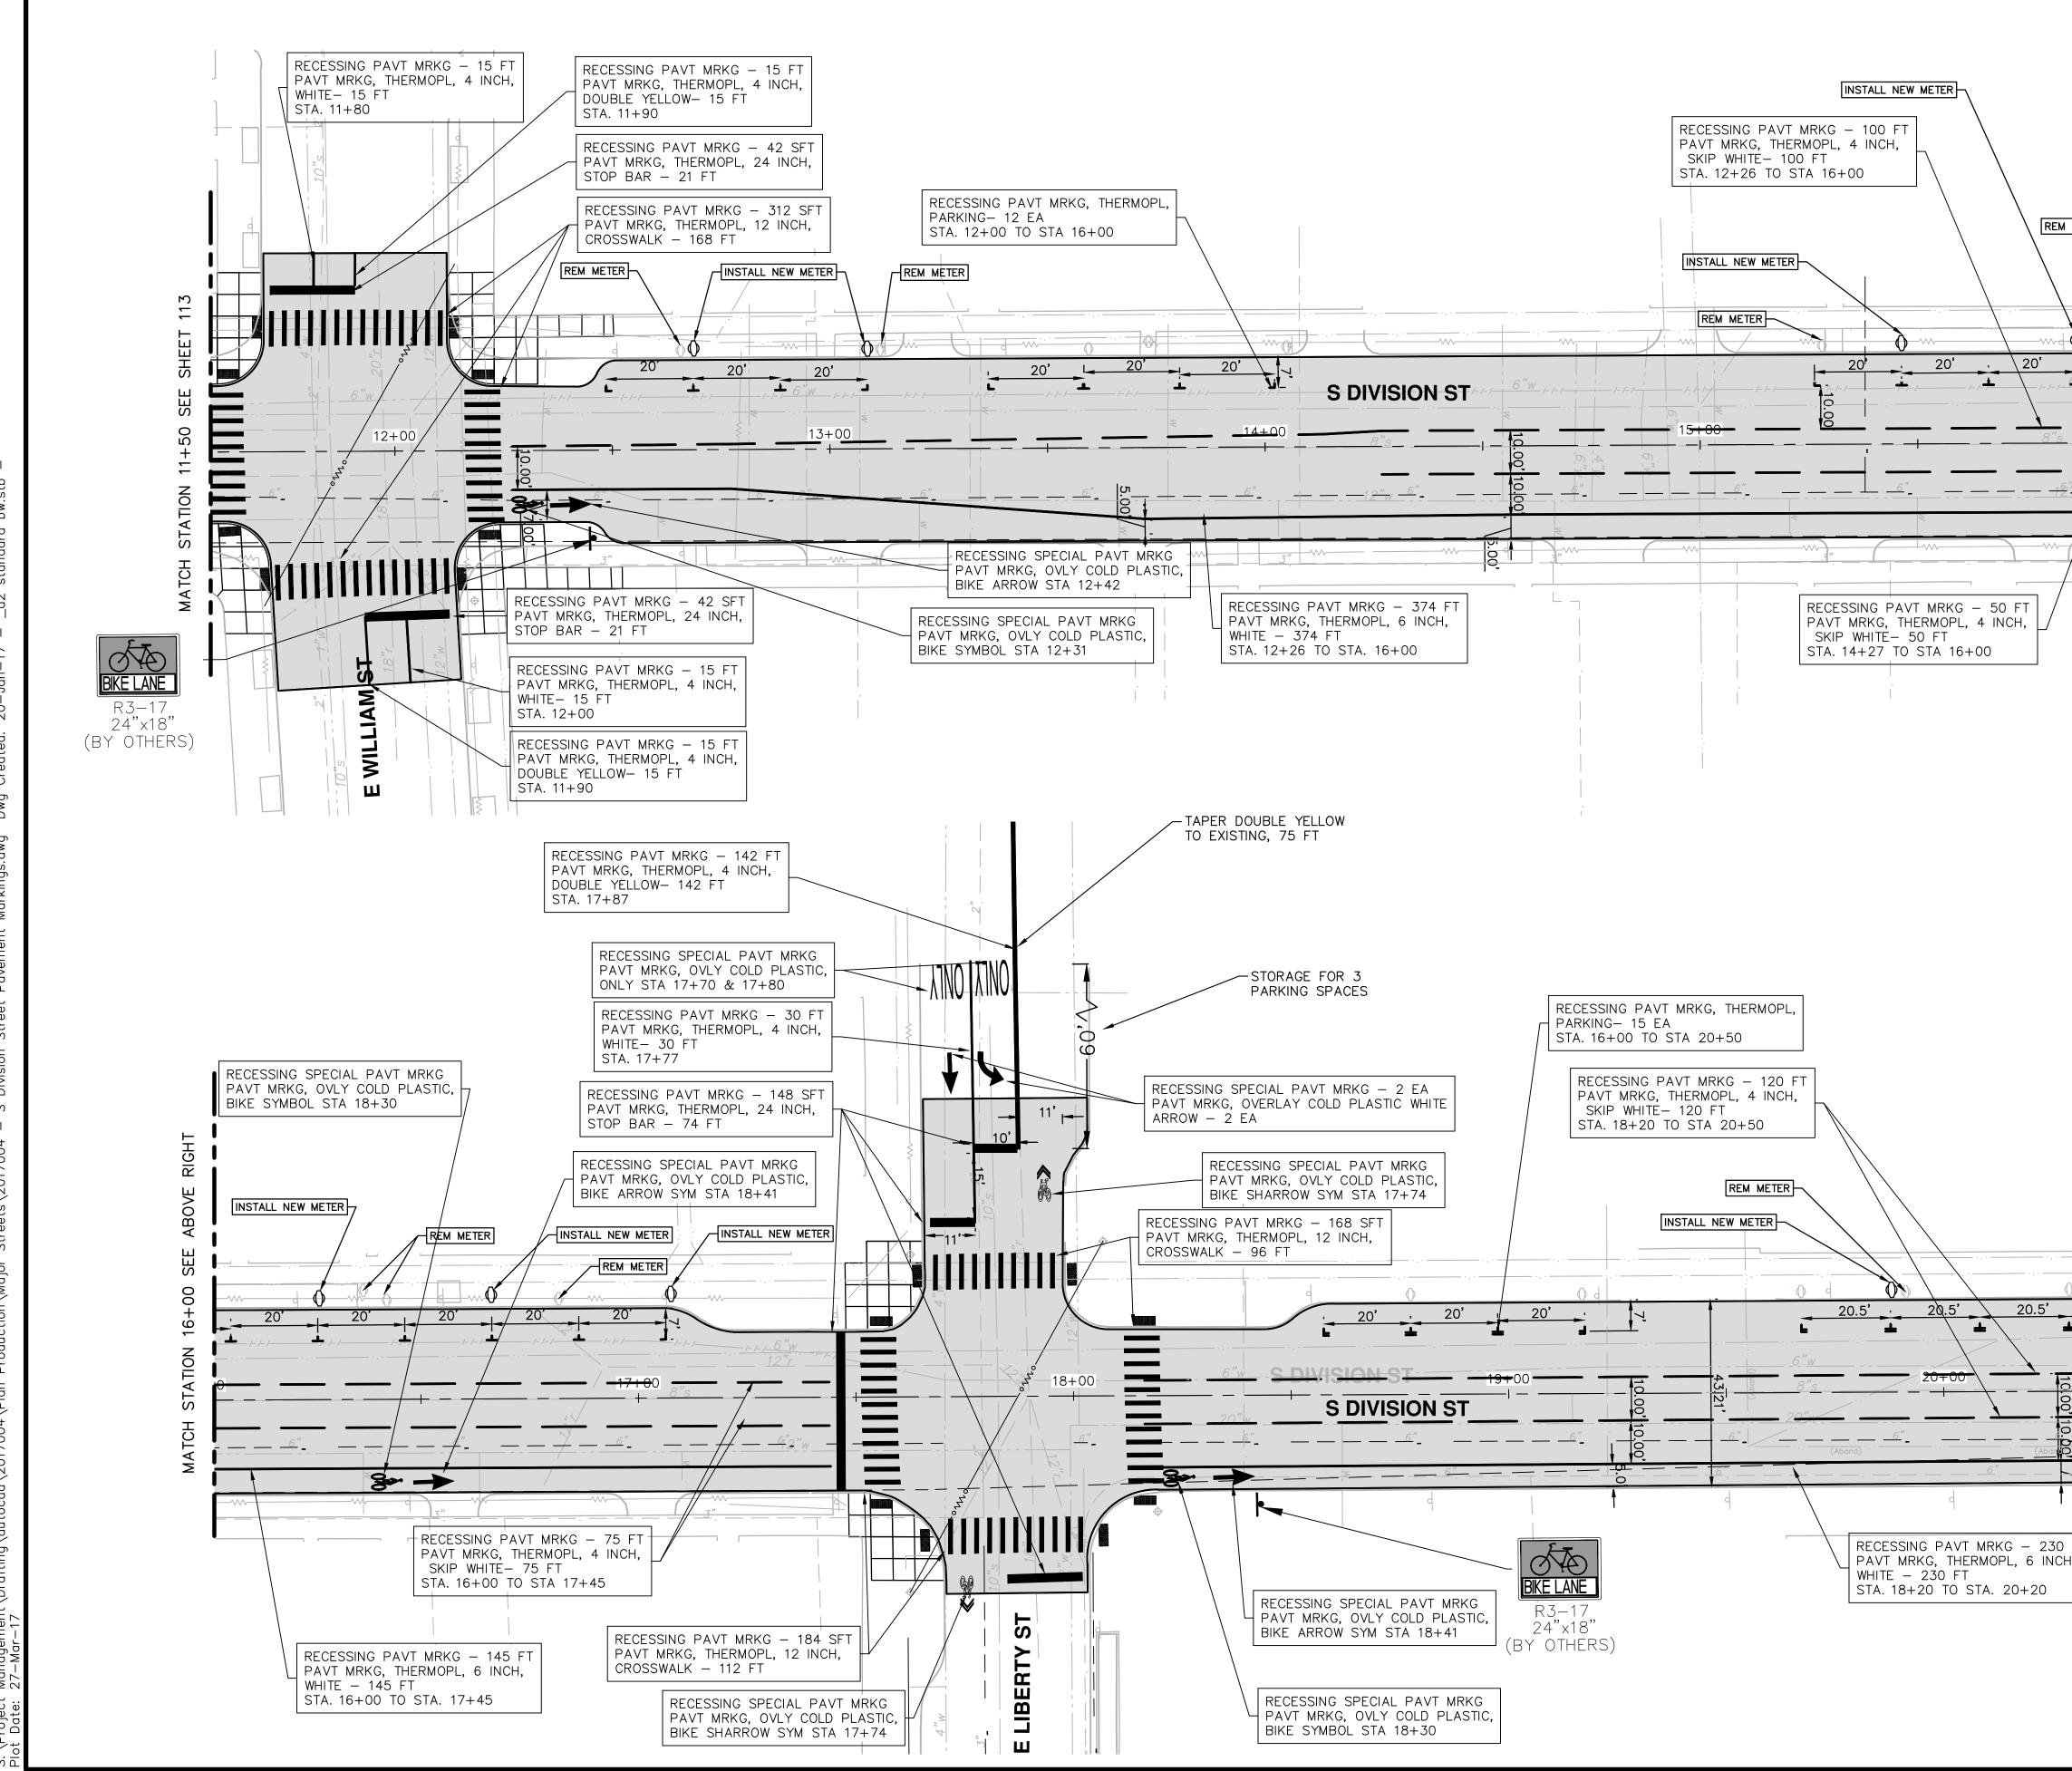

	Know what's below.
	AG,GS,RG DAD AG,GS,RG DAD AG,GS,RG DAD DRAWN CHECKED
	03-24-17 03-08-17 DATE
MATCH STATION 16+00 SEE BELOW LEFT	ADDENDUM #1 BID SET DESCRIPTION
MATCH	00 01 REV.
	CITY OF ANN ARBOR DUBLIC SERVICES 301 EAST HURON STREET P.O. BOX 8647 ANN ARBOR, MI 48107-8647 734-794-6410 www.a2gov.org
MATCH STATION 20+50 SEE SHEET 115	ANAGEMENT - PUBLIC SERVICES - CITY OF ANN ARBOR ANNUAL STREET RESURFACING - 2017 S DIVISION STREET BMARK 11+50 TO 20+50
D FT HOLEN	PROJECT MANAGEME SCALE PLAN: 1" = 20' DRAWING NO. 2017004-114 2017004-114

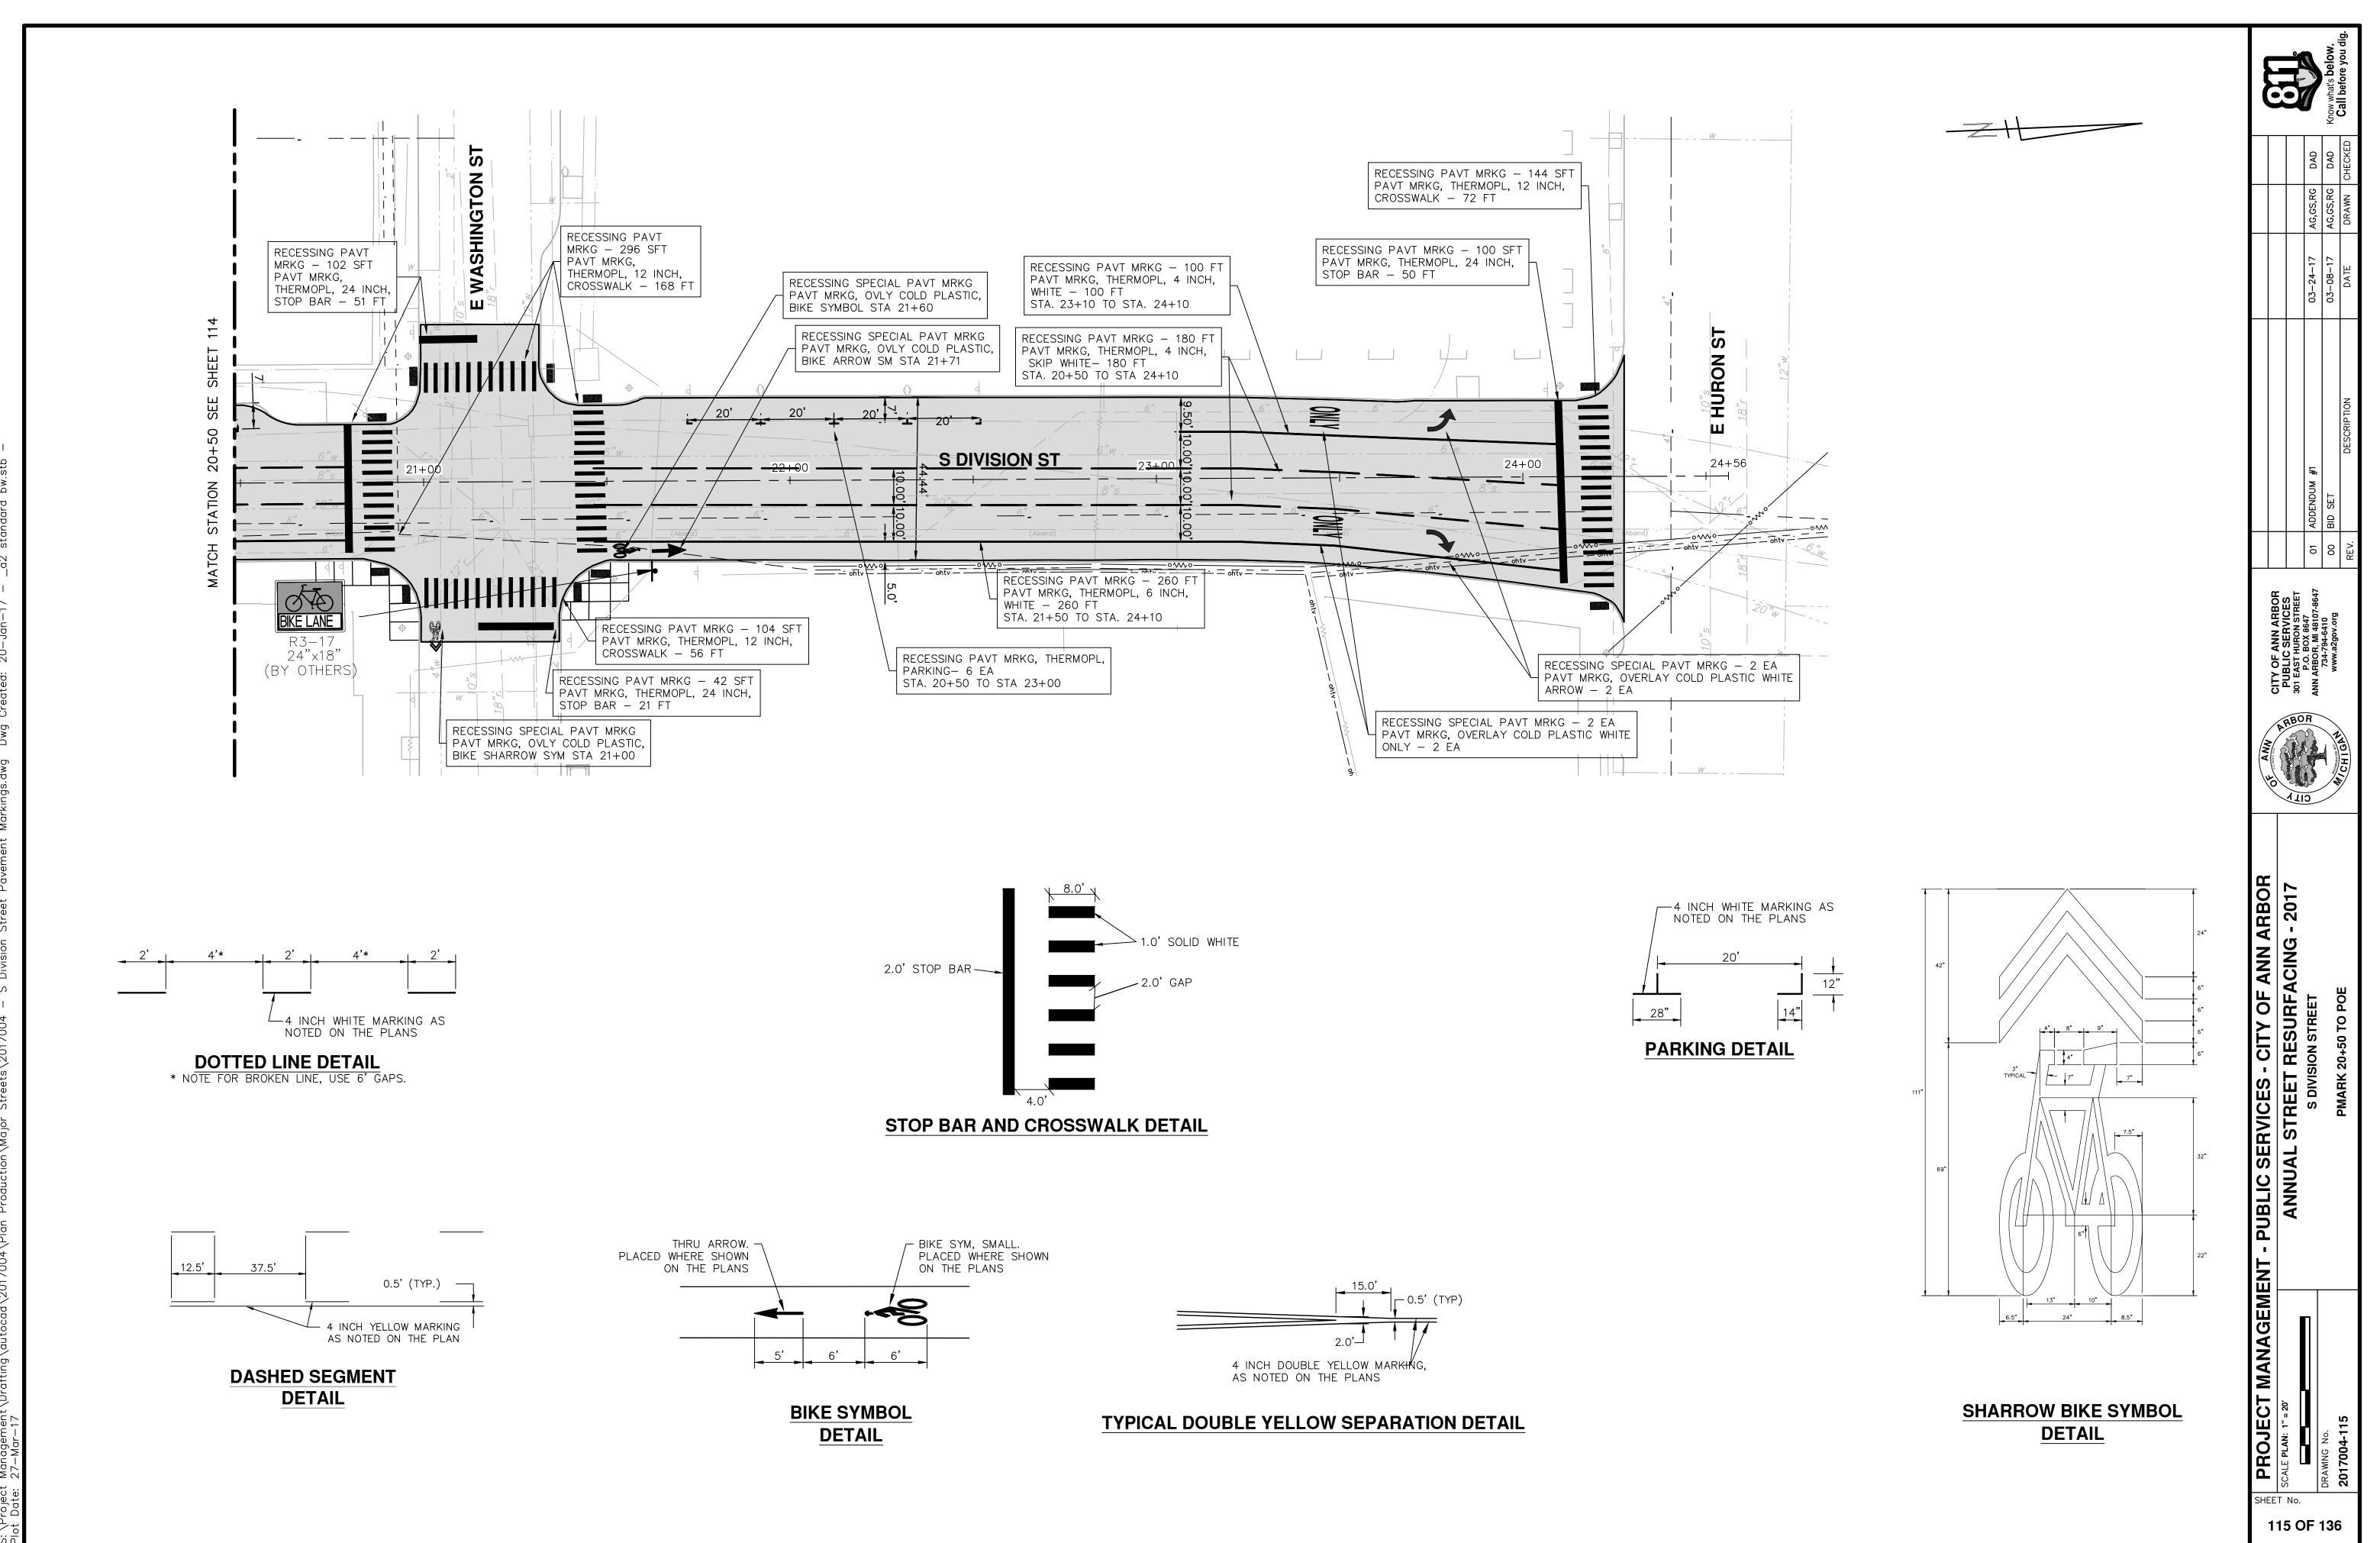

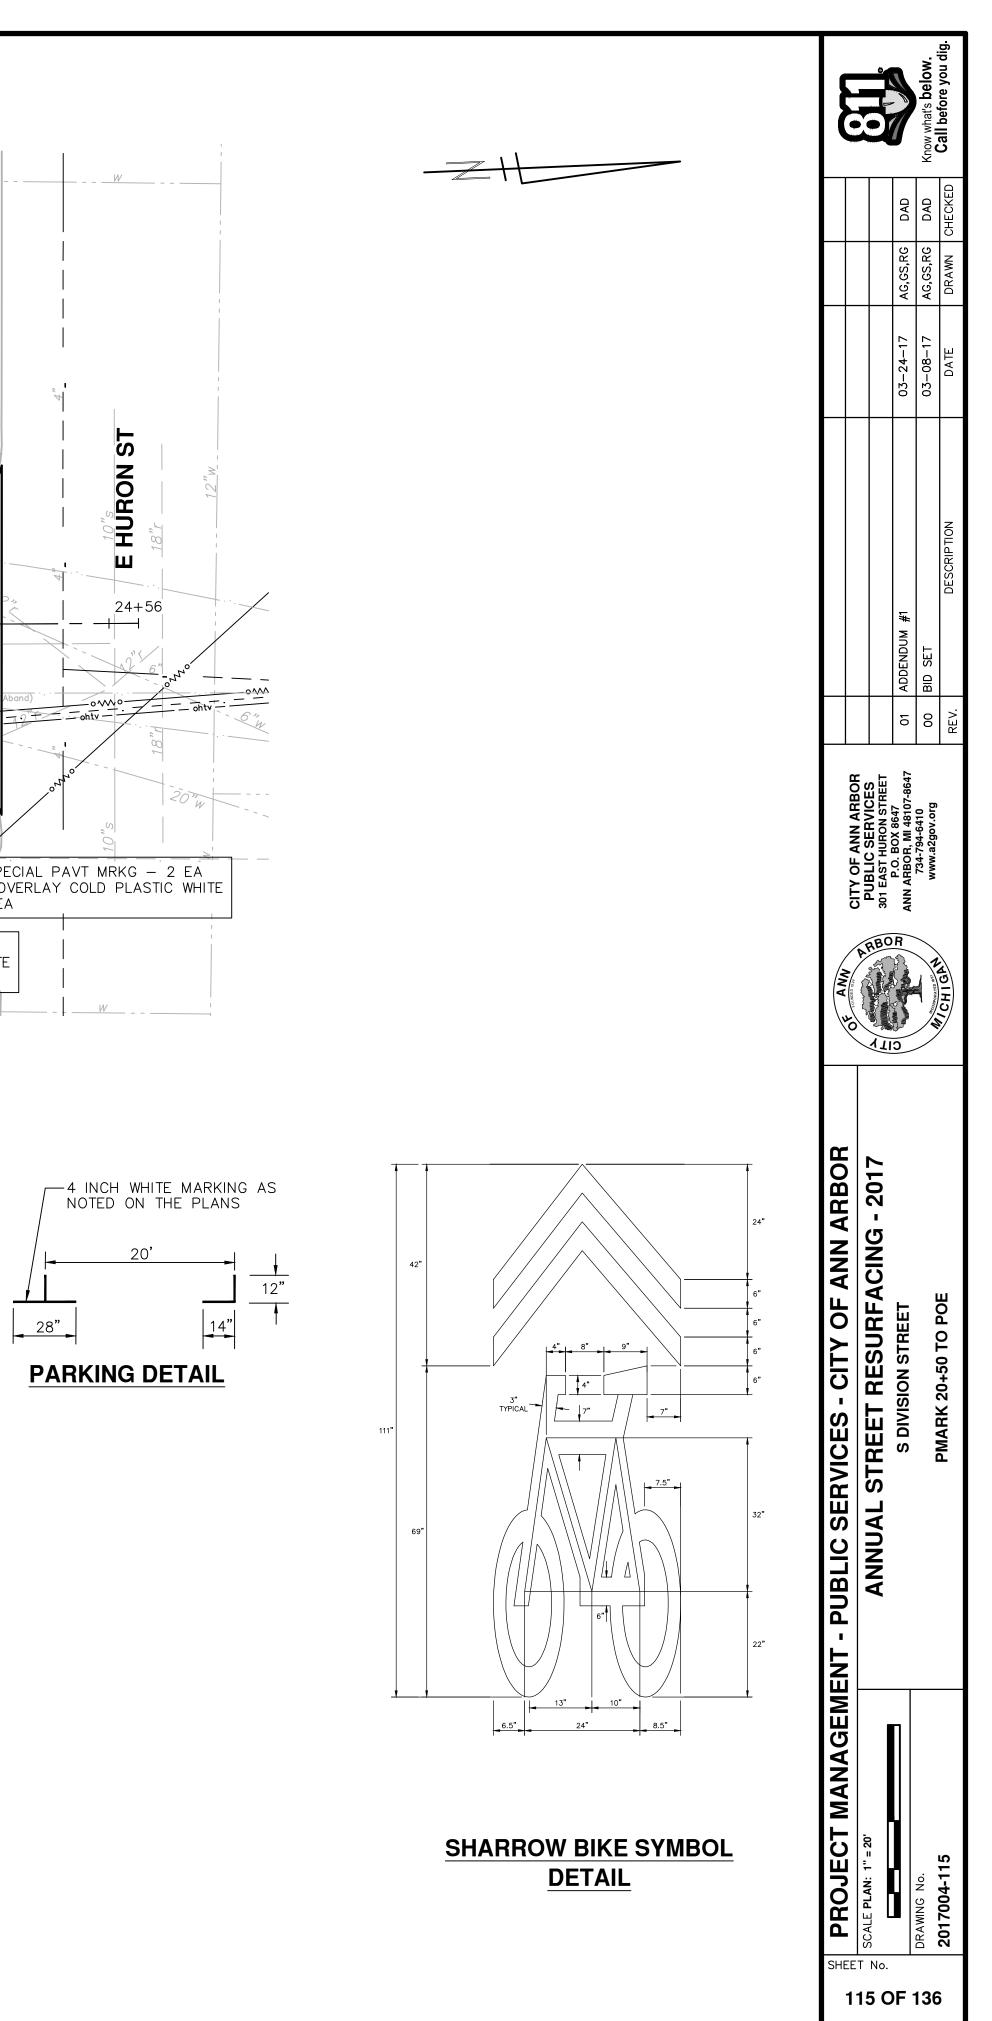



PROJECT LOCATION: S UNIVERSITY AVENUE

Item Code	Item Description	Units	Quantity
2057021	_Subgrade Undercutting, Type IIA	Cyd	46.000
2080020	Erosion Control, Inlet Protection, Fabric Drop	Ea	16.000
5010003	Cold Milling HMA Surface	Ton	465.000
5010061	HMA, Approach	Ton	82.00
5010703	HMA, LVSP	Ton	383.00
5017050	_HMA Surface, Around Structure Cover, Rem	Ea	28.00
8110079	Pavt Mrkg, Ovly Cold Plastic, Sharrow Symbol	Ea	3.00
8110520	Pavt Mrkg, Wet Retrflec, Thermopl, 4 inch, White	Ft	60.00
8110524	Pavt Mrkg, Wet Retrflec, Thermopl, 4 inch, Yellow	Ft	1,716.00
8117001	_Pavt Mrkg, Wet Retrflec, Thermopl, 12 inch, Crosswalk	Ft	976.00
8117001	_Pavt Mrkg, Wet Retrflec, Thermopl, 24 inch, Stop Bar	Ft	164.00
8117001	_Pavt Mrkg, Wet Retrflec, Thermopl, 4 inch, Parking Sym, White	Ft	192.00
8120012	Barricade, Type III, High Intensity, Double Sided, Lighted, Furn	Ea	5.00
8120013	Barricade, Type III, High Intensity, Double Sided, Lighted, Oper	Ea	5.00
8120030	Channelizing Device, 42 inch, Fum	Ea	55.00
8120031	Channelizing Device, 42 inch, Oper	Ea	55.00
8120140	Lighted Arrow, Type C, Furn	Ea	2.00
8120141	Lighted Arrow, Type C, Oper	Ea	2.00
8120260	Plastic Drum, High Intensity, Lighted, Furn	Ea	12.00
8120261	Plastic Drum, High Intensity, Lighted, Oper	Ea	12.00
8120331	Sign, Portable, Changeable Message, Oper	Ea	2.00
8120350	Sign, Type B, Temp, Prismatic, Furn	Sft	500.00
8120351	Sign, Type B, Temp, Prismatic, Oper	Sft	500.00

KEY	CONSTRUCTION KEY ASSOCIATED PAY ITEM(S)
NE I	
AA	 _Dr Structure, Adj, Case 1, Modified _Dr Structure, Adj, Case 2, Modified
AA	
	Dr Structure, Temp Lowering, Modified
	 _Dr Structure, Temp Lowering, Modified Gate Box, Adj, Case 1
AB	• _Gate Box, Adj, Case 1
	• _Monument Box Adjust
ADST	Nonument Box Adjust
AK	• _Dr Structure, Adj, Case 1, Modified
AN	 Sidewalk, Sidewalk Ramp, and Driveway Approach, Any Thickness, Re
C4	 Grading, Sidewalk
04	• _Sidewalk, Conc, 4 inch, Modified
	 _Sidewalk, Sidewalk Ramp, and Driveway Approach, Any Thickness, Re
	 Grading, Sidewalk
C4HE	Cement
	 _Sidewalk, Conc, 4 inch, Modified
	 Sidewalk, Sidewalk Ramp, and Driveway Approach, Any Thickness, Re
	 Grading, Sidewalk
	Grading, Sidewalk Ramp
C6	Detectable Warning Surface, Modified
	_Sidewalk Ramp, Conc, 6 inch, Modified
	 Sidewalk, Conc, 6 inch, Modified
	Grading, Driveway Approach
C8	
	 Sidewalk, Sidewalk Ramp, and Driveway Approach, Any Thickness, Re
	• _Grading, Driveway Approach
	Grading, Sidewalk
	• _Grading, Sidewalk Ramp
	Cement
C HE	 Driveway, Nonreinf Conc, 6 inch, Modified
	 Driveway, Nonreinf Conc, 8 inch, Modified
	Detectable Warning Surface, Modified
	 Sidewalk Ramp, Conc, 6 inch, Modified
	 _Sidewalk, Conc, 6 inch, Modified
010	Curb, Gutter, and Curb and Gutter, Any Type, Rem
C/G	Curb and Gutter, Conc
	_Curb, Gutter, and Curb and Gutter, Any Type, Rem
C/GHE	• Cement
	 _Driveway Opening, Conc, Det M, Modified
CD	Grading, Sidewalk
CP	 Sidewalk, Conc, 4 inch, Modified
CR	• _Sidewalk, Sidewalk Ramp, and Driveway Approach, Any Thickness, Re
	Dr Structure, Rem
DS	• Sewer, Rem, Less than 24 inch
	Dr Structure, 24 inch dia
	Dr Structure, Rem
DSDI	Sewer, Rem, Less than 24 inch
	_Dr Structure, Double Inlet
PT	_Dr Structure, Point
	Dr Structure Cover, Type B
	_Dr Structure Cover, Type B, Special
RRA	_Dr Structure, Adj, Case 1, Modified
	_Dr Structure, Temp Lowering, Modified
	Dr Structure Cover, Type K
RRK	_Dr Structure, Adj, Case 1, Modified
RS	Dr Structure, Reconstruct
	Plastic Drum, High Intensity, Lighted, Furn
TYPE II	Plastic Drum, High Intensity, Lighted, Oper
	Barricade, Type III, High Intensity, Double Sided, Lighted, Furn
TYPE III	

CITY OF ANN ARBOR PROJECT MANAGEMENT

ITB No. 4477 FILE No. 2017-004

	LEGEND		
SYMBOL	DESCRIPTION		
S	EXISTING SANITARY SEWER MANHOLE		
(r)	EXISTING STORM SEWER MANHOLE		
\otimes	EXISTING WATER MAIN VALVE IN WELL		
+	WATER MAIN GATE VALVE IN BOX		
+Ŷ+	FIRE HYDRANT		
(g)	MICHCON GAS CO. VALVE BOX/WELL		
t	AMERITECH TELEPHONE VAULT		
e	ELECTRIC MANHOLE		
\bullet	SOIL BORING		
	EXISTING STORM SEWER INLET		
٥	MONUMENT BOX		
	REMOVE AND REPLACE CONC. SIDEWALK		
	PLACE CONCRETE SIDEWALK		
	REMOVE & REPLACE CONC. CURB & GUTTER		
	CONSTRUCTION LIMITS		
— · —	- 6" WRAPPED UNDERDRAIN		
	REMOVE CONCRETE SIDEWALK		
	SUBGRADE UNDERCUT		

CONSTRUCTION METHOD AND SEQUENCING


WORK ON THIS STREET INCLUDES, BU ACCORDANCE WITH THE PLANS AND SP TWO (2) PHASE CONSTRUCTION. PER AUTHORIZED OR DIRECTED BY THE E CURRENTLY IN PLACE, LANE CLOSURES

<u>PHASE I</u>

- IMPLEMENT MAINTENANCE OF TRAFF CONTROL MEASURES.
- 2. CONDUCT REMOVAL WORK RELATED COLDMILLING.
- 3. INSTALL PROPOSED DRAINAGE STRU
- PERFORM ALL CONCRETE WORK, IN
- 5. REMOVE 2 INCHES OF EXISTING HM
- 6. PERFORM ALL JOINT AND CRACK (REQUIRED.
- 7. CLEAN PAVEMENT AND PLACE 2 IN <u>PHASE II</u>
- 8. REPEAT ITEMS 1 THRU 6 IN THE OF
- 9. REMOVE 2 INCHES OF EXISTING HM
- 10. PERFORM ALL JOINT AND CRACK C REQUIRED.
- 11. CLEAN PAVEMENT AND PLACE 2 IN
- 12. CLEAN PAVEMENT AND PLACE HMA
- 13. CLEAN PAVEMENT AND COMPLETE
- 14. COMPLETE ALL MISCELLANEOUS CO
- 15. REMOVE ALL TRAFFIC CONTROL DEV

		QUANTITIES Sign, Type B, Temp, Prismatic		
Quantity	Sign Code	Description	Area (sft)	Total Area
17.0	D3-1	Street Name Sign	4.000	68.000
1.0	M4-10R	Detour Arrow Sign	6.000	6.000
1.0	M4-8a	End Detour Sign	3.000	3.000
7.0	M4-9L	Detour Sign (w/Left Arrow)	5.000	35.000
1.0	M4-9R	Detour Sign (w/Right Arrow)	5.000	5.000
6.0	M4-9S	Detour Sign (w/Thru Arrow)	5.000	30.000
2.0	R5-1	Do Not Enter Sign	6.250	12.500
2.0	R5-1A	Wrong Way Sign	6.000	12.000
3.0	R11-2	Road Closed Sign ("Road Closed")	10.000	30.000
1.0	R11-4	Road Closed Sign ("Road Closed To Thru Traffic")	12.500	12.500
3.0	R3-1	Movement Prohibition Sign ("No Right Turn")	4.000	12.000
2.0	R3-2	Movement Prohibition Sign ("No Left Turn")	4.000	8.000
3.0	R6-1 L	One Way (Left) Sign	3.000	9.000
3.0	R6-1R	One Way (Right) Sign	3.000	9.000
7.0	SP-1	Special Sign	20.000	140.000
9.0	W20-1	Road Work Ahead Sign	9.000	81.000
2.0	W20-2	Detour Ahead Sign	9.000	18.000
1.0	W20-3	Road Closed Ahead Sign	9.000	9.000
			TOTAL	500.00



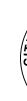


PROJECT CONTRACT DOCUMENTS.	PROJECT	
IMPROVEMENTS COVERED BY THESE PLANS SHALL BE PERFORMED IN ACCORDANCE MICHIGAN DEPARTMENT OF TRANSPORTATION (MDOT) 2012 STANDARD CIFICATIONS FOR CONSTRUCTION, INCLUDING REFERENCED MDOT PUBLICATIONS, AND		
UNDERGROUND LOCATIONS SHOWN FOR NATURAL GAS, TELEPHONE, ELECTRICAL ER, CABLE TV AND FIBER OPTIC LINES ARE APPROXIMATE. THE CITY OF ANN DR ASSUMES NO RESPONSIBILITY FOR THEIR ACCURATE REPRESENTATION IN THIS MING. MISS DIG MUST BE CONTACTED PRIOR TO CONSTRUCTION TO LOCATE THESE TIES.	MANAGEMENT	
PROTECTION OF UNDERGROUND UTILITIES AND IN CONFORMANCE WITH PUBLIC ACT OF 2013, THE CONTRACTOR SHALL CALL 811 OR 1-800-482-7171 A MINIMUM OF E FULL WORKING DAYS, EXCLUDING SATURDAYS, SUNDAYS, AND HOLIDAYS, PRIOR BEGINNING EACH EXCAVATION IN AREAS WHERE PUBLIC UTILITIES HAVE NOT BEEN /IOUSLY LOCATED. MEMBERS WILL THUS BE ROUTINELY NOTIFIED. THIS DOES NOT EVE THE CONTRACTOR OF THE RESPONSIBILITY OF NOTIFYING UTILITY OWNERS MAY NOT BE A PART OF THE "MISS DIG" ALERT SYSTEM.	ENT - PUBLIC	PROJECT DESCRIPTION
TES:		ANNUAL
VICES, AND MISS DIG FLAGS.	SERVICES	
INSTRUCTION INCLUDING ALL CLEAN UP AND FINAL RESTORATION.	ы СШ СШ	STRE
ALL PAVEMENT MARKINGS.	•	ET R
A APPROACHES AS REQUIRED.	CIT	RESL
NCH TOP COURSE HMA MIX (LVSP).	Y OF	JRFACING
CLEANOUT. HMA/HAND PATCHING, UNDERCUTS AND/OR BASE REPAIRS AS	ANN	SNIC
IA SURFACE BY COLDMILLING.	N	- 201
ORDER SHOWN SHOWN ABOVE.	ARBOR	117
NCH TOP COURSE HMA MIX (LVSP).	В	
CLEANOUT. HMA/HAND PATCHING, UNDERCUTS AND/OR BASE REPAIRS AS		
IA SURFACE BY COLDMILLING.		
UCTURES, STORM SEWER, AND UNDERDRAIN AS REQUIRED.		
D TO PAVEMENT, DRAINAGE, AND CONCRETE ITEMS WITH EXCEPTION TO		
FIC (M.O.T.) PLAN, AND INSTALL SOIL EROSION AND SEDIMENTATION		
PECIFICATIONS, AS DIRECTED BY THE ENGINEER, AND UTILIZING PART WIDTH RFORM THE WORK IN THE ORDER INDICATED BELOW UNLESS OTHERWISE ENGINEER. COMPLETE ITEMS 12 THRU 14 UTILIZING THE M.O.T. PLAN , AND FLAG CONTROL OPERATIONS AS DIRECTED BY THE ENGINEER.		

301 EAST HURON STREET, P.O. BOX 8647 ANN ARBOR, MICHIGAN 48107-8647 734-794-6410 www.a2gov.org

PROJECT DESCRIPTION ANNUAL STREET RESURFACING - 2017	S UNIVERSITY AVENUE
T No. 16 OF	DRAWING No. 2017004-116
	PROJECT DESCRIPTION






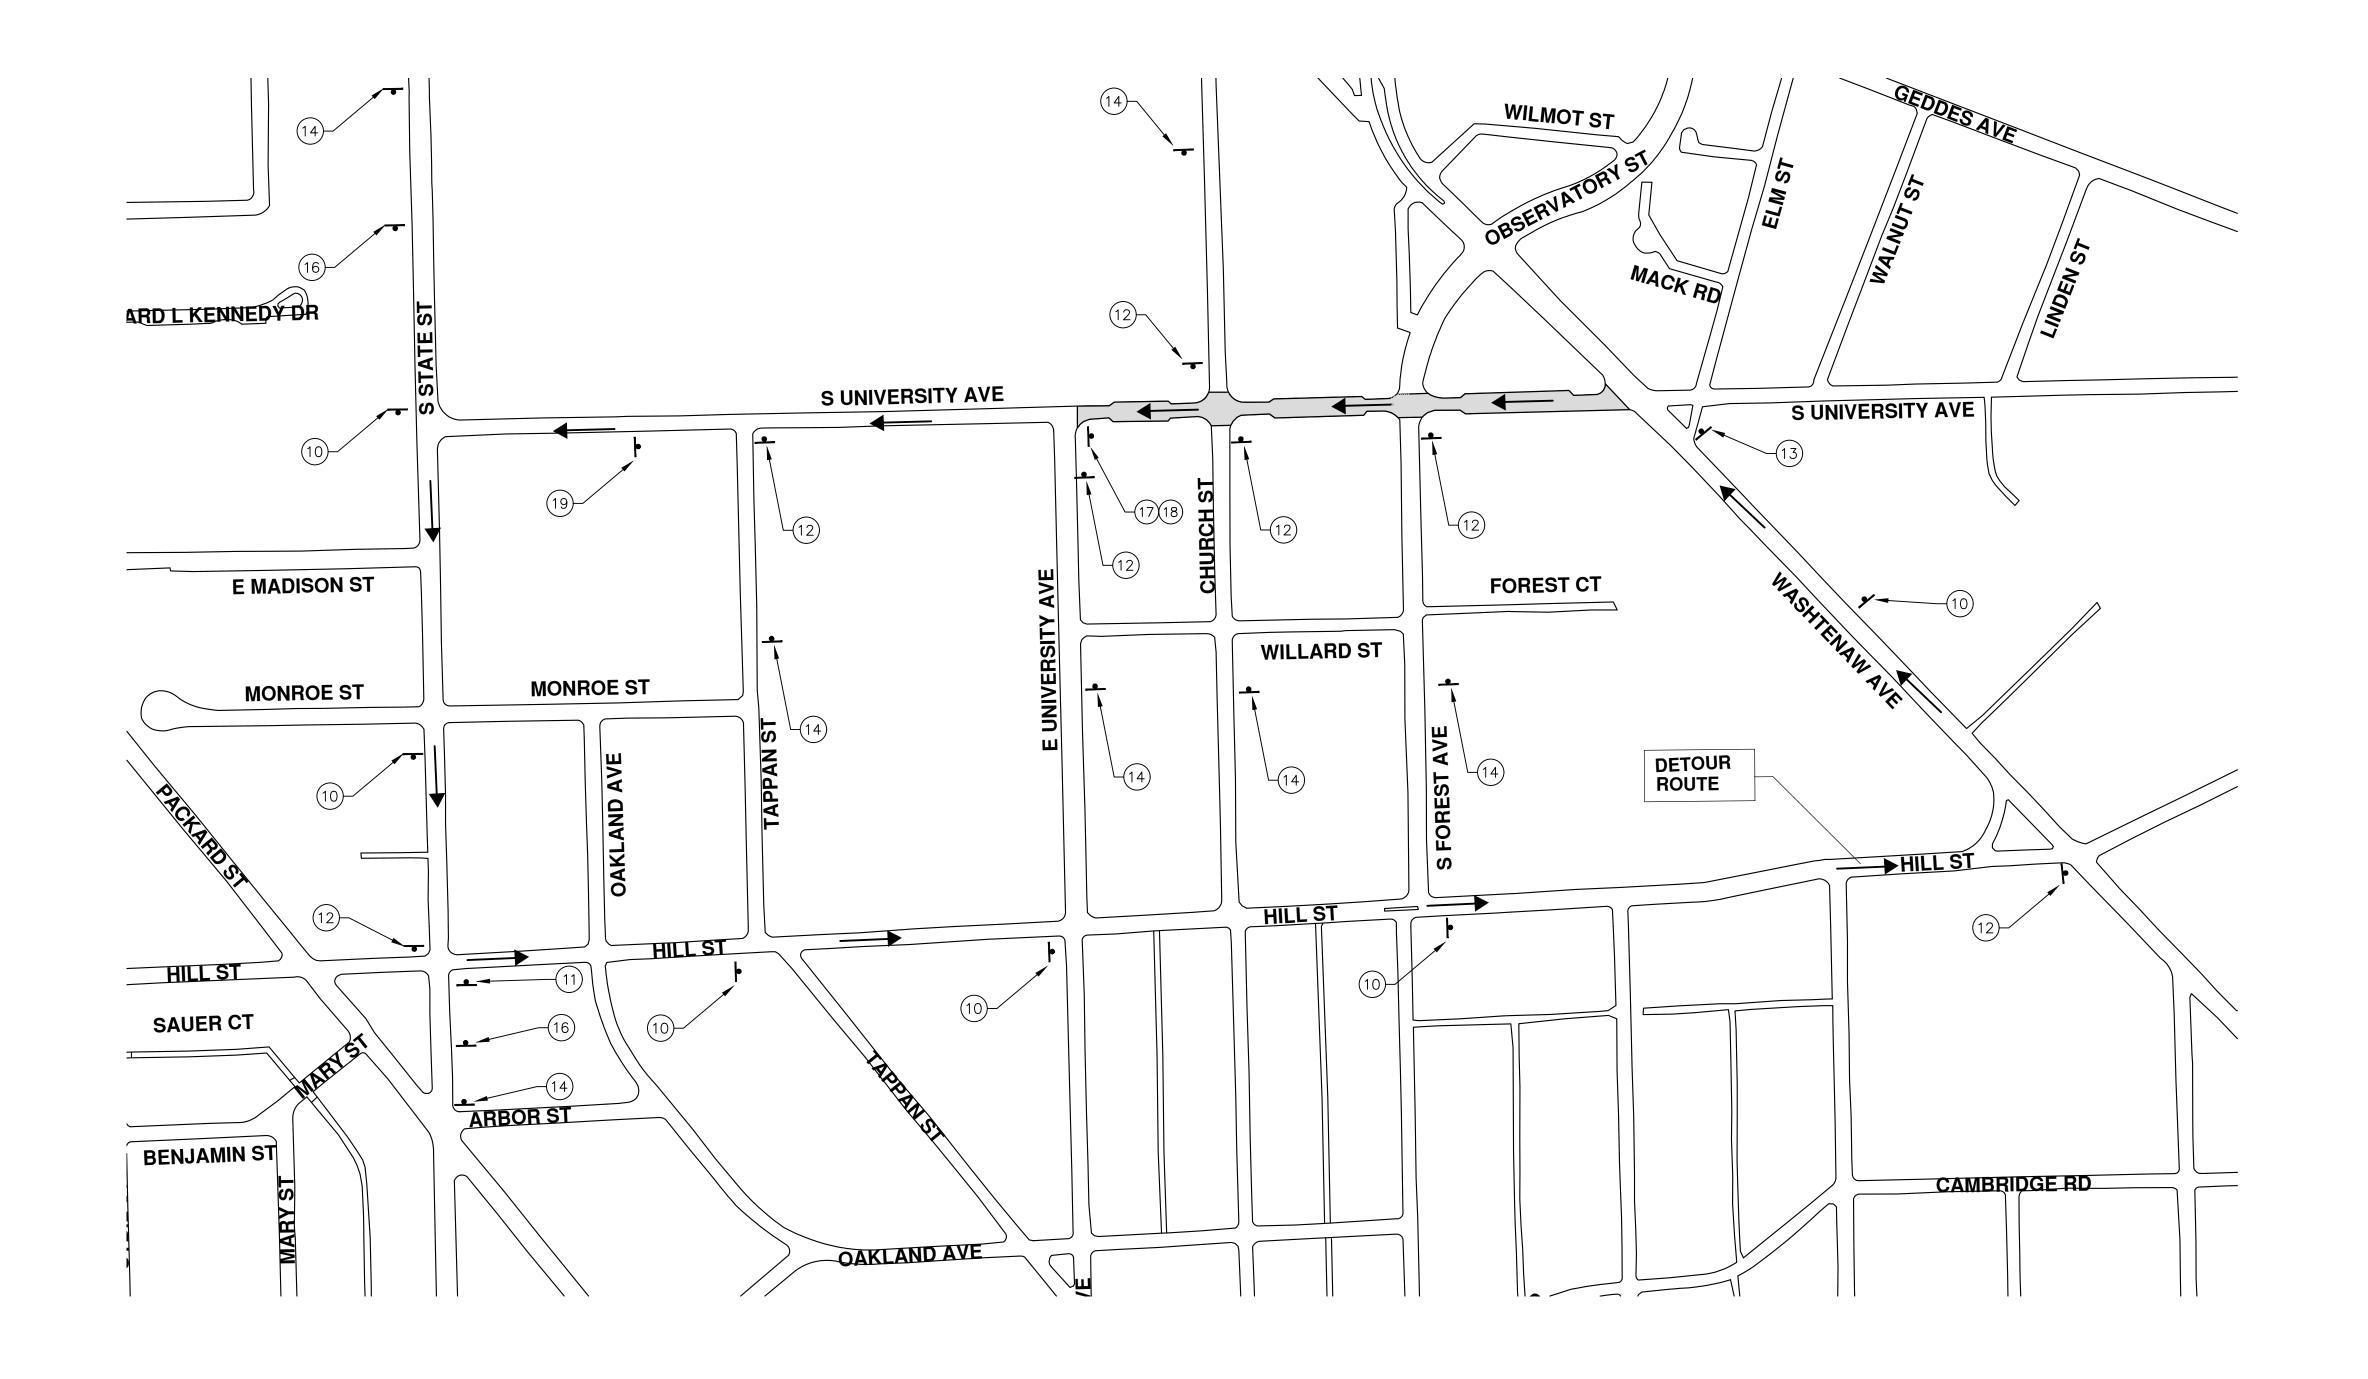


	50" A 0" 3 6"	AL) 2 56"	a 3 AL)	1 9L 4	PR 4	N I. 1 VS 4 1			
	ANAGEMENT - PUBLIC SERVICES - CITY OF ANN ARI	N ARBOR	OF ANN NUMBER BAN	CITY OF ANN ABBOB					Ŀ
☐ SCALE PLAN: 1" = 200' .0	ANNUAL STREET RESURFACING - 2017	G - 2017	ARBO TI	PUBLIC SERVICE 301 EAST HURON STREET					
	S UNIVERSITY AVENUE		DR DR DR	P.O. BOX 8647 ANN ARBOR, MI 48107-8647	01 AD	01 ADDENDUM #1	03-24-17	AG,GS,RG DAD	
DRAWING No.			A POORDAATED AN	734-794-6410 www.a2gov.org	00 BIE	BID SET	03-08-17	AG,GS,RG DAD	Know what's below.
2017004-117	DELOUR		CHIGH.		REV.	DESCRIP TION	DATE	DRAWN CHECKED	Call before you dig.

117 OF 136




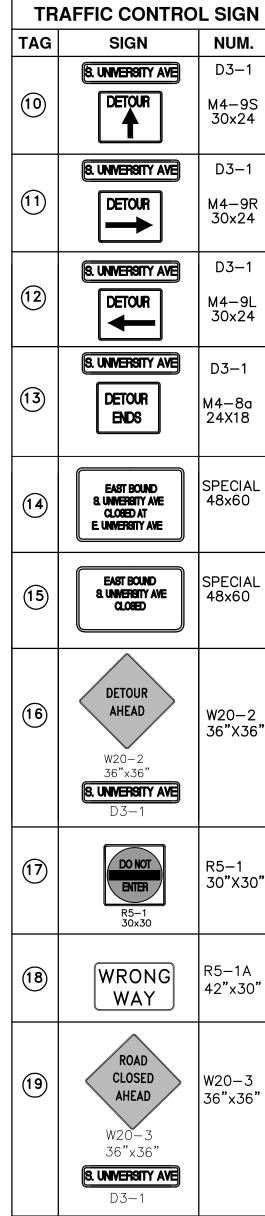


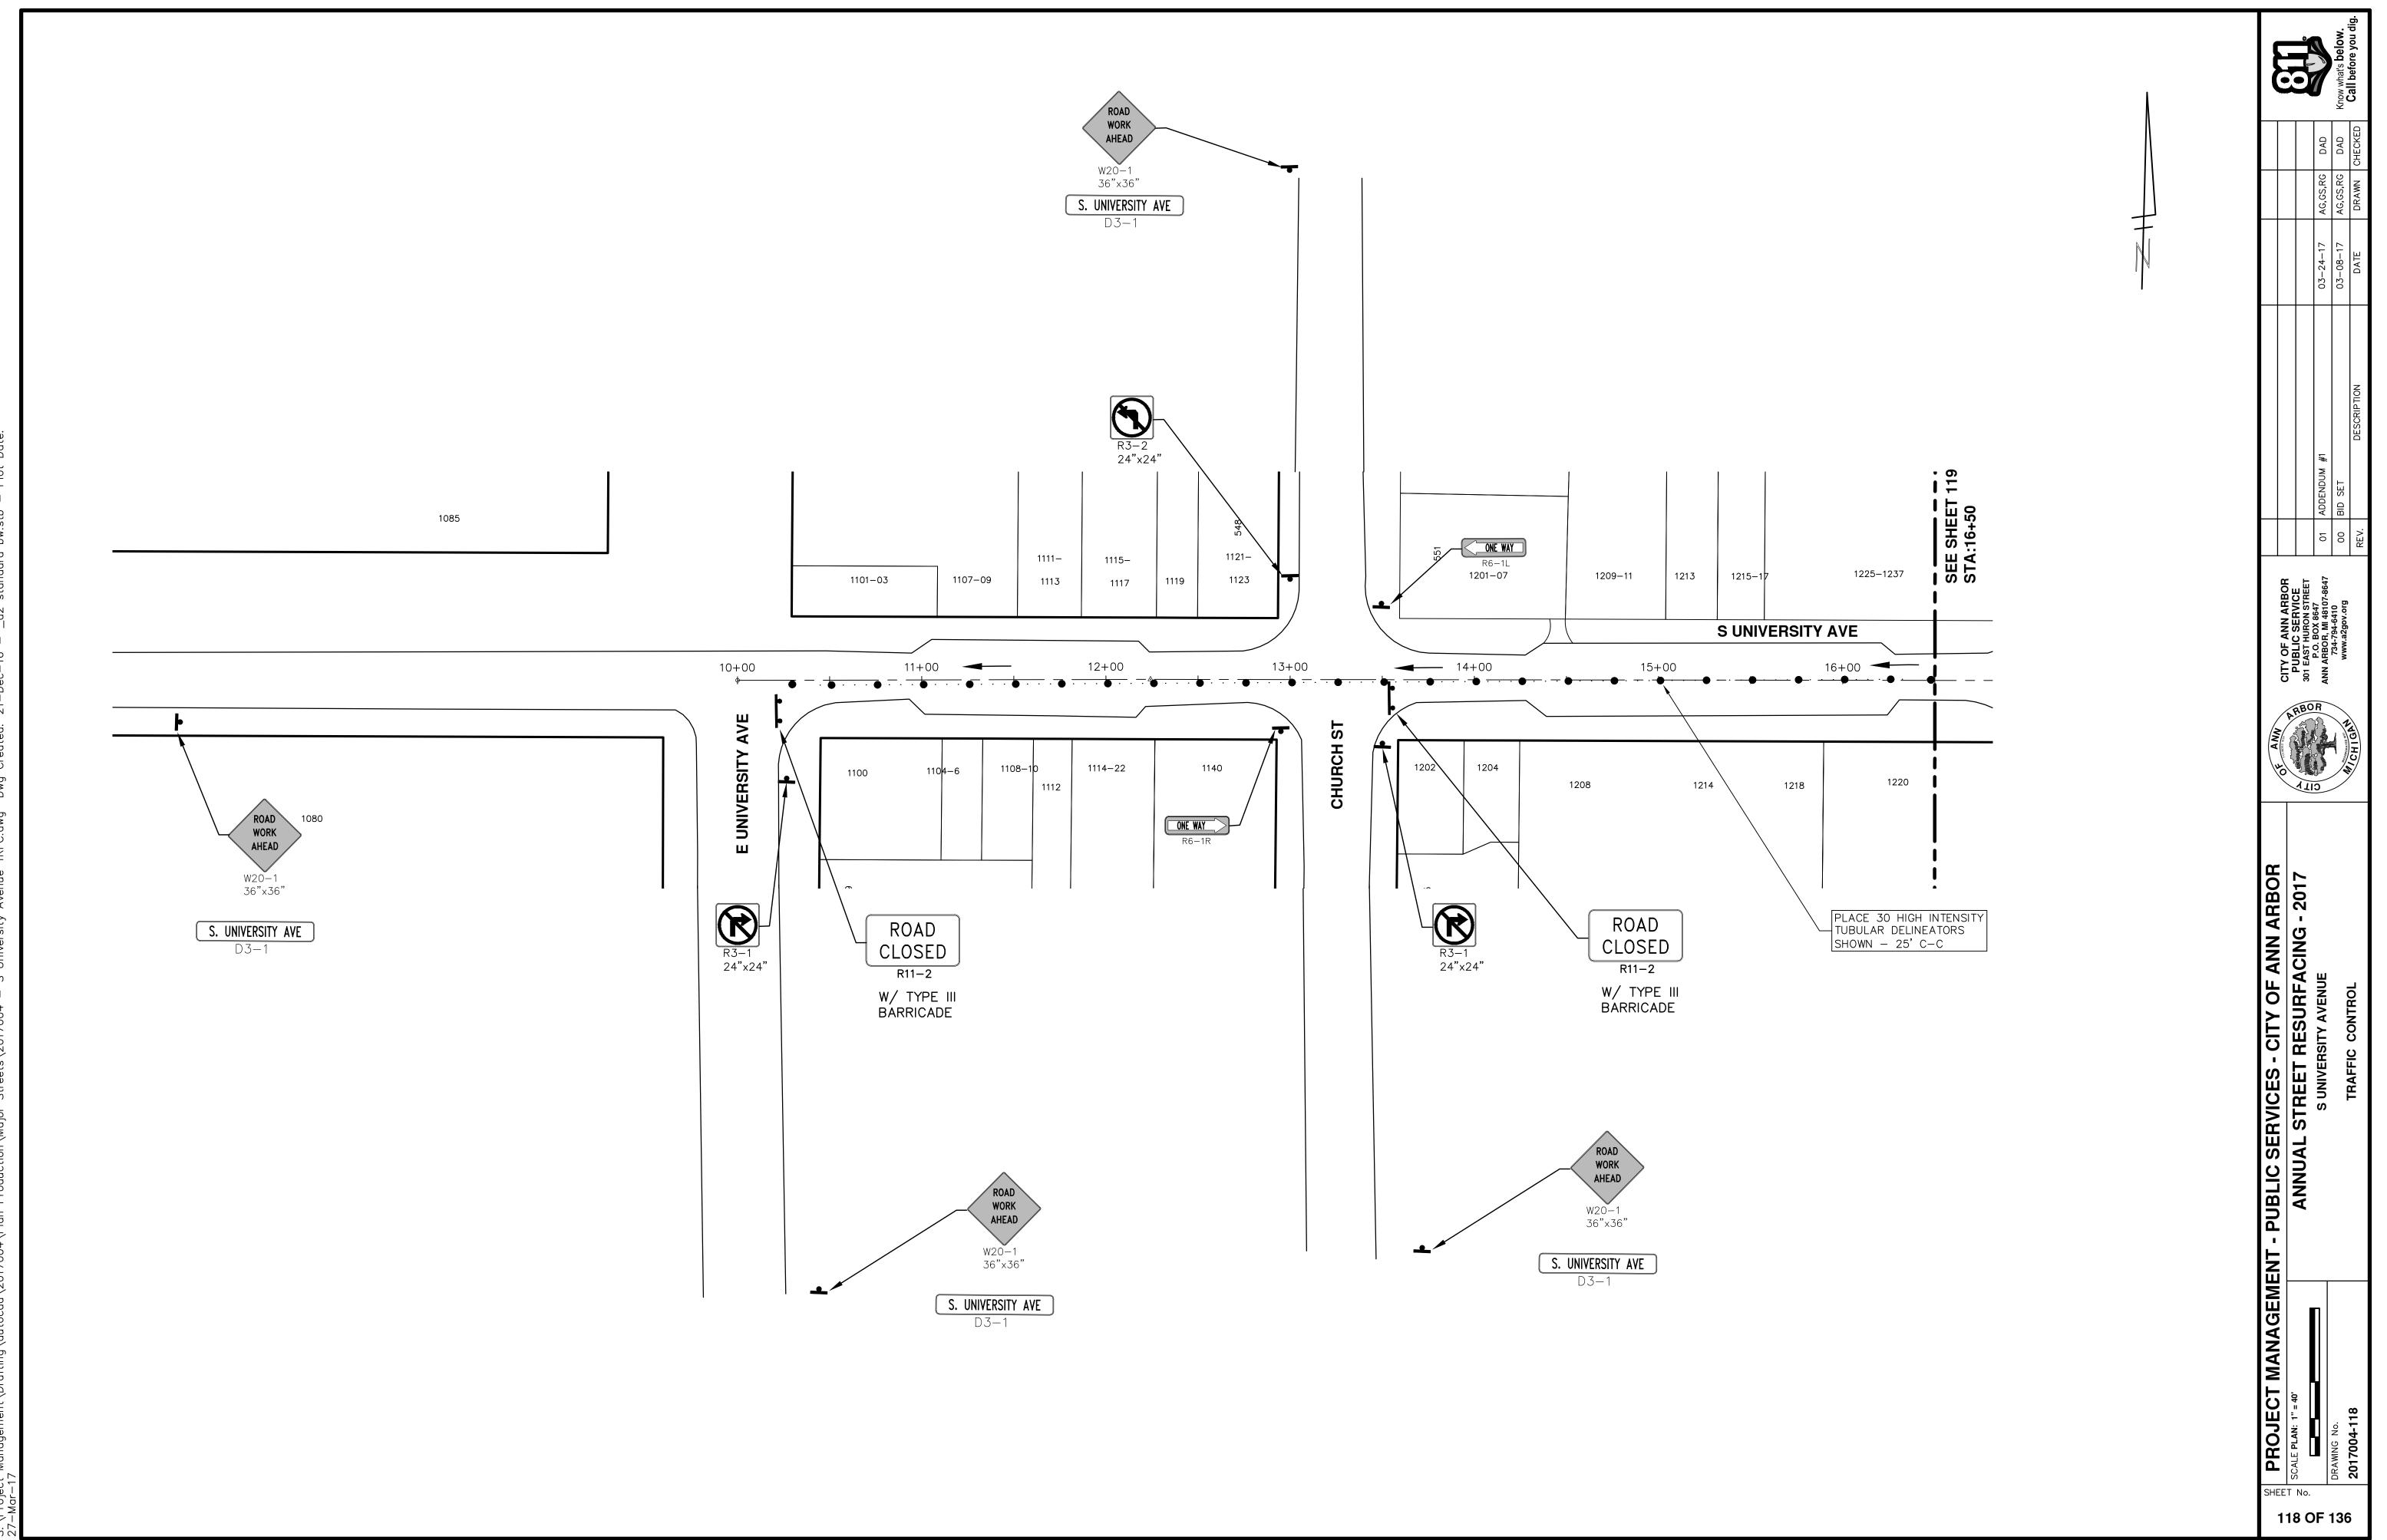



S \Proje Si si



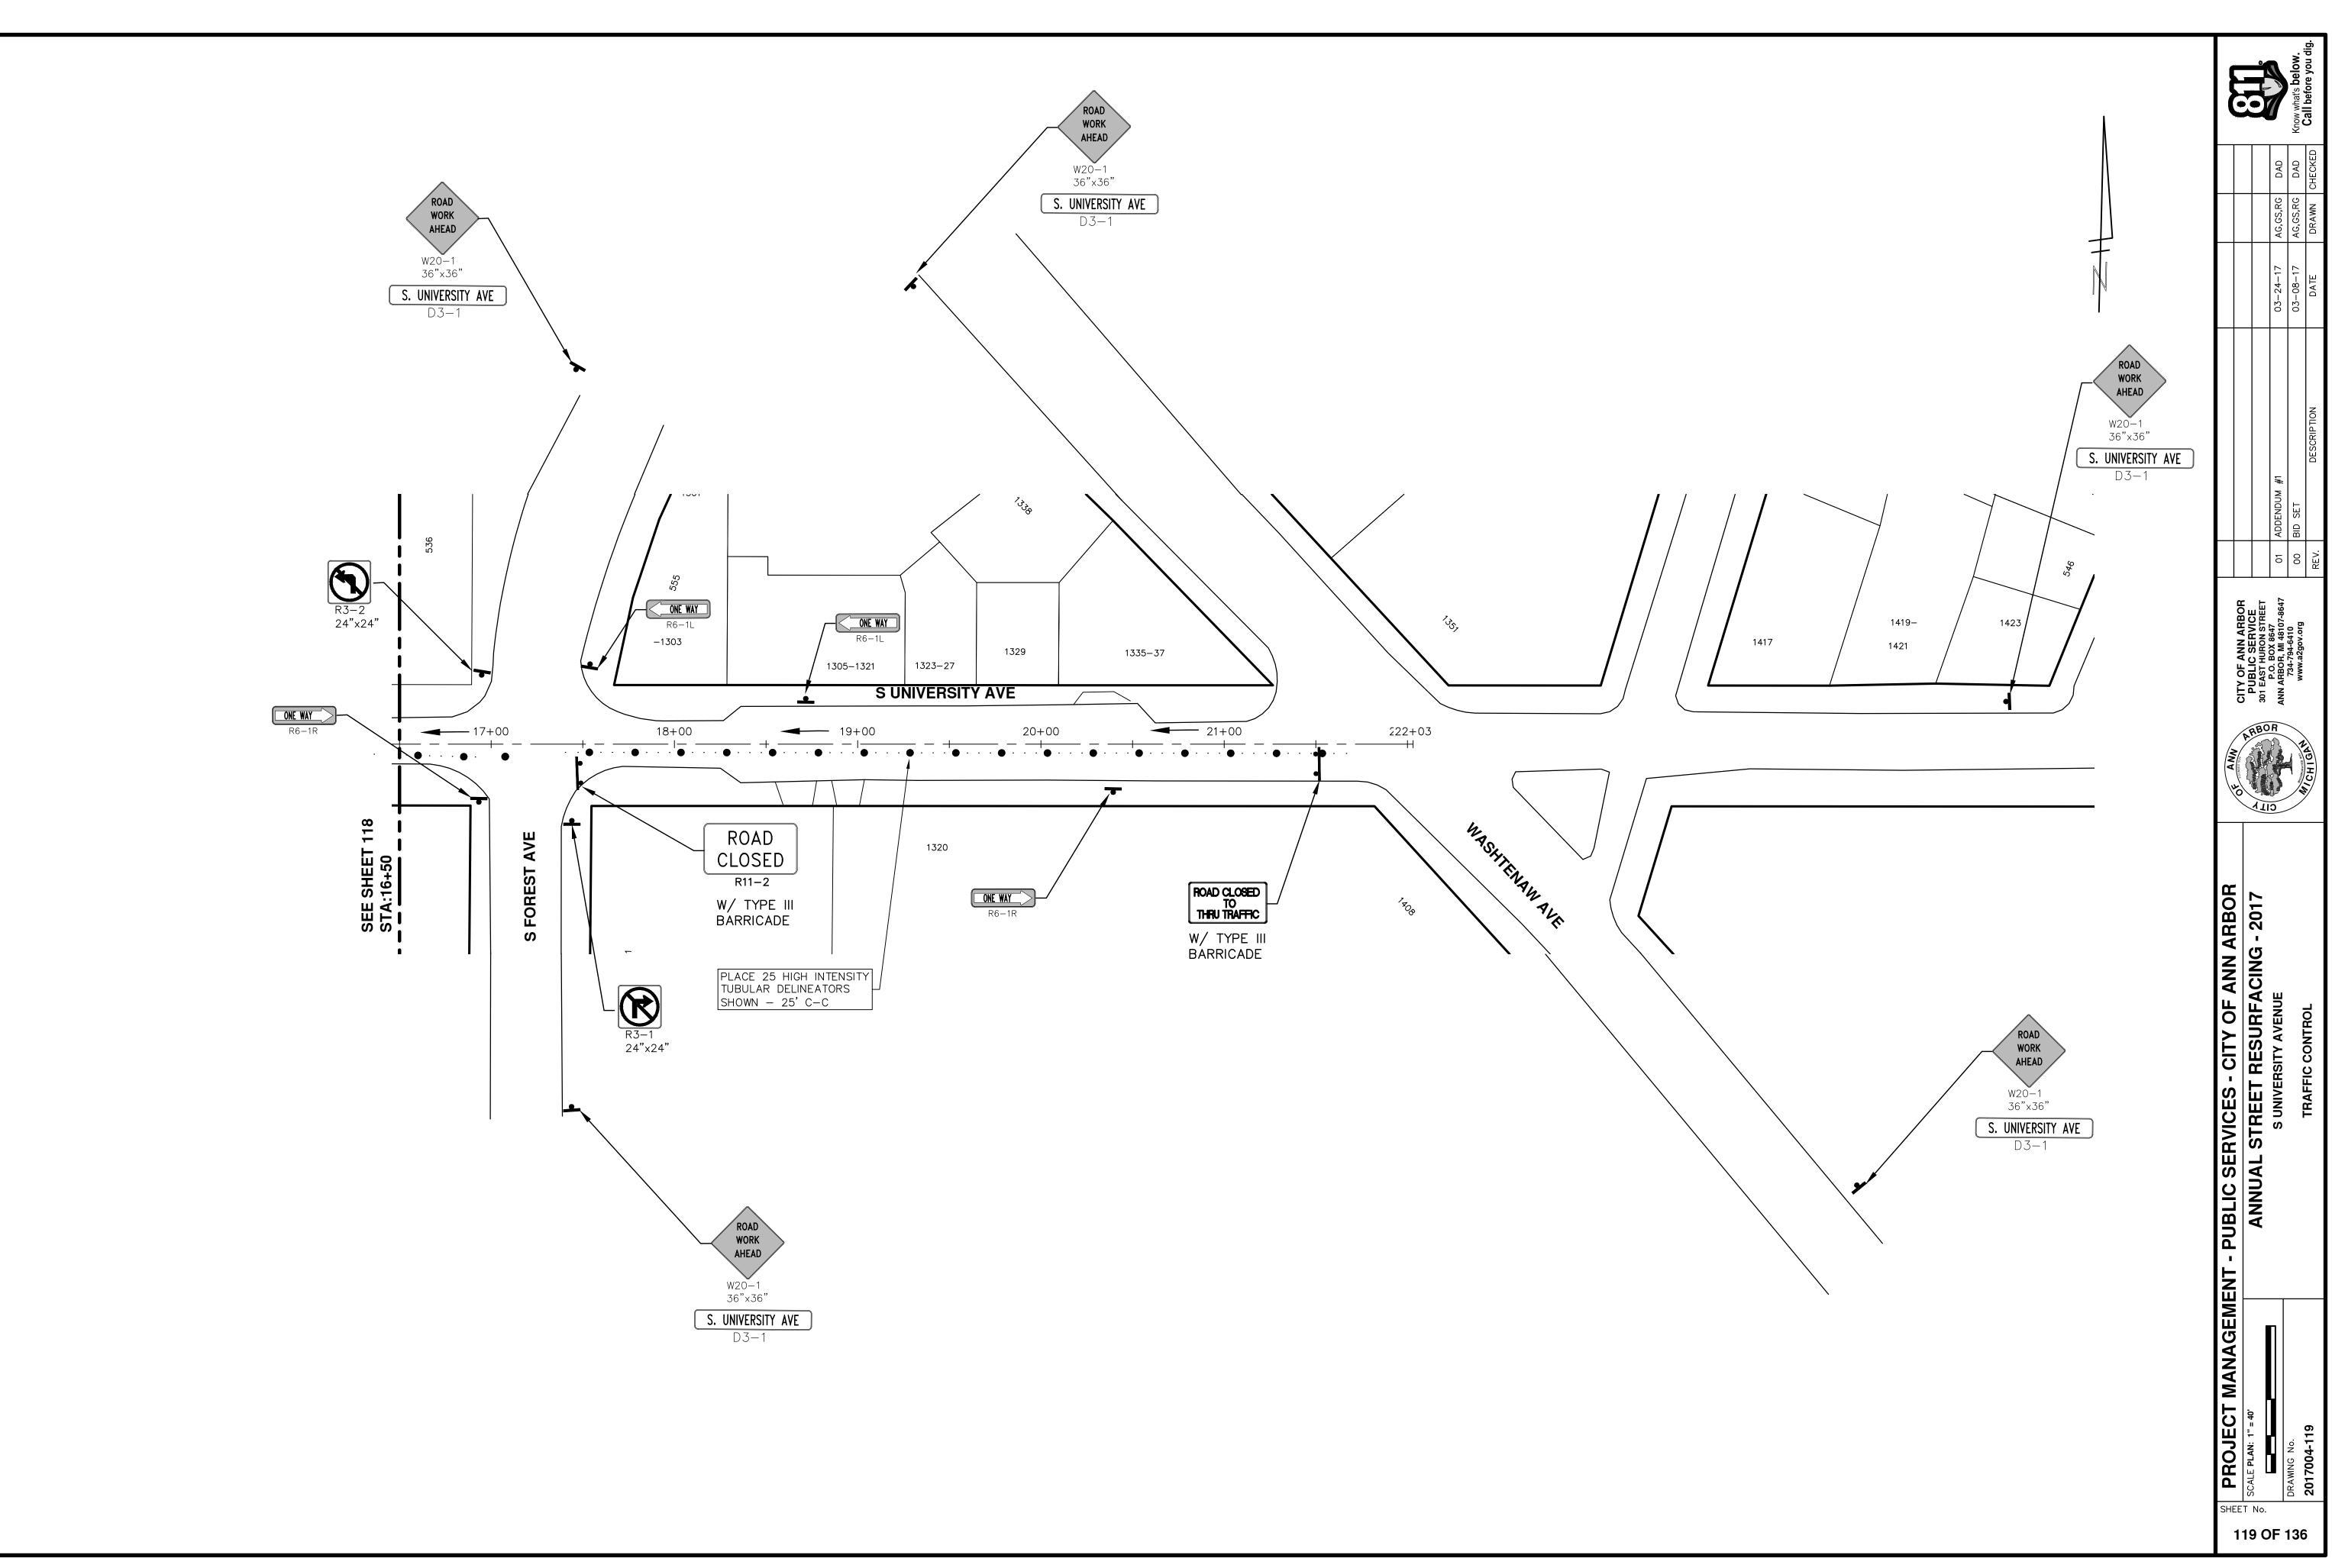

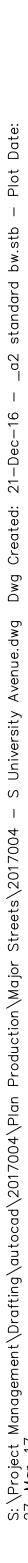

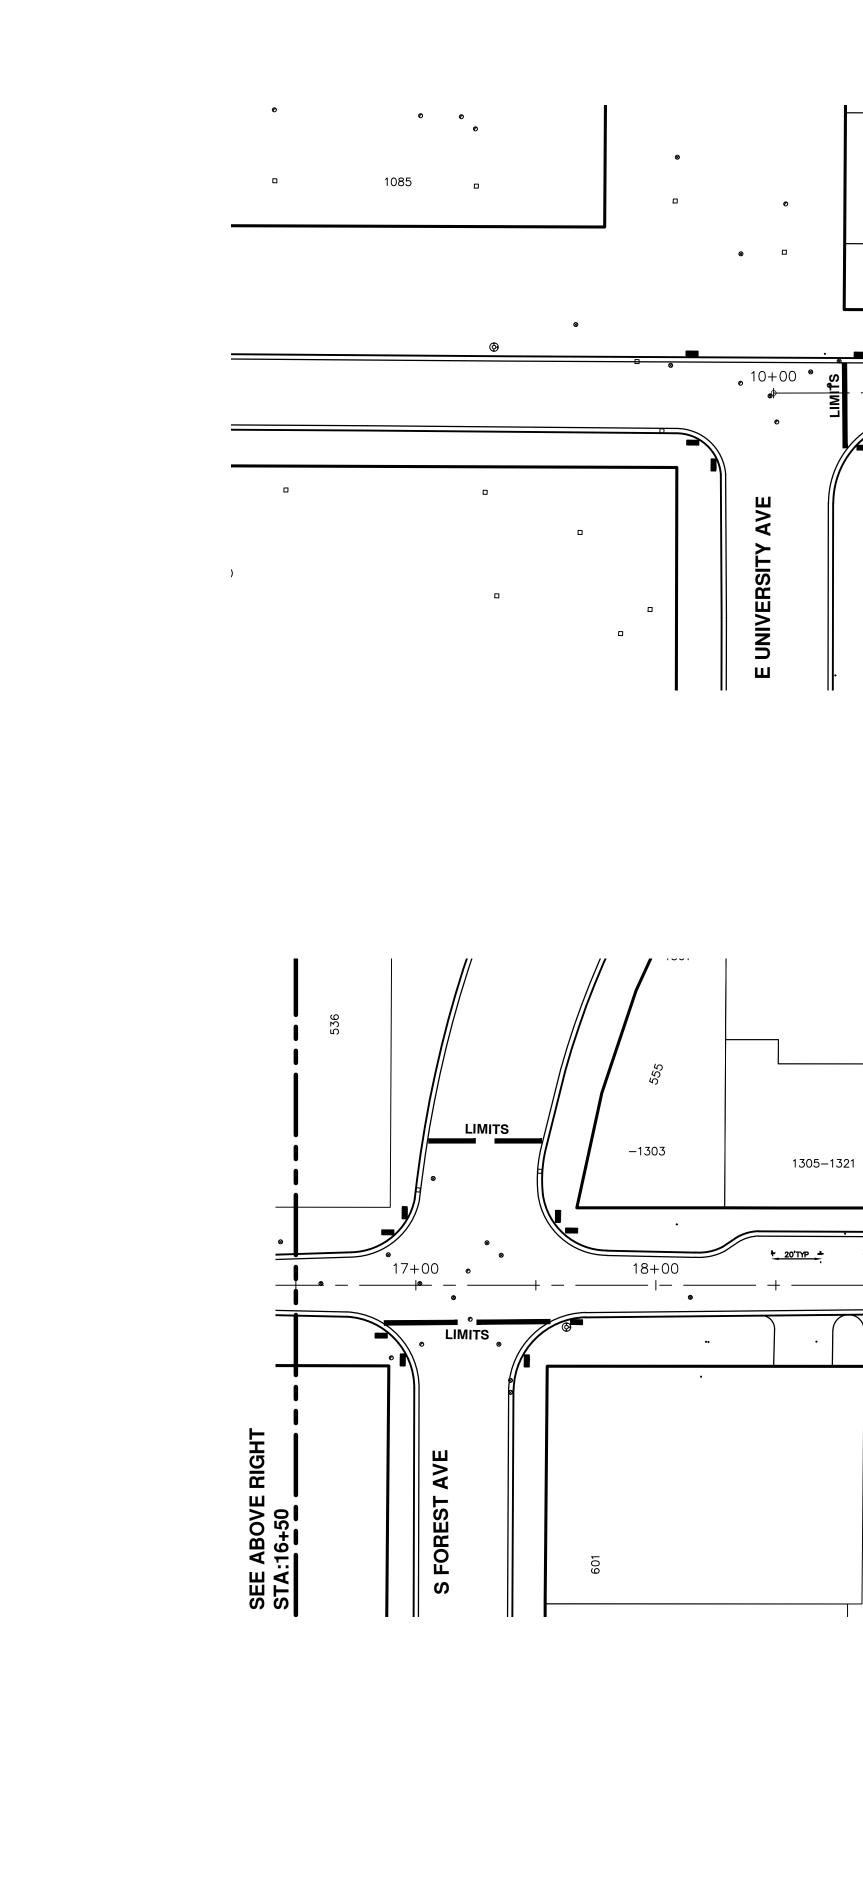

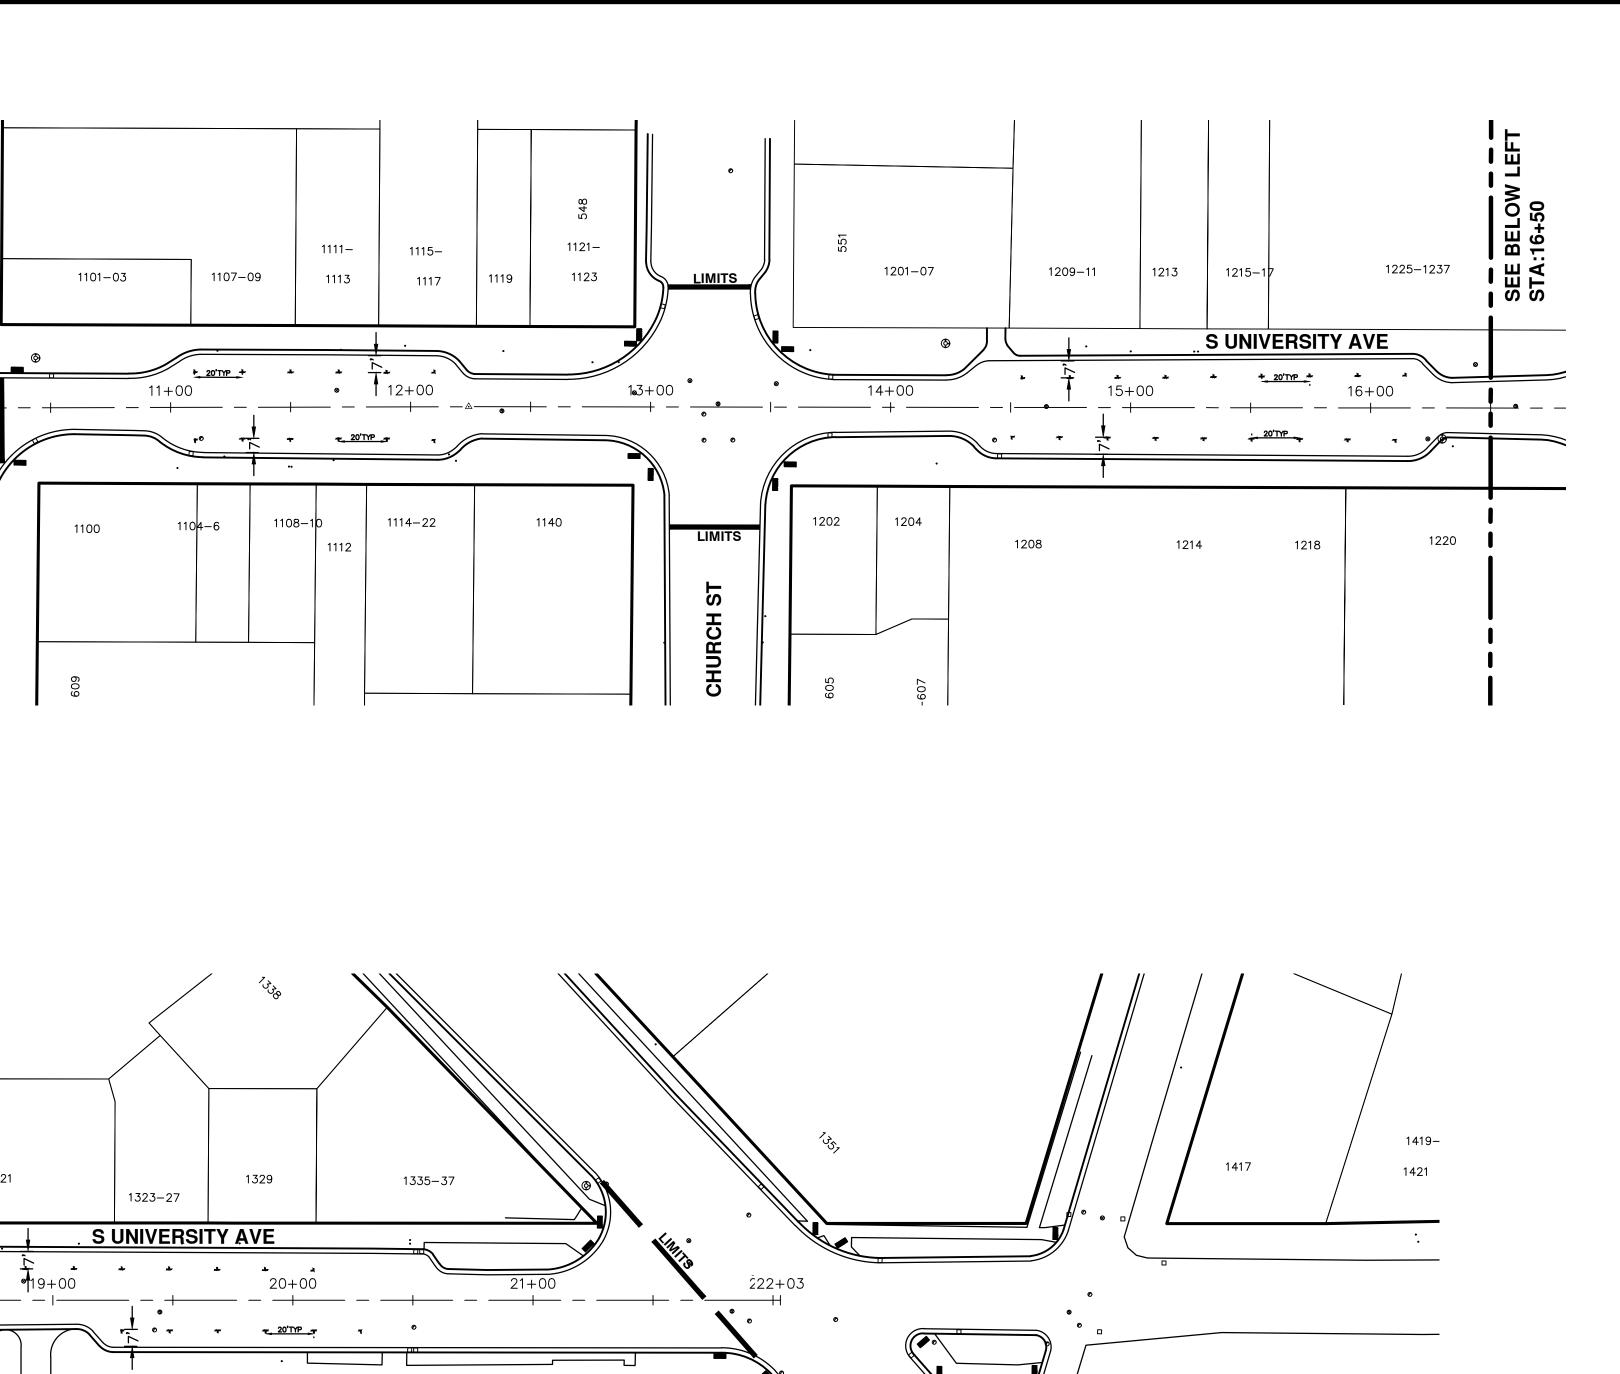

1320

ø


d


TOO

/

MASHTENAN ALE

 \mathbb{N}

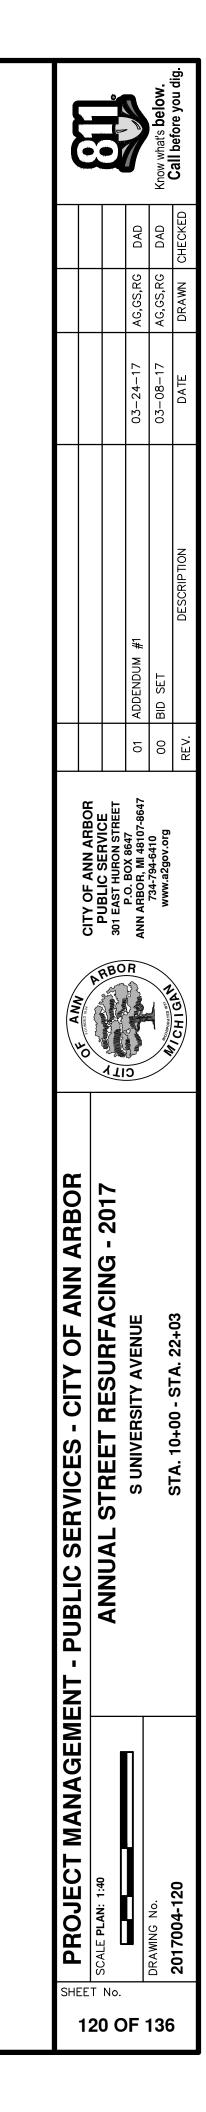

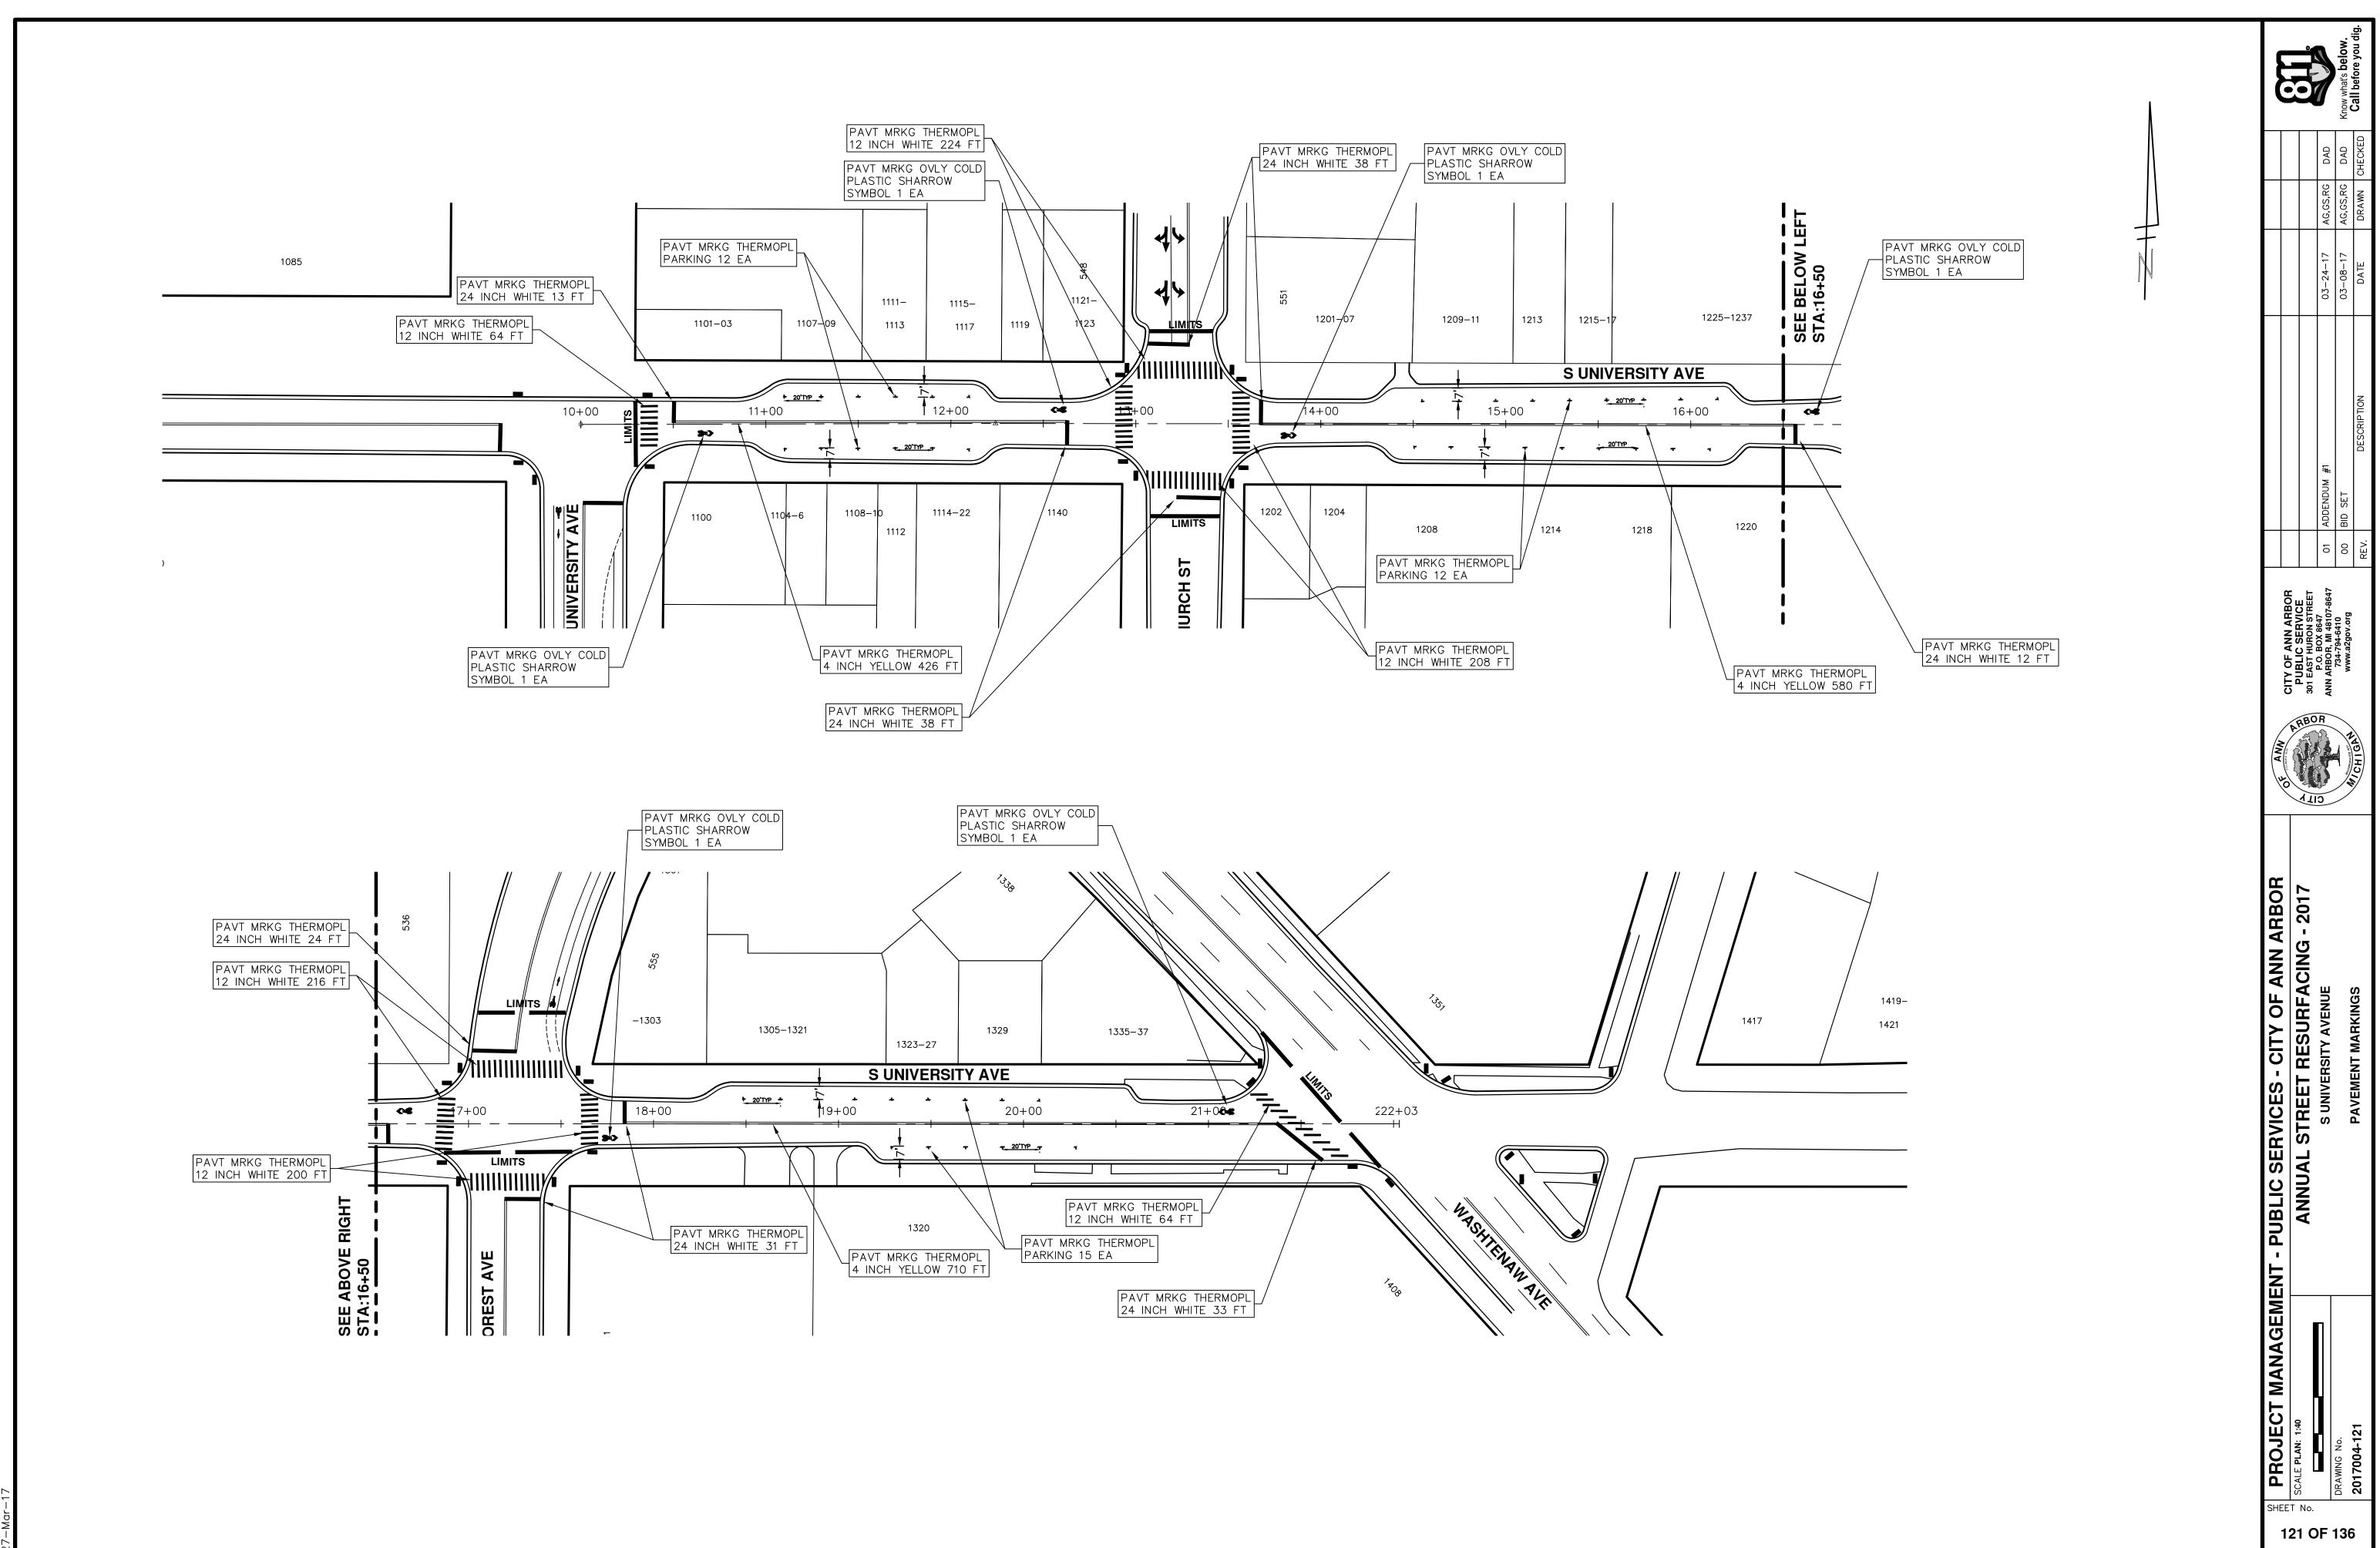



ltem Code	Item Description	Units	Quantity
2047001	_Curb, Gutter, and Curb and Gutter, Any Type, Rem	Ft	254.000
2047011	_Sidewalk, Sidewalk Ramp, and Driveway Approach, Any Thickness, Rem	Syd	191.000
2057011	_Grading, Sidewalk	Syd	73.000
2057011	 Grading, Sidewalk Ramp	Syd	120.000
2057021	_Subgrade Undercutting, Type IIA	Cyd	177.000
2080020	Erosion Control, Inlet Protection, Fabric Drop	Ea	13.000
4037050	_Dr Structure, Adj, Case 1, Modified	Ea	1.000
5010003	Cold Milling HMA Surface	Ton	1,240.000
5010005	HMA Surface, Rem	Syd	70.000
5010025	Hand Patching	Ton	3.000
5010057	HMA, 5E3	Ton	1,196.000
5010061	HMA, Approach	Ton	53.000
5017050	_HMA Surface, Around Structure Cover, Rem	Ea	7.000
6027021	Flowable Fill	Cyd	9.407
8027001	Curb and Gutter, Conc	Ft	254.000
8037001	 Detectable Warning Surface, Modified	Ft	100.000
8037010	Sidewalk Ramp, Conc, 6 inch, Modified	Sft	1072.000
8037010		Sft	650.000
8110049	Pavt Mrkg, Ovly Cold Plastic, Direction Arrow Sym, Bike	Ea	11.000
8110058	Pavt Mrkg, Ovly Cold Plastic, Bike, Small Sym	Ea	11.000
8110520	Pavt Mrkg, Wet Retrflec, Thermopl, 4 inch, White	Ft	1,639.000
8110521	Pavt Mrkg, Wet Retrflec, Thermopl, 6 inch, White	Ft	3,076.00
8110524	Pavt Mrkg, Wet Retrflec, Thermopl, 4 inch, Yellow	Ft	6,568.000
8117001	_Pavt Mrkg, Wet Retrflec, Thermopl, 12 inch, Crosswalk	Ft	112.000
8117001	_Pavt Mrkg, Wet Retrflec, Thermopl, 24 inch, Stop Bar	Ft	34.000
8117050	_Pavt Mrkg, Wet Retrflec, Thermopl, Only	Ea	5.000
8117050	_Pavt Mrkg, Wet Retrflec, Thermopl, Lt Turn Arrow Sym	Ea	2.000
8120012	Barricade, Type III, High Intensity, Double Sided, Lighted, Fum	Ea	6.000
8120013	Barricade, Type III, High Intensity, Double Sided, Lighted, Oper	Ea	6.000
8120140	Lighted Arrow, Type C, Furn	Ea	2.000
8120141	Lighted Arrow, Type C, Oper	Ea	2.00
8120260	Plastic Drum, High Intensity, Lighted, Furn	Ea	150.000
8120261	Plastic Drum, High Intensity, Lighted, Oper	Ea	150.00
8120331	Sign, Portable, Changeable Message, Oper	Ea	4.000
8120350	Sign, Type B, Temp, Prismatic, Furn	Sft	493.00
8120351	Sign, Type B, Temp, Prismatic, Oper	Sft	493.00
8167011	Slope Restoration	Syd	94.000

						PLACE, LANE CL
			LEGEND	PHASE	<u>E I</u>	
KEY	ASSOCIATED PAY ITEM(S) • _Dr Structure, Adj, Case 1, Modified	SYMBOL	DESCRIPTION	1 IN		MAINTENANCE
AA	_Dr Structure, Adj, Case 2, Modified	<u> </u>	EXISTING SANITARY SEWER MANHOLE		CONTROL M	
	_Dr Structure, Temp Lowering, Modified Dr Structure, Temp Lowering, Modified		EXISTING STORM SEWER MANHOLE	2 0	CONDUCT R	EMOVAL WORK
AB	• _Gate Box, Adj, Case 1	<u>⊗</u>	EXISTING WATER MAIN VALVE IN WELL		OLDMILLIN	
	 _Gate Box, Adj, Case 2 Monument Box Adjust 			3 11	NSTALL PR	
ADST	_Dr Structure, Adj, Add Depth, Modified	+	WATER MAIN GATE VALVE IN BOX			
AK	 _Dr Structure, Adj, Case 1, Modified _Sidewalk, Sidewalk Ramp, and Driveway Approach, Any Thickness, Rem 	+++++	FIRE HYDRANT	4. P	PERFORM A	LL CONCRETE V
C4	Grading, Sidewalk	<i>g</i>	MICHCON GAS CO. VALVE BOX/WELL	5. R	EMOVE 2	INCHES OF EXIS
	 _Sidewalk, Conc, 4 inch, Modified _Sidewalk, Sidewalk Ramp, and Driveway Approach, Any Thickness, Rem 	t	AMERITECH TELEPHONE VAULT	6 0		LL JOINT AND
C4HE	Grading, Sidewalk	e	ELECTRIC MANHOLE		EQUIRED.	
OHIL	Cement Sidewalk, Conc, 4 inch, Modified	•	SOIL BORING	7 0		
	Sidewalk, Conc, 4 mcn, Modified Sidewalk, Sidewalk Ramp, and Driveway Approach, Any Thickness, Rem			7. C	LEAN PAV	EMENT AND PLA
	Grading, Sidewalk		EXISTING STORM SEWER INLET			
C6	 Grading, Sidewalk Ramp Detectable Warning Surface, Modified 		MONUMENT BOX	PHASE	<u>- II</u>	
	 Sidewalk Ramp, Conc, 6 inch, Modified Sidewalk, Conc, 6 inch, Modified 		REMOVE AND REPLACE CONC. SIDEWALK	8. R	REPEAT ITE	MS 1 THRU 6 I
C8		· · · · · ·	PLACE CONCRETE SIDEWALK	9. R	EMOVE 2	INCHES OF EXIS
	Sidewalk, Sidewalk Ramp, and Driveway Approach, Any Thickness, Rem Grading, Driveway Approach		- REMOVE & REPLACE CONC. CURB & GUTTER		PERFORM A	LL JOINT AND
	• _Grading, Sidewalk		- CONSTRUCTION LIMITS	IX.		
	 Grading, Sidewalk Ramp Cement 		- 6" WRAPPED UNDERDRAIN	11. C	LEAN PAV	EMENT AND PLA
C HE				12. C	LEAN PAV	EMENT AND PLA
	Driveway, Nonreinf Conc, 8 inch, Modified			13 0		EMENT AND CO
	 _Detectable Warning Surface, Modified _Sidewalk Ramp, Conc, 6 inch, Modified 		SUBGRADE UNDERCUT	15. 0	LLAN FAV	EMENT AND CO
	Sidewalk, Conc, 6 inch, Modified			14. C	OMPLETE	ALL MISCELLANE
C/G	 _Curb, Gutter, and Curb and Gutter, Any Type, Rem 					
1	_Curb and Gutter, Conc			15. R	EMOVE AL	L TRAFFIC CON
0/01/5	Curb, Gutter, and Curb and Gutter, Any Type, Rem			15. R	REMOVE AL	L TRAFFIC CON
C/GHE	Curb, Gutter, and Curb and Gutter, Any Type, Rem Cement		QUANTITIES	15. R	EMOVE AL	L TRAFFIC CON
C/GHE CP	 Curb, Gutter, and Curb and Gutter, Any Type, Rem Cement Driveway Opening, Conc, Det M, Modified Grading, Sidewalk 		QUANTITIES Sign, Type B, Temp, Prismatic	15. R	EMOVE AL	L TRAFFIC CON
СР	 Curb, Gutter, and Curb and Gutter, Any Type, Rem Cement Driveway Opening, Conc, Det M, Modified Grading, Sidewalk Sidewalk, Conc, 4 inch, Modified 	Quantity Sigr	Sign, Type B, Temp, Prismatic	15. R		Total
CP CR	 Curb, Gutter, and Curb and Gutter, Any Type, Rem Cement _Driveway Opening, Conc, Det M, Modified _Grading, Sidewalk _Sidewalk, Conc, 4 inch, Modified _Sidewalk, Sidewalk Ramp, and Driveway Approach, Any Thickness, Rem Dr Structure, Rem 		Sign, Type B, Temp, Prismatic	15. R	Area (sft)	Total Area
СР	 Curb, Gutter, and Curb and Gutter, Any Type, Rem Cement _Driveway Opening, Conc, Det M, Modified _Grading, Sidewalk _Sidewalk, Conc, 4 inch, Modified _Sidewalk, Sidewalk Ramp, and Driveway Approach, Any Thickness, Rem Dr Structure, Rem Sewer, Rem, Less than 24 inch 	26.0 D	Sign, Type B, Temp, Prismatic n Code Description 3-1 Street Name Sign	15. R	Area (sft) 4.000	Total Area 104.000
CP CR	 Curb, Gutter, and Curb and Gutter, Any Type, Rem Cement _Driveway Opening, Conc, Det M, Modified _Grading, Sidewalk _Sidewalk, Conc, 4 inch, Modified _Sidewalk, Sidewalk Ramp, and Driveway Approach, Any Thickness, Rem Dr Structure, Rem 	26.0 D 1.0 M	Sign, Type B, Temp, Prismatic	15. R	Area (sft)	Total Area
CP CR	 Curb, Gutter, and Curb and Gutter, Any Type, Rem Cement _Driveway Opening, Conc, Det M, Modified _Grading, Sidewalk _Sidewalk, Conc, 4 inch, Modified _Sidewalk, Sidewalk Ramp, and Driveway Approach, Any Thickness, Rem Dr Structure, Rem Sewer, Rem, Less than 24 inch Dr Structure, Rem Sewer, Rem, Less than 24 inch Sewer, Rem, Less than 24 inch 	26.0 D 1.0 M 2.0 M	Sign, Type B, Temp, Prismatic n Code Description 3-1 Street Name Sign 4-10L Detour Arrow Sign 4-8a End Detour Sign 4-9L Detour Sign (w/Left Arrow)	15. R	Area (sft) 4.000 6.000 3.000 5.000	Total Area 104.000 6.000 3.000 10.000
CP CR DS DSDI	 Curb, Gutter, and Curb and Gutter, Any Type, Rem Cement _Driveway Opening, Conc, Det M, Modified _Grading, Sidewalk _Sidewalk, Conc, 4 inch, Modified _Sidewalk, Sidewalk Ramp, and Driveway Approach, Any Thickness, Rem Dr Structure, Rem Sewer, Rem, Less than 24 inch Dr Structure, Rem Sewer, Rem, Less than 24 inch Dr Structure, Rem Sewer, Rem, Less than 24 inch Dr Structure, Rem Sewer, Rem, Less than 24 inch Dr Structure, Rem 	26.0 D 1.0 M 2.0 M 3.0 M	Sign, Type B, Temp, Prismatic A Code Description 3-1 Street Name Sign 4-10L Detour Arrow Sign 4-8a End Detour Sign 4-9L Detour Sign (w/Left Arrow) 4-9R Detour Sign (w/Right Arrow)	15. R	Area (sft) 4.000 6.000 3.000 5.000 5.000	Total Area 104.000 6.000 3.000 10.000 15.000
CP CR DS	 Curb, Gutter, and Curb and Gutter, Any Type, Rem Cement _Driveway Opening, Conc, Det M, Modified _Grading, Sidewalk _Sidewalk, Conc, 4 inch, Modified _Sidewalk, Sidewalk Ramp, and Driveway Approach, Any Thickness, Rem Dr Structure, Rem Sewer, Rem, Less than 24 inch Dr Structure, Rem Sewer, Rem, Less than 24 inch Dr Structure, Rem Sewer, Rem, Less than 24 inch Dr Structure, Rem Sewer, Rem, Less than 24 inch Dr Structure, Point Dr Structure, Point Dr Structure Cover, Type B 	26.0 D 1.0 M 2.0 M 3.0 M 8.0 M	Sign, Type B, Temp, Prismaticn CodeDescription3-1Street Name Sign4-10LDetour Arrow Sign4-8aEnd Detour Sign4-9LDetour Sign (w/Left Arrow)4-9RDetour Sign (w/Right Arrow)4-9SDetour Sign (w/Thru Arrow)	15. R	Area (sft) 4.000 6.000 3.000 5.000 5.000 5.000	Total Area 104.000 6.000 3.000 10.000 15.000 40.000
CP CR DS DSDI	 Curb, Gutter, and Curb and Gutter, Any Type, Rem Cement _Driveway Opening, Conc, Det M, Modified _Grading, Sidewalk _Sidewalk, Conc, 4 inch, Modified _Sidewalk, Sidewalk Ramp, and Driveway Approach, Any Thickness, Rem Dr Structure, Rem Sewer, Rem, Less than 24 inch Dr Structure, Rem Sewer, Rem, Less than 24 inch Dr Structure, Rem Sewer, Rem, Less than 24 inch Dr Structure, Rem Sewer, Rem, Less than 24 inch Dr Structure, Rem Sewer, Rem, Less than 24 inch Dr Structure, Rem Sewer, Rem, Less than 24 inch Dr Structure, Point Dr Structure, Point Dr Structure Cover, Type B _Dr Structure Cover, Type B, Special 	26.0 D 1.0 M 2.0 M 3.0 M 8.0 M 1.0 R	Sign, Type B, Temp, Prismaticn CodeDescription3-1Street Name Sign4-10LDetour Arrow Sign4-8aEnd Detour Sign4-9LDetour Sign (w/Left Arrow)4-9RDetour Sign (w/Right Arrow)4-9SDetour Sign (w/Thru Arrow)3-7(R)Right Lane Must Tum Right Sign	15. R	Area (sft) 4.000 6.000 3.000 5.000 5.000 5.000 6.250	Total Area 104.000 6.000 3.000 10.000 15.000 40.000 6.250
CP CR DS DSDI PT	 Curb, Gutter, and Curb and Gutter, Any Type, Rem Cement _Driveway Opening, Conc, Det M, Modified _Grading, Sidewalk _Sidewalk, Conc, 4 inch, Modified _Sidewalk, Sidewalk Ramp, and Driveway Approach, Any Thickness, Rem Dr Structure, Rem Sewer, Rem, Less than 24 inch Dr Structure, Rem Sewer, Rem, Less than 24 inch Dr Structure, Rem Sewer, Rem, Less than 24 inch Dr Structure, Rem Sewer, Rem, Less than 24 inch Dr Structure, Point Dr Structure, Point Dr Structure Cover, Type B 	26.0 D 1.0 M 2.0 M 3.0 M 8.0 M 1.0 R	Sign, Type B, Temp, Prismaticn CodeDescription3-1Street Name Sign4-10LDetour Arrow Sign4-8aEnd Detour Sign4-9LDetour Sign (w/Left Arrow)4-9RDetour Sign (w/Right Arrow)4-9SDetour Sign (w/Thru Arrow)	15. R	Area (sft) 4.000 6.000 3.000 5.000 5.000 5.000	Total Area 104.000 6.000 3.000 10.000 15.000 40.000
CP CR DS DSDI PT	 _Curb, Gutter, and Curb and Gutter, Any Type, Rem Cement _Driveway Opening, Conc, Det M, Modified _Grading, Sidewalk _Sidewalk, Conc, 4 inch, Modified _Sidewalk, Sidewalk Ramp, and Driveway Approach, Any Thickness, Rem Dr Structure, Rem Sewer, Rem, Less than 24 inch Dr Structure, Rem Sewer, Rem, Less than 24 inch _Dr Structure, Rem Sewer, Rem, Less than 24 inch _Dr Structure, Double Inlet _Dr Structure, Point Dr Structure Cover, Type B _Dr Structure Cover, Type B, Special _Dr Structure, Adj, Case 1, Modified _Dr Structure, Temp Lowering, Modified Dr Structure Cover, Type K 	26.0 D 1.0 M 2.0 M 3.0 M 8.0 M 1.0 R 2.0 R	Sign, Type B, Temp, Prismaticn CodeDescription3-1Street Name Sign4-10LDetour Arrow Sign4-8aEnd Detour Sign4-9LDetour Sign (w/Left Arrow)4-9RDetour Sign (w/Right Arrow)4-9SDetour Sign (w/Thru Arrow)3-7(R)Right Lane Must Turn Right Sign3-7(L)Left Lane Must Turn Left Sign	15. R	Area (sft) 4.000 6.000 3.000 5.000 5.000 5.000 6.250 6.250	Total Area 104.000 6.000 3.000 10.000 15.000 40.000 6.250 6.250
CP CR DS DSDI PT RRA RRK	 _Curb, Gutter, and Curb and Gutter, Any Type, Rem _Cement _Driveway Opening, Conc, Det M, Modified _Grading, Sidewalk _Sidewalk, Conc, 4 inch, Modified _Sidewalk, Sidewalk Ramp, and Driveway Approach, Any Thickness, Rem Dr Structure, Rem Sewer, Rem, Less than 24 inch Dr Structure, Rem Sewer, Rem, Less than 24 inch _Dr Structure, Rem Sewer, Rem, Less than 24 inch _Dr Structure, Double Inlet _Dr Structure, Point Dr Structure Cover, Type B _Dr Structure Cover, Type B, Special _Dr Structure, Adj, Case 1, Modified 	26.0 D 1.0 M 2.0 M 3.0 M 8.0 M 1.0 R 2.0 R 2.0 R 4.0 R	Sign, Type B, Temp, Prismaticn CodeDescription3-1Street Name Sign4-10LDetour Arrow Sign4-8aEnd Detour Sign4-9LDetour Sign (w/Left Arrow)4-9RDetour Sign (w/Right Arrow)4-9SDetour Sign (w/Thru Arrow)3-7(R)Right Lane Must Turn Right Sign3-7(L)Left Lane Must Turn Left Sign5-1Do Not Enter Sign5-1AWrong Way Sign11-2Road Closed Sign ("Road Closed")	15. R	Area (sft) 4.000 6.000 3.000 5.000 5.000 5.000 6.250 6.250 6.250 6.000 10.000	Total Area 104.000 6.000 3.000 10.000 15.000 40.000 6.250 6.250 6.250 12.500 12.000
CP CR DS DSDI PT RRA RRK RS	 _Curb, Gutter, and Curb and Gutter, Any Type, Rem _Cement _Driveway Opening, Conc, Det M, Modified _Grading, Sidewalk _Sidewalk, Conc, 4 inch, Modified _Sidewalk, Sidewalk Ramp, and Driveway Approach, Any Thickness, Rem Dr Structure, Rem Sewer, Rem, Less than 24 inch Dr Structure, 24 inch dia Dr Structure, Rem Sewer, Rem, Less than 24 inch _Dr Structure, Double Inlet _Dr Structure, Point Dr Structure Cover, Type B _Dr Structure Cover, Type B, Special _Dr Structure, Adj, Case 1, Modified _Dr Structure, Adj, Case 1, Modified _Dr Structure, Rem, Light Intensity, Lighted, Furn 	26.0 D 1.0 M 1.0 M 2.0 M 3.0 M 1.0 R 2.0 R 2.0 R 2.0 R 1.0 R 1.0 R 1.0 R 1.0 R 2.0 R 2.0 R 0.0 R	Sign, Type B, Temp, Prismaticn CodeDescription3-1Street Name Sign4-10LDetour Arrow Sign4-8aEnd Detour Sign4-9LDetour Sign (w/Left Arrow)4-9RDetour Sign (w/Right Arrow)4-9SDetour Sign (w/Thru Arrow)3-7(R)Right Lane Must Turn Right Sign3-7(L)Left Lane Must Turn Left Sign5-1Do Not Enter Sign5-1AWrong Way Sign11-2Road Closed Sign ("Road Closed")11-4Road Closed Sign ("Road Closed To Thru Traffic")	15. R	Area (sft) 4.000 6.000 3.000 5.000 5.000 5.000 6.250 6.250 6.250 6.250 6.250 6.250 10.000 12.500	Total Area 104.000 6.000 3.000 10.000 15.000 40.000 6.250 12.500 12.000 40.000
CP CR DS DSDI PT RRA RRK RS TYPE I	 Curb, Gutter, and Curb and Gutter, Any Type, Rem Cement _Driveway Opening, Conc, Det M, Modified _Grading, Sidewalk _Sidewalk, Conc, 4 inch, Modified _Sidewalk, Sidewalk Ramp, and Driveway Approach, Any Thickness, Rem Dr Structure, Rem Sewer, Rem, Less than 24 inch Dr Structure, 24 inch dia Dr Structure, Rem Sewer, Rem, Less than 24 inch _Dr Structure, Rem Sewer, Rem, Less than 24 inch _Dr Structure, Rem Sewer, Rem, Less than 24 inch _Dr Structure, Double Inlet _Dr Structure, Double Inlet _Dr Structure Cover, Type B _Dr Structure Cover, Type B, Special _Dr Structure, Adj, Case 1, Modified _Dr Structure Cover, Type K _Dr Structure, Adj, Case 1, Modified >Dr Structure, Rep Lowering, Modified >Dr Structure, Rep Lowering, Modified >Dr Structure, Rep Lowering, Modified >Dr Structure, Adj, Case 1, Modified >Dr Structure, Cover, Type K _Dr Structure, Rep Lowering, Modified >Dr Structure, Rep Lowering, Lighted, Furn >Plastic Drum, High Intensity, Lighted, Oper >Particado Turo, Wilkin Intensity, Doper 	26.0 D 1.0 M 2.0 M 3.0 M 8.0 M 1.0 R 2.0 R 2.0 R 1.0 R 1.0 R 1.0 R 1.0 R 2.0 R 2.0 R 2.0 R 3.0 R 3.0 R	Sign, Type B, Temp, Prismaticn CodeDescription3-1Street Name Sign4-10LDetour Arrow Sign4-8aEnd Detour Sign4-9LDetour Sign (w/Left Arrow)4-9RDetour Sign (w/Right Arrow)4-9SDetour Sign (w/Right Arrow)3-7(R)Right Lane Must Turn Right Sign3-7(L)Left Lane Must Turn Left Sign5-1Do Not Enter Sign5-1AWrong Way Sign11-2Road Closed Sign ("Road Closed")11-4Road Closed Sign ("No Right Turn")	15. R	Area (sft) 4.000 6.000 3.000 5.000 5.000 6.250 6.250 6.250 6.000 10.000 12.500 4.000	Total Area 104.000 6.000 3.000 10.000 15.000 40.000 6.250 6.250 12.500 12.000 40.000
CP CR DS DSDI PT RRA RRK RS	 Curb, Gutter, and Curb and Gutter, Any Type, Rem Cement _Driveway Opening, Conc, Det M, Modified _Grading, Sidewalk _Sidewalk, Conc, 4 inch, Modified _Sidewalk, Sidewalk Ramp, and Driveway Approach, Any Thickness, Rem Dr Structure, Rem Sewer, Rem, Less than 24 inch Dr Structure, 24 inch dia Dr Structure, Rem Sewer, Rem, Less than 24 inch _Dr Structure, Rem Sewer, Rem, Less than 24 inch _Dr Structure, Rem Sewer, Rem, Less than 24 inch _Dr Structure, Double Inlet _Dr Structure, Double Inlet _Dr Structure Cover, Type B _Dr Structure Cover, Type B, Special _Dr Structure, Adj, Case 1, Modified _Dr Structure Cover, Type K _Dr Structure, Adj, Case 1, Modified >Dr Structure, Rep Lowering, Modified >Dr Structure, Rep Lowering, Modified >Dr Structure, Rep Lowering, Modified >Dr Structure, Adj, Case 1, Modified >Dr Structure, Cover, Type K _Dr Structure, Rep Lowering, Modified >Dr Structure, Rep Lowering, Lighted, Furn >Plastic Drum, High Intensity, Lighted, Oper >Particado Turo, Wilkin Intensity, Doper 	26.0 D 1.0 M 1.0 M 2.0 M 3.0 M 8.0 M 1.0 R 2.0 R 1.0 R 1.0 R 1.0 R 1.0 R 1.0 R 2.0 R 4.0 R 0.0 R 3.0 R 2.0 R	Sign, Type B, Temp, Prismaticn CodeDescription3-1Street Name Sign4-10LDetour Arrow Sign4-8aEnd Detour Sign4-9LDetour Sign (w/Left Arrow)4-9RDetour Sign (w/Right Arrow)4-9SDetour Sign (w/Thru Arrow)3-7(R)Right Lane Must Turn Right Sign3-7(L)Left Lane Must Turn Left Sign5-1Do Not Enter Sign5-1AWrong Way Sign11-2Road Closed Sign ("Road Closed")11-4Road Closed Sign ("Road Closed To Thru Traffic")		Area (sft) 4.000 6.000 3.000 5.000 5.000 5.000 6.250 6.250 6.250 6.250 6.250 6.250 10.000 12.500	Total Area 104.000 6.000 3.000 10.000 15.000 40.000 6.250 12.500 12.000 40.000
CP CR DS DSDI PT RRA RRK RS TYPE I	 Curb, Gutter, and Curb and Gutter, Any Type, Rem Cement _Driveway Opening, Conc, Det M, Modified _Grading, Sidewalk _Sidewalk, Conc, 4 inch, Modified _Sidewalk, Sidewalk Ramp, and Driveway Approach, Any Thickness, Rem Dr Structure, Rem Sewer, Rem, Less than 24 inch Dr Structure, Rem Sewer, Rem, Less than 24 inch Dr Structure, Rem Sewer, Rem, Less than 24 inch Dr Structure, Rem Sewer, Rem, Less than 24 inch Dr Structure, Point Dr Structure, Double Inlet _Dr Structure Cover, Type B _Dr Structure Cover, Type B, Special _Dr Structure, Adj, Case 1, Modified _Dr Structure Cover, Type K _Dr Structure, Adj, Case 1, Modified _Dr Structure, Adj, Case 1, Modified Pr Structure, Reconstruct Plastic Drum, High Intensity, Lighted, Furn Plastic Drum, High Intensity, Lighted, Oper Barricade, Type III, High Intensity, Double Sided, Lighted, Furn 	26.0 D 1.0 M 1.0 M 2.0 M 3.0 M 3.0 M 1.0 R 2.0 R 1.0 R 2.0 R 2.0 R 2.0 R 2.0 R 2.0 R 3.0 R 3.0 R 2.0 R 0.0 R 0.0 R 0.0 R	Sign, Type B, Temp, Prismaticn CodeDescription3-1Street Name Sign4-10LDetour Arrow Sign4-8aEnd Detour Sign4-9LDetour Sign (w/Left Arrow)4-9RDetour Sign (w/Left Arrow)4-9RDetour Sign (w/Right Arrow)4-9SDetour Sign (w/Thru Arrow)3-7(R)Right Lane Must Turn Right Sign3-7(L)Left Lane Must Turn Left Sign5-1Do Not Enter Sign5-1AWrong Way Sign11-2Road Closed Sign ("Road Closed")11-4Road Closed Sign ("Road Closed To Thru Traffic")3-1Movement Prohibition Sign ("No Right Turn")3-2Movement Prohibition Sign ("No Left Turn")3-8Advance Intersection Lane Control Sign (Thru Only or Right Sign Control Sign (Thru Only Only Contrel Sign Control Sign Control Sign (Thru On	Right Turn Only)	Area (sft) 4.000 6.000 3.000 5.000 5.000 5.000 6.250 6.250 6.250 6.000 10.000 12.500 4.000 4.000	Total Area 104.000 6.000 3.000 10.000 15.000 40.000 6.250 12.500 12.000 40.000 6.250 12.500 12.000 40.000 0.000 12.000 8.000
CP CR DS DSDI PT RRA RRK RS TYPE I	 Curb, Gutter, and Curb and Gutter, Any Type, Rem Cement _Driveway Opening, Conc, Det M, Modified _Grading, Sidewalk _Sidewalk, Conc, 4 inch, Modified _Sidewalk, Sidewalk Ramp, and Driveway Approach, Any Thickness, Rem Dr Structure, Rem Sewer, Rem, Less than 24 inch Dr Structure, Rem Sewer, Rem, Less than 24 inch Dr Structure, Rem Sewer, Rem, Less than 24 inch Dr Structure, Rem Sewer, Rem, Less than 24 inch Dr Structure, Point Dr Structure, Double Inlet _Dr Structure Cover, Type B _Dr Structure Cover, Type B, Special _Dr Structure, Adj, Case 1, Modified _Dr Structure Cover, Type K _Dr Structure, Adj, Case 1, Modified _Dr Structure, Adj, Case 1, Modified Pr Structure, Reconstruct Plastic Drum, High Intensity, Lighted, Furn Plastic Drum, High Intensity, Lighted, Oper Barricade, Type III, High Intensity, Double Sided, Lighted, Furn 	26.0 D 1.0 M 1.0 M 2.0 M 3.0 M 8.0 M 1.0 R 2.0 R 0.0 R 0.0 R 0.0 R 0.0 R 5.0 R	Sign, Type B, Temp, Prismatic n Code Description 3-1 Street Name Sign 4-10L Detour Arrow Sign 4-8a End Detour Sign 4-9L Detour Sign (w/Left Arrow) 4-9R Detour Sign (w/Right Arrow) 4-9S Detour Sign (w/Thru Arrow) 3-7(R) Right Lane Must Turn Right Sign 3-7(L) Left Lane Must Turn Left Sign 5-1 Do Not Enter Sign 5-14 Wrong Way Sign 11-2 Road Closed Sign ("Road Closed") 11-4 Road Closed Sign ("Road Closed To Thru Traffic") 3-1 Movement Prohibition Sign ("No Right Turn") 3-2 Movement Prohibition Sign ("No Left Turn") 3-8 Advance Intersection Lane Control Sign (Left Turn On;y or 3-8 Advance Intersection Lane Control Sign (Thru Only or Right 6-1 L	Right Turn Only)	Area (sft) 4.000 6.000 3.000 5.000 5.000 6.250 6.250 6.250 6.250 6.250 6.250 4.000 12.500 4.000 7.500 3.000	Total Area 104.000 6.000 3.000 10.000 15.000 40.000 6.250 12.500 12.000 40.000 0.000 12.000 8.000 0.000 15.000
CP CR DS DSDI PT RRA RRK RS TYPE I	 Curb, Gutter, and Curb and Gutter, Any Type, Rem Cement _Driveway Opening, Conc, Det M, Modified _Grading, Sidewalk _Sidewalk, Conc, 4 inch, Modified _Sidewalk, Sidewalk Ramp, and Driveway Approach, Any Thickness, Rem Dr Structure, Rem Sewer, Rem, Less than 24 inch Dr Structure, Rem Sewer, Rem, Less than 24 inch Dr Structure, Rem Sewer, Rem, Less than 24 inch Dr Structure, Rem Sewer, Rem, Less than 24 inch Dr Structure, Point Dr Structure, Double Inlet _Dr Structure Cover, Type B _Dr Structure Cover, Type B, Special _Dr Structure, Adj, Case 1, Modified _Dr Structure Cover, Type K _Dr Structure, Adj, Case 1, Modified _Dr Structure, Adj, Case 1, Modified Pr Structure, Reconstruct Plastic Drum, High Intensity, Lighted, Furn Plastic Drum, High Intensity, Lighted, Oper Barricade, Type III, High Intensity, Double Sided, Lighted, Furn 	26.0 D 1.0 M 1.0 M 2.0 M 3.0 M 3.0 M 1.0 R 1.0 R 1.0 R 1.0 R 1.0 R 2.0 R 2.0 R 2.0 R 3.0 R 2.0 R 0.0 R 0.0 R 0.0 R 0.0 R 2.0 R 2.0 R 0.0 R 0.0 R 2.0 R	Sign, Type B, Temp, Prismatic n Code Description 3-1 Street Name Sign 4-10L Detour Arrow Sign 4-8a End Detour Sign 4-9L Detour Sign (w/Left Arrow) 4-9R Detour Sign (w/Right Arrow) 4-9R Detour Sign (w/Thru Arrow) 3-7(R) Right Lane Must Turn Right Sign 3-7(L) Left Lane Must Turn Left Sign 5-1 Do Not Enter Sign 5-14 Wrong Way Sign 11-2 Road Closed Sign ("Road Closed") 11-4 Road Closed Sign ("Road Closed To Thru Traffic") 3-1 Movement Prohibition Sign ("No Right Turm") 3-2 Movement Prohibition Sign ("No Left Turm") 3-8 Advance Intersection Lane Control Sign (Left Turn On;y or 3-8 Advance Intersection Lane Control Sign (Thru Only or Right 6-1 L One Way (Left) Sign Gental Control Sign (Thru Only or Right 6-1 R	Right Turn Only)	Area (sft) 4.000 6.000 3.000 5.000 5.000 5.000 6.250 6.250 6.250 6.250 6.250 6.250 4.000 12.500 4.000 7.500 3.000 3.000	Total Area 104.000 6.000 3.000 10.000 15.000 40.000 6.250 12.500 12.000 40.000 0.000 12.000 8.000 0.000 15.000 6.000
CP CR DS DSDI PT RRA RRK RS TYPE I	 Curb, Gutter, and Curb and Gutter, Any Type, Rem Cement _Driveway Opening, Conc, Det M, Modified _Grading, Sidewalk _Sidewalk, Conc, 4 inch, Modified _Sidewalk, Sidewalk Ramp, and Driveway Approach, Any Thickness, Rem Dr Structure, Rem Sewer, Rem, Less than 24 inch Dr Structure, Rem Sewer, Rem, Less than 24 inch Dr Structure, Rem Sewer, Rem, Less than 24 inch Dr Structure, Rem Sewer, Rem, Less than 24 inch Dr Structure, Point Dr Structure, Double Inlet _Dr Structure Cover, Type B _Dr Structure Cover, Type B, Special _Dr Structure, Adj, Case 1, Modified _Dr Structure Cover, Type K _Dr Structure, Adj, Case 1, Modified _Dr Structure, Adj, Case 1, Modified Pr Structure, Reconstruct Plastic Drum, High Intensity, Lighted, Furn Plastic Drum, High Intensity, Lighted, Oper Barricade, Type III, High Intensity, Double Sided, Lighted, Furn 	26.0 D 1.0 M 1.0 M 2.0 M 3.0 M 8.0 M 1.0 R 2.0 R 1.0 R 2.0 R 2.0 R 2.0 R 2.0 R 2.0 R 3.0 R 2.0 R 0.0 R 0.0 R 0.0 R 0.0 R 2.0 R 2.0	Sign, Type B, Temp, Prismaticn CodeDescription3-1Street Name Sign4-10LDetour Arrow Sign4-8aEnd Detour Sign (W/Left Arrow)4-9LDetour Sign (w/Left Arrow)4-9RDetour Sign (w/Right Arrow)4-9RDetour Sign (w/Thru Arrow)3-7(R)Right Lane Must Turn Right Sign3-7(L)Left Lane Must Turn Left Sign5-1Do Not Enter Sign5-1AWrong Way Sign11-2Road Closed Sign ("Road Closed To Thru Traffic")3-1Movement Prohibition Sign ("No Left Turn")3-2Movement Prohibition Sign ("No Left Turn")3-8Advance Intersection Lane Control Sign (Thru Only or Righ6-1 LOne Way (Left) SignP-1Special Sign	Right Turn Only)	Area (sft) 4.000 6.000 3.000 5.000 5.000 6.250 6.250 6.250 6.250 6.250 6.250 6.250 7.500 7.500 3.000 3.000 20.000	Total Area 104.000 6.000 3.000 10.000 15.000 40.000 6.250 12.500 12.000 40.000 0.000 12.000 40.000 0.000 12.000 8.000 0.000 15.000 8.000 0.000 15.000 6.000 80.000
CP CR DS DSDI PT RRA RRK RS TYPE I	 Curb, Gutter, and Curb and Gutter, Any Type, Rem Cement _Driveway Opening, Conc, Det M, Modified _Grading, Sidewalk _Sidewalk, Conc, 4 inch, Modified _Sidewalk, Sidewalk Ramp, and Driveway Approach, Any Thickness, Rem Dr Structure, Rem Sewer, Rem, Less than 24 inch Dr Structure, Rem Sewer, Rem, Less than 24 inch Dr Structure, Rem Sewer, Rem, Less than 24 inch Dr Structure, Rem Sewer, Rem, Less than 24 inch Dr Structure, Point Dr Structure, Double Inlet _Dr Structure Cover, Type B _Dr Structure Cover, Type B, Special _Dr Structure, Adj, Case 1, Modified _Dr Structure Cover, Type K _Dr Structure, Adj, Case 1, Modified _Dr Structure, Adj, Case 1, Modified Pr Structure, Reconstruct Plastic Drum, High Intensity, Lighted, Furn Plastic Drum, High Intensity, Lighted, Oper Barricade, Type III, High Intensity, Double Sided, Lighted, Furn 	26.0 D 1.0 M 1.0 M 2.0 M 3.0 M 3.0 M 1.0 R 2.0 R 1.0 R 1.0 R 2.0 R 2.0 R 2.0 R 2.0 R 3.0 R 2.0 R 0.0 R 0.0 R 0.0 R 2.0 R 9.0 W	Sign, Type B, Temp, Prismatic n Code Description 3-1 Street Name Sign 4-10L Detour Arrow Sign 4-8a End Detour Sign 4-9L Detour Sign (w/Left Arrow) 4-9R Detour Sign (w/Right Arrow) 4-9R Detour Sign (w/Thru Arrow) 3-7(R) Right Lane Must Turn Right Sign 3-7(L) Left Lane Must Turn Left Sign 5-1 Do Not Enter Sign 5-14 Wrong Way Sign 11-2 Road Closed Sign ("Road Closed") 11-4 Road Closed Sign ("Road Closed To Thru Traffic") 3-1 Movement Prohibition Sign ("No Right Turm") 3-2 Movement Prohibition Sign ("No Left Turm") 3-8 Advance Intersection Lane Control Sign (Left Turn On;y or 3-8 Advance Intersection Lane Control Sign (Thru Only or Right 6-1 L One Way (Left) Sign Gental Control Sign (Thru Only or Right 6-1 R	Right Turn Only)	Area (sft) 4.000 6.000 3.000 5.000 5.000 5.000 6.250 6.250 6.250 6.250 6.250 6.250 4.000 12.500 4.000 7.500 3.000 3.000	Total Area 104.000 6.000 3.000 10.000 15.000 40.000 6.250 12.500 12.000 40.000 0.000 12.000 8.000 0.000 15.000 6.000

CITY OF ANN ARBOR **PROJECT MANAGEMENT**

PROJECT LOCATION: WEST LIBERTY STREET

ITB No. 4477 FILE No. 2017-004

CONSTRUCTION METHOD AND SEQUENCING

WORK ON THIS STREET INCLUDES, BUT IS NOT LIMITED TO, THE FOLLOWING ITEMS. COMPLETE THE WORK IN ACCORDANCE WITH THE PLANS AND SPECIFICATIONS, AS DIRECTED BY THE ENGINEER, AND UTILIZING PART WIDTH TWO (2) PHASE CONSTRUCTION. PERFORM THE WORK IN THE ORDER INDICATED BELOW UNLESS OTHERWISE AUTHORIZED OR DIRECTED BY THE ENGINEER. COMPLETE ITEMS 12 THRU 14 UTILIZING THE M.O.T. PLAN RES. AND FLAG CONTROL OPERATIONS AS DIRECTED BY THE ENGINEER



R PROTECTION OF UNDERGROUND UTILITIES AND IN CONFORMANCE WITH PUBLIC ACT F OF 2013, THE CONTRACTOR SHALL CALL 811 OR 1-800-482-7171 A MINIMUM OF REE FULL WORKING DAYS, EXCLUDING SATURDAYS, SUNDAYS, AND HOLIDAYS, PRIOR BEGINNING EACH EXCAVATION IN AREAS WHERE PUBLIC UTILITIES HAVE NOT BEEN EVIOUSLY LOCATED. MEMBERS WILL THUS BE ROUTINELY NOTIFIED. THIS DOES NOT LIEVE THE CONTRACTOR OF THE RESPONSIBILITY OF NOTIFYING UTILITY OWNERS IO MAY NOT BE A PART OF THE "MISS DIG" ALERT SYSTEM.





RAFFIC (M.O.T.) PLAN, AND INSTALL SOIL EROSION AND SEDIMENTATION

TED TO PAVEMENT, DRAINAGE, AND CONCRETE ITEMS WITH EXCEPTION TO

STRUCTURES, STORM SEWER, AND UNDERDRAIN AS REQUIRED.

INCLUDING RESTORATION.

HMA SURFACE BY COLDMILLING.

K CLEANOUT. HMA/HAND PATCHING, UNDERCUTS AND/OR BASE REPAIRS AS

INCH TOP COURSE HMA MIX (MAJOR STREETS)

ORDER SHOWN SHOWN ABOVE.

HMA SURFACE BY COLDMILLING.

K CLEANOUT. HMA/HAND PATCHING, UNDERCUTS AND/OR BASE REPAIRS AS

INCH TOP COURSE HMA MIX (MAJOR STREETS).

HMA APPROACHES AS REQUIRED.

TE ALL PAVEMENT MARKINGS.

CONSTRUCTION INCLUDING ALL CLEAN UP AND FINAL RESTORATION.

DEVICES. AND MISS DIG FLAGS.

DTES:

E UNDERGROUND LOCATIONS SHOWN FOR NATURAL GAS, TELEPHONE, ELECTRICAL WER, CABLE TV AND FIBER OPTIC LINES ARE APPROXIMATE. THE CITY OF ANN BOR ASSUMES NO RESPONSIBILITY FOR THEIR ACCURATE REPRESENTATION IN THIS AWING. MISS DIG MUST BE CONTACTED PRIOR TO CONSTRUCTION TO LOCATE THESE ILITIES.

IMPROVEMENTS COVERED BY THESE PLANS SHALL BE PERFORMED IN ACCORDANCE TH MICHIGAN DEPARTMENT OF TRANSPORTATION (MDOT) 2012 STANDARD ECIFICATIONS FOR CONSTRUCTION, INCLUDING REFERENCED MOOT PUBLICATIONS, AND E PROJECT CONTRACT DOCUMENTS.


> **PROJECT MANAGEMENT SERVICES UNIT CITY OF ANN ARBOR PUBLIC SERVICES** 301 EAST HURON STREET, P.O. BOX 8647 ANN ARBOR, MICHIGAN 48107-8647 734-794-6410 www.a2gov.org

PROJECT MANAGEMENT - PUBLIC SERVICES - CITY OF ANN ARBOR	PROJECT DESCRIPTION ANNUAL STREET RESURFACING - 2017	WEST LIBERTY STREET
	T No. 22 OF	139 2017004-122




SHE	PROJECT MANAGEMENT .	ANAGEMENT - PUBLIC SERVICES - CITY OF ANN ARBOR	ANN							
				CITY OF ANN ARBOR						
	SCALE PLAN: N/A	ANNUAL STREET RESURFACING - 2017								
		WEST LIBERTY STREET		P.O. BOX 8647	01 AL	01 ADDENDUM #1	03-24-17	AG.GS.RG	DAD	
DR	DRAWING No.				00 BII	BID SET	03-08-17	AG,GS,RG		Know what's below.
50	2017004-123	DETOUR	MICHIGAN		REV.	DESCRIPTION	DATE	DRAWN	DRAWN CHECKED	- Call before you dig.


TR	AFFIC CONTRO	LSIGN
TAG	SIGN	NUM.
(10)		D3-1 M4-9S 30x24
(11)	W. LIBERTY RD DETOUR	D3-1 M4-9R 30x24
(12)	W. LIBERTY RD DETOUR	D3-1 M4-9L 30x24
	W. LIBERTY RD	D3–1
(13)	DETOUR ENDS	M4-8a 24X18
14	WEST BOUND LIBERTY RD. Cloged at Maple RD	SPECIAL 48x60
(15)	WEST BOUND LIBERTY RD CLOSED	SPECIAL 48x60
16	DETOUR AHEAD W20-2 36"x36" W. LIBERTY RD D3-1	W20-2 36"X36'
(17)	DO NOT ENTER R5-1 30x30	R5–1 30"X30
18)	WRONG WAY	R5–1A 42"x30"
(9)	ROAD CLOSED AHEAD W20-3 36"x36" W. LIBERTY RD	W20-3 36"x36"
	D3-1	

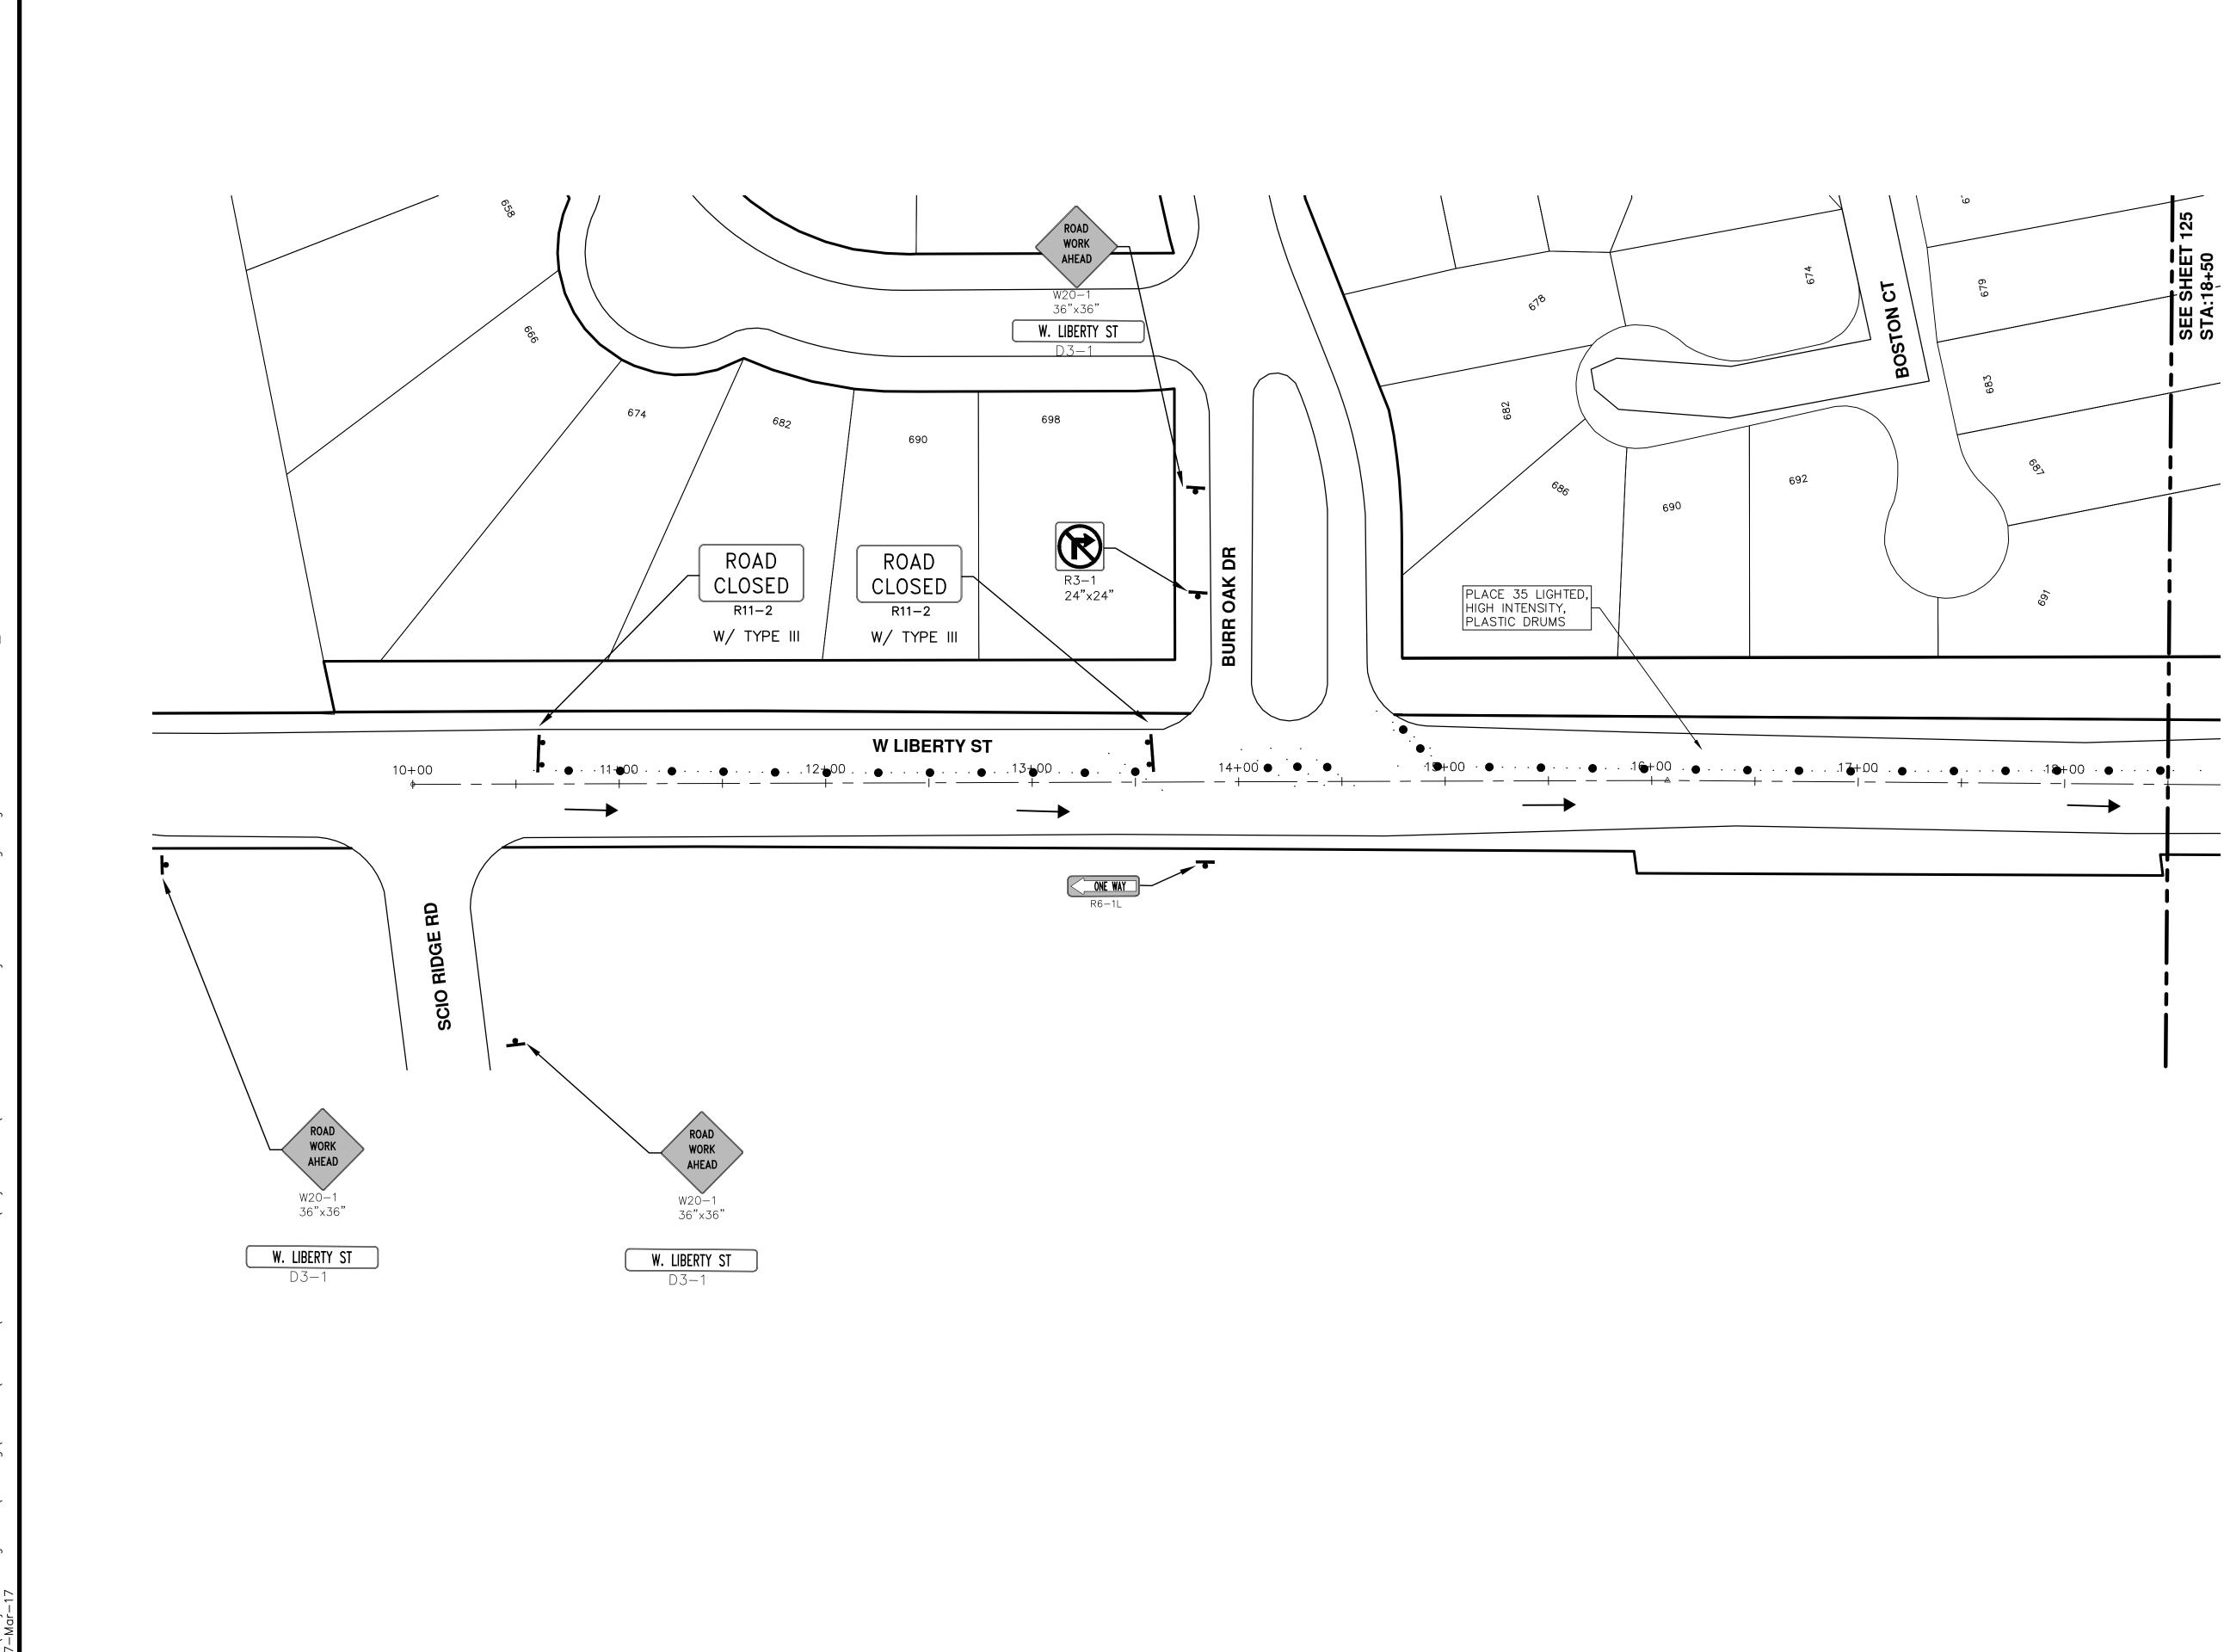


SH	PRO.IFCT MAI	NAGEMENT - PLIRLIC SERVICES - CITY OF ANN ARROR							
	H SCALE PLAN. 1" - 40'								
No. 1 C		ANNUAL STREET RESURFACING - 2017	1/2/ 100 COLIC SERVICE						
)F ^{··}		WEST LIBERTY STREET	O BOX 8647 ANN ARBOR, MI 48107-8647	01	01 ADDENDUM #1	03-24-17	AG,GS,RG	DAD	
	DRAWING No.		734-794-6410 WWW.a2gov.org	00	00 BID SET	03-08-17	AG,GS,RG	DAD	Know what's below
	2017004-124	IRAFFIC CONTROL	CHIGN	REV.	DESCRIPTION	DATE	DRAWN	DRAWN CHECKED	Call before you dig.

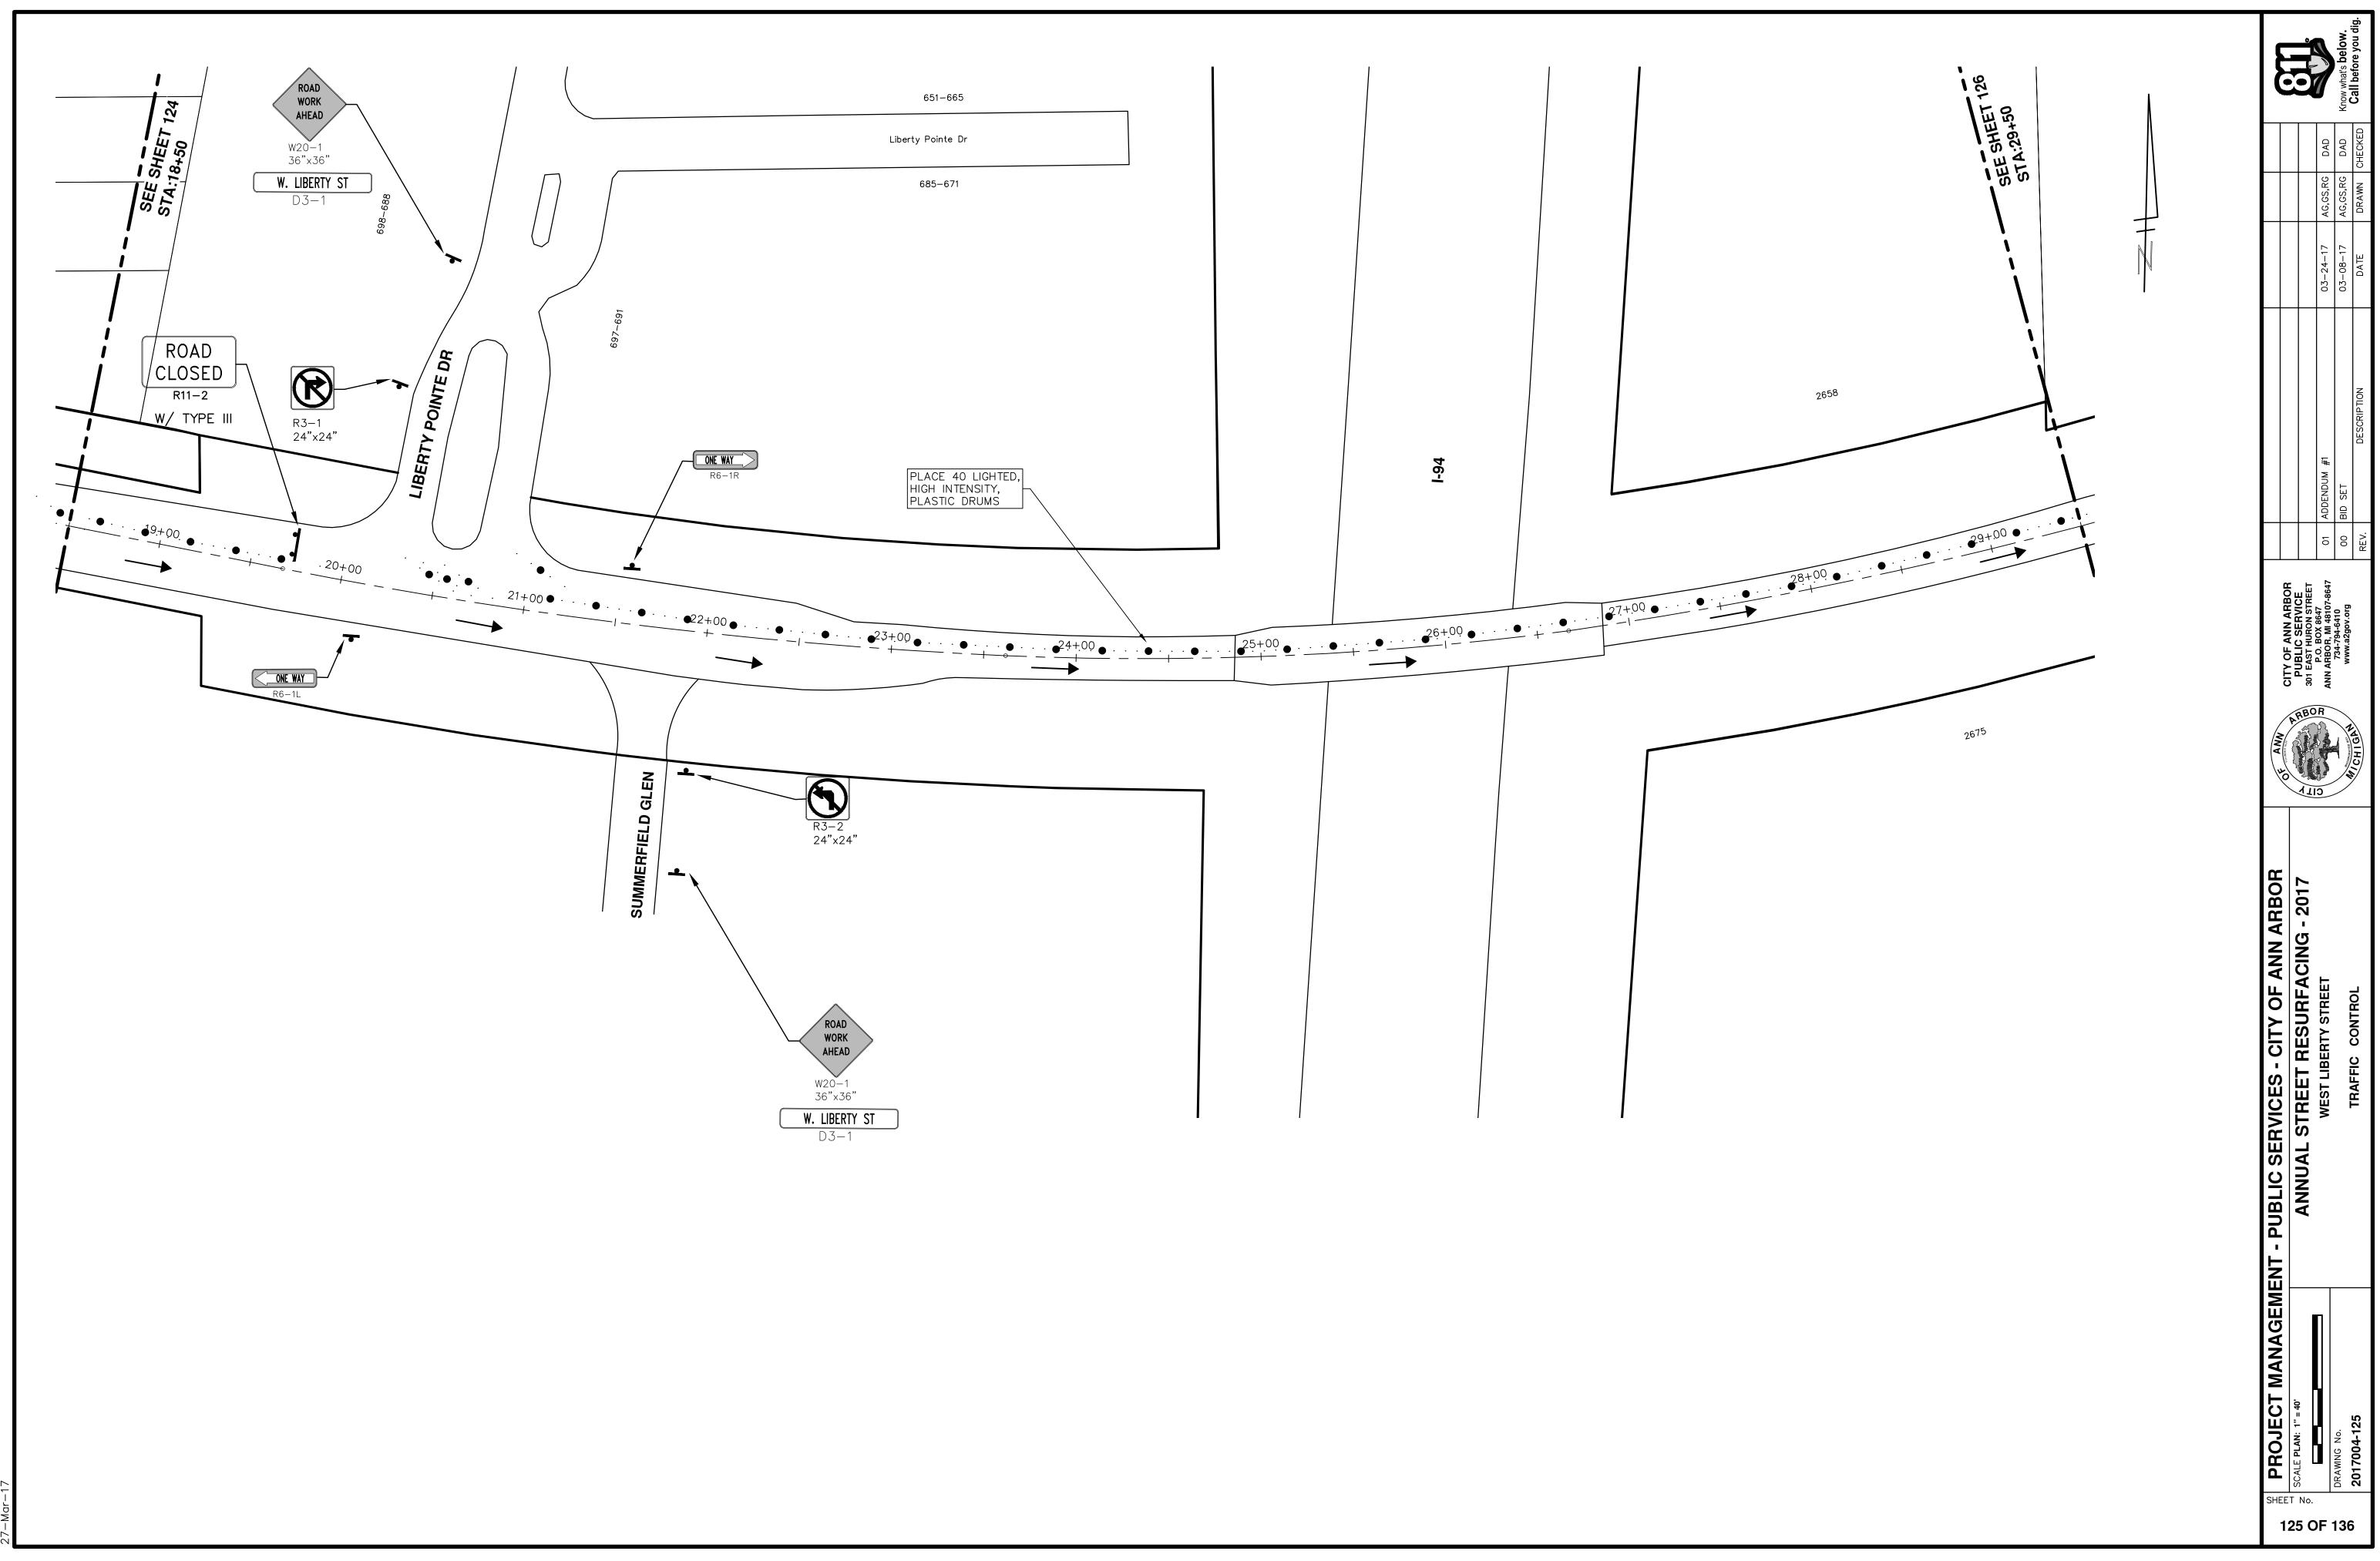


S. \Project 7-Mar-17 2. S:

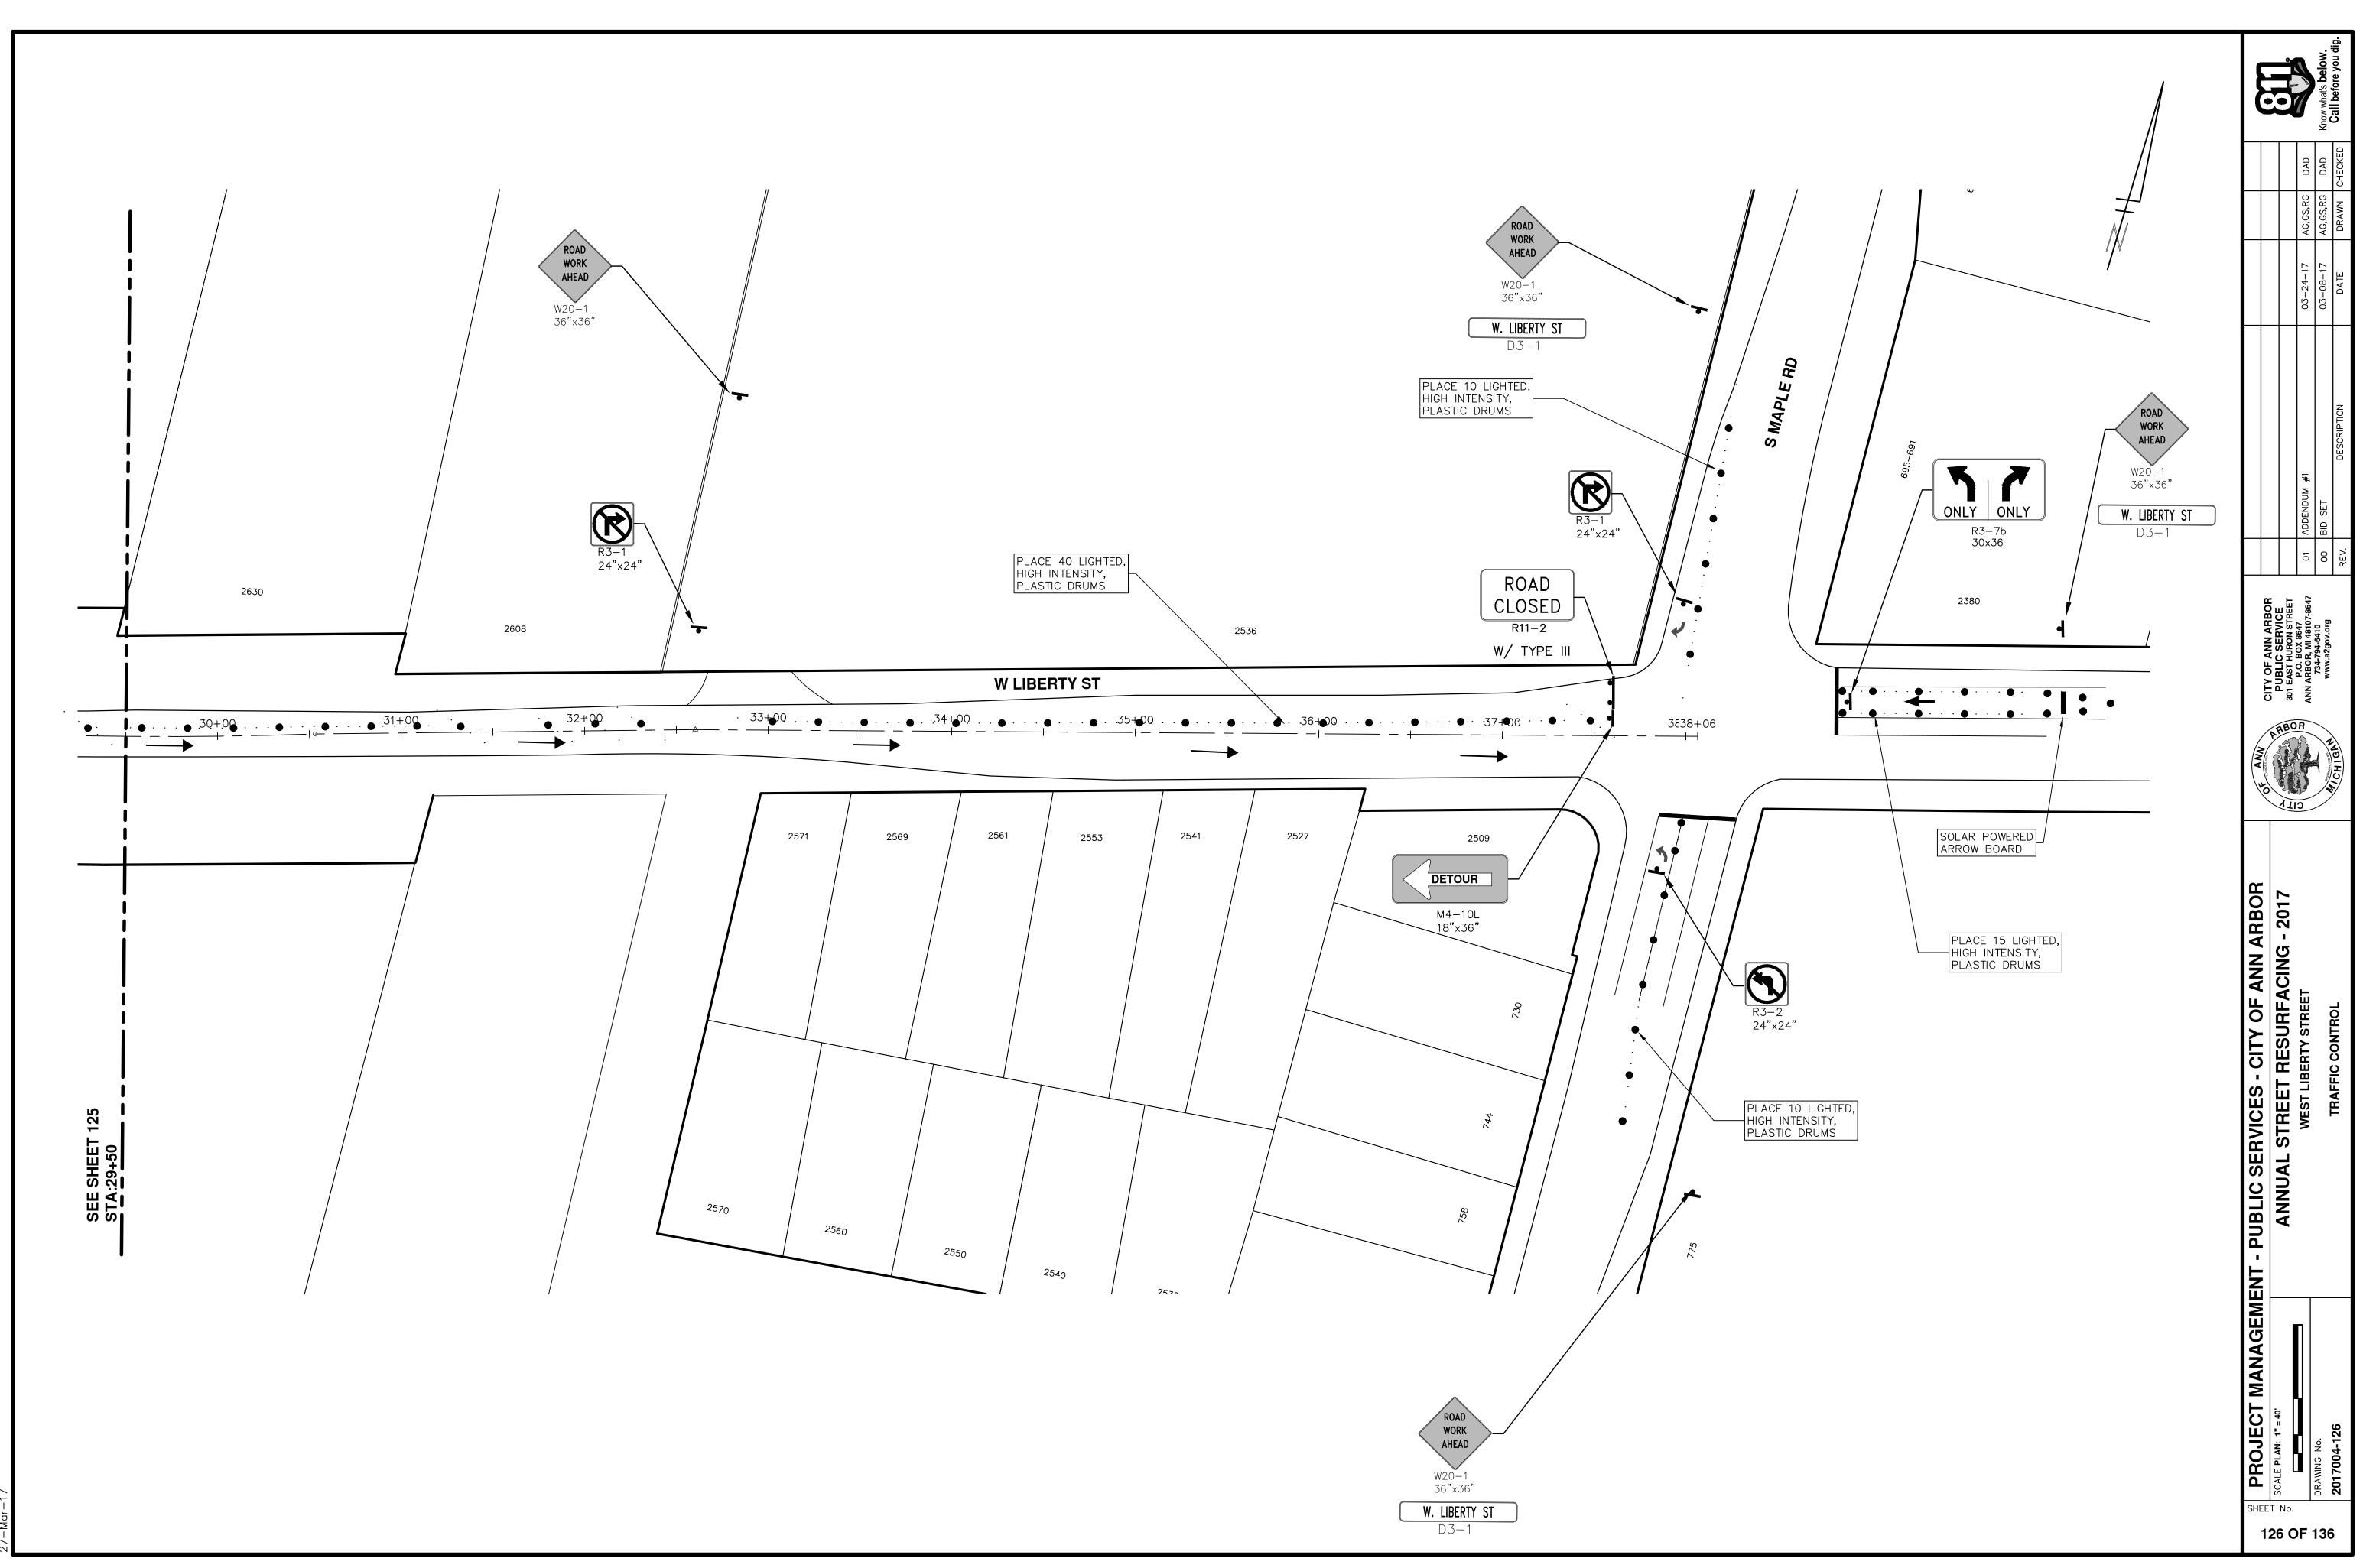


∖Proje '-Marς, Υ

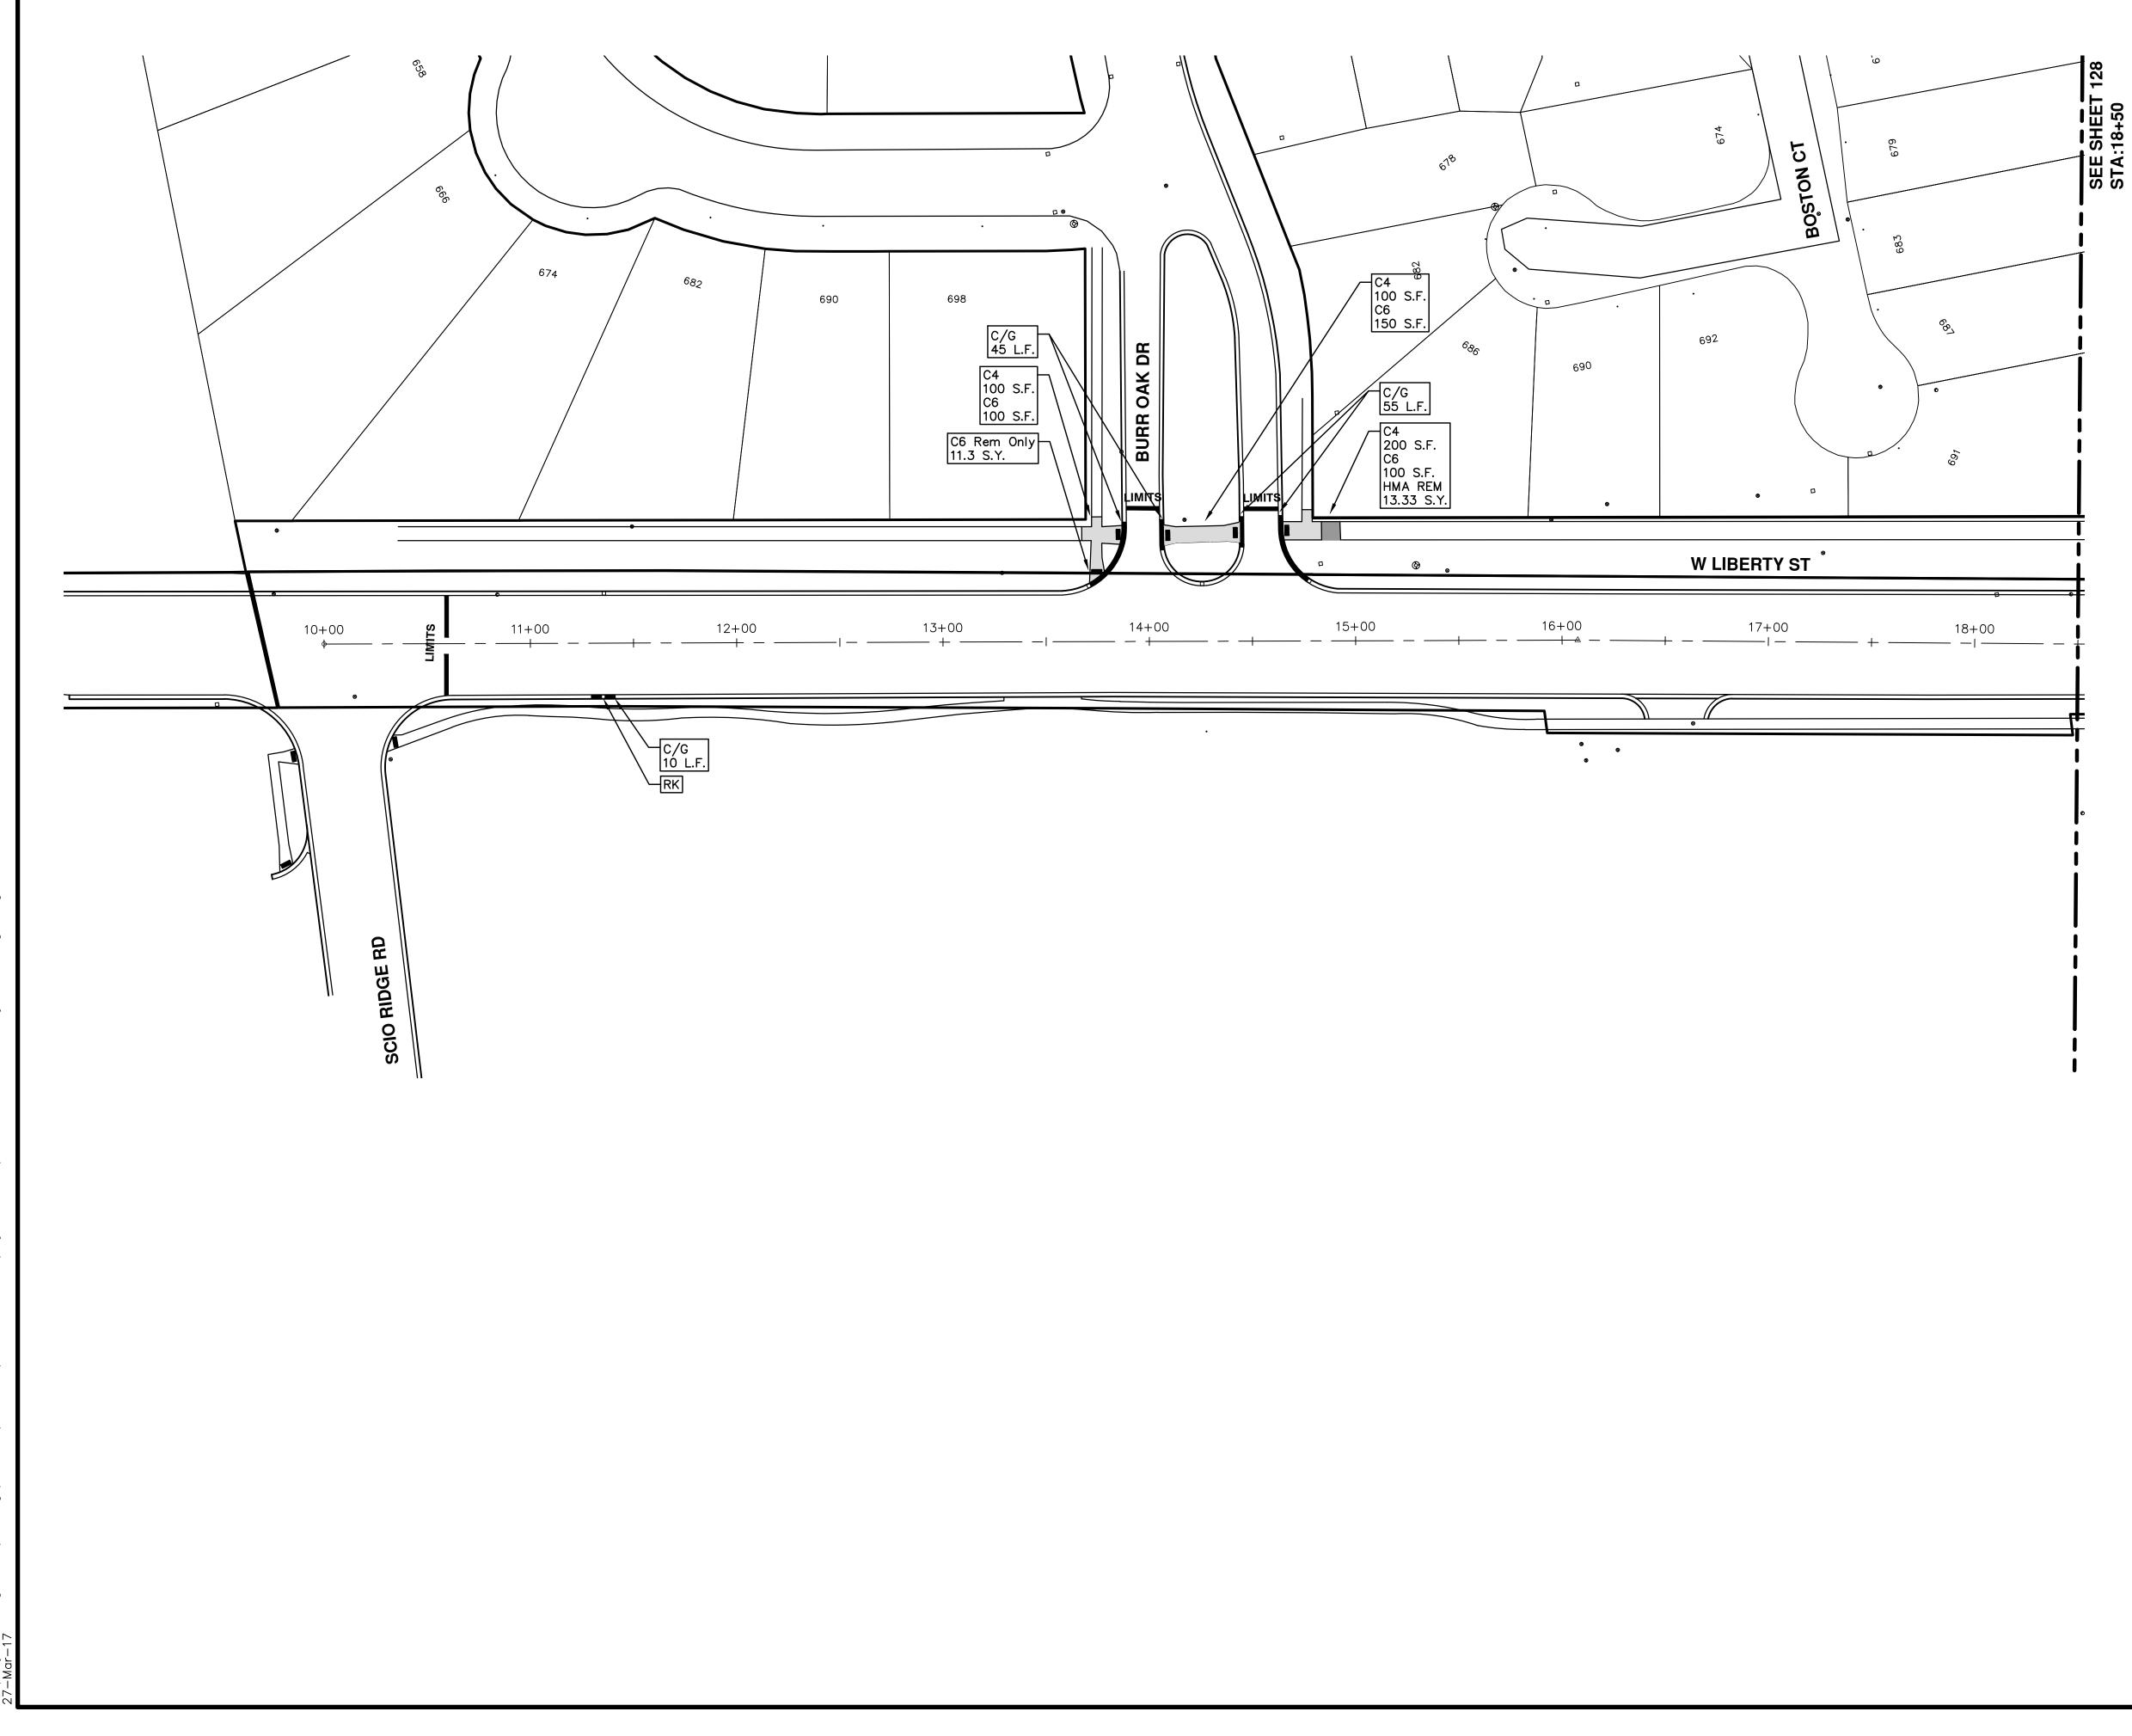


PROJECT MANAGEMEN	NAGEMENT - PUBLIC SERVICES - CITY OF ANN ARBOR	ANN					8
SCALE PLAN: 1:40	ANNUAL STREET RESURFACING - 2017	PUBLIC SERVICE					
	WEST LIBERTY STREET	D P.O. BOX 8647 ANN ARBOR, MI 48107-8647	01 AD	01 ADDENDUM #1	03-24-17	AG,GS,RG DAD	
		734-794-6410 Www.a2gov.org	00 BID SET) SET	03-08-17	AG,GS,RG DAD	Know what's below.
2017004-127	SIA. 10+00 - SIA. 18+50	CHIGN	REV.	DESCRIPTION	DATE	DRAWN CHECKED	Call before you dig.

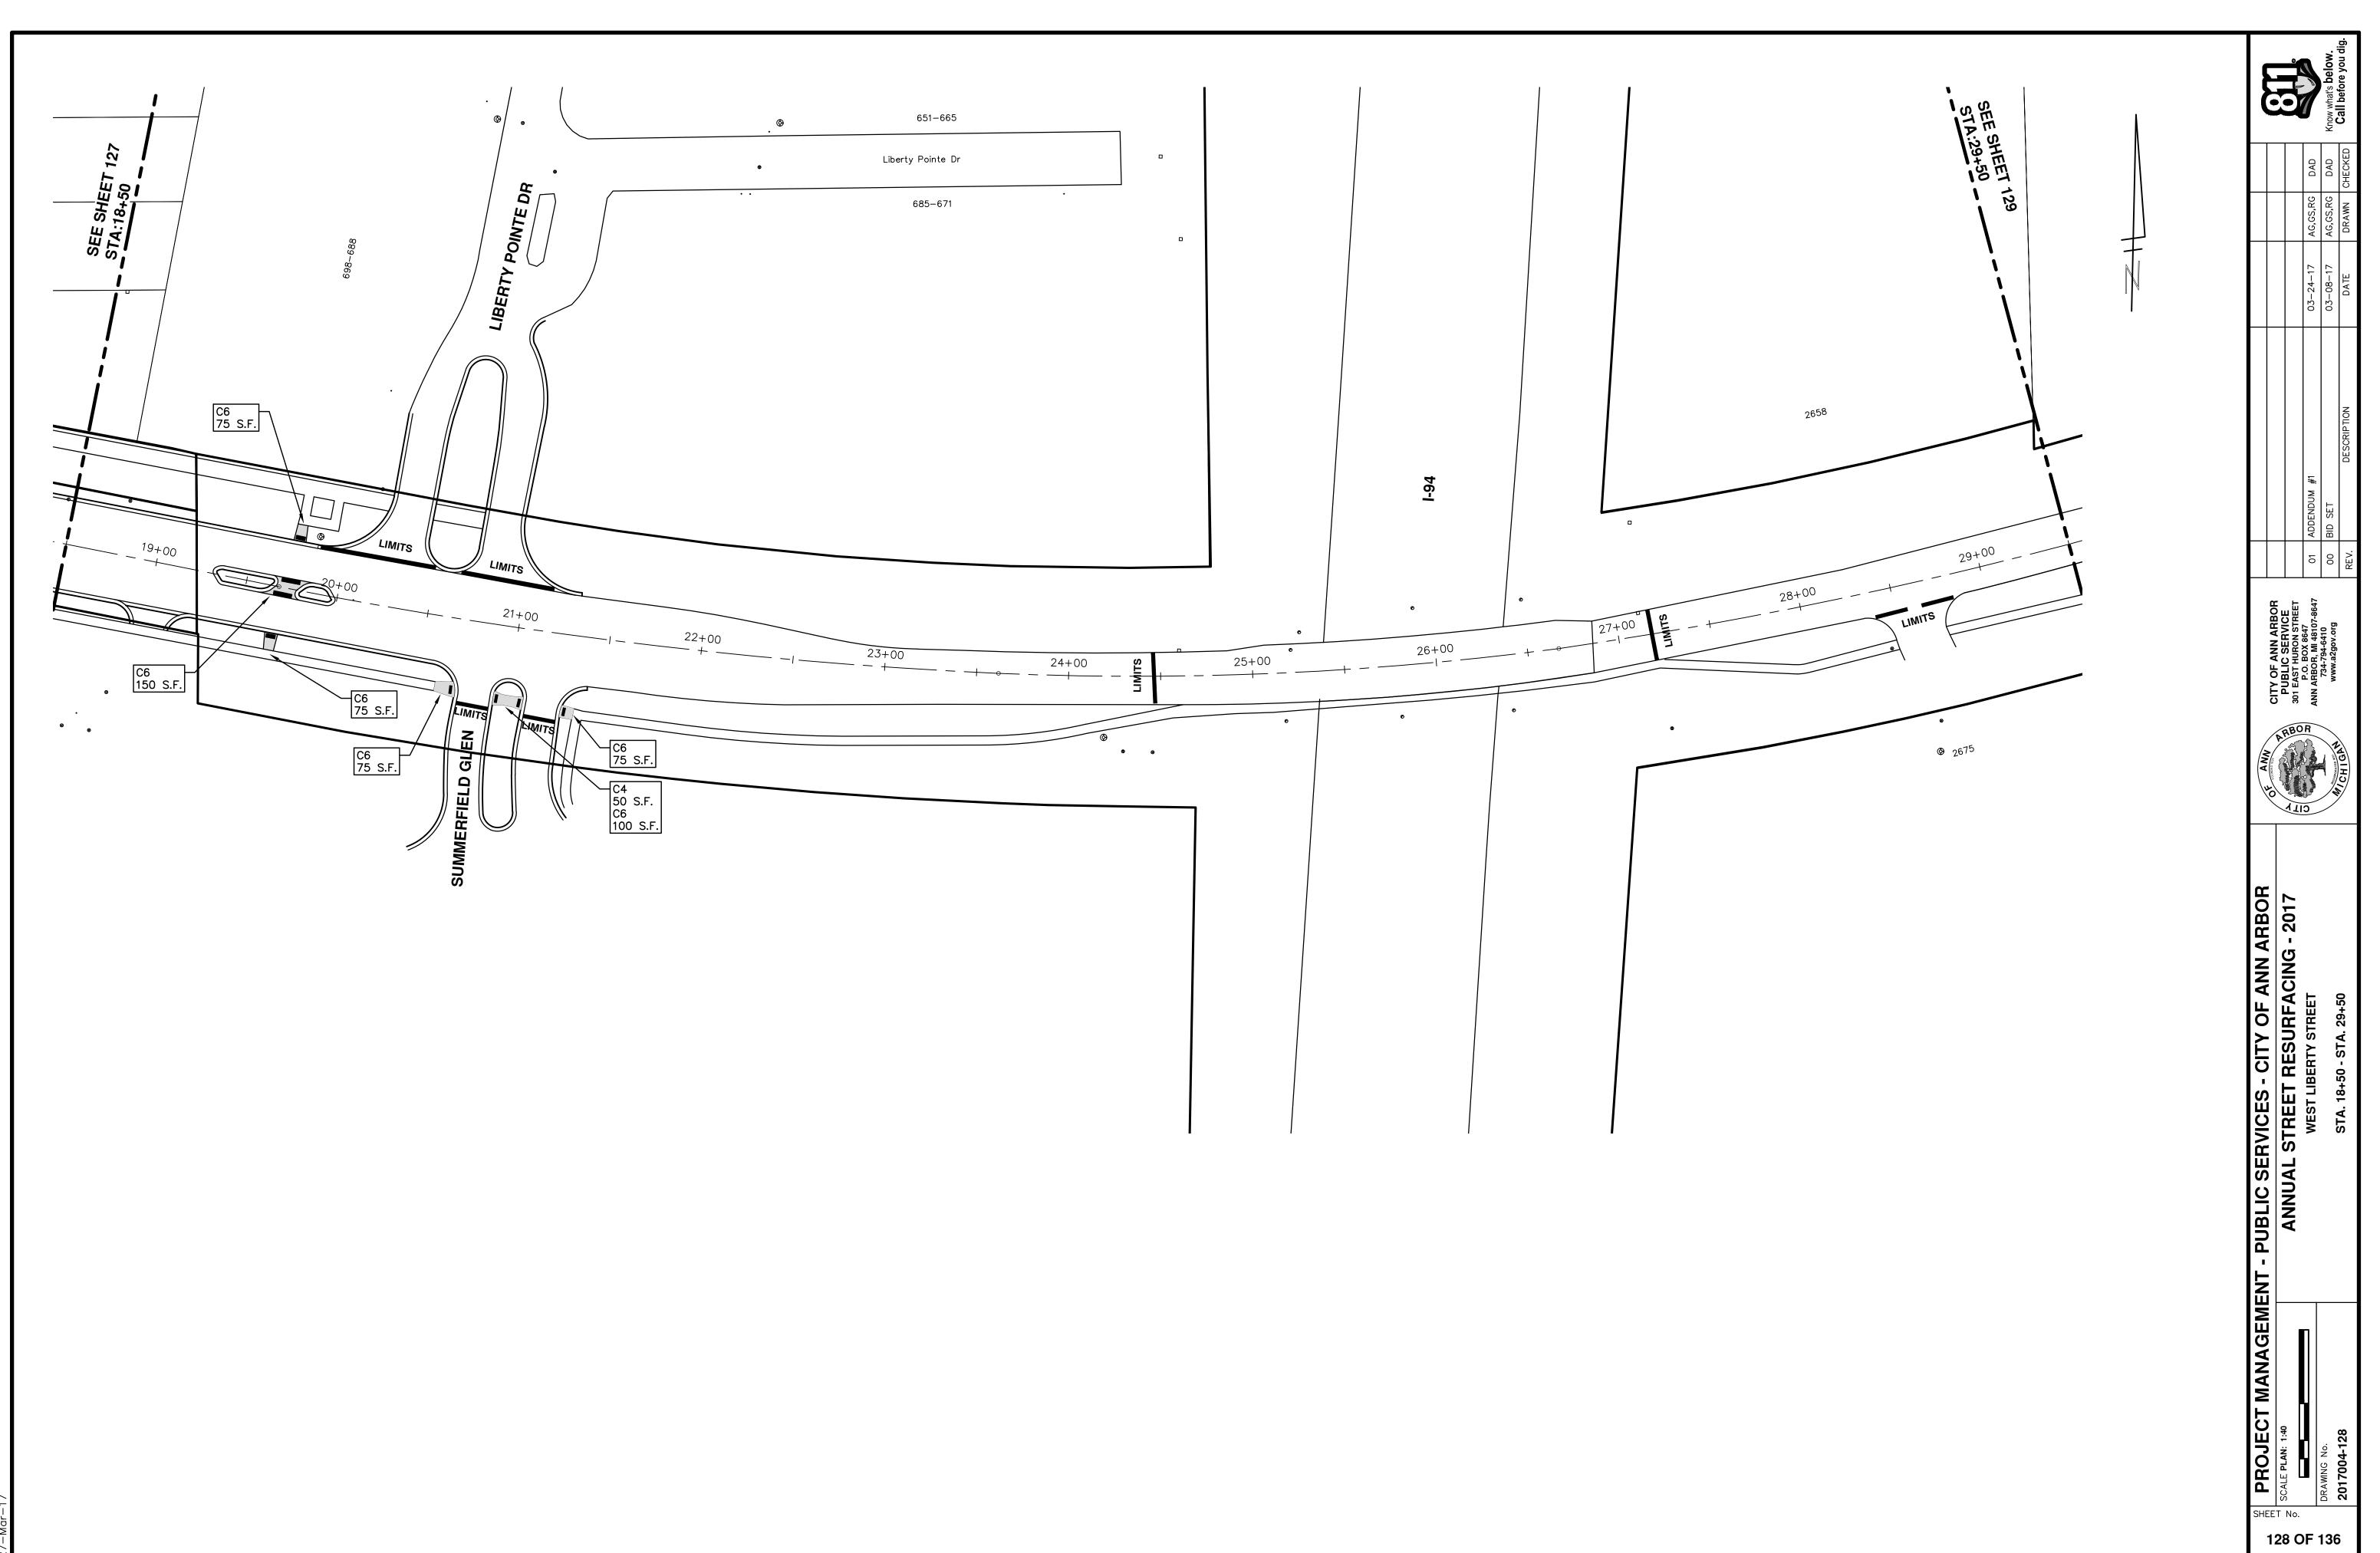




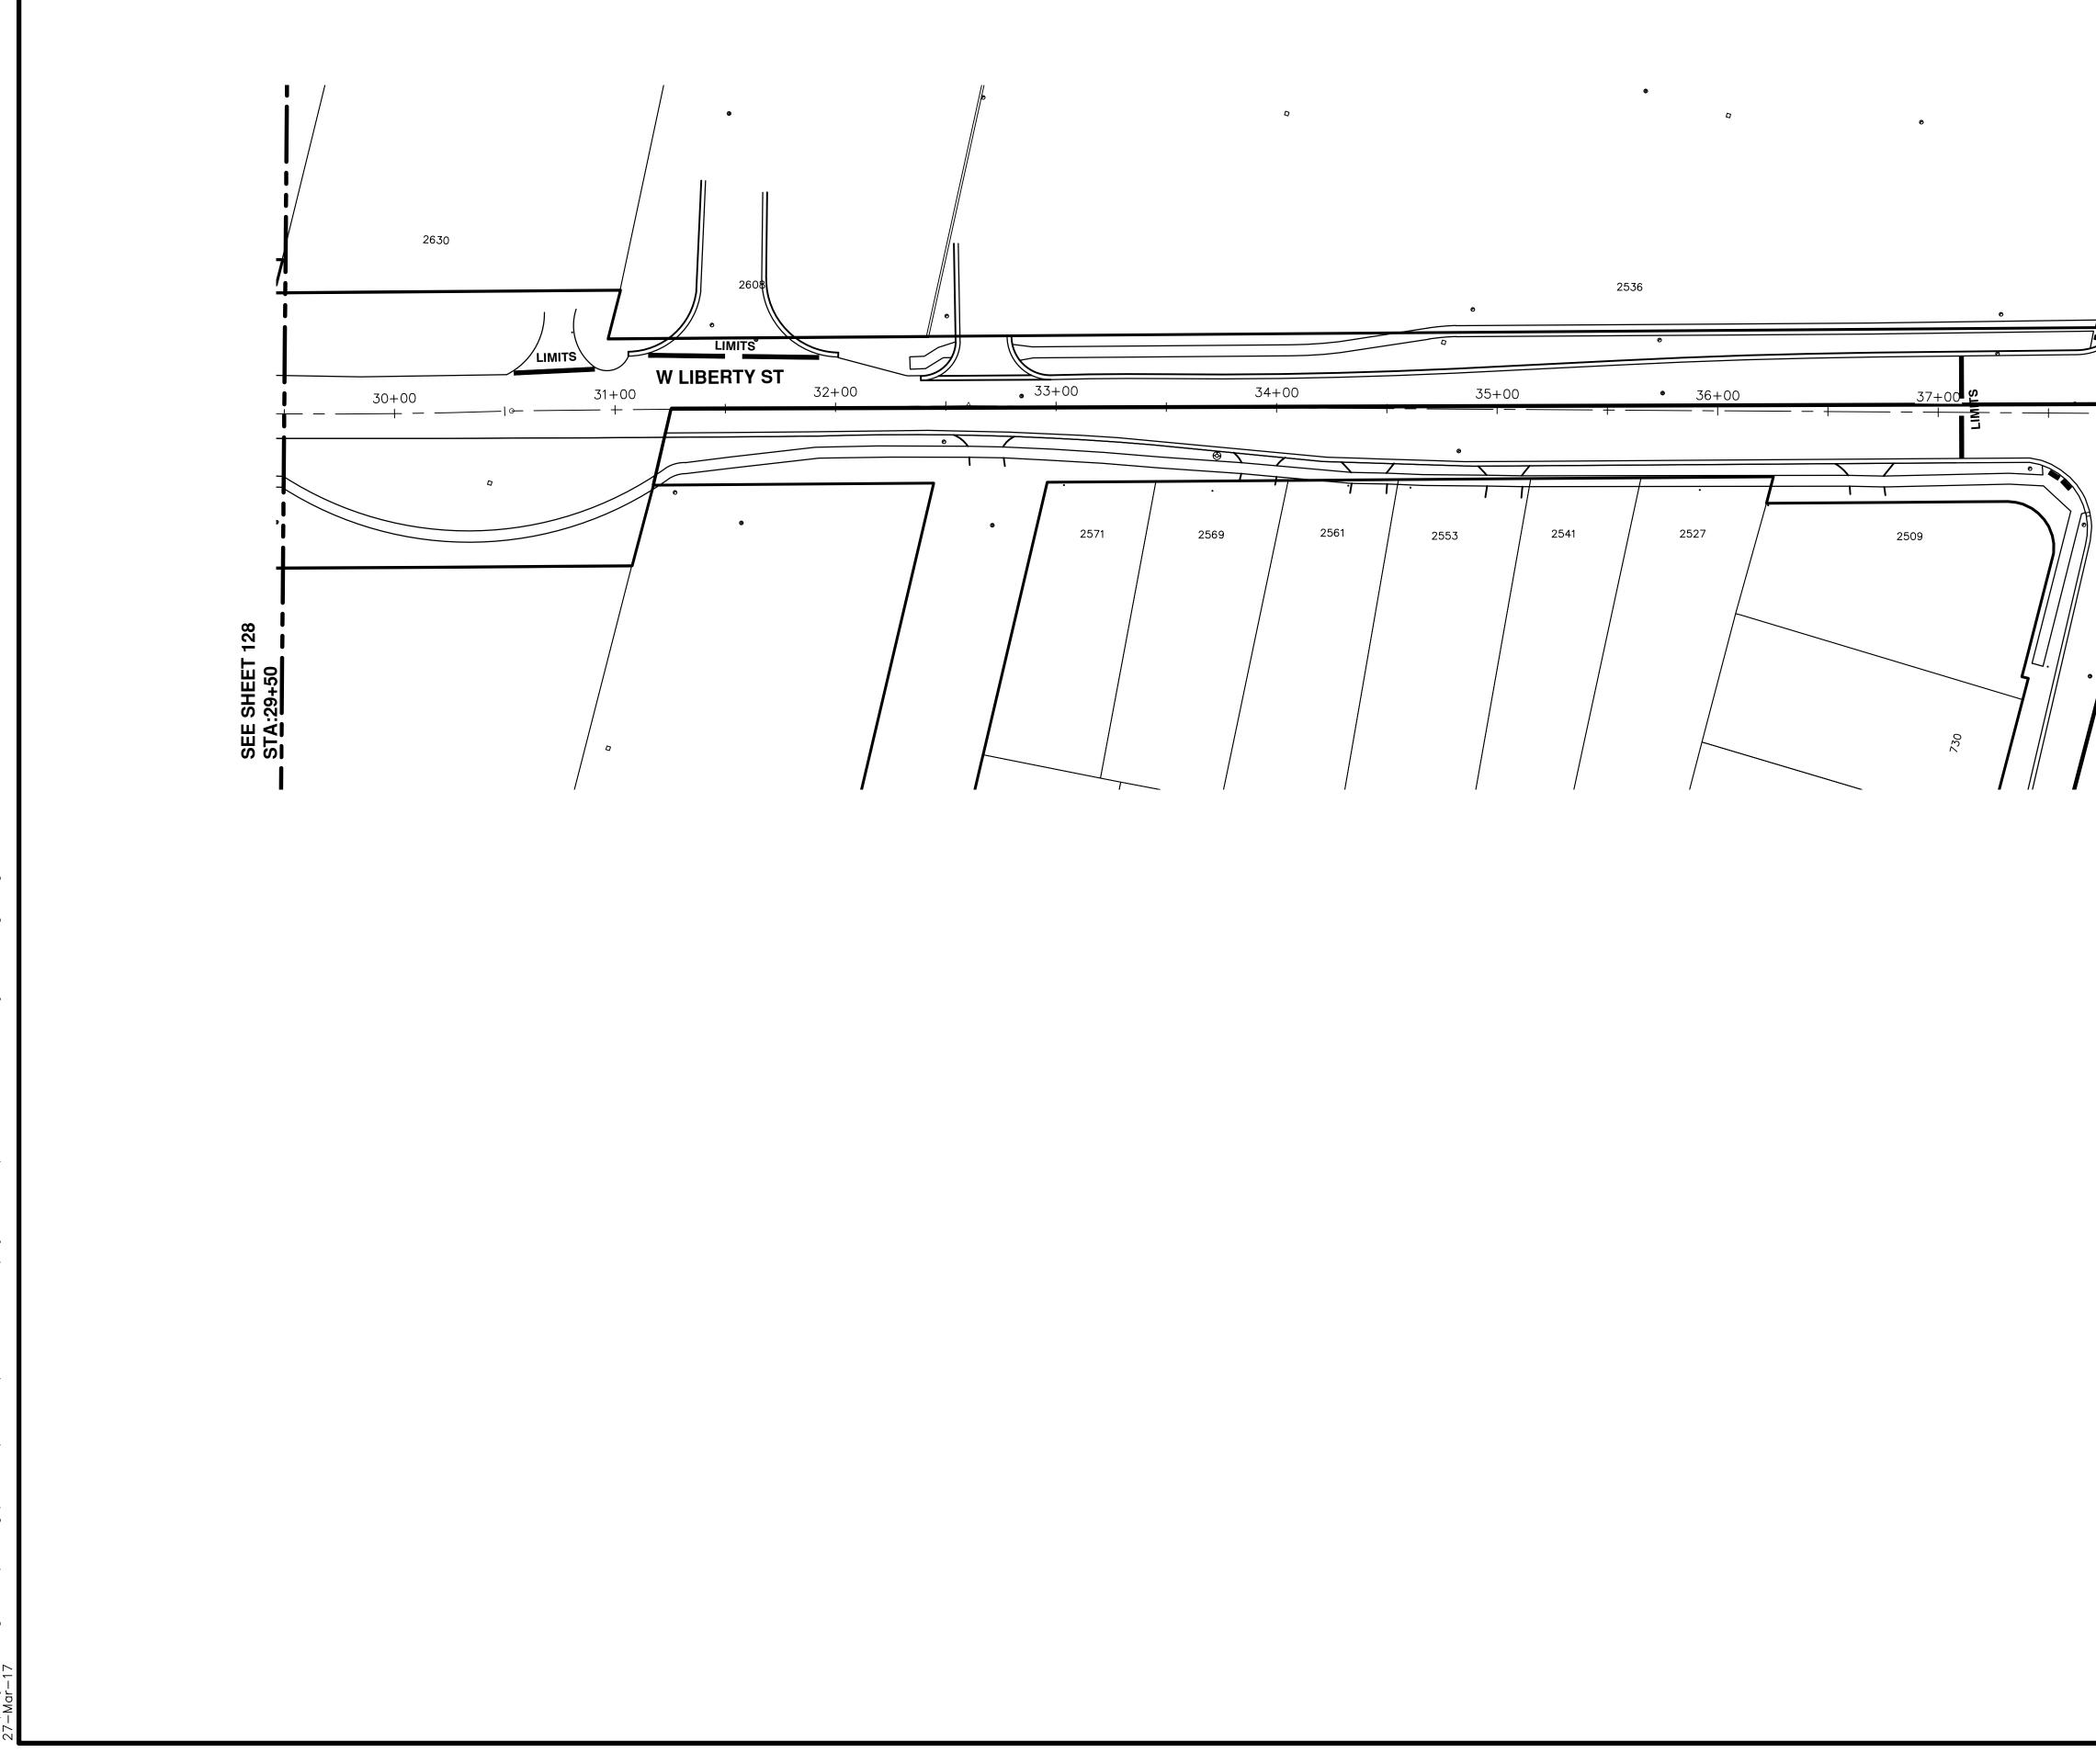


	1	Know what's below.
		AG,GS,RG DAD AG,GS,RG DAD AG,GS,RG DAD DRAWN CHECKED
S MAPLE RD	Ţ,	03-24-17 A 03-08-17 A DATE
		01 ADDENDUM #1 00 BID SET REV. DESCRIPTION
		CITY OF ANN ARBOR PUBLIC SERVICE 301 EAST HURON STREET 7.0. BOX 8647 ANN ARBOR, MI 48107-8647 734-794-6410 www.a2gov.org
		ARBOR IN HO HO HID
		ANAGEMENT - PUBLIC SERVICES - CITY OF ANN ARBOR ANNUAL STREET RESURFACING - 2017 MEST LIBERTY STREET STA. 29+50 - STA. 38+06
		BREAL NOULE CT MANAGEMEL SCALE PLAN: 1:40 DRAWING NO. 2017004-129 2017004-129

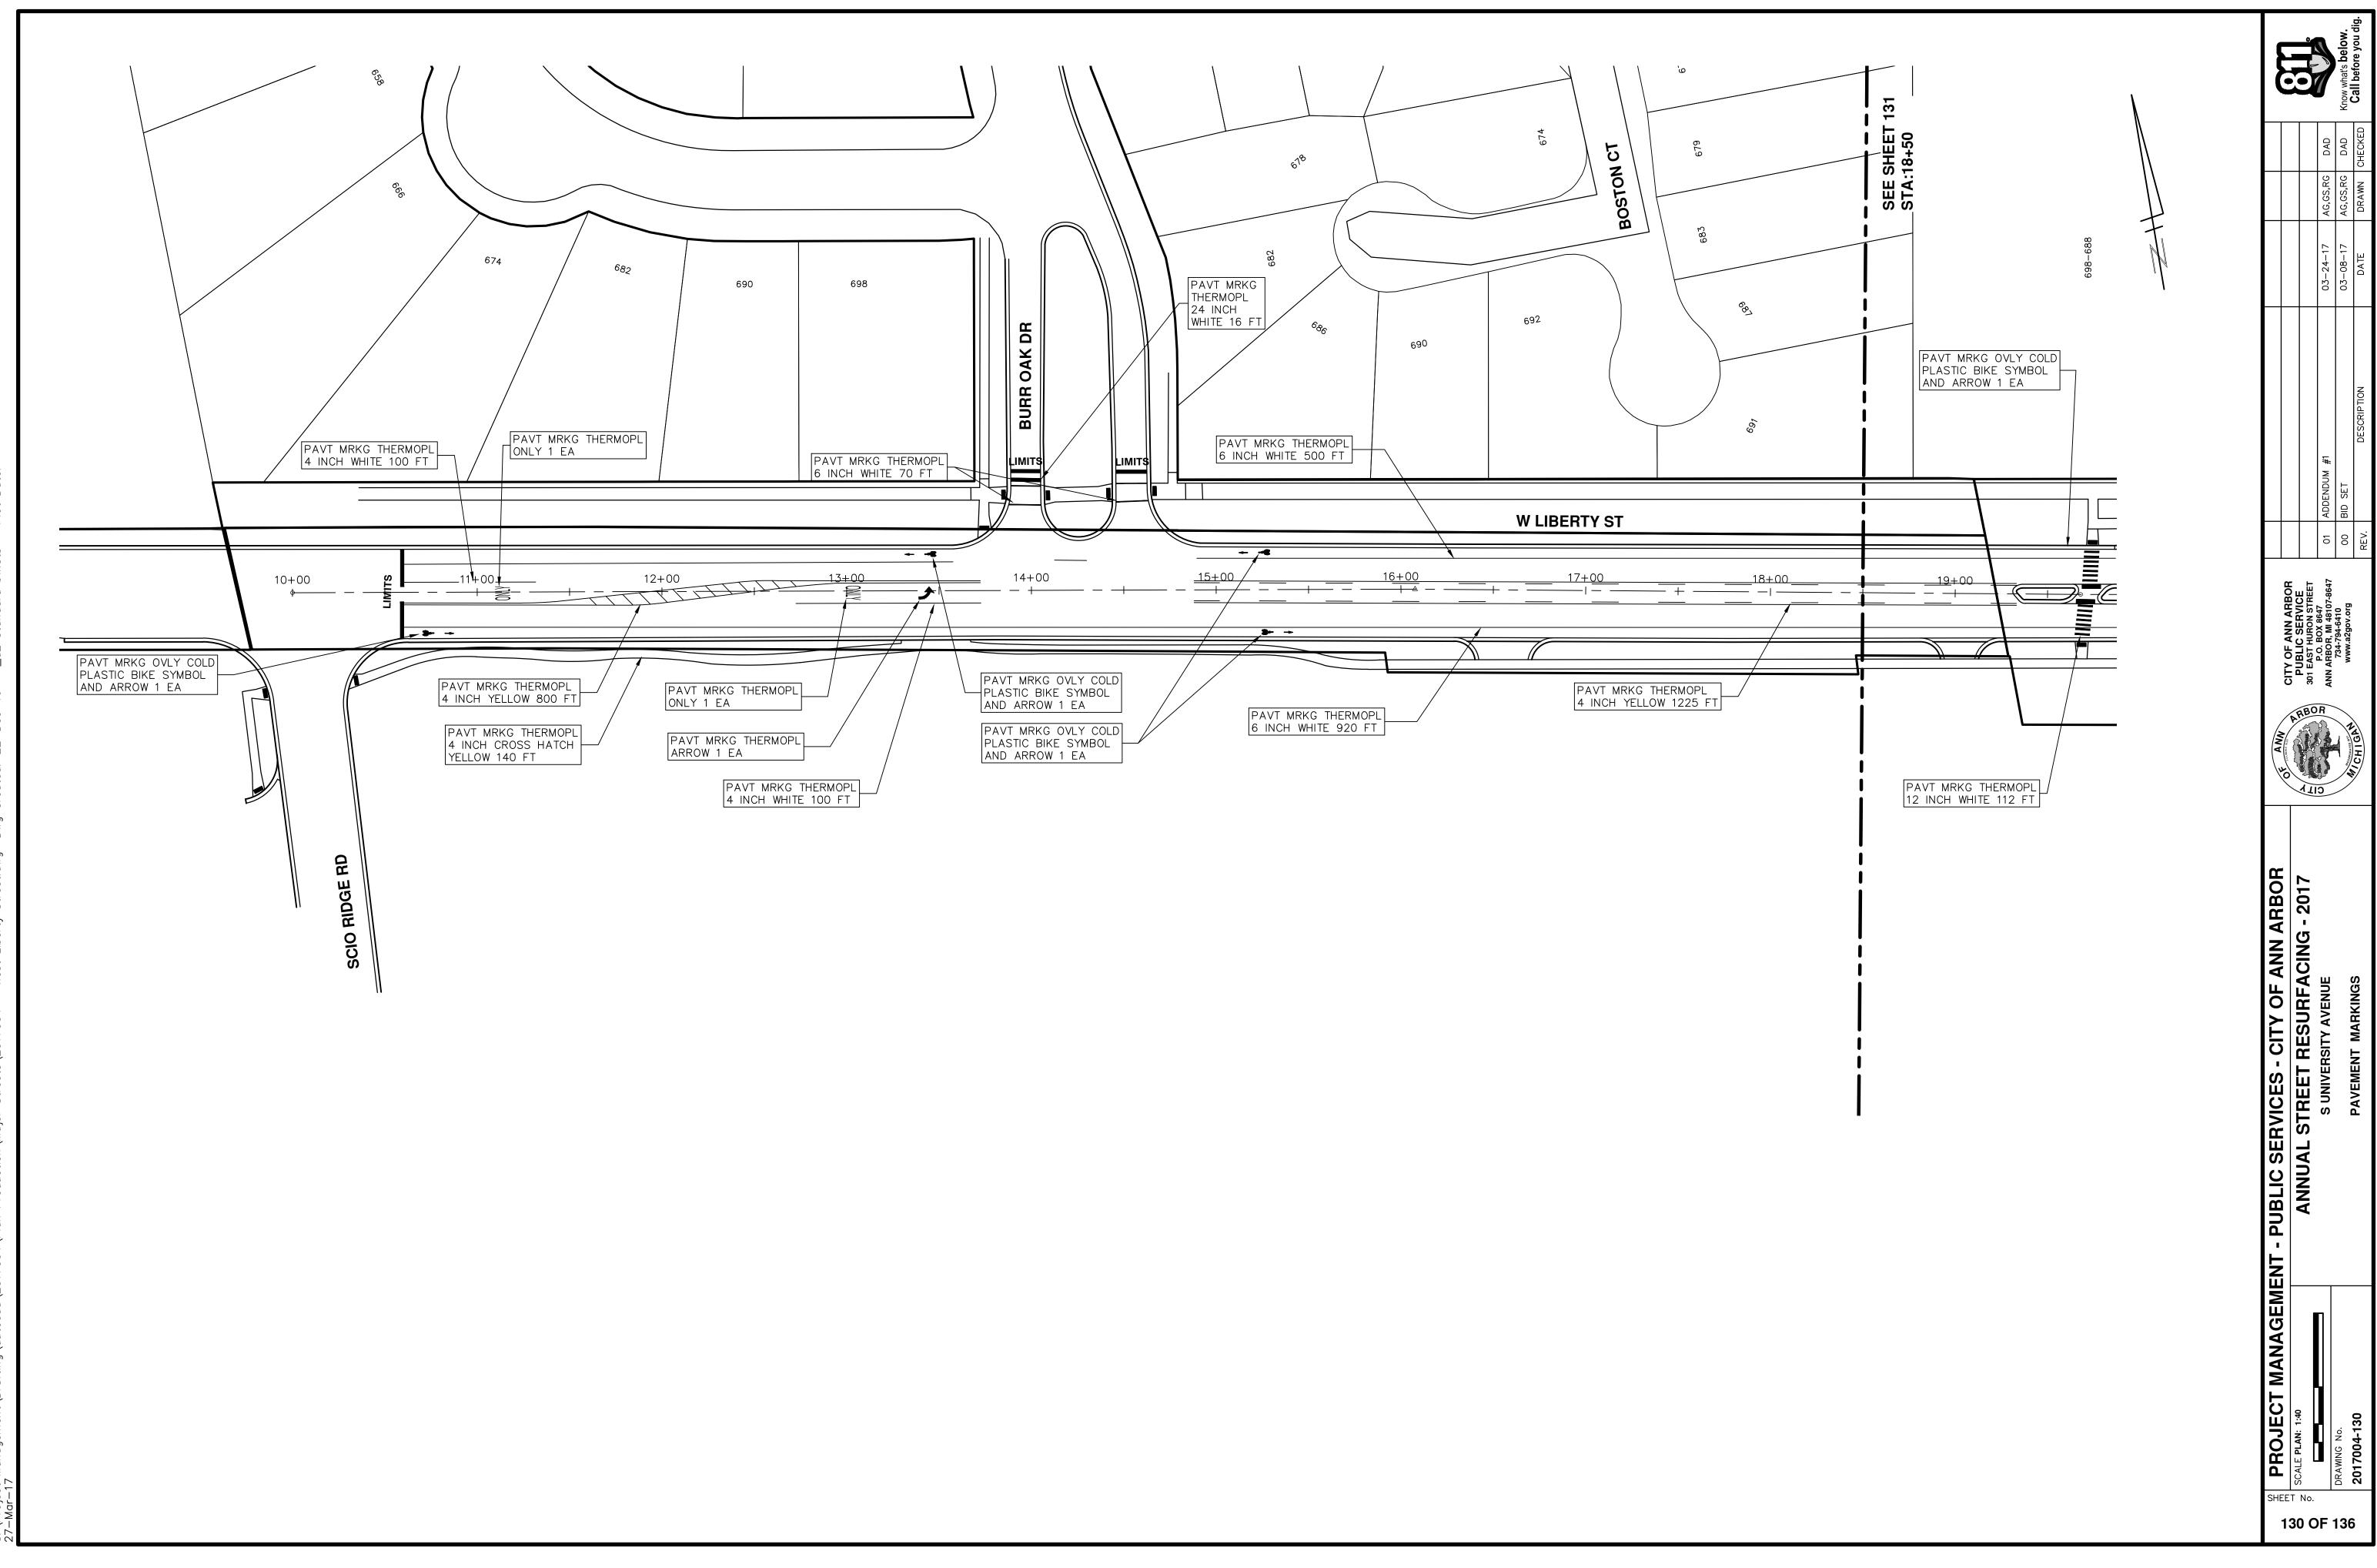

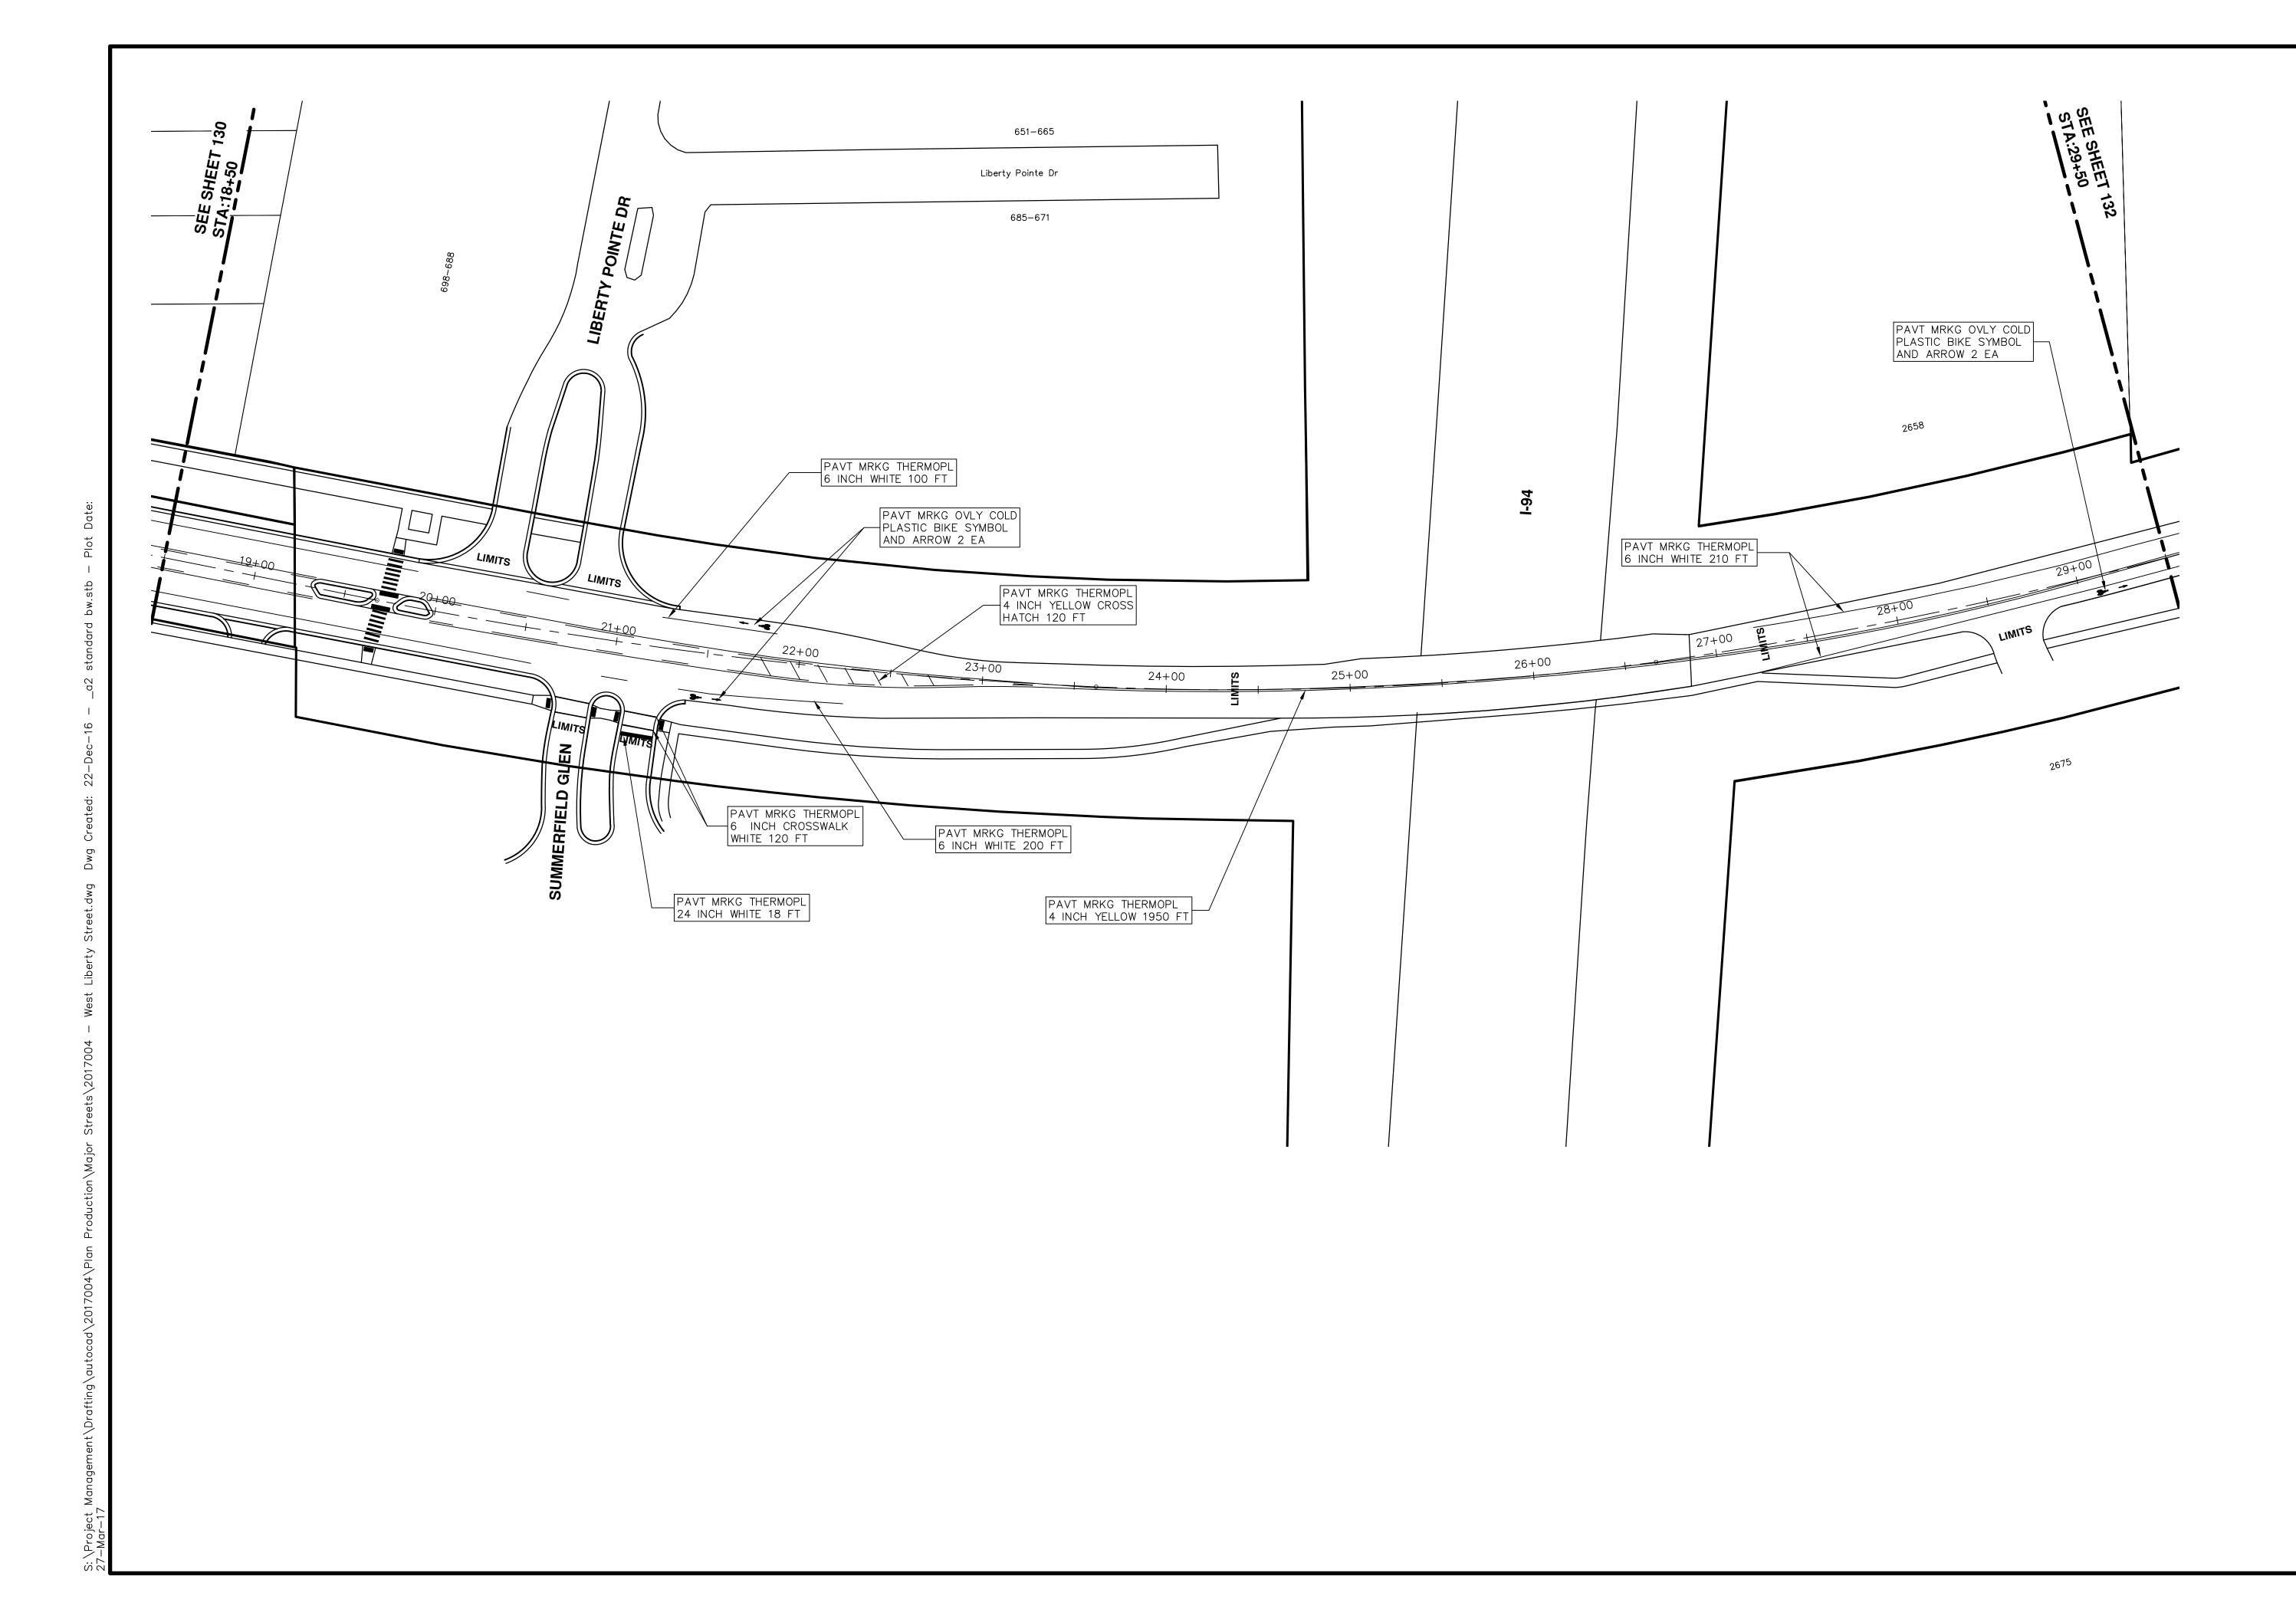

		MANAGEMENT - PUBLIC SERVICES - CITY OF ANN ARBOR	ANN					Ę
	SCALE PLAN: 1:40	ANNUAL STREET RESURFACING - 2017	PUBLIC SERVICE					
DF ⁻		WEST LIBERTY STREET	O O P.O. BOX 8647 ANN ARBOR, MI 48107-8647 ANN ARBOR, MI 48107-8647	01 ADDENDUM #1	03-24-17	AG,GS,RG	DAD	
136	DRAWING No.		734-794-6410 Www.a2gov.org	00 BID SET	03-08-17	AG,GS,RC	AG,GS,RG DAD	Know what's below
6	2017004-131	PAVEMENI MARKINGS	CHIGN.	REV. DESCRIPTION	DATE	DRAWN	DRAWN CHECKED	Call before you dig.

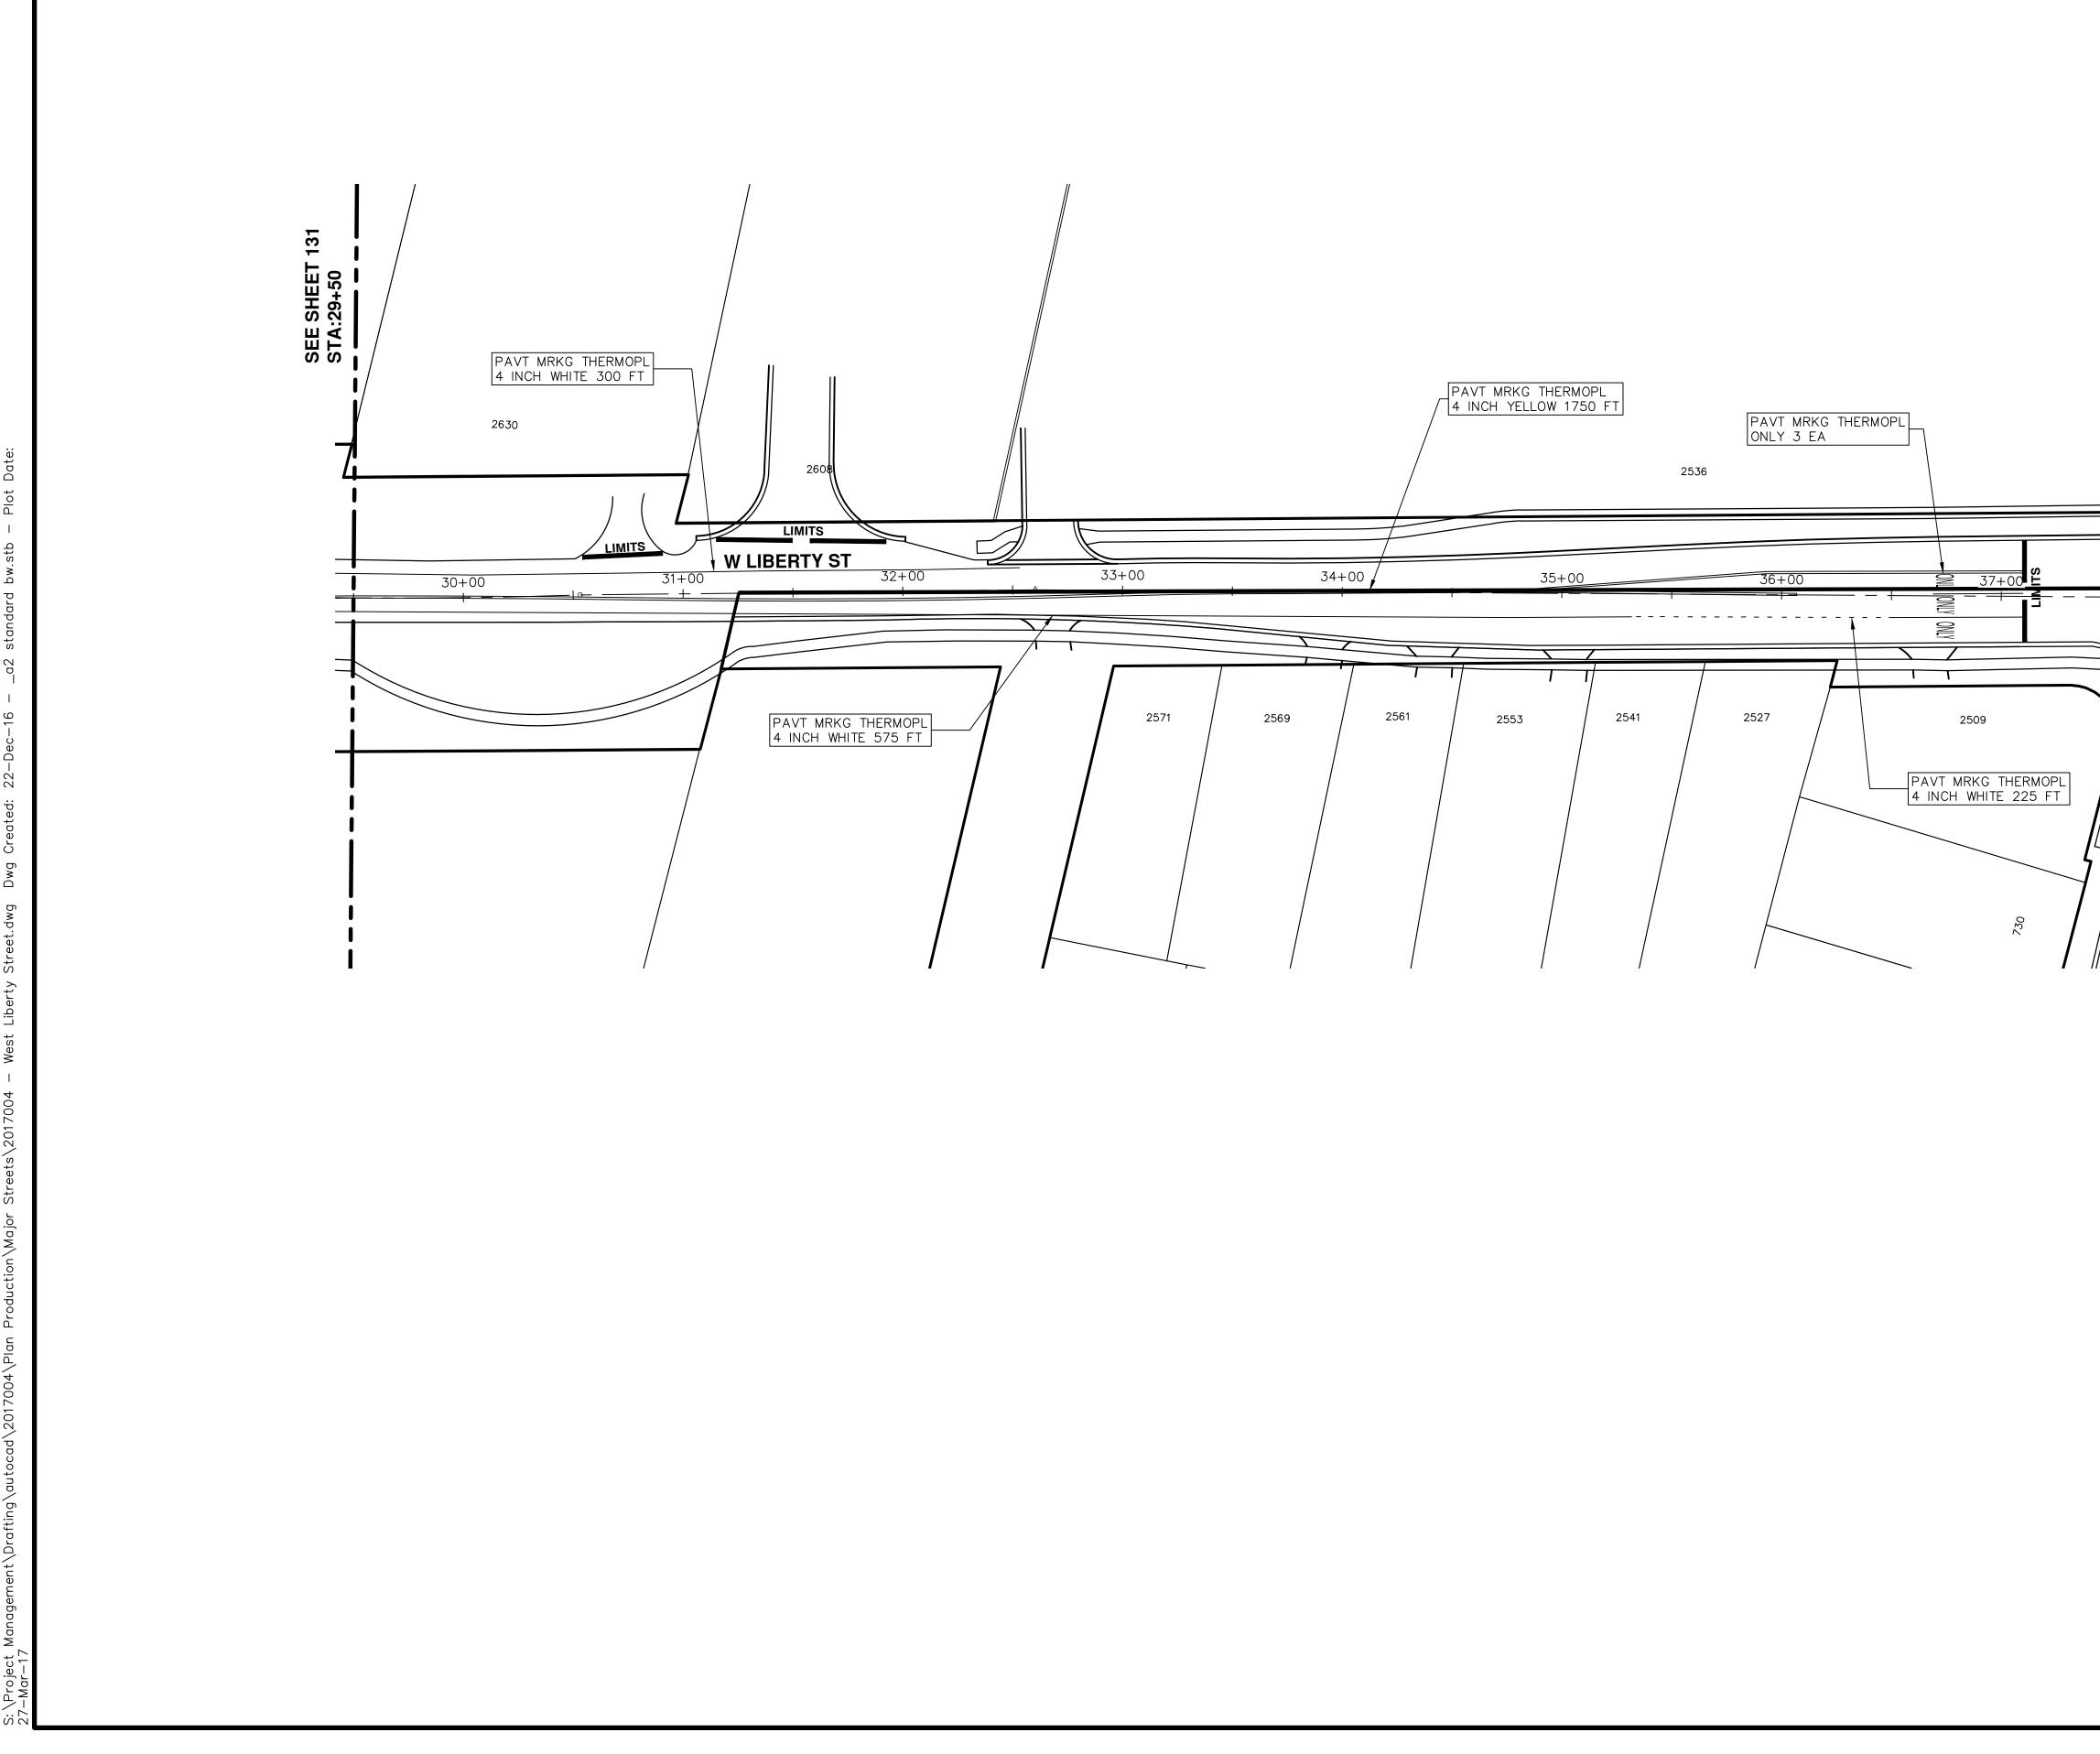

	AG,GS,RGDAD03-24-17AG,GS,RGDATEDADKhow what's below.DATEDRAWNCHECKED
BILLER STORES	01 ADDENDUM #1 00 BID SET REV. DESCRIPTION
	CITY OF ANN ARBOR DUBLIC SERVICE 301 EAST HURON STREET P.O. BOX 8647 ANN ARBOR, MI 48107-8647 734-794-6410 www.a2gov.org
	PROJECT MANAGEMENT - PUBLIC SERVICES - CITY OF ANN ARBOR CALE PLAN: 1:40 ANNUAL STREET RESURFACING - 2017 VIENT NATURET ANNU NG PAVENT NATURET PAVENT NATURET
	BREAT NO. 2017004-132 2017004-132



CITY OF ANN ARBOR PROJECT MANAGEMENT PROJECT LOCATION: W. STADIUM BLVD

	QUANTITIES		
Item Code	Item Description	Units	Quantity
2047001	_Curb, Gutter, and Curb and Gutter, Any Type, Rem	Ft	35.000
2047011	_Sidewalk, Sidewalk Ramp, and Driveway Approach, Any Thickness, Rem	Syd	50.000
2057011	_Grading, Sidewalk	Syd	9.000
2057011	_Grading, Sidewalk Ramp	Syd	42.000
2057021	_Subgrade Undercutting, Type IIA	Cyd	113.000
2080020	Erosion Control, Inlet Protection, Fabric Drop	Ea	3.000
5010003	Cold Milling HMA Surface	Ton	780.000
5010005	HMA Surface, Rem	Syd	8.000
5010057	HMA, 5E3	Ton	740.000
5010061	HMA, Approach	Ton	46.000
5017031	_HMA, Wedging, 36A	Ton	8.000
5017050	_HMA Surface, Around Structure Cover, Rem	Ea	5.000
6027021		Cyd	1.296
8027001	Curb and Gutter, Conc	Ft	35.000
8037001	_Detectable Warning Surface, Modified	Ft	15.000
8037010	_Sidewalk Ramp, Conc, 6 inch, Modified	Sft	375.000
8037010	_Sidewalk, Conc, 4 inch, Modified	Sft	75.000
8110520	Pavt Mrkg, Wet Retrflec, Thermopl, 4 inch, White	Ft	1,196.000
8110524	Pavt Mrkg, Wet Retrflec, Thermopl, 4 inch, Yellow	Ft	2,684.000
8110521	Pavt Mrkg, Wet Retrflec, Thermopl, 6 inch, White	Ft	120.000
8117001	_Pavt Mrkg, Wet Retrflec, Thermopl, 12 inch, Crosswalk	Ft	220.000
8117050	_Pavt Mrkg, Wet Retrflec, Thermopl, Lt Turn Arrow Sym	Ea	4.000
8120012	Barricade, Type III, High Intensity, Double Sided, Lighted, Furn	Ea	6.000
8120013	Barricade, Type III, High Intensity, Double Sided, Lighted, Oper	Ea	6.000
8120140	Lighted Arrow, Type C, Furn	Ea	2.000
8120141	Lighted Arrow, Type C, Oper	Ea	2.000
8120260	Plastic Drum, High Intensity, Lighted, Furn	Ea	70.000
8120261	Plastic Drum, High Intensity, Lighted, Oper	Ea	70.000
8120331	Sign, Portable, Changeable Message, Oper	Ea	4.000
8120350	Sign, Type B, Temp, Prismatic, Furn	Sft	231.000
8120351	Sign, Type B, Temp, Prismatic, Oper	Sft	231.000
8167011	_Slope Restoration	Syd	13.000

KEY	ASSOCIATED PAY ITEM(S)
	 _Dr Structure, Adj, Case 1, Modified
AA	 _Dr Structure, Adj, Case 2, Modified
	_Dr Structure, Temp Lowering, Modified
	_Dr Structure, Temp Lowering, Modified
AB	 _Gate Box, Adj, Case 1
110	_Gate Box, Adj, Case 2
	Monument Box Adjust
ADST	_Dr Structure, Adj, Add Depth, Modified
AK	 _Dr Structure, Adj, Case 1, Modified
	• _Sidewalk, Sidewalk Ramp, and Driveway Approach, Any Thickness, Rem
C4	_Grading, Sidewalk
	_Sidewalk, Conc, 4 inch, Modified
	• _Sidewalk, Sidewalk Ramp, and Driveway Approach, Any Thickness, Rem
C4HE	 _Grading, Sidewalk
24NE	Cement
	 _Sidewalk, Conc, 4 inch, Modified
	•_Sidewalk, Sidewalk Ramp, and Driveway Approach, Any Thickness, Rem
	• _Grading, Sidewalk
CE	• _Grading, Sidewalk Ramp
C6	Detectable Warning Surface, Modified
	 Sidewalk Ramp, Conc, 6 inch, Modified
	 _Sidewalk, Conc, 6 inch, Modified
<u></u>	Grading, Driveway Approach
C8	 _Driveway, Nonreinf Conc, 8 inch, Modified
	 Sidewalk, Sidewalk Ramp, and Driveway Approach, Any Thickness, Rem
	 Grading, Driveway Approach
	Grading, Sidewalk
	• _Grading, Sidewalk Ramp
0.1.1=	Cement
C HE	_Driveway, Nonreinf Conc, 6 inch, Modified
	Driveway, Nonreinf Conc, 8 inch, Modified
	Detectable Warning Surface, Modified
	 _Sidewalk Ramp, Conc, 6 inch, Modified
	_Sidewalk, Conc, 6 inch, Modified
	Curb, Gutter, and Curb and Gutter, Any Type, Rem
C/G	• _Curb and Gutter, Conc
	_Curb, Gutter, and Curb and Gutter, Any Type, Rem
/GHE	Cement
	_Driveway Opening, Conc, Det M, Modified
Martin 1	Grading, Sidewalk
CP	 Sidewalk, Conc, 4 inch, Modified
CR	 _Sidewalk, Sidewalk Ramp, and Driveway Approach, Any Thickness, Rem
UN	• Dr Structure, Rem
DS	• Sewer, Rem, Less than 24 inch
20	• Dr Structure, 24 inch dia
	• Dr Structure, Rem
DSDI	Sewer, Rem, Less than 24 inch
	_Dr Structure, Double Inlet
PT	Dr Structure, Point
ГІ	
	Dr Structure Cover, Type B
RRA	_Dr Structure Cover, Type B, Special
	_Dr Structure, Adj, Case 1, Modified
	_Dr Structure, Temp Lowering, Modified
RRK	Dr Structure Cover, Type K
	_Dr Structure, Adj, Case 1, Modified
RS	_Dr Structure, Reconstruct
YPE II	Plastic Drum, High Intensity, Lighted, Furn
	 Plastic Drum, High Intensity, Lighted, Oper
YPE III	Barricade, Type III, High Intensity, Double Sided, Lighted, Furn

ITB No. 4477 FILE No. 2017-004

	LEGEND
SYMBOL	DESCRIPTION
S	EXISTING SANITARY SEWER MANHOLE
(\mathbf{r})	EXISTING STORM SEWER MANHOLE
\otimes	EXISTING WATER MAIN VALVE IN WELL
+	WATER MAIN GATE VALVE IN BOX
+Q+	FIRE HYDRANT
9	MICHCON GAS CO. VALVE BOX/WELL
t	AMERITECH TELEPHONE VAULT
e	ELECTRIC MANHOLE
•	SOIL BORING
	EXISTING STORM SEWER INLET
٥	MONUMENT BOX
	REMOVE AND REPLACE CONC. SIDEWALK
· · · · · · · · · · · · · · · · · · ·	PLACE CONCRETE SIDEWALK
	REMOVE & REPLACE CONC. CURB & GUTTER
	CONSTRUCTION LIMITS
	6" WRAPPED UNDERDRAIN
	REMOVE CONCRETE SIDEWALK
	SUBGRADE UNDERCUT

CONSTRUCTION METHOD AND SEQUENCING

WORK ON THIS STREET INCLUDES, B ACCORDANCE WITH THE PLANS AND S TWO (2) PHASE CONSTRUCTION. PE AUTHORIZED OR DIRECTED BY THE CURRENTLY IN PLACE, LANE CLOSURE

- PHASE
- 1. IMPLEMENT MAINTENANCE OF TRAI CONTROL MEASURES.
- 2. CONDUCT REMOVAL WORK RELATED COLDMILLING.
- 3. INSTALL PROPOSED DRAINAGE STR
- 4. PERFORM ALL CONCRETE WORK, II
- 5. REMOVE 2 INCHES OF EXISTING H
- 6. PERFORM ALL JOINT AND CRACK REQUIRED.
- 7. CLEAN PAVEMENT AND PLACE 2 II

<u>PHASE II</u>

- 8. REPEAT ITEMS 1 THRU 6 IN THE
- 9. REMOVE 2 INCHES OF EXISTING H
- 10. PERFORM ALL JOINT AND CRACK REQUIRED.
- 11. CLEAN PAVEMENT AND PLACE 2 II
- 12. CLEAN PAVEMENT AND PLACE HM
- 13. CLEAN PAVEMENT AND COMPLETE
- 14. COMPLETE ALL MISCELLANEOUS CO
- 15. REMOVE ALL TRAFFIC CONTROL DE

NOT

FOR	ł
174	(
THRE	E
TO I	
PRE	
RELI	E
WHO	

THE POWE ARBO DRAW UTILI

THE WITH SPEC THE

	QUANTITIES								
Sign, Type B, Temp, Prismatic									
Quantity	Sign Code	Description	Area (sft)	Total Area					
15.0	D3-1	Street Name Sign	4.000	60.000					
2.0	W4-2(R)	Right Lane Ends Sign	9.000	18.000					
2.0	W4-2(L)	Left Lane Ends Sign	9.000	18.000					
15.0	W20-1	Road Work Ahead Sign	9.000	135.000					
			TOTAL	231.00					



ANN ARBOR, MICHIGAN 48107-8647 734-794-6410 www.a2gov.org

SHEET No.

133 OF 136

