


# CITY OF ANN ARBOR PROJECT MANAGEMENT

# MAXWELL, WAKEFIELD, LUTZ WATER MÁIN REPLACEMENT

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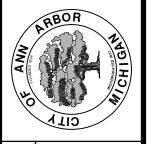
BID No. 4472, FILE No. 2016039

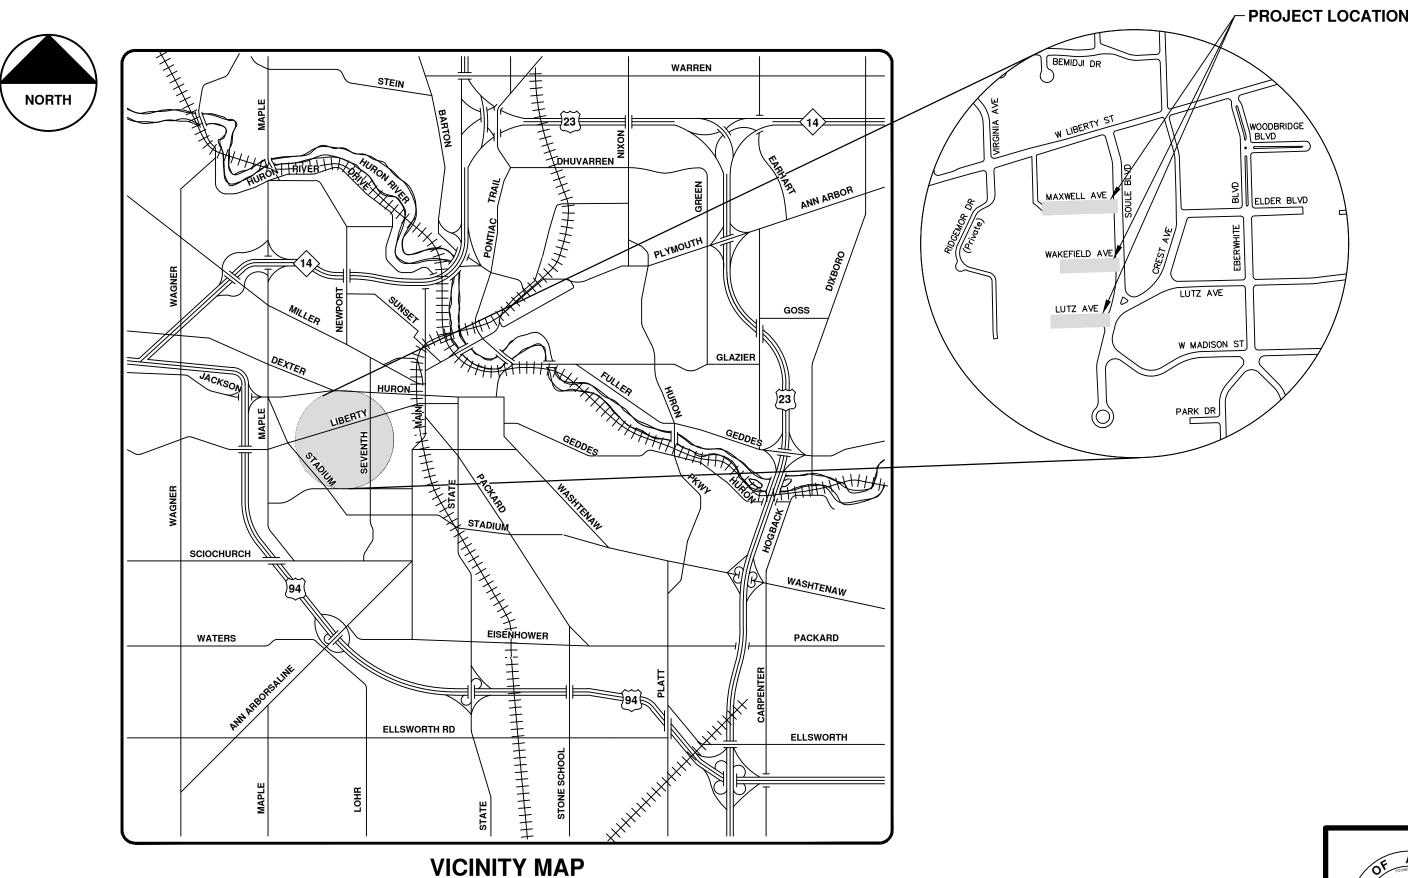

PUBLIC ACT 174 OF 2013, THE CONTRACTOR SHALL CALL 811 OR

ELECTRICAL POWER, CABLE TV AND FIBER OPTIC LINES ARE

STANDARD SPECIFICATIONS, IT'S DETAILS, WHICH ARE INCLUDED BY REFERENCE, AND THIS PROJECT'S CONTRACT DOCUMENTS. THE OMISSION OF ANY CURRENT STANDARD DETAIL DOES NOT RELIEVE THE CONTRACTOR




3/17/2017

PROJECT MANAGEMENT SERVICE UNIT

PREPARED UNDER THE SUPERVISION OF

PROJECT MANAGER

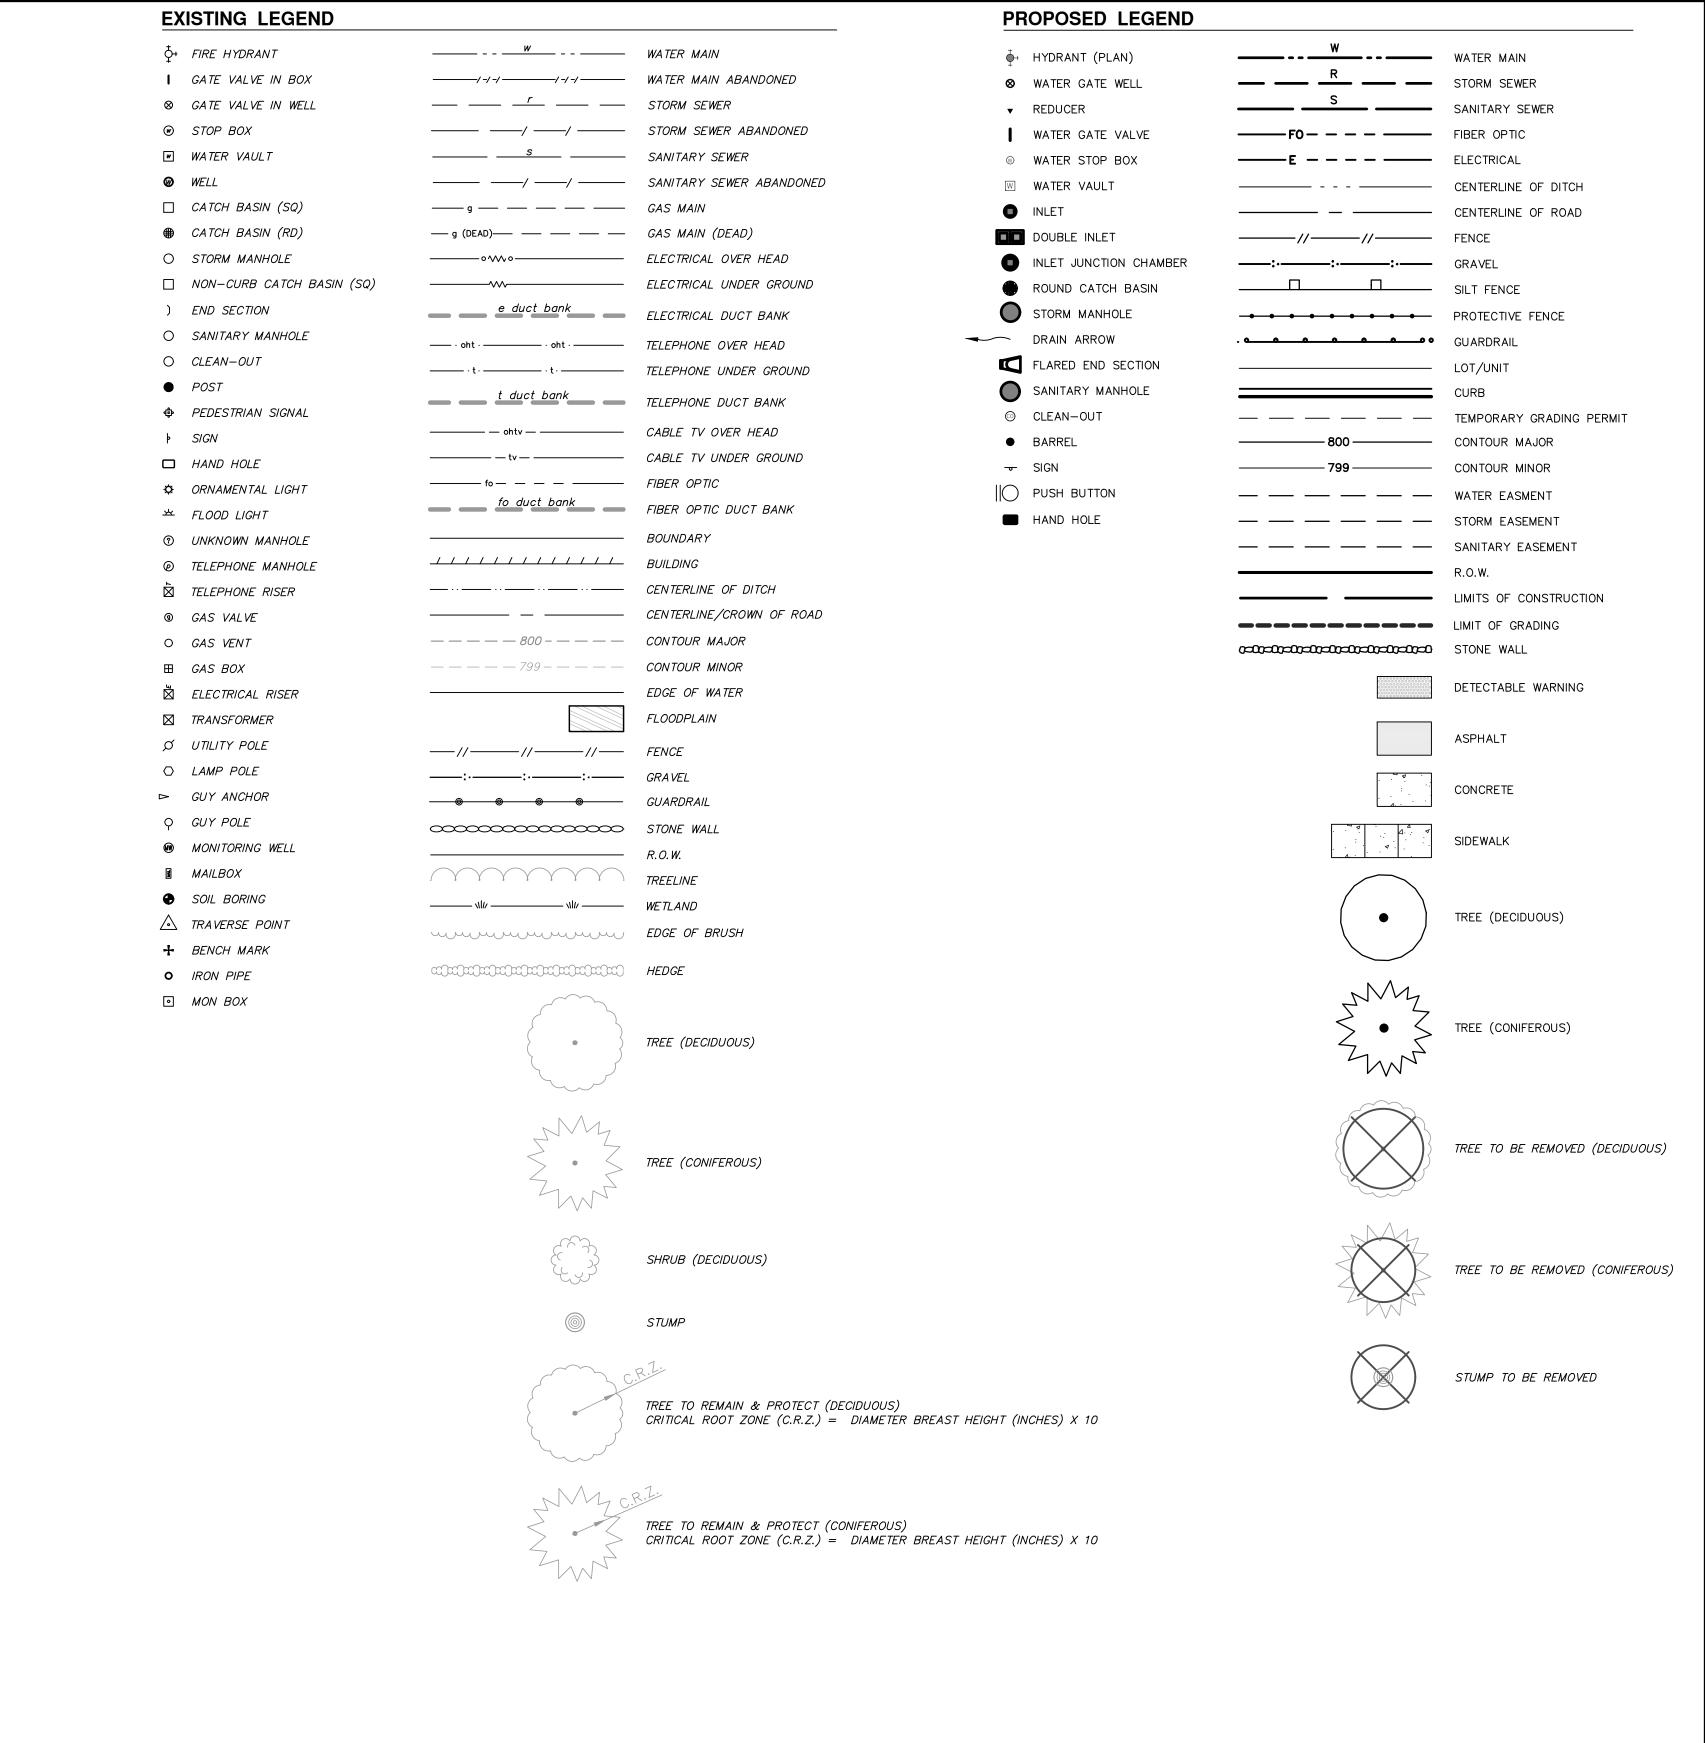

PROJECT MANAGEMENT - PUBLIC SERVICES - CITY OF ANN AF

SHEET No.

#### **CONSTRUCTION NOTES:**

- 1. Driveways and entrances to buildings, real property, and the like shall not be blocked except for short durations and only when approved by the Engineer. Vehicular and pedestrian access shall be maintained at all times. It shall be the Contractor's responsibility to coordinate all necessary driveway closures with the property owner(s) and resident(s) in the areas of construction.
- 2. The location and depth of all existing utilities and service leads are to be field verified by the Contractor prior to construction.
- 3. Location and depth of utilities as depicted on the plans is approximate and shown according to the best information available. It is the Contractor's responsibility to excavate ahead and adjust depth of conflict utilities accordingly. Any damage to utilities is the Contractor's responsibility to avoid and/or repair as necessary.
- 4. The Contractor is to take special care to protect the existing water main and be responsible for maintaining consistent water
- 5. During non-working hours no trench shall remain open; any open trench shall be properly secured with protective fencing. This work shall be included in the item of work "General Conditions".
- 6. Trenches for new water services shall be excavated to MIOSHA and City of Ann Arbor Field Services requirements.
- 7. City of Ann Arbor Public Services will install the corporation and copper service lead(s) to transfer the connection(s). If an existing water service is found to be failing or is not copper, the lead will be replaced to the curb box by Public Works staff.
- 8. For the installation of corporations, or any other related activities, the Contractor shall not receive additional compensation for delays due to the scheduling of or coordination with the City of Ann Arbor Public Works.
- 9. The Contractor shall backfill trenches in accordance with Trench Detail specified on plans. This work shall be included in the item of work "Excavate and Backfill for Water Service Tap and Lead". All concrete removals and replacements required for this work will be paid for separately.
- 10. All ductile iron pipe and fittings shall be polyethylene wrapped per ANSI/AWWA C105/A21.5.
- 11. Cor-blu bolts to be used at all mechanical water main joints at hydrants and Megalug
- 12. The Contractor shall construct, flush, and bacteriologically test the water main per Detailed Specification "Water Main Installation and Testing" and as approved by the Engineer. All chlorinated water shall be discharged directly into an approved sanitary sewer. The Contractor shall supply all necessary hoses, fittings and the like to accomplish this work.
- 13. Water main fittings, other than those specifically listed as separate pay items, which are required to complete the work, such as blow-off assemblies, concrete thrust blocks, solid sleeves and mechanical plugs, shall not be paid for separately, but shall be included in the pipe pay items.
- 14. "No Parking" signs shall be installed by the Contractor at locations as approved or directed by the Engineer. All signs shall be installed in accordance with the detailed specifications.

- 15. Postal delivery and refuse pickup service shall be maintained at all times by the Contractor.
- 16. All fittings, hydrants, valves and castings removed during construction are the property of the City of Ann Arbor. The Contractor within 48 hours shall deliver to City of Ann Arbor Field Operations and Maintenance Facility at the W.R. Wheeler Service Center located at 4251 Stone School Road.
- 17. Where street curbs are undermined due to construction activities, they shall be removed and replaced as directed by the Engineer.
- 18. The Contractor shall be responsible for the continuous maintenance of the temporary road surface and soil erosion control measures within the construction area until the full completion of the project. This work shall be included in the item of work "General Conditions".
- 19. All curb, sidewalk, driveway approach removals shall be approved by Engineer before the work is done.
- 20. Sawed sewer pipe connections shall be coupled with a Fernco flexible coupling and a stainless steel shear ring.
- 21. The location of material stock piles and on—site staging areas to be approved by the
- 22. For mainline paving, the width of the mat for each pass of the paver shall be not less than 10.5' or greater than 15', as directed by the Engineer. The Engineer will direct the layout of the longitudinal joints during construction.
- 23. All structures shall receive new castings as directed by the Engineer, as specified on the standard casting schedule. The existing castings are the property of the City of Ann Arbor. The Contractor shall deliver to City of Ann Arbor Field Operations and Maintenance Facility at the W.R. Wheeler Service Center located at 4251 Stone School Road.
- 24. Payment for drainage structure sumps, where specified, shall be included in the payment for the various drainage structure sizes and or
- 25. Where sewer pipes of different sizes or materials are joined, Fernco flexible couplings with stainless steel shear rings shall be used. The Contractor's purchase price for these devices, including shipping, shall be paid as an extra. Prior to payment for this item, the Contractor shall submit receipts for the Engineer's review and approval. All other costs associated with the installation of these devices shall be included in the payment for the sewer.
- 26. Where sewer and water main are to be removed & replaced or added, all pipe shall be installed using Trench Detail detailed in the specifications or shown on Plans. Backfill for sewer and water construction shall be MDOT Granular Material, Class II, Modified.
- 27. Existing street name, guide, and regulatory signs, and mailboxes which conflict with the proposed construction shall be removed prior to construction, stored in a manner which will prevent damage, and re—set in locations as directed by the Engineer. This work will not be paid for separately, but shall be included in "Machine Grading, Modified"
- 28. In areas where edge drain cannot be installed in accordance with City of Ann Arbor Detail SD-TD-11. the edge drain shall be installed at the depth as indicated on the plans, or as directed by Engineer. In no case shall the edge drain be installed at a grade less than 0.50% or at a depth of less than 2' below top of proposed pavement.

GENERAL
NOTIFY THE CITY OF ANN ARBOR SOIL EROSION CONTROL OFFICE 48 HOURS PRIOR TO BEGINNING WORK ON THE PROJECT. PHONE: 734-794-6265

- THE CONTRACTOR SHALL IMPLEMENT AND MAINTAIN THE SOIL EROSION CONTROL MEASURES AS SHOWN ON THE PLANS AND AS DIRECTED BY THE ENGINEER AT ALL TIMES DURING CONSTRUCTION. ANY MODIFICATIONS OR ADDITIONS TO THE SOIL EROSION CONTROL MEASURES DUE TO CONSTRUCTION OR CHANGED CONDITIONS SHALL BE AS DIRECTED AND APPROVED BY THE ENGINEER.
- 2. ALL SOIL EROSION AND SEDIMENTATION CONTROL WORK SHALL CONFORM TO THE PERMIT REQUIREMENTS OF THE CITY OF ANN ARBOR, CITY ORDINANCE CHAPTER 63, CITY OF ANN ARBOR STANDARDS DIVISION VII, THE LAWS OF THE STATE OF MICHIGAN, AND THE REQUIREMENTS OF THE CONTRACT DOCUMENTS.
- 3. DAILY, OR AFTER ANY STORM EVENT, INSPECTIONS OF EROSION CONTROL MEASURES SHALL BE MADE BY THE CONTRACTOR. PERIODIC INSPECTIONS MAY BE MADE BY THE ENGINEER TO DETERMINE THE EFFECTIVENESS OF EROSION AND SEDIMENTATION CONTROL MEASURES. ANY NECESSARY CORRECTIONS SHALL BE MADE WITHOUT DELAY, AND WITHOUT ADDITIONAL COST TO THE CITY OF ANN ARBOR.
- 4. EROSION AND SEDIMENTATION FROM WORK ON THE SITE SHALL BE CONTAINED ON THE SITE AND NOT BE ALLOWED TO COLLECT ON ANY OFF-SITE AREAS, ROADWAYS OR WATERWAYS.
- 5. ALL MUD/SOIL TRACKED ONTO ROADWAYS FROM THE SITE DUE TO CONSTRUCTION, SHALL BE PROMPTLY REMOVED BY THE CONTRACTOR. IF SO ORDERED, THE CONTRACTOR SHALL PROVIDE AND OPERATE A VACUUM-TYPE STREET SWEEPER, AT NO ADDITIONAL COST TO THE CITY OF ANN ARBOR, WITHIN FOUR (4) HOURS OF BEING SO ORDERED.
- 6. RESTORATION OF ALL DISTURBED AREAS, INCLUDING PLACEMENT OF TOPSOIL, SEED, FERTILIZER AND MULCH AND/OR SOD SHALL BE PERFORMED WITHIN FIVE (5) DAYS OF THE COMPLETION OF FINAL
- CONSTRUCTION OPERATIONS SHALL BE SCHEDULED AND PERFORMED SO THAT PREVENTATIVE SOIL EROSION CONTROL MEASURES ARE IN PLACE PRIOR TO EXCAVATION IN CRITICAL AREAS AND TEMPORARY STABILIZATION MEASURES ARE IN PLACE IMMEDIATELY FOLLOWING BACKFILLING OPERATIONS.
- 8. SPECIAL PRECAUTIONS WILL BE TAKEN IN THE USE OF CONSTRUCTION EQUIPMENT TO PREVENT SITUATIONS THAT PROMOTE EROSION.
- 9. PROPER DUST CONTROL SHALL BE MAINTAINED DURING CONSTRUCTION BY USE OF WATER TRUCKS AND/OR DUST PALLATIVE AS REQUIRED.
- 10. THE CONTRACTOR SHALL BE RESPONSIBLE FOR MAINTAINING ALL TEMPORARY SOIL EROSION CONTROL MEASURES AND REMOVAL OF SOME MEASURES UPON AUTHORIZED COMPLETION OF THE PROJECT FINAL COMPLETION OF PROJECT WILL NOT BE AUTHORIZED UNTIL ALL SITE WORK AND UTILITY CONSTRUCTION IS COMPLETE AND ALL SOILS ARE STABILIZED.
- 11. THE CONTRACTOR SHALL NOT GRADE INTO ADJACENT PROPERTIES. SILT AND PROTECTIVE FENCE SHALL BE INSTALLED AND MAINTAINED TO PREVENT GRADING, EROSION AND SEDIMENTATION INTO THE
- 12. TREE PROTECTION FENCING MUST REMAIN INTACT UNTIL RESTORATION OF THE SITE IS COMPLETE. SEQUENCE OF EROSION CONTROL MEASURES:
- THE CONTRACTOR IS TO SUBMIT TO THE ENGINEER. A SEQUENCE OF CONSTRUCTION WITH RESPECT TO THE SOIL EROSION CONTROL MEASURES FOR REVIEW, COMMENT AND APPROVAL. THIS SCHEDULE IS TO INCLUDE INSPECTION AND REPAIR OF ALL TEMPORARY EROSION CONTROL MEASURES DAILY AND WITHIN 24 HOURS OF A STORM EVENT.
- SAMPLE SOIL EROSION AND SEDIMENTATION CONTROL INSTALLATION MINIMUM REQUIREMENTS:

  1.1. INSTALL SILT FENCE, TREE PROTECTION FENCING, MUD MATS, INLET FILTERS ON EXISTING DRAINAGE FEATURES, AND ALL OTHER TEMPORARY SOIL EROSION CONTROLS, PRIOR TO ANY CLEARING OR EARTH MOVING OPERATION.
- 1.2. INSTALL WATER MAINS, STORM AND SANITARY SEWERS, AND OTHER ENCLOSED DRAINAGE FEATURES. NEW INLET FILTERS SHALL BE INSTALLED IMMEDIATELY FOLLOWING INSTALLATION OF NEW DRAINAGE
- 1.3. PERFORM MACHINE GRADING OPERATIONS AND CONSTRUCT PAVEMENTS (MAINLINE, SIDEWALKS,
- 1.4. CONTINUALLY MAINTAIN EROSION AND SEDIMENTATION CONTROL MEASURES, AS REQUIRED TO ALLOW DRAINAGE AND SEDIMENT REMOVAL. REMOVE ANY ACCUMULATED SEDIMENT IMMEDIATELY.
- 1.5. TEMPORARY SEED AND INSTALL EROSION CONTROL BLANKET IN ALL DISTURBED AREAS.
- 1.6. REFER TO LANDSCAPE PLANTING PLANS FOR PERMANENT SITE STABILIZATION.
- 1.7. CLEAN OUT STORM SEWER SYSTEMS.
- 1.8. REMEDY ANY NOTED DEFECTS TO THE SATISFACTION OF THE CITY OF ANN ARBOR'S SOIL EROSION AND SEDIMENTATION CONTROL OFFICIAL.
- 1.9. ALL TEMP. SOIL EROSION CONTROL MEASURES MUST BE REMOVED, WITH ENGINEERS APPROVAL, PRIOR TO FINAL INSPECTION
- NOTE: THIS SEQUENCE IS FOR INFORMATION ONLY. IT IS INTENDED TO SHOW THE SEQUENCE OF CONTRACTOR IS RESPONSIBLE FOR SUBMITTING THEIR OWN DETAILED CONSTRUCTION SEQUENCE AND SCHEDULE TO THE ENGINEER FOR REVIEW, COMMENT, AND APPROVAL.

#### **TEMPORARY SEEDING:**

- 1. SEED IN ACCORDANCE WITH PROJECT DRAWINGS AND SPECIFICATIONS.
- 2. ANY DISTURBED AREA NOT PAVED, SEEDED, MULCHED, SODDED OR BUILT UPON BY NOVEMBER 15TH OR JUNE 30TH IS TO BE TEMPORARILY STABILIZED PER SPECIFICATIONS.
- ON SITE SOILS PER THE USDA SOIL SURVEY OF WASHTENAW COUNTY, MICHIGAN: • WawabB - WAWASEE LOAM, 2 TO 6 PERCENT SLOPES; THIS SOIL CONSISTS OF VERY DEEP. WELL
- DRAINED SOILS FORMED IN TILL ON MORAINS AND TILL PLAINS. WawabC - WAWASEE LOAM, 6 TO 12 PERCENT SLOPES; THIS SOIL CONSISTS OF VERY DEEP, WELL DRAINED SOILS FORMED IN TILL ON MORAINS AND TILL PLAINS.

IMPERVIOUS PROJECT AREA

PRIOR TO CONSTRUCTION = 0.85 ACRES

POST CONSTRUCTION = 0.85 ACRES

AREA OF PROPOSED DISTURBANCE = 0.20 ACRES

#### PERMITS REQUIRED TO BE OBTAINED BY THE CONTRACTOR PRIOR TO THE REGINNING OF CONSTRUCTION

PERMIT	ISSUING AUTHORITY
ANE CLOSURE PERMIT*	CITY OF ANN ARBOR PROJECT MANAGEMENT UNIT
'NO PARKING" SIGNS PERMIT*	CITY OF ANN ARBOR PROJECT MANAGEMENT UNIT
GRADING/SOIL EROSION & SEDIMENTATION CONTROL PERMIT*	CITY OF ANN ARBOR CUSTOMER SERVICE
RIGHT-OF-WAY PERMIT*	CITY OF ANN ARBOR CUSTOMER SERVICE

#### PERMITS REQUIRED TO BE OBTAINED BY THE CITY OF ANN ARBOR PRIOR TO THE BEGINNING OF CONSTRUCTION.

PERMIT	ISSUING AUTHORITY
M.D.E.Q. WATER MAIN CONSTRUCTION PERMIT	MICHIGAN DEPARTMENT OF ENVIRONMENTAL QUALITY
M.D.E.Q. SANITARY SEWER CONSTRUCTION PERMIT	MICHIGAN DEPARTMENT OF ENVIRONMENTAL QUALITY

#### CONTACT INFORMATION

PUBLIC UTILITIES	OWNER	CONTACT
WATER		DAN WOODEN (734) 794-6350
SANITARY		PAT MAINO (734) 794-6350
STORM	CITY OF ANN ARBOR FIELD OPERATIONS SERVICE UNIT W.R. WHEELER SERVICE CENTER	PAT MAINO (734) 794-6350
FORESTRY	4251 STONE SCHOOL ROAD ANN ARBOR, MI 48108	MATT WALDSMITH (734) 794-6350
SIGNS SIGNALS STREET LIGHTS		СНИСК FOJПК (734) 794-6361
PRIVATE UTILITIES	OWNER	CONTACT
GAS	DTE ENERGY 3150 E. MICHIGAN AVE, YPSILANTI TOWNSHIP, MI 48198	ROBERT CZAPIEWSKI (734) 544–7818
ELECTRIC	DTE ENERGY WESTERN WAYNE SERVICE CENTER 8001 HAGGERTY ROAD BELLEVILLE, MI 48111	CLAY COMBEE (734) 397-4112
CABLE	COMCAST 27800 FRANKLIN ROAD SOUTHFIELD, MI 48034	RON SUTHERLAND (313) 999-8300
PHONE	AT&T 550 S. MAPLE ROAD ANN ARBOR, MI 48103	(734) 996–2135
FIBER OPTIC	MCI 2800 N. GLENFILLE ROAD RICHARDSON, TX 75082	DEAN BOYERS (972) 729-6016

BM#	ELEV	DESCRIPTION
1	883.515	SET RR SPIKE IN S'LY SIDE OF L.P. @ N.W. CORNER OF SOULE AND LUTZ
2	887.149	SET RR SPIKE IN S. SIDE OF U.P. ON N. SIDE OF LUTZ IN FRONT OF HSE # 1406
3	906.489	STEAMER VALVE ON FIRE HYD. NEAR S.E. CORNER OF ZION LUTHERAN CHURCH
4	891.727	SET RR SPIKE IN N. SIDE OF L.P. ON S. SIDE OF WAKEFIELD AT DRIVE FOR HSE NO. 1405
5	886.544	SET R.R. SPIKE IN S.E. SIDE OF L.P. @ N.W. CORNER OF SOULE AND WAKEFIELD
6	898.131	SET RR SPIKE IN S.E. SIDE OF L.P. @ N.W. CORNER OF MAXWELL AND SOULE
7	901.309	SET RR SPIKE IN N. SIDE OF L.P. ON S. SIDE OF MAXWELL
8	904.587	TOP, E. SIDE OF CONC. BASE FOR L.P. IN ZION LUTHERAN CHURCH PARKING LOT. POLE IS NORTHERN MOST ONE.



01         BID SET         3/17/17         JKA         AMW           00         INTERNAL CITY REVIEW         12/12/16         JKA         AMW           REV.         DESCRIPTION         DATE         DRAWN         CHECKED				준,	
BID SET 3/17/17 INTERNAL CITY REVIEW 12/12/16 DESCRIPTION DATE			AMW	AMW	CHECKED
BID SET INTERNAL CITY REVIEW DESCRIPTION			JKA	JKA	DRAWN
BID SET INTERNAL CITY F			3/17/17	12/12/16	DATE
00 REV.			BID SET	INTERNAL CITY REVIEW	DESCRIPTION
			10	00	REV.






ANN ARBC D, LUTZ


IL, WAKEFIEL MAIN REPLAC


MAXWEL WATER I

PROJECT MANAGEMENT


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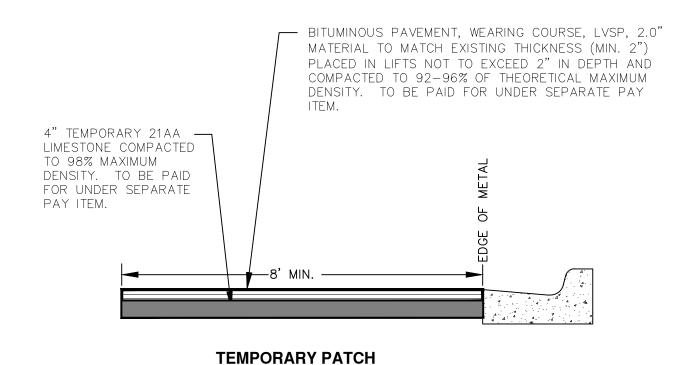


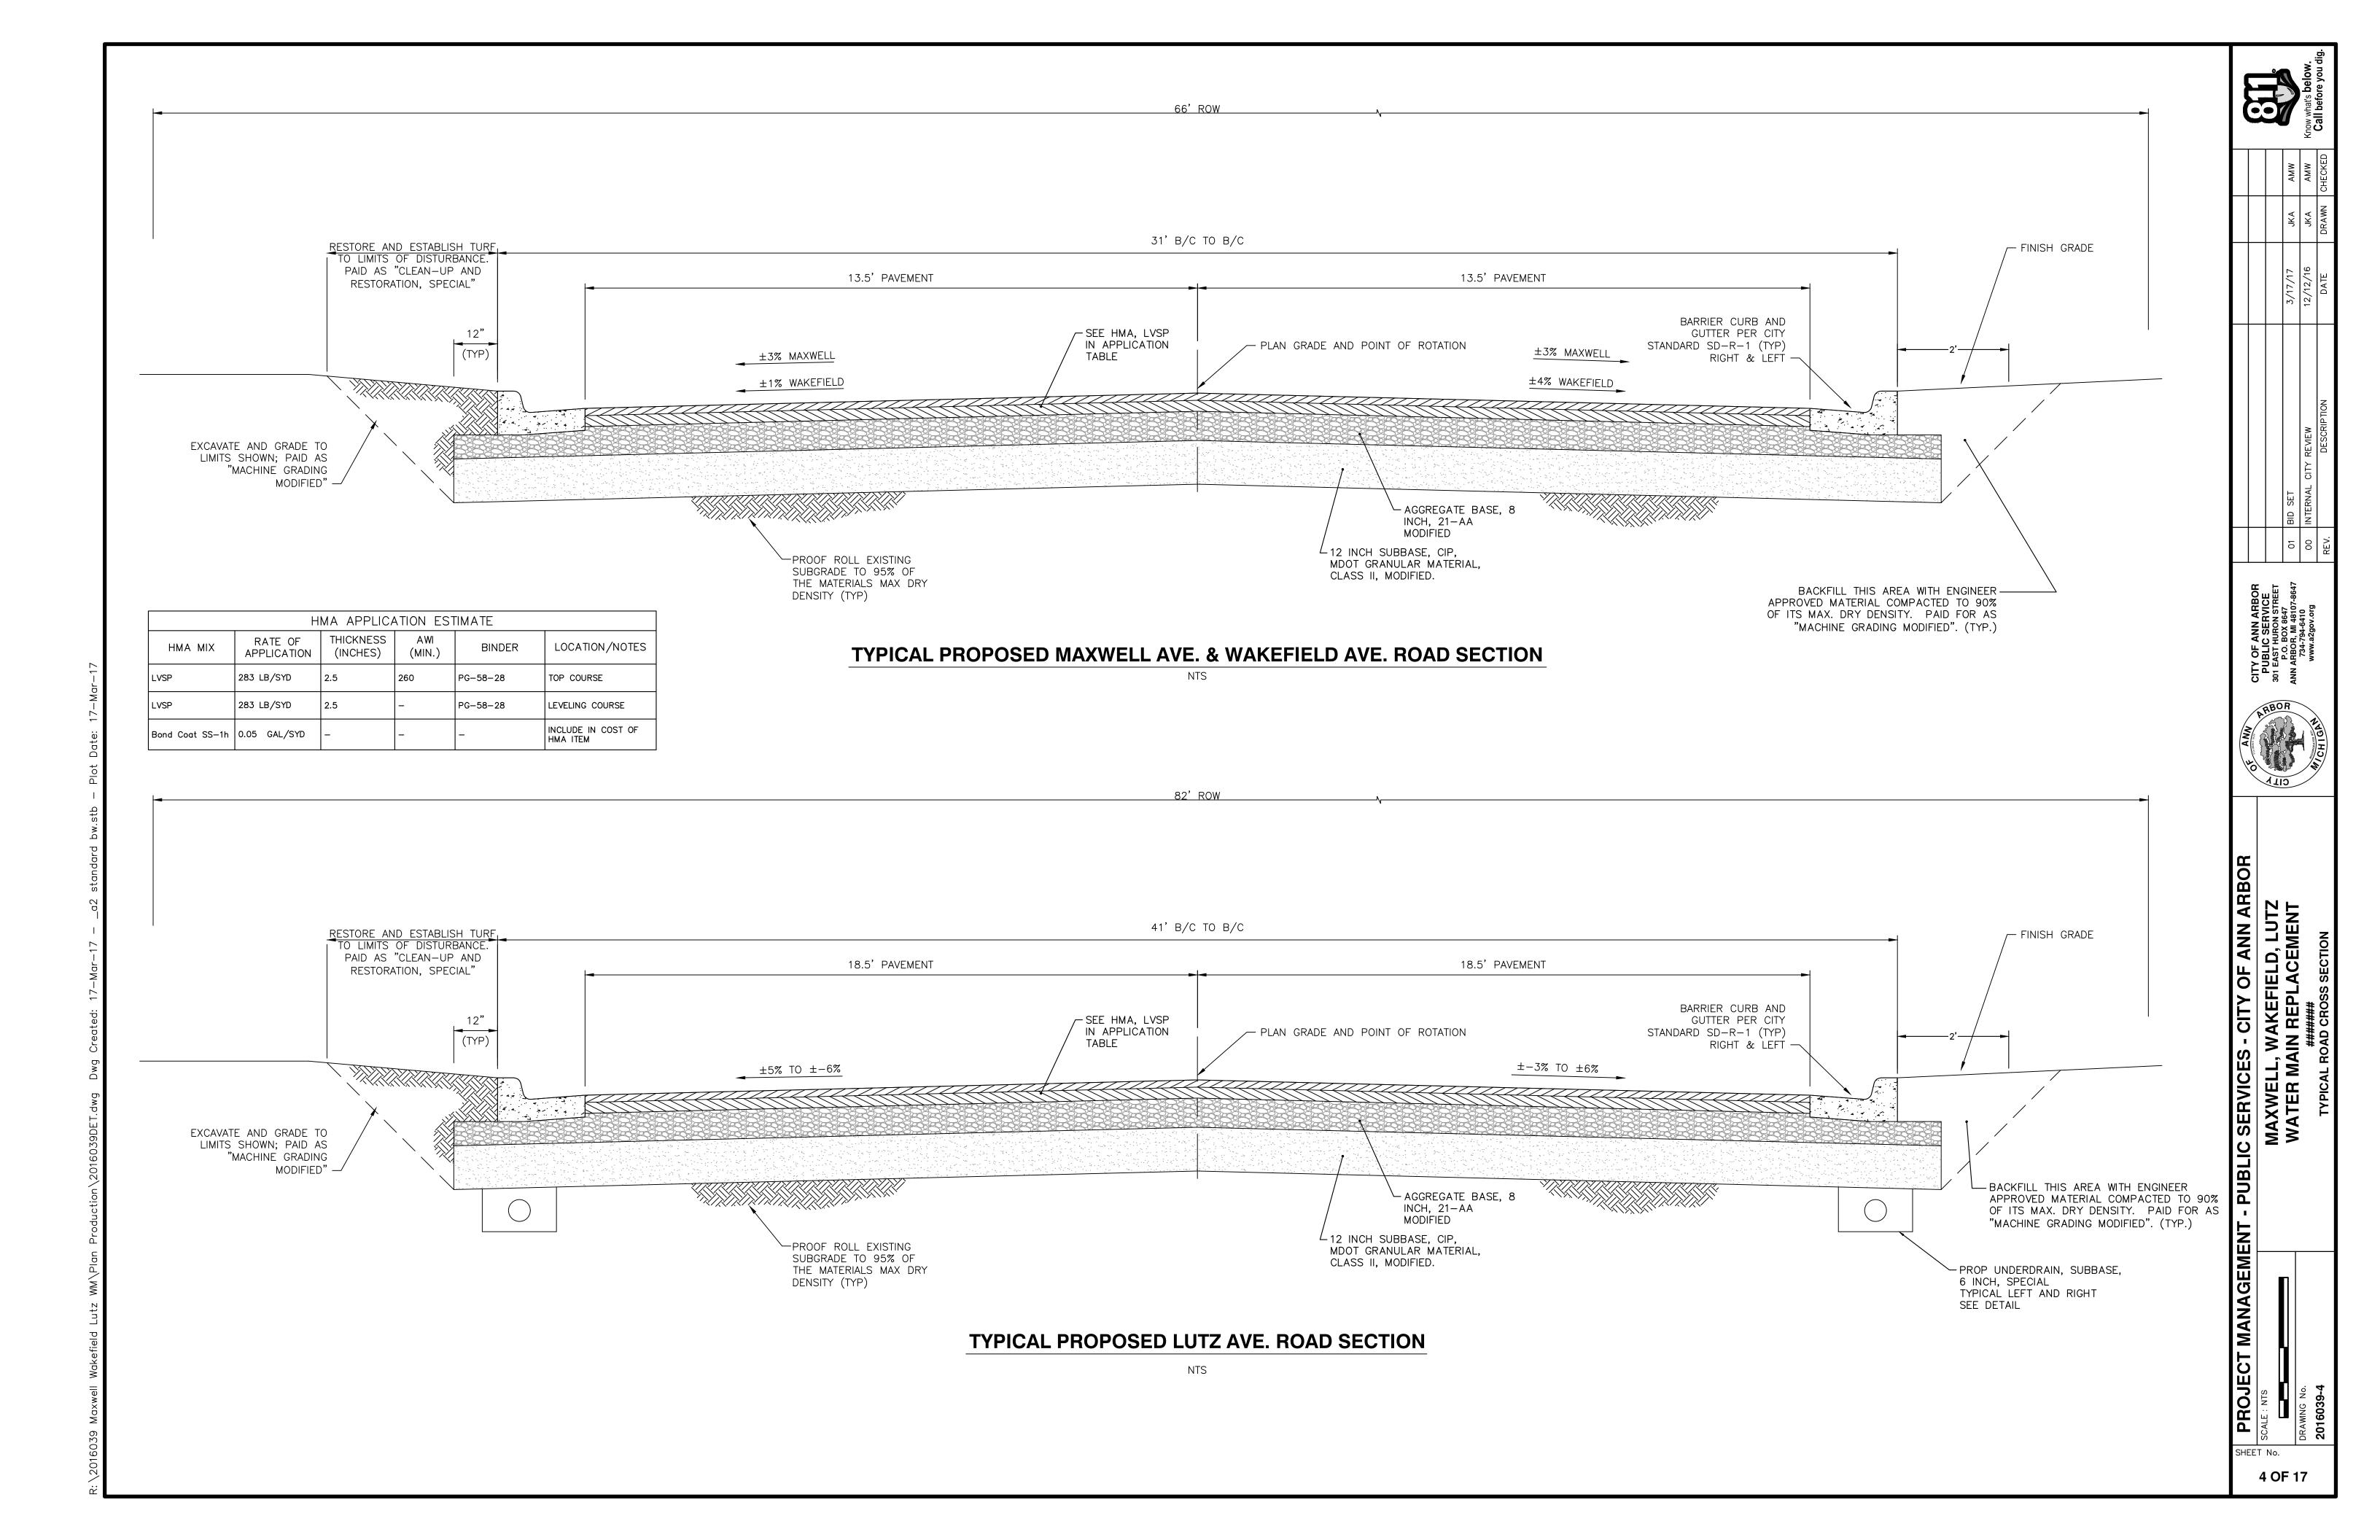


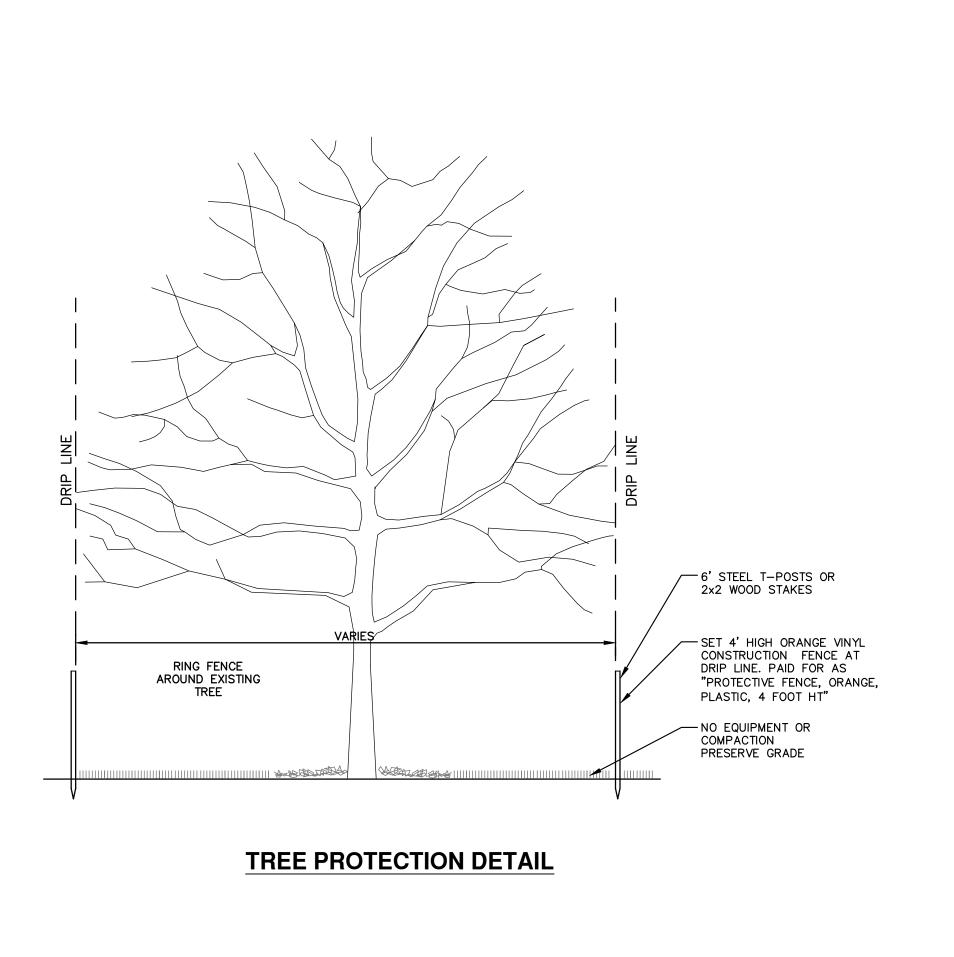**CURB, CONC, DET F4** NO SCALE

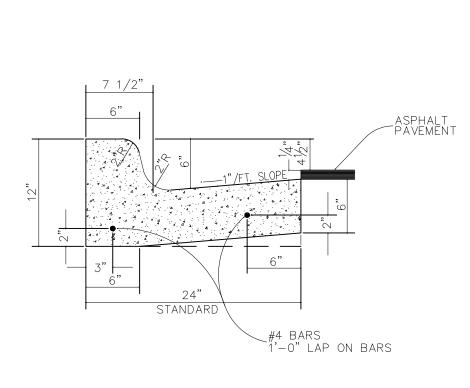

### TYPE "M" DRIVE APPROACH

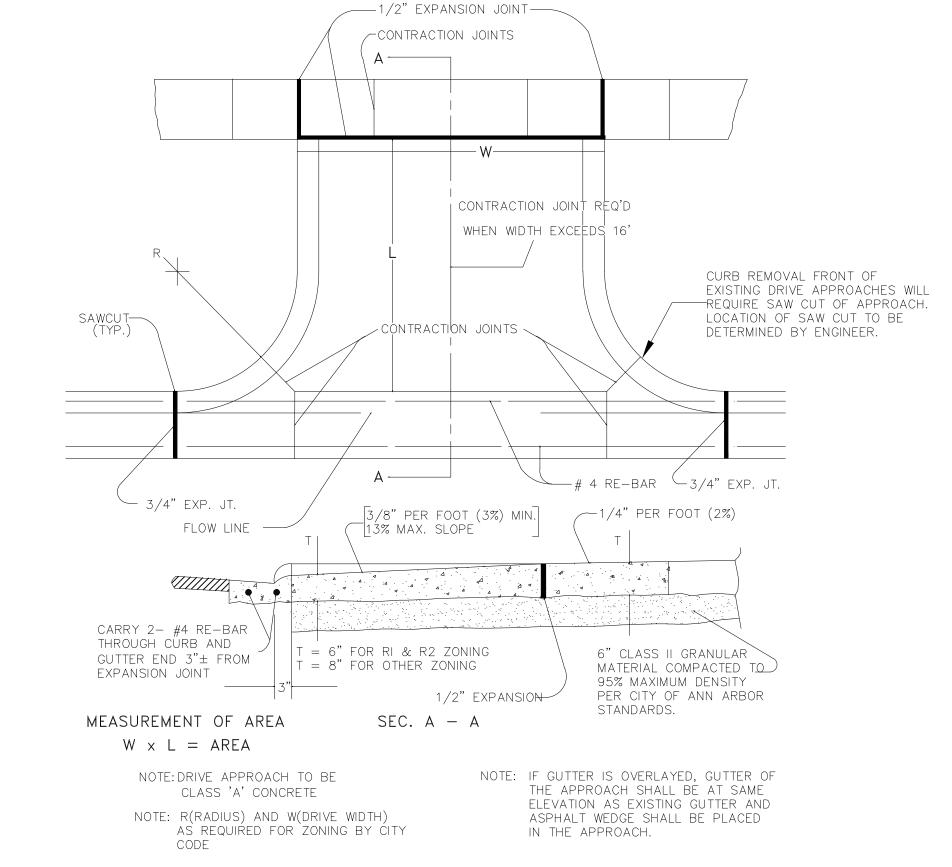

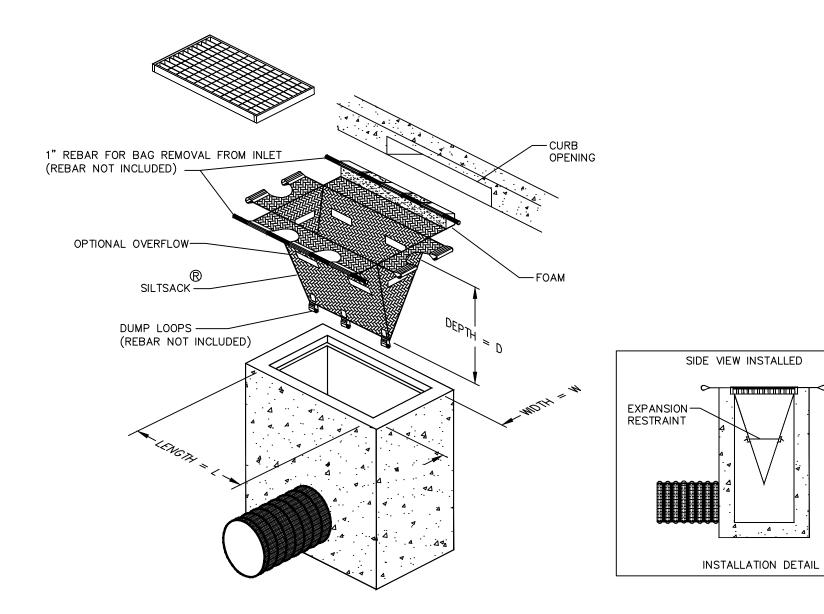

<u>SILTSACK</u>® SPECIFICATIONS NOTE: THE SILTSACK WILL BE MANUFACTURED FROM A WOVEN POLYPROPYLENE FABRIC THAT MEETS OR EXCEEDS THE FOLLOWING SPECIFICATIONS.

<u>REGULAR FLOW SILTSACK</u>®

(FOR AREAS OF LOW TO MODERATE PRECIPITATION AND RUN-OFF)

PROPERTIES  REQUIRED VALUE  TEST METHOD  RAB TENSILE STRENGTH ASTM D-4632 20% FUNCTURE ASTM D-4833 120 LBS FULLEN BURST RAPEZOID TEAR ASTM D-4533 120 LBS FUNCTURE ASTM D-4533 120 LBS FUNCTURE ASTM D-4533 120 LBS FUNCTION FOR ASTM D-4533 120 LBS FUNCTION FOR ASTM D-4535 80% FUNCTION FOR ASTM D-4751 FUNCTION FOR ASTM D-4751 FUNCTION FUN			
RAB TENSILE ELONGATION       ASTM D-4632       20%         PUNCTURE       ASTM D-4833       120 LBS         PUNCTURE       ASTM D-3786       800 PSI         RAPEZOID TEAR       ASTM D-4533       120 LBS         LV RESISTANCE       ASTM D-4355       80%         PPARENT OPENING SIZE       ASTM D-4751       40 US SIEVE         LOW RATE       ASTM D-4491       40 GAL/MIN/SQ FT	<u>PROPERTIES</u>	REQUIRED VALUE	TEST METHOD
ERMITIVITY ASIM D-4491 0.55 SEC-	RAB TENSILE ELONGATION PUNCTURE JULLEN BURST RAPEZOID TEAR JV RESISTANCE PPARENT OPENING SIZE LOW RATE	ASTM D-4632 ASTM D-4833 ASTM D-3786 ASTM D-4533 ASTM D-4355 ASTM D-4751 ASTM D-4491	20% 120 LBS 800 PSI 120 LBS 80% 40 US SIEVE 40 GAL/MIN/SQ FT
	CIVIALL LIALL I	ASTW D-TTSI	0.00 JLC

<u>HI-FLOW SILTSACK</u>®

(FOR AREAS OF MODERATE TO HEAVY PRECIPITATION AND RUN-OFF)

PROPERTIES	REQUIRED VALUE	TEST METHOD
GRAB TENSILE STRENGTH GRAB TENSILE ELONGATION PUNCTURE MULLEN BURST TRAPEZOID TEAR UV RESISTANCE APPARENT OPENING SIZE FLOW RATE PERMITTIVITY	ASTM D-4632 ASTM D-4632 ASTM D-4833 ASTM D-3786 ASTM D-4533 ASTM D-4555 ASTM D-4751 ASTM D-4491 ASTM D-4491	265 LBS 20% 135 LBS 420 PSI 45 LBS 90% 20 US SIEVE 200 GAL/MIN/SQ FT 1.5 SEC-1

OIL-ABSORBANT SILTSACK®

(FOR AREAS WHERE THERE IS A CONCERN FOR OIL RUN-OFF OR SPILLS)

DEPENDING ON YOUR PARTICULAR APPLICATION, THE SILTSACK® CAN BE MADE FROM EITHER ONE OF THE ABOVE FABRICS WITH AN OIL—ABSORBANT PILLOW INSERT OR, MADE COMPLETELY FROM AN OIL-ABSORBANT SILESACK WITH A WOVEN PILLOW INSERT.

**TEMPORARY PATCH** 


**INLET FILTER (MODIFIED)** 

SERVICES - CITY OF ANN ARBC MAXWELL, WAKEFIELD, LUTZ WATER MAIN REPLACEMENT PROJECT MANAGEMENT - PUBLIC


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APPLIES TO: WATER AND/OR SEWER CROSSINGS WITH LESS THAN 1.5' OF VERTICAL CLEARANCE - SEE PLANS FOR LOCATIONS

#### **CONCRETE UTILITY SADDLE**

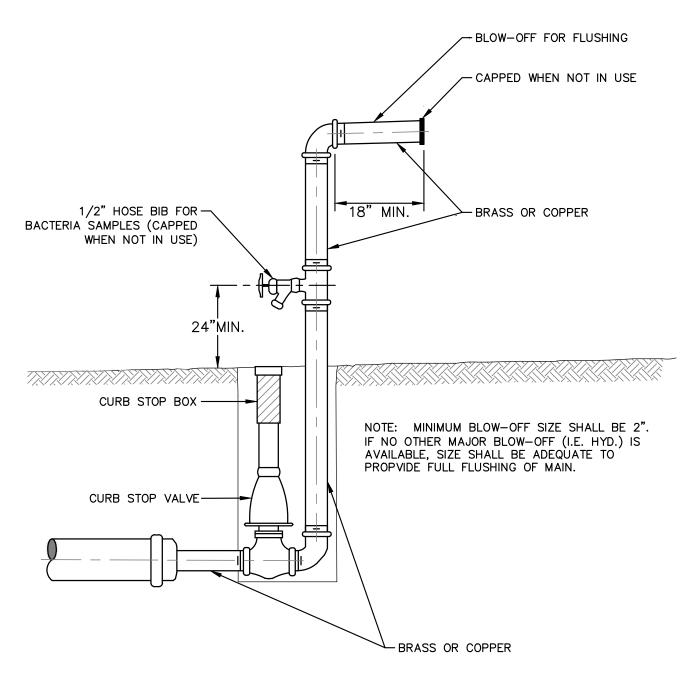

## **TEMPORARY TESTING BLOW OFF SD-W-7**

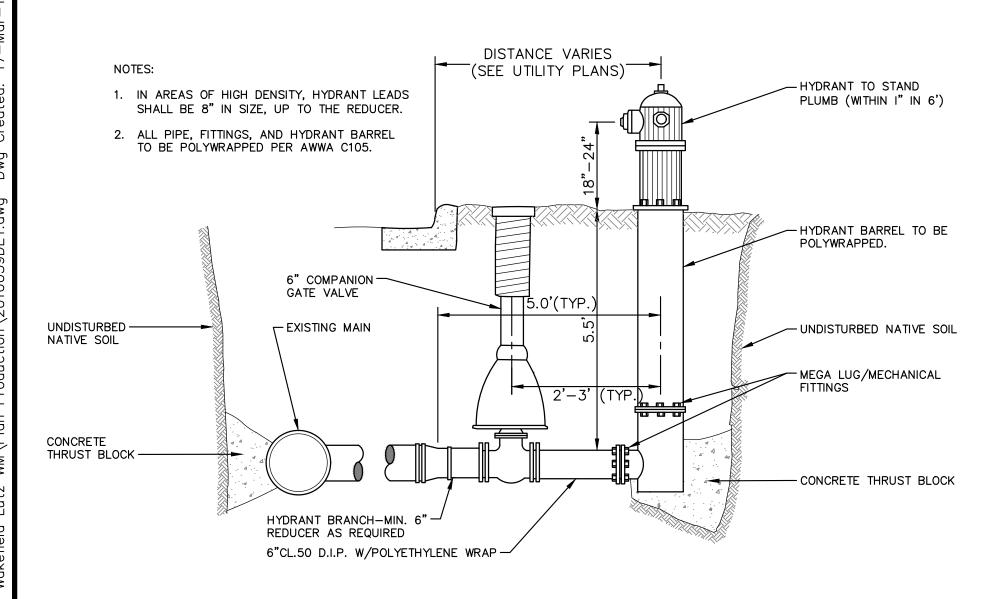


#### FIRE HYDRANT ASSEMBLY SD-W-1

#### MINIMUM STANDARDS


REACTION BACKING: The Class "A" concrete at the Fitting face shall extend to within (2) inches of the bell and shall extend from the fitting face a minimum of (2) feet to the UNDISTURBED SOLID GROUND. The dimensions of the reaction backing (thrust block) at the face of the undisturbed solid ground shall be as shown in the Table below. If there isn't sufficient space for the installation of the "thrust block" without interference with other services, another arrangement satisfactory to the engineer shall be used, i.e. encasement.

Fittings	Plug		Bends				Hvd	Irant			
I.D.	Tee	9	0°	4	45°	2.	2 <del>1</del> °	1	1 <del>1</del> °		
	Cross						_		•		
Inches	w H	W	Н	W	Н	W	Н	W	Н	W	Н
2.5	1 1	1	1	1	1						
4	1 1	1	1	1	1						
6	2 1.5	2	2	2	1	1	1	1	1	2	1.5
8	2.5 2	3.5	2	2	2	2	1	1	1	2.5	2
12	3.5 3	5.5	3	3.5	2.5	2	2	2	1		
16	6 3.5	6	4	5	3	3.5	2.5	2	2		
20	8 4	12	4	6	4	4	3	3	2		
24	11 4	17	4	9	4	6	4	3.5	2		
30	11 4	17	4	9	4	6	4	3.5	2		

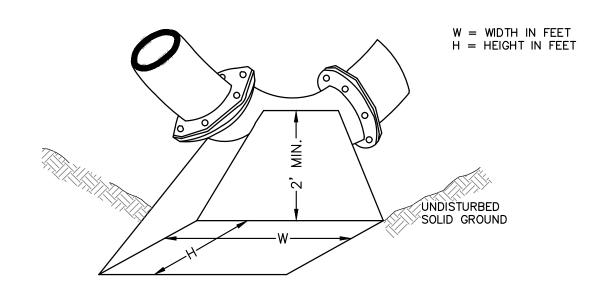


NOTE: THESE ARE MINIMUM STANDARDS. WHERE SOIL CONDITIONS DICTATE, ADJUSTMENTS IN SIZE SHALL BE MADE BY THE PUBLIC SERVICES

#### THRUST BLOCK

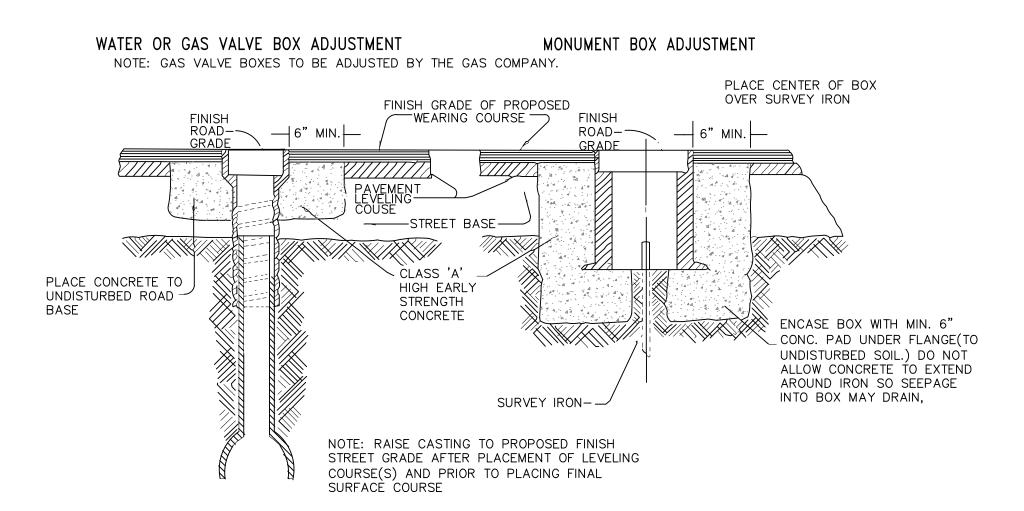


#### **VALVE/MONUMENT BOX ADJUSTMENT**

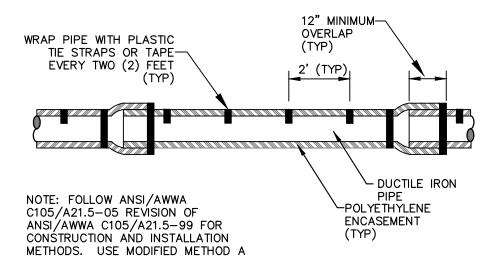

APPLIES TO: POLYETHYLENE WRAPPED D.I. WATERMAIN SEE PLANS FOR LOCATIONS


#### POLYETHYLENE ENCASEMENT (DRY INSTALLATION)

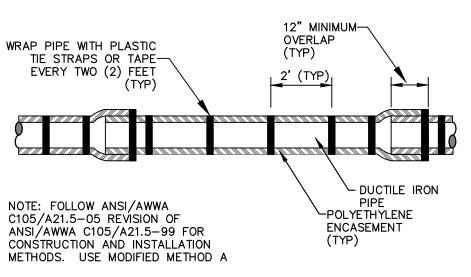

APPLIES TO: POLYETHYLENE WRAPPED D.I. WATERMAIN SEE PLANS FOR LOCATIONS

#### POLYETHYLENE ENCASEMENT (WET INSTALLATION)

PLAN VIEW

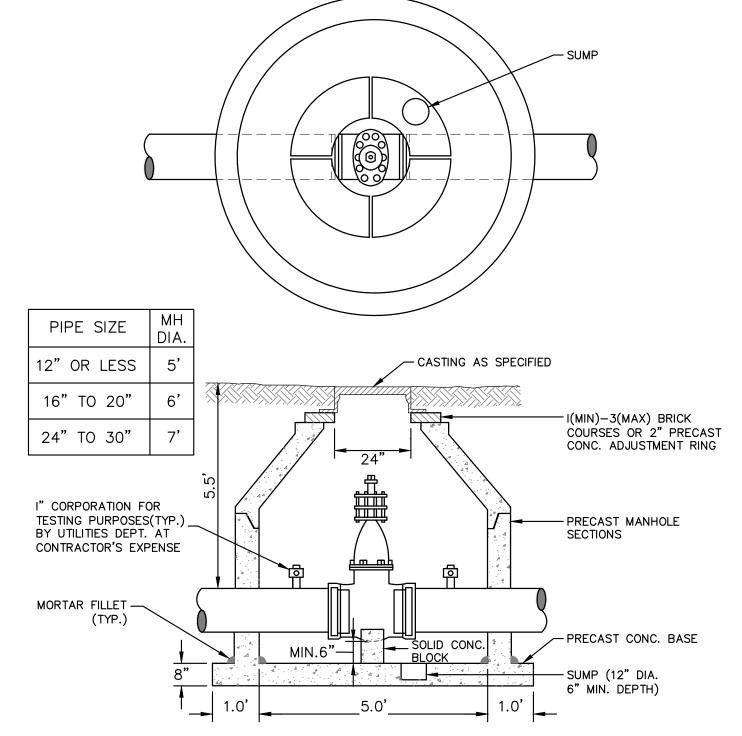

#### NOTES:

- 1. ALL LIFT HOLES AND JOINTS SHALL BE MORTARED BOTH INSIDE AND OUTSIDE.
- 2. ALL JOINTS MADE WATER TIGHT WITH RUBBER GASKET JOINTS.
- 3. NO STEPS PERMITTED

### **GATE WELL FOR MAIN**





SERVICES - CITY OF ANN ARBOF
MAXWELL, WAKEFIELD, LUTZ
WATER MAIN REPLACEMENT
######
WATER MAIN DETAILS

SERVICES .

PROJECT MANAGEMENT - PUBLIC

SHEET No.

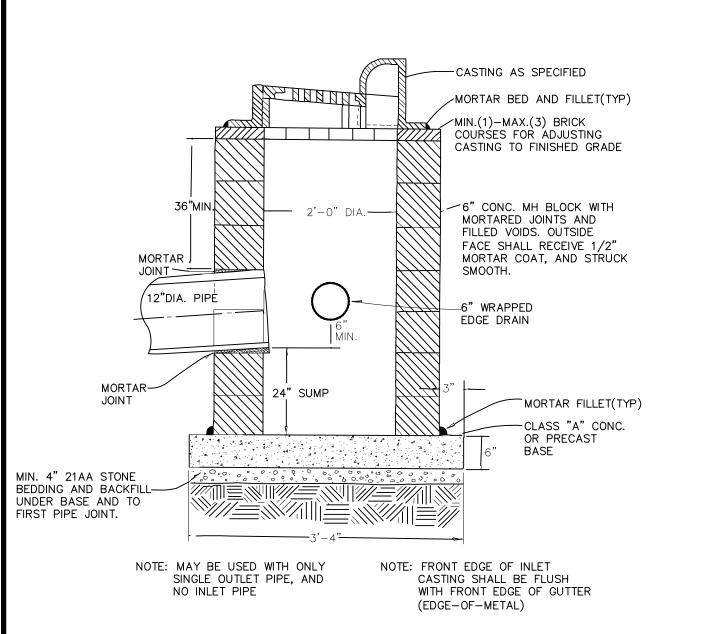

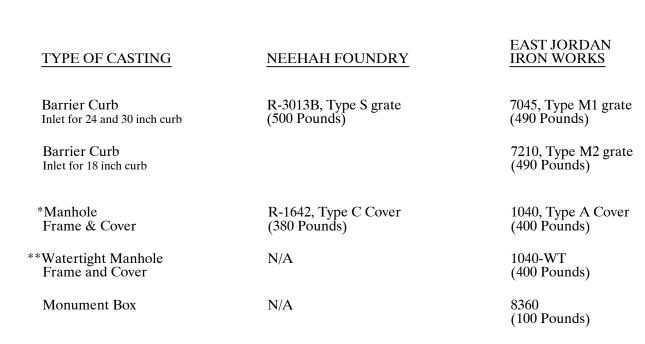


\*Frames and covers must have machined bearing surfaces. Covers must have two (2) 1" vent holes located opposite each other and 6" from the edge of the cover. Each cover shall have "Sewer", "S" or "Water", "W" cast in the surface, whichever is applicable.

\*\*Frames and covers must have machined bearing surfaces. Each cover shall have "Sewer", "S" or "Water", "W" cast in the surface, whichever is applicable.

#### RAISE M.H. CASTING TO PROPOSED FINISH STREET GRADE AFTER PLACEMENT OF LEVELING COURSE(S) AND PRIOR TO PLACING FINAL SURFACE COURSE. -POINTED SMOOTH OR FINE BRUSH FINISH -PAVEMENT WEARING MORTAR BED COURSE PAVEMENT BASE AND LEVELING -COURSE CLASS 'A' HIGH-EARLY STRENGTH CONCRETE TO BE PLACED TO UNDISTURBED ROAD CONCRETE BRICK OR 2" PRECAST CONCRETE NOTE: IF MANHOLE TO BE PLACED IN GRAVEL ROAD, ADJUSTMENT RING SET CASTING TO BE SET 6" TO 8" BELOW ROADWAY IN MORTAR--MIN. GRADE. ALL CONSTRUCTION METHODS SHALL 1/4" MIN. THICKNESS AND SUFFICENT ONE, MAX. 3 COURSE REMAIN AS SHOWN ABOVE. TO CARRY THE CONSTRUCTION LOAD.


MANHOLE CASTING ADJUSTMENT

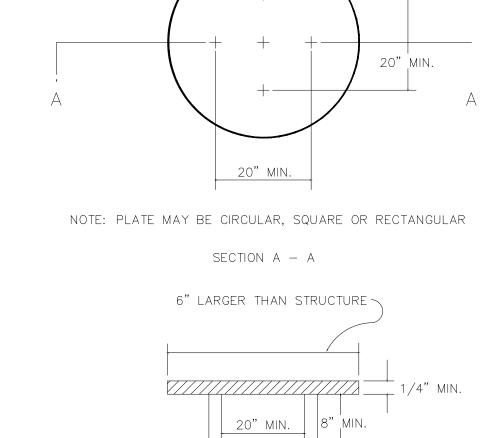


STRUCTURE PLATE

### SINGLE INLET STRUCTURE



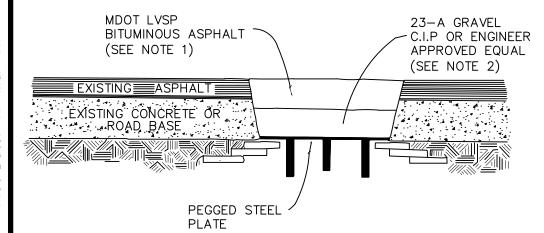

MANHOLE LOWERING DETAIL

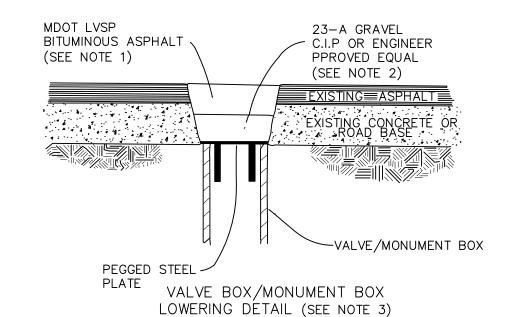


NOTE 1: IF TRAFFIC IS TO BE MAINTAINED ON THE ROADWAY BEFORE OR AFTER THE COLD MILLING OPERATION, THE STRUCTURE SHALL BE LOWERED TO THE EXTENT THAT A MINIMUM OF THREE(3) INCHES ASPHALT MATERIAL MDOT LVSP. OR ENGINEER APPROVED EQUAL, REMAINS -TO SUPPORT

TRAFFIC.

NOTE 2: IF THE ROADWAY BEING MILLED IS CLOSED TO TRAFFIC, THE STRUCTURE SHALL BE LOWERED SUCH THAT THE STEEL PLATE IS A MINIMUM OF FOUR(4) INCHES BELOW THE PROPOSED ROAD GRADE AND THE RESULTING VOID SHALL BE FILLED WITH COMPACTED 23-A GRAVEL OR ENGINEER APPROVED EQUAL.

NOTE 3: WHERE A MONUMENT IS TO BE LOWERED, THE CONTRACTOR SHALL GIVE THE ENGINEER A MINIMUM OF 48 HOURS WRITTEN NOTICE SO THAT THE MONUMENT CAN BE PROPERLY WITNESSED OR PROTECTED. FAILURE TO DO SO SHALL RESULT IN THE REPLACING SAID MONUMENT AT THE CONTRACTORS EXPENSE.

#### MANHOLE & VALVE/MONUMENT BOX LOWERING

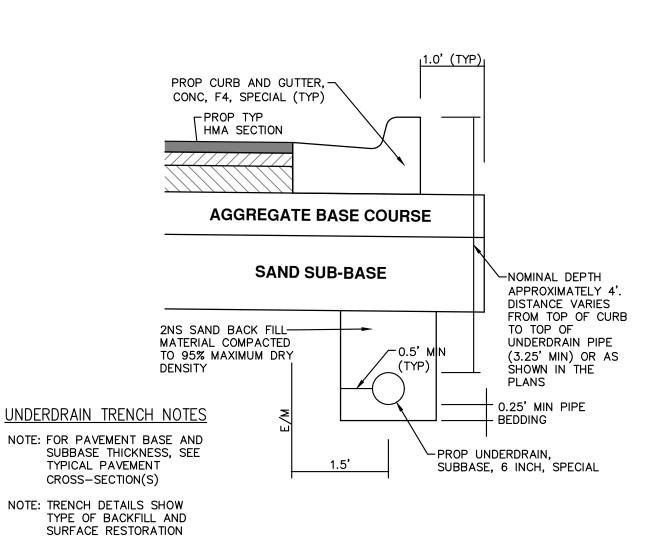

TRENCH DETAIL FOR **UNDERDRAIN (UNDER HMA PAVEMENT)** 

APPLICABLE M.I.O.S.H.A. APPLIES TO: HMA PAVEMENT - SEE PLANS FOR LOCATIONS

BASED ON CITY OF ANN ARBOR STANDARD SD-TD-10

ONLY

NOTE: ALL TRENCHING TO

STANDARDS

CONFORM TO ALL

## - PIPE AS SPECIFIED - CASTING AS SPECIFIED 2-8"x8"x40" PRECAST CONCRETE. LINTELS WITH 2-NO.3 BARS EACH - 8"x8"x16" CONC. BLOCK WITH 2' DIA. MORTAR JOINT MORTARED JOINTS AND FILLED CORES. OUTSIDE FACE SHALL RECEIVE 1/2" MORTAR COAT AND STRUCK SMOOTH. 6" WRAPPED EDGE DRAIN SPECIFIED 7 MORTAR JOINT -- MORTAR FILLET (TYP.) MIN. 4" 21AA STONE BEDDING AND BACKFILL UNDER BASE AND TO UNDER BASE AND TO FIRST PIPE JOINT.

/─ 2-8"x8"x40" PRECAST CONC.

LINTELS W/2-NO.3 BARS

1. FRONT EDGE OF INLET CASTINGS SHALL BE FLUSH WITH THE FRONT EDGE OF GUTTER (EDGE-OF-METAL)

2. 2' SUMP REQUIRED ON ALL DRAINAGE STRUCTURES


## **DOUBLE INLET STRUCTURE SD-S-11**

#### **UTILITY TRENCH DETAILS**


UTILITY TRENCH NOTES


NOTE: TRENCH DETAILS SHOW TYPE OF BACKFILL AND SURFACE RESTORATION

NOTE: ALL TRENCHING TO CONFORM TO ALL APPLICABLE M.I.O.S.H.A. STANDARDS

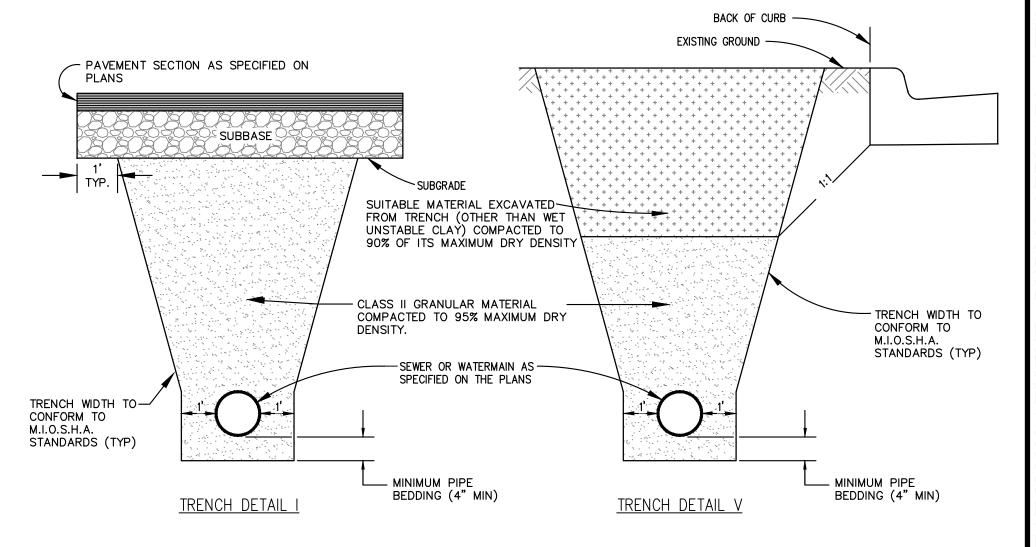

IC SERVICES - CITY OF ANN ARBOR
MAXWELL, WAKEFIELD, LUTZ
WATER MAIN REPLACEMENT
######
STORM SEWER DETAILS PUBLIC PROJECT MANAGEMENT SHEET No. 7 OF 17

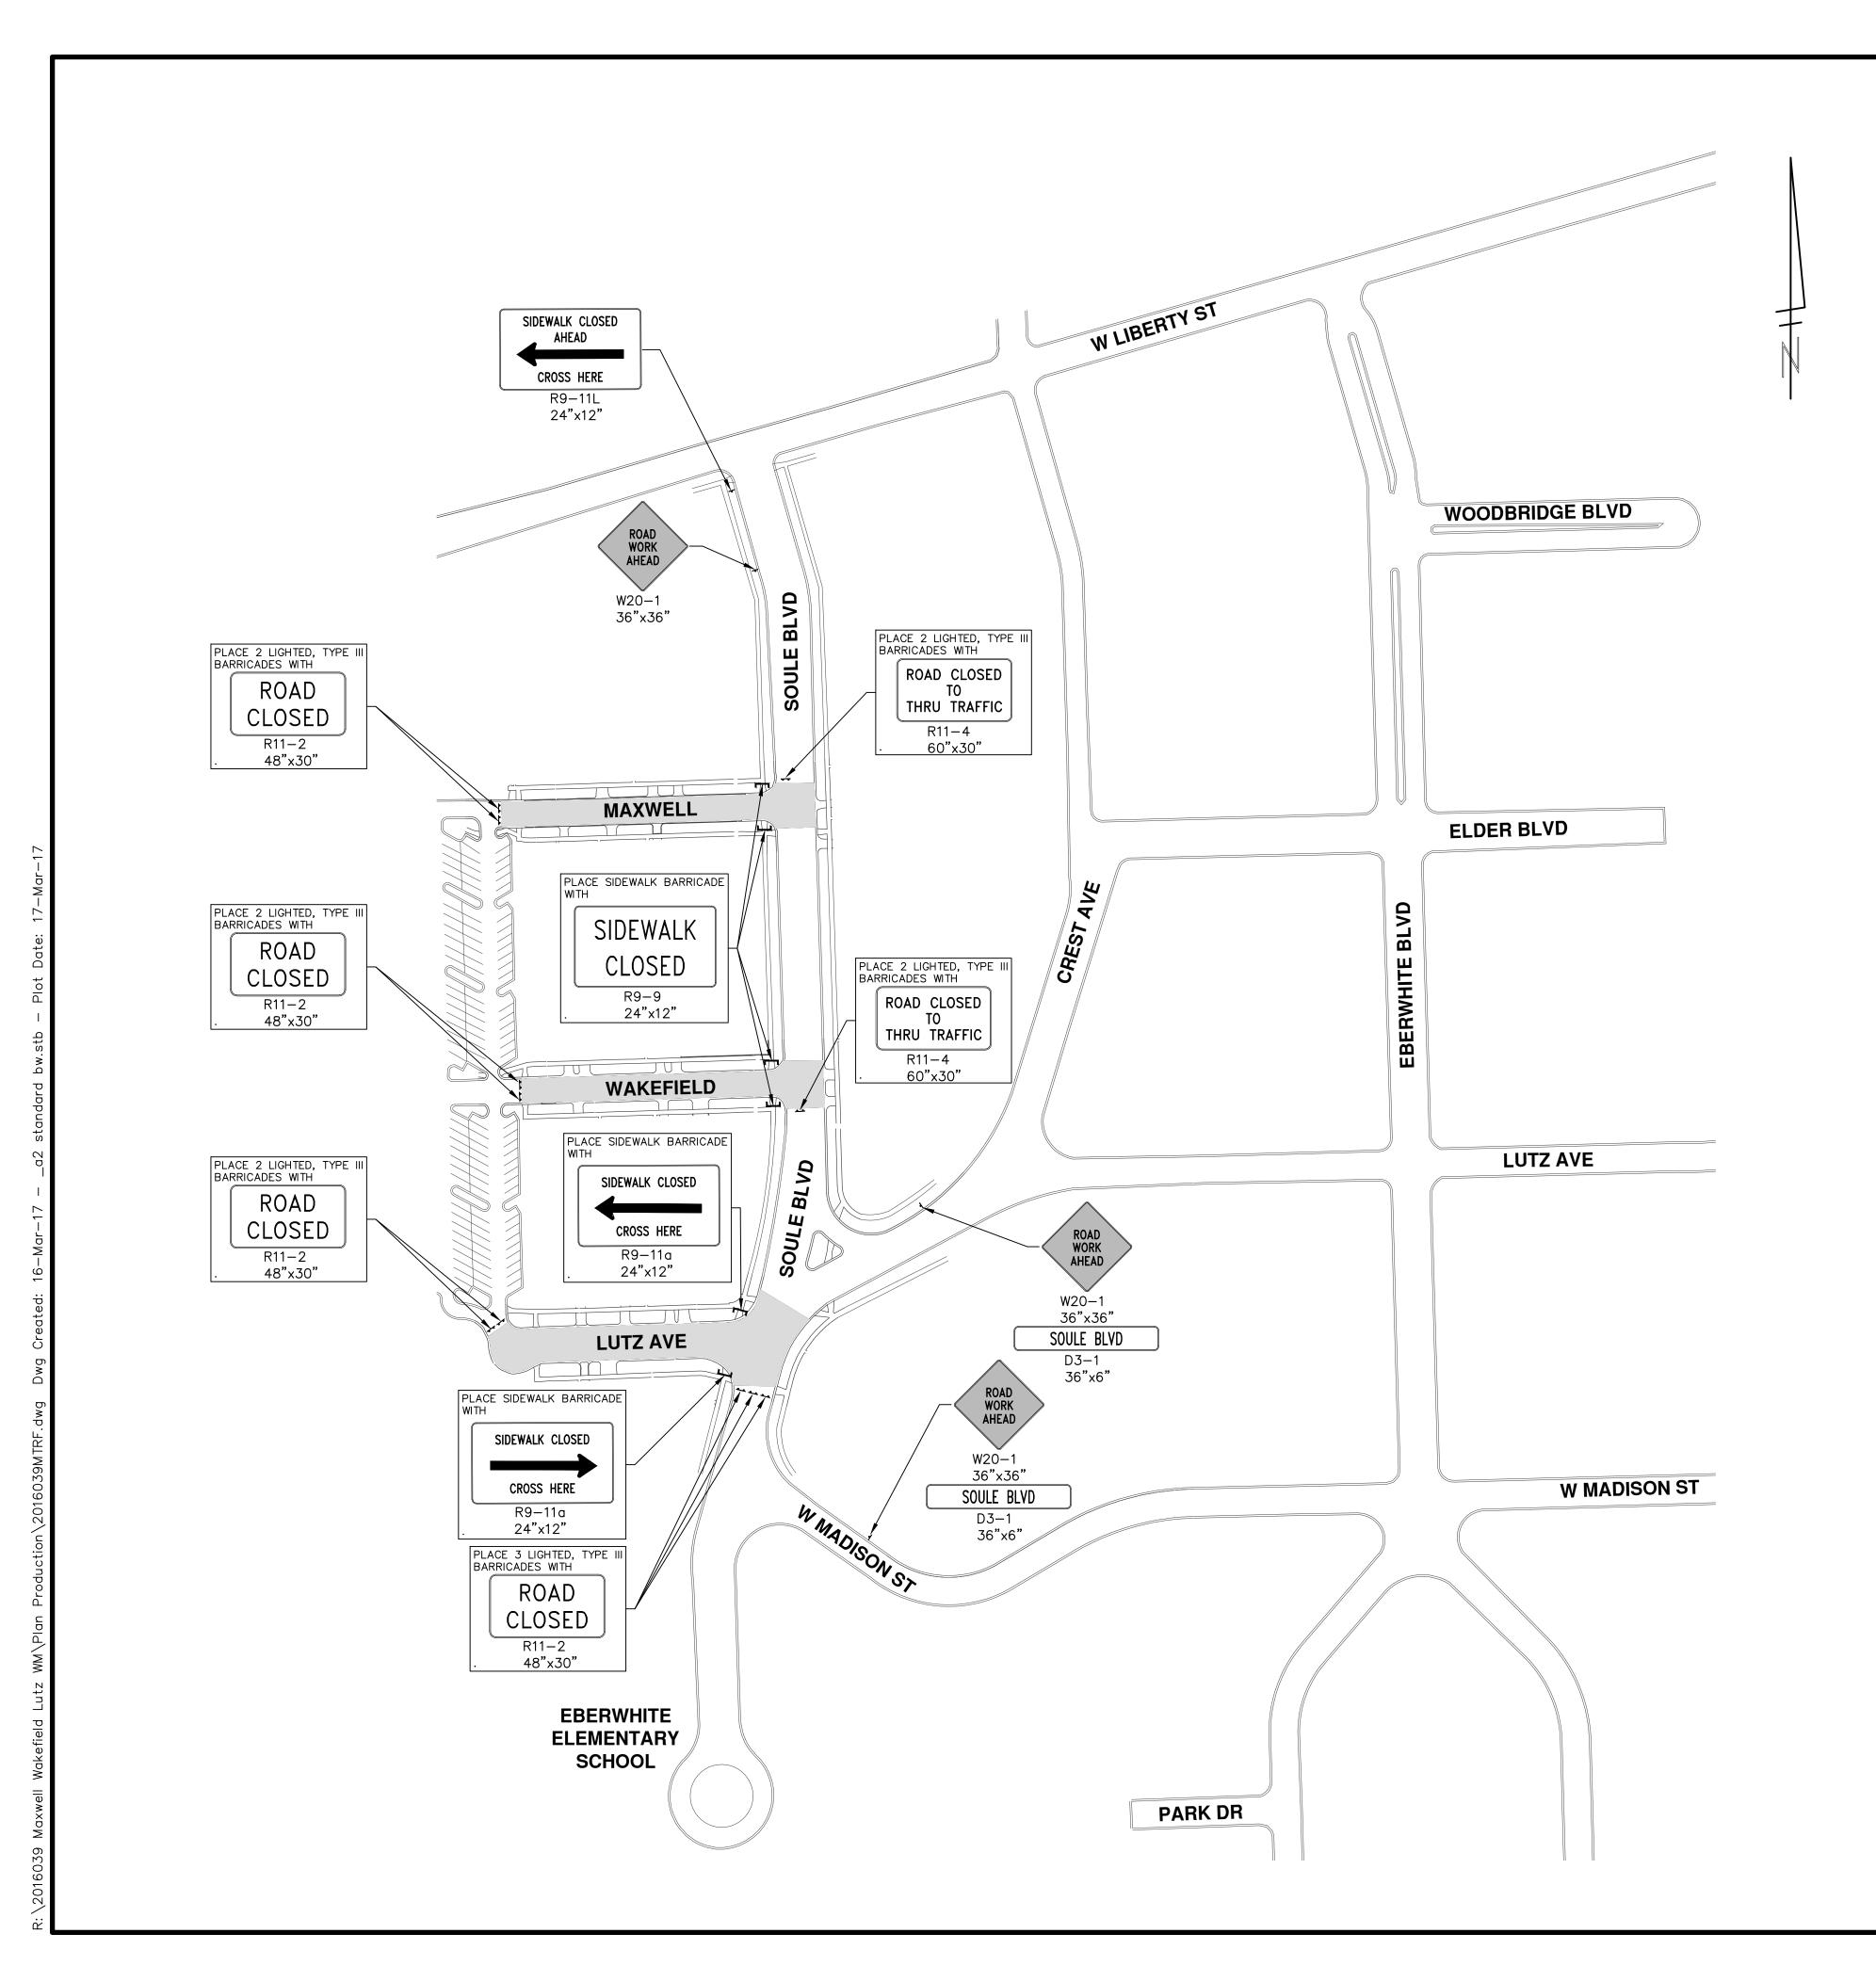

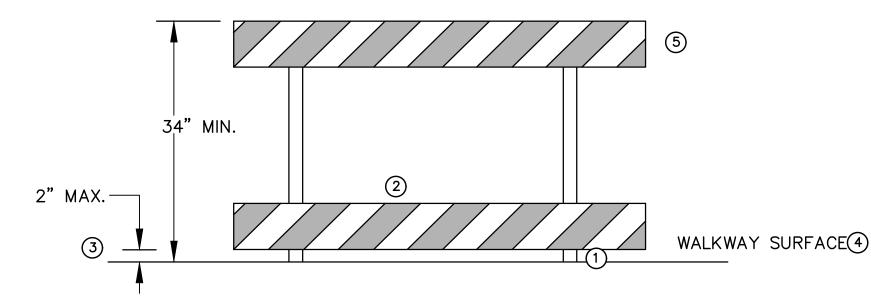

#### SIDEWALK BARRICADE

#### **GENERAL NOTES**

RAILINGS OR OTHER OBJECTS MAY PROTRUDE A MAXIMUM OF 4 INCHES INTO THE WALKWAY CLEAR SPACE WHEN LOCATED A MINIMUM OF 27 INCHES ABOVE THE WALKWAY SURFACE.

ANY PEDESTRIAN DEVICES USED TO PROVIDE POSITIVE PROTECTION FOR PEDESTRIANS OR WORKERS SHALL MEET CRASHWORTHY REQUIREMENTS APPROPRIATE FOR THE BARRIERS APPLICATION.

BARRICADES SHALL BE PLACED ACROSS THE ENTIRE WIDTH OF THE WALKWAY

WHEN CLOSING OR RELOCATING CROSSWALKS OR SIDEWALKS, PROVIDE DETECTABLE TEMPORARY FACILITIES AND INCLUDE ACCESSIBILITY FEATURES CONSISTENT WITH EXISTING PEDESTRIAN FACILITIES.

TEMPORARY TRAFFIC CONTROL DEVICES FOR PEDESTRIANS ARE SHOWN. OTHER DEVICES MAY BE NECESSARY TO CONTROL VEHICULAR TRAFFIC. STAGE WORK, AS NECESSARY, TO PROVIDE AN ALTERNATE PEDESTRIAN ROUTE (APR) AT ALL TIMES. FOR ROADWAYS WITH NO AVAILABLE DETOURS, MAINTAIN ONE OPEN SIDEWALK AT ALL TIMES.

PROVIDE A SMOOTH, CONTINUOUS, HARD SURFACE THROUGH THE LENGTH OF THE APR. PROVIDE A FIRM, STABLE, AND SLIP RESISTANT TEMPORARY WALKWAY SURFACE TO COVER SHORT SEGMENTS OF ROUGH, SOFT, OR UNEVEN GROUND.

THE PEDESTRIAN TRAFFIC SIGNALS CONTROLLING CLOSED CROSSWALKS SHALL BE COVERED OR DEACTIVATED.

POST MOUNTED SIGNS LOCATED ADJACENT TO A SIDEWALK SHALL HAVE A 7 FOOT MINIMUM CLEARANCE FROM THE BOTTOM OF THE SIGN TO THE SIDEWALK SURFACE. WHEN A SIGN OR BARRICADE IS ORIENTED SUCH THAT VISIBILITY TO TRAFFIC (BIKES, PEDESTRIANS) IS REDUCED ENOUGH TO CAUSE HAZARD, DELINEATE THE SIGN/BARRICADE WITH APPROPRIATE DEVICES.

MINIMIZE DISRUPTION TO PEDESTRIANS TO THE MAXIMUM EXTENT FEASIBLE BY PROVIDING AN APR IN THE FOLLOWING ORDER OF PREFERENCE:

- 1. PROVIDE THE APR ON THE SAME SIDE OF THE STREET AS THE DISRUPTED ROUTE UTILIZING BYPASSES.
- 2. WHERE IT IS NOT FEASIBLE TO PROVIDE A SAME SIDE APR, PROVIDE A DETOUR ON THE OTHER SIDE OF THE STREET.
- 3. WHERE IT IS NOT FEASIBLE TO PROVIDE AN APR ON THE OTHER SIDE OF THE ROADWAY, PROVIDE AN APR DETOUR WITH TRAILBLAZING SIGNS.

#### SPECIFIC NOTES

- 2 ANY TRIPPING HAZARD IN THE WALKWAY NEEDS A DETECTABLE EDGE. BALLAST SHALL BE LOCATED BEHIND OR INTERNAL TO THE DEVICE. ANY SUPPORT ON THE FRONT OF THE DEVICE SHALL NOT EXTEND INTO THE 48 INCH MINIMUM WALKWAY (3) CLEAR SPACE AND SHALL NOT EXCEED 0.5 INCHES IN HEIGHT ABOVE THE WALKWAY SURFACE.
- DETECTABLE EDGES SHALL BE CONTINUOUS AND 6 INCHES MIN. HIGH ABOVE (4) WALKWAY SURFACE AND HAVE COLOR MARKINGS CONTRASTING WITH THE WALKWAY

DEVICES SHALL NOT BLOCK WATER DRAINAGE FROM THE WALKWAY. A GAP HEIGHT OR OPENING FROM THE WALKWAY SURFACE UP TO A MAXIMUM OF 2 INCHES IS ALLOWED FOR DRAINAGE PURPOSES.

A WALKWAY SURFACE SHALL BE FIRM, STABLE, AND SLIP RESISTANT. LONGITUDINAL CHANNELIZING DEVICES FOR PEDESTRIANS SHALL BE 32 INCHES HIGH OR GREATER.


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	AMW	AMW	DRAWN CHECKED	
	JKA	JKA	DRAWN	
	3/17/17	12/12/16	DATE	
	01 BID SET	OO INTERNAL CITY REVIEW	DESCRIPTION	
	01	00	REV.	




MAXWELL, WAKEFIELD, LUTZ
WATER MAIN REPLACEMENT
TRAFFIC CONTROL

MANAGEMENT

SHEET No.

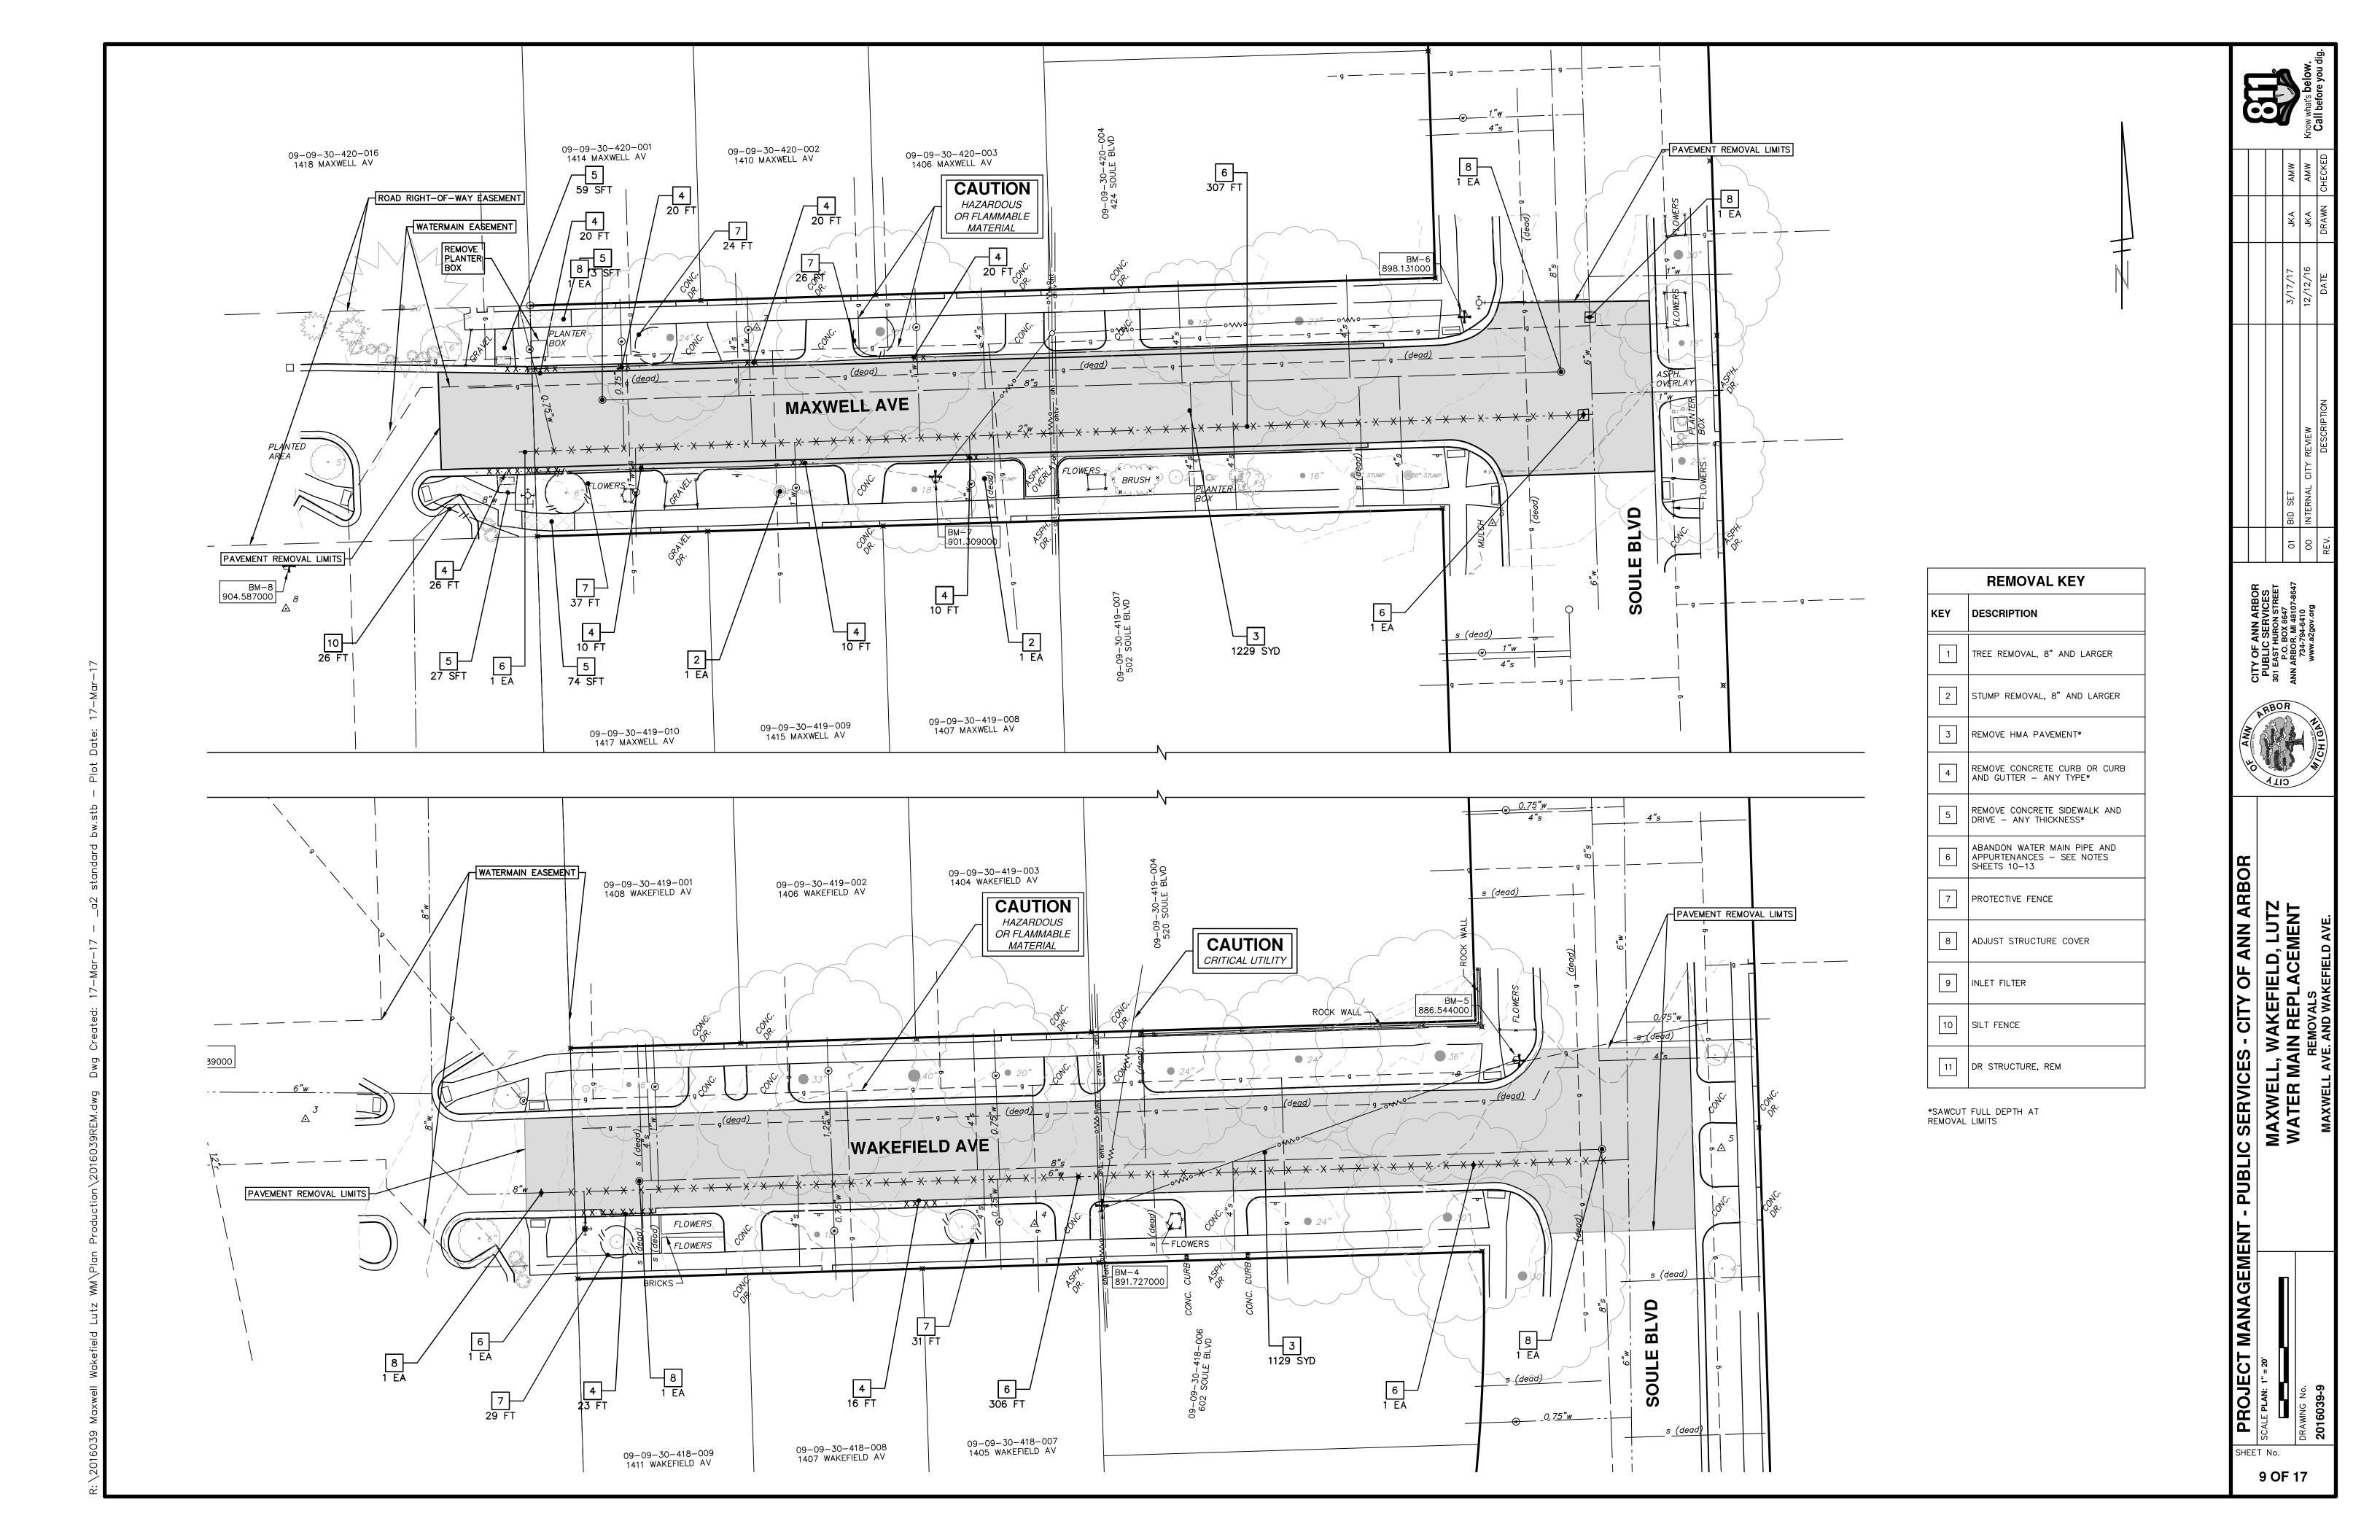

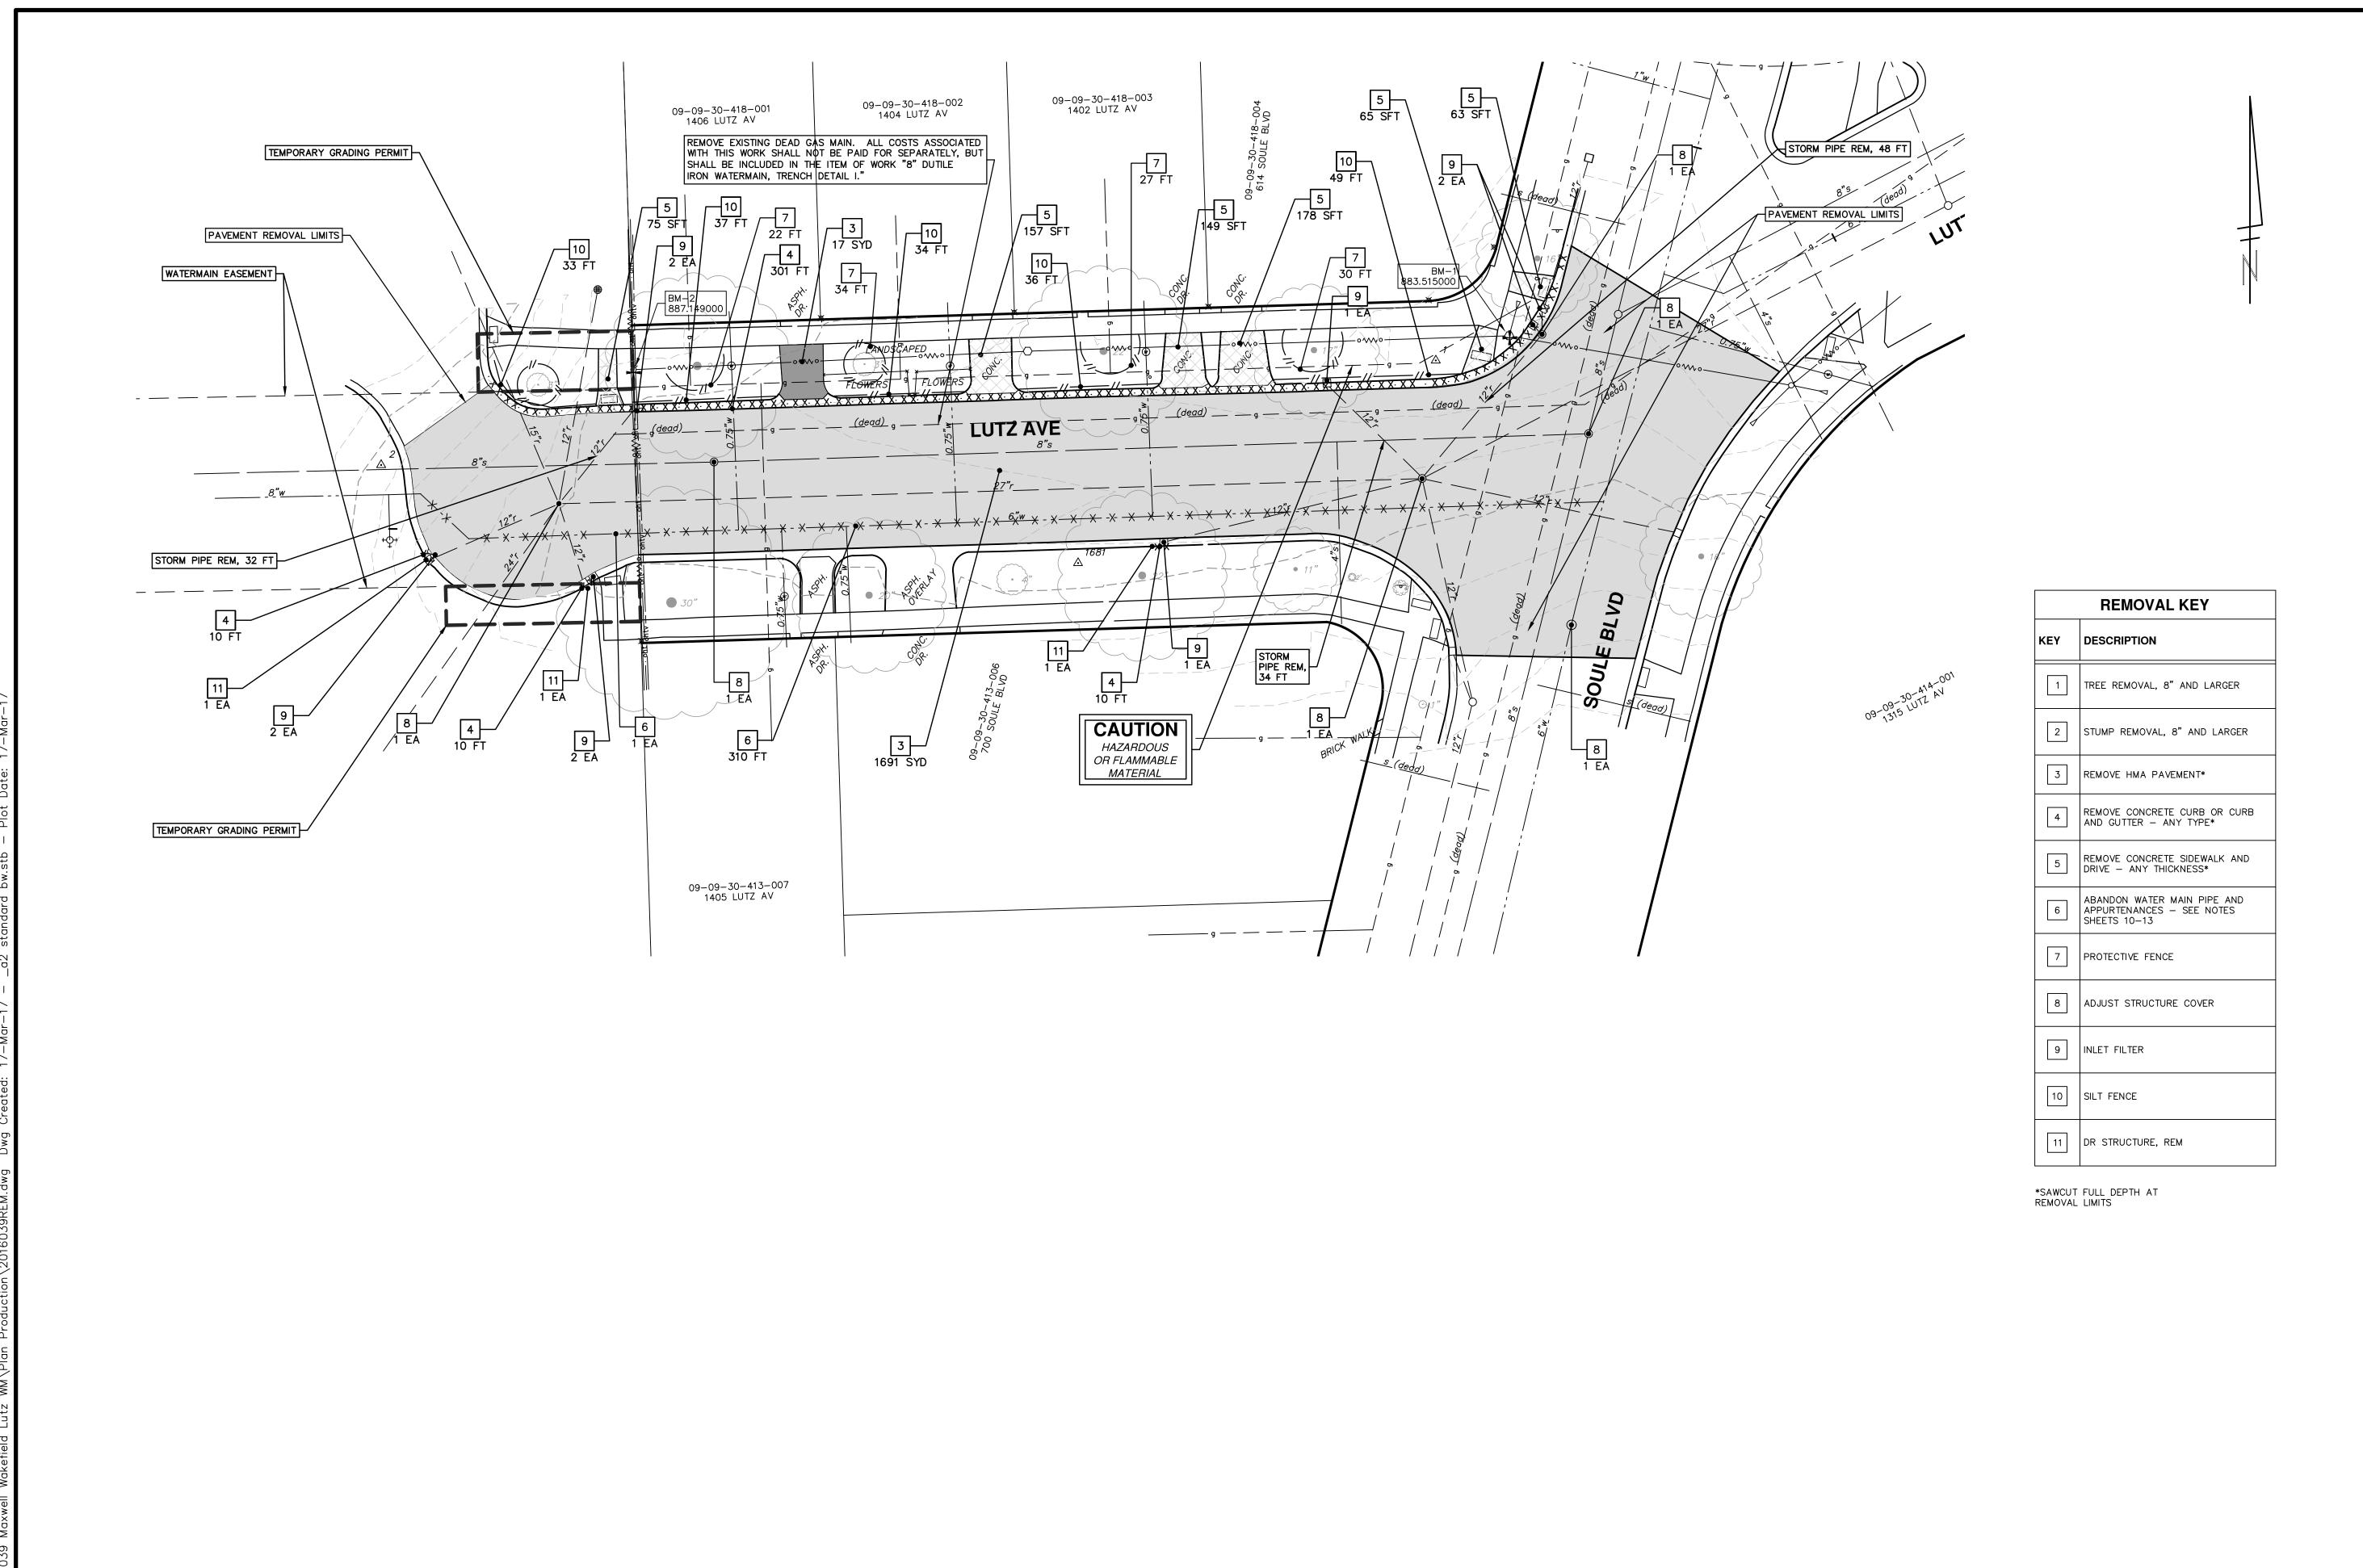

PROJECT MANAGEMENT - PUBLIC SERVICES - CITY OF ANN ARBOR

SCALE PLAN: 1" = 20'


MAXWELL, WAKEFIELD, LUTZ


WATER MAIN REPLACEMENT


REMOVALS


LUTZ AVE


LUTZ AVE

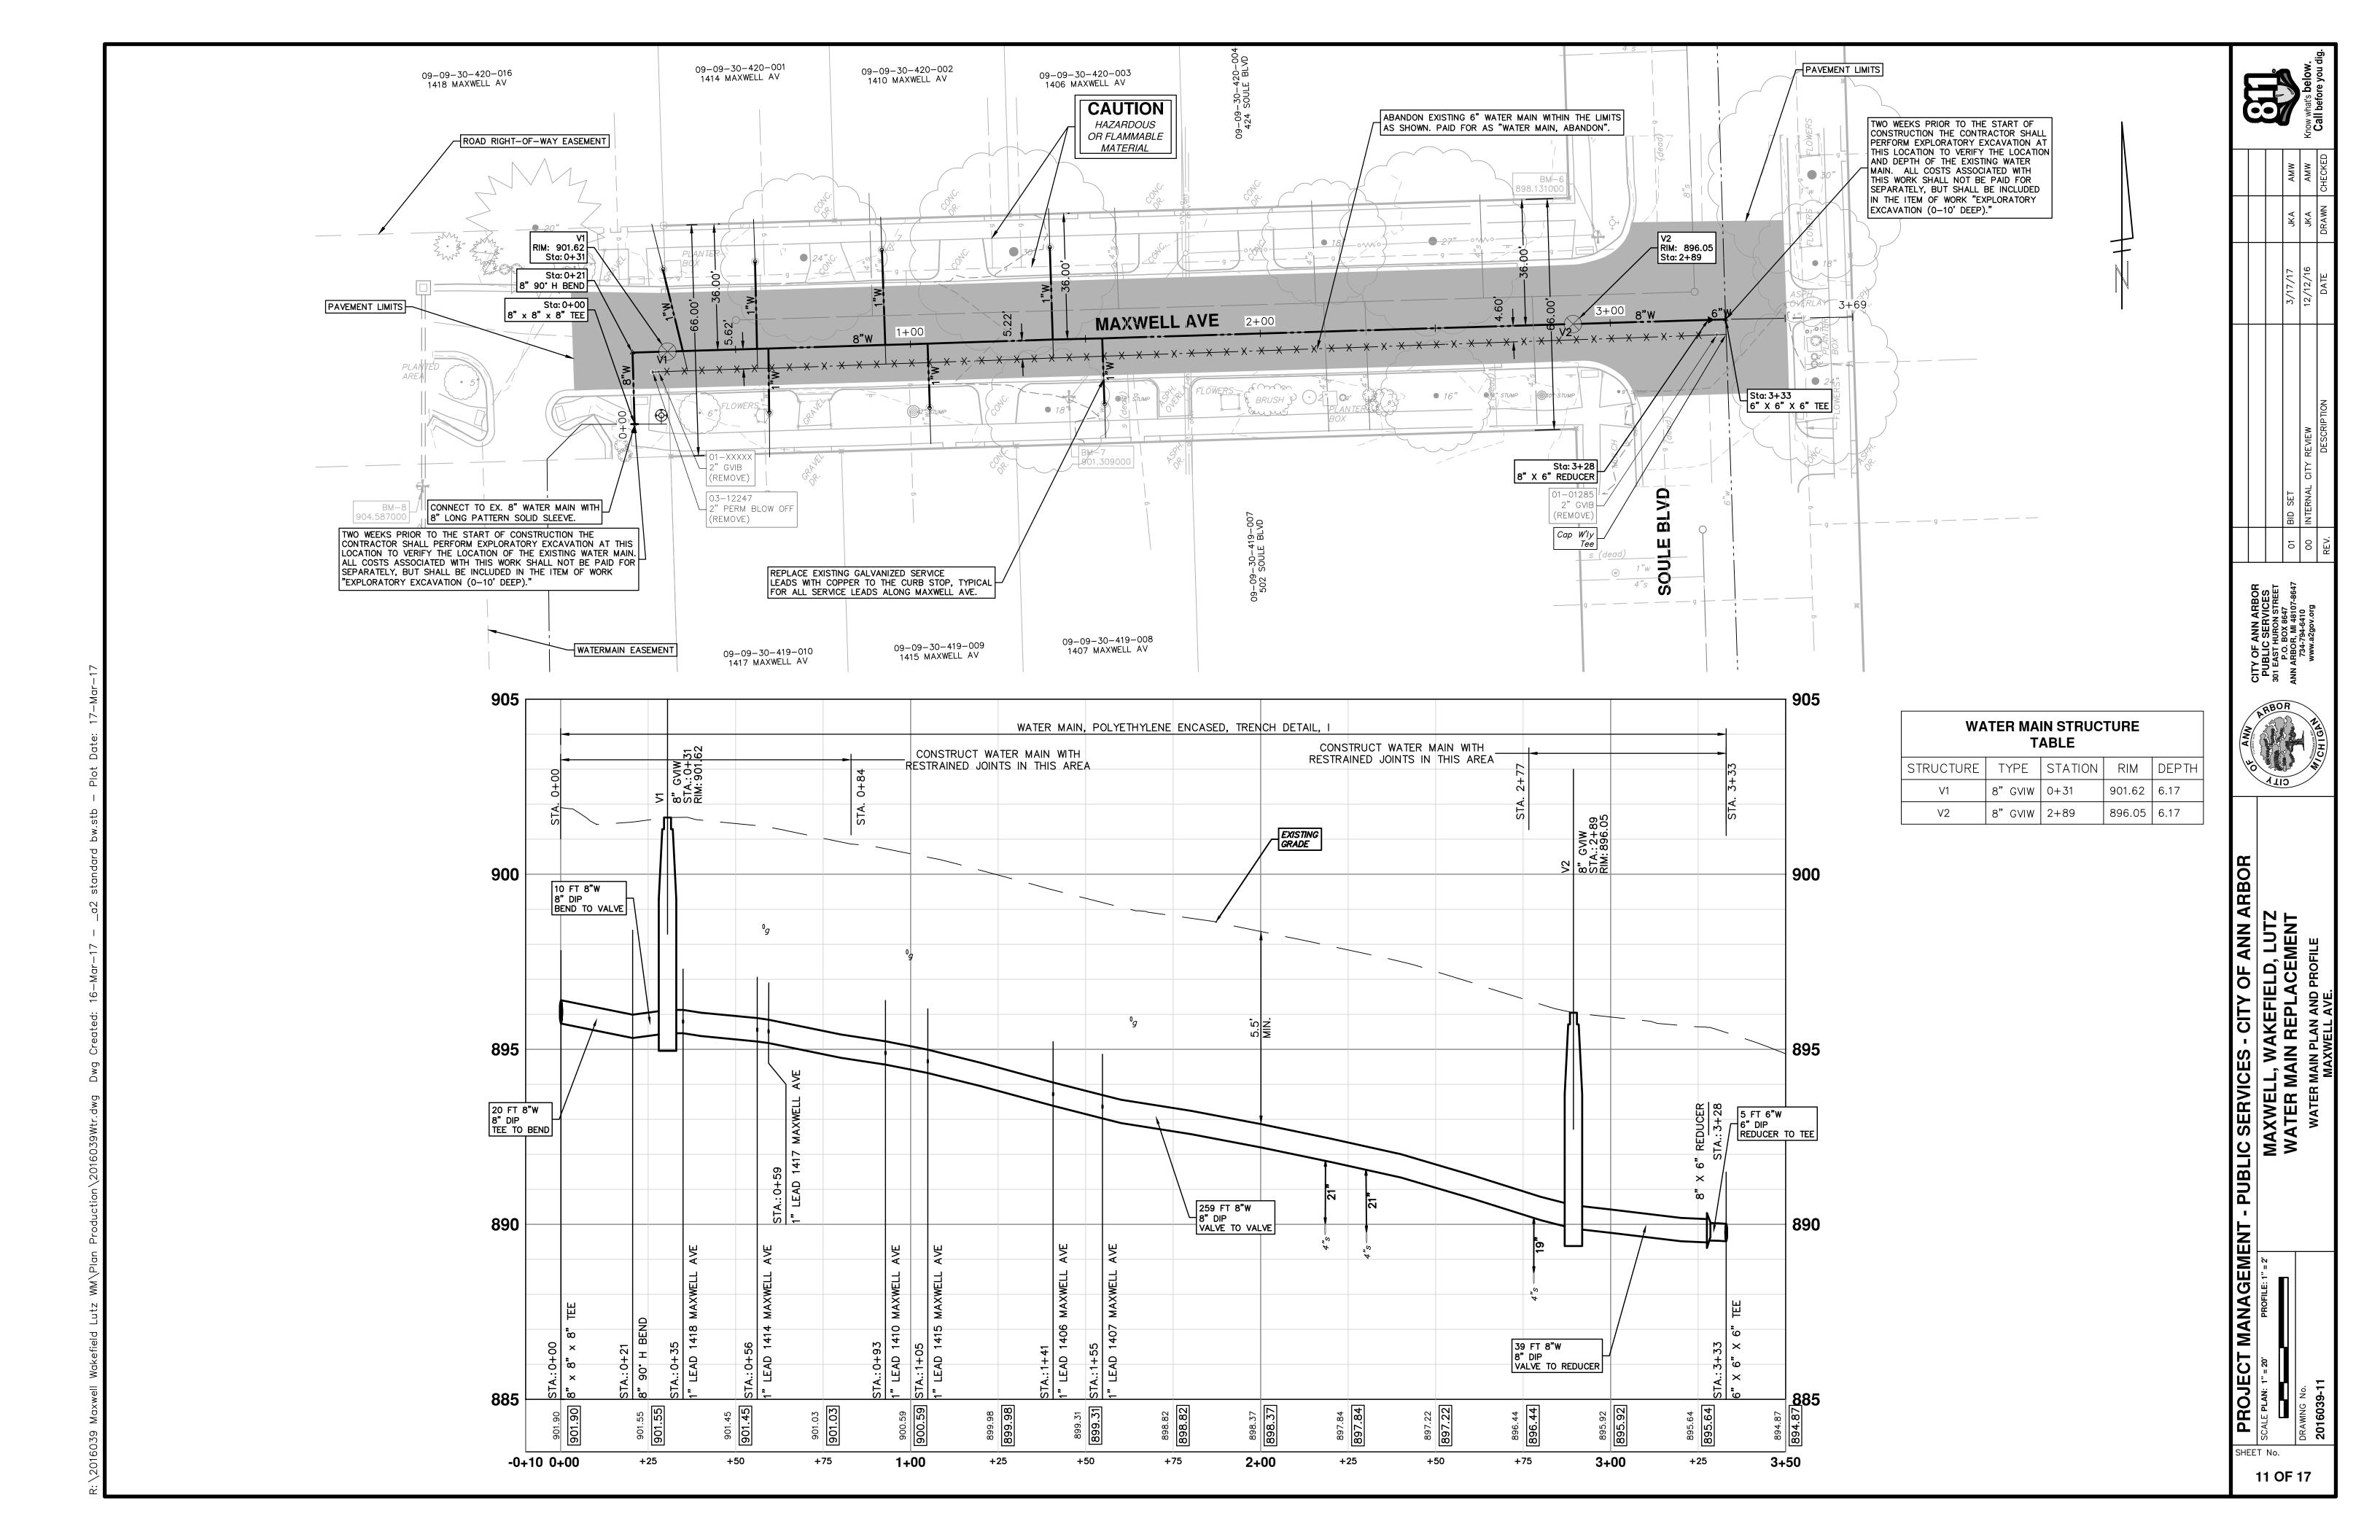

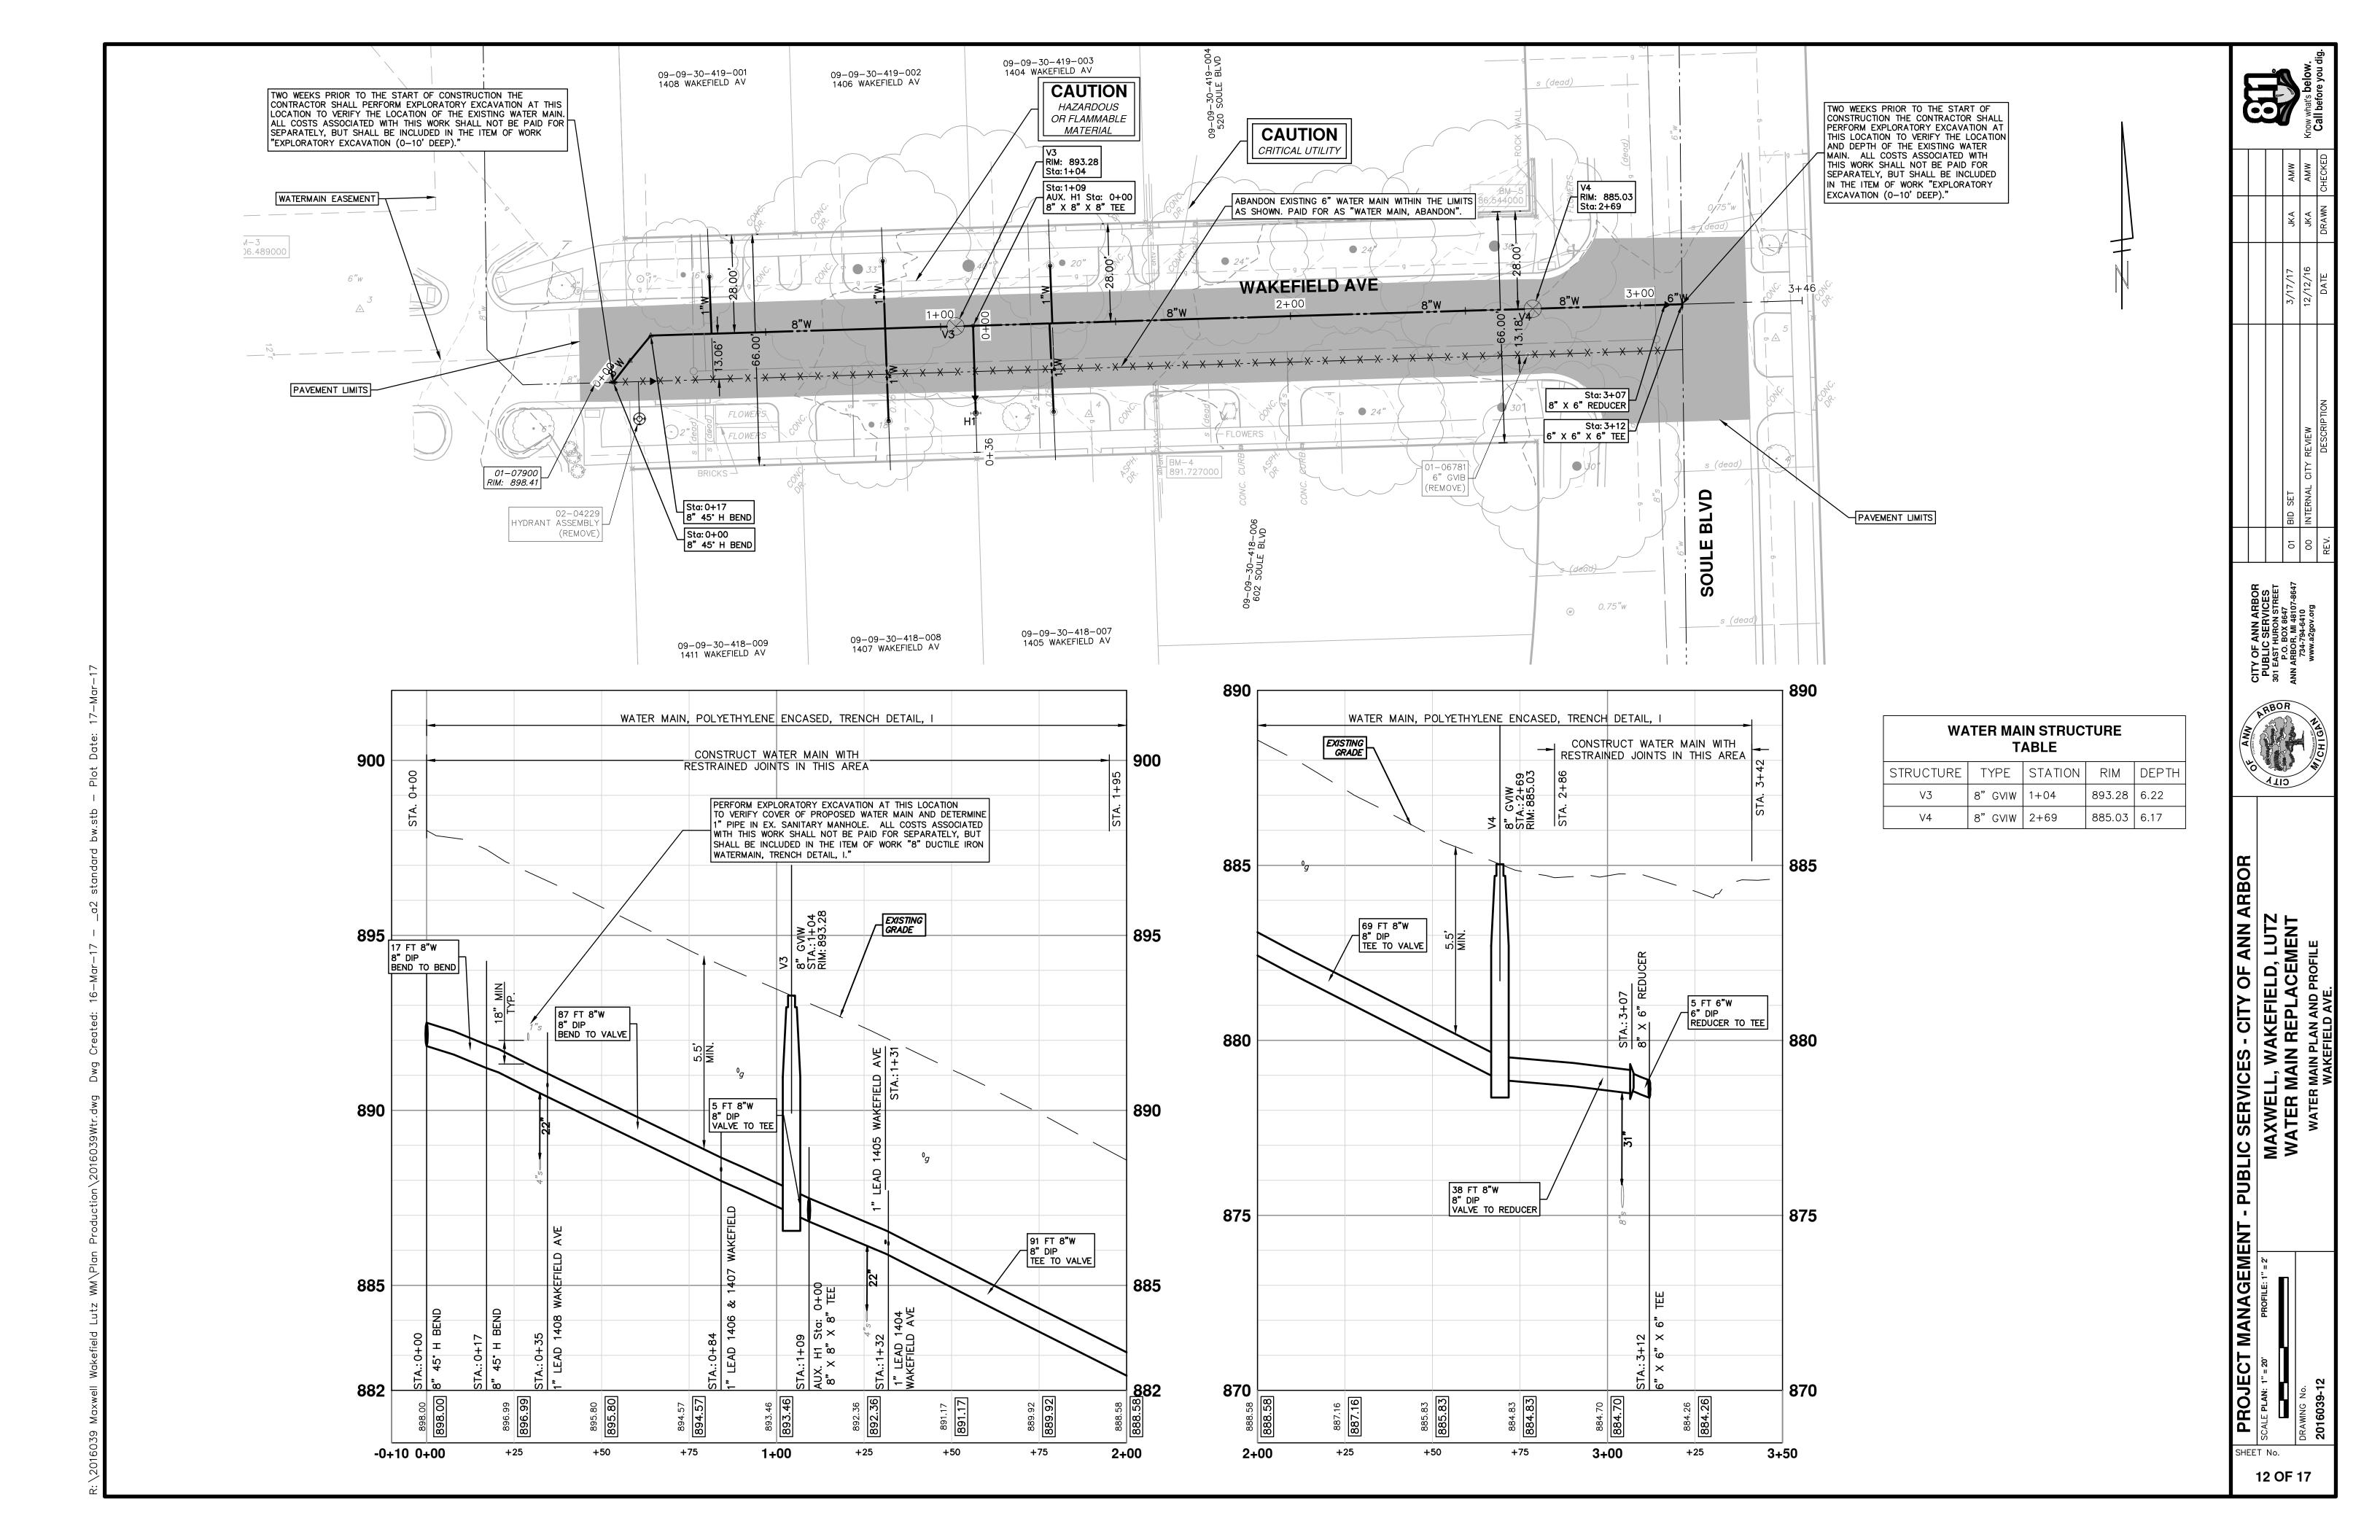

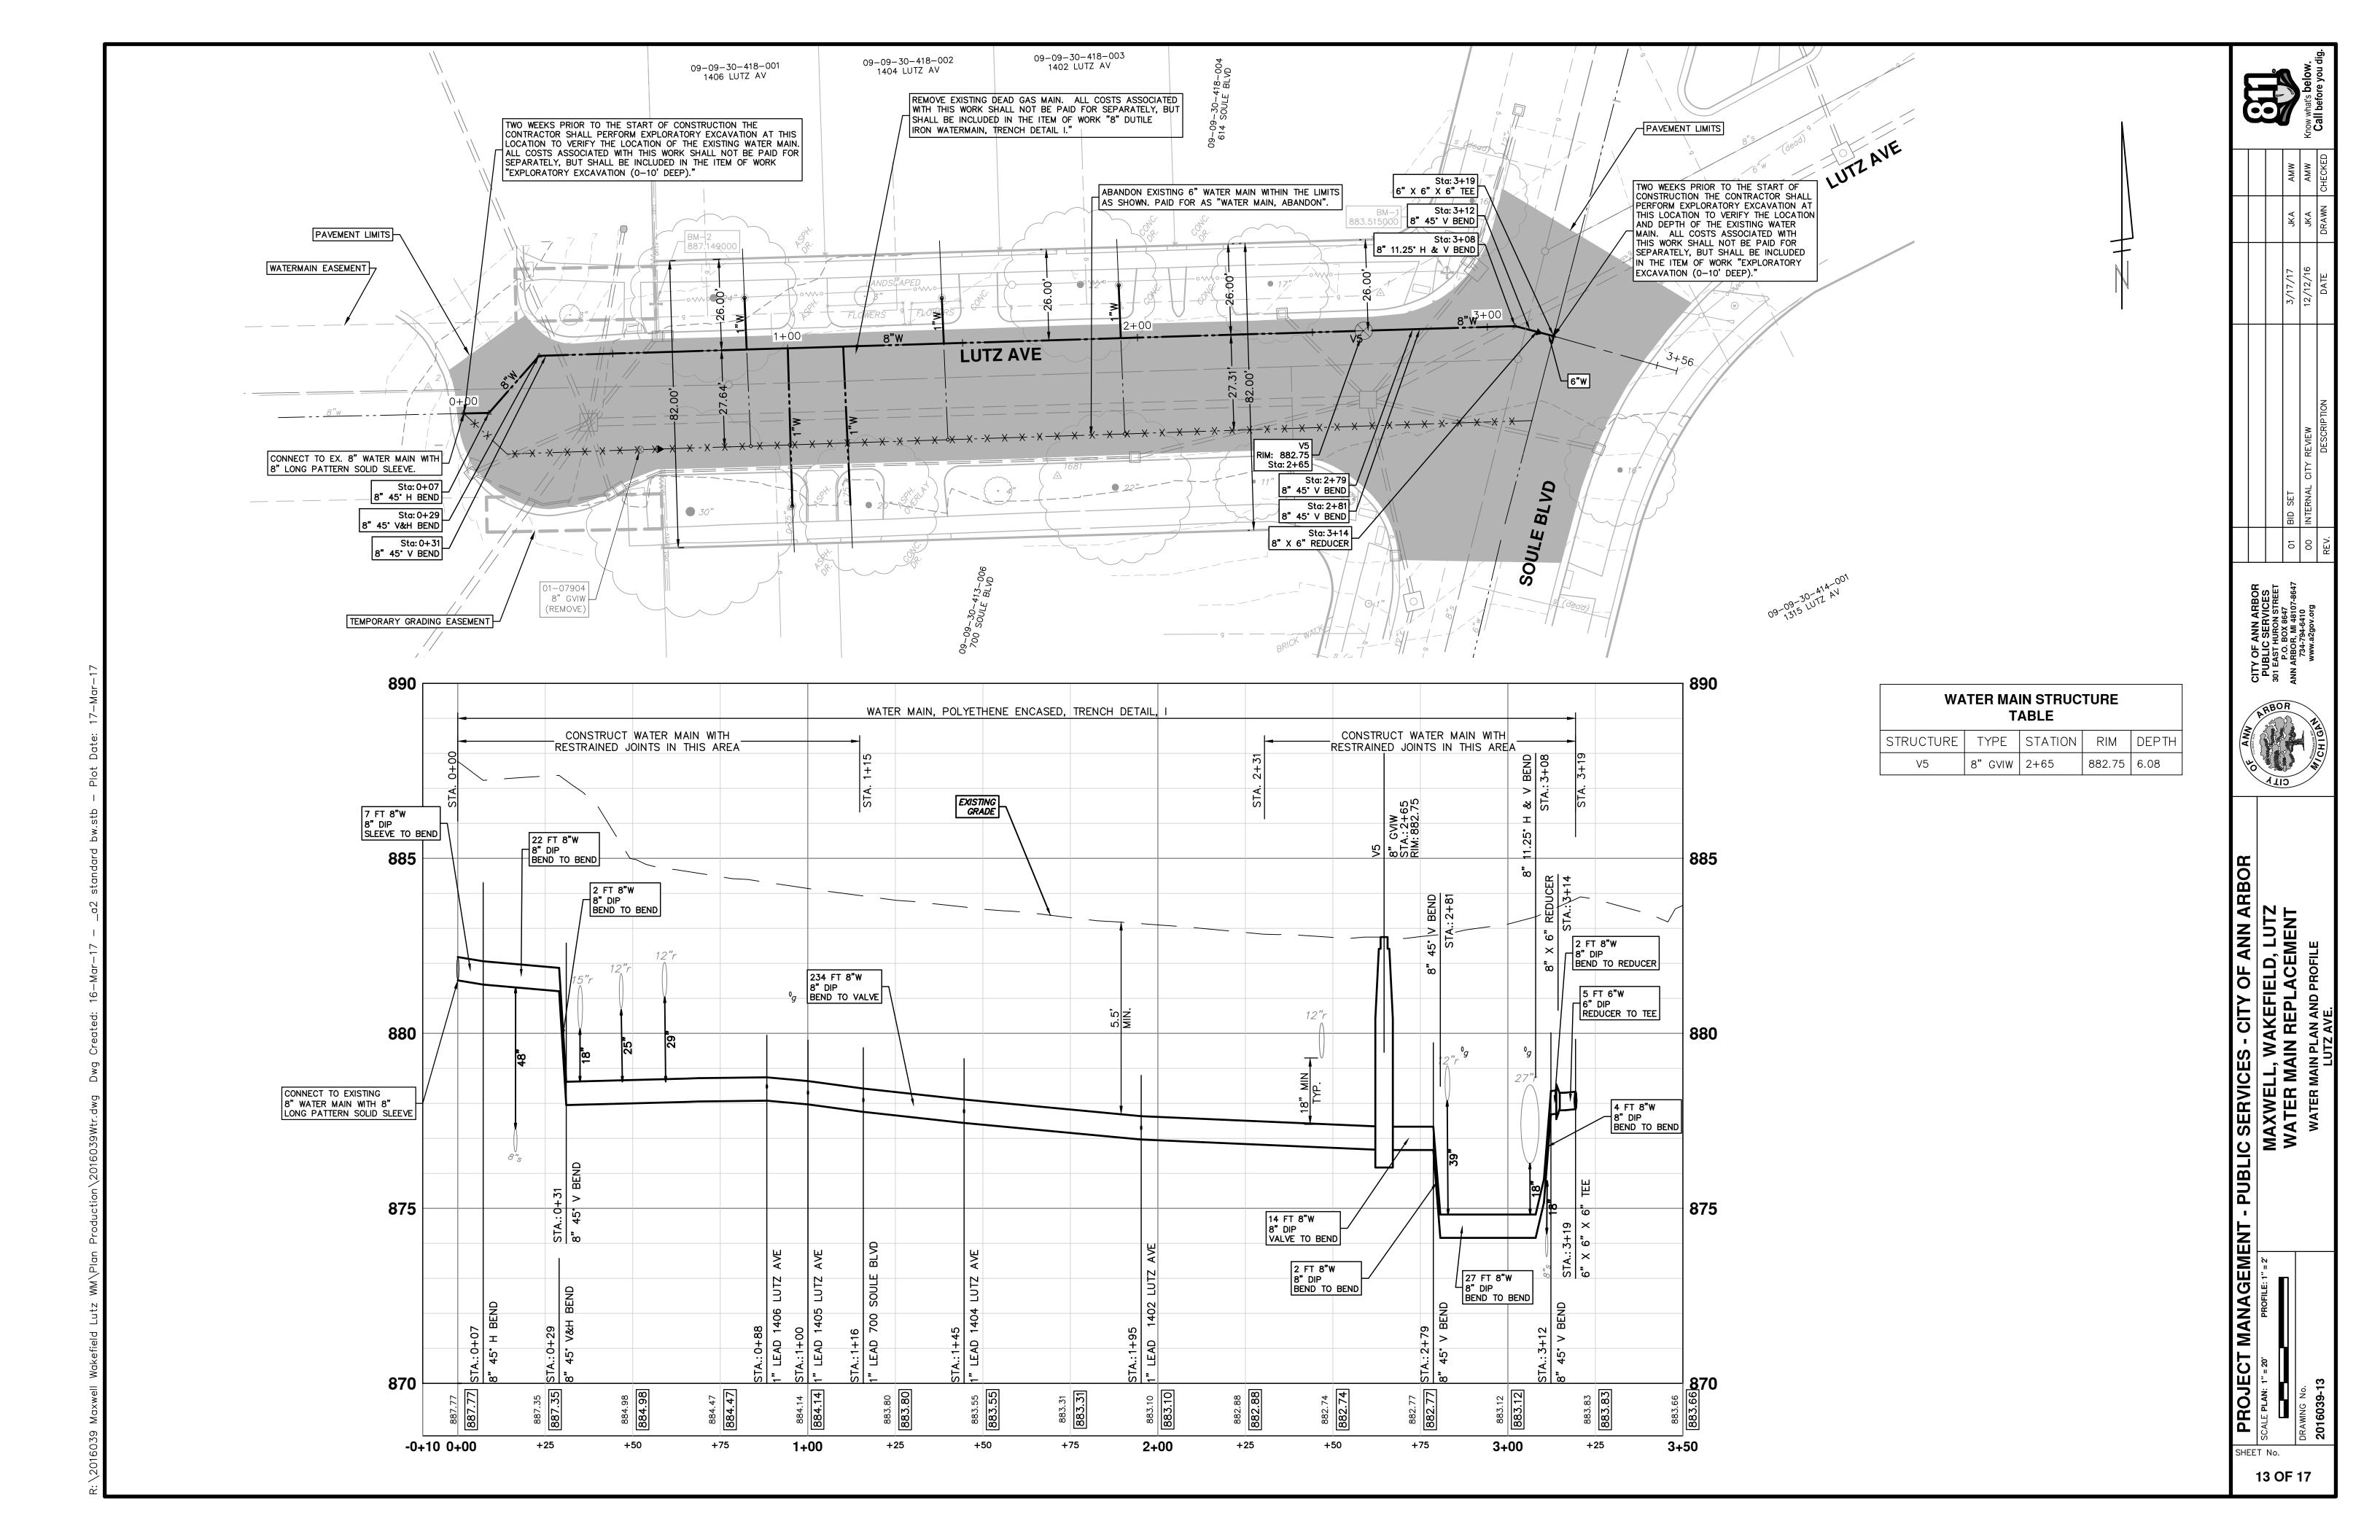

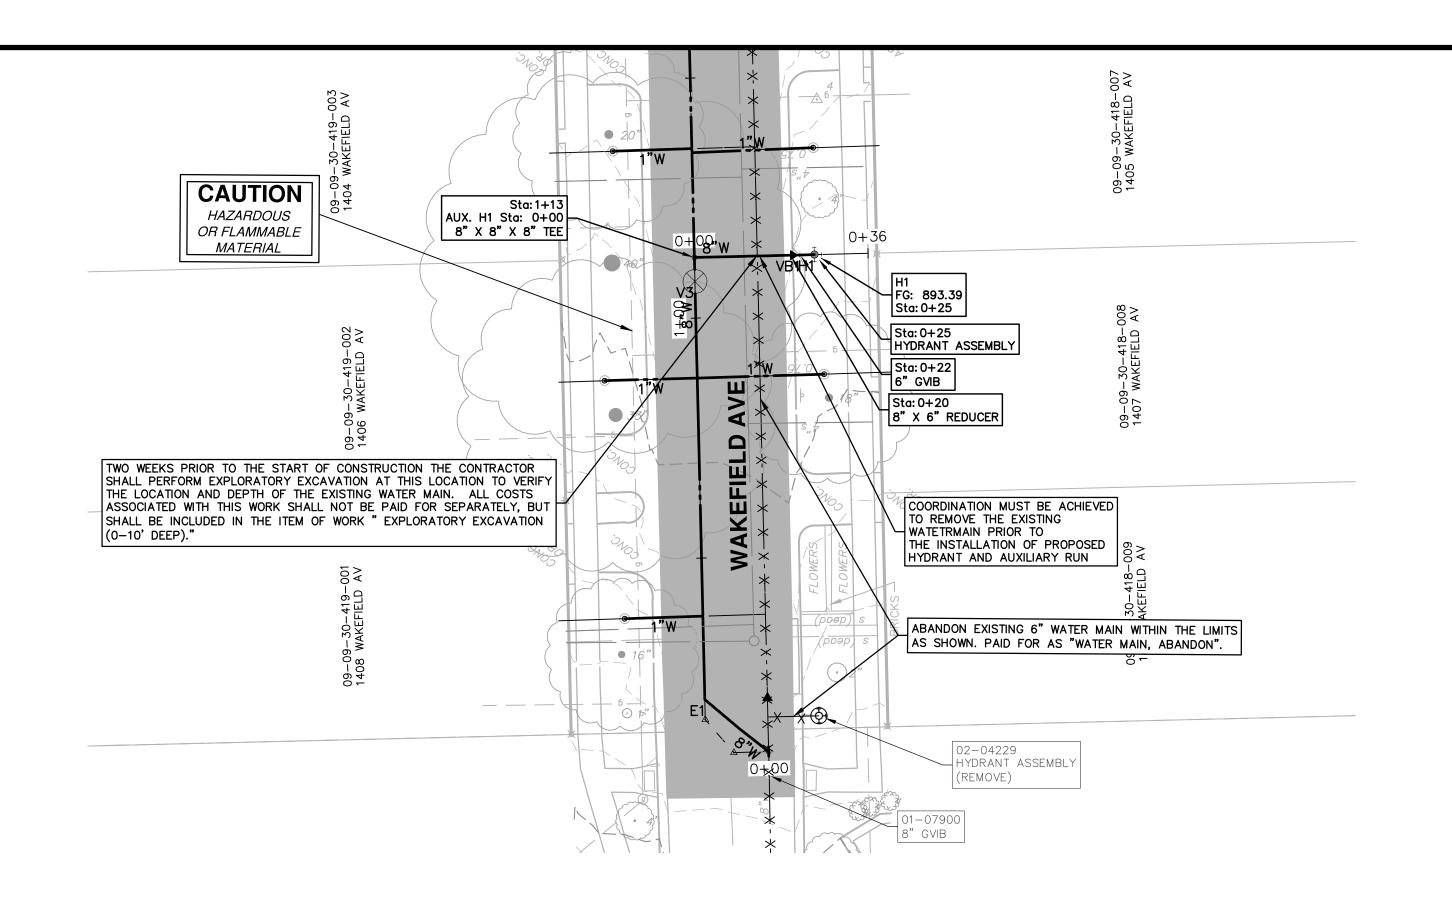


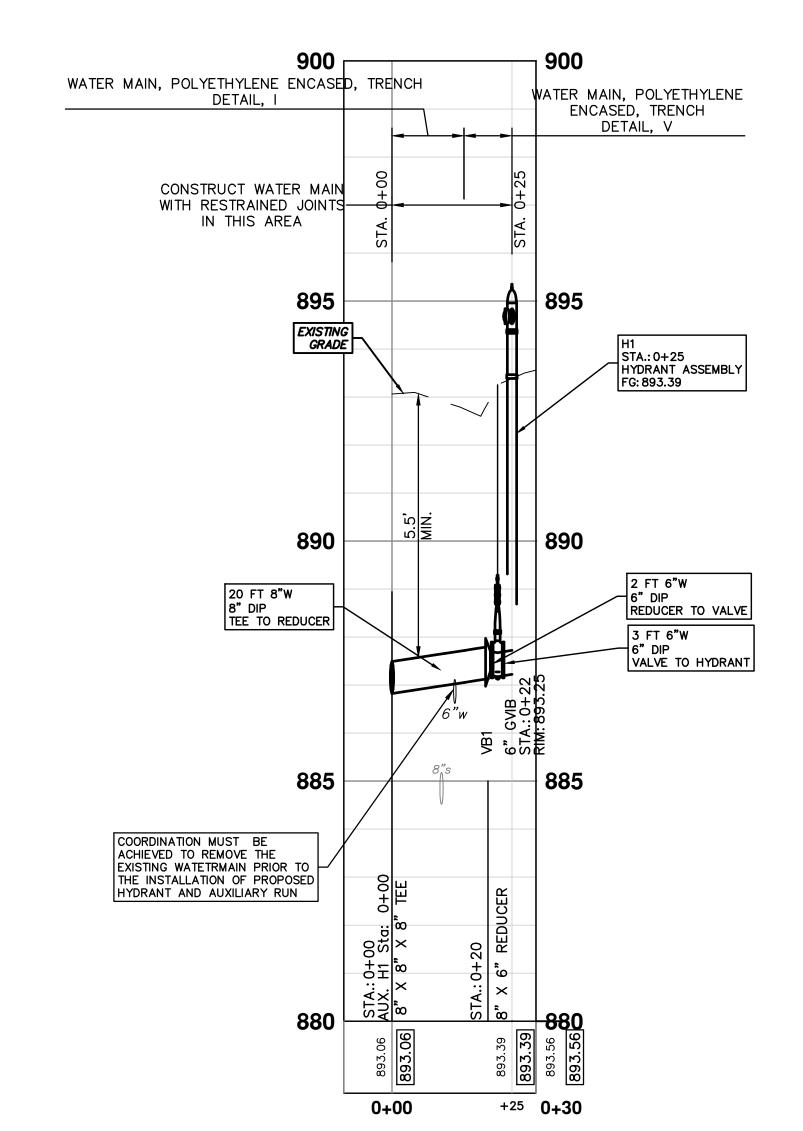

w	ATER MAIN STRUC	CTURE TA	BLE	
STRUCTURE	TYPE	STATION	FG	DEPTH
H1	HYDRANT ASSEMBLY	0+25	893.39	6.16

WA	IN STRUC ABLE	TURE		
STRUCTURE	TYPE	STATION	RIM	DEPTH
VB1	6" GVIB	0+22	893.25	6.08

CHECK	DRAWN CHECK	DATE	DESCRIPTION	REV.
AMW	JKA	12/12/16	00 INTERNAL CITY REVIEW	00
AMW	JKA	3/17/17	01 BID SET	10

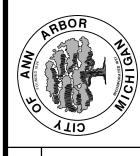


PROJECT MANAGEMENT - PUBLIC SERVICES - CITY OF ANN ARBC


SCALE PLAN: 1" = 20' PROFILE: 1" = 2'

DRAWING No.

WATER MAIN REPLACEMENT

WATER MAIN PLAN AND PROFILE
HYDRANT ASSEMBLY H1

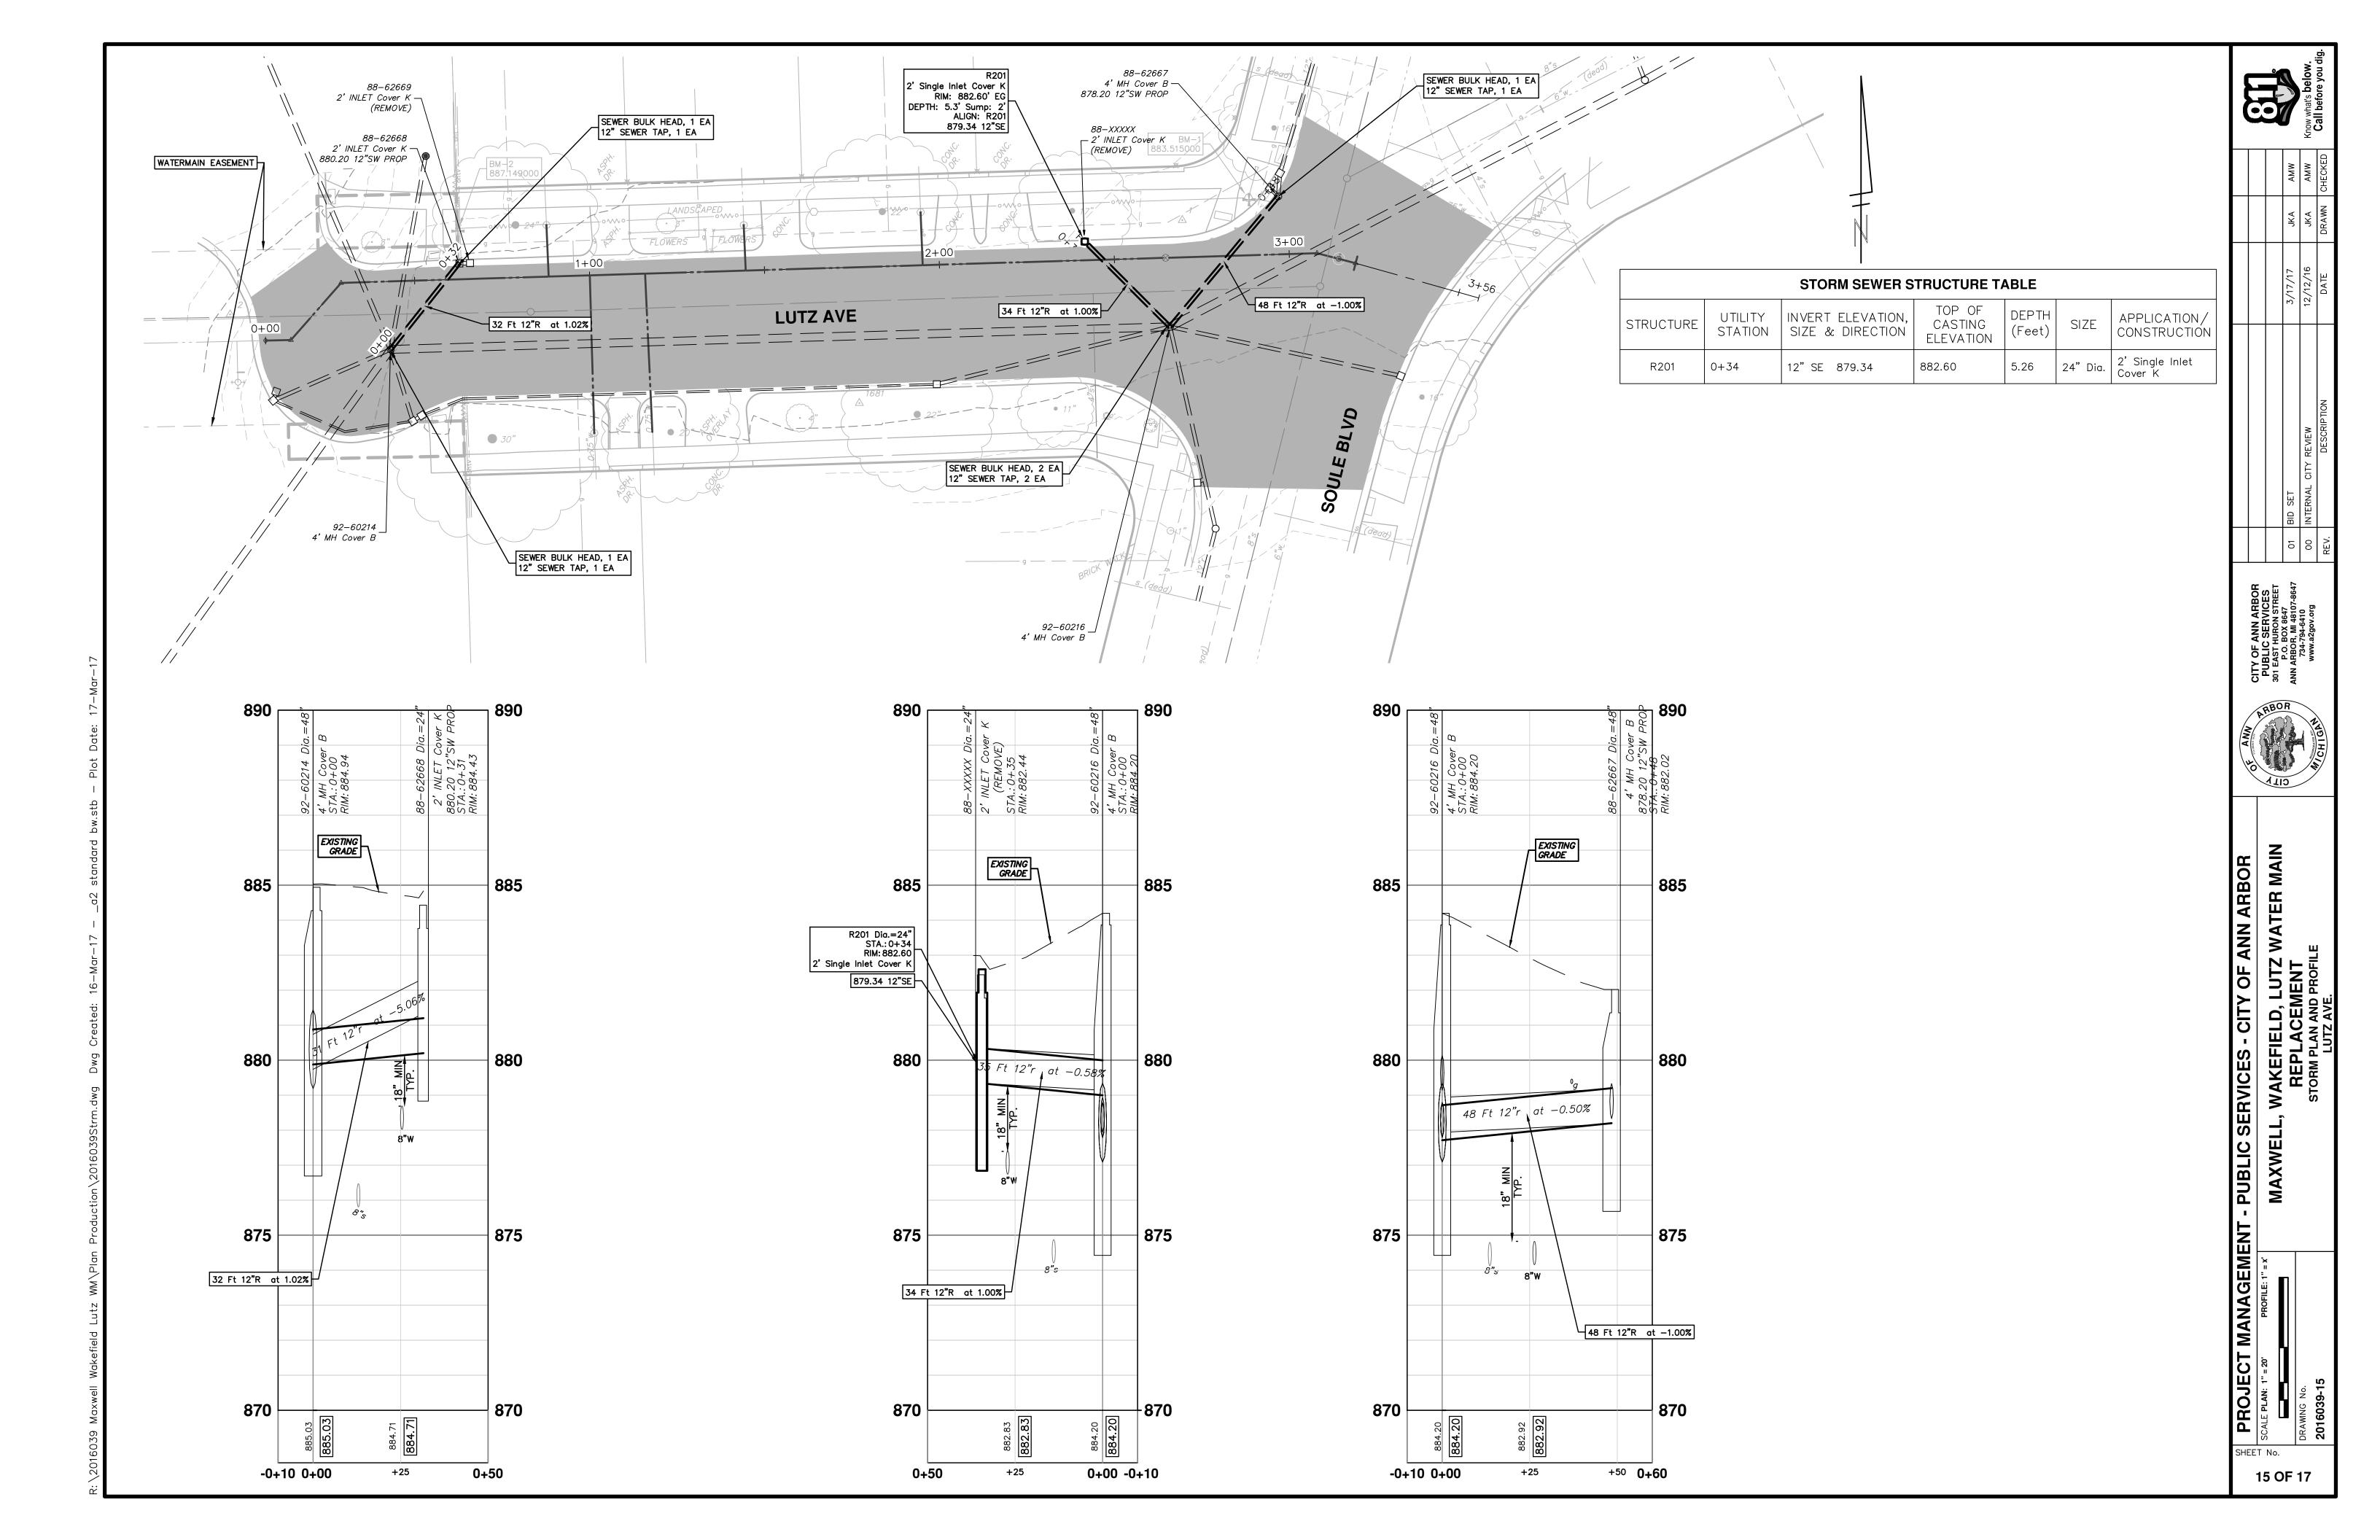

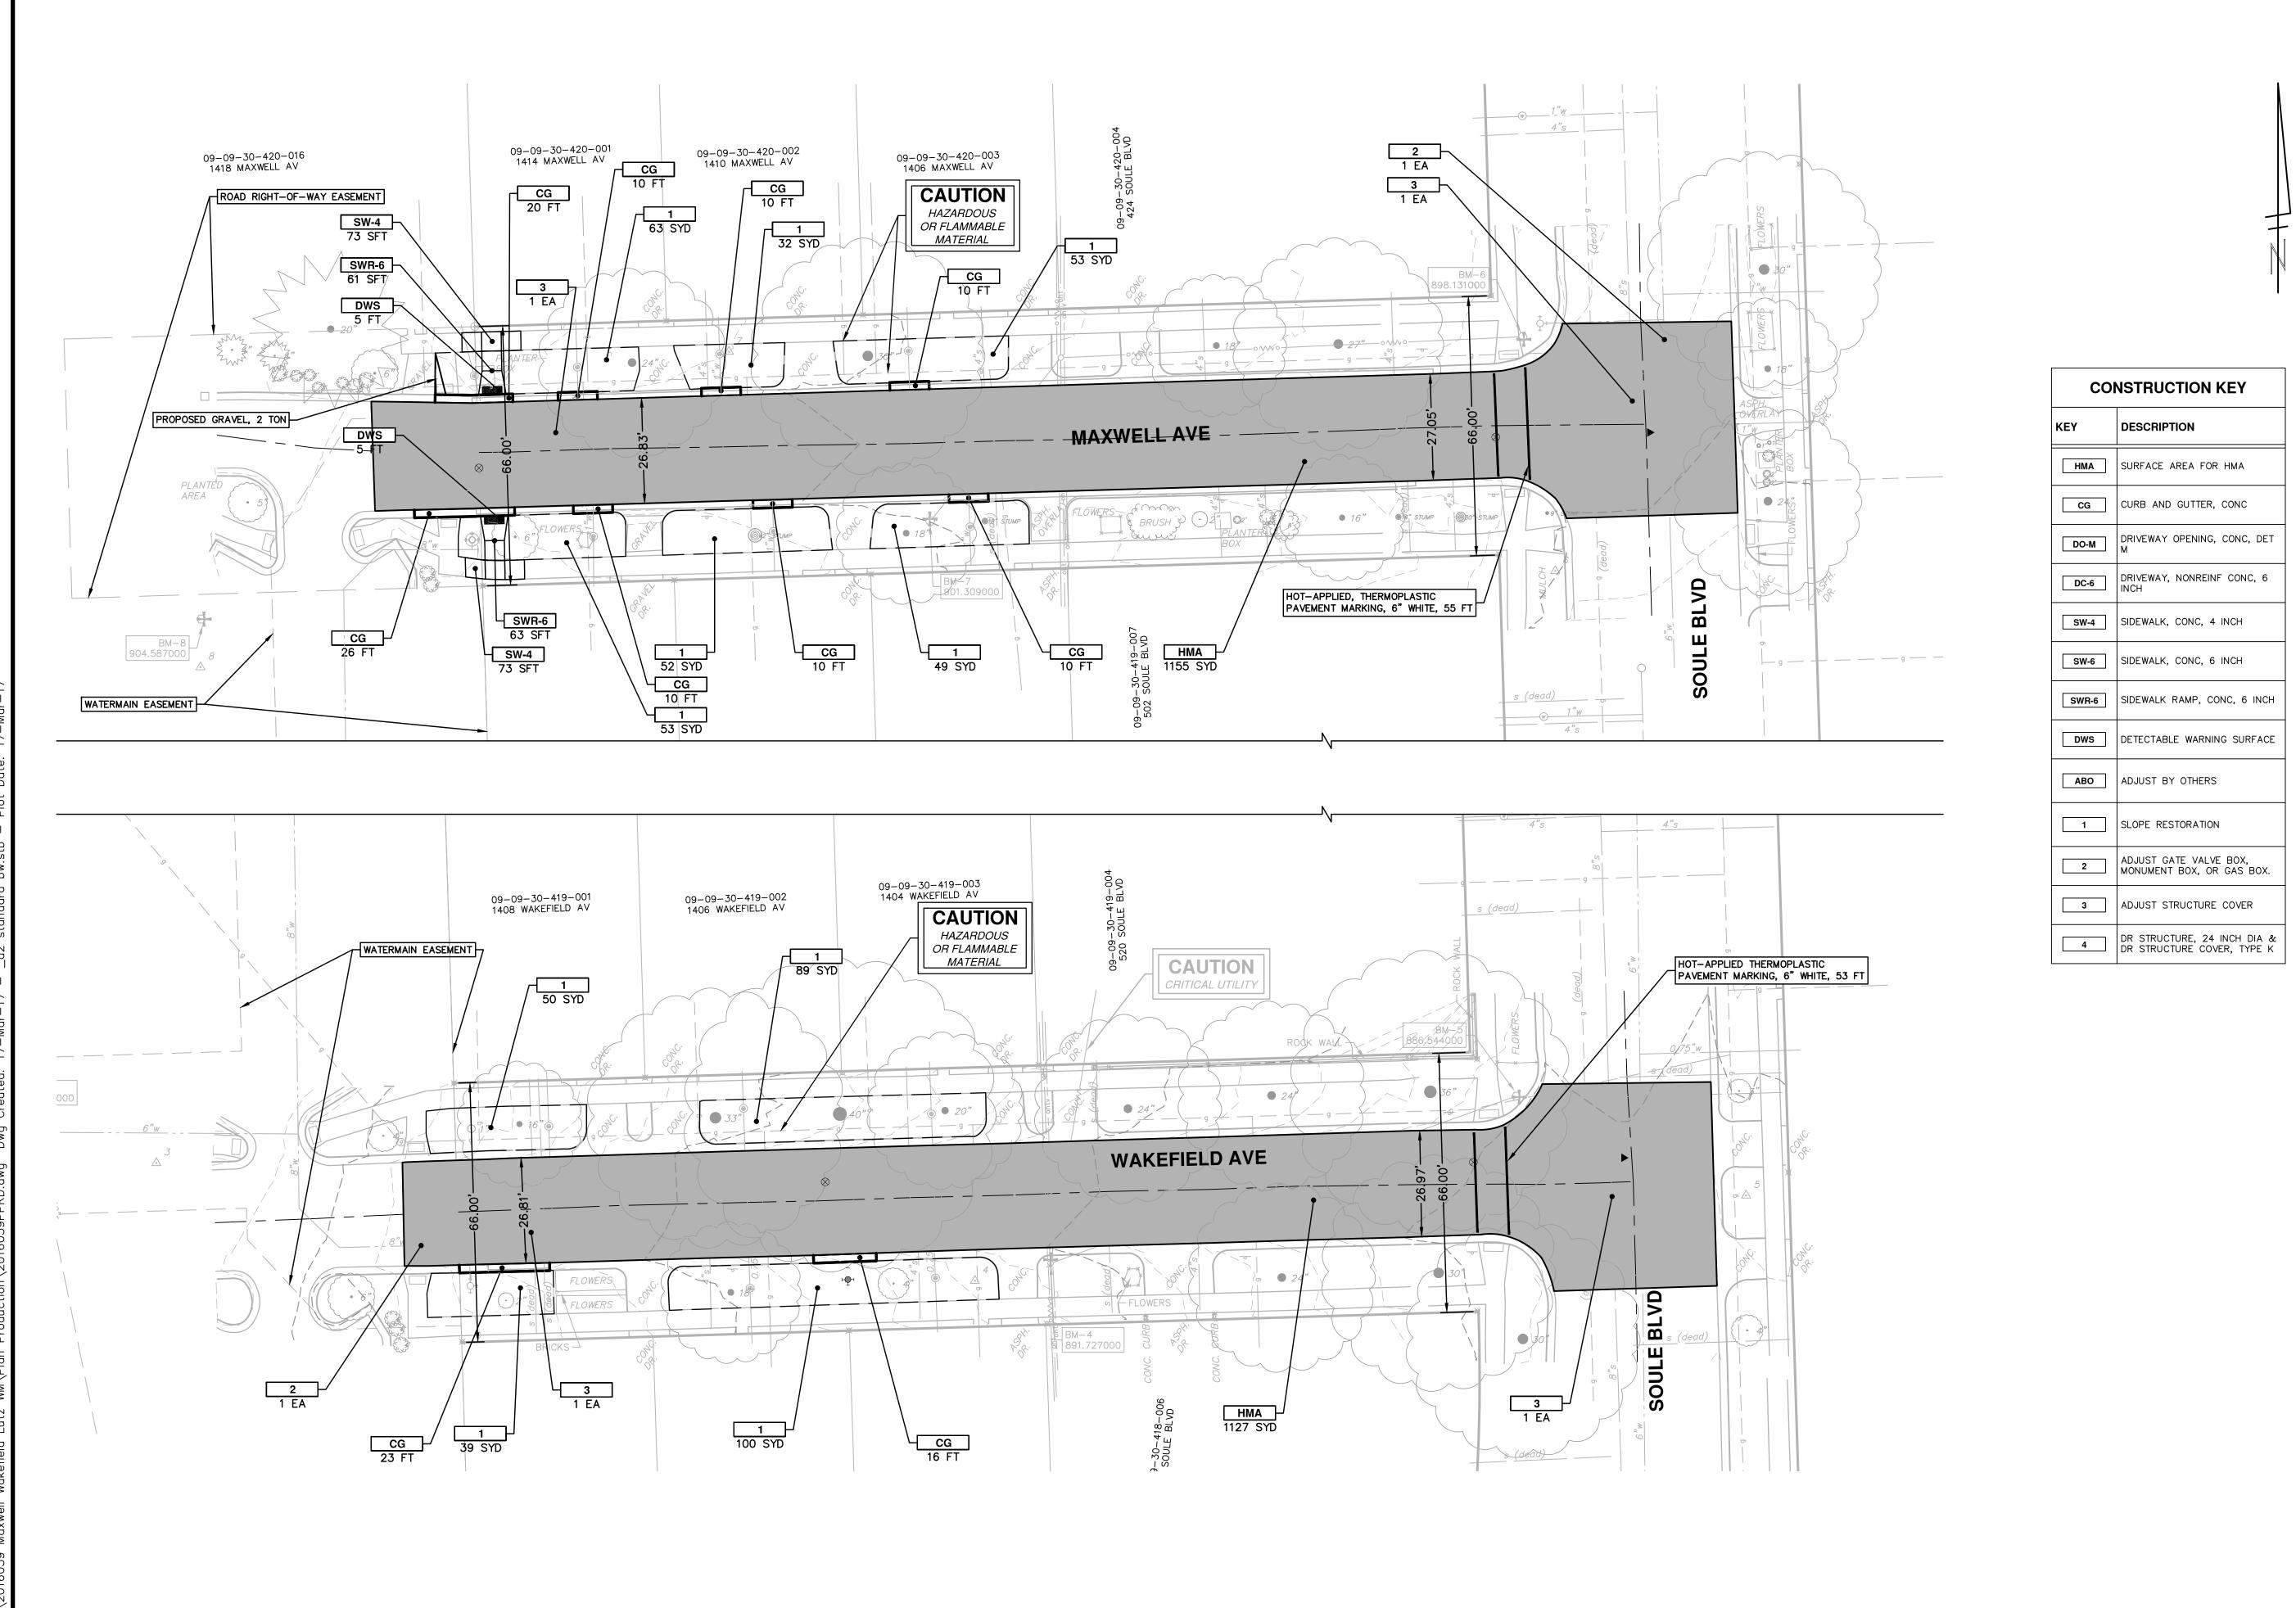

ND GUTTER, CONC	
AY OPENING, CONC, DET	
AY, NONREINF CONC, 6	
K, CONC, 4 INCH	
K, CONC, 6 INCH	
K RAMP, CONC, 6 INCH	
ABLE WARNING SURFACE	
BY OTHERS	
RESTORATION	
GATE VALVE BOX, ENT BOX, OR GAS BOX.	
STRUCTURE COVER	
JCTURE, 24 INCH DIA &	

PROJECT MANAGEMENT - PUBLIC SERVICES - CITY OF ANN ARBC

SCALE PLAN: 1" = 20' PROFILE: 1" = 2'

DRAWING NO.


PROJECT MANAGEMENT - PUBLIC SERVICES - CITY OF ANN ARBC


MAXWELL, WAKEFIELD, LUTZ

WATER MAIN REPLACEMENT

ROADWAY PLANS

MAXWELL AVE. AND WAKEFIELD AVE.

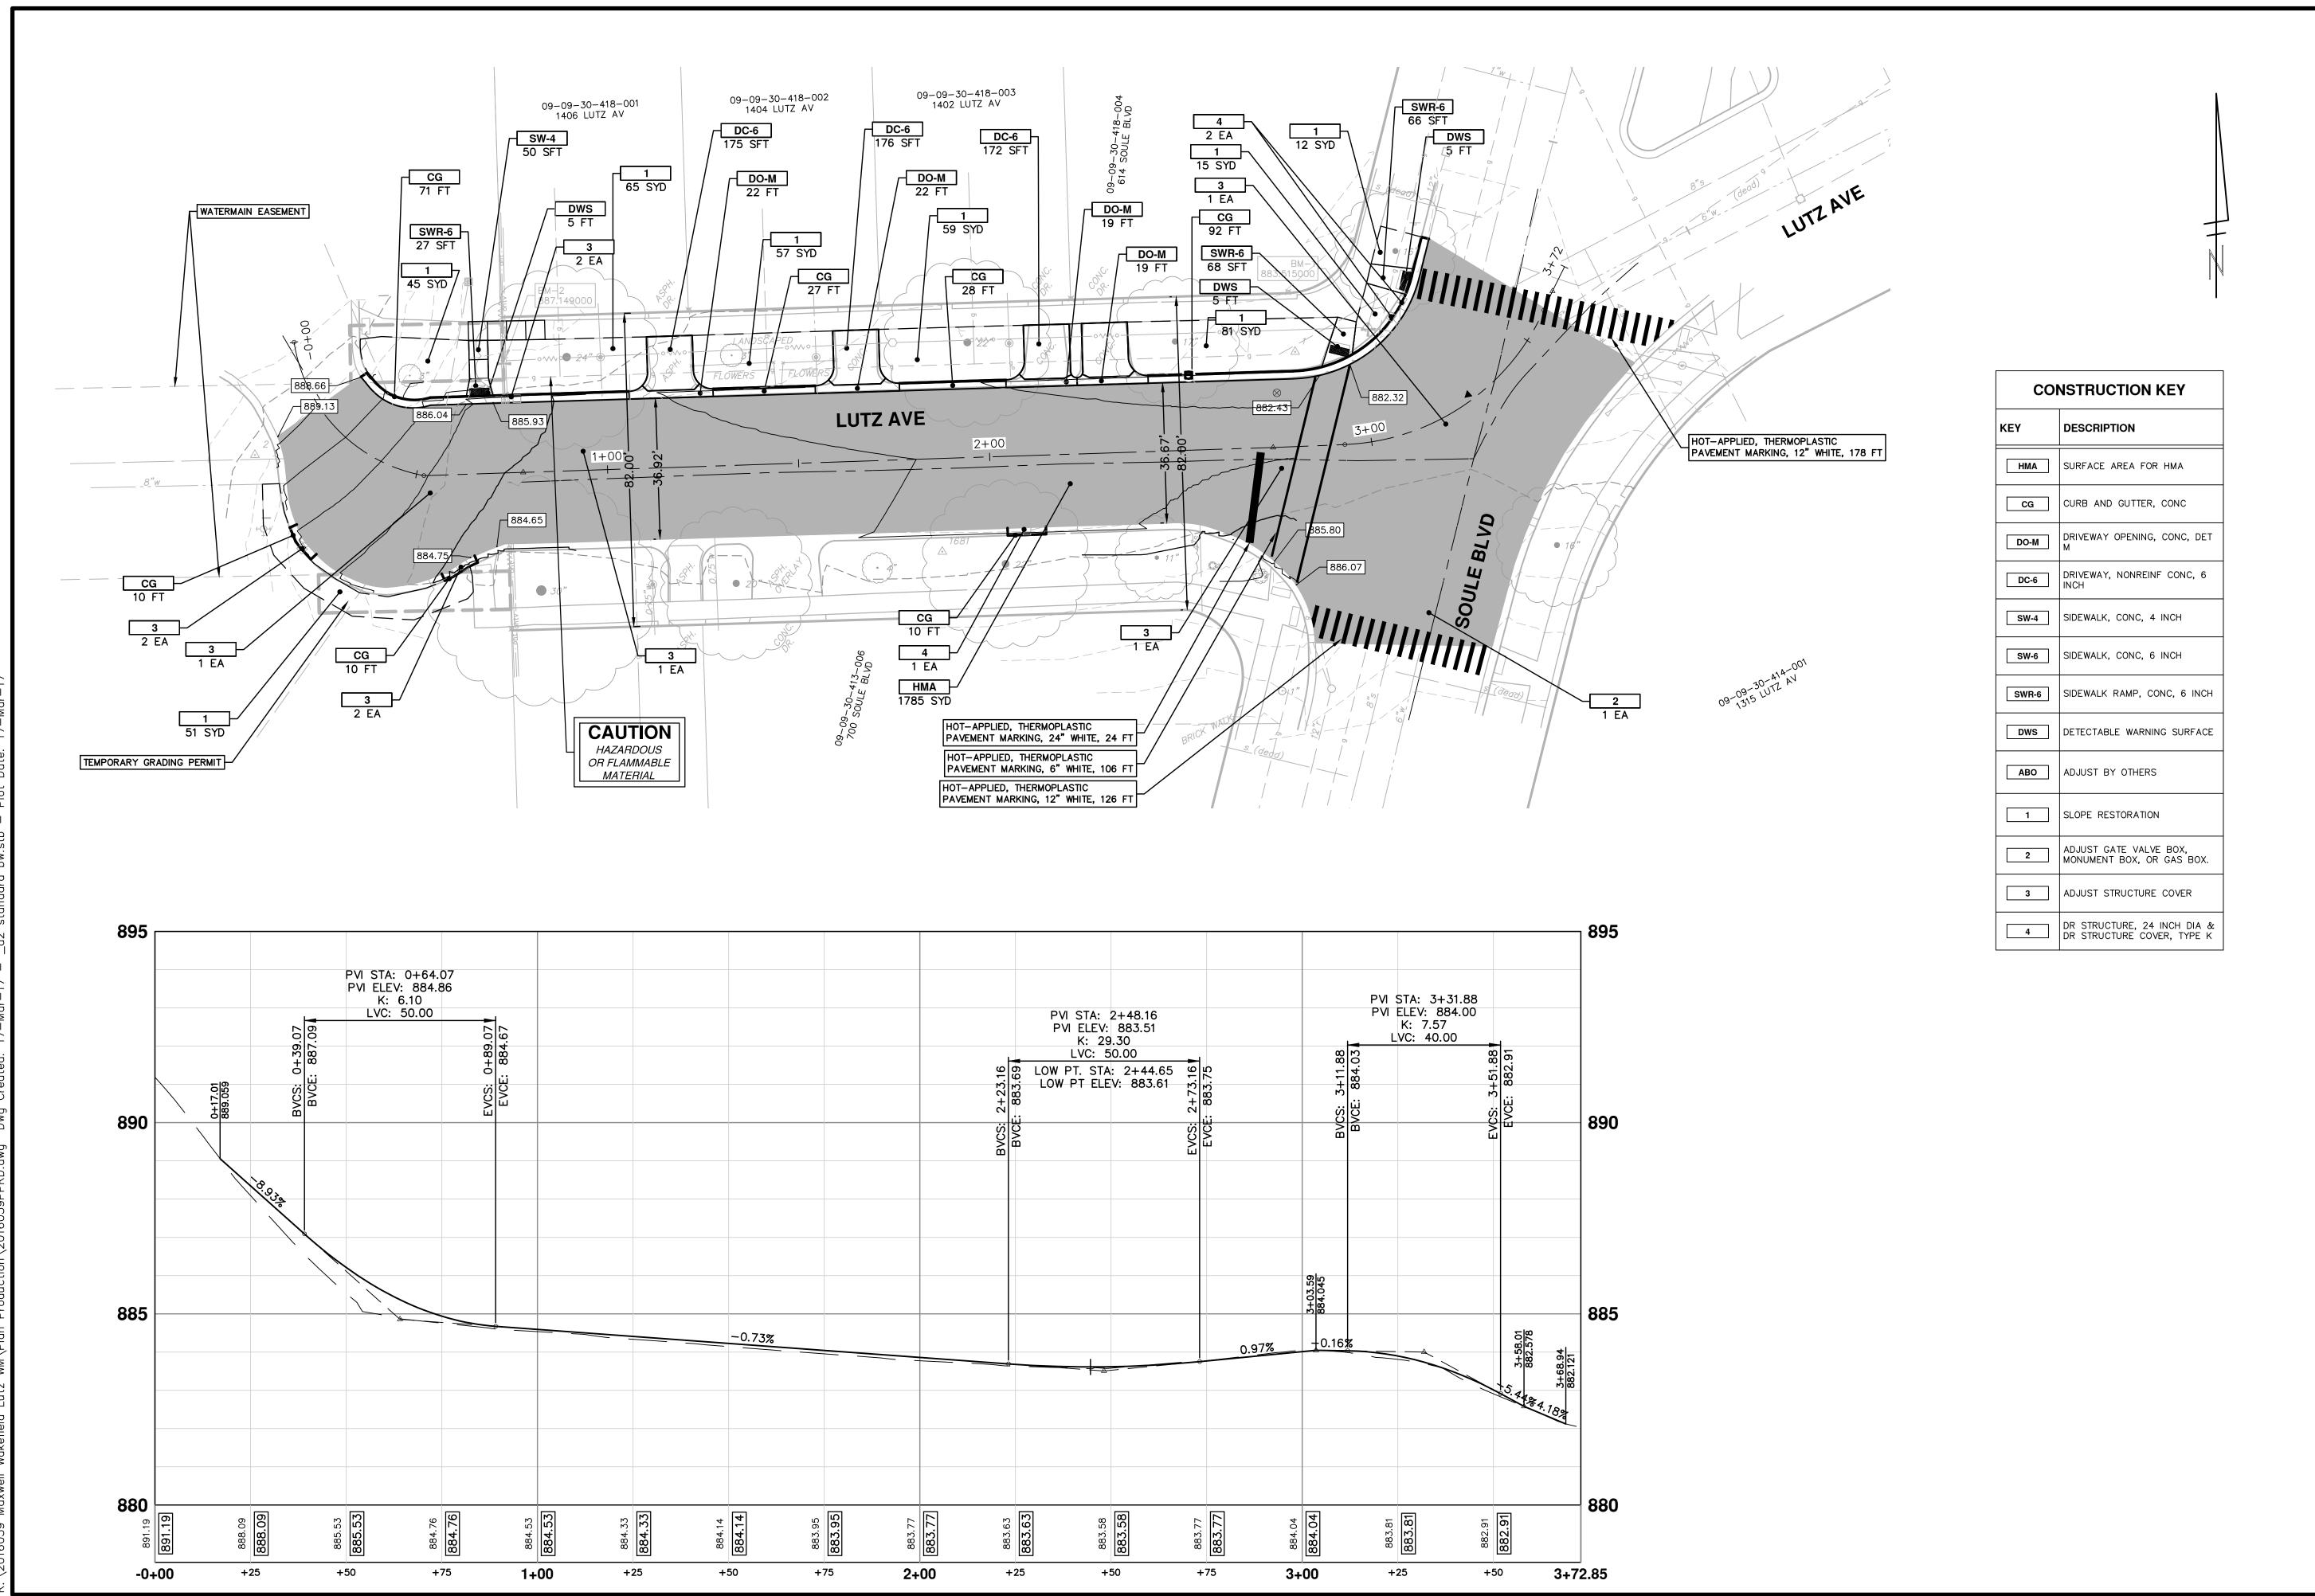

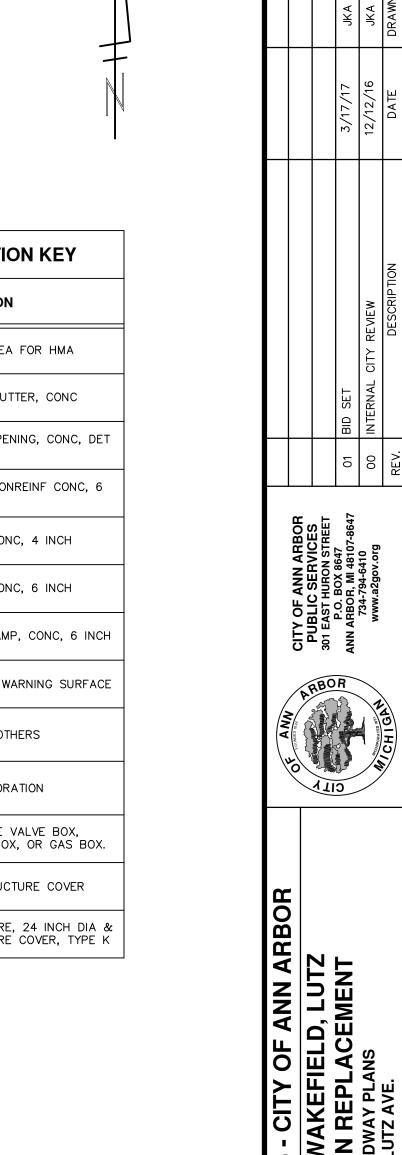

SEMENT - PUBLIC SERVICES - CITY OF ANN ARBOR	MAXWELL, WAKEFIELD, LUTZ	WATER MAIN REPLACEMENT	ROADWAY PLANS	
NEW NEW NEW NEW NEW NEW NEW NEW NEW NEW	:: 1" = 2'			