ROTARY CLUB OF ANN ARBOR CENTENNIAL PLAYGROUND

Gallup Park 3000 Fuller Rd. Ann Arbor, MI

BID PLANS

October 14, 2016 SGJJR Project Number: 20678.000

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Prepared for:




Prepared by:


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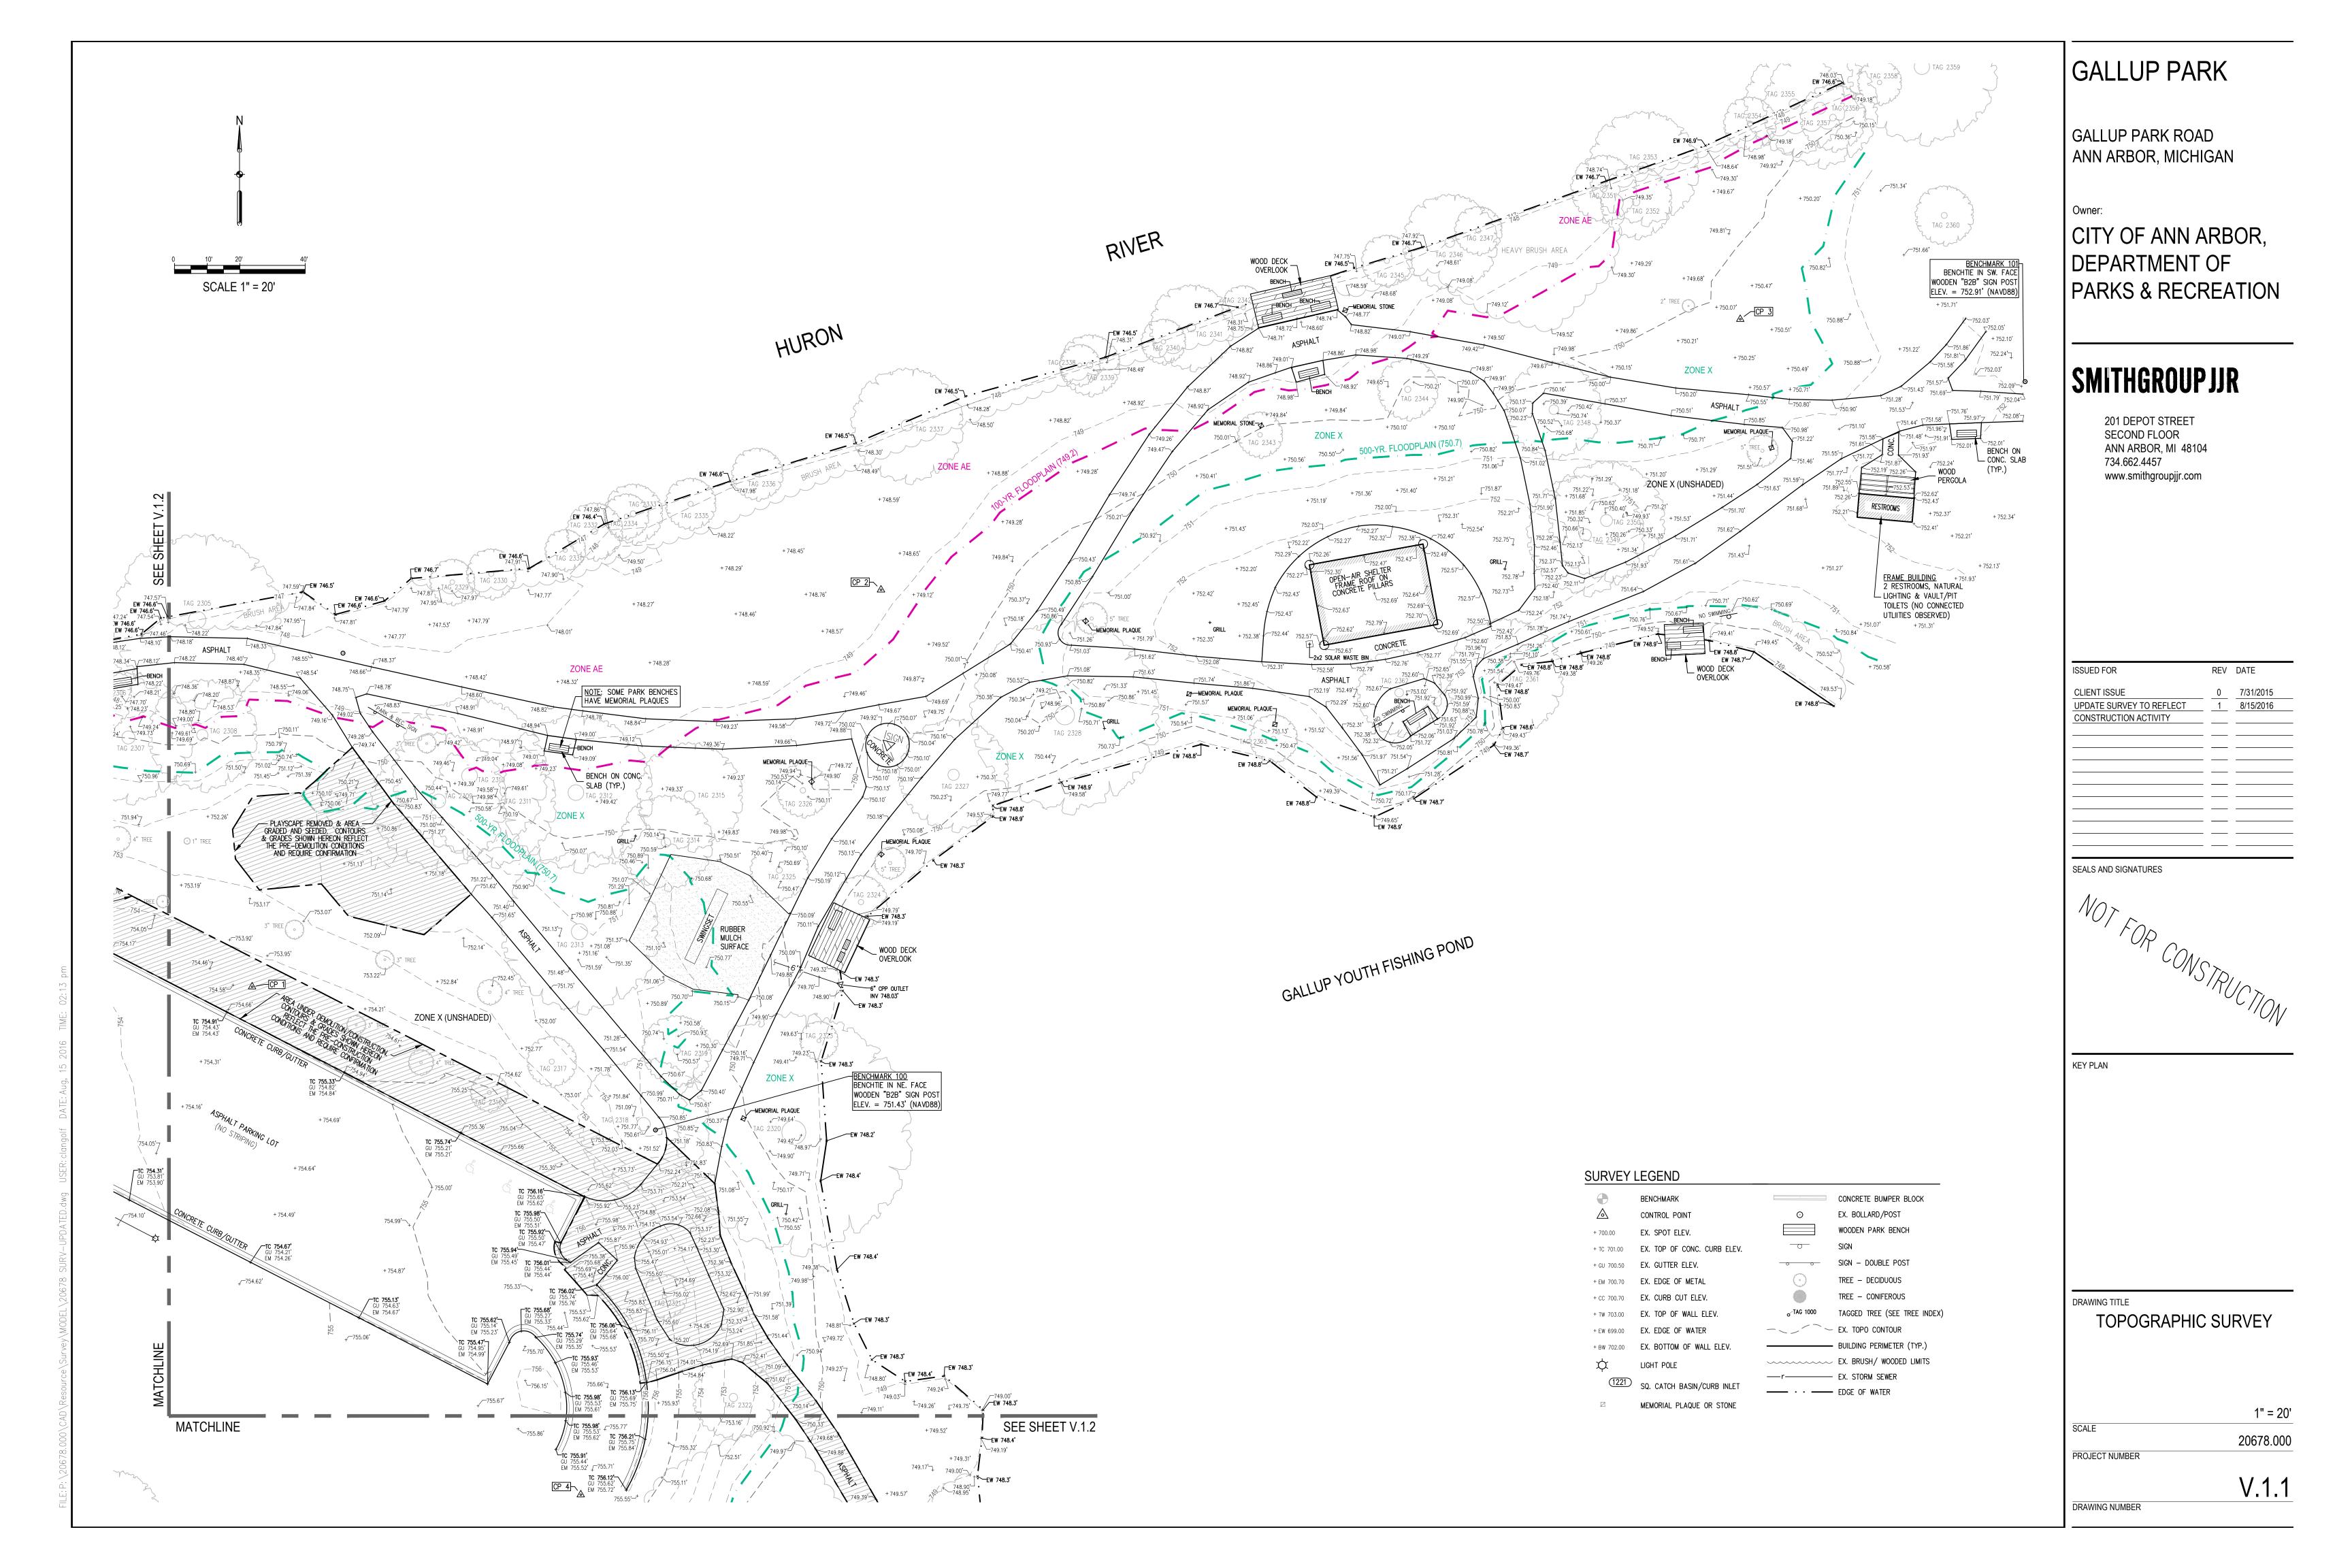
PARKS AND RECREATION SERVICES
301 East Huron
Ann Arbor, MI 48104


201 DEPOT STREET SECOND FLOOR ANN ARBOR, MI 48104 734.662.4457 www.smithgroupjjr.com



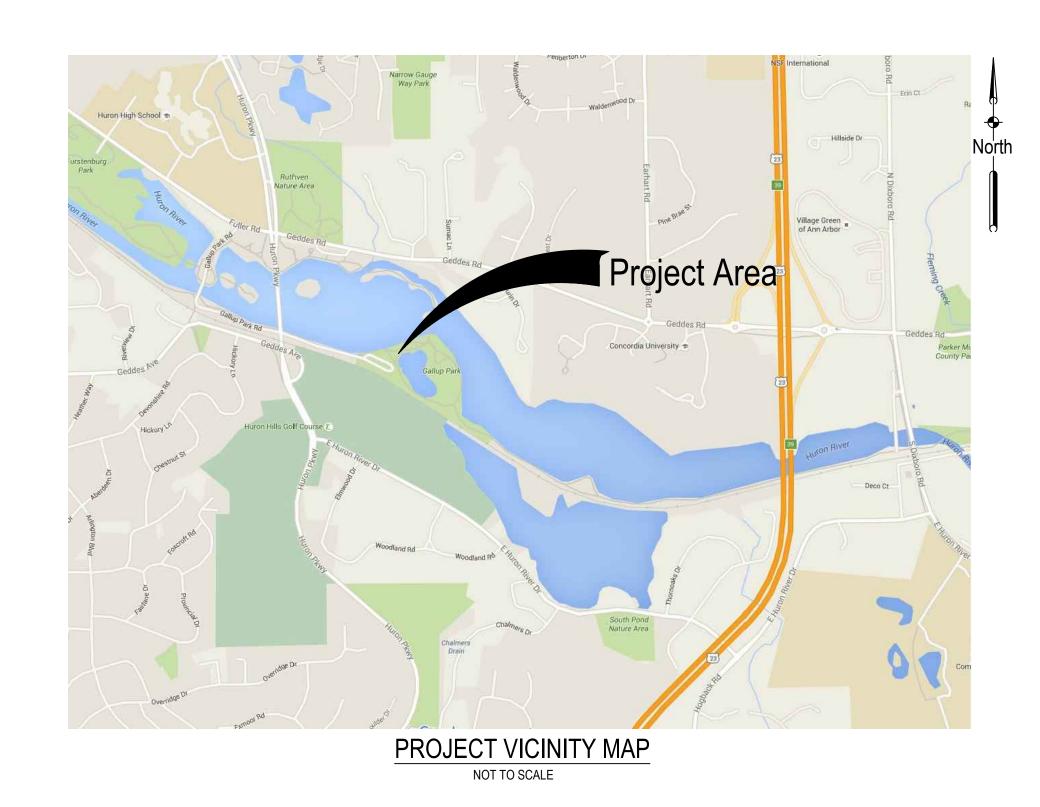



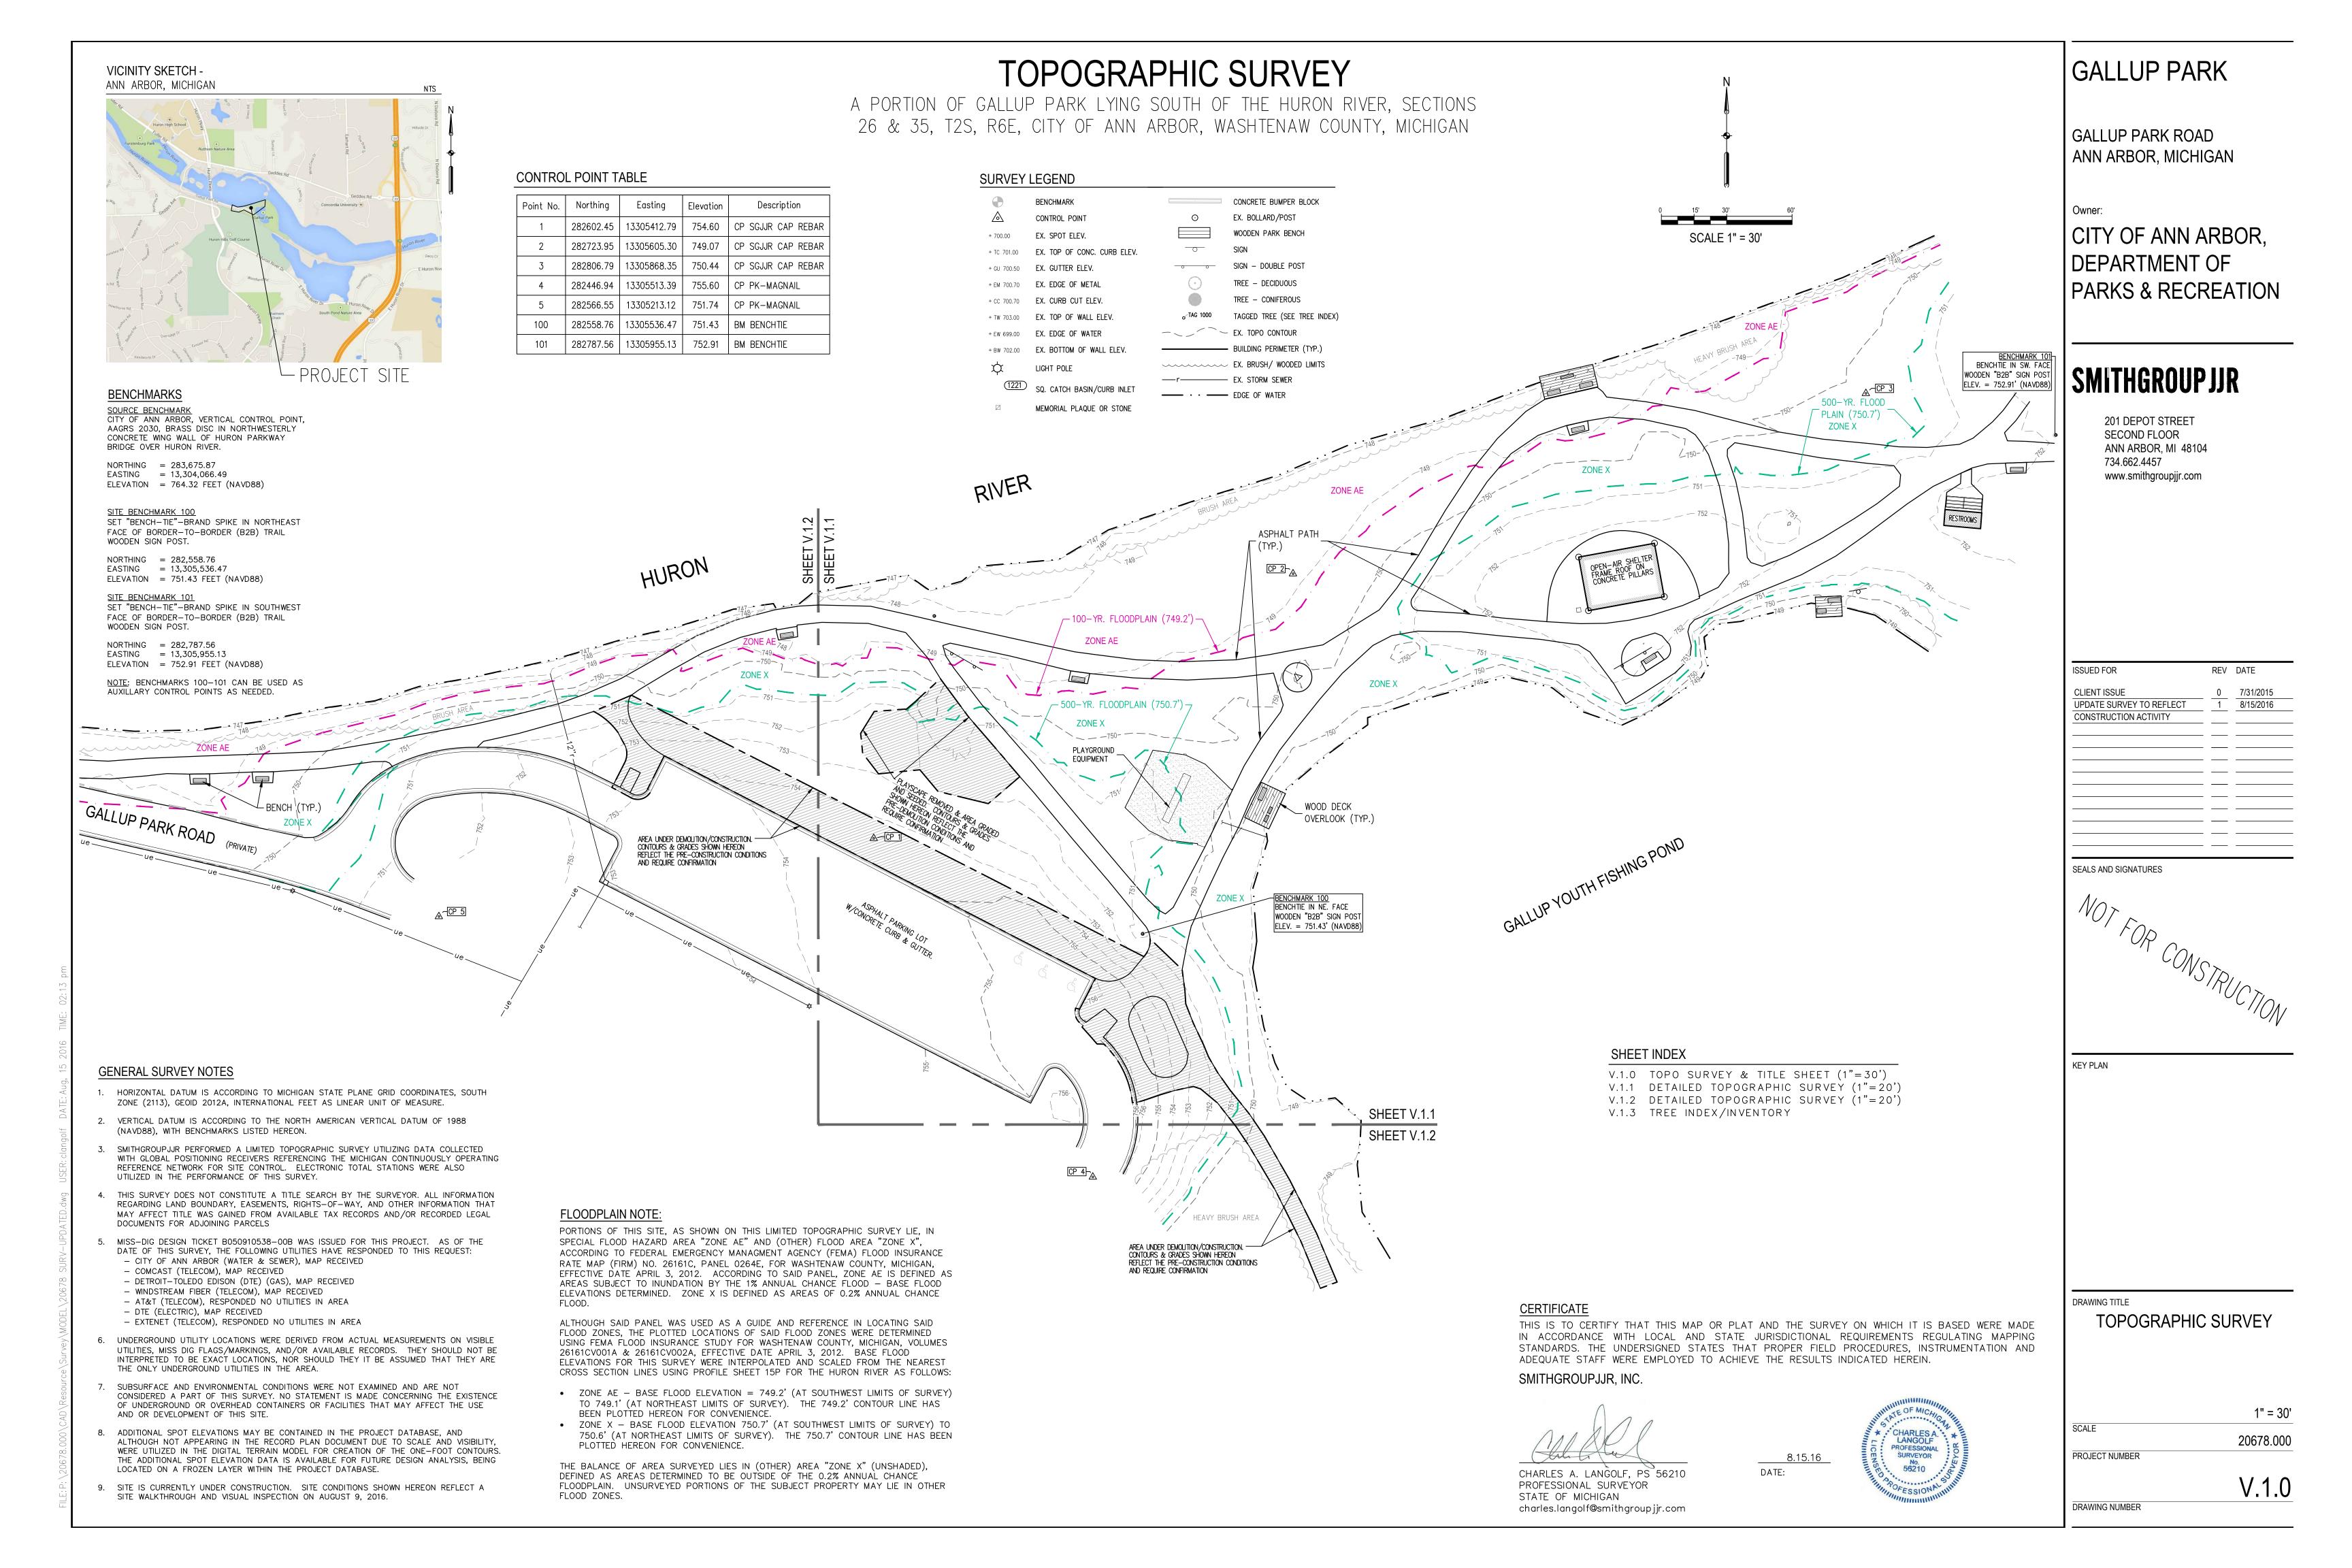

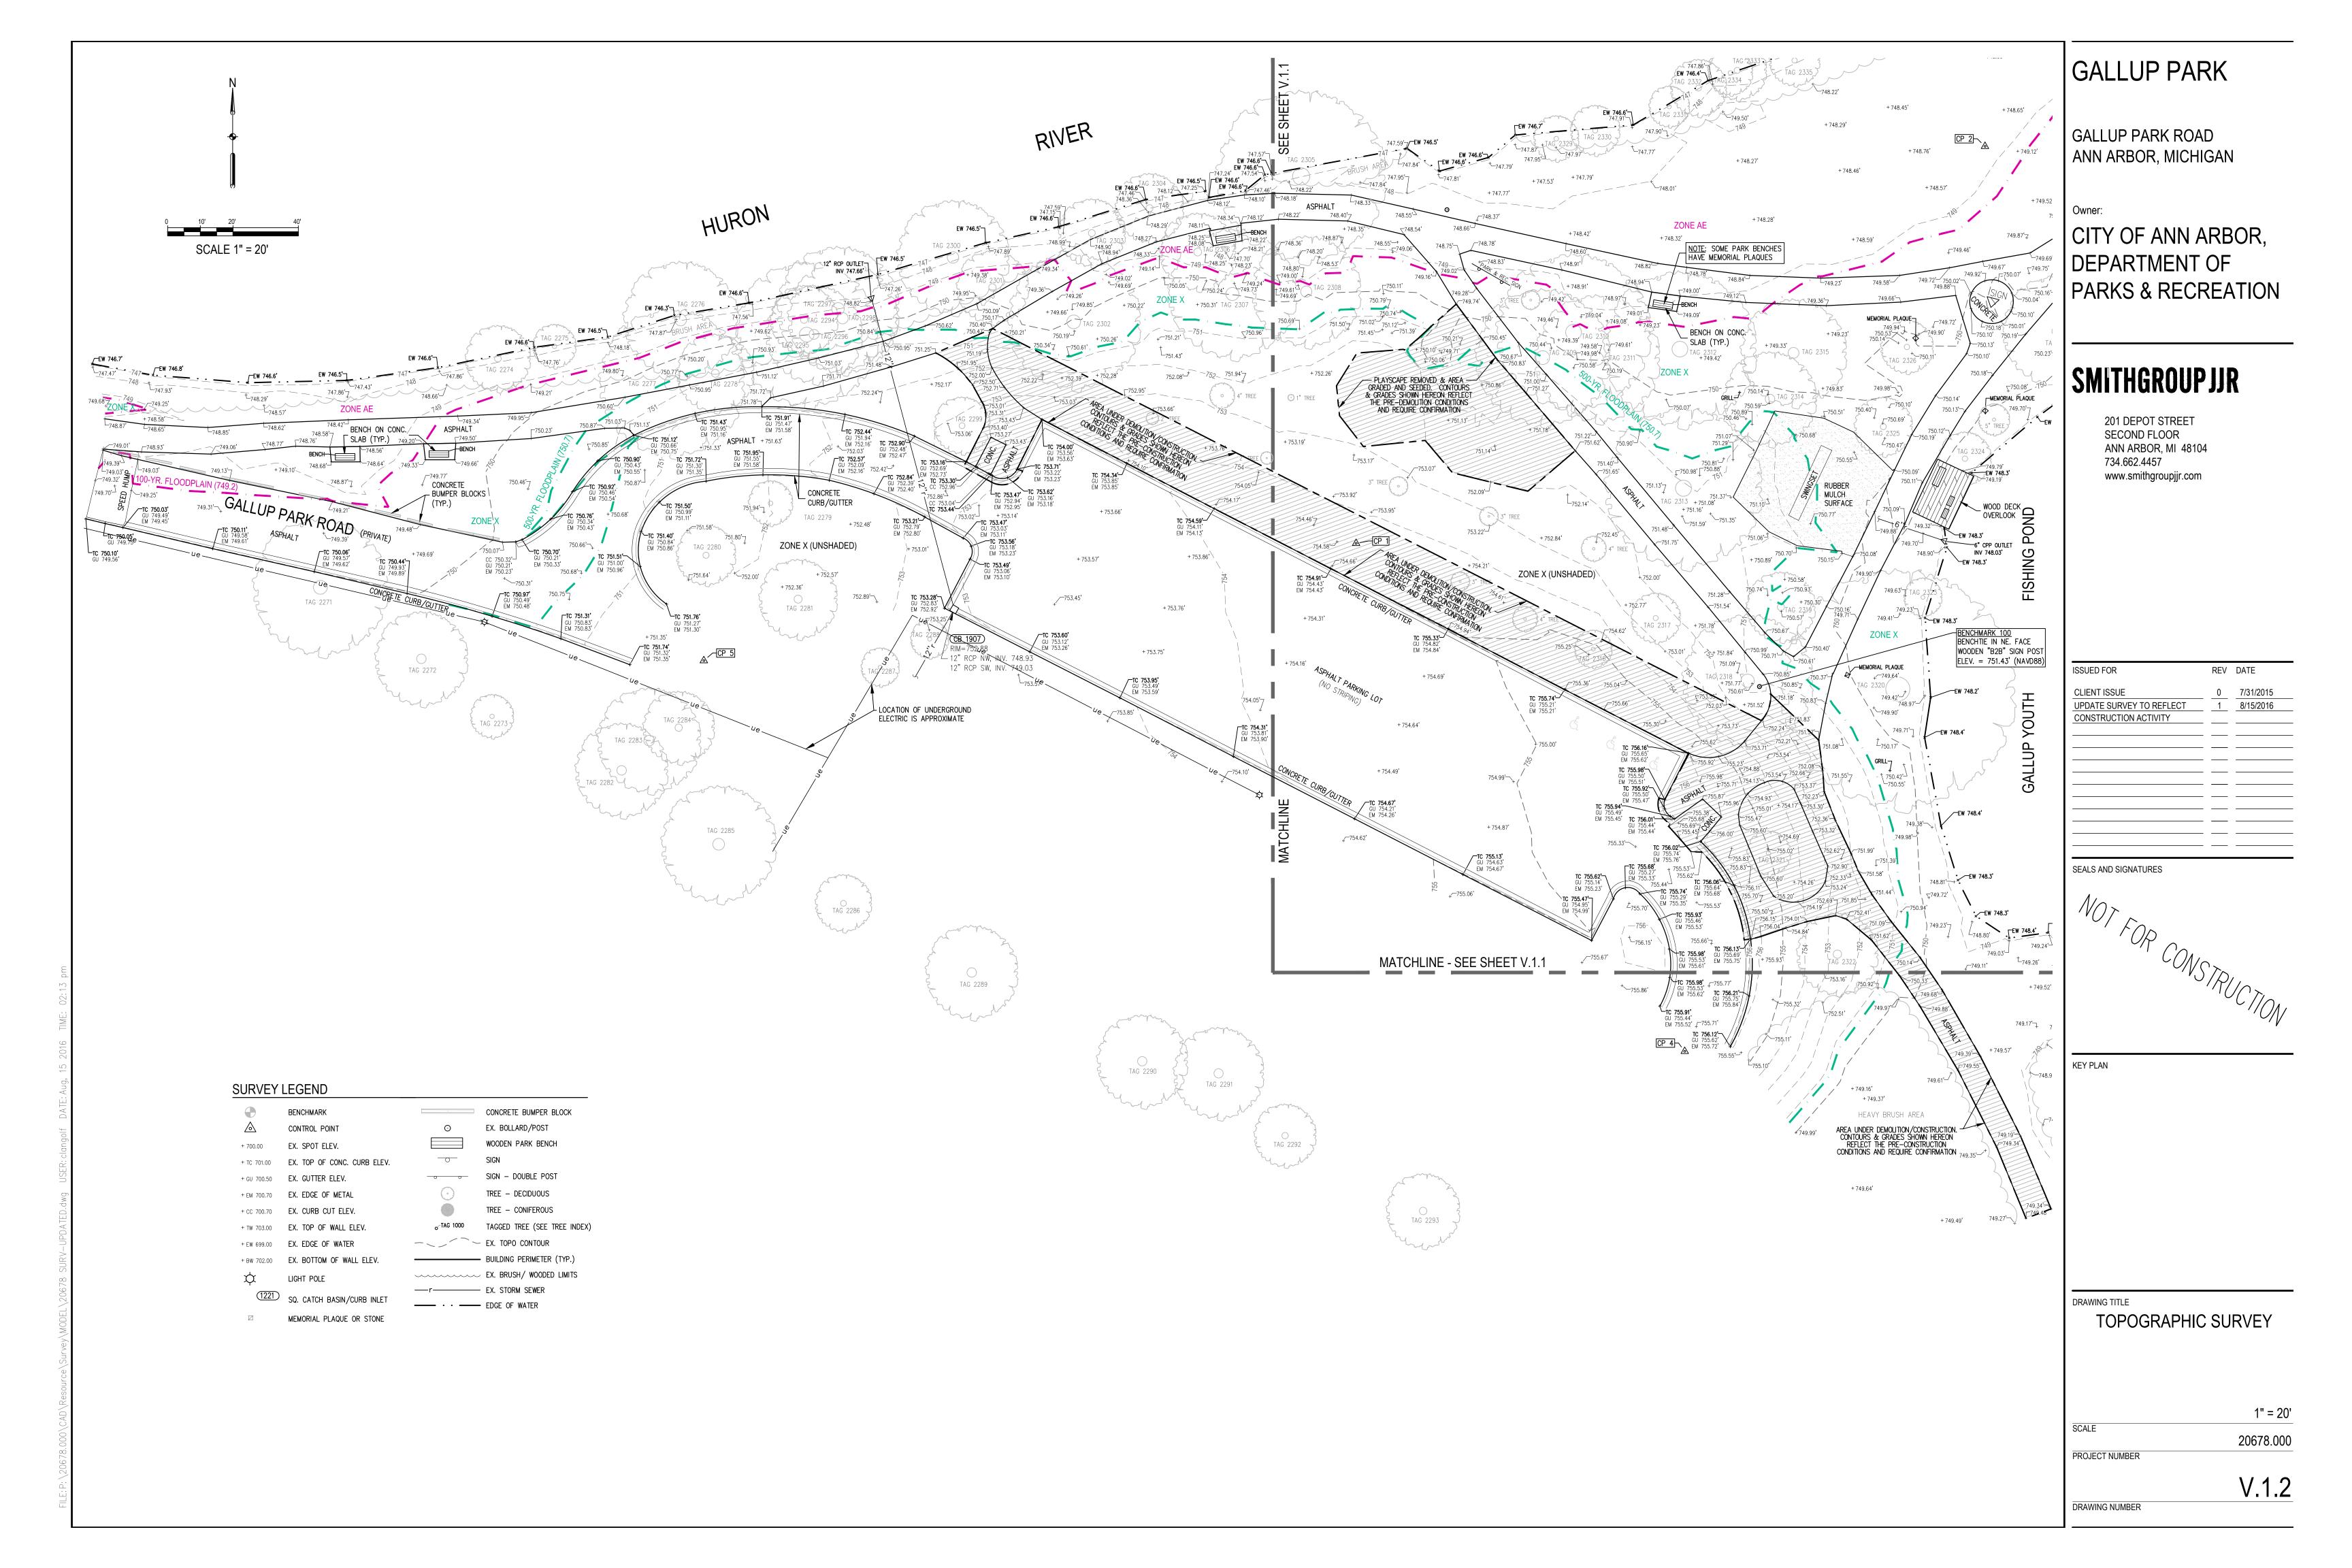

TREE INDEX

Tag	Species	Common Name	DBH (Inches)	[Northing]	GPS Coordinates [Easting]	Invasive Species Class	Potential Landmark Tree	Critcial Root Zone (Feet)	Trunk	Growth Rate	Structure	Insects/ Diseases	Crown Devlpmt	Life Expect- ancy	Total	Notes
	Acer negundo Pinus nigra	Boxelder Austrian pine	21.5 14.8	282589 282567	13305096 13305127	2	Y	21.5	3	5	5	4	5	5	27	2 TR sap running
273	Juglens nigra	Black walnut	6.9	282549	13305148											Sup running
	Ulmus americana	American elm	10.4	282659	13305150											
	Alnus glutinosa Alnus glutinosa	European alder European alder	6.9 18.3	282663 282671	13305167 13305206	1										
	Quercus velutina	Black oak	23.2	282652	13305203	<u> </u>	Y	23.2	5	5	4	5	4	5	28	
	•	Bur oak	12.3	282654	13305217											sprouting from trunk
	Acer saccharinum Acer saccharinum	Silver maple Silver maple	7.1 9.5	282615 282599	13305234 13305214											rotten core
	Acer saccharinum Acer saccharinum	Silver maple	12.5	282585	13305214											girdling root
		Austrian pine	14.8	282533	13305188	2										borer holes, sap running
	Pinus nigra	Austrian pine	16.5	282542	13305196	2										
	Pinus nigra Acer negundo	Austrian pine Boxelder	11.4 18.3	282546 282510	13305205 13305218	2	Y	18.3	4	5	4	4	4	5	26	2 TR
	Platanus x acerifolia	London planetree	9.0	282492	13305216		T	10.3	4	3	4	4	4	3	26	ZIK
	Gleditsia triacanthos v. inemis	Honeylocust	6.1	282565	13305267											
	Crataegus spp.	Hawthorn	6.1	282573	13305282	_										2 TR
	Pinus nigra Pinus nigra	Austrian pine	14.7 14.5	282471 282444	13305295 13305347	2										borer holes
	Pinus nigra Pinus nigra	Austrian pine Austrian pine	14.5	282440	13305347	2										borer holes, sap
	-	Austrian pine	9.9	282421	13305391	2										bad crotch angle
	Pinus nigra	Austrian pine	11.7	282398	13305433	2										
	Ulmus americana	American elm	10.8	282671	13305244		\ \ \ \ \ \ \ \ \ \ \ \ \ \ \ \ \ \ \	20.0	-	-		_	4			
	Quercus velutina Quercus bicolor	Black oak Swamp white oak	22.8 15.4	282666 282666	13305245 13305247		Y	22.8	5	5	4	5	4	5	28	trunk sprouts
	Quercus bicolor	Swamp white oak	19.5	282674	13305254		Υ	19.5	4	4	3	4	3	4	22	
	Quercus bicolor	Swamp white oak	17.5	282671	13305256		Υ	17.5	3	3	3	4	3	4	20	
	Acer rubrum	Red maple	9.0	282638	13305292											old sunscald
300 301	Salix nigra Tilia americana	Black willow American linden	17.9 11.5	282690 282681	13305289 13305301											3 TR 4 TR
	Tilia americana Tilia americana	American linden American linden	21.3	282670	13305301		Y	21.3	4	4	4	4	4	4	24	3 TR
	Alnus glutinosa	European alder	10.7	282697	13305332	1										2 TR
	Alnus glutinosa	European alder	10.9	282705	13305350	1							_	_		2 TR
	Alnus glutinosa	European alder	26.9	282715	13305396	1										estimated DBH
306 307	Tilia americana Tilia americana	American linden American linden	12.2 20.4	282692 282679	13305364 13305375		Y	20.4	4	5	5	4	5	5	28	2 TR
	Quercus macrocarpa	Bur oak	17.4	282680	13305378		Y	17.4	4	4	4	4	4	4	24	
09	Quercus alba	White oak	21.5	282659	13305470		Υ	21.5	4	4	5	4	5	4	26	
	Quercus alba	White oak	24.6	282667	13305479		Y	24.6	5	4	3	4	4	4	24	leaning
	Quercus alba Tilia americana	White oak American linden	20.0	282659 282662	13305487 13305512		Y	20.0 24.4	3	3 5	4	3 5	5	3 5	20 28	trunk sprouts leaning
	Quercus velutina	Black oak	25.1	282619	13305512		Y	25.1	5	5	5	5	5	5	30	2 TR
	Tilia americana	American linden	14.8	282647	13305539					-	-		-	-		
15	Tilia americana	American linden	16.9	282661	13305547											2 TR
	Celtis occidentalis	Hackberry	6.0	282570	13305485											
	Gleditsia triacanthos v. inermis Prunus serotina	Honeylocust Black cherry	7.9	282580 282560	13305505 13305533		Y	20.8	4	4	4	4	4	4	24	
	Acer rubrum	Red maple	11.0	282583	13305543		'	20.0	7			7		7		
320	Salix alba	White willow	37.5	282558	13305579	2										
	Acer rubrum	Red maple	7.0	282508	13305539											
	Quercus velutina Morus alba	Black oak White mulberry	13.0 6.1	282477 282586	13305560 13305586	2										4 TR
	Betula nigra 'Heritage'	Heritage river birch	8.4	282628	13305500											2 TR
	Liquidambar styraciflua	Sweet gum	9.3	282638	13305574											
	<u> </u>	Sweet gum	8.4	282663	13305581											
	Quercus alba Salix alba	White oak White willow	17.5 30.1	282667 282686	13305628 13305662	2	Y	17.5	5	5	5	5	5	5	30	
	Alnus glutinosa	European alder	7.2	282726	13305662	1										multiple trunks
	Alnus glutinosa	European alder	7.9	282729	13305486	1										2 TR
	Alnus glutinosa	European alder	6.5	282736	13305509	1										
-	Alnus glutinosa	European alder	9.0	282742	13305518	1										estimate DBH; 8+ trur
	Alnus glutinosa Alnus glutinosa	European alder European alder	9.4 7.1	282747 282746	13305529 13305527	1	-								0	4 TR 3 TR
	Acer negundo	Boxelder	8.1	282750	13305547	'										J
	Alnus glutinosa	European alder	8.2	282759	13305567	1										4 TR
	Robinia pseudoacacia	Black locust	17.9	282774	13305613	2									0	2 TR
	Alnus glutinosa Robinia pseudoacacia	European alder Black locust	6.5 9.6	282793 282793	13305666 13305669	2	-									
	Prunus avium	Sweet cherry	7.1	282800	13305692	2										
41	Alnus glutinosa	European alder	13.4	282804	13305700	1										3 TR
	Alnus glutinosa	European alder	6.9	282810	13305716	1										leaning
343 344	Tilia cordifolia Quercus rubra	Littleleaf linden Red oak	7.2 9.6	282771 282785	13305721 13305767		1									
	Alnus glutinosa	European alder	9.6 8.1	282785	13305767	1										2 TR
	Alnus glutinosa	European alder	15.1	282830	13305779	1										
	Rhamnus cathartica	Buckthorn	7.6	282834	13305788	1										
	Quercus rubra	Red oak	15.1	282779	13305811			40.7	A				2		40	oignificant to mile
	Quercus macrocarpa Tilia americana	Bur oak American linden	18.7 18.6	282741 282745	13305821 13305827		Y	18.7 18.6	3	3	3	2	3	3	18 20	significant trunk sprout 2 TR
	Morus alba	White mulberry	10.5	282847	13305827	2	† '	.5.5						,		
52	Robinia pseudoacacia	Black locust	11.4	282843	13305836	2										3 TR
	Alnus glutinosa	European alder	17.7	282853	13305839	1										7.70
	Alnus glutinosa Robinia pseudoacacia	European alder Black locust	8.4 16.1	282867 282873	13305871 13305885	2										7 TR
	Robinia pseudoacacia Robinia pseudoacacia	Black locust	16.1	282873	13305885	2	1									
_	Robinia pseudoacacia	Black locust	10.4	282869	13305897	2	1									
58	Acer negundo	Boxelder	7.0	282879	13305911											
	Robinia pseudoacacia	Black locust	24.0	282884	13305924	2										estimated DBH, 7 TR
_	Tilia cordifolia Tilia cordifolia	Littleleaf linden Littleleaf linden	9.3 18.7	282839 282697	13305931 13305796		Y	18.7	4	4	4	5	4	5	26	
וני.		Littleleaf linden	18.7	282697	13305796		T T	10.7	4	4	4	5	4	5	∠٥	1
	Tilia cordifolia	LILLIOIGUI III II	1 10			i			II.		1					
362	Tilia cordifolia Betula nigra 'Heritage'	Heritage river birch	7.6	282678	13305725											

Number of Landmark Trees with a Health/Condition score of 16 or higher: 19

Number of Landmark Trees with a Health/Condition score of less than 16: 0

Tree survey completed during leaf off; health of tree was estimated

GPS Coordinates are expressed in NAD 83 Datum, Michigan State Plane Grid

GALLUP PARK

GALLUP PARK ROAD ANN ARBOR, MICHIGAN

Owner:


CITY OF ANN ARBOR,
DEPARTMENT OF
PARKS & RECREATION

SMITHGROUPJJR

201 DEPOT STREET SECOND FLOOR ANN ARBOR, MI 48104 734.662.4457 www.smithgroupjjr.com

ISSUED FOR	KEV	DATE
CLIENT ISSUE	0	7/31/2015
UPDATE SURVEY TO REFLECT	1	8/15/2016
CONSTRUCTION ACTIVITY		
<u>- </u>		

SEALS AND SIGNATURES

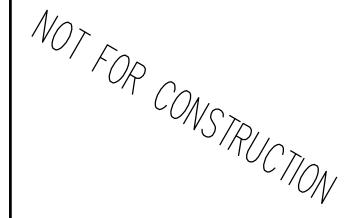


KEY PLAN

DRAWING TITLE

TREE INVENTORY

N/A
SCALE
20678.000
PROJECT NUMBER

DRAWING NUMBER

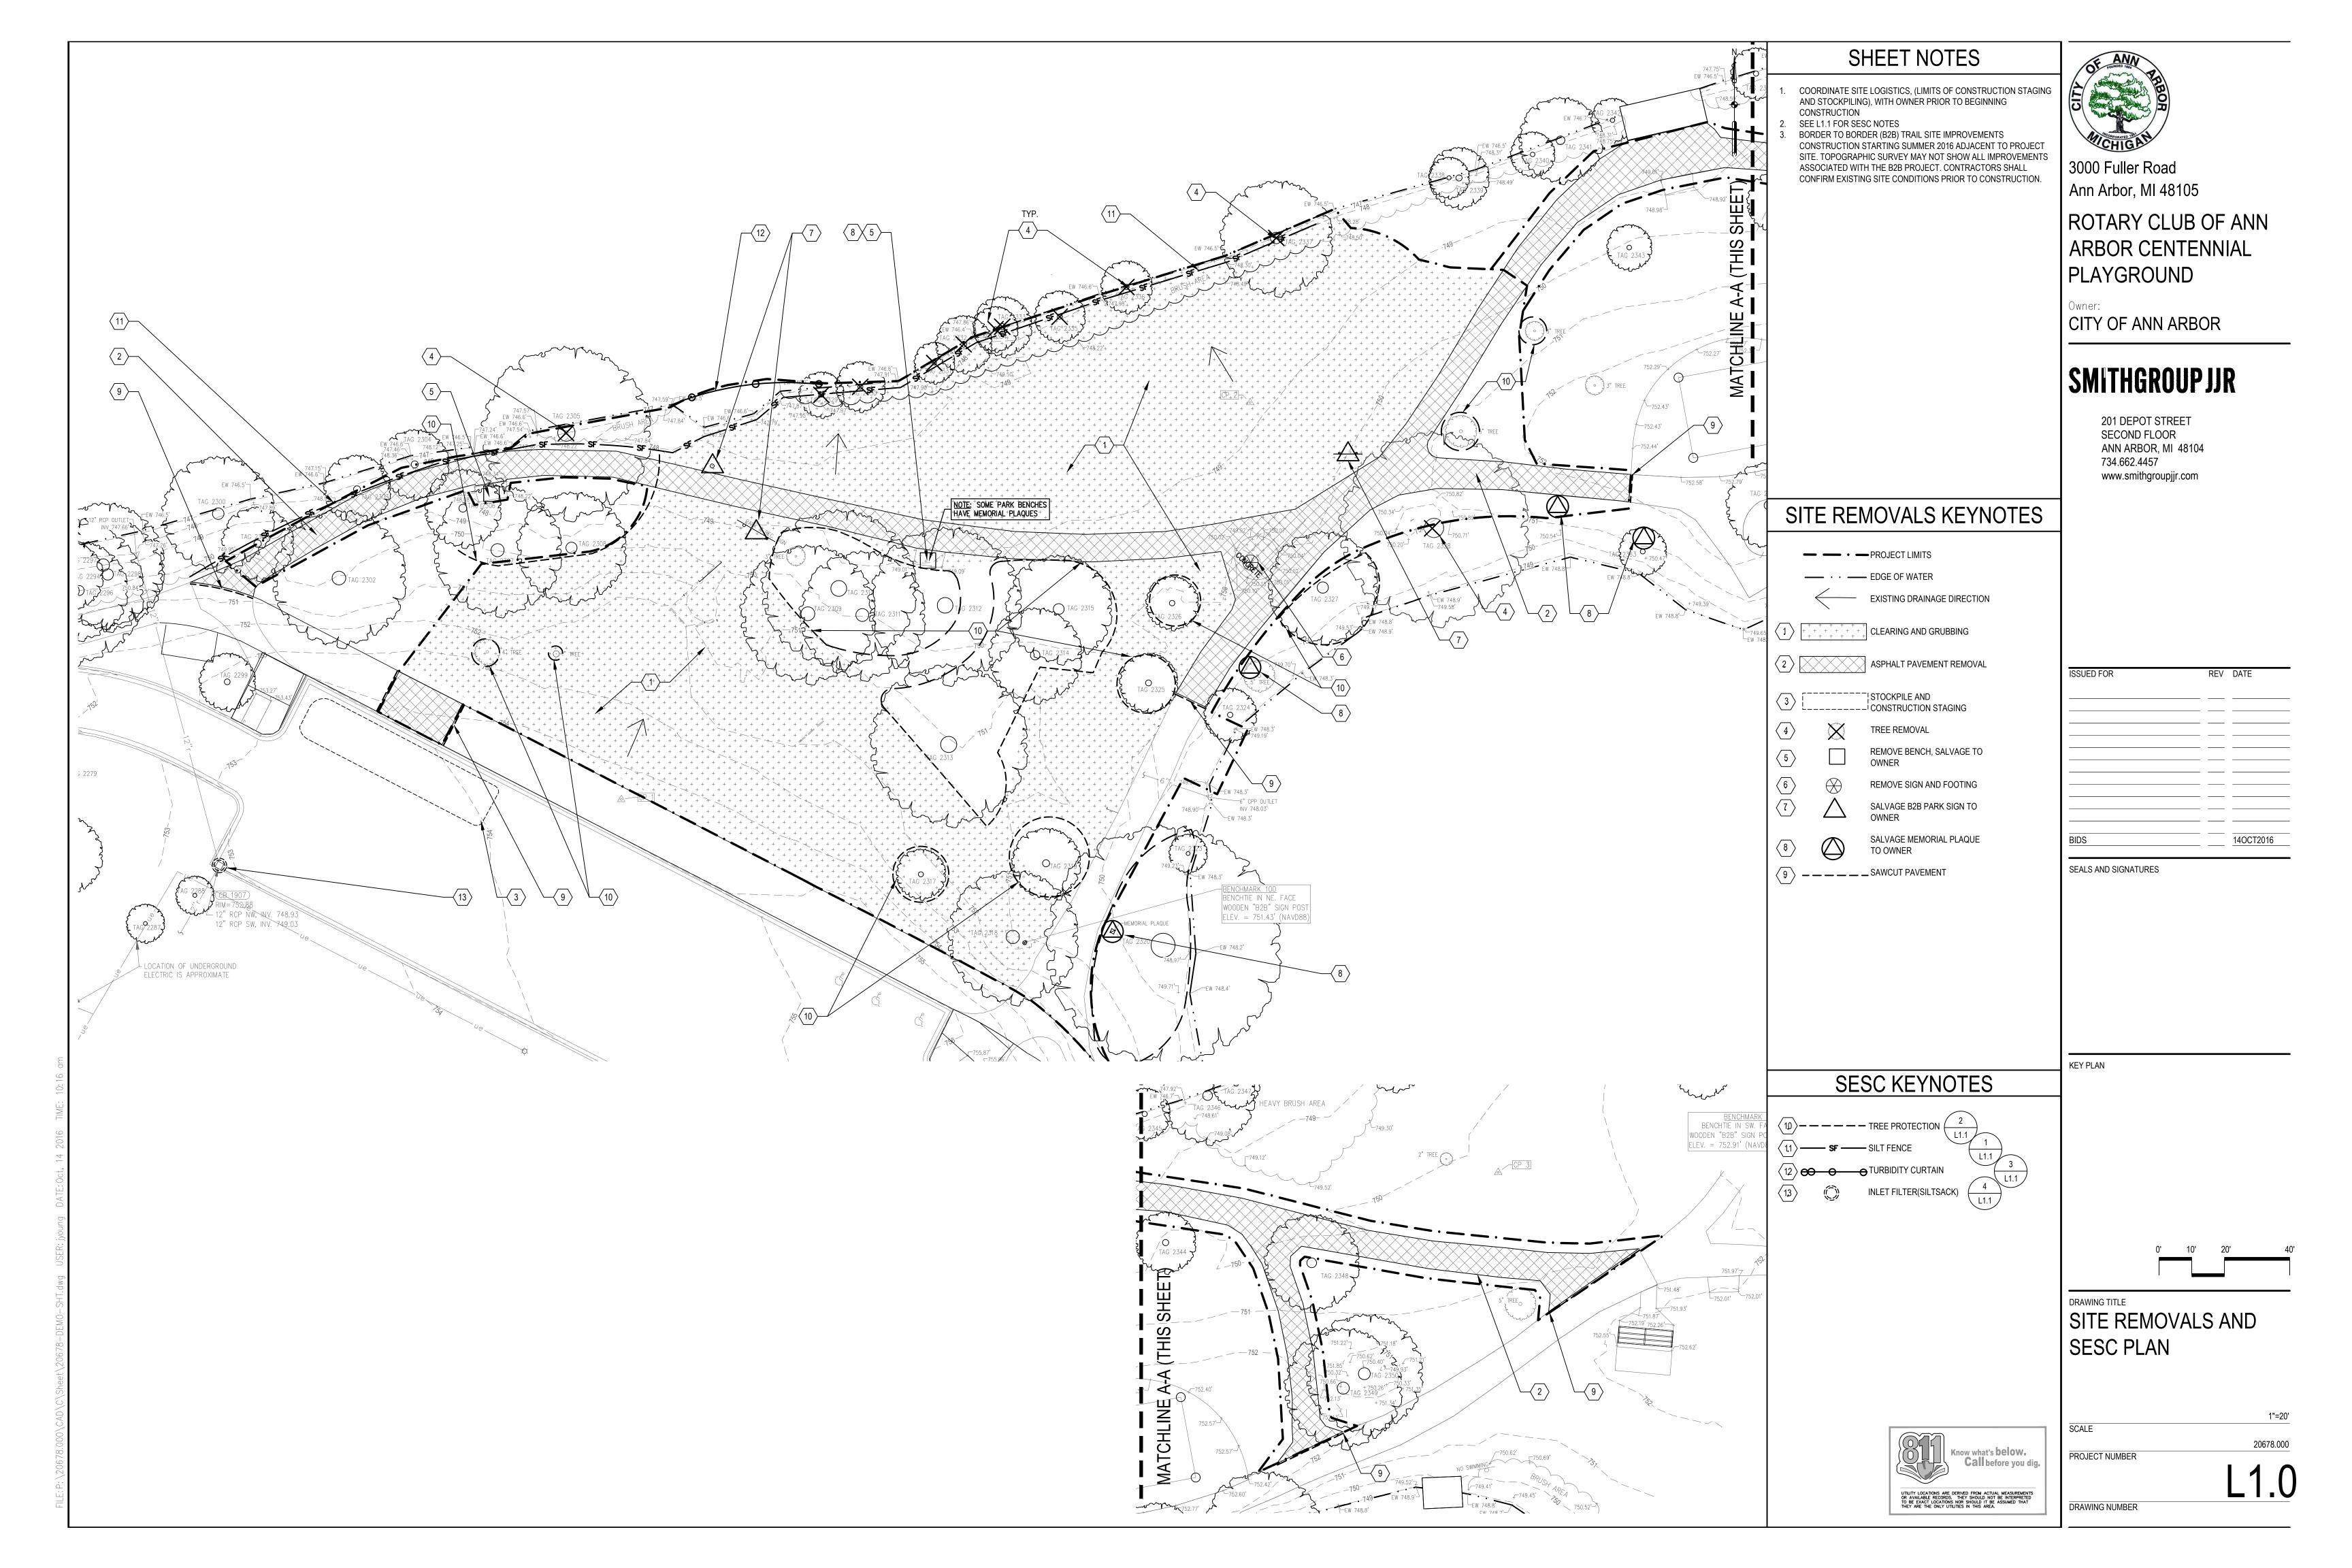

NOTIFY THE CITY OF ANN ARBOR SOIL EROSION CONTROL OFFICE 48 HOURS PRIOR TO BEGINNING WORK ON THE PROJECT. PHONE: 734-794-6265.

- 1. THE CONTRACTOR SHALL IMPLEMENT AND MAINTAIN THE SOIL EROSION CONTROL MEASURES AS SHOWN ON THE PLANS AND AS DIRECTED BY THE OWNER'S REPRESENTATIVE AT ALL TIMES DURING CONSTRUCTION. ANY MODIFICATIONS OR ADDITIONS TO THE SOIL EROSION CONTROL MEASURES DUE TO CONSTRUCTION OR CHANGED CONDITIONS SHALL BE AS DIRECTED AND APPROVED BY THE OWNER'S REPRESENTATIVE.
- 2. ALL SOIL EROSION AND SEDIMENTATION CONTROL WORK SHALL CONFORM TO THE PERMIT REQUIREMENTS OF THE CITY OF ANN ARBOR, CITY ORDINANCE CHAPTER 63, CITY OF ANN ARBOR STANDARDS DIVISION VII, THE LAWS OF THE STATE OF MICHIGAN, AND THE REQUIREMENTS OF THE CONTRACT DOCUMENTS.
- 3. DAILY, OR AFTER ANY STORM EVENT, INSPECTIONS OF EROSION CONTROL MEASURES SHALL BE MADE BY THE CONTRACTOR. PERIODIC INSPECTIONS MAY BE MADE BY THE OWNER'S REPRESENTATIVE TO DETERMINE THE EFFECTIVENESS OF EROSION AND SEDIMENTATION CONTROL MEASURES. ANY NECESSARY CORRECTIONS SHALL BE MADE WITHOUT DELAY, AND WITHOUT ADDITIONAL COST TO THE CITY OF ANN ARBOR.
- 4. EROSION AND SEDIMENTATION FROM WORK ON THE SITE SHALL BE CONTAINED ON THE SITE AND NOT BE ALLOWED TO COLLECT ON ANY OFF-SITE AREAS, ROADWAYS OR WATERWAYS.
- 5. ALL MUD/SOIL TRACKED ONTO ROADWAYS FROM THE SITE DUE TO CONSTRUCTION, SHALL BE PROMPTLY REMOVED BY THE CONTRACTOR. IF SO ORDERED, THE CONTRACTOR SHALL PROVIDE AND OPERATE A VACUUM-TYPE STREET SWEEPER, AT NO ADDITIONAL COST TO THE CITY OF ANN ARBOR, WITHIN FOUR (4) HOURS OF BEING SO ORDERED.
- 6. RESTORATION OF ALL DISTURBED AREAS, INCLUDING PLACEMENT OF TOPSOIL, SEED, FERTILIZER AND MULCH AND/OR SOD SHALL BE PERFORMED WITHIN FIVE (5) DAYS OF THE COMPLETION OF FINAL GRADE.
- 7. CONSTRUCTION OPERATIONS SHALL BE SCHEDULED AND PERFORMED SO THAT PREVENTATIVE SOIL EROSION CONTROL MEASURES ARE IN PLACE PRIOR TO EXCAVATION IN CRITICAL AREAS AND TEMPORARY STABILIZATION MEASURES ARE IN PLACE IMMEDIATELY FOLLOWING BACKFILLING OPERATIONS.
- 8. SPECIAL PRECAUTIONS WILL BE TAKEN IN THE USE OF CONSTRUCTION EQUIPMENT TO PREVENT SITUATIONS THAT PROMOTE EROSION.
- 9. PROPER DUST CONTROL SHALL BE MAINTAINED DURING CONSTRUCTION BY USE OF WATER TRUCKS AND/OR DUST PALLATIVE AS REQUIRED.
- 10. THE CONTRACTOR SHALL BE RESPONSIBLE FOR MAINTAINING ALL TEMPORARY SOIL EROSION CONTROL MEASURES AND REMOVAL OF SOME MEASURES UPON AUTHORIZED COMPLETION OF THE PROJECT. FINAL COMPLETION OF PROJECT WILL NOT BE AUTHORIZED UNTIL ALL SITE WORK AND UTILITY CONSTRUCTION IS COMPLETE AND ALL SOILS ARE STABILIZED.
- 11. THE CONTRACTOR SHALL NOT GRADE INTO ADJACENT PROPERTIES. SILT AND PROTECTIVE FENCE SHALL BE INSTALLED AND MAINTAINED TO PREVENT GRADING, EROSION AND SEDIMENTATION INTO THE ADJACENT PROPERTIES.
- 12. TREE PROTECTION FENCING MUST REMAIN INTACT UNTIL RESTORATION OF THE SITE IS COMPLETE.

SEQUENCE OF EROSION CONTROL MEASURES:

1. THE CONTRACTOR IS TO SUBMIT TO THE OWNER'S REPRESENTATIVE, A SEQUENCE OF CONSTRUCTION WITH RESPECT TO THE SOIL EROSION CONTROL MEASURES FOR REVIEW, COMMENT AND APPROVAL. THIS SCHEDULE IS TO INCLUDE INSPECTION AND REPAIR OF ALL TEMPORARY EROSION CONTROL MEASURES DAILY AND WITHIN 24 HOURS OF A STORM EVENT.

SAMPLE SOIL EROSION AND SEDIMENTATION CONTROL INSTALLATION MINIMUM REQUIREMENTS:

- INSTALL SILT FENCE, TREE PROTECTION FENCING, TURBIDITY CURTAIN, INLET FILTERS ON EXISTING DRAINAGE FEATURES, AND ALL OTHER TEMPORARY SOIL EROSION CONTROLS, PRIOR TO ANY CLEARING OR EARTH MOVING OPERATION.
- 1.2. REMOVE VEGETATION, TREES AND BRUSH, PAVEMENT, STRUCTURES AND PLAY SURFACE/SAND PER SITE REMOVALS AND SESC PLAN. REMOVE ALL TOPSOIL, ORGANIC MATTER, AND DELETERIOUS MATERIALS. STOCKPILE TOPSOIL AS NECESSARY FOR REUSE. STABILIZE STOCKPILE AS REQUIRED.
- 1.3. DISPOSE OF ALL EXCESS AND UNUSABLE MATERIALS OFFSITE IN A LEGAL MANNER. NO BURN OR BURY PITS ALLOWED.
- 1.4. PERFORM MASS GRADING OPERATIONS.
- 1.5. INSTALL WALLS, UTILITIES, AND PLAY STRUCTURES
- 1.6. CONTINUALLY MAINTAIN EROSION AND SEDIMENTATION CONTROL MEASURES, AS REQUIRED TO ALLOW DRAINAGE AND SEDIMENT REMOVAL. REMOVE ANY ACCUMULATED SEDIMENT IMMEDIATELY.
- 1.7. COMPLETE ALL DETENTION GRADING.
- 1.8. INSTALL SITE PAVING AND PLAY SURFACE.
- 1.9. APPLY TOPSOIL AND FINISH GRADE AREAS THAT HAVE BEEN GRADED AND STABILIZE WITH TEMPORARY MEASURES. PERMANENT SEED MIXES TO BE INSTALLED WITHIN 5 DAYS OF COMPLETING FINAL GRADING.
- 1.10. TEMPORARY SEED AND INSTALL EROSION CONTROL BLANKET IN ALL DISTURBED
- 1.11. REFER TO LANDSCAPE PLANTING PLANS FOR PERMANENT SITE STABILIZATION.
- 1.12. REMEDY ANY NOTED DEFECTS TO THE SATISFACTION OF THE CITY OF ANN ARBOR'S SOIL EROSION AND SEDIMENTATION CONTROL OFFICIAL.
- 1.13. ALL TEMP. SOIL EROSION CONTROL MEASURES MUST BE REMOVED, WITH OWNER'S REPRESENTATIVES APPROVAL, PRIOR TO FINAL INSPECTION

NOTE: THIS SEQUENCE IS FOR INFORMATION ONLY. IT IS INTENDED TO SHOW THE SEQUENCE OF CONSTRUCTION WITH RESPECT TO THE SOIL EROSION AND SEDIMENTATION CONTROL MEASURES. THE CONTRACTOR IS RESPONSIBLE FOR SUBMITTING THEIR OWN DETAILED CONSTRUCTION SEQUENCE AND SCHEDULE TO THE OWNER'S REPRESENTATIVE FOR REVIEW, COMMENT, AND APPROVAL.

TEMPORARY SEEDING:

- 1. SEED IN ACCORDANCE WITH PROJECT DRAWINGS AND SPECIFICATIONS.
- 2. ANY DISTURBED AREA NOT PAVED, SEEDED, MULCHED, SODDED OR BUILT UPON BY NOVEMBER 15TH OR JUNE 30TH IS TO BE TEMPORARILY STABILIZED PER SPECIFICATIONS.

THE ESTIMATED COST OF SOIL EROSION AND SEDIMENTATION CONTROL MEASURES = \$2,100

ESTIMATE OF EXCAVATION AND FILL FROM EXISTING TO FINAL GRADE:

IMPERVIOUS PROJECT AREA

EXCAVATION = 150 CY, FILL = 600 CY

ON SITE SOILS PER THE USDA SOIL SURVEY OF WASHTENAW COUNTY, MICHIGAN:

- BnB BOYER LOAMY SAND, 1% 6% SLOPES, WELL DRAINED, IN TERRACES AND MORRAINES


5,431 ft2 - CONCRETE PAVEMENT/SIDEWALK = 0.125 AC


11,1756 ft2 - TOTAL IMPERVIOUS PROJECT AREA = 0.270 AC

TOTAL AREA OF PROPOSED DISTURBANCE = 0.703 AC

6,275 ft2 - POURED IN PLACE RUBBER PLAY SURFACE = 0.144 AC

SILT FENCE WaA - WASEPI SANDY LOAM, 0% - 4% SLOPES, SOMEWHAT POORLY DRAINED, IN DRAINAGEWAYS ON VALLEY TRAINS, STRAND PLAINS, LAKE PLAINS, AND DELTAS.

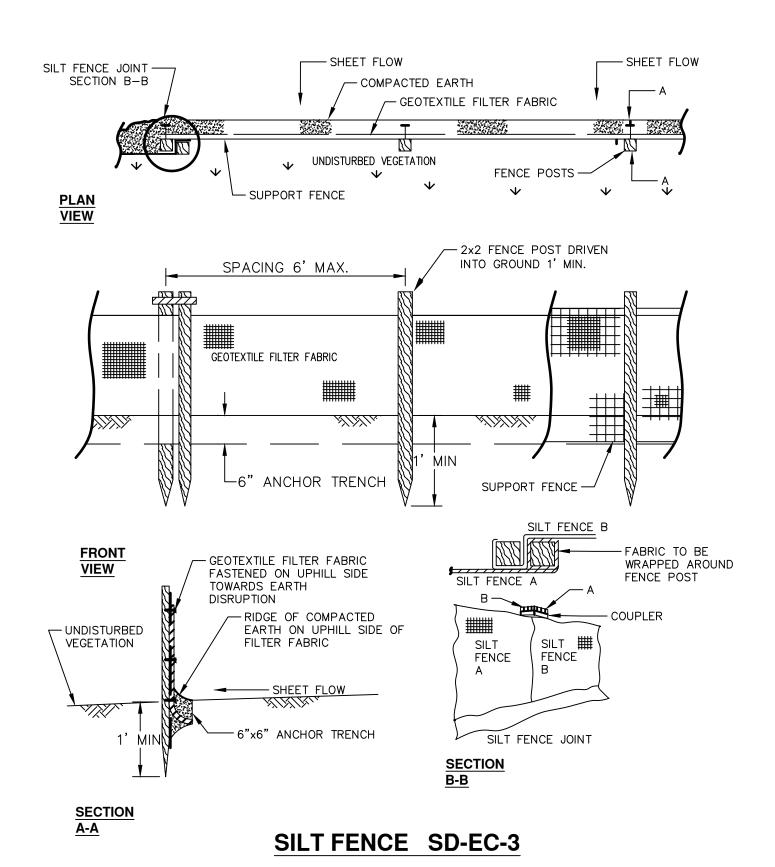

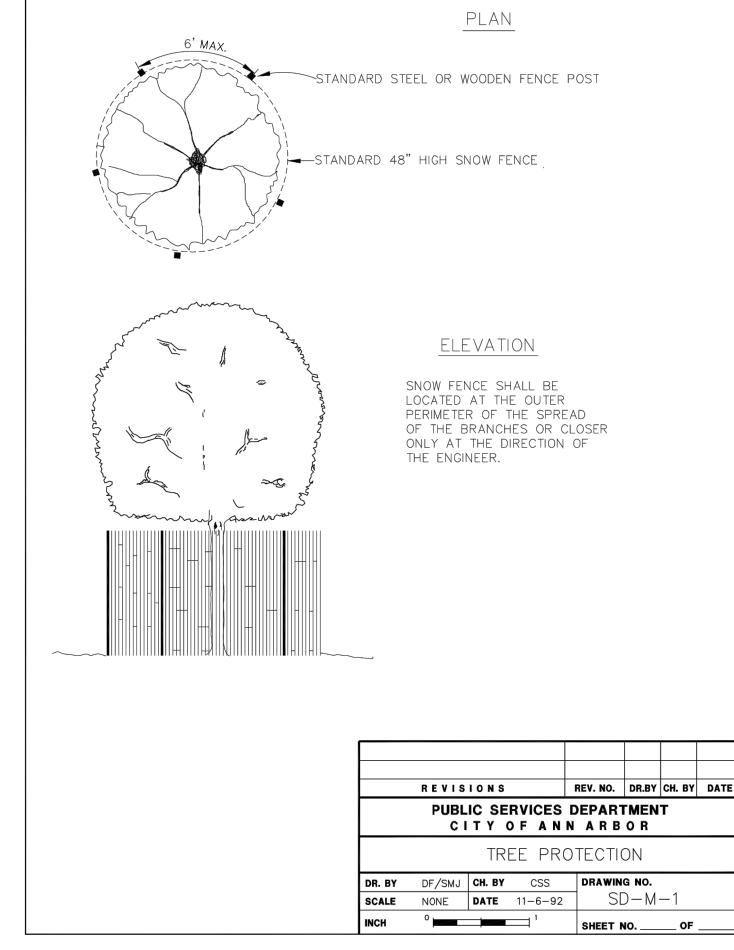

TREE PROTECTION

SEALS AND SIGNATURES

14OCT2016

20678.000

3000 Fuller Road

Ann Arbor, MI 48105

PLAYGROUND

ROTARY CLUB OF ANN

ARBOR CENTENNIAL

CITY OF ANN ARBOR

201 DEPOT STREET

ANN ARBOR, MI 48104

www.smithgroupjjr.com

SECOND FLOOR

734.662.4457

KEY PLAN

ASTM D-4491 200 GAL/MIN/SQ FT ASTM D-4491 OIL-ABSORBANT SILTSACK (FOR AREAS WHERE THERE IS A CONCERN FOR OIL RUN-OFF OR SPILLS)

REGULAR FLOW SILTSACK

<u>PROPERTIES</u>

GRAB TENSILE ELONGATION

APPARENT OPENING SIZE

HI-FLOW SILTSACK

GRAB TENSILE ELONGATION

APPARENT OPENING SIZE

MULLEN BURST

UV RESISTANCE

FLOW RATE

PERMITTIVITY

PUNCTURE

TRAPEZOID TEAR

UV RESISTANCE

TRAPEZOID TEAR

(FOR AREAS OF LOW TO MODERATE PRECIPITATION AND RUN-OFF)

(FOR AREAS OF MODERATE TO HEAVY PRECIPITATION AND RUN-OFF)

REQUIRED VALUE

ASTM D-4632 ASTM D-4833

ASTM D-3786

ASTM D-4533

ASTM D-4355

ASTM D-4751

ASTM D-4491

REQUIRED VALUE

ASTM D-4632

ASTM D-4833

ASTM D-3786

ASTM D-4533

ASTM D-4355

ASTM D-4751

TEST METHOD

80% 40 US SIEVE

40 GAL/MIN/SQ FT 0.55 SEC -1

135 LBS

420 PSI

20 US SIEVE


IT IS THE INTENT OF THE PLANS AND SPECIFICATIONS THAT THE CONTRACTOR INSTALL THE REBAR AS SHOWN IN THIS DETAIL PROVIDE A FULLY FUNCTIONING UNIT. ALL COSTS ASSOCIATED WITH FURNISHING, CLEANING AS MANY TIMES AS REQUIRED, DISPOSAL

NEEDED IS INCLUDED IN THE ITEM OF WORK AND WILL NOT BE PAID FOR SEPARATELY.

INLET FILTER(SILTSACK)

DRAWING TITLE SESC DETAILS AND **NOTES**

AS NOTED Know what's **below.** PROJECT NUMBER Call before you dig DRAWING NUMBER

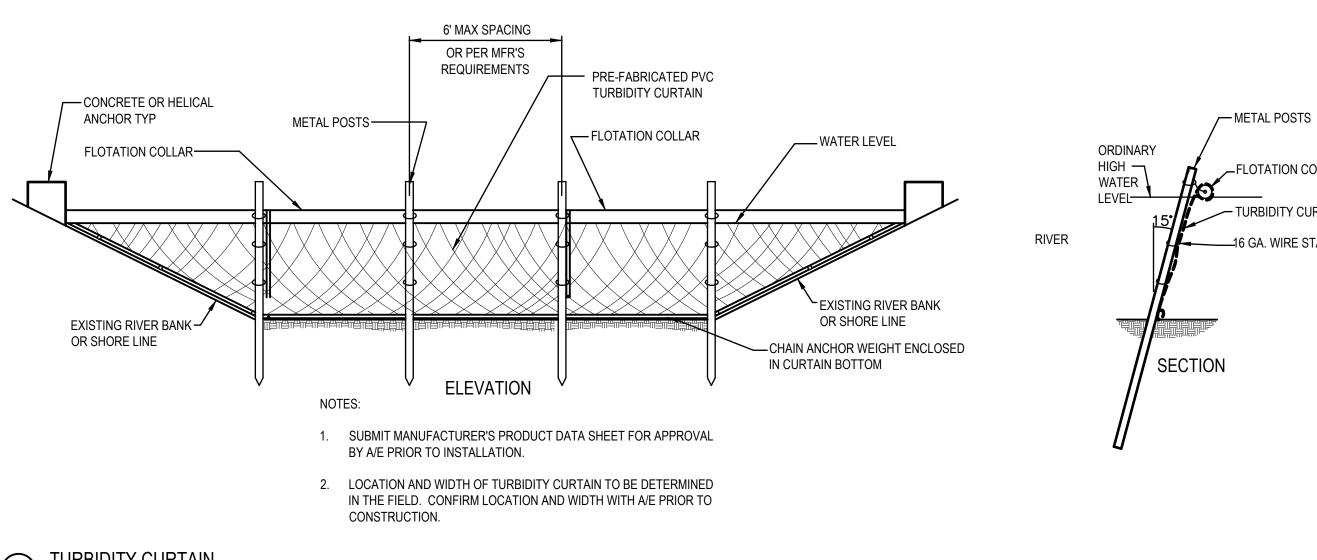


NOTE: THE SILTSACK WILL BE MANUFACTURED FROM A WOVEN POLYPROPYLENE FABRIC THAT MEETS OR EXCEEDS THE FOLLOWING SPECIFICATIONS. - CURB OPENING 1" RFBAR FOR BAG REMOVAL FROM INLET OPTIONAL OVERFLOW -SILTSACK -DUMP LOOPS (REBAR -NOT INCLUDED) SIDE VIEW INSTALLED **INSTALLATION DETAIL**


TURBIDITY CURTAIN EXISTING SHORELINE/ —16 GA. WIRE STAYS WORK AREA


-FLOTATION COLLAR

TURBIDITY CURTAIN

1" = 1/2'

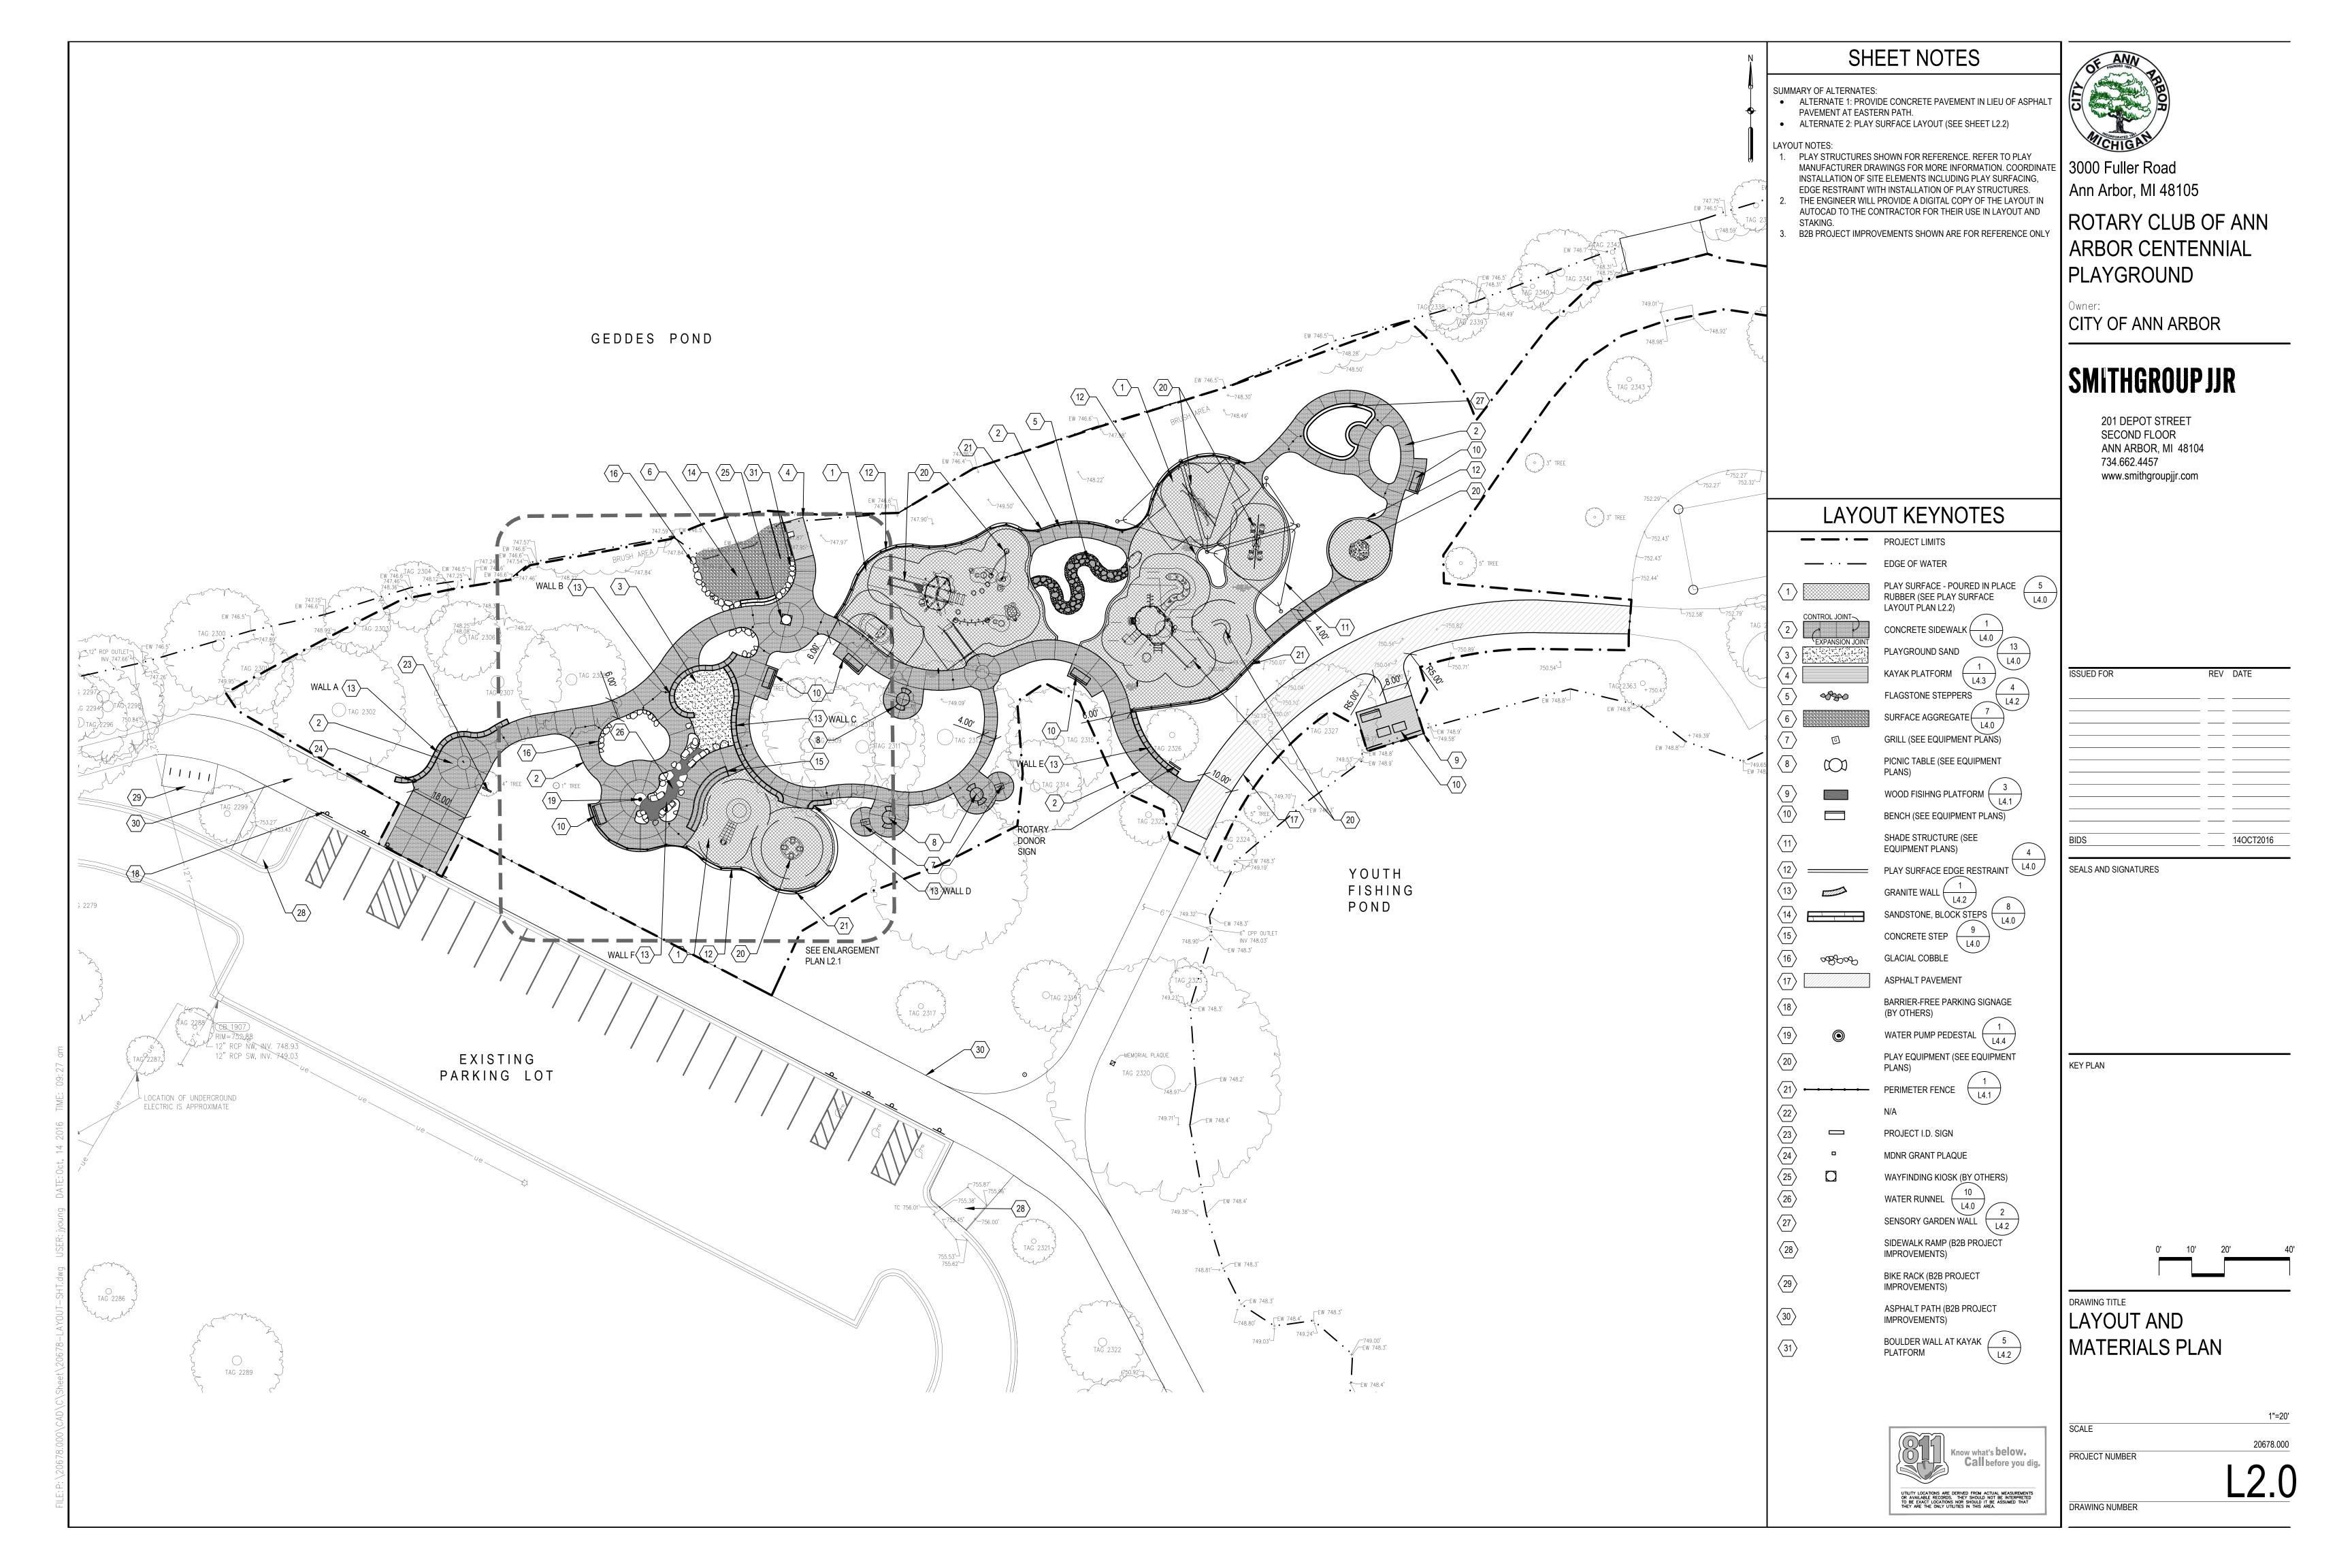

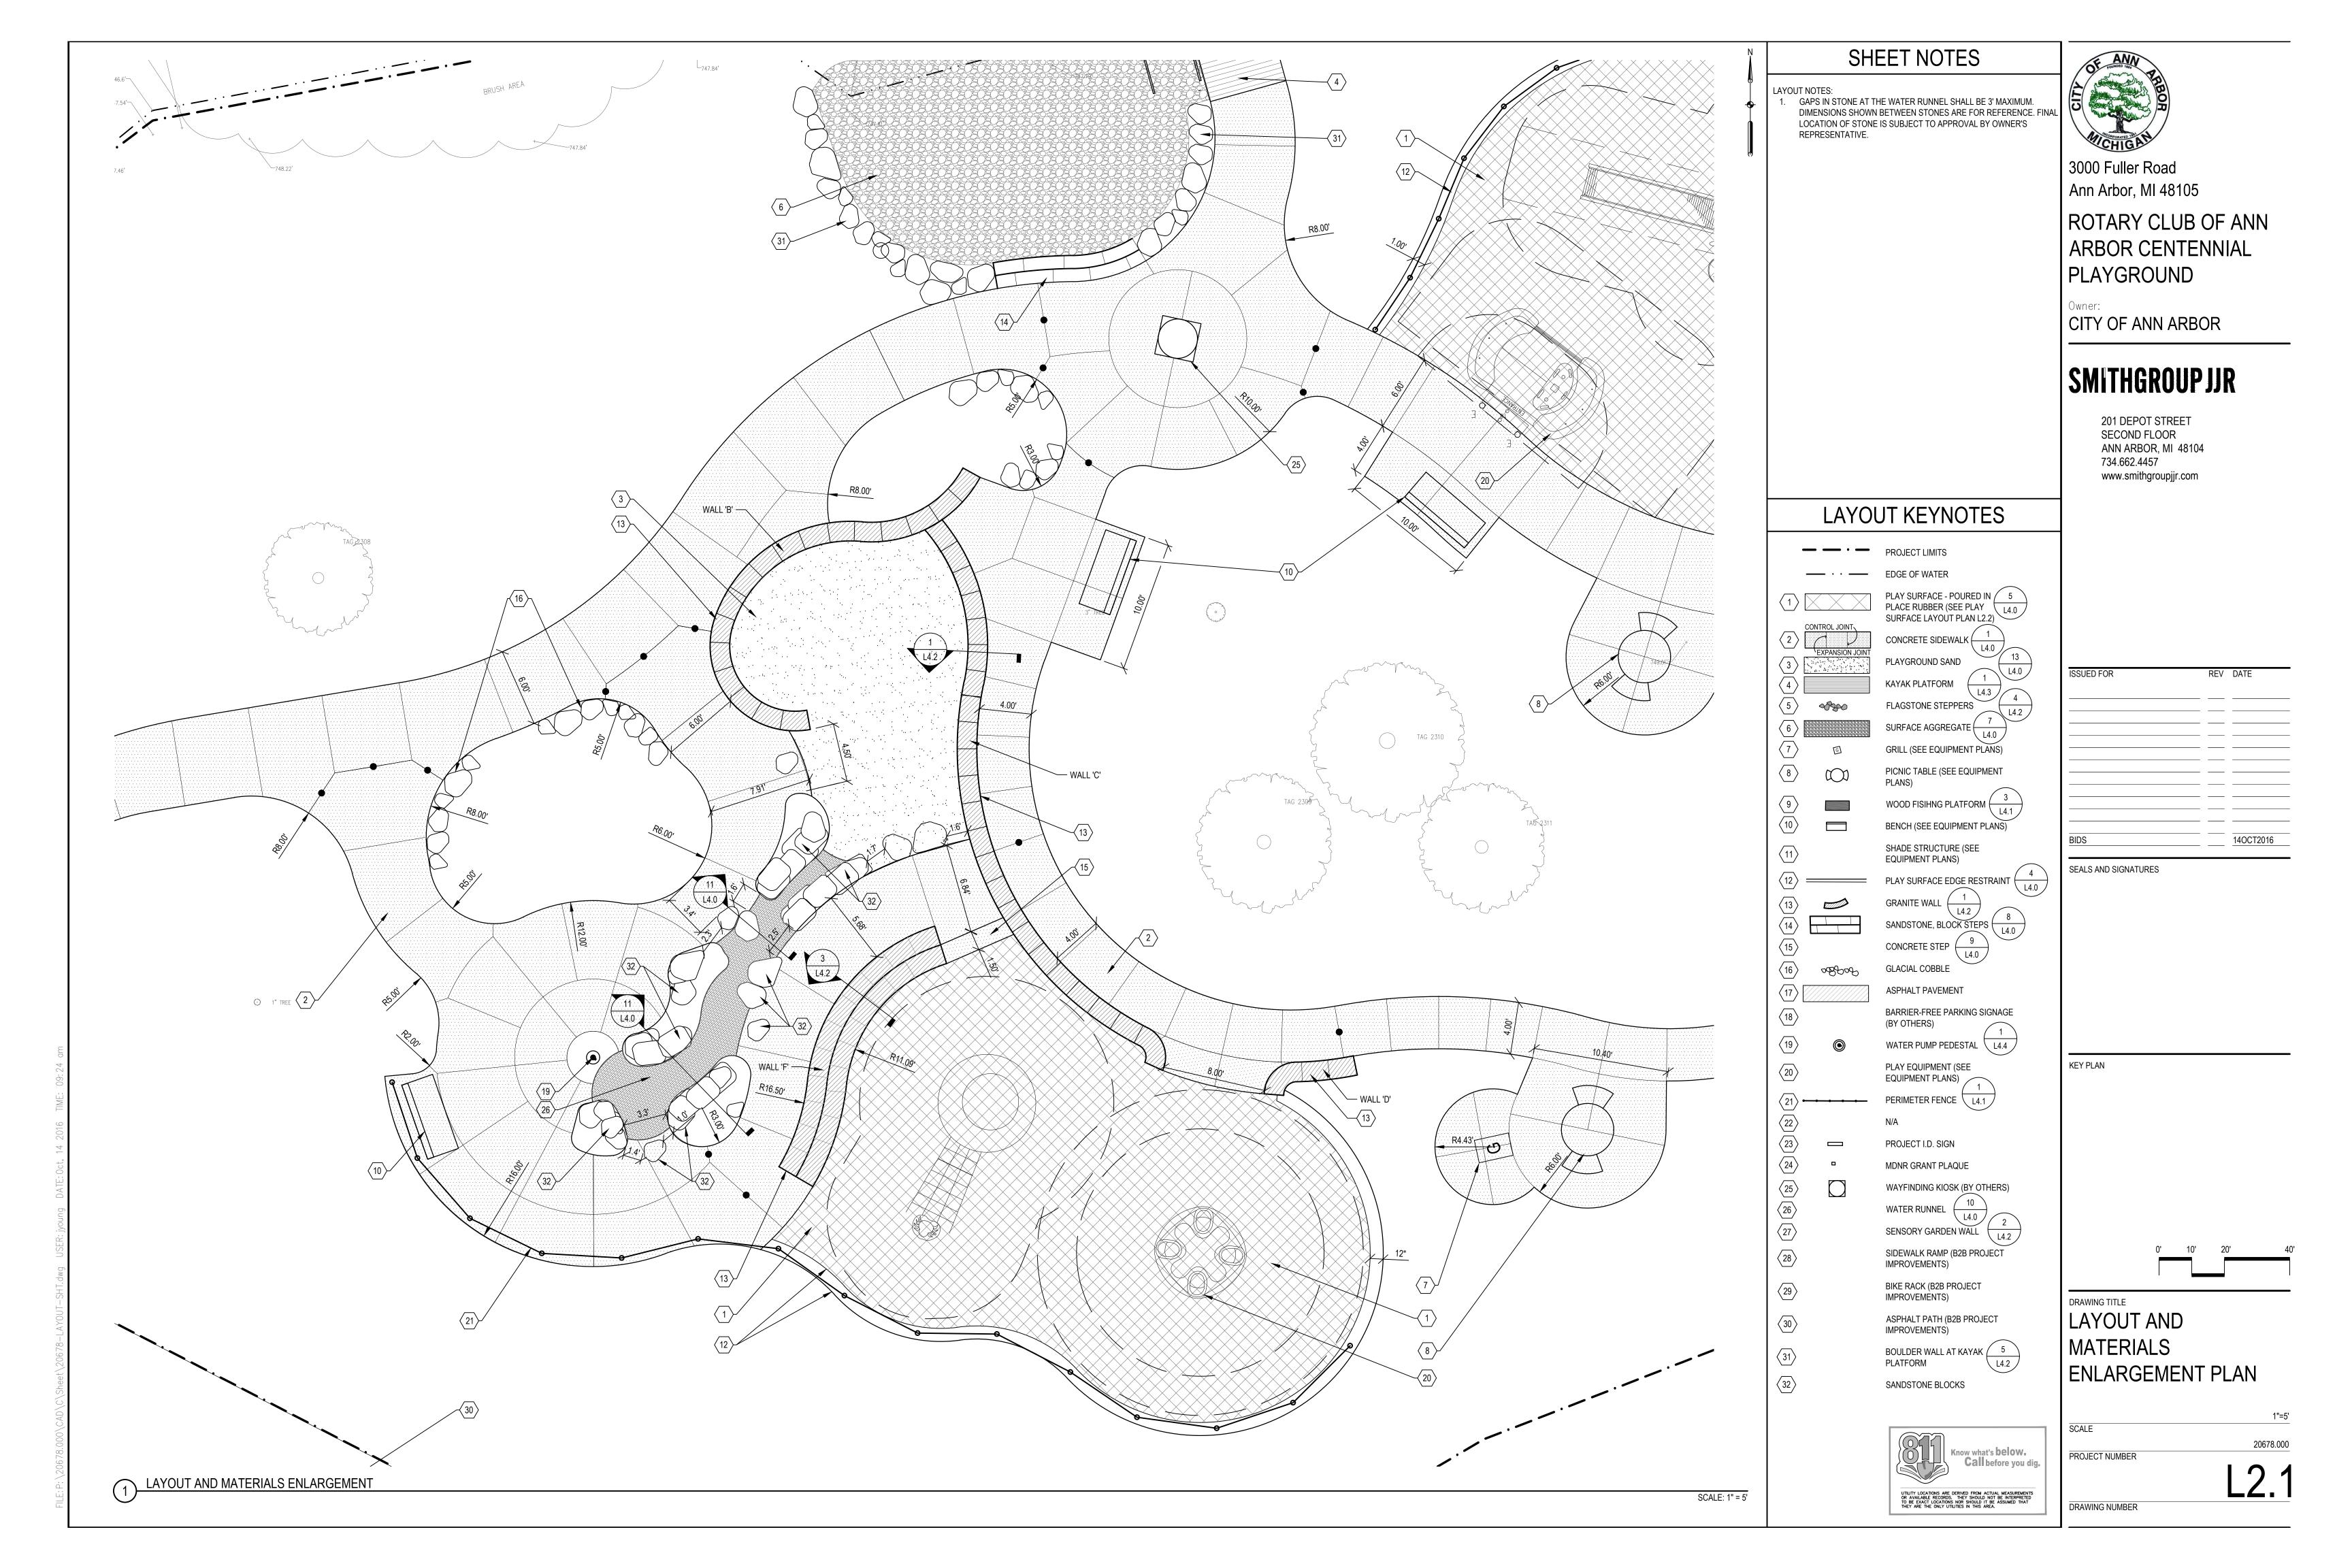

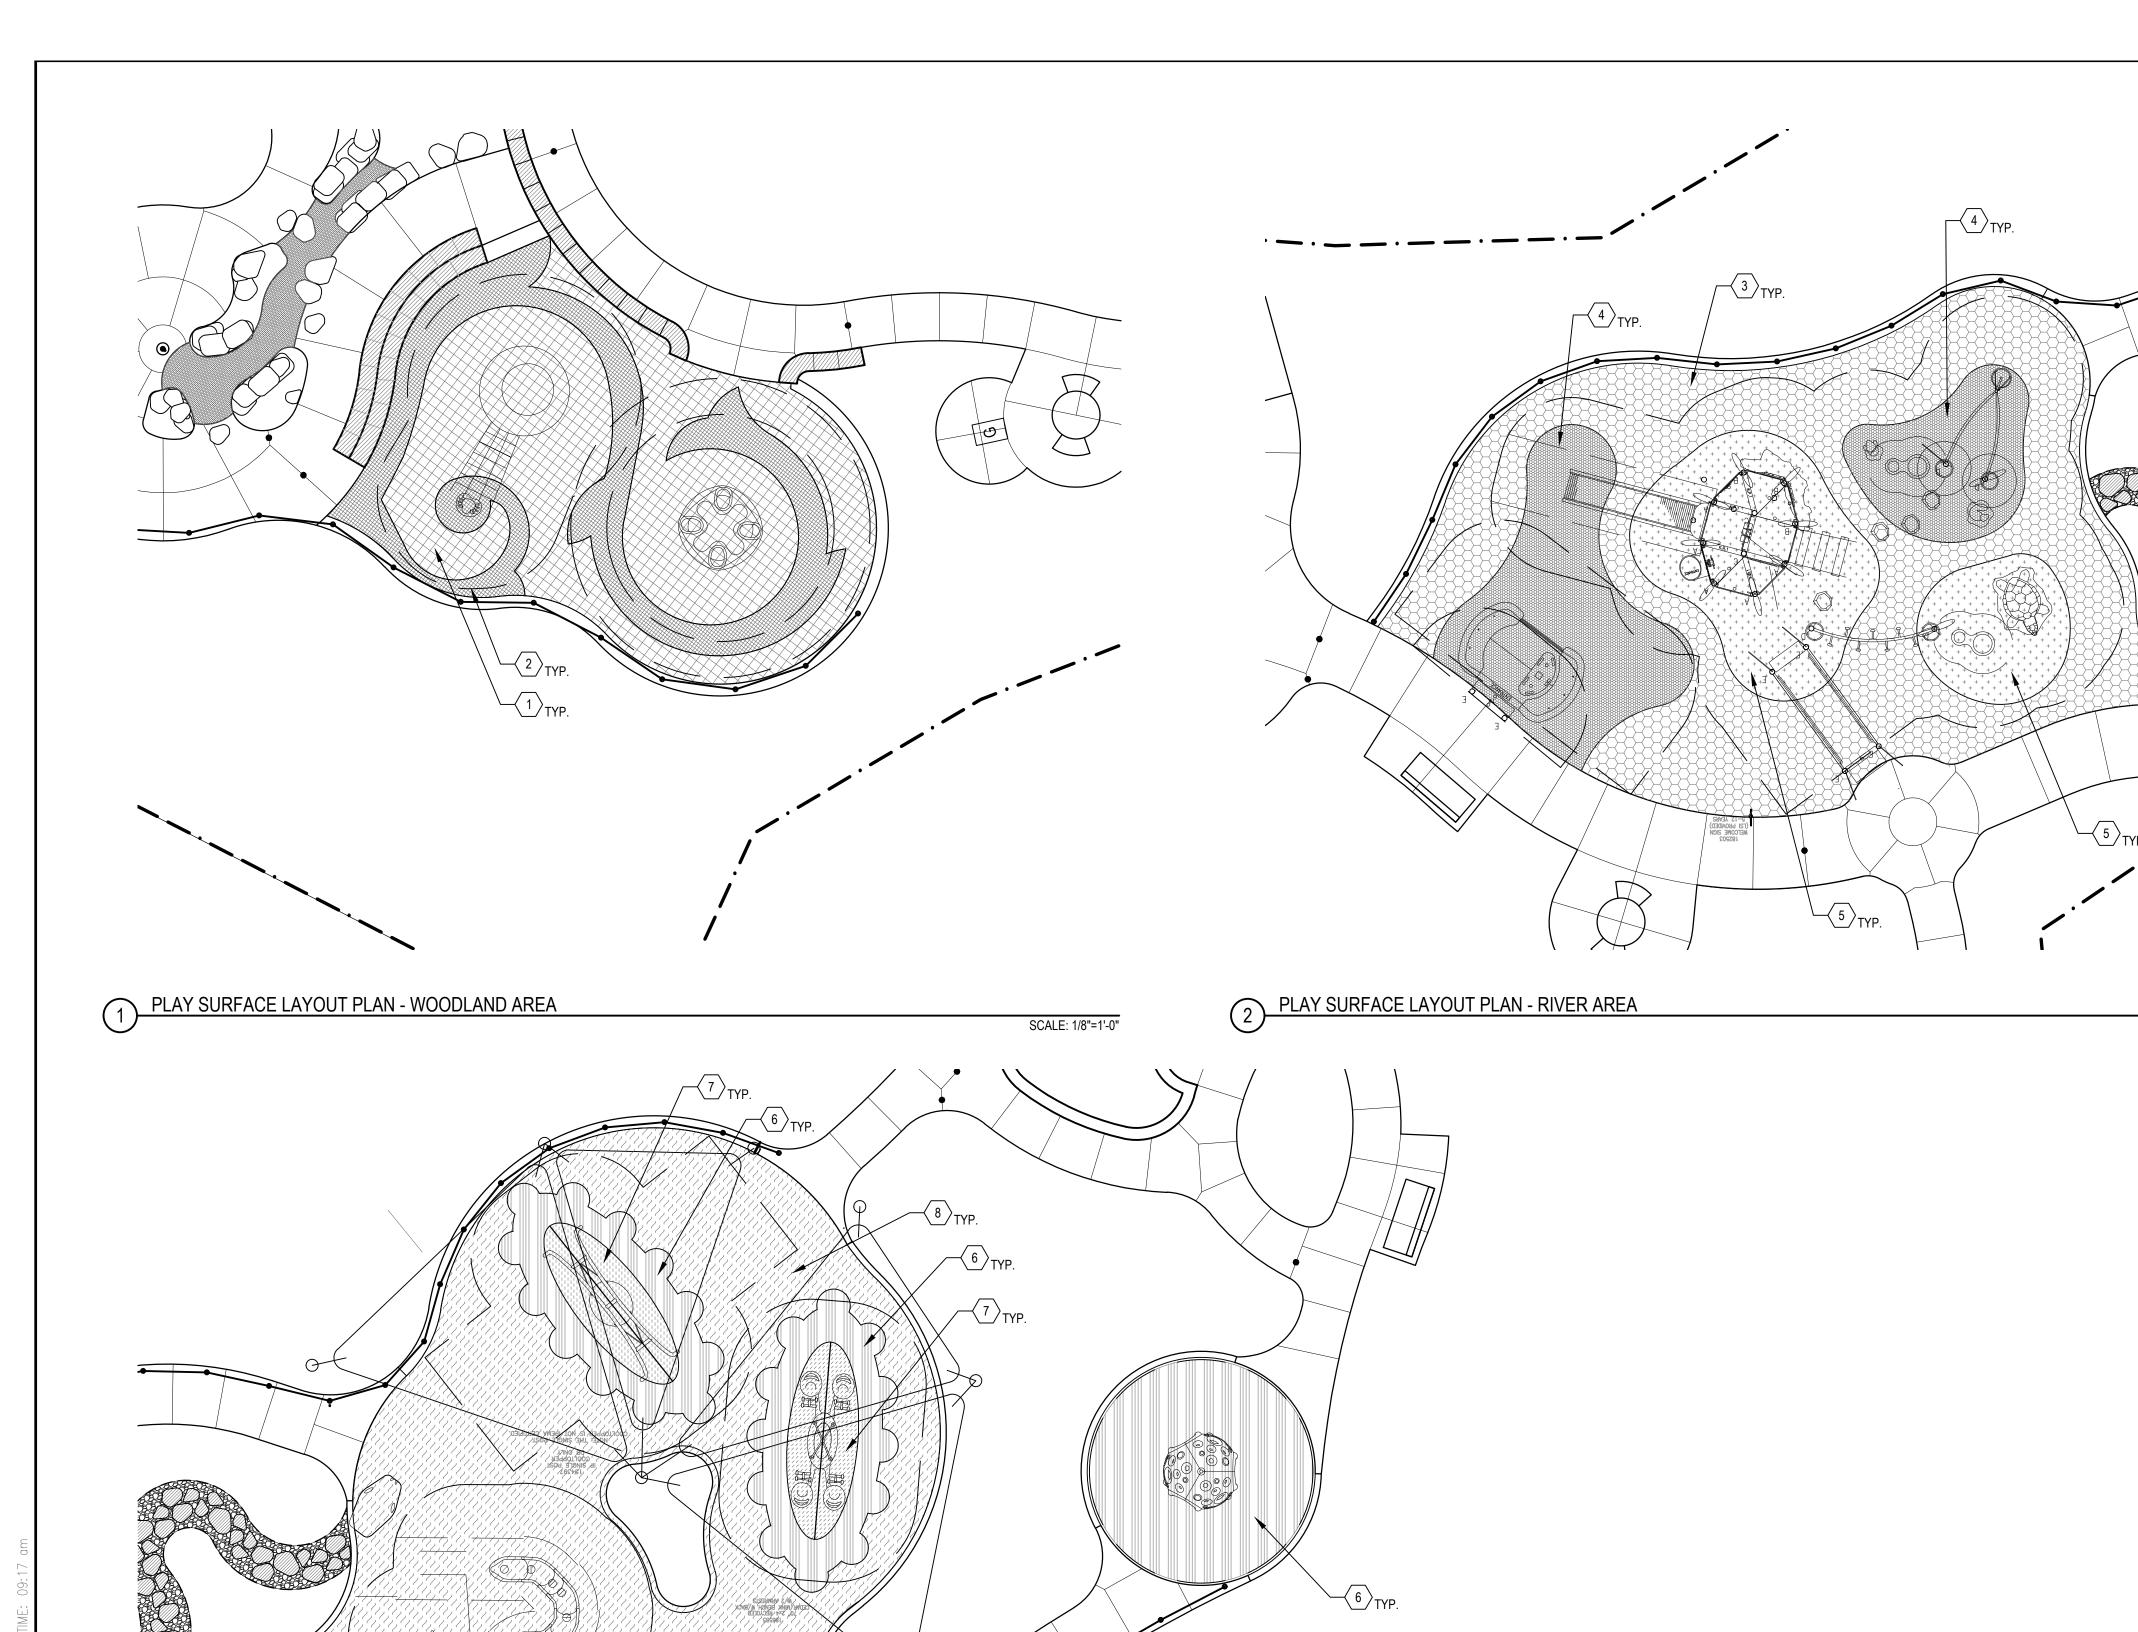

SHEET NOTES

- PLAY STRUCTURES SHOWN FOR REFERENCE. REFER TO PLAY MANUFACTURER DRAWINGS FOR MORE INFORMATION. COORDINAT INSTALLATION OF SITE ELEMENTS INCLUDING PLAY SURFACING, EDGE RESTRAINT WITH INSTALLATION OF PLAY STRUCTURES.
- THE ENGINEER WILL PROVIDE A DIGITAL COPY OF THE LAYOUT IN AUTOCAD TO THE CONTRACTOR FOR THEIR USE IN LAYOUT AND
- REFER TO DETAIL 5 PLAY SURFACE POURED IN PLACE RUBBER ON SHEET L4.0 FOR PLAY SURFACE THICKNESS FOR EACH AREA. ALTERNATE NO. 2: IN LIEU OF MULTIPLE COLORED PLAY SURFACE AREAS AS DEPICTED ON THIS PLAN, PROVIDE THE FOLLOWING:

- ONE COLOR FOR WOODLAND PLAY AREA

- TWO COLORS FOR RIVER AREA -TWO COLORS FOR PRAIRIE AREA IF ALTERNATE NO. 2 IS SELECTED, SUBMIT COLOR SAMPLES FOR PLAY SURFACING FOR OWNER COLOR SELECTION.



3000 Fuller Road Ann Arbor, MI 48105

ROTARY CLUB OF ANN ARBOR CENTENNIAL PLAYGROUND

CITY OF ANN ARBOR

SMITHGROUPJJR

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PLAY SURFACE KEYNOTES

1	PLAY SURFACE COLOR A - LIGHT BLUE
2	PLAY SURFACE COLOR B - LIGHT GREE
(3)	PLAY SURFACE COLOR C - BLUE
4	PLAY SURFACE COLOR D - DARK BLUE
5	PLAY SURFACE COLOR E - GRAY/BEIGE
6	PLAY SURFACE COLOR F - YELLOW/GO
7	PLAY SURFACE COLOR G - ORANGE
(8) [333333333]	PLAY SURFACE COLOR H - GOLD

SCALE: 1/8" = 1'-0"


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SEALS AND SIGNATURES		


KEY PLAN


DRAWING TITLE PLAY SURFACE


LAYOUT


	1" = 10
SCALE	
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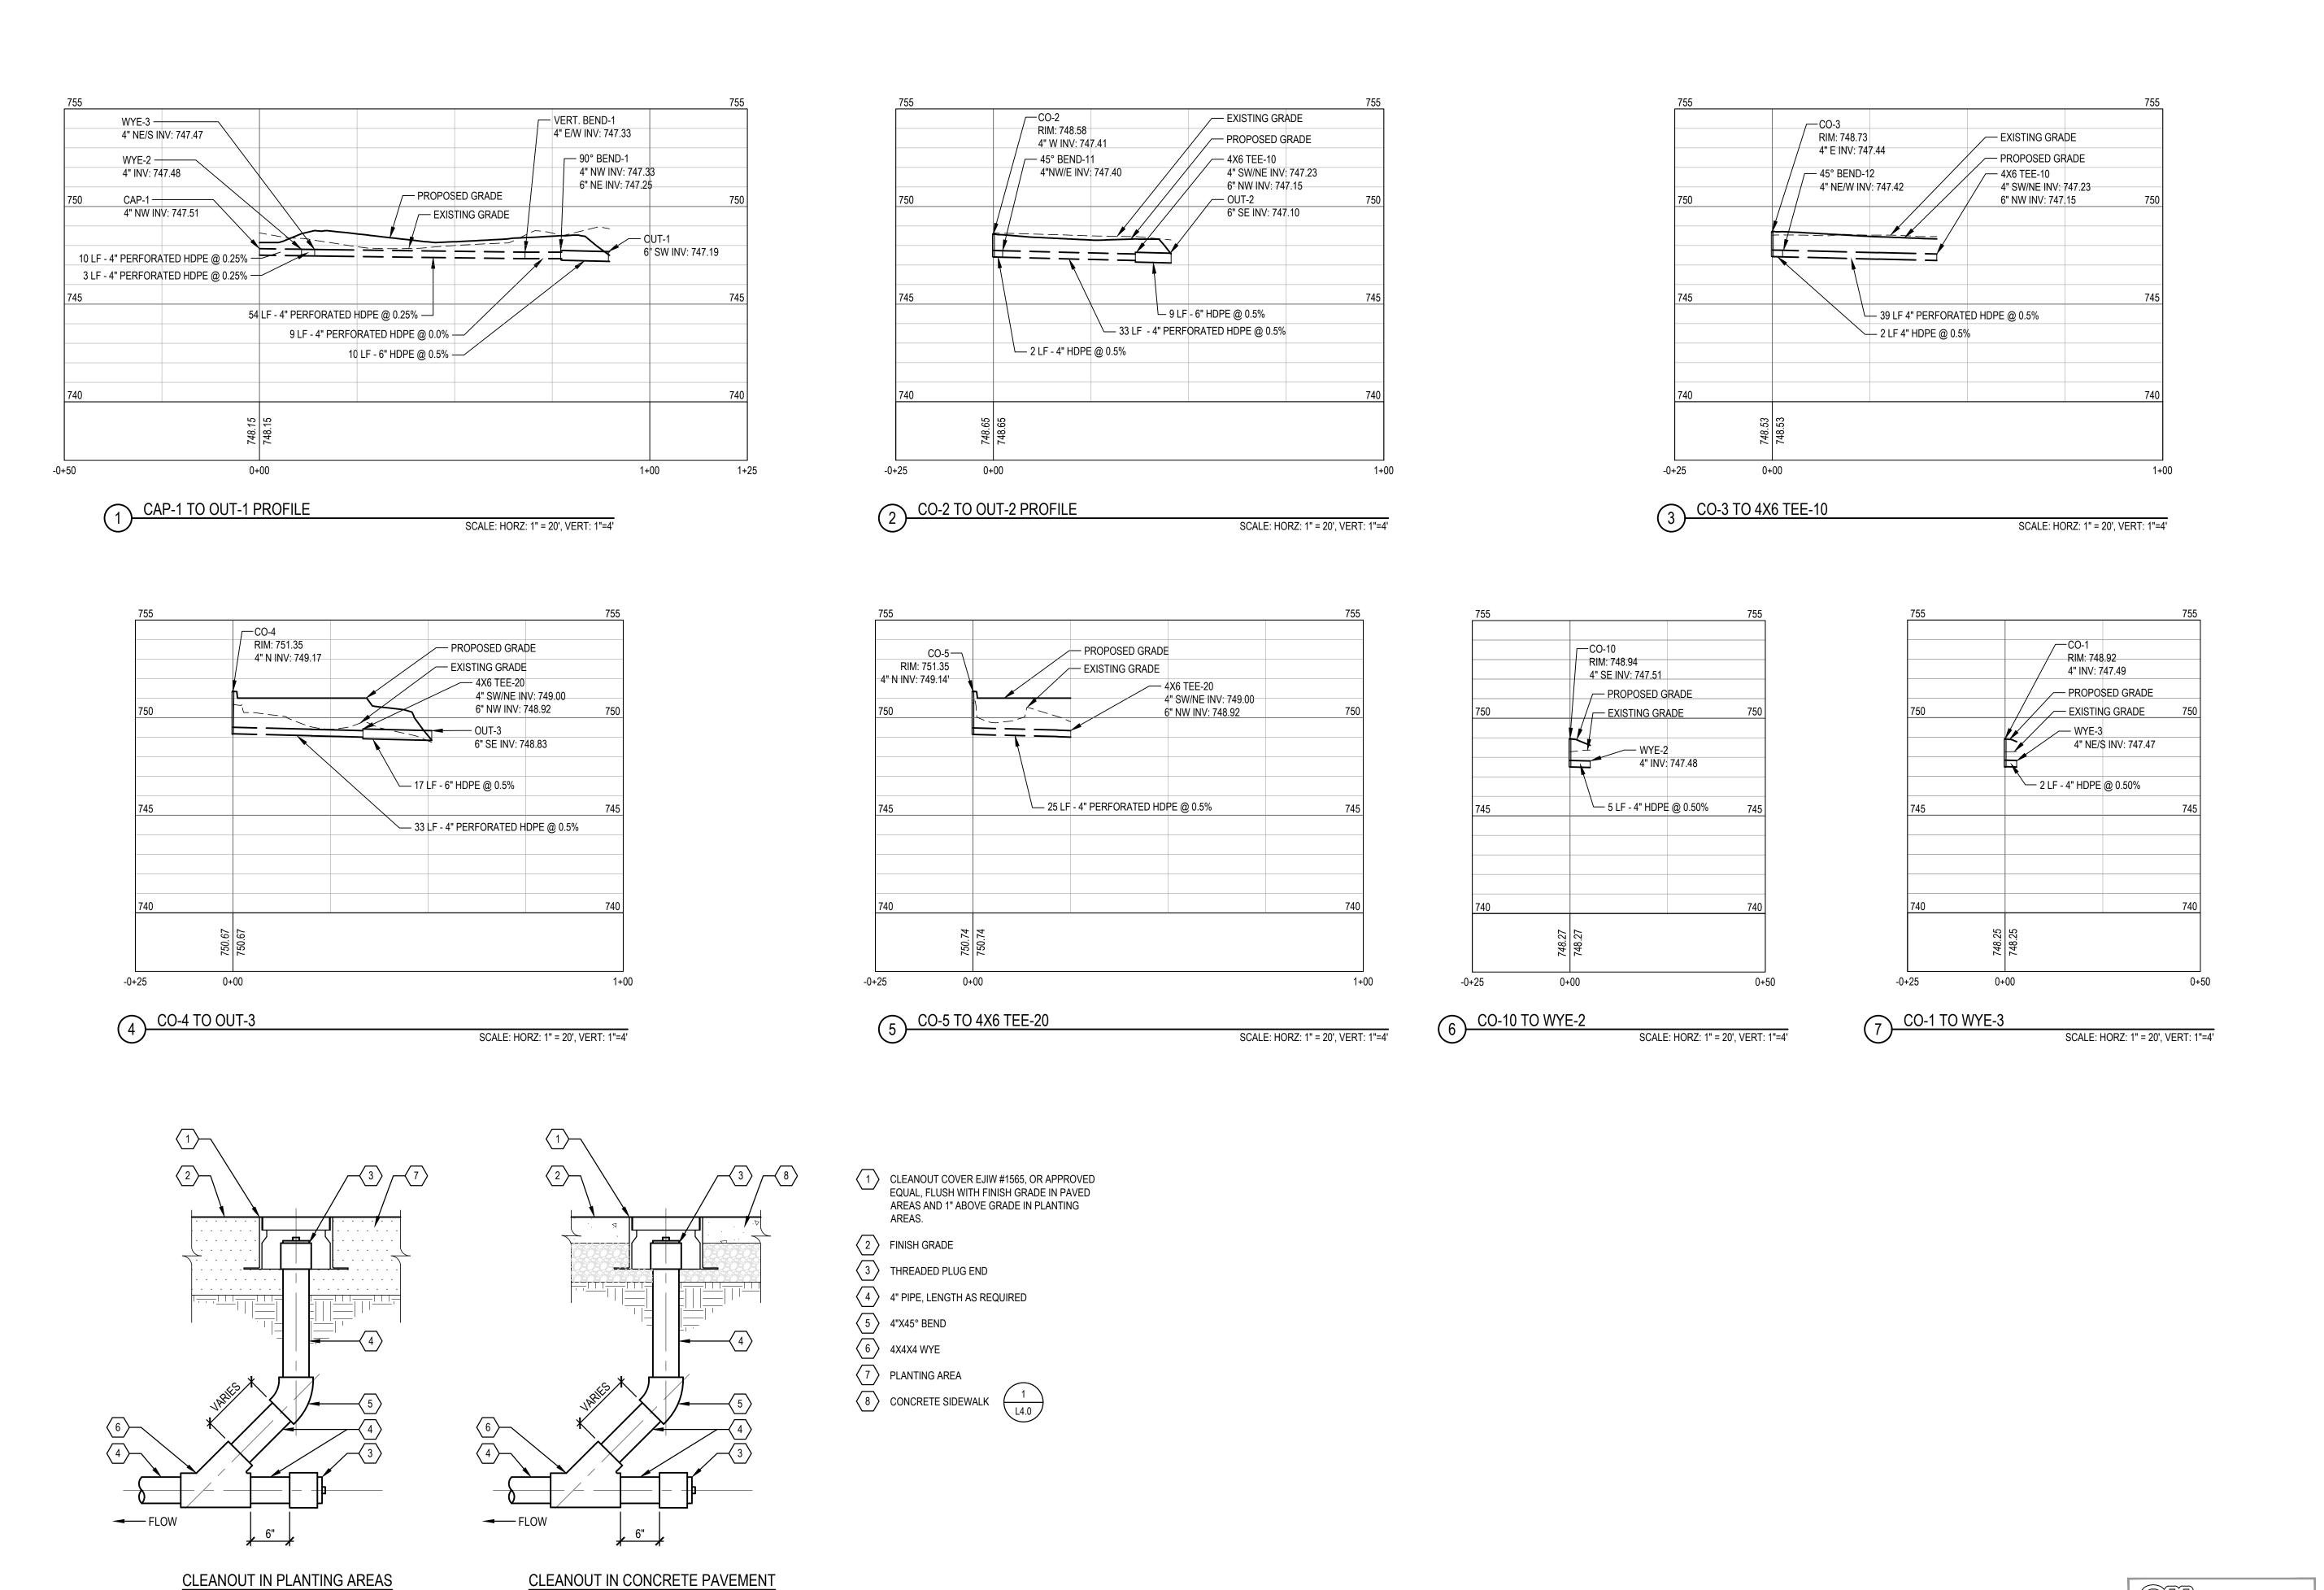


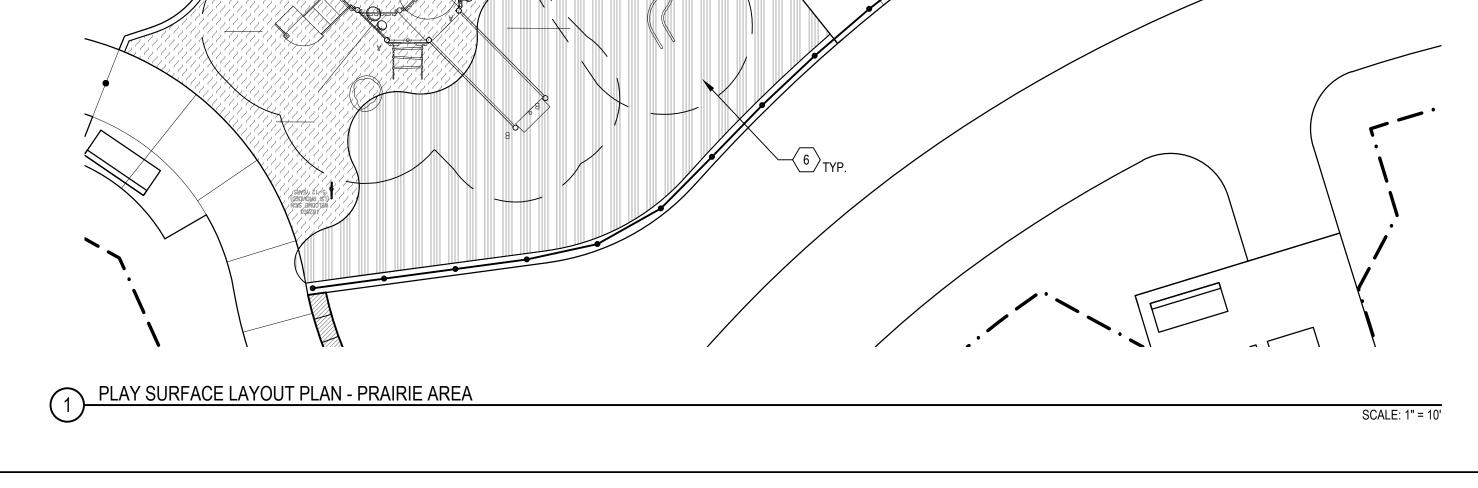

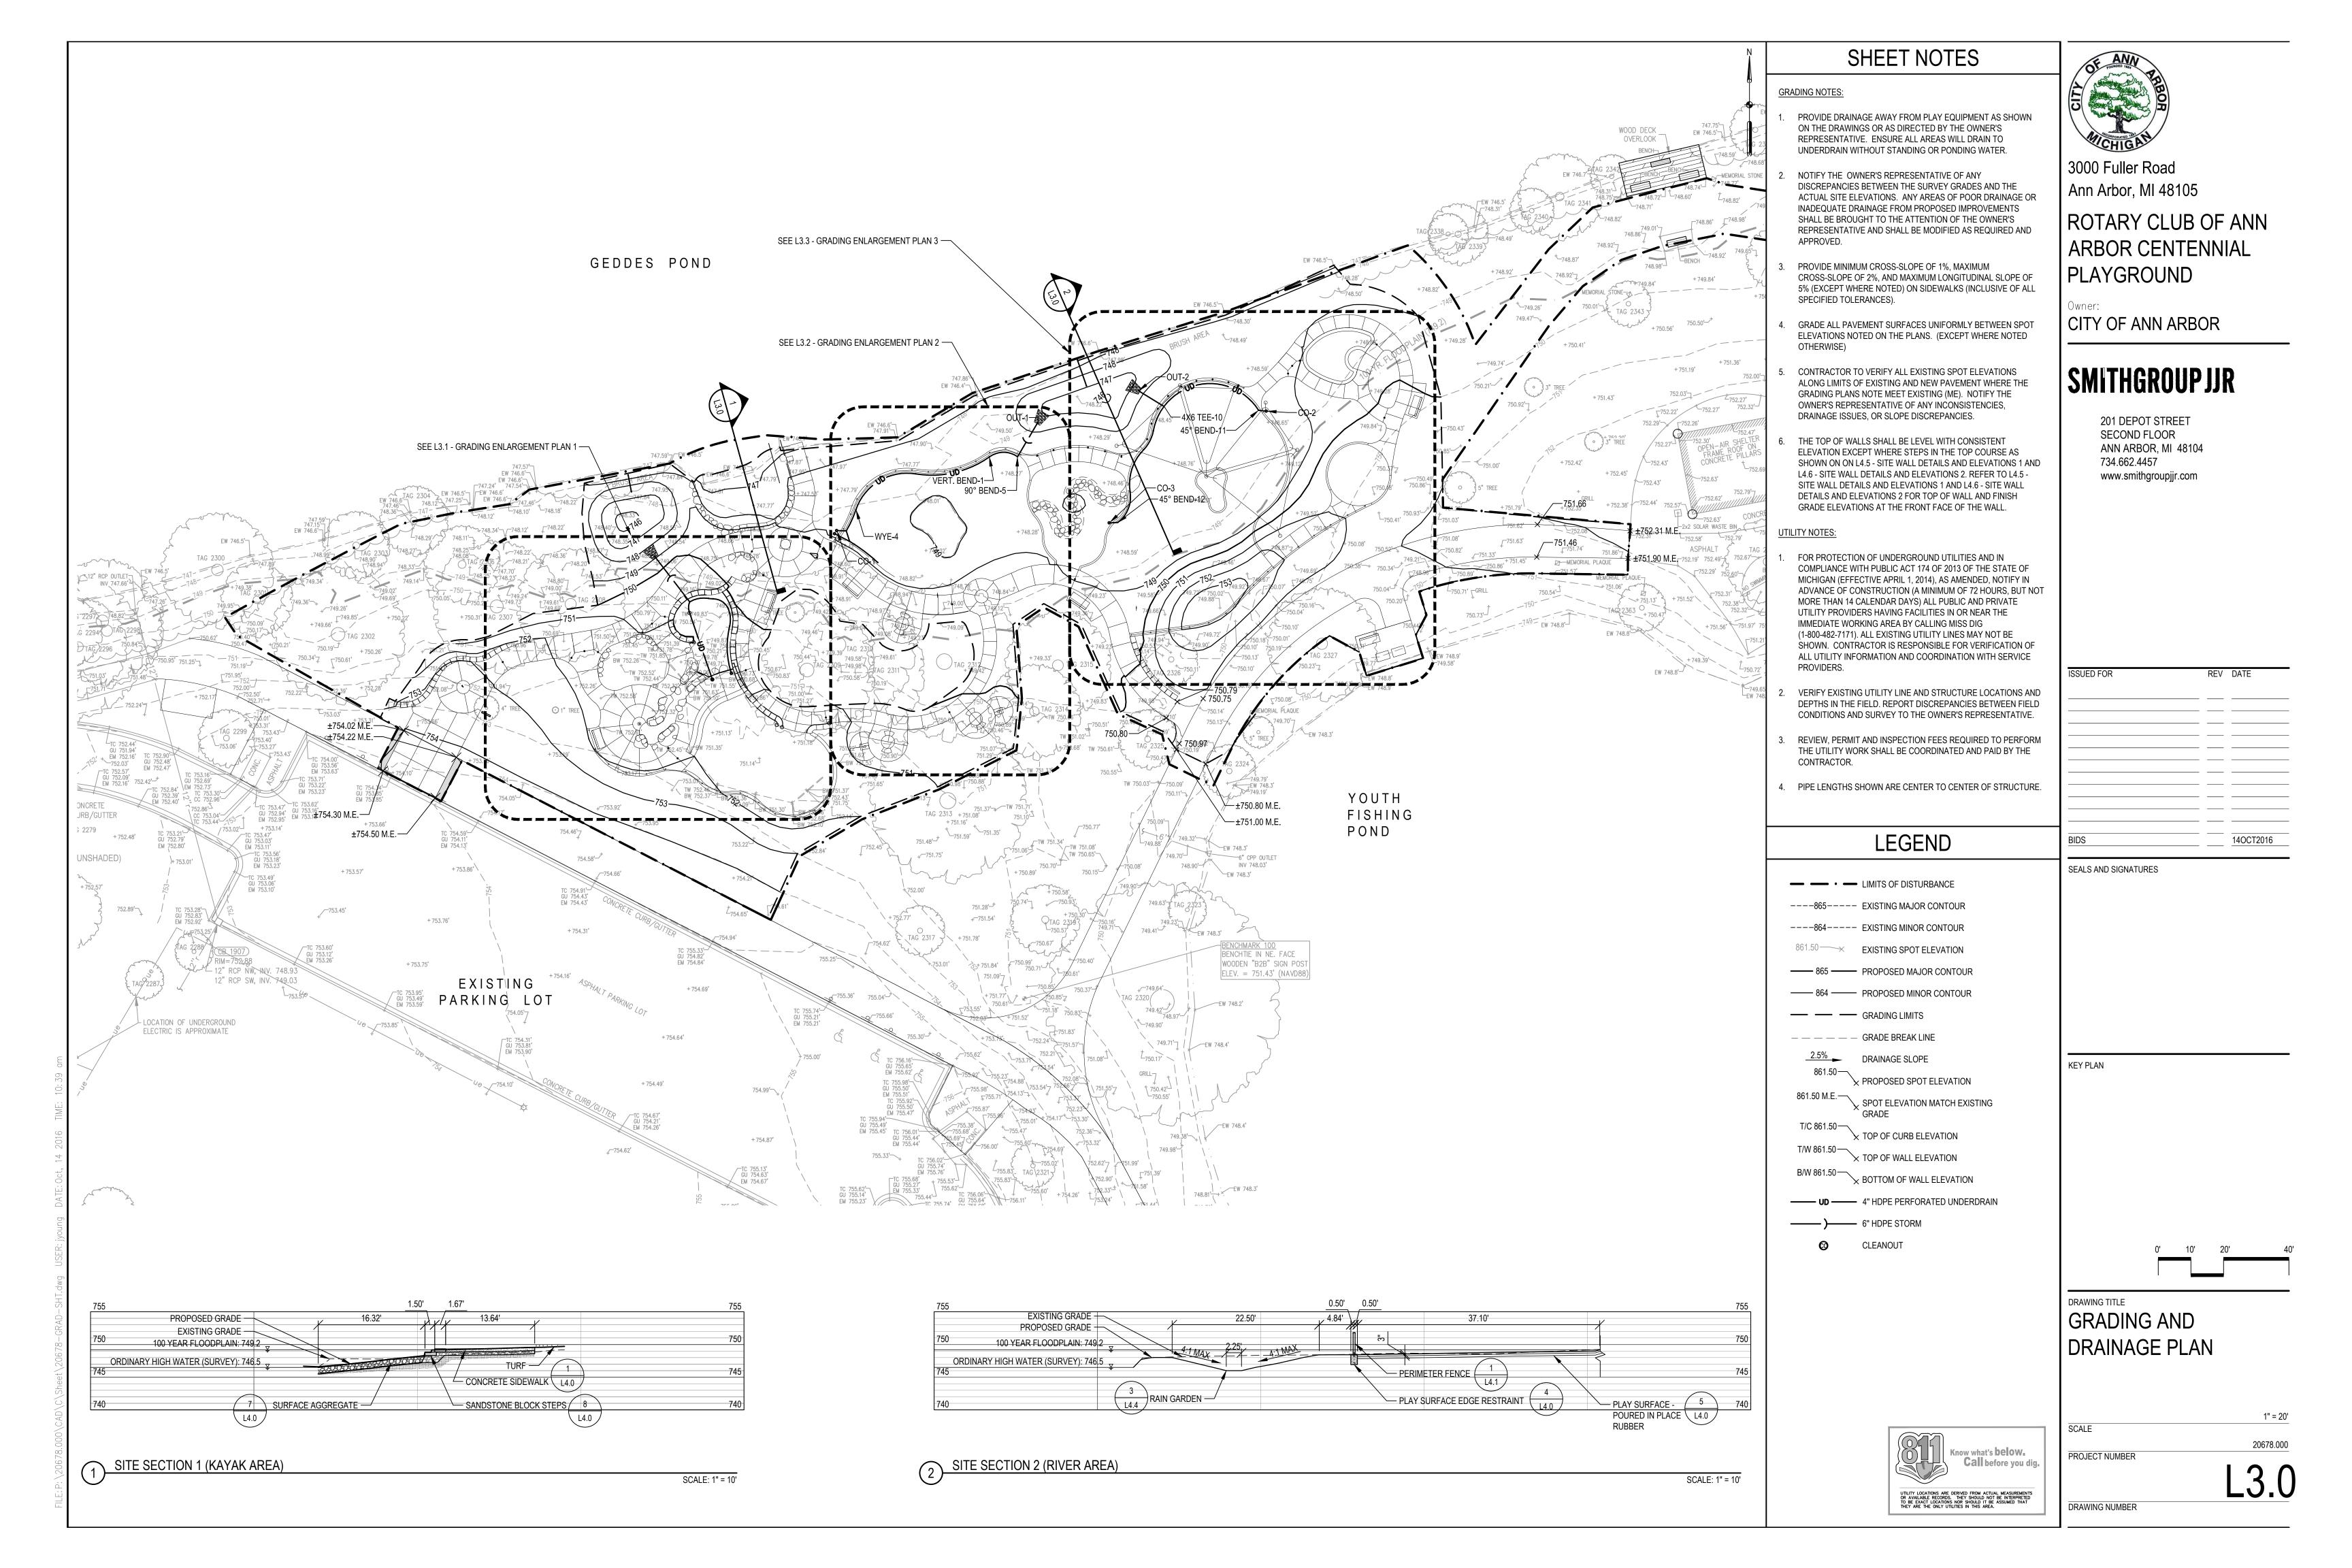

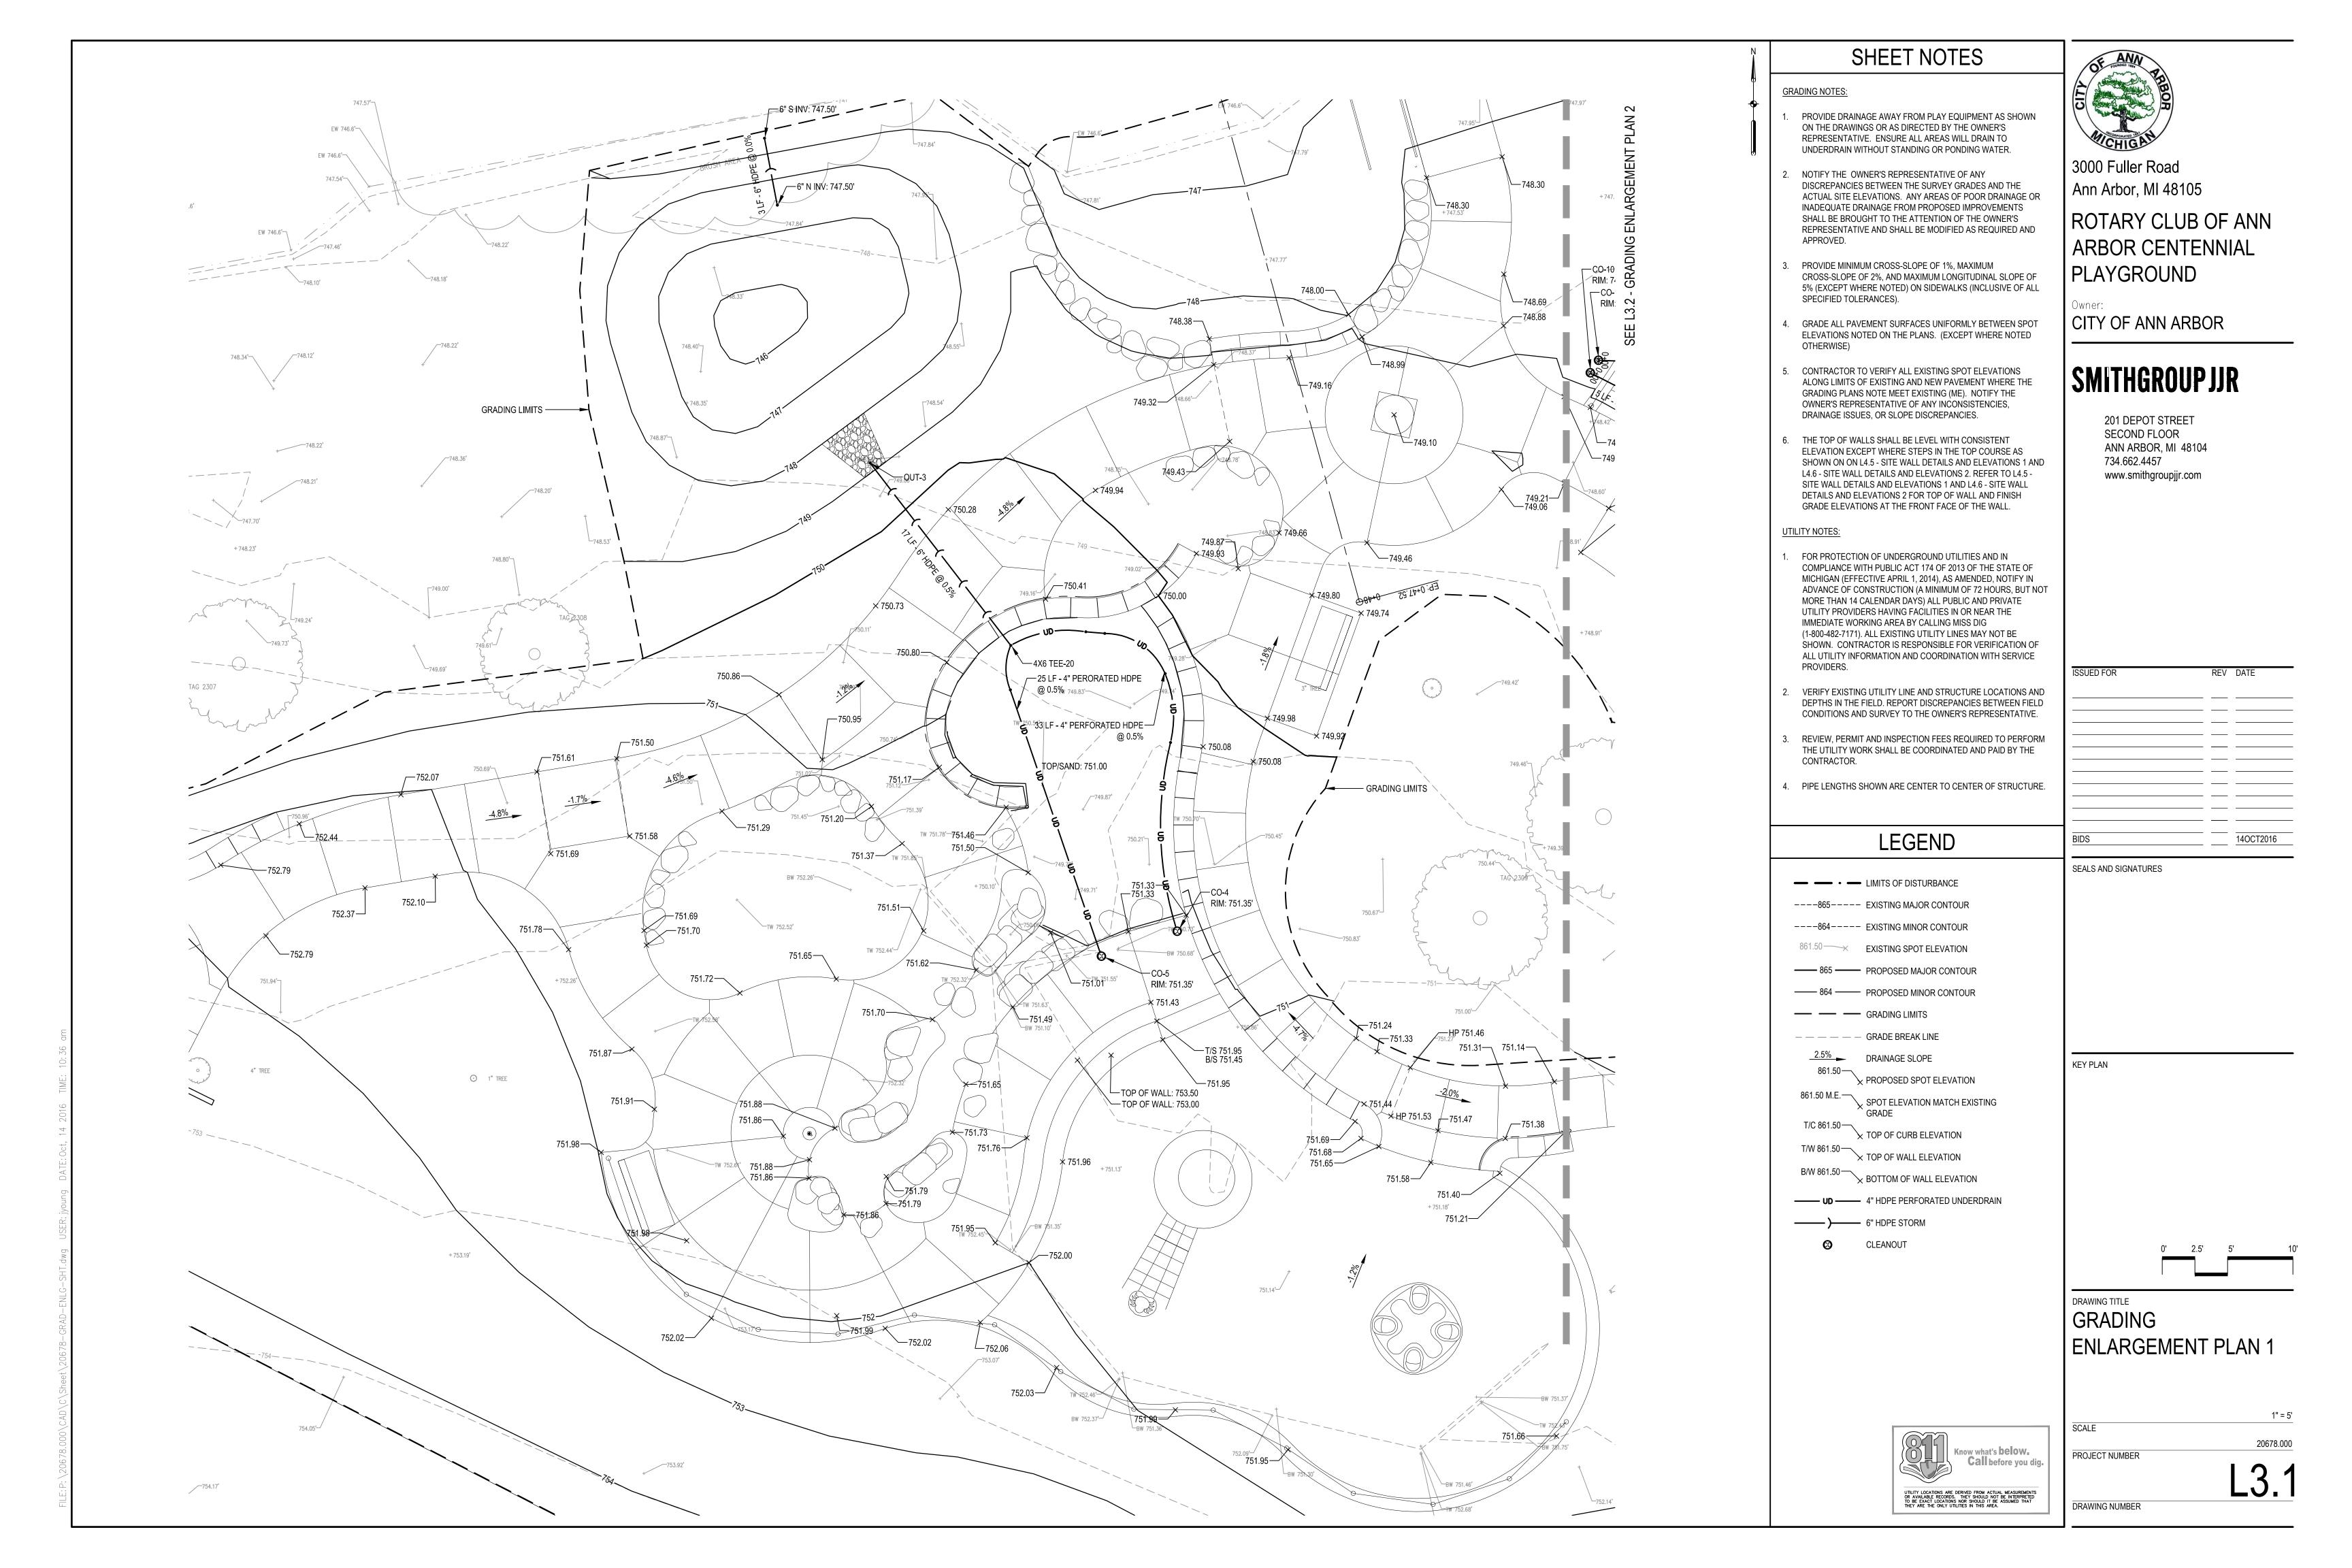

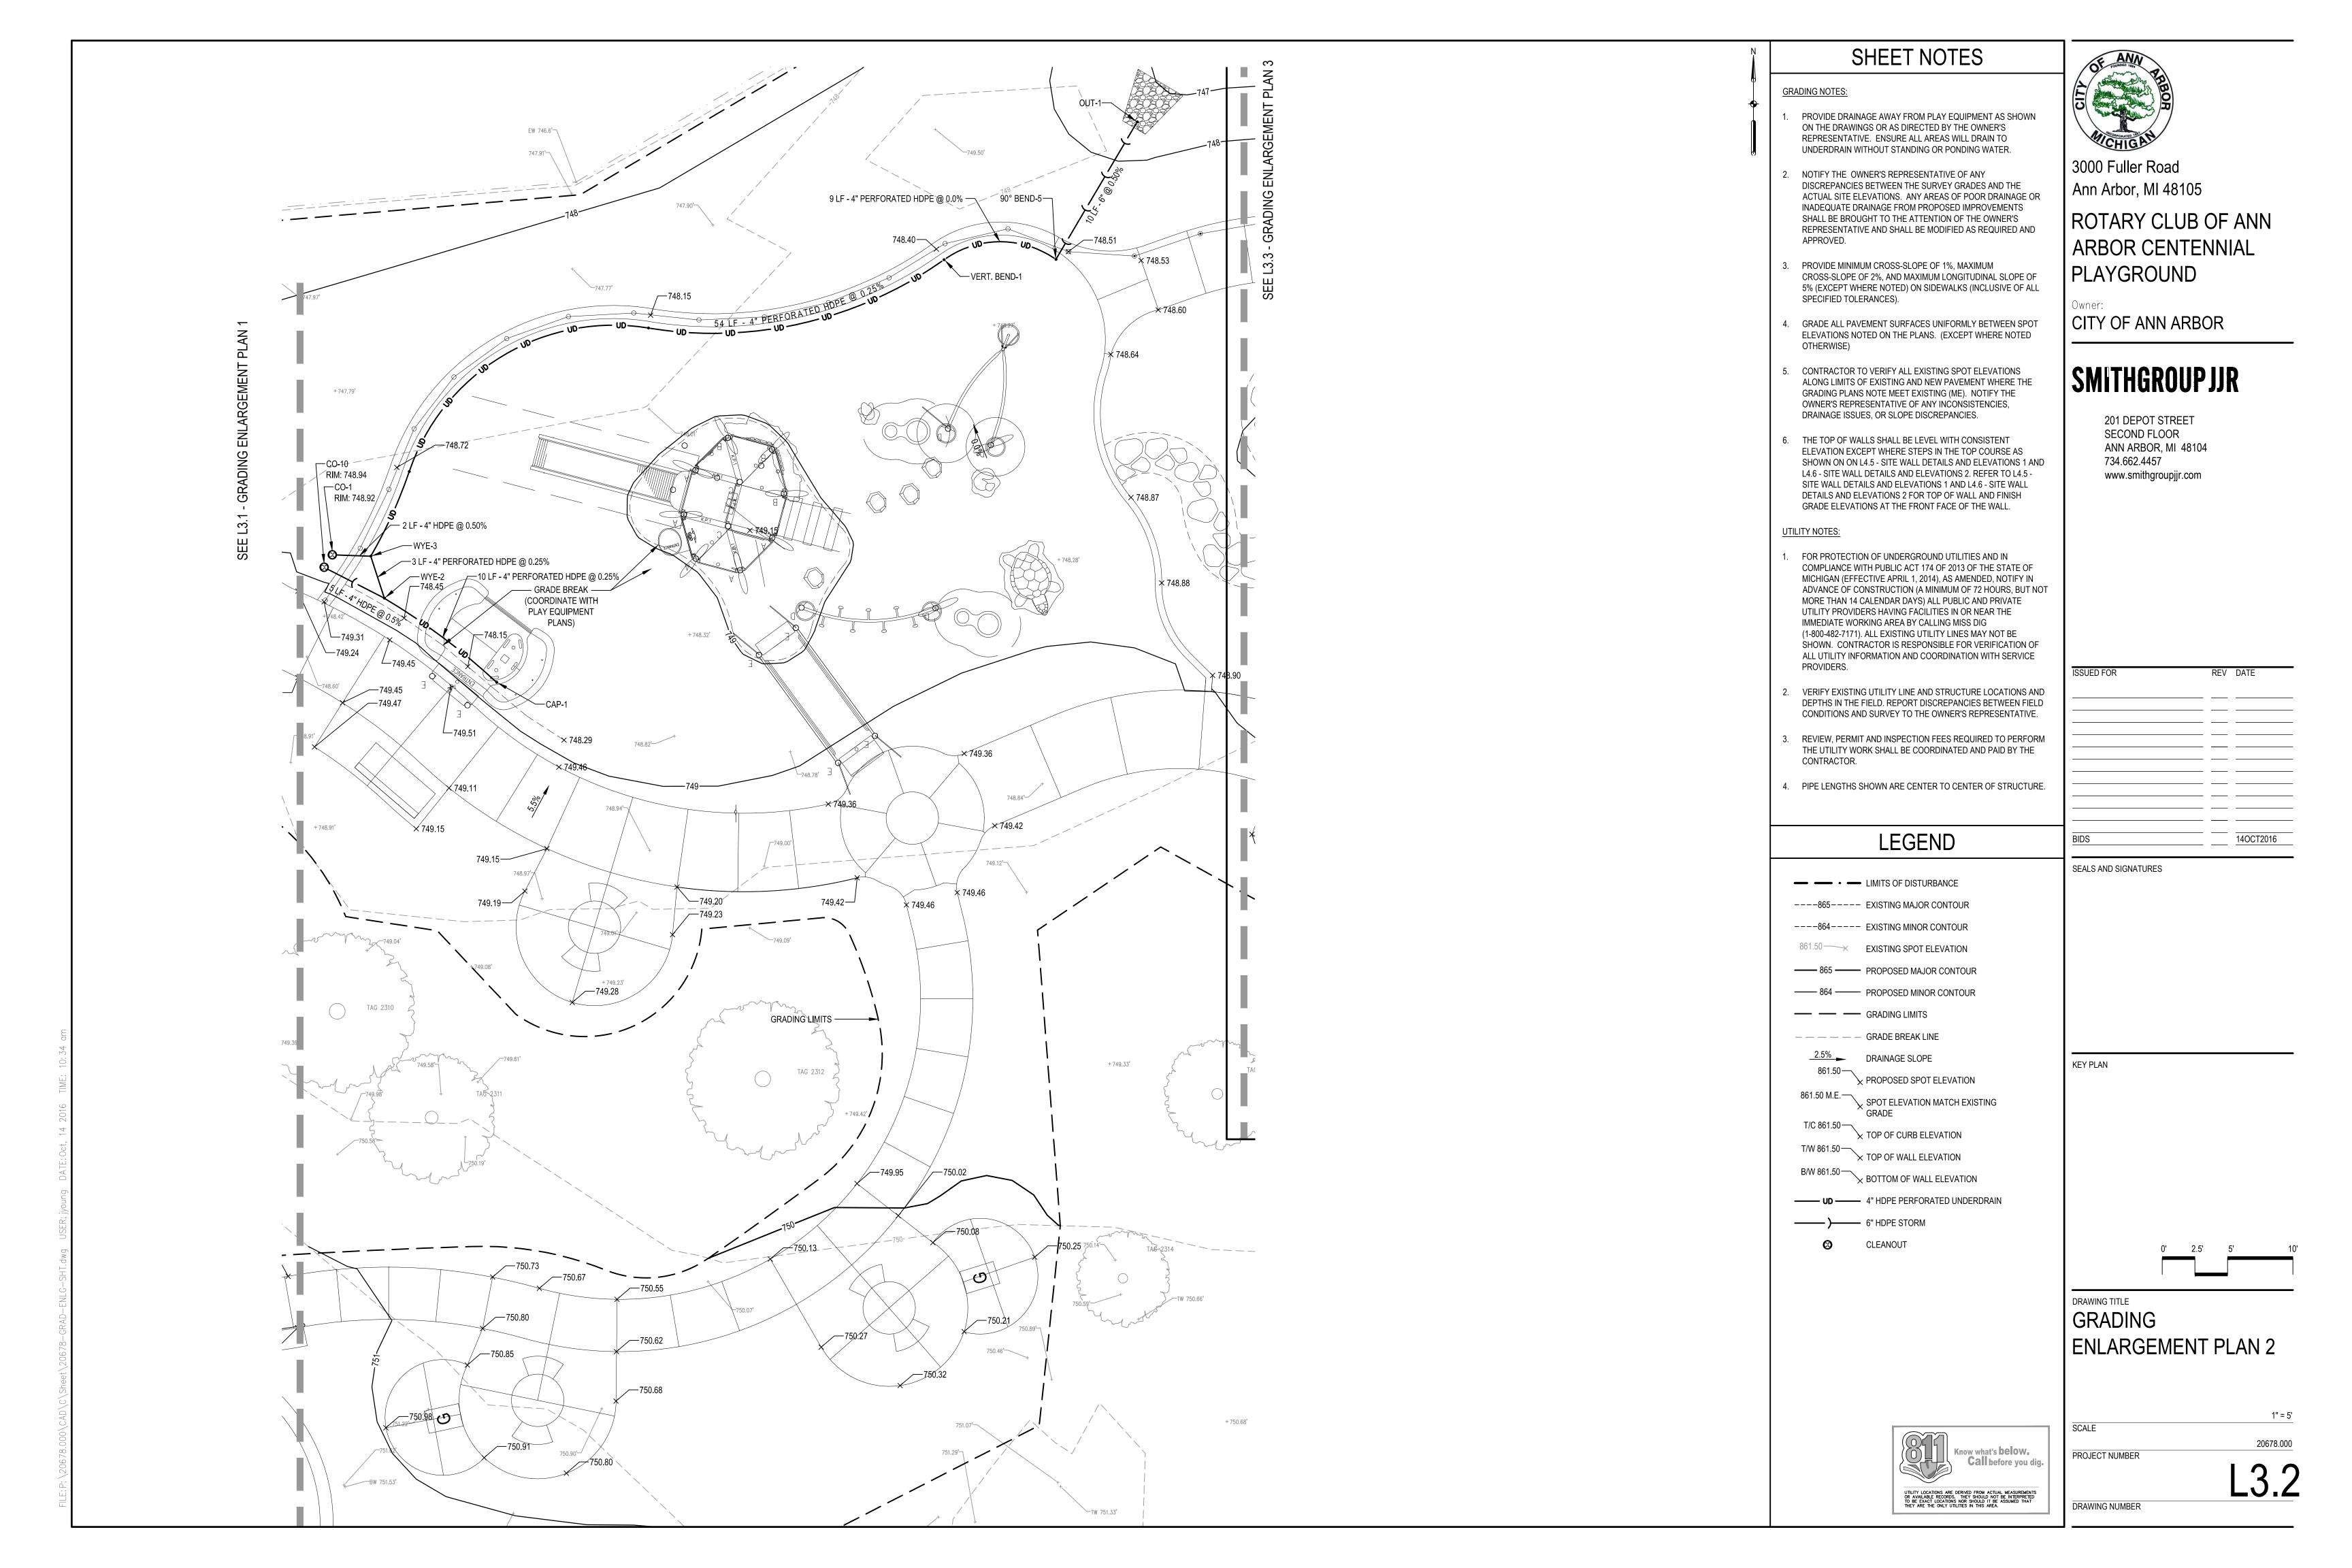1" = 5' 20678.000

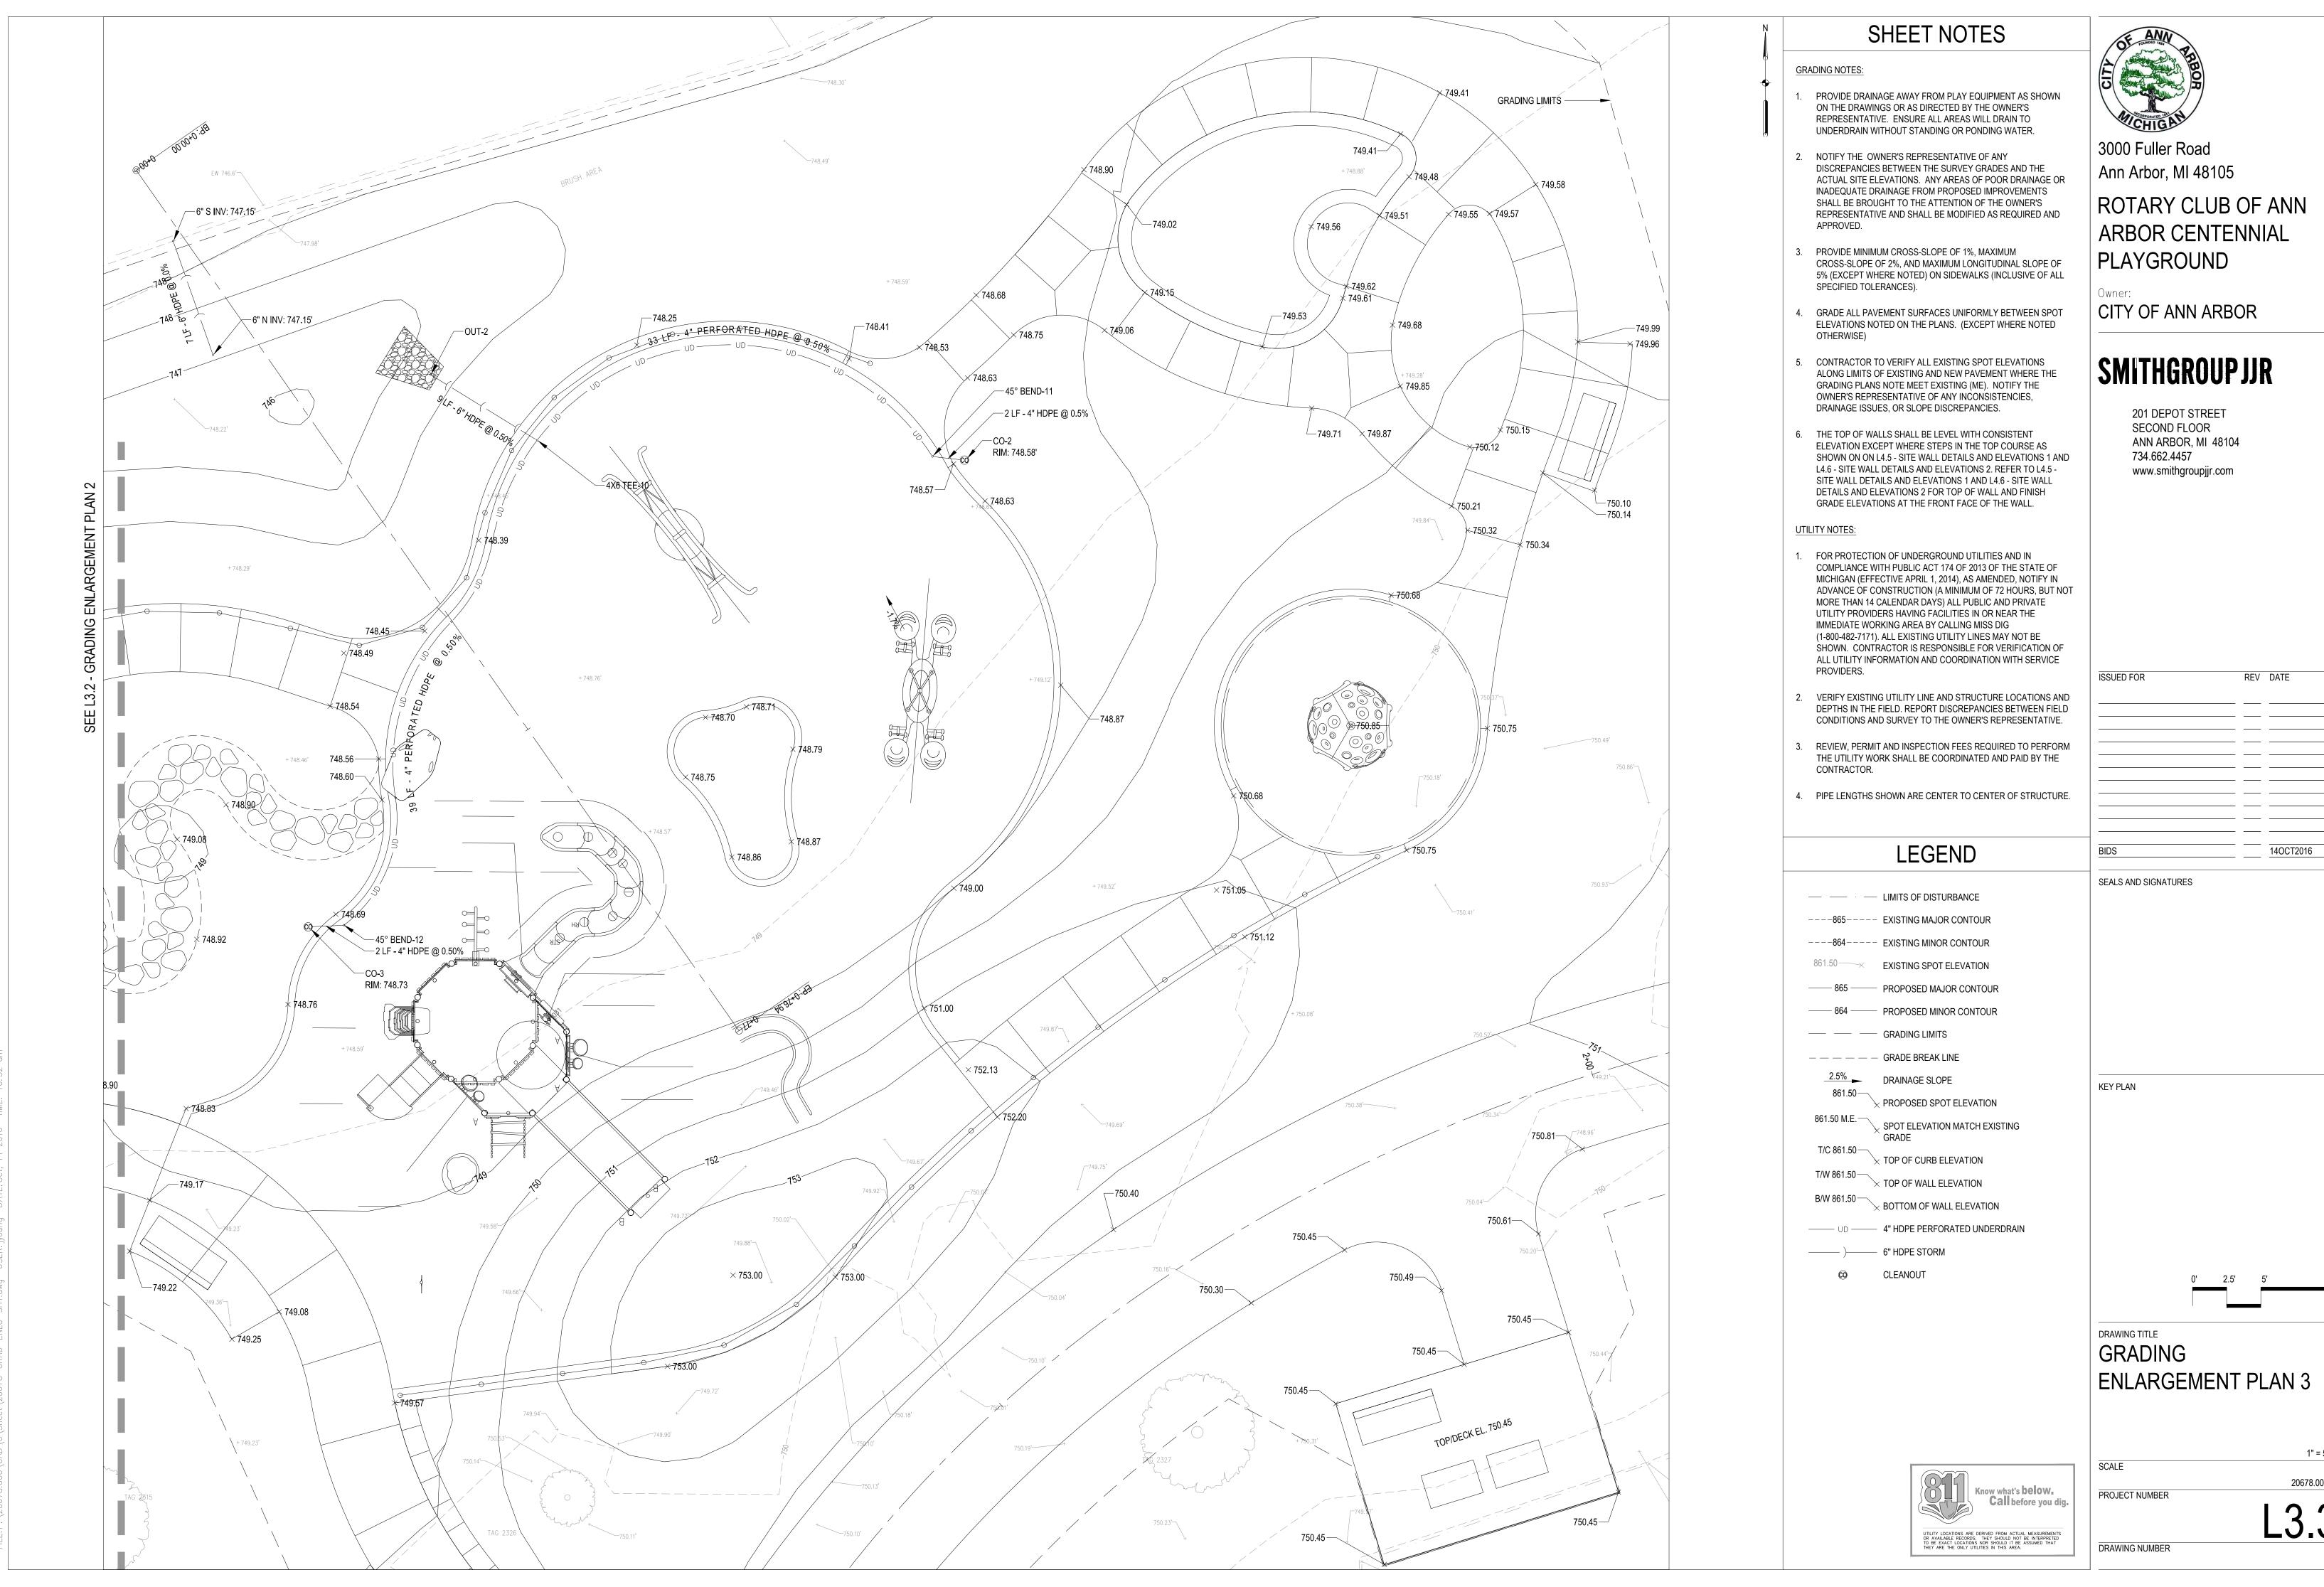

SCALE: 1"=1'

6 CLEANOUT



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SEALS AND SIGNATURES


UTILITY PROFILES AND DETAILS


SCALE


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SEALS AND SIGNATURES

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SITE DETAILS 2


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UTILITY LOCATIONS ARE DERIVED FROM ACTUAL MEASUREMENTS
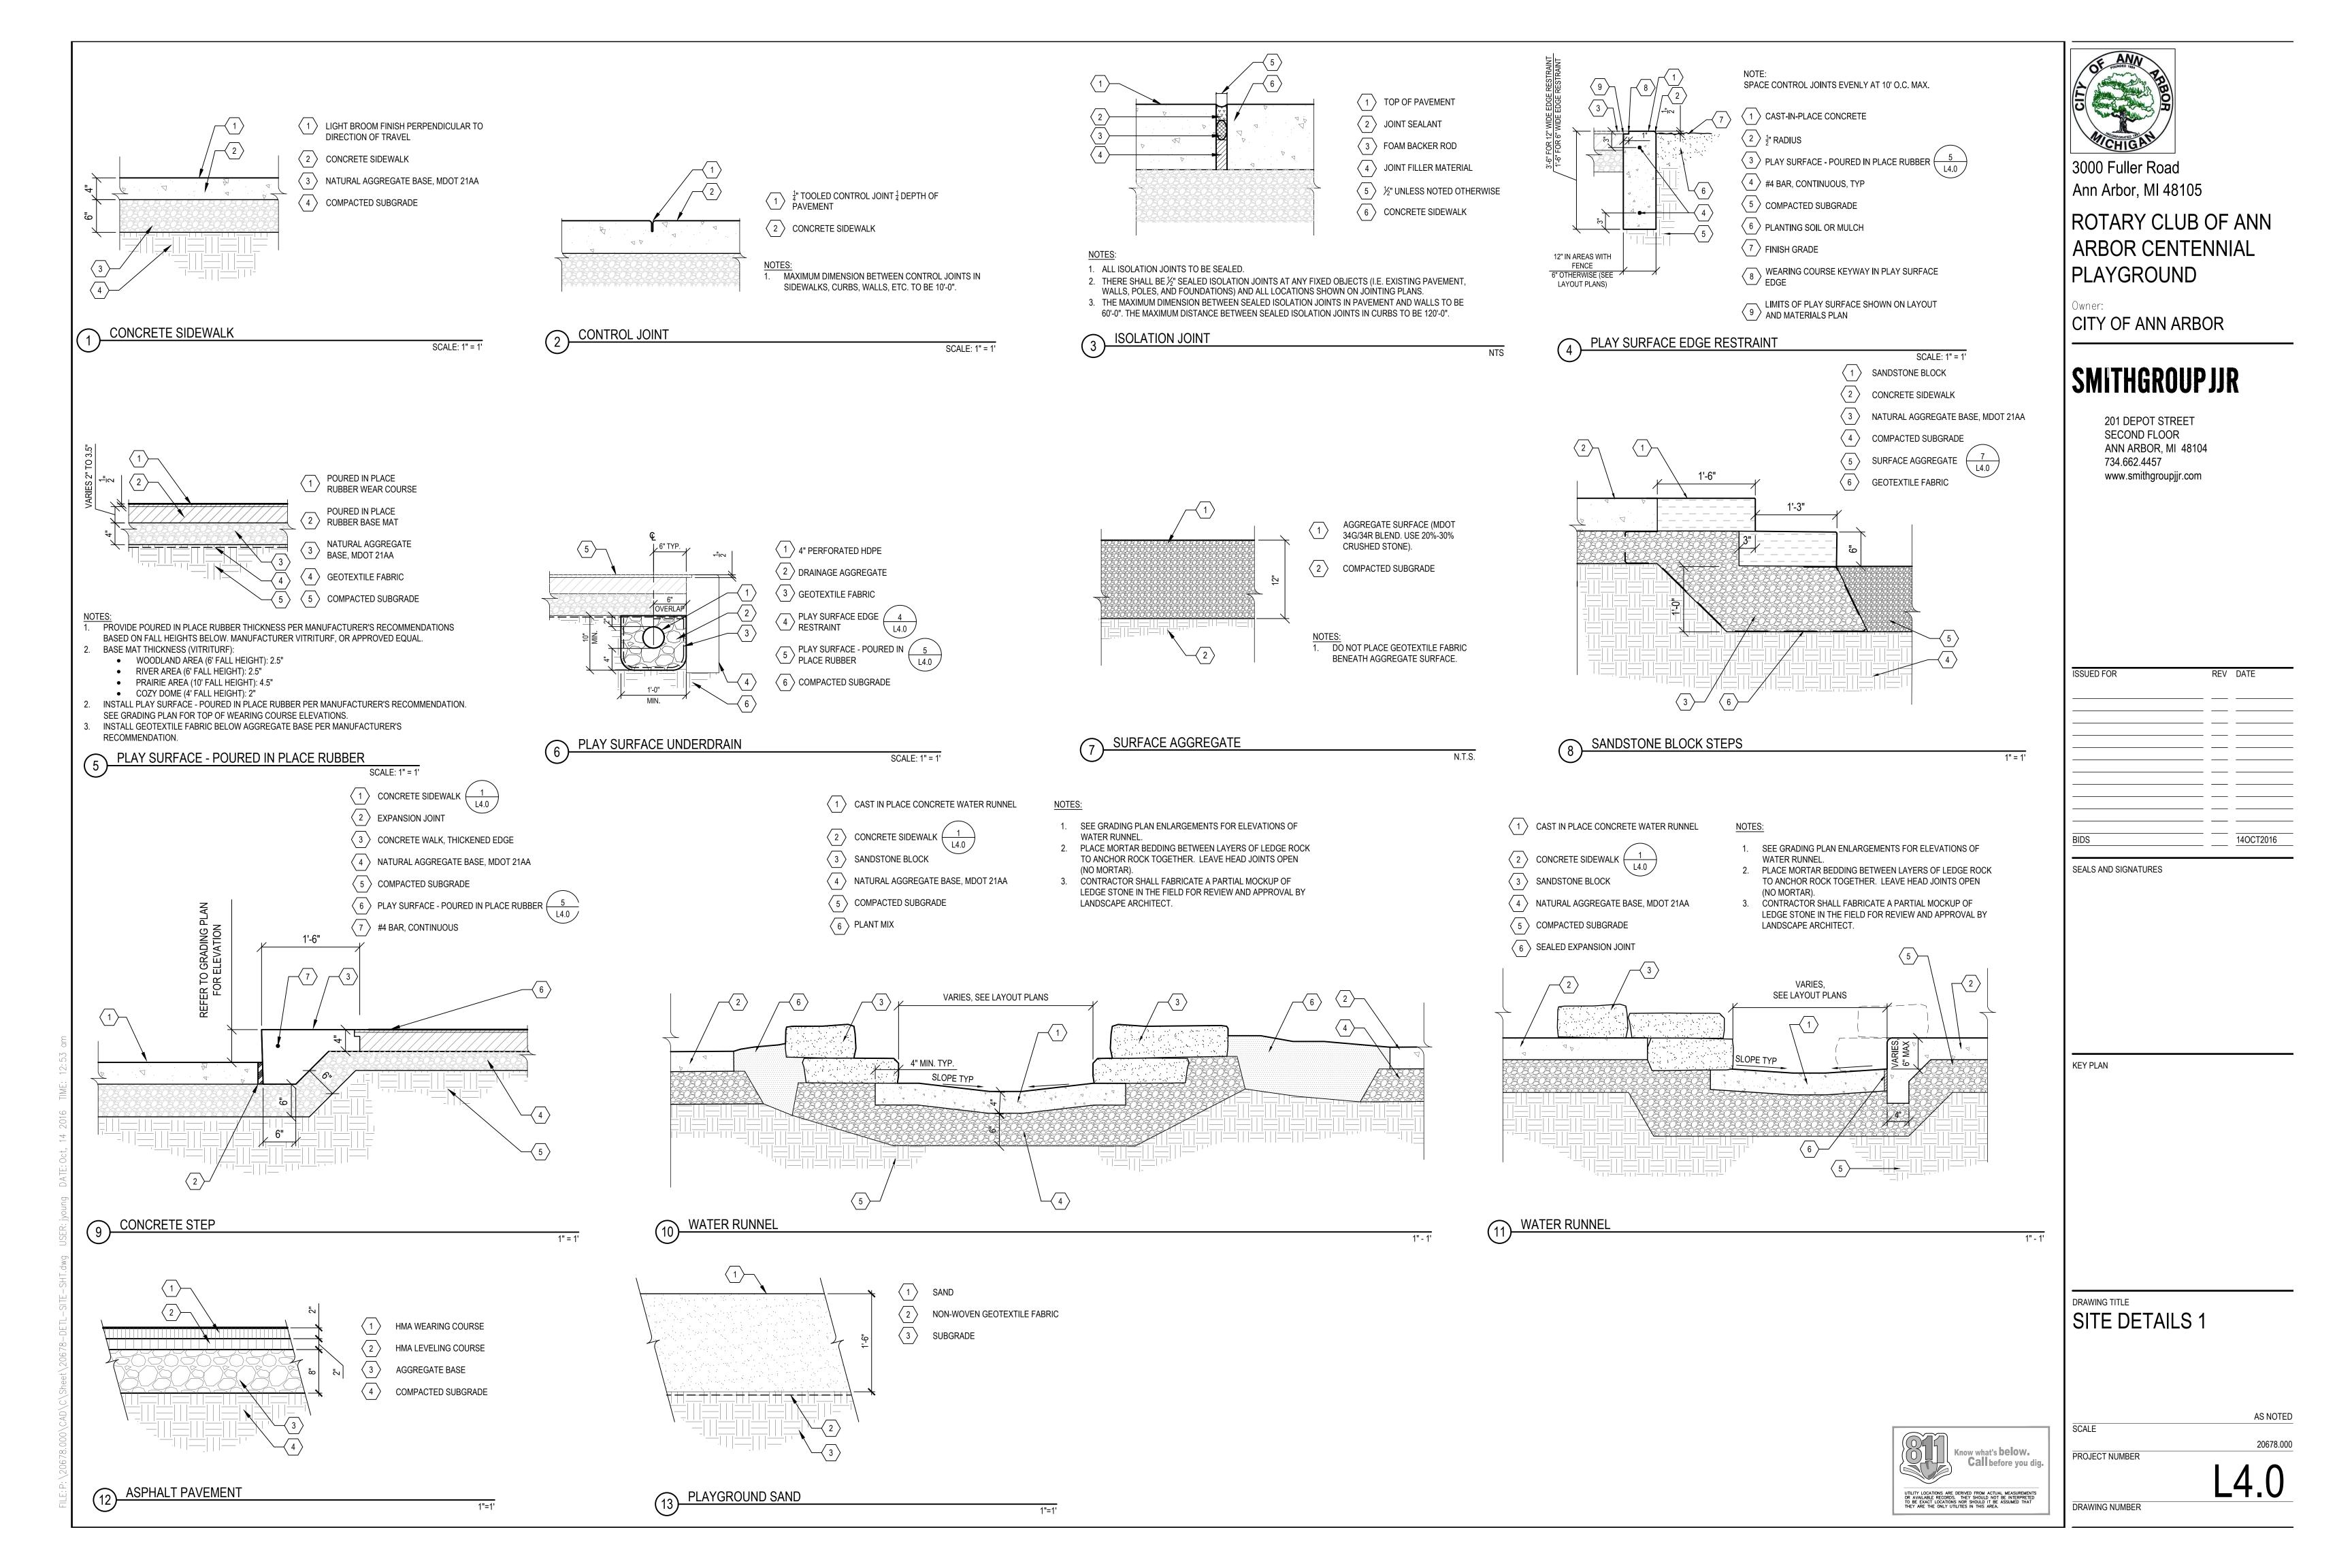
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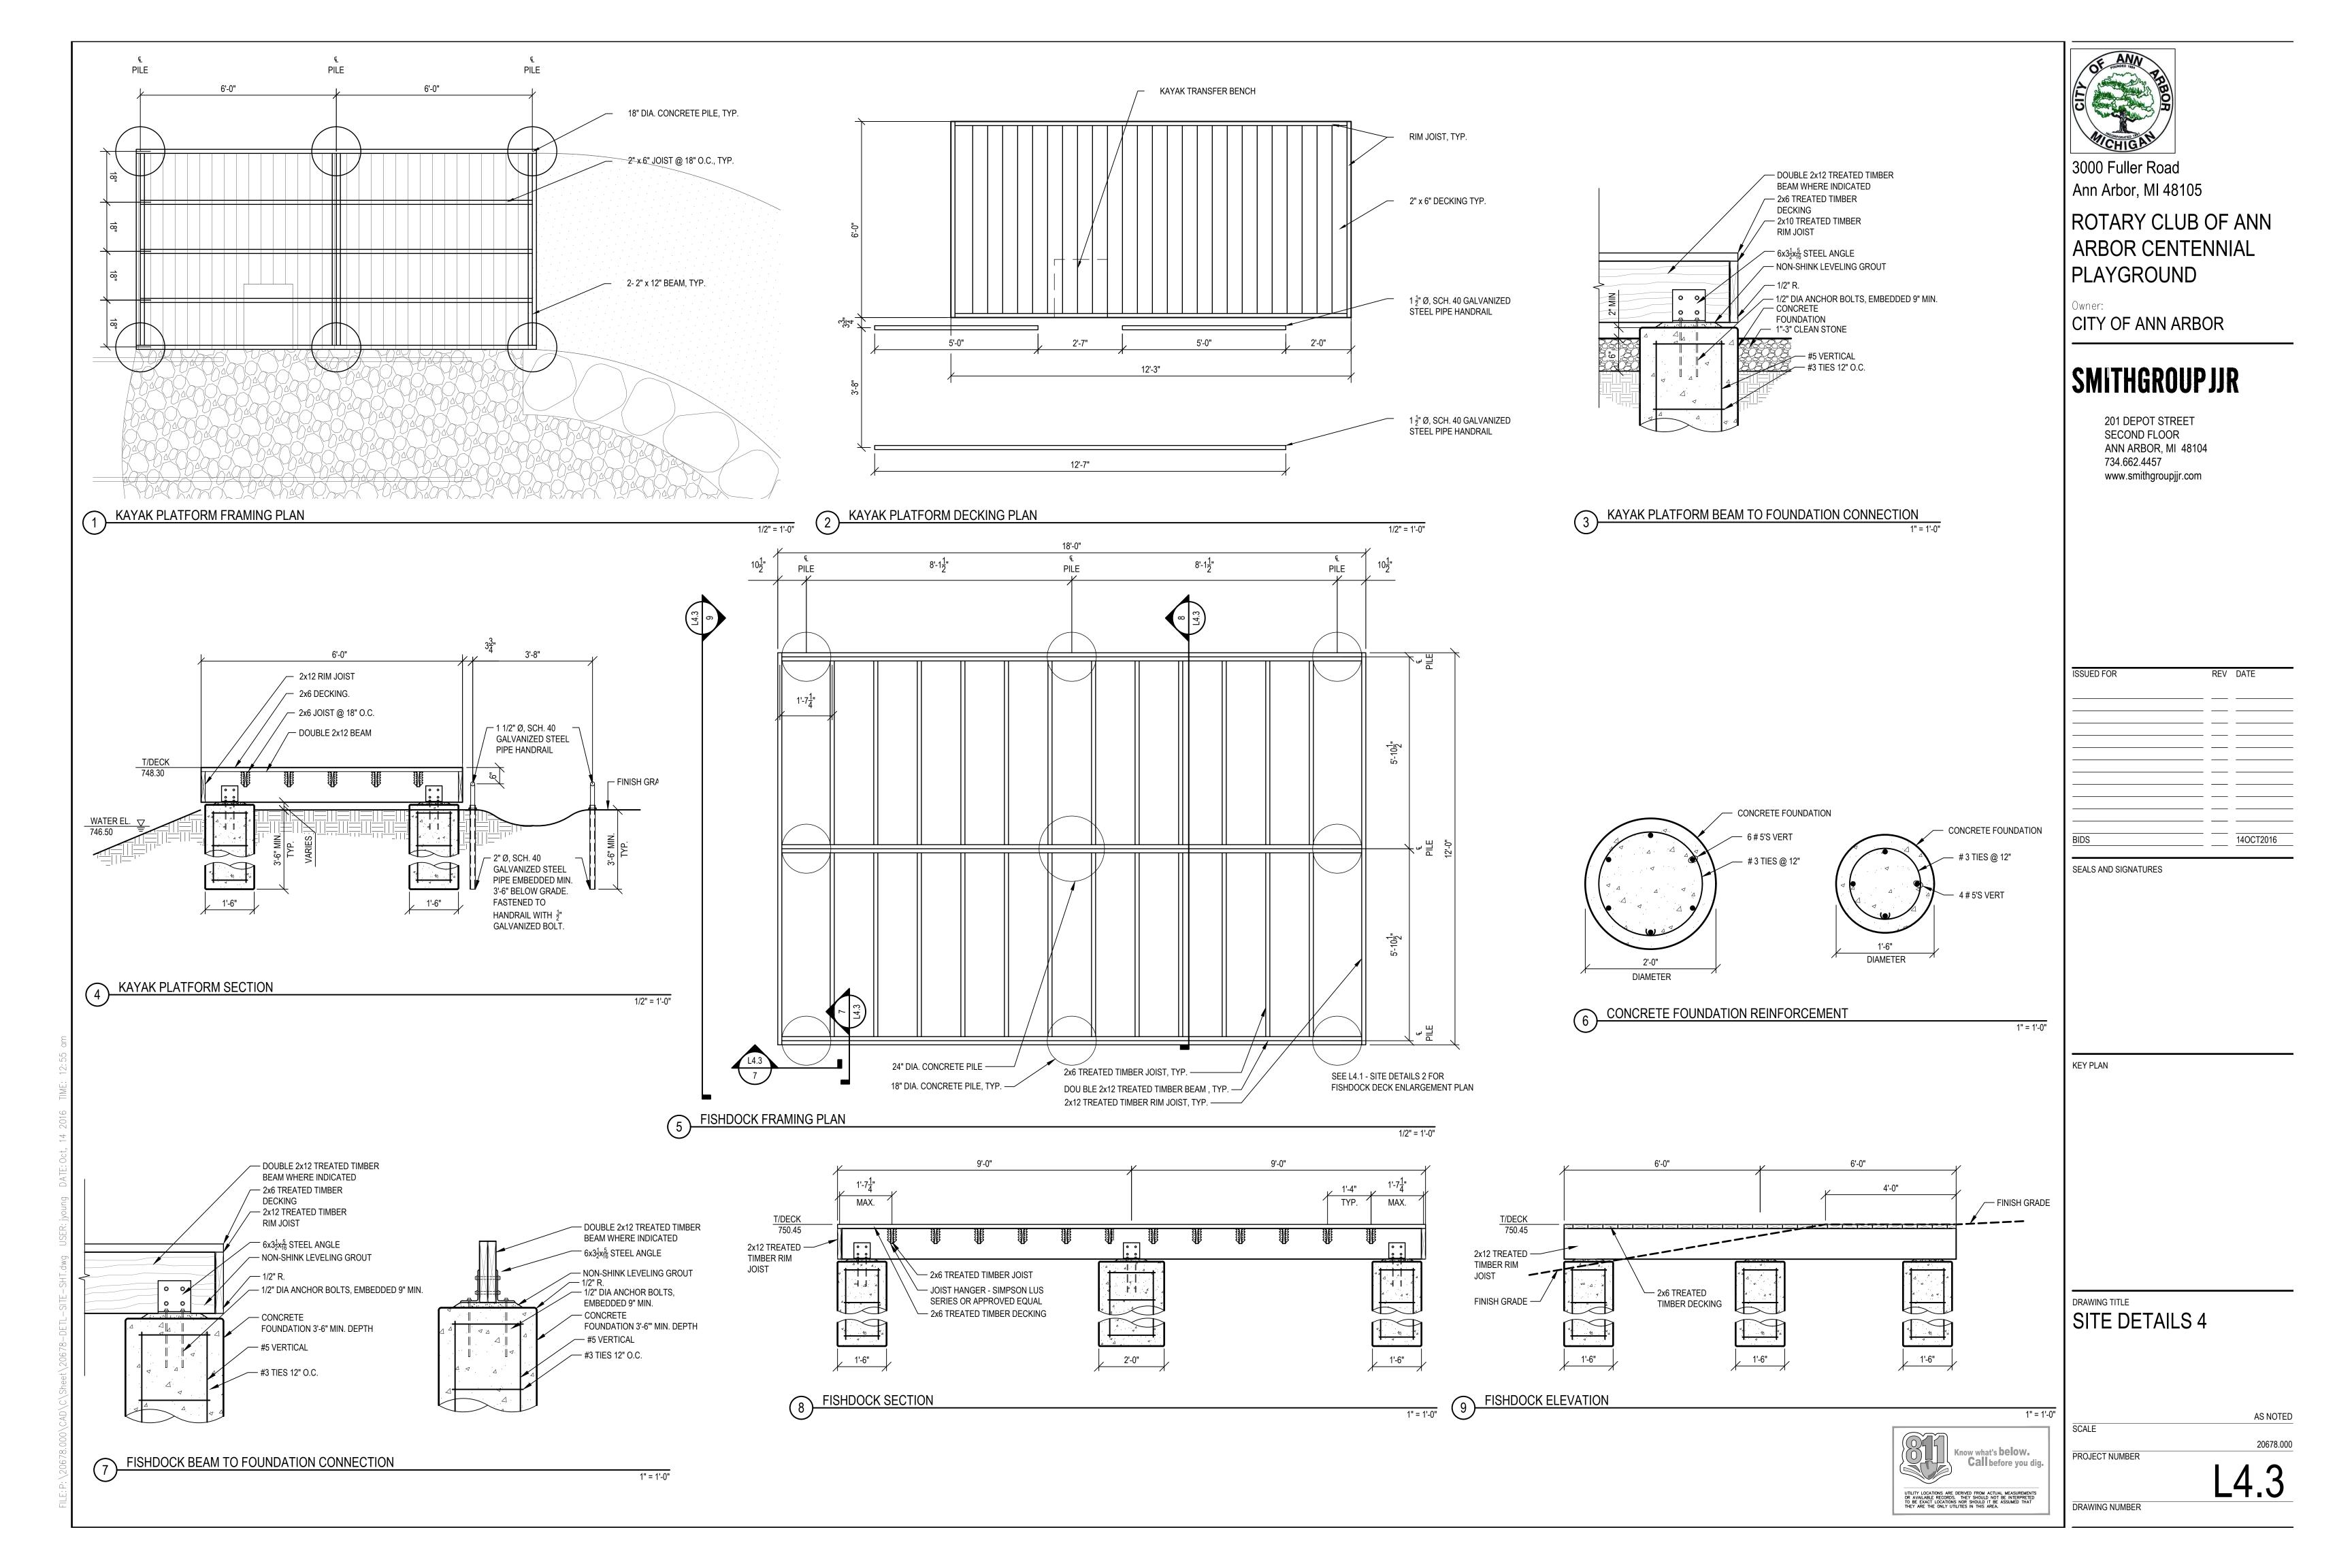
DRAWING TITLE SITE DETAILS 3

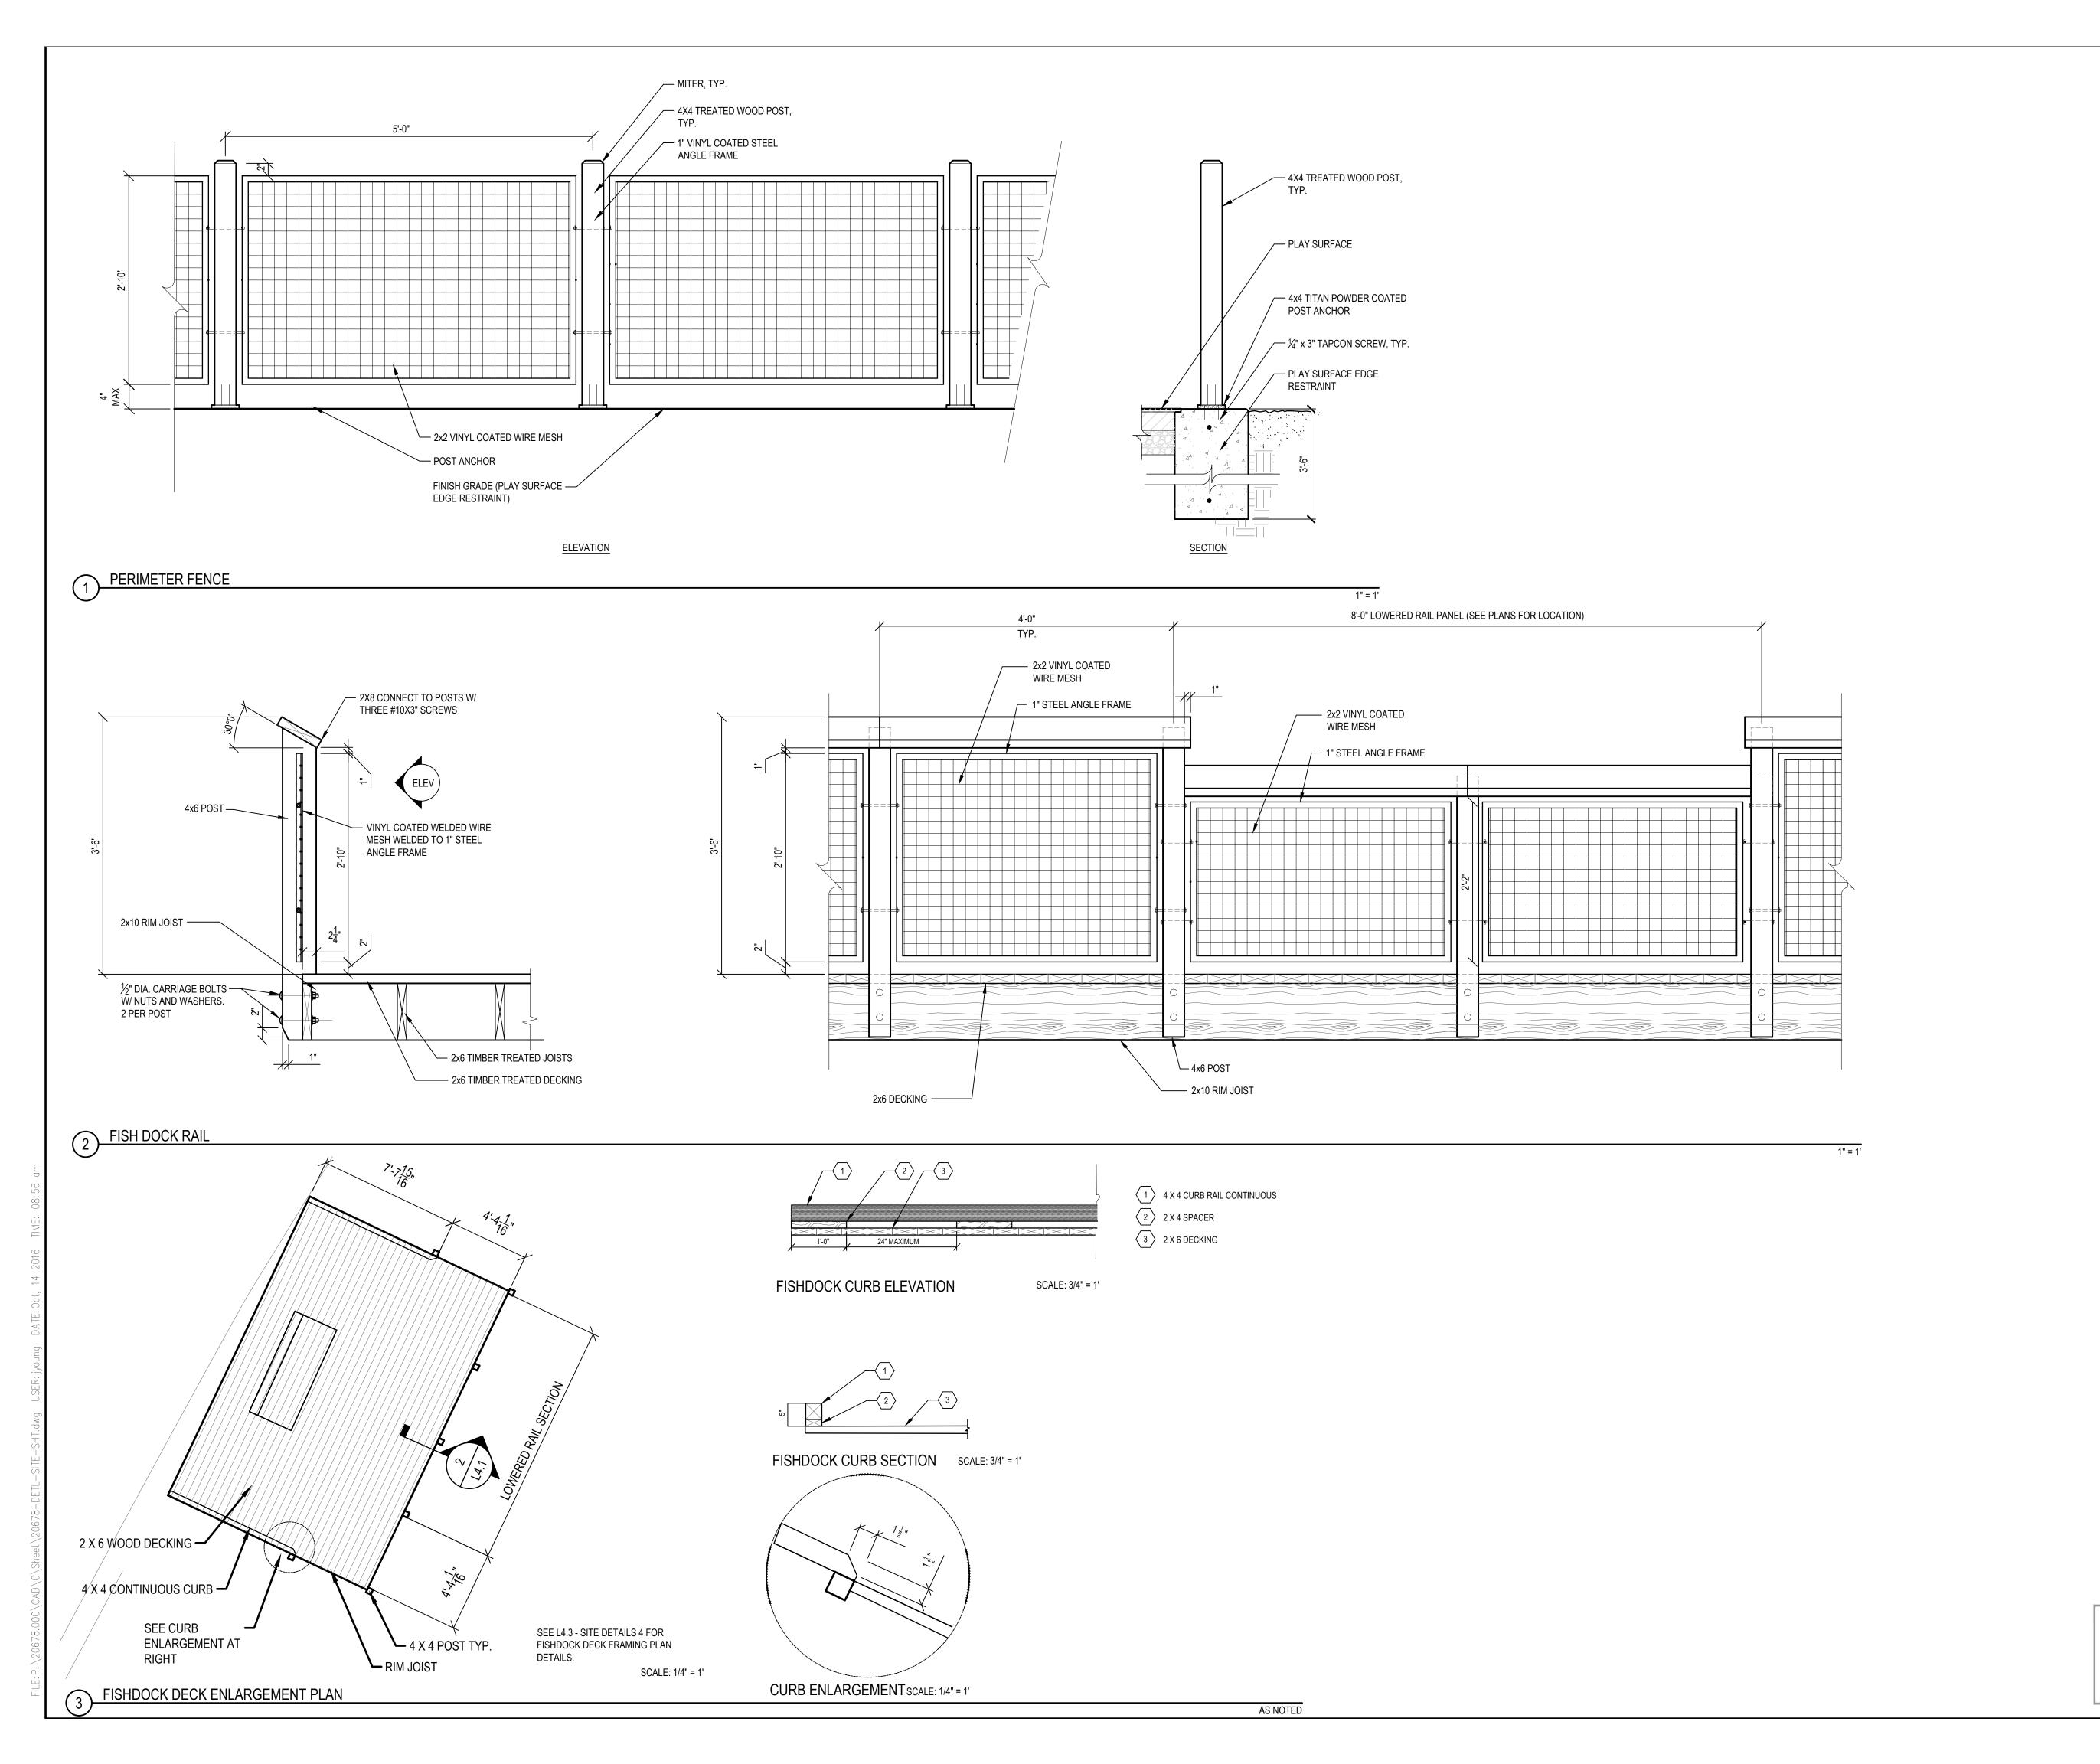
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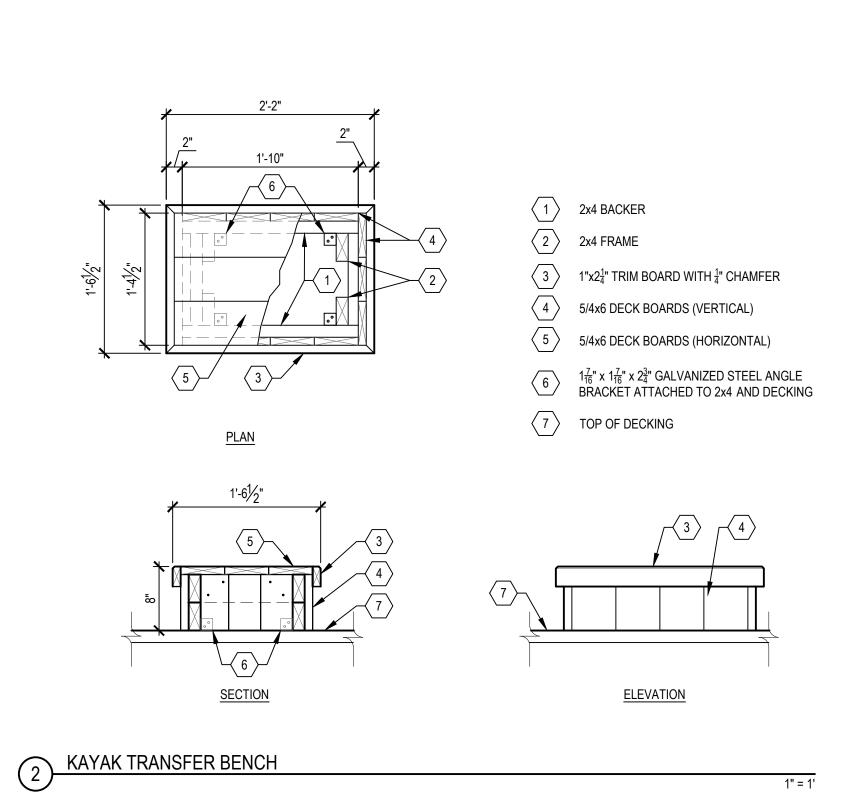
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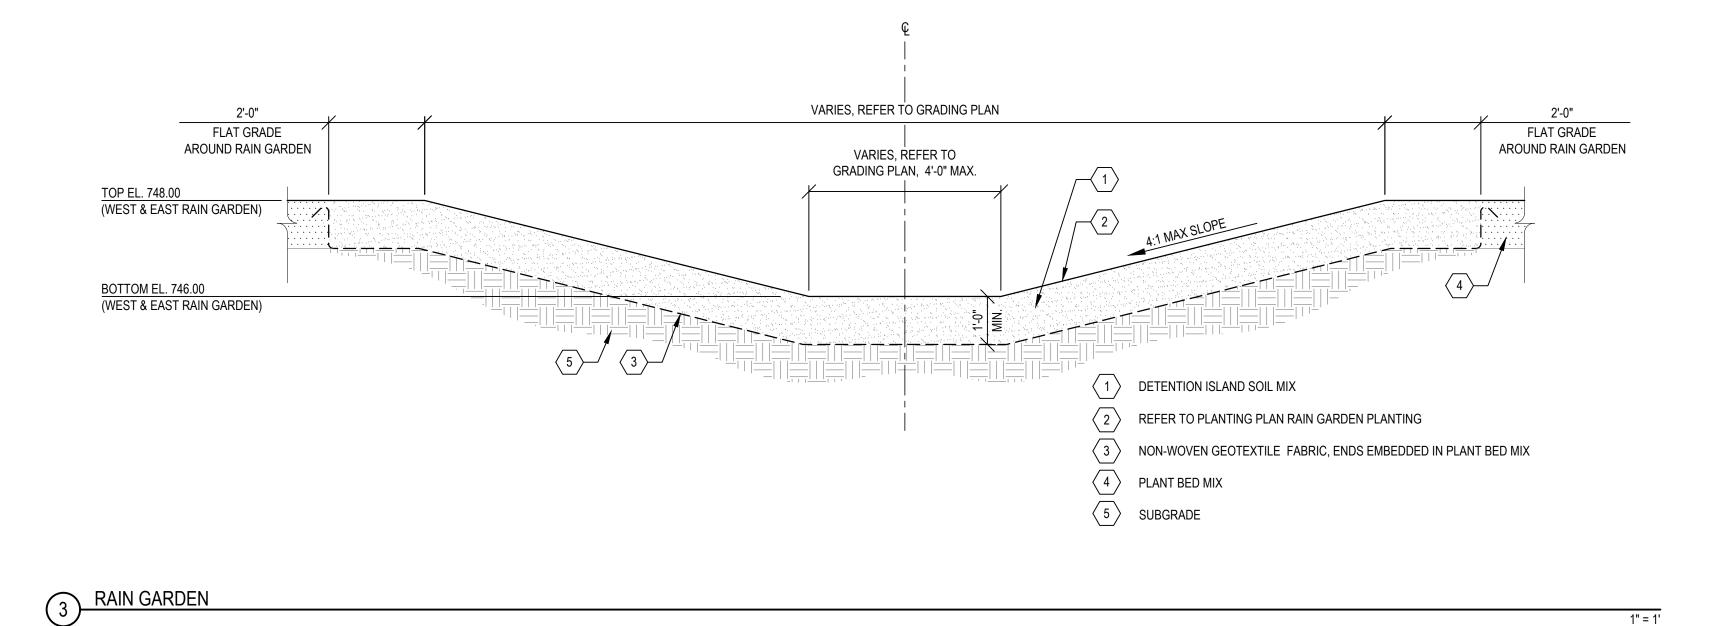
7 NON-SHRINK GROUT

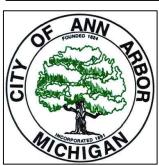CONTRACTOR TO INSTALL MORTAR IN SELECT LOCATION BETWEEN BOULDERS TO PREVENT DISPLACEMENT OF STONE. IT IS NOT INTENDED THAT ALL JOINTS BE FULLY MORTARED SO THE WALL MAINTAINS A DRY LAID LOOK.



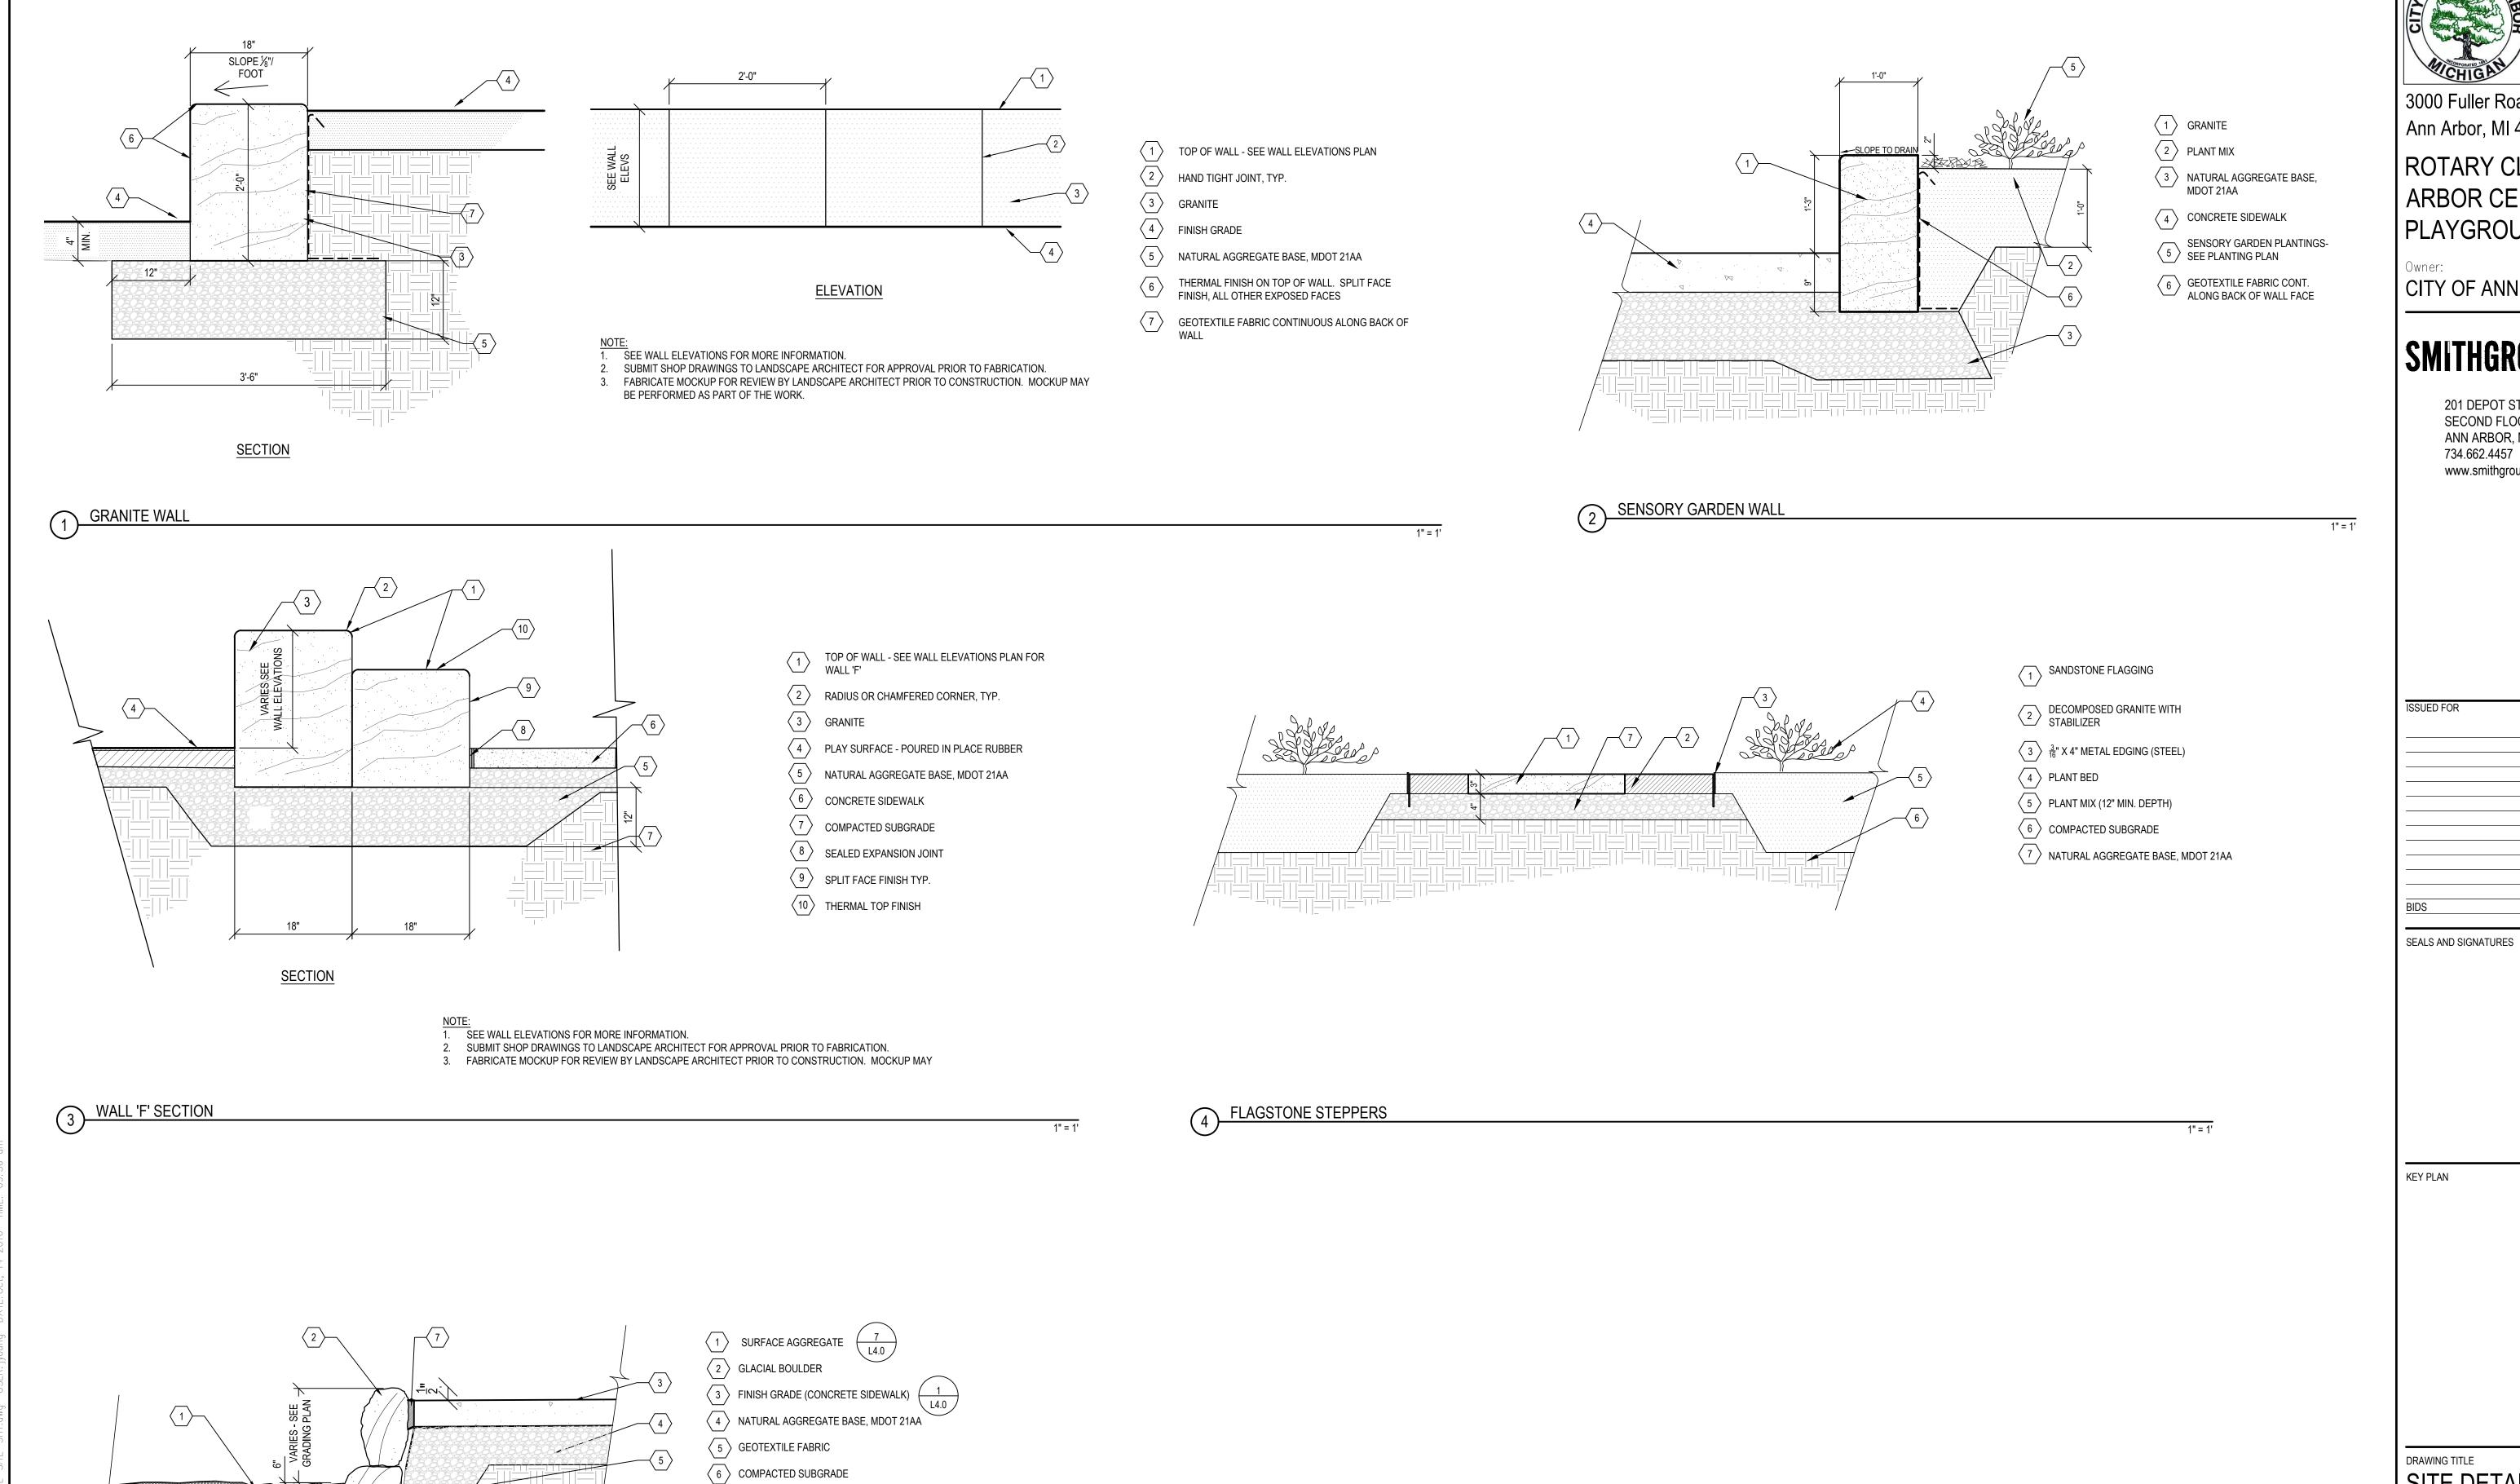



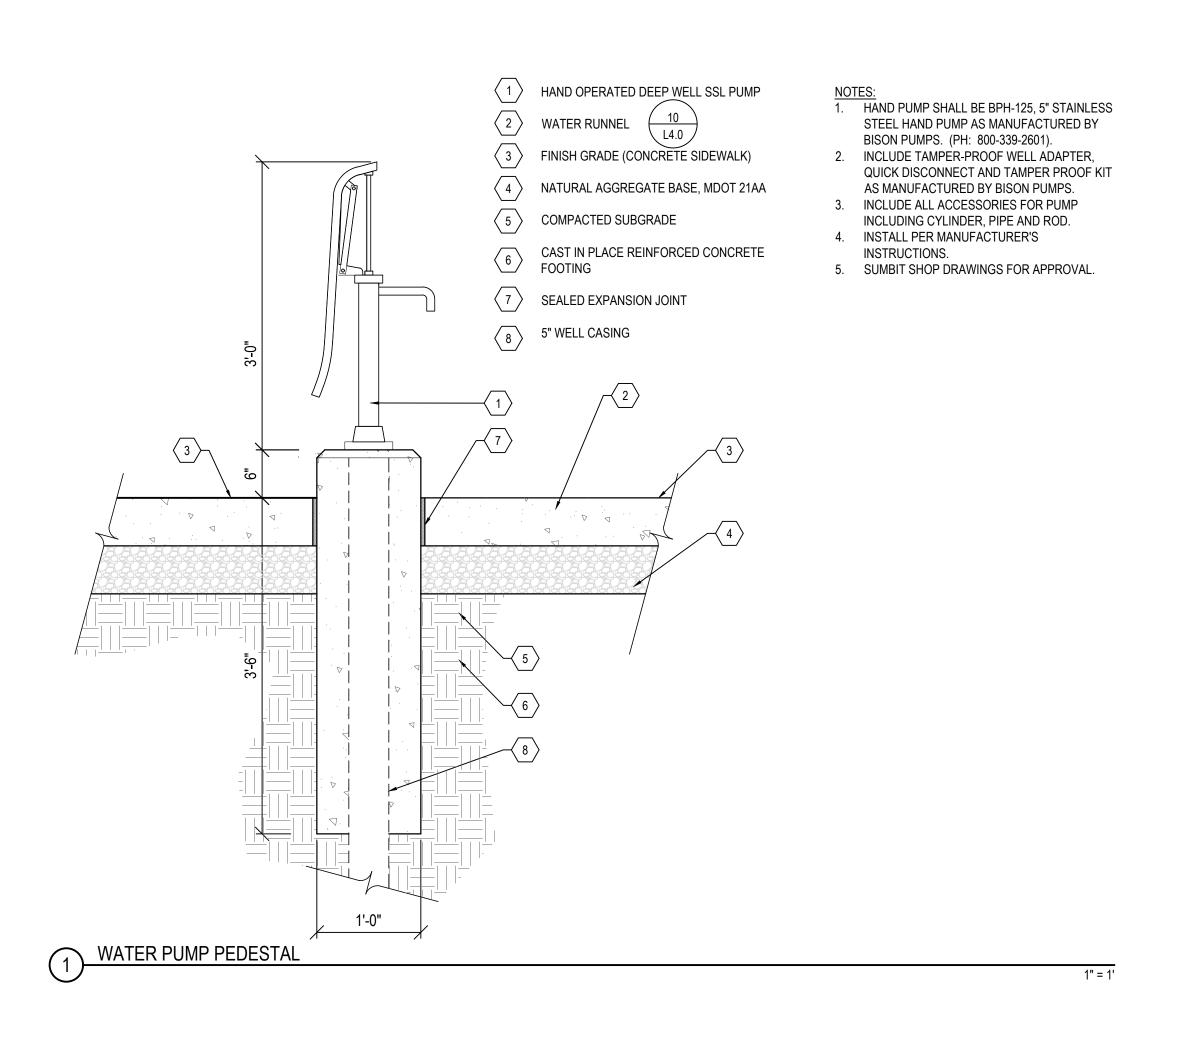

Know what's **below. Call** before you dig.

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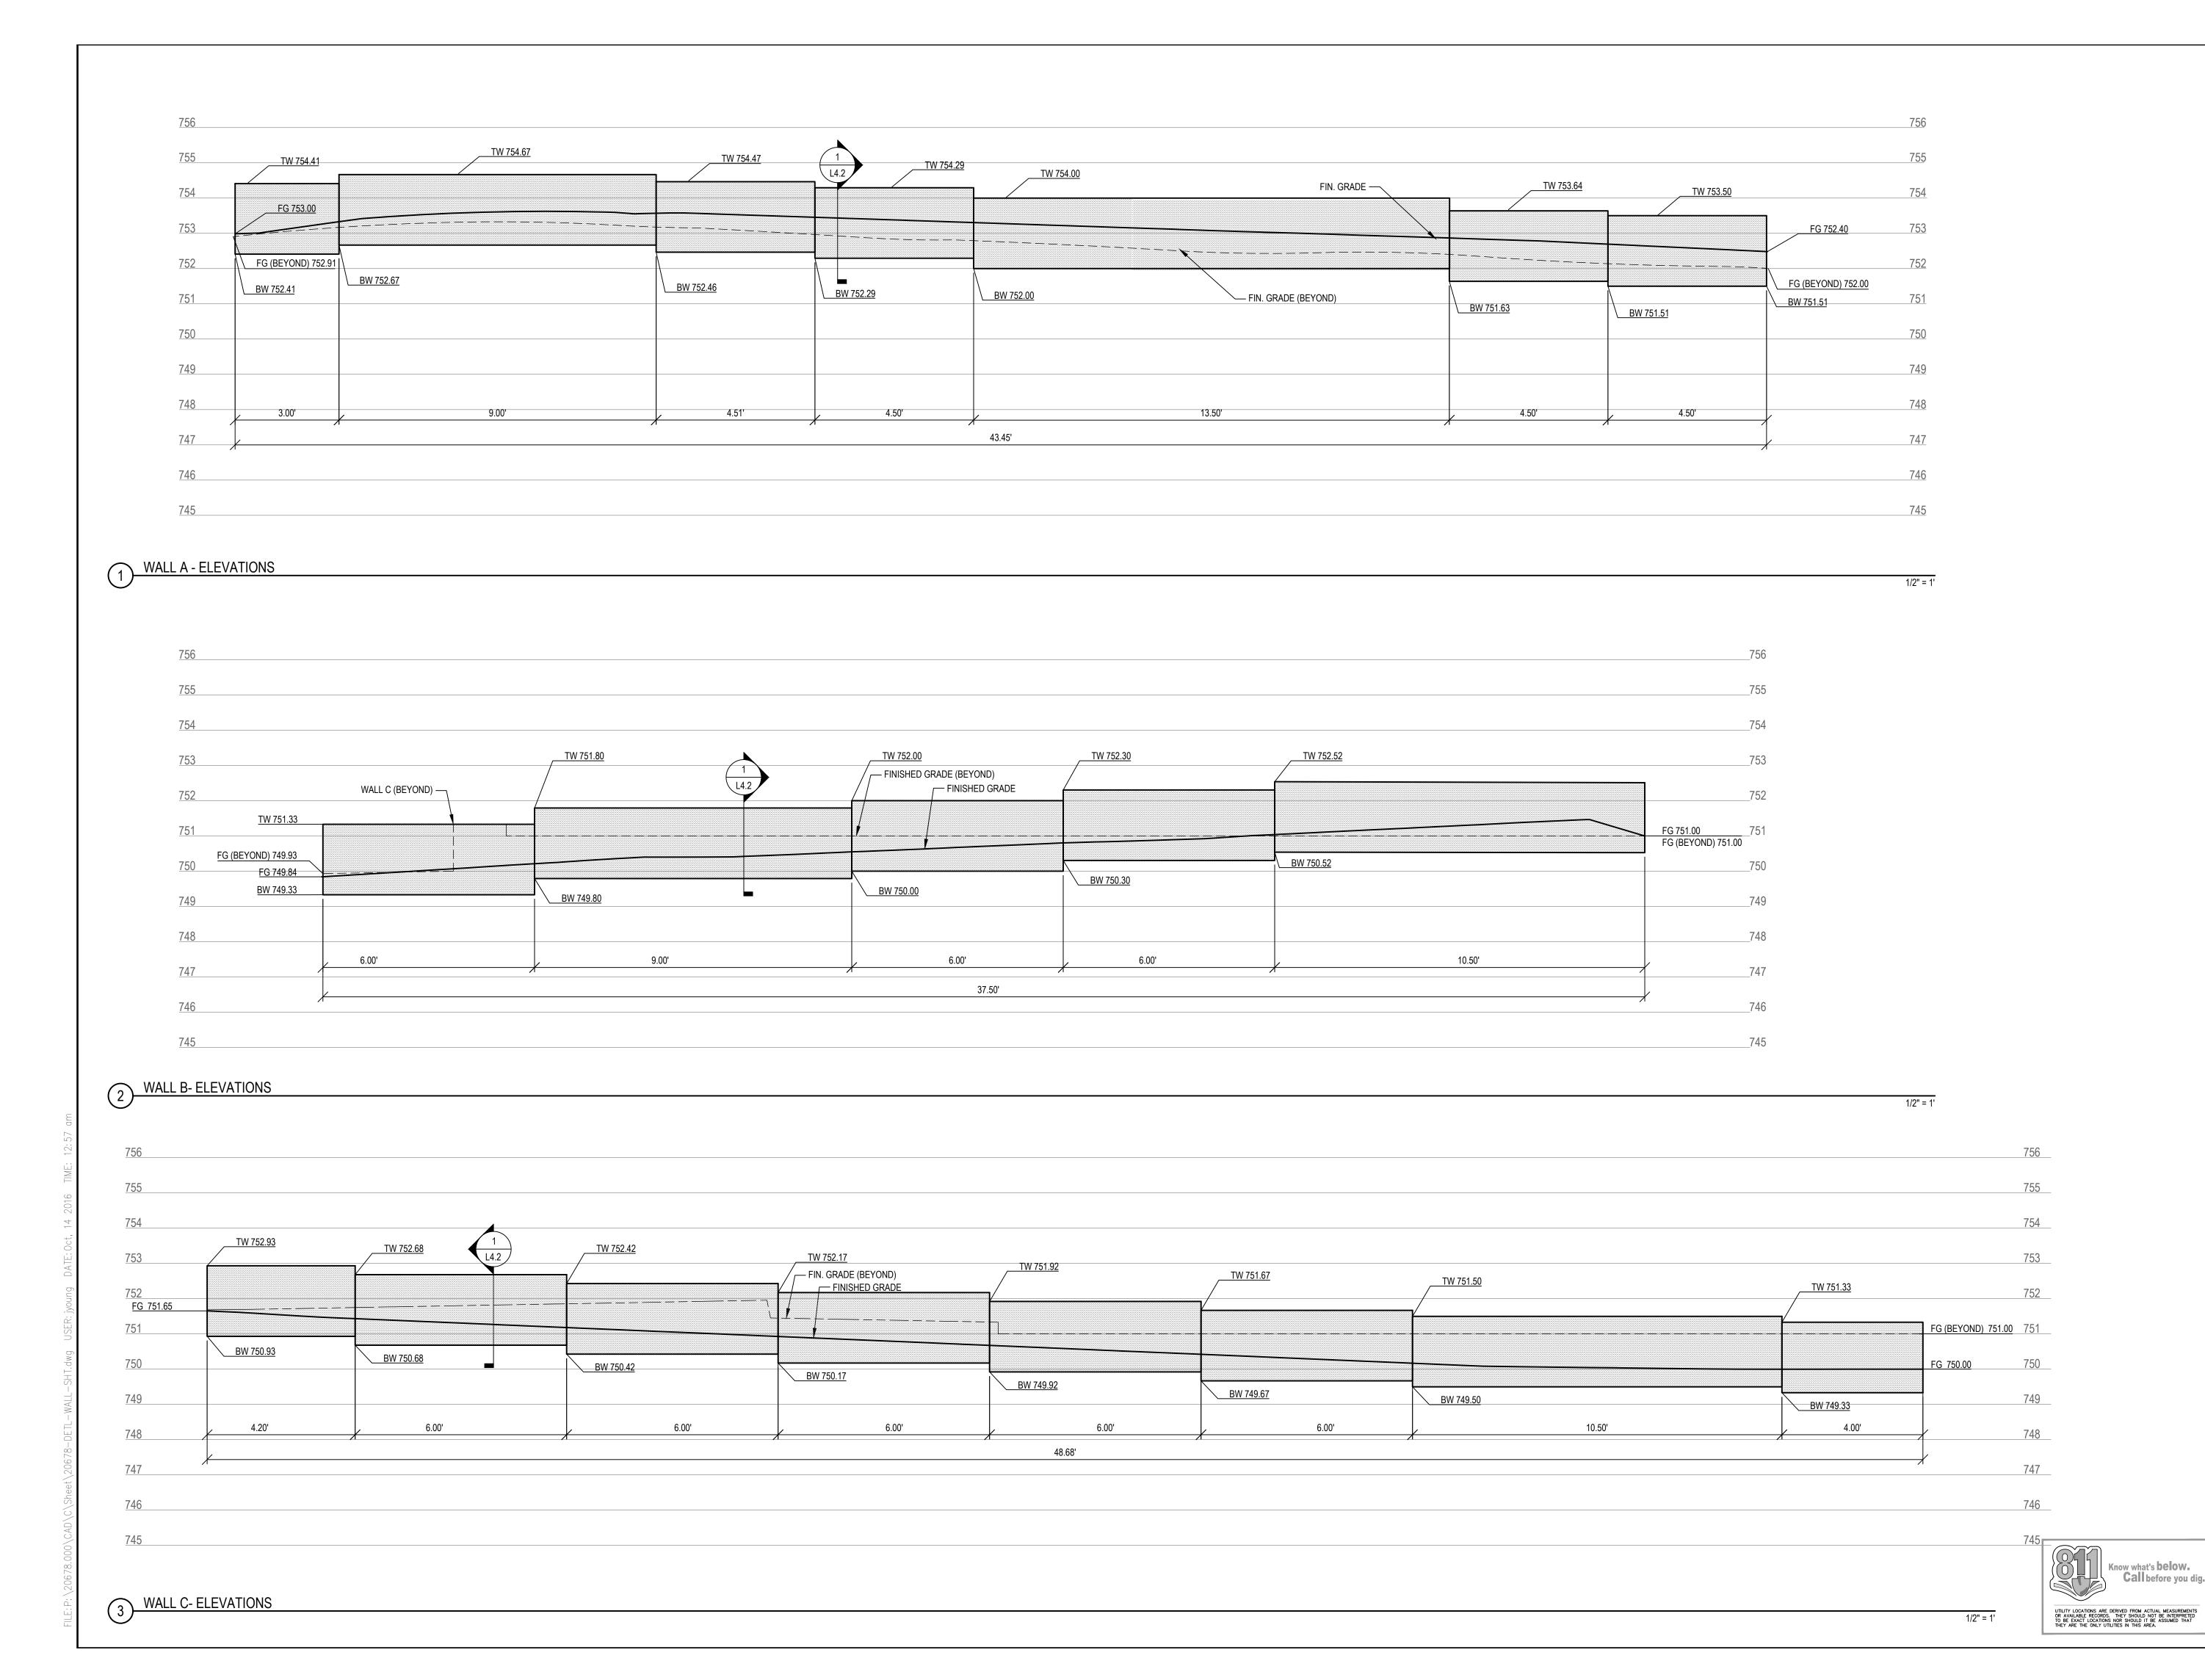
SEALS AND SIGNATURES

KEY PLAN

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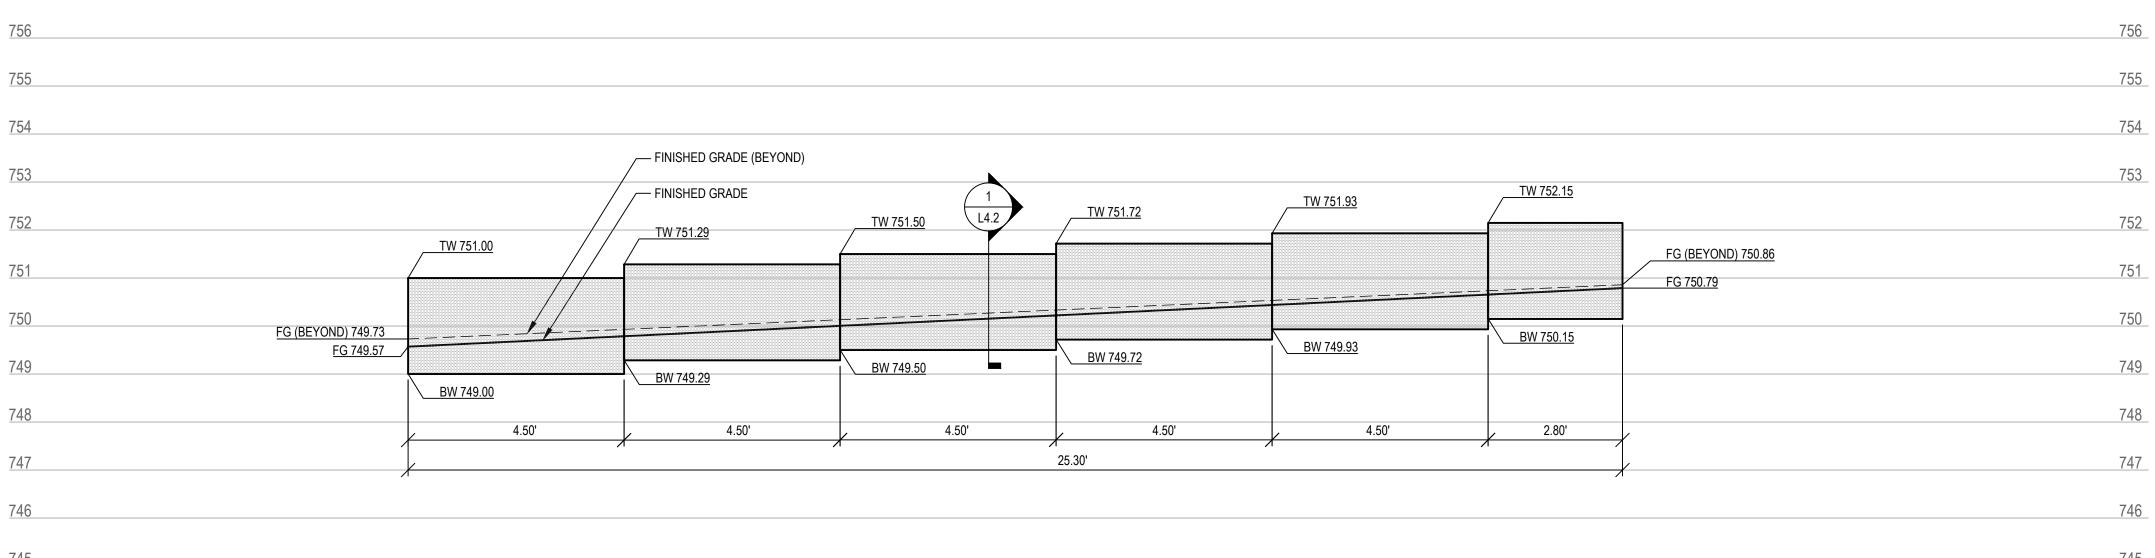
SEALS AND SIGNATURES


SITE WALL DETAILS
AND ELEVATIONS 1

AS NOTED SCALE

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PROJECT NUMBER

DRAWING NUMBER



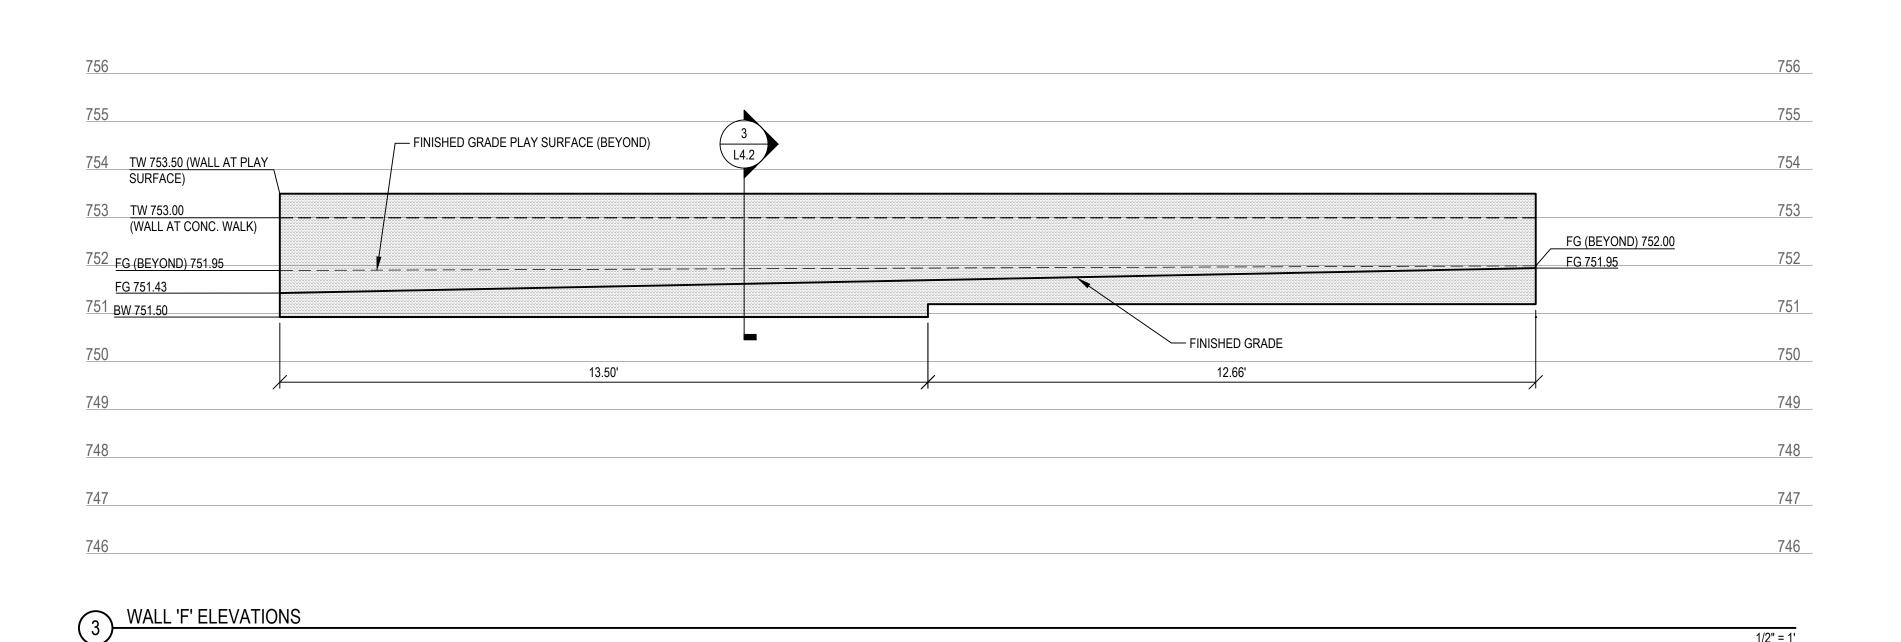



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SEALS AND SIGNATURES		

KEY PL

SITE WALL DETAILS
AND ELEVATIONS 2


Know what's below.
Call before you dig.


ITY LOCATIONS ARE DERIVED FROM ACTUAL MEASUREMENTS
AVAILABLE RECORDS. THEY SHOULD NOT BE INTERPRETED
BE EXACT LOCATIONS NOR SHOULD IT BE ASSUMED THAT
YARF THE ONLY UTILITIES IN THIS AREA

1/2" = 1'

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WALL E- ELEVATIONS



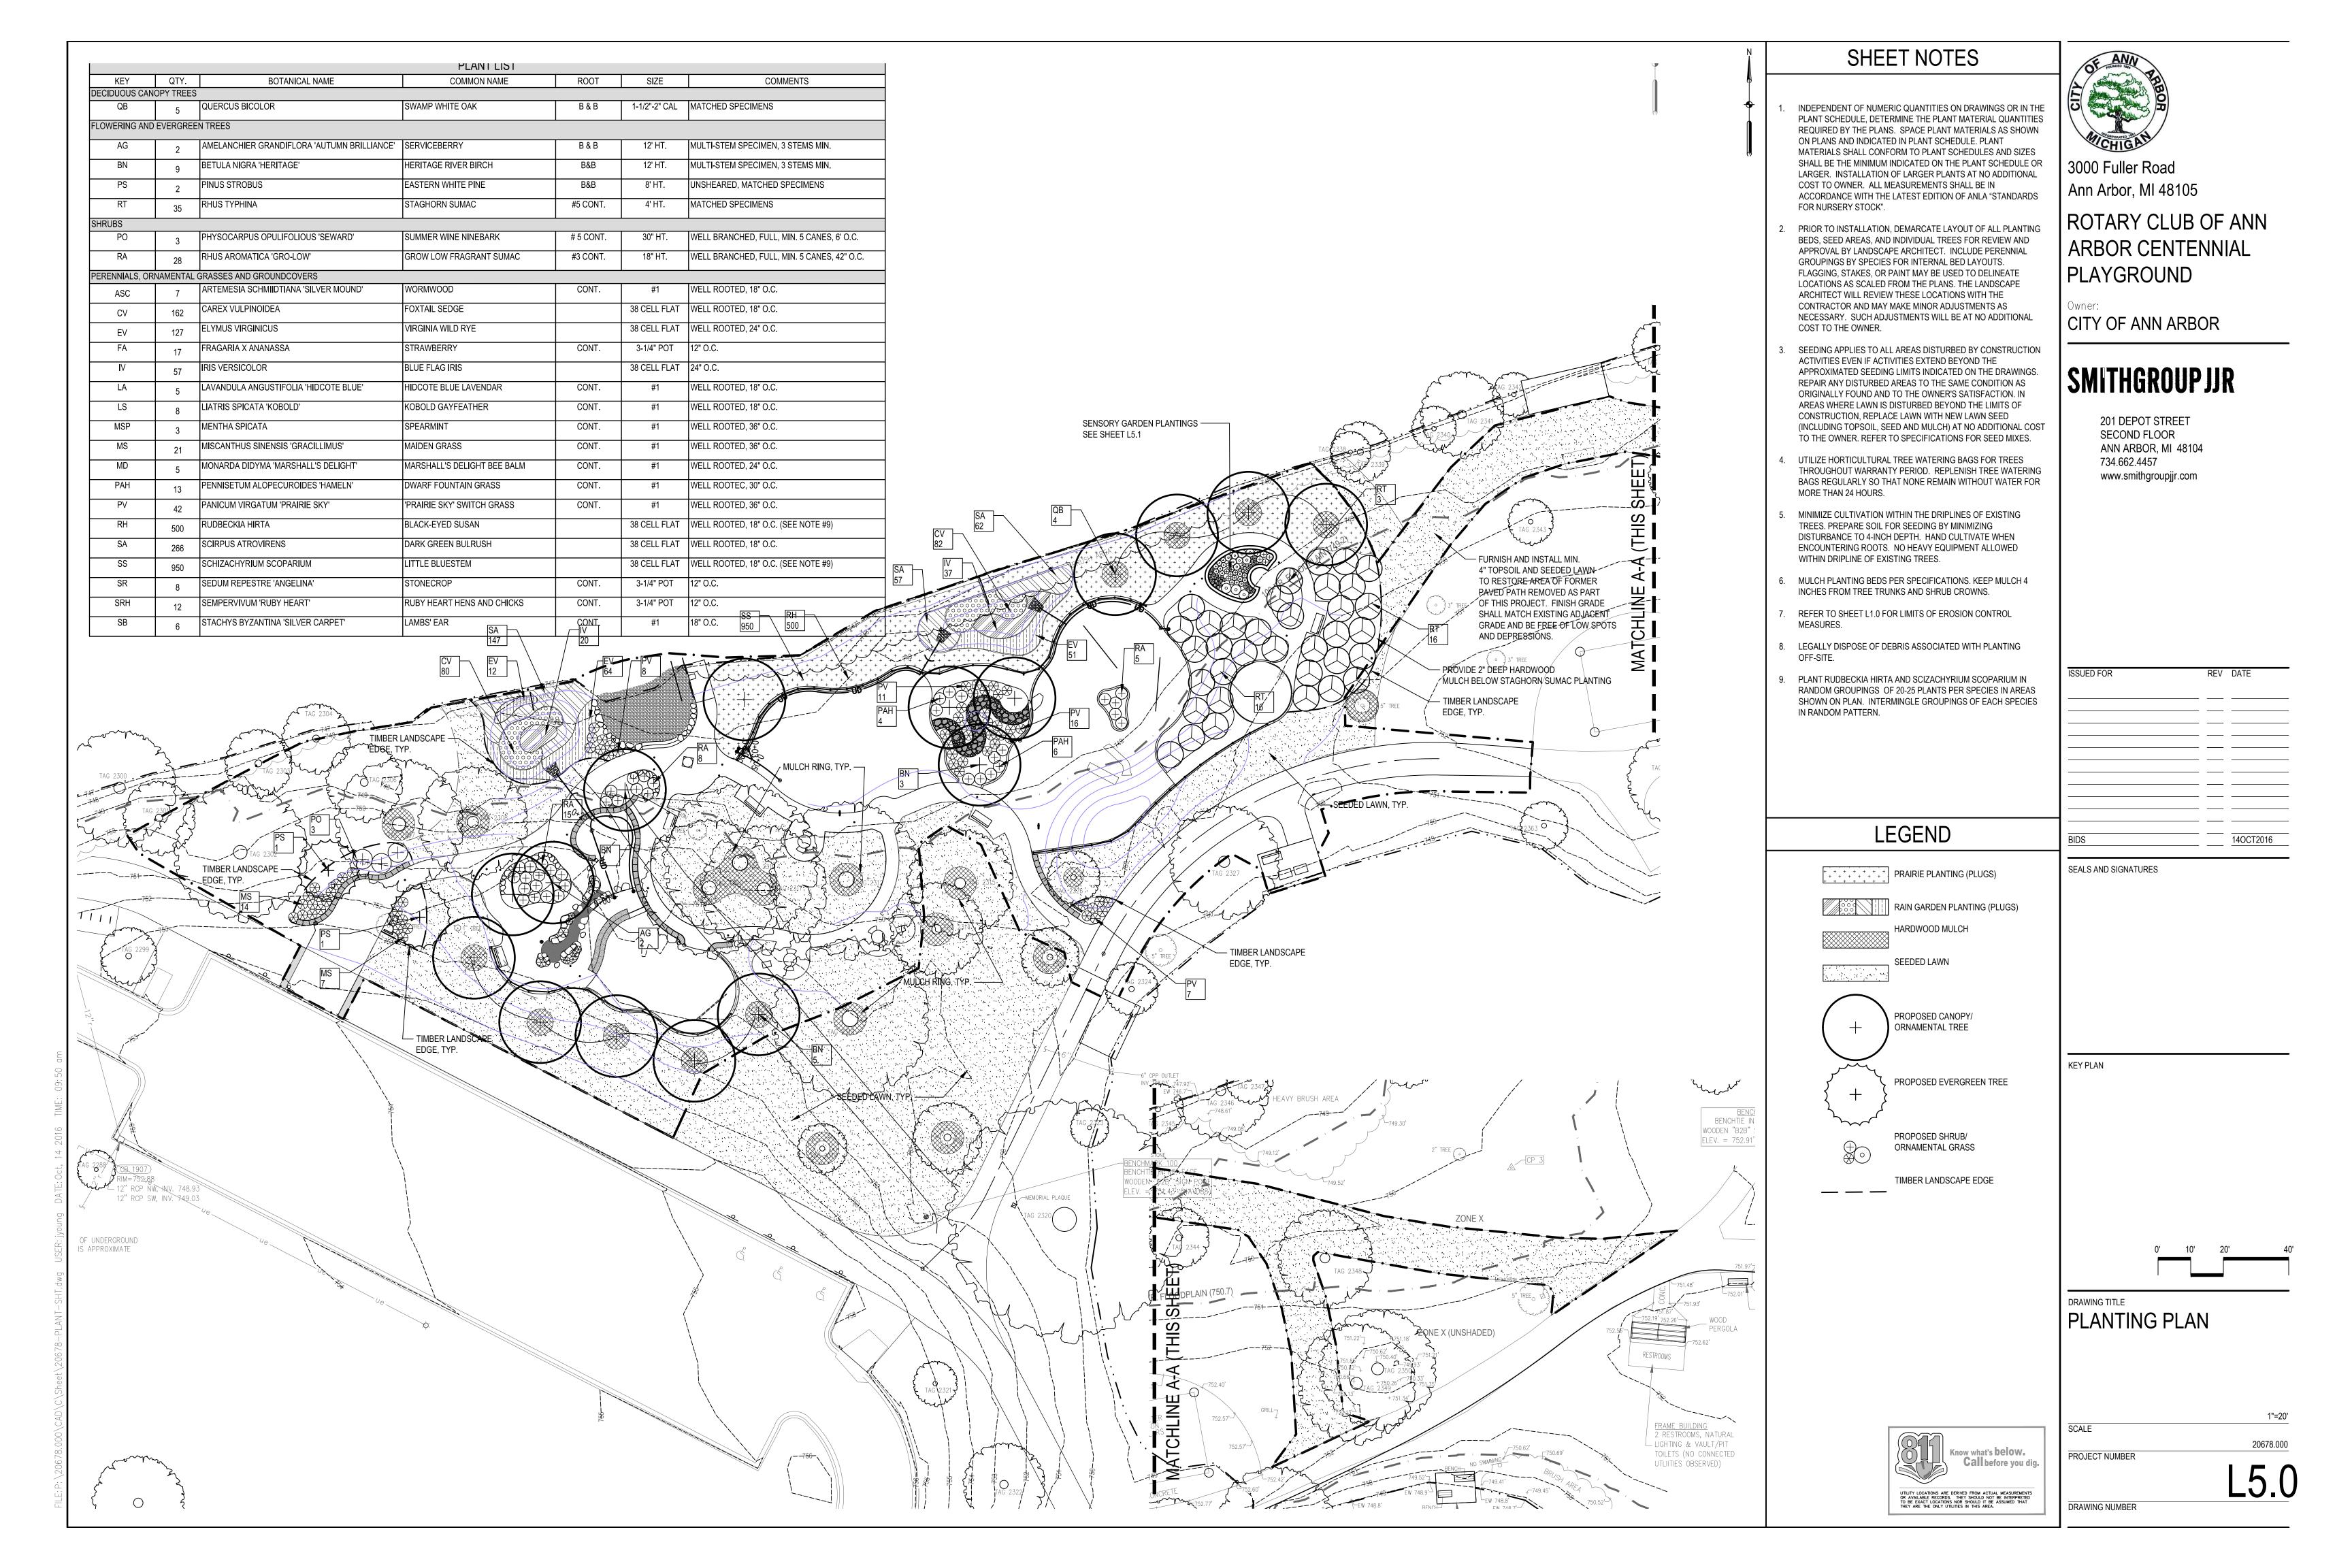

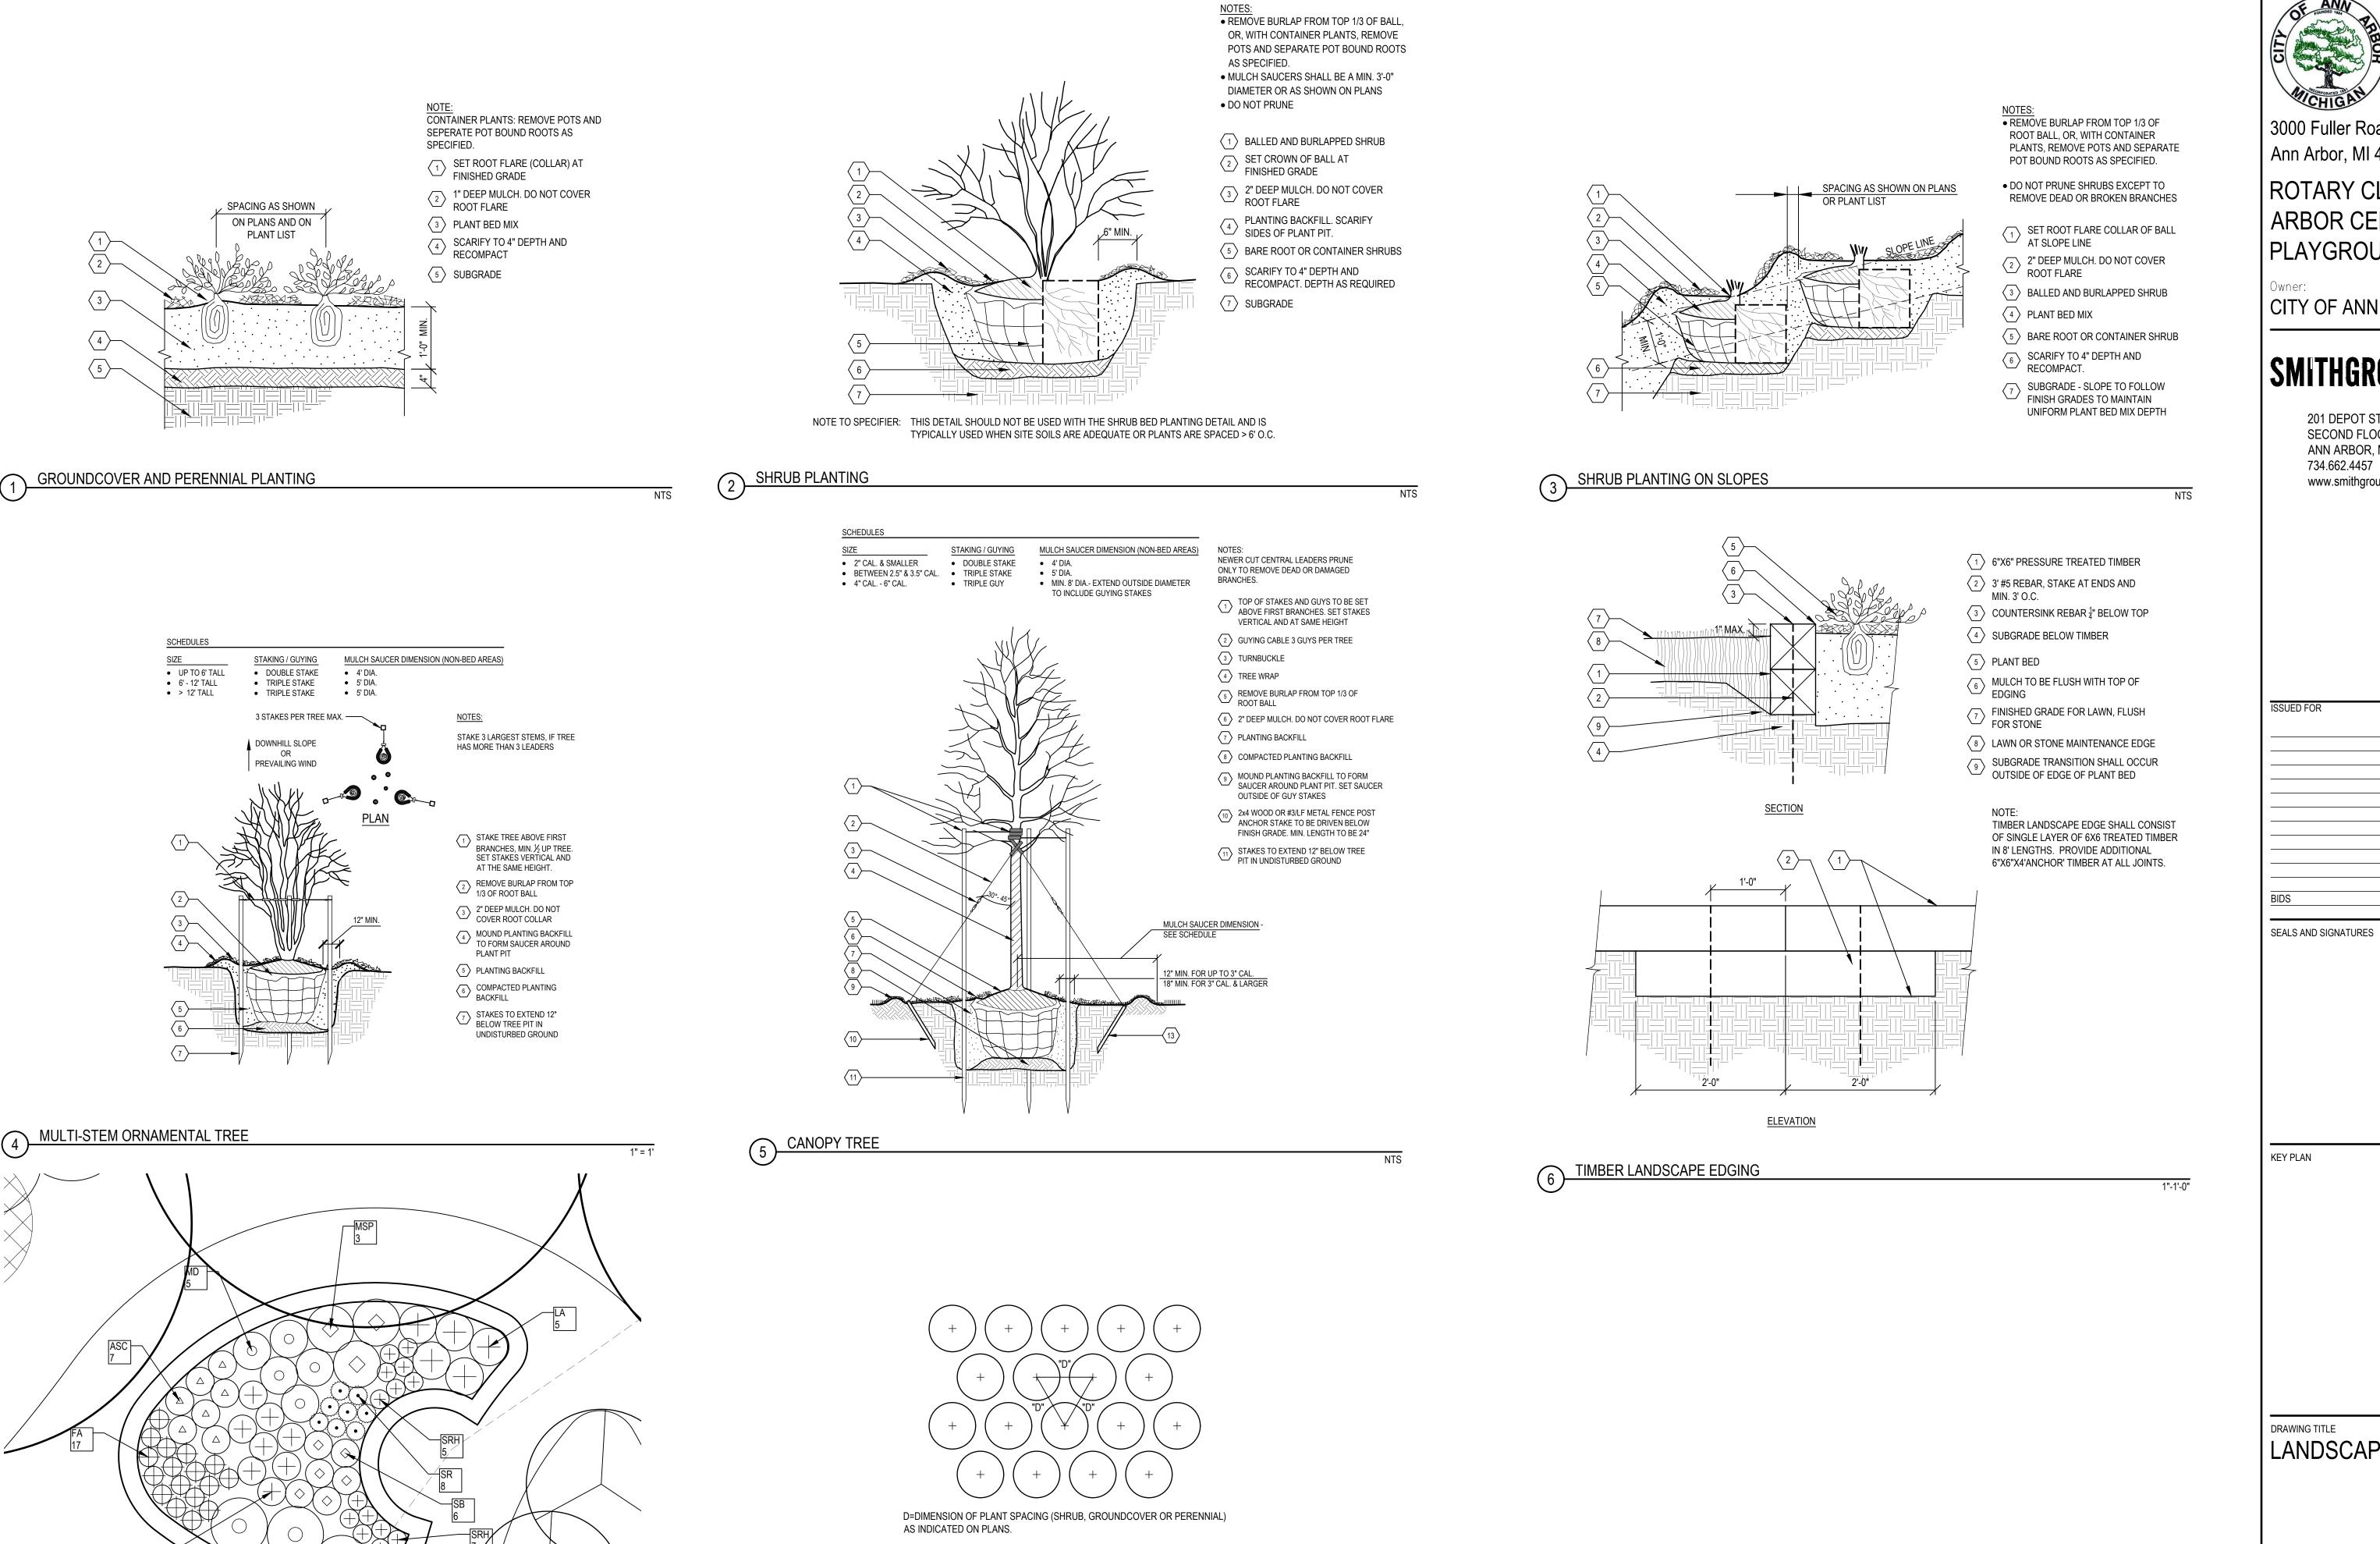NOTE TO SPECIFIER:

TYPICAL PLANT SPACING

SENSORY GARDEN ENLARGEMENT

 IN NARROW BEDS OR WHERE RECTANGULAR BEDS ARE SHOWN W/OUT INDIVIDUAL PLANT SYMBOLS - SPECIFY THE # OF ROWS ON THE PLANS. THIS DETAIL SHOULD BE USED ON ALL PLANT DETAIL SHEETS WHERE

SHRUBS, PERENNIALS & GROUNDCOVER ARE SPECIFIED.



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KEY PLAN

DRAWING TITLE

LANDSCAPE DETAILS

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