


CITY OF ANN ARBOR, MICHIGAN

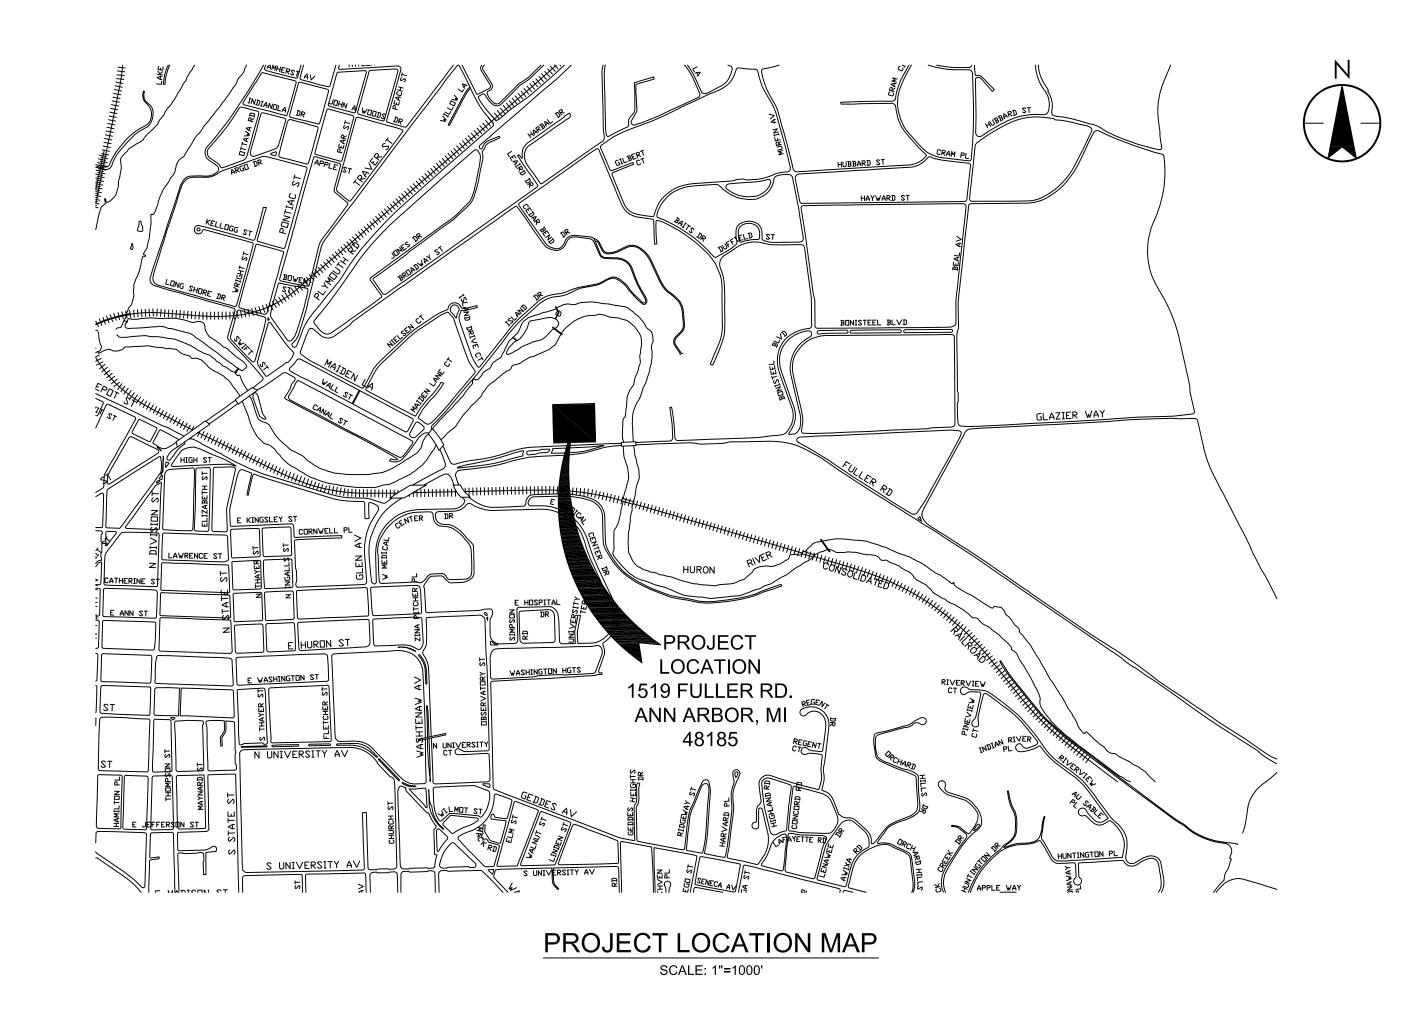

FULLER POOL BOILER REPLACEMENT

ITB #: 4315

DECEMBER, 2013

Project Number: 2075128409

BID SET

DRAWING INDEX:

COVER SHEET

DEMOLITION

D1.01 DEMOLITION - PLAN AND NOTES
D1.02 DEMOLITION - PHOTOS

MECHANICAL

M1.01 MECHANICAL - NEW WORK PLAN

M1.02 MECHANICAL - DETAILS, SCHEDULES AND GENERAL NOTES

ELECTRICAL

E1.01 ELECTRICAL - LEGEND AND NEW WORK PLAN E1.02 ELECTRICAL - WIRING BLOCK DIAGRAM

DEMOLITION NOTES

<u>GENERAL</u>

- 1. ALL WORK SHALL MEET AND BE PERFORMED IN ACCORDANCE WITH ALL APPLICABLE CITY, STATE AND FEDERAL CODES.
- 2. IF CONTRACTOR IS UNSURE IF AN ITEM IS TO BE REMOVED OR NOT, VERIFY WITH OWNER AND/OR ENGINEER BEFORE PROCEEDING. EQUIPMENT REMOVED THAT WAS NOT TO BE, WILL BE REINSTALLED BACK TO ITS ORIGINAL WORKING CONDITION AT THE CONTRACTOR'S OWN EXPENSE.
- 3. THE OWNER SHALL MARK WITH AN INDELIBLE AND VISIBLE MARKING ALL ITEMS/DEVICES TO BE REMOVED IN GOOD CONDITION AND RETAINED BY THE OWNER. IT IS THE RESPONSIBILITY OF THE CONTRACTOR TO: a. DELIVER THE SELECTED OR "MARKED" DEVICES TO THE ALLOCATED FACILITY FOR
 - STORAGE. COORDINATE STORAGE LOCATION WITH OWNER. b. PROPERLY DISPOSE OF UNMARKED AND/OR REMAINING DEVICES TO BE REMOVED.
- 4. MAKE ALL TEMPORARY CONNECTIONS AS REQUIRED TO MAINTAIN OPERATION OF THE FACILITY DURING CONSTRUCTION AND EQUIPMENT REPLACEMENT OR MODIFICATION. SCHEDULE WORK FOR SHUTDOWN, AS REQUIRED, TO REDUCE THE DISRUPTION TO THE REST OF THE CIRCUITRY.
- 5. RELOCATE, MAKE TEMPORARY CONNECTIONS, REINSTALL AND RECONNECT ANY EQUIPMENT AS REQUIRED FOR THE CONSTRUCTION OF NEW PIPING AND SYSTEMS BEING MODIFIED AS PART OF THIS PROJECT.
- 6. CONTRACTOR IS RESPONSIBLE FOR ANY DAMAGE RESULTING FROM OPERATIONS TO EXISTING FACILITIES SUCH AS, BUT NOT LIMITED TO, UNDERGROUND CABLES, HARD SURFACE AREAS, PIPING AND OTHER UTILITIES. CONTRACTOR TO RESTORE, REPLACE OR REPAIR ANY SUCH DAMAGE TO THE SATISFACTION OF THE ENGINEER AND OWNER.
- 7. REFER TO THE SPECIFICATIONS FOR GUIDELINES REGARDING SITE CLEANLINESS.
- 8. ANY ITEM REQUIRED TO BE REMOVED IN THE CONTRACTOR'S JUDGEMENT BUT NOT SHOWN ON DRAWING SHALL BE VERIFIED AND REMOVED/RELOCATED AT NO ADDITIONAL
- 9. EXAMINE THE DRAWINGS AND SPECIFICATIONS OF ALL DIVISIONS AND BECOME FULLY FAMILIAR THE ENTIRE WORK. BEFORE COMMENCING, OBTAIN A RULING FROM THE ENGINEER ON ANY CONFLICTING ISSUES SHOWN ON THE DRAWINGS OR BETWEEN DIVISIONS. NO COMPENSATION WILL BE MADE FOR ANY COSTS ARISING FROM CONFLICT NOT IDENTIFIED BEFORE WORK HAS COMMENCED.
- 10. DRAWINGS INDICATE GENERAL LOCATION AND ROUTING OF CONDUITS, CABLES, PIPING, ELECTRICAL AND MECHANICAL EQUIPMENT ARRANGEMENTS. THEY DO NOT SHOW ALL STRUCTURAL AND ARCHITECTURAL DETAILS. IN SOME CASES, ROUTING IS ONLY SHOWN DIAGRAMMATICALLY ON THE DRAWINGS AND MAY NOT DETAIL EXACT OR COMPLETE REQUIREMENTS.
- 11. COORDINATE THE WORK TO BE PERFORMED OF ALL DIVISIONS REMOVING EQUIPMENT TO ENSURE THAT THERE ARE NO CONFLICTS OR DELAYS.
- 12. PROSPECTIVE BIDDERS SHALL USE THE PRE-BID CONFERENCE TO VISIT THE SITE BEFORE SUBMITTING BIDS TO CAREFULLY EXAMINE ALL EXISTING CONDITIONS AND THOROUGHLY ASCERTAIN THAT THE WORK DESCRIBED ON THE DRAWINGS AND ALL SPECIFICATIONS HAVING A BEARING ON THE WORK CAN BE CARRIED OUT SATISFACTORILY WITHOUT ANY CHANGES TO THE DRAWINGS OR SPECIFICATIONS. NO EXTRAS WILL BE ALLOWED FOR ANYTHING THAT WOULD HAVE BEEN REVEALED IN THE COURSE OF SUCH AN EXAMINATION.
- 13. PROVIDE QUALIFIED PERSONNEL TO DO BOTH THE REMOVAL AND INSTALLATION OF ALL EQUIPMENT AS NOTED ON THE DRAWINGS OR STATED IN THE SPECIFICATIONS.

ELECTRICAL

- 1. THE REMOVAL OF EQUIPMENT SHALL INCLUDE ALL ASSOCIATED WIRING, RACEWAYS, ETC. UNLESS OTHERWISE NOTED.
- 2. PATCH ALL HOLES IN EXISTING INTERIOR AND EXTERIOR WALLS, STRUCTURES, BASES, CEILINGS, ETC. RESULTING FROM THE REMOVAL OF RACEWAYS. PATCHING SHALL MATCH EXISTING MATERIALS OF CONSTRUCTION (I.E. BRICK, BLOCK, CONCRETE, ETC.)
- 3. ENSURE SERVICE CONTINUITY TO EXISTING CIRCUITS NOT AFFECTED BY THE CONSTRUCTION WORK. MAKE TEMPORARY CONNECTIONS IF NECESSARY.
- 4. DISCONNECT AND MAKE SAFE ALL EXISTING POWER AND CONTROL WIRING AS NOTED TO BE REMOVED. ASSOCIATED LOW VOLTAGE WIRING TO BE REMOVED.
- 5. CONDUIT AND EQUIPMENT TO BE REMOVED ARE INDICATED ON THIS SHEET. REMOVE ITEMS AS INDICATED AND AS REQUIRED TO ACCOMMODATE THE NEW WORK.

MECHANICAL

- PIPING AND EQUIPMENT TO BE REMOVED ARE INDICATED ON SHEET D1.01 & D1.02. REMOVE ITEMS AS INDICATED AND AS REQUIRED TO ACCOMMODATE THE NEW WORK.
- 2. REMOVE BOILER IN THE BOILER ROOM, ALL ASSOCIATED PIPING, AND FLUE AS SHOWN ON SHEET D1.01.
- 3. VERIFY EXACT SIZES, LOCATIONS AND QUANTITIES OF ALL ITEMS IN FIELD PRIOR TO PREPARING SHOP DRAWINGS.
- 4. CHECK WITH ENGINEER FOR ITEMS TO BE SALVAGED AND RETURN SUCH ITEMS TO THE OWNER. ALL OTHER ITEMS SHALL BE HAULED AWAY FROM SITE.
- 5. ALL PIPING WHICH ARE DISCONNECTED, SHALL BE TEMPORARILY VALVED & CAPPED TILL NEW CONNECTIONS ARE MADE.
- 6. ALL DUCTWORK WHICH IS DISCONNECTED, SHALL BE TEMPORARILY CAPPED UNTIL NEW CONNECTIONS ARE MADE.

7. ALL OPENINGS REMAINING IN WALLS/FLOOR/ROOF, AFTER DEMOLITION WORK IS DONE,


FINISHES, UNLESS OTHERWISE SHOWN. 8. INSULATION ON MATERIALS TO BE REMOVED SHALL BE IDENTIFIED BEFORE ATTEMPTING

SHALL BE PATCHED BY THE CONTRACTOR WITH MATERIALS SO AS TO MATCH EXISTING

- DEMOLITION AND EPA REGULATION SHALL BE COMPLIED WITH.
- 10. CAP PIPING BELOW FLOOR/BEHIND WALL AS REQUIRED.

CONTRACTOR SHALL REMOVE PIPE OR DUCT HANGERS AND SUPPORTS.

- 11. DEMOLITION TO BE CARRIED OUT IN A MANNER TO PREVENT DAMAGE TO ANY EXISTING SERVICE OR STRUCTURE.
- 12. CONTRACTOR SHALL BE RESPONSIBLE FOR REPAIRING ANY DAMAGE THAT MAY OCCUR.
- 13. REMOVE EXISTING CONCRETE PADS USED FOR THE EXISTING BOILER AND REPAIR FLOOR. REPAIR THE FLOOR WITH A THIN SET PATCHING MATERIAL BY SIKA. PROVIDE SATURATED SURFACE DRY CONDITION AND APPLY BONDING AGENT PRIOR TO THE THIN SET MATERIAL.

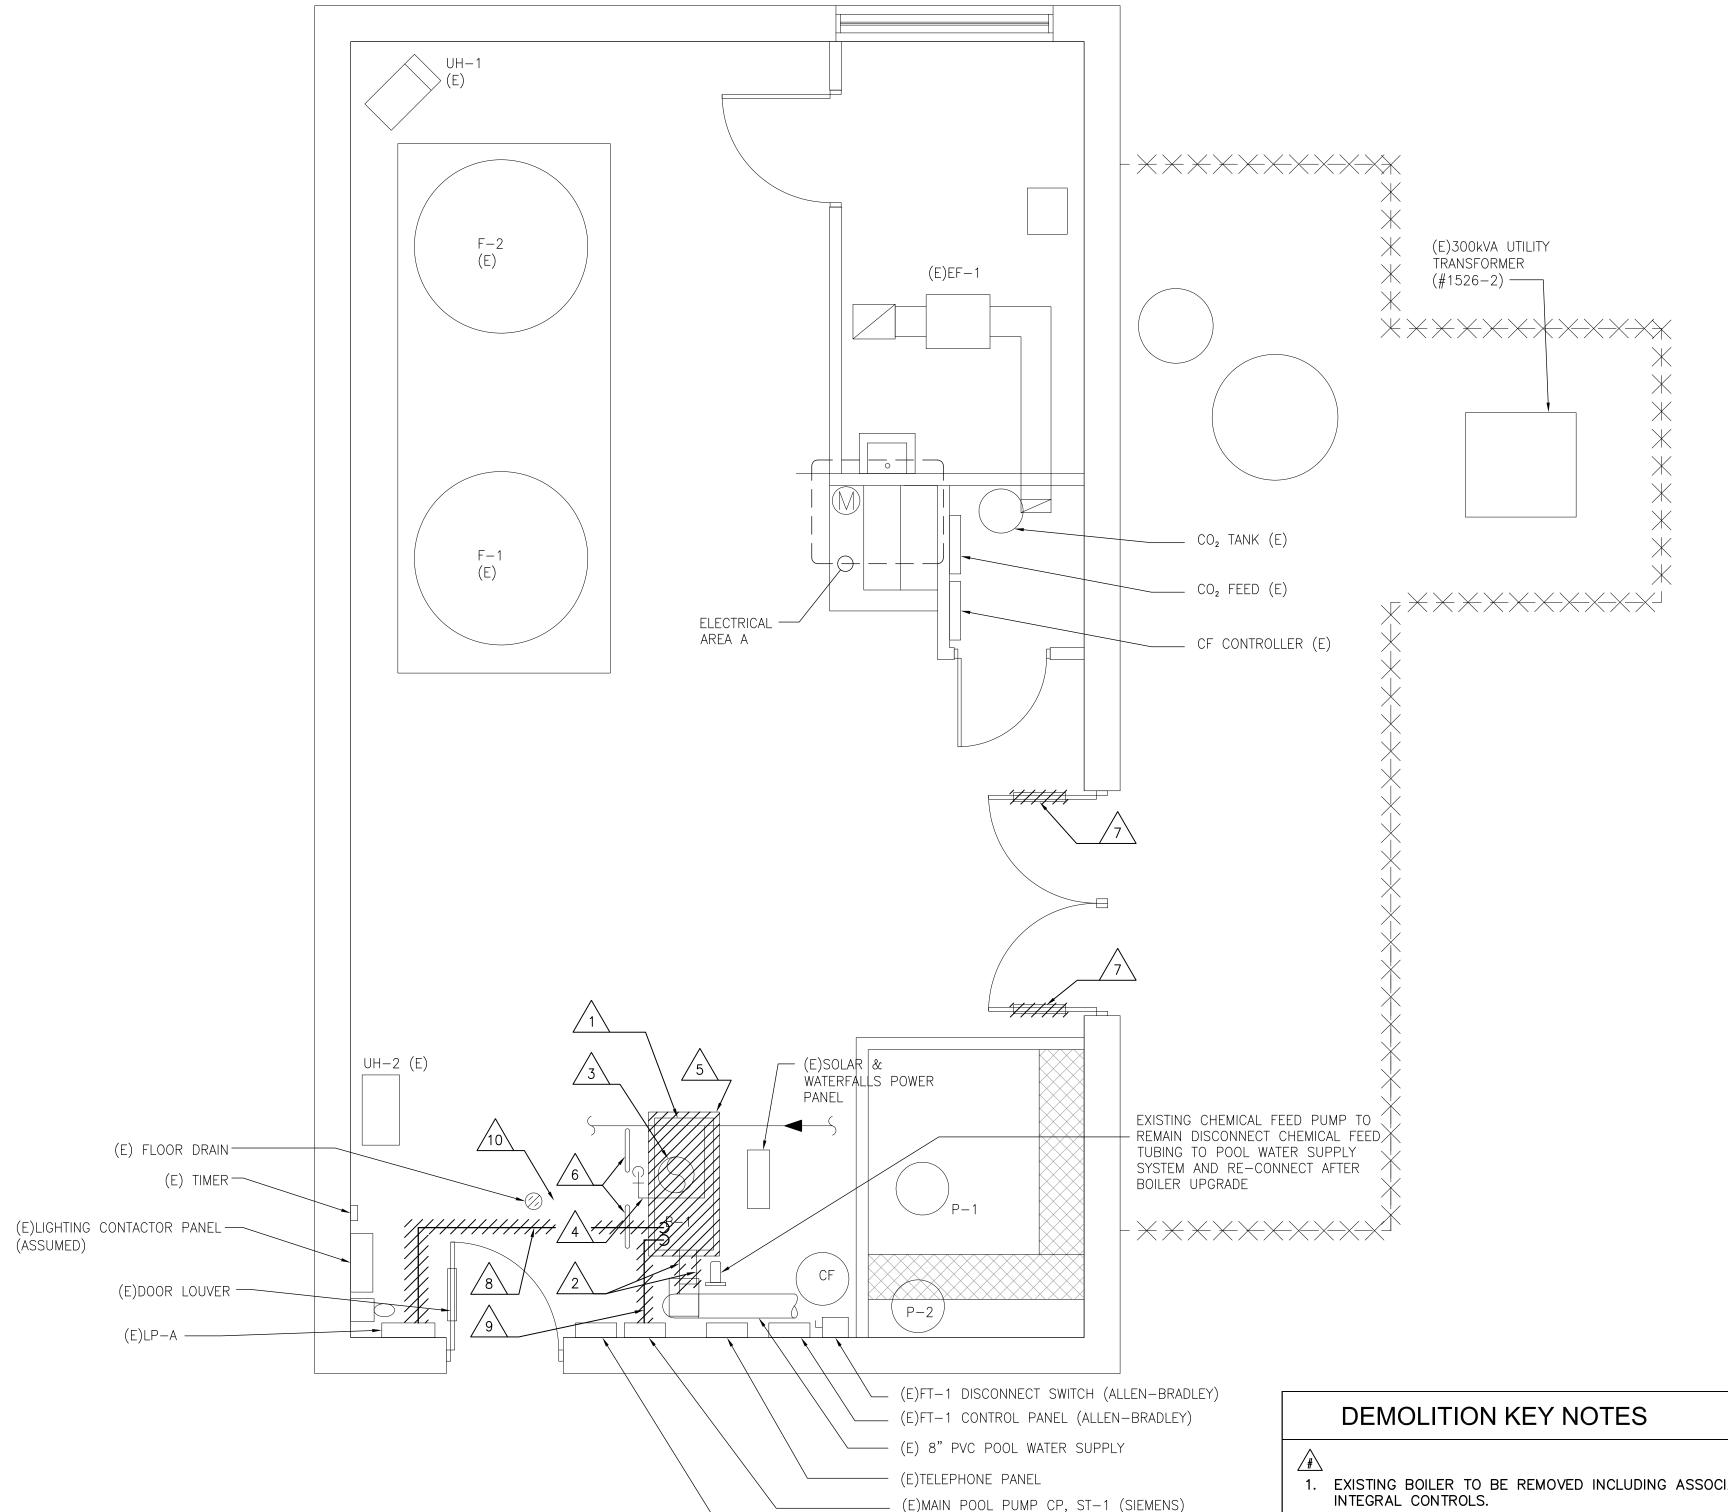

DEMOLITION PLAN N.T.S.

(E)PUMP CONTROLS (HYDROMATIC

ELECTRICAL CONTROLS)

- 1. EXISTING BOILER TO BE REMOVED INCLUDING ASSOCIATED INTEGRAL CONTROLS.
- 2. REMOVE WATER SUPPLY AND RETURN PIPING WITH ACCESSORIES AND THE FITTINGS IN THE POOL WATER MAIN AS
- 3. REMOVE BOILER STACK AND REUSE THE OPENING FOR NEW BOILER STACK.
- 4. REMOVE THE PORTION OF THE NATURAL GAS PIPING AS REQUIRED.
- 5. REMOVE EXISTING CONCRETE HOUSEKEEPING PAD. ENCAPSULATED THE DEMOLITION WORK WITH PLASTIC SHEETING TO CONTROL DUST.
- 6. REMOVE EXISTING MAINTENANCE BARRIER AND RE-INSTALL AFTER THE BOILER UPGRADE (TYP. 2). REINSTALL WITH S.S. HARDWARE.
- 7. REMOVE EXISTING DOOR LOUVER IN PREPARATION FOR NEW DOOR LOUVER. (TYP. 2).
- 8. DISCONNECT AND REMOVE EXISTING POWER FEEDER FROM PANEL LP-A TO THE BOILER COMPLETE INCLUDING EXISTING RIGID AND FLEXIBLE CONDUIT AND BREAKER. PROVIDE NEW BREAKER AS PER THE NEW WORKS. RE-USE EXISTING CIRCUIT #14 SPACE FOR NEW BOILER POWER. NOTE: CONDUIT ROUTING IS DIAGRAMMATIC. VERIFY ON SITE.
- 9. DISCONNECT AND REMOVE EXISTING STARTER CONTROL CONDUCTOR TO EXISTING PUMP PANEL.
- 10. SAW CUT EXISTING CONCRETE FLOOR TO EXTEND THE FLOOR



Stantec Consulting Michigan Inc. 3754 Ranchero Drive Ann Arbor MI U.S.A. 734.761.1010

734.761.1200

The Contractor shall verify and be responsible for all dimensions. DO NOT scale the drawing — any errors or omissions shall be reported to Stantec without delay The Copyrights to all designs and drawings are the property of Stantec. Reproduction or use for any purpose other than that authorized by Stantec is forbidden.

ITEMS TO BE DEMOLISHED

Consultants

Legend

Notes

Revision B BID SET SA SA 2013.12.03 A OWNER REVIEW SA SA 2013.11.22 Appd. YY.MM.DD Issued File Name: 2075128409_D1.01 Q.K. WMJ/SA WMJ/ZM 2013.12.10 Dwn. Chkd. Dsgn. YY.MM.DD

Permit-Seal

Client/Project CITY OF ANN ARBOR

FULLER POOL BOILER REPLACEMENT ANN ARBOR, MI

DEMOLITION PLAN AND NOTES

Project No. Scale AS NOTED Sheet Drawing No.

2 of 7



PHOTO No.1 - WATER SUPPLY AND PUMP CONTROL PANELS



PHOTO No.2 - BOILER

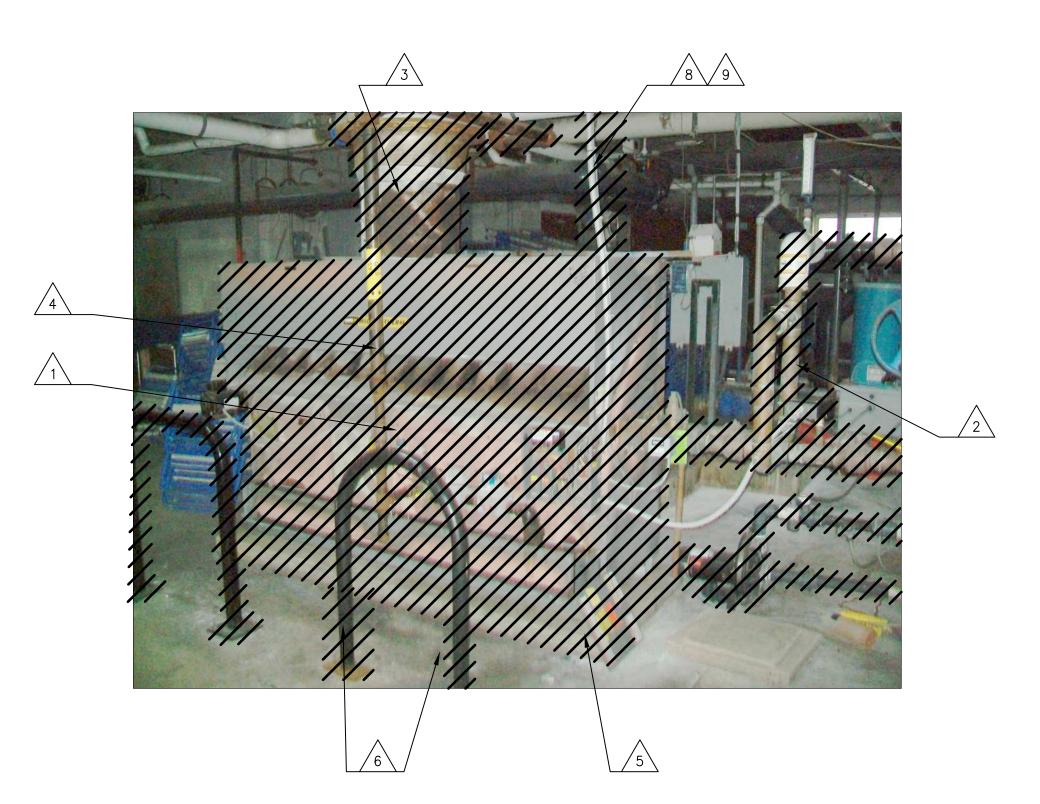


PHOTO No.3 - BOILER



PHOTO No.4 - BOILER STACK

DEMOLITION KEY NOTES

- 1. EXISTING BOILER TO BE REMOVED INCLUDING ASSOCIATED CONTROLS, CONCRETE PAD, AND ALL RELATED EQUIPMENT AND ACCESSORIES.
- REMOVE WATER SUPPLY AND RETURN PIPING INCLUDING ACCESSORIES AND THE FITTINGS, AND VALVE IN THE POOL WATER MAIN AS SHOWN.
- 3. REMOVE BOILER STACK AND REUSE THE OPENING FOR NEW BOILER STACK.
- 4. REMOVE THE PORTION OF THE NATURAL GAS PIPING AS SHOWN AND AS REQUIRED.
- 5. REMOVE EXISTING CONCRETE HOUSEKEEPING PAD AND PATCH FLOOR.
- 6. REMOVE EXISTING MAINTENANCE BARRIER AND RE-INSTALLED AFTER THE BOILER UPGRADE.
- REMOVE EXISTING DOOR LOUVER IN PREPARATION FOR NEW DOOR LOUVER.
- DISCONNECT AND REMOVE EXISTING POWER FEEDER FROM PANEL LP—A TO THE BOILER COMPLETE INCLUDING EXISTING RIGID AND FLEXIBLE CONDUIT.
- DISCONNECT AND REMOVE EXISTING CONTROL CONDUCTOR TO EXISTING PUMP PANEL.



Stantec Consulting Michigan Inc. 3754 Ranchero Drive Ann Arbor MI U.S.A. 48108

734.761.1200

734.761.1010

The Contractor shall verify and be responsible for all dimensions. DO NOT scale the drawing — any errors or omissions shall be reported to Stantec without delay.

The Copyrights to all designs and drawings are the property of Stantec. Reproduction or use for any purpose other than that authorized by Stantec is forbidden.

Consultants

Legend

ITEMS TO BE DEMOLISHED

Notes

 B
 BID SET
 SA
 SA
 2013.12.03

 A
 OWNER REVIEW
 SA
 SA
 2013.11.22

 Issued
 By
 Appd.
 YY.MM.DD

 File Name: 2075128409_D1.02
 Q.K.
 WMJ/SA
 WMJ/ZM
 2013.12.10

 Dwn.
 Chkd.
 Dsgn.
 YY.MM.DD

Permit-Seal

ent/Project

CITY OF ANN ARBOR

FULLER POOL BOILER REPLACEMENT ANN ARBOR, MI

itle

DEMOLITION PHOTOS

Project No.
2075128409

Drawing No.

Scale

AS NOTED


Sheet

NEW WORK GENERAL NOTES

- 1. ALL NEW WORK SHALL MEET AND BE PERFORMED IN ACCORDANCE WITH ALL APPLICABLE CITY, STATE AND FEDERAL CODES.
- 2. ALL NEW MATERIALS INCLUDING FASTENERS, HARDWARE, STRAPS, SUPPORTS, BOLTS, NUTS, INSERTS, HANGERS, ETC. SHALL BE 304 STAINLESS STEEL.
- 3. ALL NEW ROOF AND WALL PENETRATIONS SHALL BE SEALED WATER TIGHT.

GENERAL MECHANICAL NOTES

- CONTRACTOR SHALL RECORD ON AS-BUILT DRAWINGS ALL SIZES, MATERIALS, ELEVATIONS AND LOCATIONS OF ALL EQUIPMENT AND DUCTWORK THAT DEVIATES FROM THE DESIGN CONTRACT DRAWINGS.
- 2. ALL WORK AND MATERIALS SHALL CONFORM TO THE LATEST EDITION OF THE BUILDING AND MECHANICAL CODES AND ALL OTHER AUTHORITIES HAVING JURISDICTION.
- 3. PRIOR TO START OF CONSTRUCTION COORDINATE INSTALLATION OF MECHANICAL WORK TO AVOID UNNECESSARY JOB DELAYS OR INTERFERENCE WITH ALL OTHER TRADES.
- 4. OBTAIN ALL FIELD APPROVALS ON MECHANICAL WORK FROM REGULATING AGENCIES WHERE REQUIRED.
- 5. ALL EQUIPMENT SHALL BE U.L. LISTED.
- 6. PROVIDE MINIMUM ONE YEAR GUARANTEE ON ALL LABOR AND MATERIALS UNLESS NOTED OTHERWISE ON CONTRACT DOCUMENTS OR SPECIFICATION.
- 7. INSTALLATION OF VENTILATION OR HEAT PRODUCING EQUIPMENT SHALL BE IN ACCORDANCE WITH NFPA 211, NFPA 31 AND PAMPHLET 91, NFPA 54 AS APPLICABLE.
- 8. ALL HVAC WORK SHALL BE IN COMPLIANCE WITH NFPA 90A AND 90B AS APPLICABLE AND IN STRICT ACCORDANCE WITH MANUFACTURER'S INSTALLATION INSTRUCTIONS.
- 9. MECHANICAL DRAWINGS ARE SCHEMATIC IN NATURE AND ARE TO CONVEY DESIGN INTENT ONLY. REQUIRED OFFSETS, FITTINGS AND GENERAL INSTALLATION REQUIREMENTS ARE THE RESPONSIBILITY OF THE CONTRACTOR.

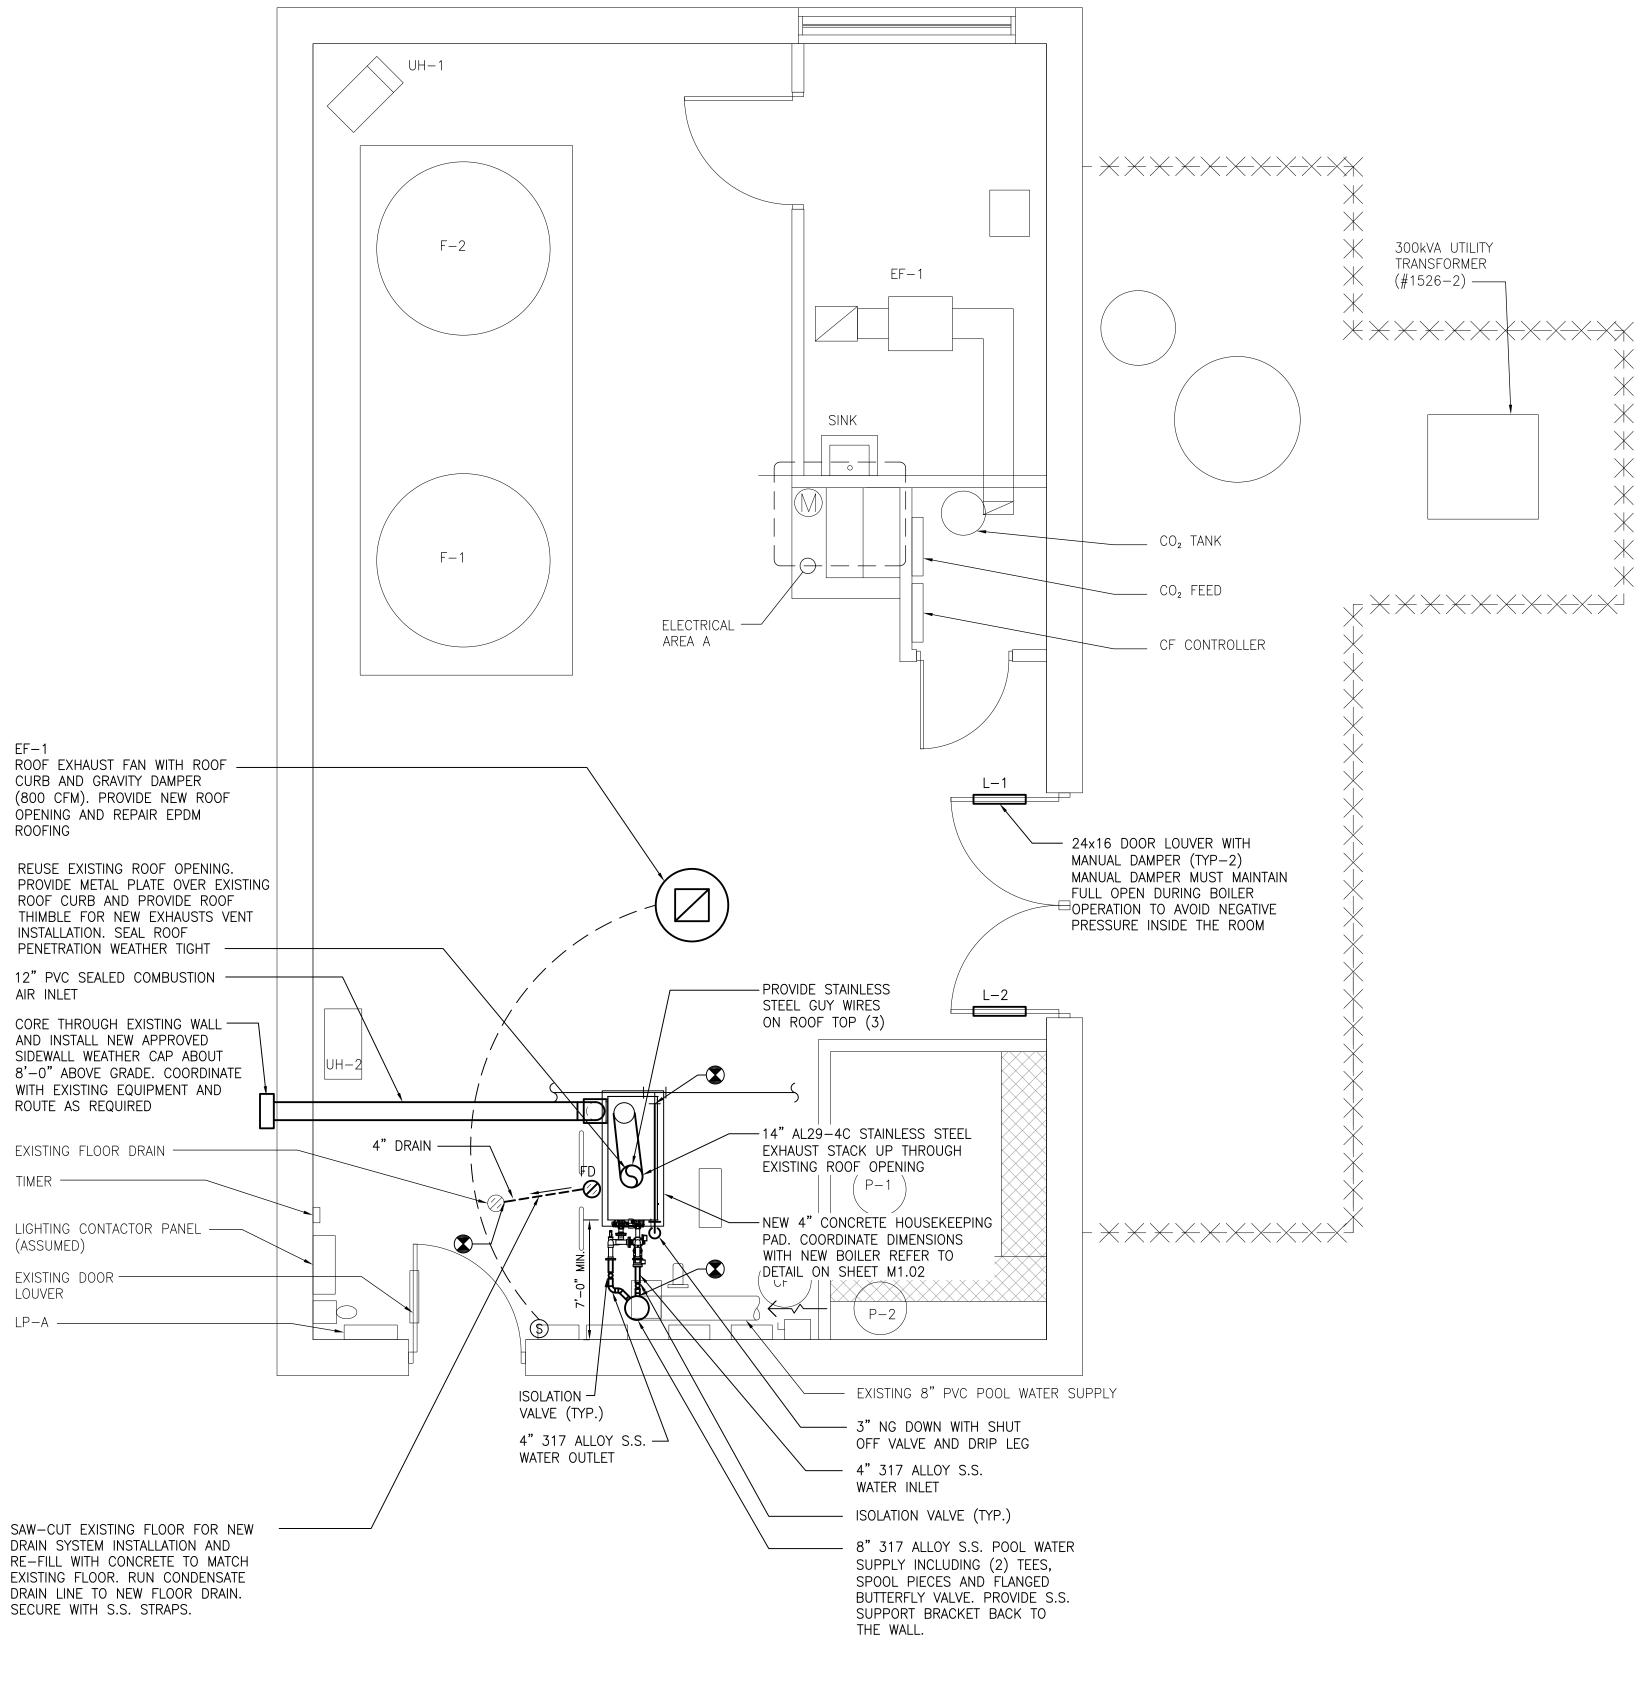

NEW WORK PLAN
N.T.S.

NOTES:

ALL PIPE MATERIAL INLET AND OUTLET CONNECTIONS TO BOILER SHALL BE PER THE BOILER SUPPLIER RECOMMENDATION.



Stantec Consulting Michigan Inc. 3754 Ranchero Drive Ann Arbor MI U.S.A. 48108 734.761.1010 734.761.1200

Copyright Reserv

The Contractor shall verify and be responsible for all dimensions. DO NOT scale the drawing — any errors or omissions shall be reported to Stantec without delay.

The Copyrights to all designs and drawings are the property of Stantec. Reproduction or use for any purpose other than that authorized by Stantec is forbidden.

Consultants

Legend

POINT OF CONNECTION

Notes

 Revision
 By
 Appd.
 YY.MM.DD

 B BID SET
 SA SA 2013.12.03

 A OWNER REVIEW
 SA SA 2013.11.22

 Issued
 By Appd.
 YY.MM.DD

 File Name: 2075128409_M1.01
 Q.K. W.M.J. W.M.J. W.M.J. 2013.12.10

 Dwn. Chkd. Dsgn. YY.MM.DD

Permit-Seal

Client/Project
CITY OF ANN ARBOR

FULLER POOL BOILER REPLACEMENT ANN ARBOR, MI

itle

MECHANICAL NEW WORK PLAN

Project No.
2075128409

Drawing No.


Scale

AS NOTED

Sheet


1.01


4 of 7

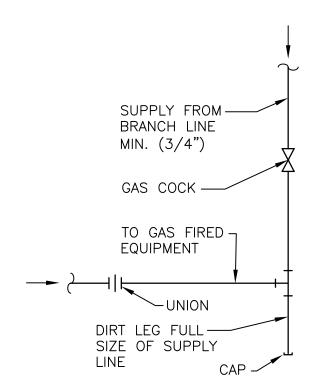


DIRT LEG AT ALL GAS PIPE DROPS

SCALE: NONE

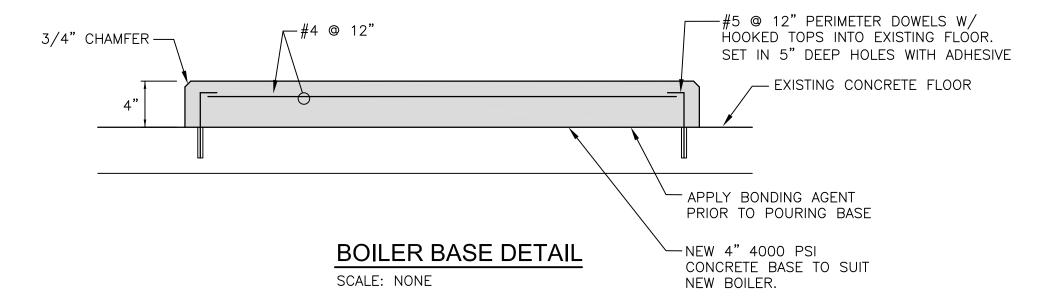

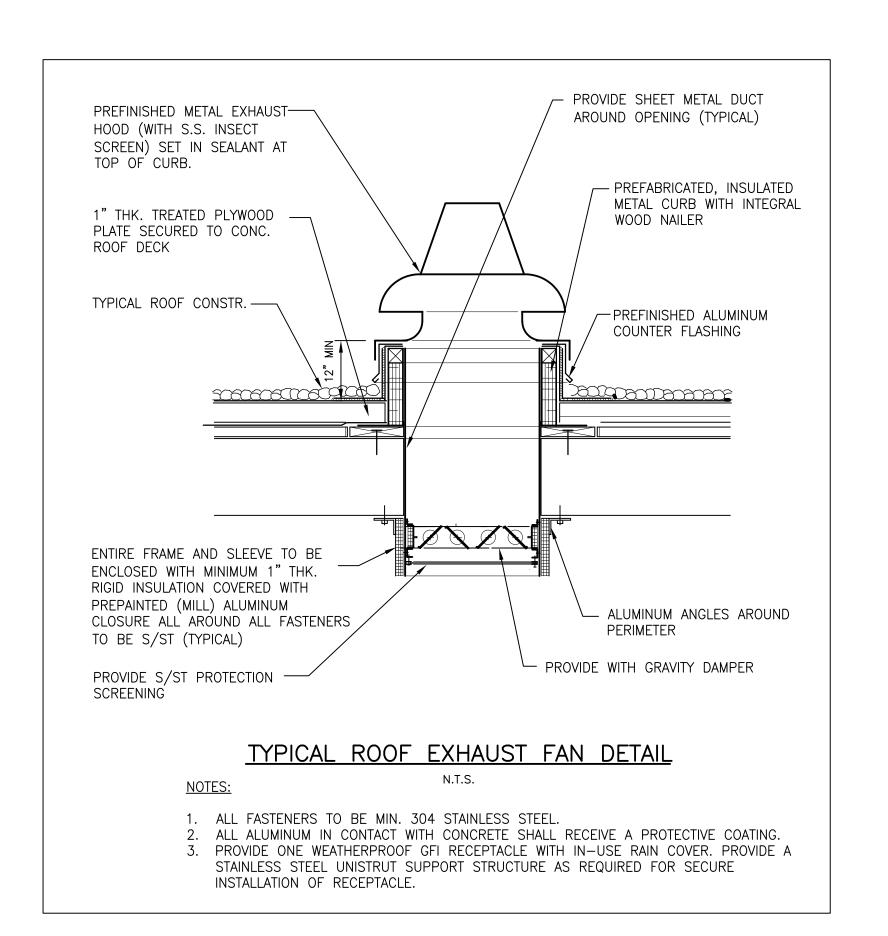

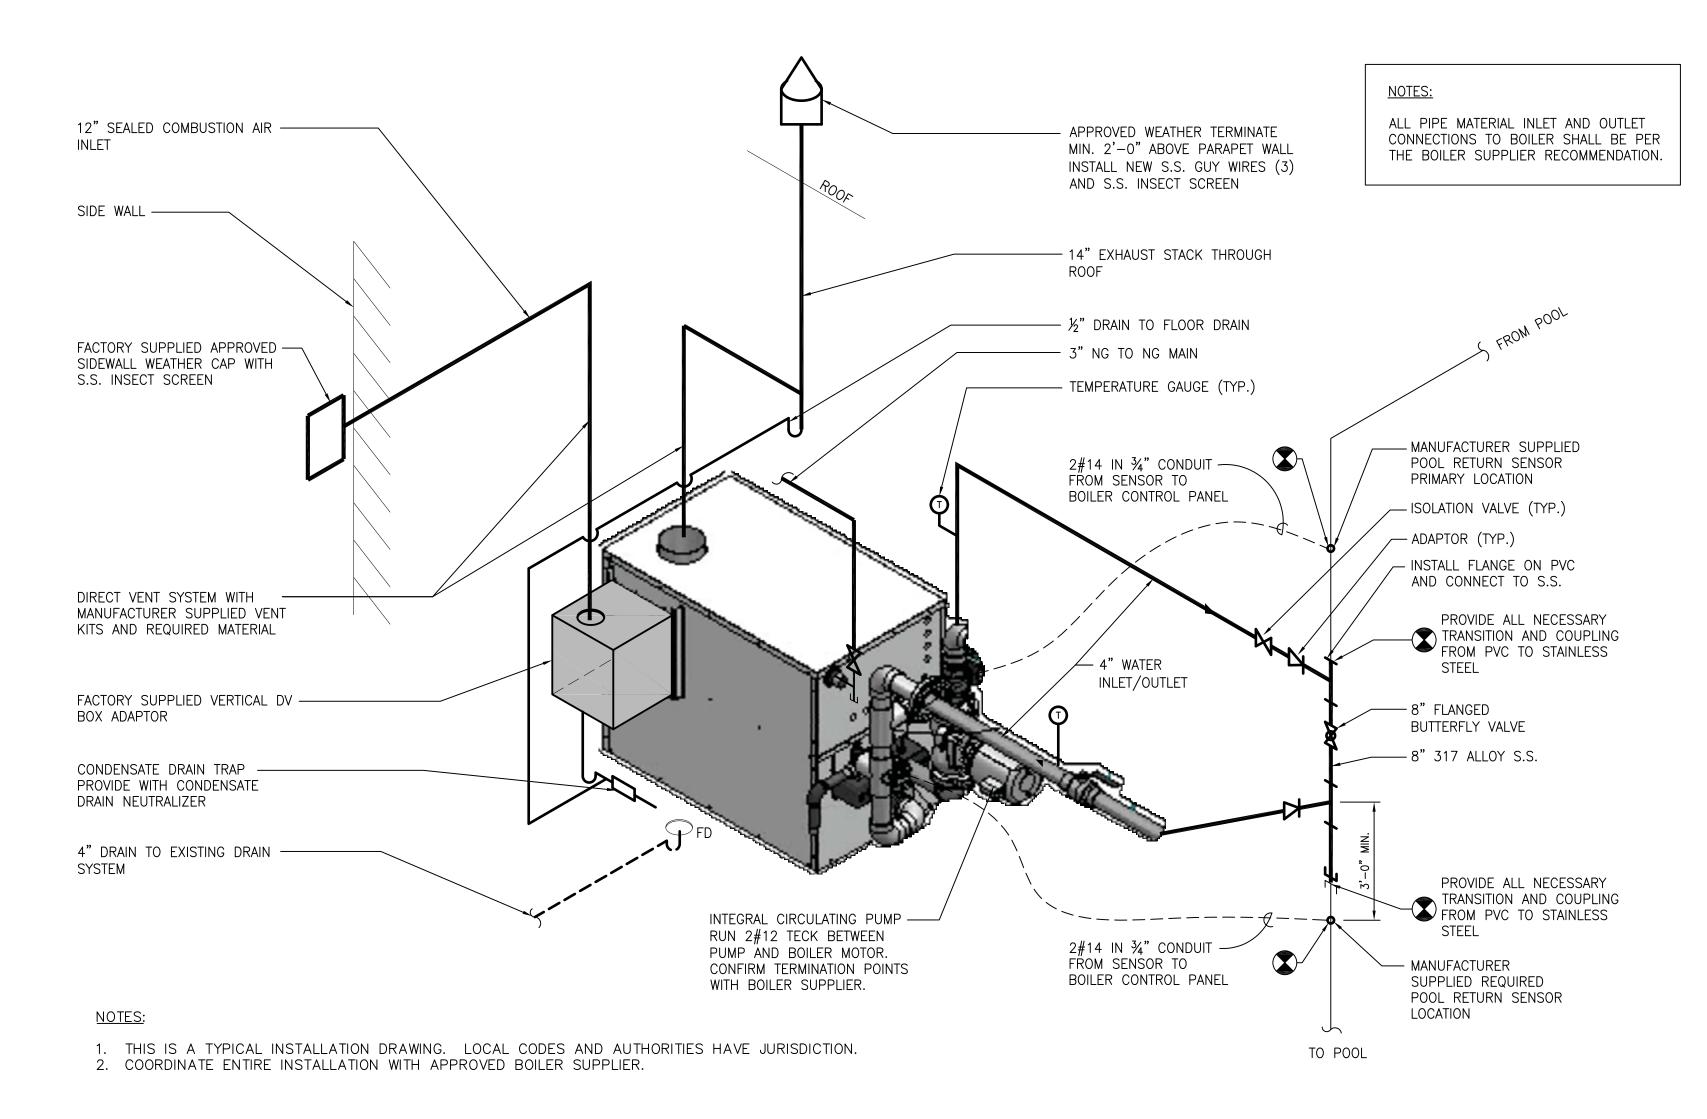

GAS FIRED BOILER INSTALLATION DIAGRAM

SCALE: NONE

HOT WA	ATER BOI	LER SCHE	DULE										
SYMBOL	DESCRIPTION	MANUFACTURE	MODEL NO.	INPUT (MBH)	OUTPUT (MBH)	EFFICIENCY	WATER CO	NNECTIONS RETURN	GAS CONNECTION	VENT (INCH)	DIRECT COMBUSTION	ELECTRICAL	REMARKS
B-1	POOL WATER BOILER	LOCHINVAR	CPN1802-M9	1820	1620	89%	3"	3"	3"	14"	12"	120/1/60	SEE NOTE 1,2,3,4,5,6,7,8,9

NOTES:

- 1. STRUCTURAL CONCRETE PAD PER DETAIL SHEET M1.02.
- 2. INTERLOCK BOILER W/ BOILER CONTROL PANEL AND MANUFACTURER SUPPLIED POOL RETURN SENSOR.
- PROVIDE FACTORY SUPPLIED DIRECT COMBUSTION AIR KIT AND SIDEWALL WEATHER CAP. 4. INSTALLATION CLEARANCES PER MANUFACTURER RECOMMENDATIONS AND CODE REQUIREMENTS.
- PROVIDE CONDENSATE DRAIN NEUTRALIZER. LOCHINVAR MODEL UIT 3087. 6. EFFICIENCY VARIES DEPENDING ON FIRING RATE AND RETURN WATER TEMPERATURE.
- 7. PROVIDE BOILER WITH MANUFACTURER SUPPLIED CIRCULATING PUMP WITH MINIMUM 115 GPM @ 18 FT.HD. CAPACITY. REFER TO MANUFACTURER'S RECOMMENDATIONS.
- 8. MANUFACTURER/CONTRACOR TO PROVIDE START UP, COMMISSIONING, TRAINING AND O&M MANUALS.
- 9. PROVIDE NG PRESSURE REGULATOR AS NEEDED.

	EXHAUST FAN SCHEDULE								
MARK	DESCRIPTION	MANUFACTURER	MODEL No	(CFM)	S.P. (In. H ₂ O)	FRPM	MOTOR (HP)	ELECTRICAL V/PH/Hz	REMARK
EF-1	ROOF EXHAUST FAN	GREENHECK	CWB-099	800	0.5	1150	1/4	115/1/60	SEE NOTE 1,2,3,4,5

- 1. PROVIDE FACTORY DISCONNECT SWITCH, FACTORY MOUNTED & WIRED, NEMA-3R
- 2. PROVIDE ALL ALUMINUM CONSTRUCTION MOTORIZED DAMPER. DAMPER BASIS OF DESIGN TAMCO. 3. PROVIDE MOTOR WITH THERMAL OVERLOADS.
- 4. PROVIDE EXHAUST FAN AND DAMPER WITH CHEMICAL RESISTANT COATING. ALL FASTENERS AND MOUNTING ACCESSORIES SHALL STAINLESS STEEL.
- 5. PROVIDE FACTORY ROOF CURB.

	LOUVER AND DAMPER SCHEDULE							
LOUVER No.	(CFM)	LOUVER SIZE	LOUVER MODEL	DAMPER No.	DAMPER SIZE	SERVES	TYPE OF DAMPER	REMARK
L-1	350	24x16	DE 635	D-1	24x16	INTAKE	PARALLEL BLADE MANUAL	SEE NOTE 1,2,3,4

NOTES:

- 1. LOUVER BASIS OF DESIGN E.H. PRICE.
- 2. DAMPER BASIS OF DESIGN TAMCO. 3. C/W PREPAINTED ALUMINUM FORMED METAL SILL.
- 4. PROVIDE CHEMICAL RESISTANT COATING. ALL FASTENERS AND MOUNTING ACCESSORIES SHALL BE STAINLESS STEEL.



Stantec Consulting Michigan Inc. 3754 Ranchero Drive Ann Arbor MI U.S.A.

48108 734.761.1010 734.761.1200

Copyright Reserved

The Contractor shall verify and be responsible for all dimensions. DO NOT scale the drawing — any errors or omissions shall be reported to Stantec without delay. The Copyrights to all designs and drawings are the property of Stantec. Reproduction or use for any purpose other than that authorized by Stantec is forbidden.

Consultants

Legend

POINT OF CONNECTION

Notes

Revision B BID SET SA SA 2013.12.03 A OWNER REVIEW SA SA 2013.11.22 Appd. YY.MM.DD Issued File Name: 2075128409_M1.02 Q.K. W.M.J. W.M.J. 2013.12.10 Dwn. Chkd. Dsgn. YY.MM.DD

Permit-Seal

Client/Project CITY OF ANN ARBOR

FULLER POOL BOILER REPLACEMENT ANN ARBOR, MI

MECHANICAL DETAILS, SCHEDULES AND **GENERAL NOTES**

Project No. Scale AS NOTED

SYMBOL	LEG	FND						
Ι Ψ	DESC	RIPTION						
	DUPLE	EX RECEPTACLE, 20A, 125V, SPECIFICATION GRADE						
WP	DUPLE	EX RECEPTACLE G.F.I. 20A, 125V, SPEC. GRADE						
Ø	208V	RECEPTACLE, NEMA TYPE AS NOTED						
	CONT	ROLLER						
<u> </u>								
	DRY	TYPE TRANSFORMER, AS INDICATED						
⊠r	СОМВ	INATION MAGNETIC MOTOR STARTER						
	DISCO	NNECT SWITCH - UNFUSED (DS)						
D'	DISCO	NNECT SWITCH - FUSED						
0	JUNC	TION BOX						
LP	LIGHTI	ING AND RECEPTACLE PANEL						
PP	POWE	R PANEL						
$\langle A \rangle$	LUMIN	IAIRE TYPE — SEE LUMINAIRE SCHEDULE						
	COND	UIT BELOW GRADE, CONCRETE SLAB OR AS NOTED						
	COND	UIT TURNS UP OR TOWARDS						
	COND	LIIT TIIDUS DOWN OD AWAY						
		UIT TURNS DOWN OR AWAY						
MMS	MANU	AL MOTOR STARTER						
	HOME	RUN, 3/4"C(2#12,1#12G) UNO.						
ТС	TIME	CLOCK						
S ₃	THRFF	E-WAY, 20A, 277V SPECIFICATION GRADE SWITCH						
<u> </u>								
S ₄		-WAY, 20A, 277V SPECIFICATION GRADE SWITCH						
S	SPST	20A, 277V SPEC. GRADE TOGGLE SWITCH						
S _D	DIMME	R SWITCH - WATTAGE AS INDICATED						
S _P	SPST	20A, 277V SPEC. GRADE SW. W/ PILOT LIGHT						
S _{XP}	EXPLO	OSION PROOF SPST 20A, 277V SPEC. GRADE SW.						
FCP		· · · · · · · · · · · · · · · · · · ·						
		ALARM CONTROL PANEL						
E _P	FIRE A	ALARM PULLSTATION						
Þ⊠	A.D.A.	. HORN/STROBE ALARM AT 80" AFF. OR AS REQUIRED						
⊕ R/F	CEILIN	IG MOUNTED RATE-OF-RISE HEAT DETECTOR						
② _P	CEILIN	NG MOUNTED PHOTOELECTRIC SMOKE DETECTOR						
	DUCT	MOUNTED SMOKE DETECTOR						
<u></u> →	FLOW	DETECTOR SWITCH						
S	CEILIN	IG MOUNTED SPEAKER						
<u></u> ⊚H	WALL	MOUNTED SPEAKER						
▼	TELEP	HONE OUTLET						
	PUSHE	BUTTON CONTROL STATION						
A		M HORN						
		TING RED ALARM LIGHT						
		JIT BREAKER (OVER 600V.)						
52	CIRCU	IT BREAKER (OVER 600V.)						
RTD	RESIS [*]	TANCE TEMPERATURE DETECTOR						
20	HFM	ATIC WIRING DIAGRAMS						
	· · L V							
SYME	30LS	DESCRIPTION						
<u></u>	_	CONTACT, NORMALLY OPEN						
		CONTACT, NORMALLY CLOSED						
-010	—	PUSHBUTTON, NORMALLY CLOSED						
0 0		,						
1		PUSHBUTTON, NORMALLY OPEN SELECTOR SWITCH — "HAND—OFF—AUTO",						
— o	a ł	UNLESS OTHERWISE NOTED.						
- b -c		PUSHBUTTON, MAINTAINED CONTACT,						
		DOUBLE SIBOUT						
	०	DOUBLE CIRCUIT						
- -	०	OVERLOADS						
	∮	OVERLOADS						
ot's	∮	OVERLOADS FUSE						
ot's	∮	DOUBLE CIRCUIT OVERLOADS FUSE SWITCH						
ot's	∮	OVERLOADS FUSE						
ot's	∮	DOUBLE CIRCUIT OVERLOADS FUSE SWITCH						
ot's	∮	OVERLOADS FUSE SWITCH PILOT LIGHT MANUAL MOTOR STARTER						
	∮	DOUBLE CIRCUIT OVERLOADS FUSE SWITCH PILOT LIGHT						
		OVERLOADS FUSE SWITCH PILOT LIGHT MANUAL MOTOR STARTER AUXILIARY STARTER CONTACTS						
		OVERLOADS FUSE SWITCH PILOT LIGHT MANUAL MOTOR STARTER AUXILIARY STARTER CONTACTS OVERLOAD						
		OVERLOADS FUSE SWITCH PILOT LIGHT MANUAL MOTOR STARTER AUXILIARY STARTER CONTACTS						
		OVERLOADS FUSE SWITCH PILOT LIGHT MANUAL MOTOR STARTER AUXILIARY STARTER CONTACTS OVERLOAD						
		OVERLOADS FUSE SWITCH PILOT LIGHT MANUAL MOTOR STARTER AUXILIARY STARTER CONTACTS OVERLOAD LOCATED REMOTE						
		DOUBLE CIRCUIT OVERLOADS FUSE SWITCH PILOT LIGHT MANUAL MOTOR STARTER AUXILIARY STARTER CONTACTS OVERLOAD LOCATED REMOTE LOCATED AT MOTOR						
		DOUBLE CIRCUIT OVERLOADS FUSE SWITCH PILOT LIGHT MANUAL MOTOR STARTER AUXILIARY STARTER CONTACTS OVERLOAD LOCATED REMOTE LOCATED AT MOTOR NEW DEVICE TO BE PROVIDED						

GENERAL NEW WORKS NOTES

- COORDINATE THE ELECTRICAL WORK TO BE PERFORMED WITH THE WORK OF OTHER TRADES TO ENSURE THAT THERE ARE NO CONFLICTS OR DELAYS.
- 2. ENTIRE INSTALLATION SHALL BE COORDINATED WITH THE APPROVED BOILER MANUFACTURER.
- 3. DRAWINGS ARE BASED ON INFORMATION GATHERED ON SITE AS NO AS-BUILT DRAWINGS WERE AVAILABLE. VERIFY ALL NEW WORKS PRIOR TO COMMENCEMENT.
- 4. ALL GROUNDING SHALL BE DONE IN ACCORDANCE WITH THE LATEST EDITION OF THE NATIONAL ELECTRICAL CODE ANSI/NFPA NO. 70.

SHEET NOTES (THIS SHEET ONLY)

- 1 NEW BOILER ASSEMBLY WITH INTEGRAL CONTROL PANEL. THIS CONTRACTOR IS RESPONSIBLE TO REVIEW THE GAS FIRED BOILER INSTALLATION DIAGRAM ON M1.02 FOR ALL WIRING REQUIREMENTS.
- 2 RUN 2#10 IN 3/4" CONDUIT FOR POWER TO NEW BOILER (VIA PB AND DS). ROUTING OF CONDUIT IS SHOWN DIAGRAMMATICALLY. INSTALL TO SUIT EXISTING SITE CONDITIONS. BOILER TERMINATION POINTS TO BE CONFIRMED AND COORDINATED WITH VENDOR APPROVED SHOP DRAWINGS. REFER TO DETAIL ON E1.02.
- NEW BOILER SHALL BE FED FROM THE EXISTING 120/208V PANEL, LP-A. PROVIDE ONE NEW 30A, 1P BREAKER IN CIRCUIT 14 POSITION FOR PROTECTION OF SYSTEM. EXISTING PANEL IS A GE TYPE NL10 STYLE 3 PANEL WITH IQL BREAKERS. RE-BALANCE ELECTRICAL LOAD BETWEEN PHASES AS NEEDED. PROVIDE A LABEL FOR BREAKER 14 SAYING "EMERGENCY SHUTDOWN BOILER BREAKER".
- 4 NEW EXHAUST FAN AND ASSOCIATED RECEPTACLE TO BE FED FROM EXISTING PANEL LP-A. PROVIDE ONE NEW 15A, 1P BREAKER IN LP-A FOR PROTECTION OF EXHAUST FAN. EXISTING PANEL IS A GE TYPE NL10 STYLE 3 PANEL WITH IQL BREAKERS. PROVIDE AND INSTALL RECEPTACLE AS PER M1.02 EXHAUST FAN DETAIL.
- The state of the s
- 6 PROVIDE AND INSTALL ONE MANUAL MOTOR STARTER CONTROLLING EF-1 AS PER SCHEMATIC WIRING DIAGRAM ON SHEET E1.02.
- 7 PROVIDE AND INSTALL DISCONNECT SWITCH FOR NEW BOILER MOUNTED TO BOILER.
- 8 EMERGENCY SHUT-OFF PUSHBUTTON TO BE TIED INTO BOILER OPERATION. PUSHBUTTONS SHALL BE A MAINTAINED-OPEN MUSHROOM TYPE AND SHALL DISCONNECT THE BOILER FROM ALL SOURCES OF POWER TO THE BOILER CONTROLS WHEN PRESSED. WHEN PUSHBUTTONS RETURN TO CLOSED POSITION, THE BOILERS WILL NEED TO BE MANUALLY RESET TO STARTUP AGAIN. MOUNT PUSHBUTTION AT 4'-0" A.F.F. REFER TO DETAIL ON E1.02.
- 9 RUN 2#14 IN 3/4" CONDUIT FROM NEW BOILER CONTROL PANEL TO EXISTING POOL PUMP CONTROL PANEL FOR START COMMAND. THE INTENT IS TO MATCH EXISTING SYSTEM IN OPERATION AND WIRING. ROUTING OF CONDUIT IS SHOWN DIAGRAMMATICALLY. INSTALL TO SUIT EXISTING SITE CONDITIONS.


TIMER -

LP-A —

LIGHTING CONTACTOR —

DOOR LOUVER -

PANEL (ASSUMED)

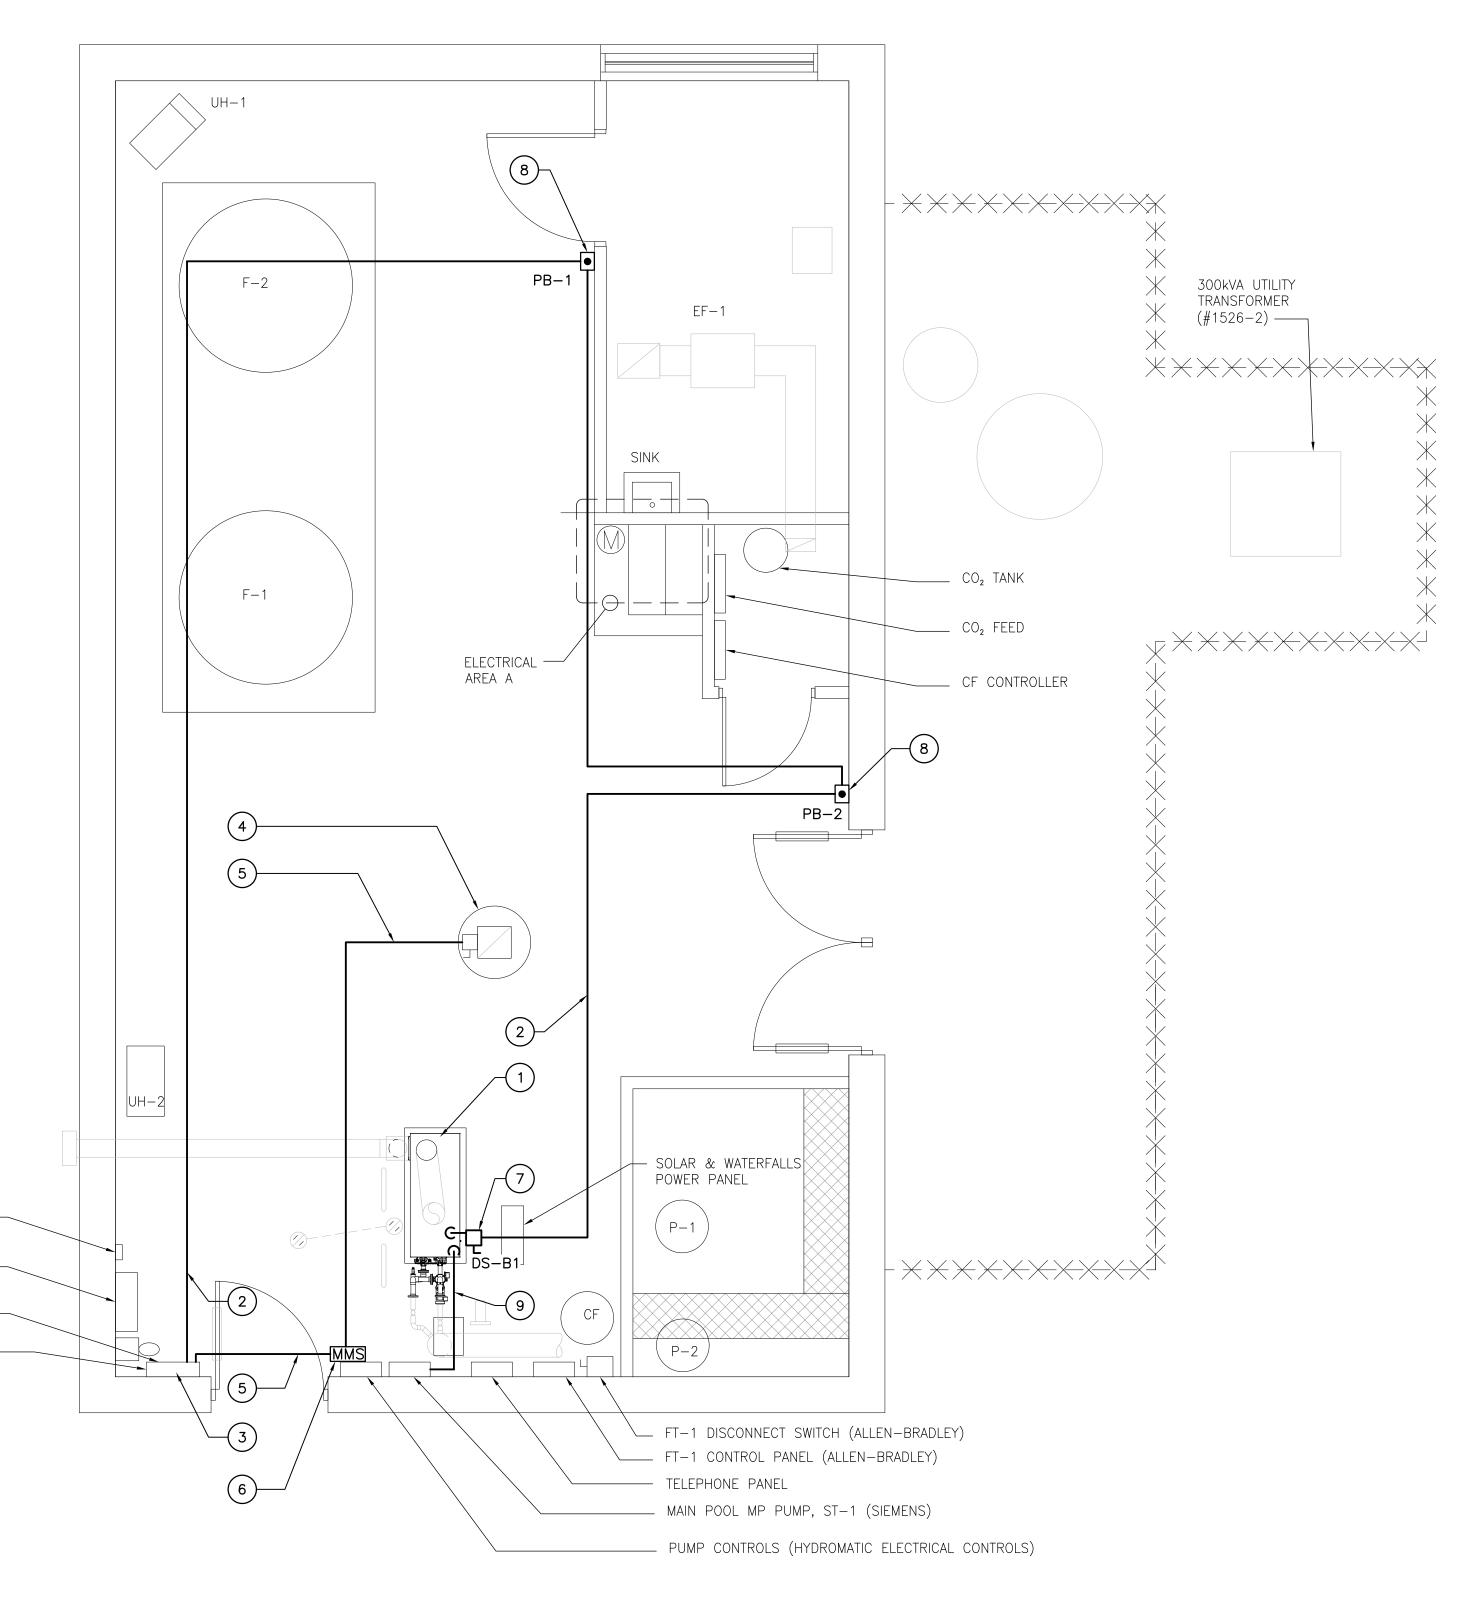

734.761.1010
734.761.1200

Copyright Reserved

The Contractor shall verify and be responsible for all dimensions. DO NOT scale the drawing — any errors or omissions shall be reported to Stantec without delay.

authorized by Stantec is forbidden.

The Copyrights to all designs and drawings are the property of Stantec. Reproduction or use for any purpose other than that

Stantec Consulting Michigan Inc.

3754 Ranchero Drive

Ann Arbor MI U.S.A.

Consultants

Legend

Notes

 B BID SET
 SA SA 2013.12.03

 A OWNER REVIEW
 SA SA 2013.11.22

 Issued
 By Appd.
 YY.MM.DD

 File Name: 2075128409_E1.01
 Q.K. W.M.J. W.M.J. W.M.J. 2013.12.10

 Dwn. Chkd. Dsgn. YY.MM.DD

Permit-Seal

Client/Project
CITY OF ANN ARBOR


FULLER POOL BOILER REPLACEMENT ANN ARBOR, MI

_____ Title


ELECTRICAL
LEGEND AND NEW WORK PLAN

NEW WORK ELECTRICAL PLAN

N.T.S.

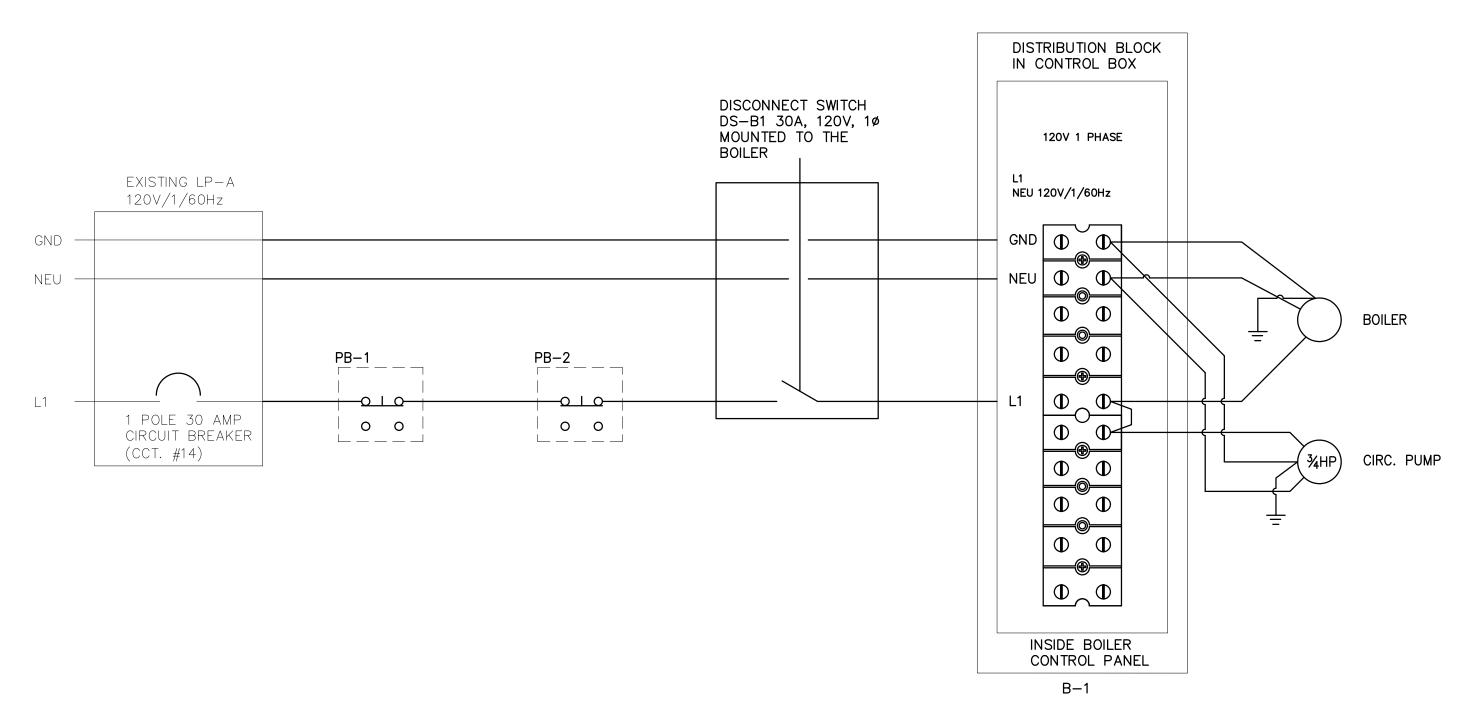

BOILER WIRING BLOCK DIAGRAM
SCALE: NONE

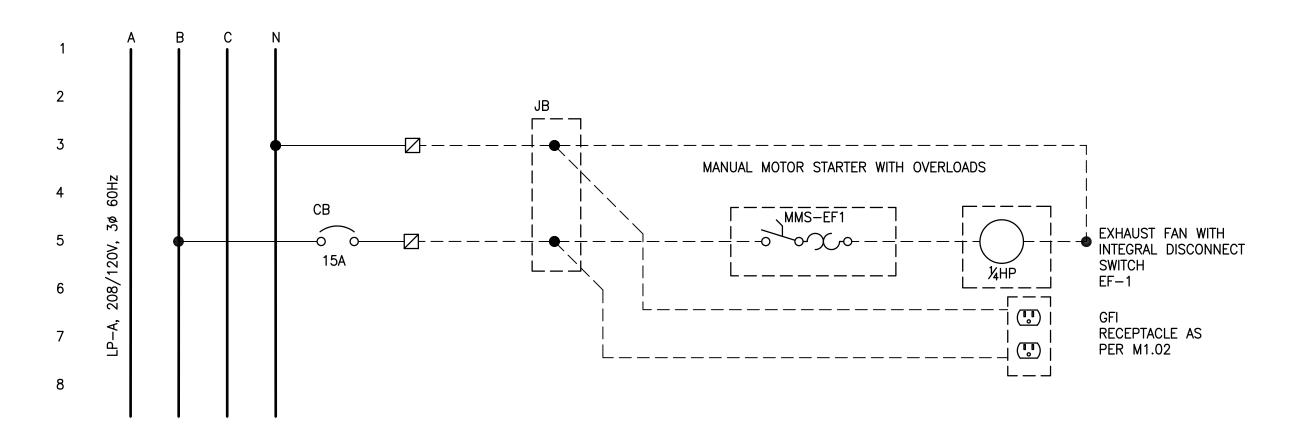

SCHEMATIC WIRING DIAGRAM FOR EXHAUST FAN EF-1



Stantec Consulting Michigan Inc. 3754 Ranchero Drive Ann Arbor MI U.S.A. 48108 734.761.1010

Copyright Reserved

734.761.1200

The Contractor shall verify and be responsible for all dimensions. DO NOT scale the drawing — any errors or omissions shall be reported to Stantec without delay.

The Copyrights to all designs and drawings are the property of Stantec. Reproduction or use for any purpose other than that authorized by Stantec is forbidden.

Consultants

Legend

 B
 BID SET
 SA
 SA
 2013.12.03

 A
 OWNER REVIEW
 SA
 SA
 2013.11.22

 Issued
 By
 Appd.
 YY.MM.DD

 File Name: 2075128409_E1.02
 Q.K.
 W.M.J.
 W.M.J.
 2013.12.10

 Dwn.
 Chkd.
 Dsgn.
 YY.MM.DD

Permit-Seal

Client/Project

CITY OF ANN ARBOR

FULLER POOL BOILER REPLACEMENT ANN ARBOR, MI

Title

ELECTRICAL
WIRING BLOCK DIAGRAM

Project No.
2075128409

Drawing No.

Scale

AS NOTED

Sheet

E1.02

7 of 7