


CITY OF ANN ARBOR PROJECT MANAGEMENT

S. FOREST AVENUE IMPROVEMENTS

BID No. 4293 FILE No. 2012-039

MAY 2013

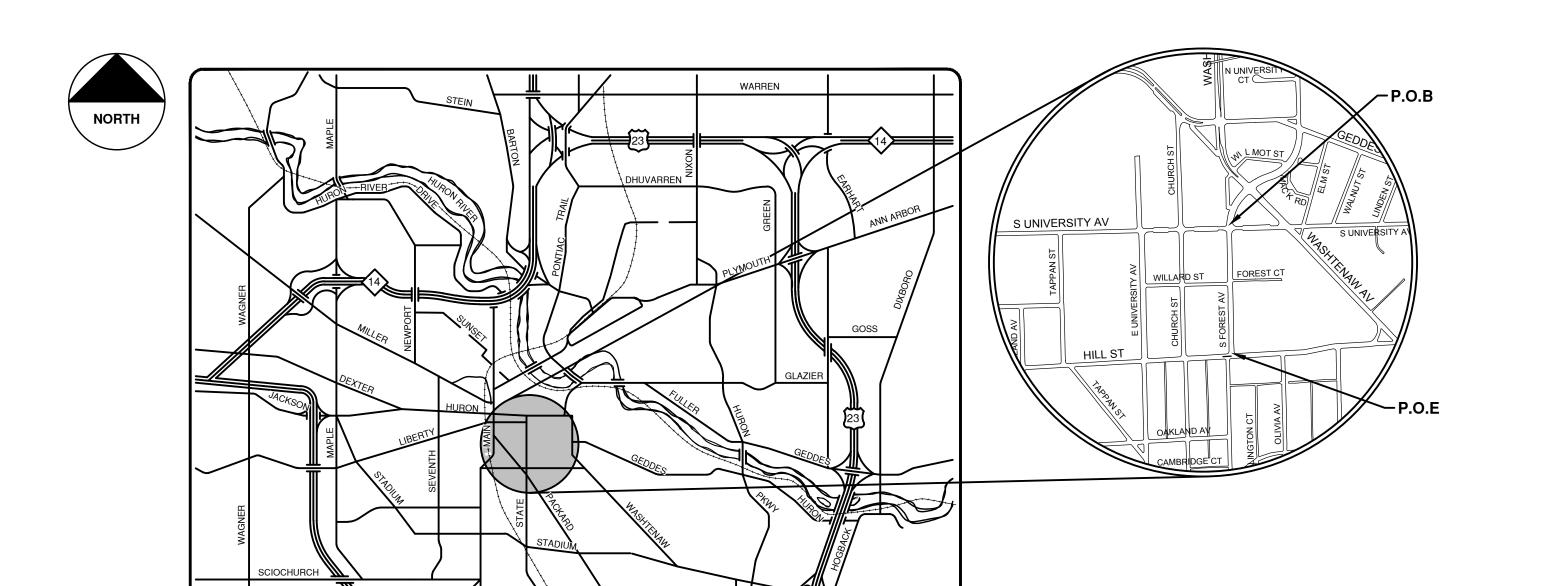

| Sheet List | Sheet List Table | |
|--------------|--|--|
| Sheet Number | Sheet Title | |
| 1 | Cover | |
| 2 | Typical Cross-Sections & Details | |
| 3 | Details | |
| 4 | Notes & Legend | |
| 5 | Removal Plan | |
| 6 | Road Plan & Profile Sta 0+00 to 3+50 | |
| 7 | Road Plan & Profile Sta 3+50 to 7+00 | |
| 8 | Road Plan & Profile Sta 7+00 to 11+00 | |
| 9 | Water Main Plan & Profile Sta 0+00 to 5+92 | |
| 10 | Transformer Park Removal & SESC Plan | |
| 11 | Transformer Park Construction Plan | |
| 12 | Transformer Park Grading & Drainage | |
| 13 | ADA Ramps & Detailed Grading | |
| 14 | ADA Ramps & Detailed Grading | |
| 15 | Detour Plan | |
| 16 | Temporary Traffic Control | |
| 17 | Pavement Marking | |
| | | |

NOTES:

THE CONSTRUCTION COVERED BY THESE PLANS SHALL CONFORM TO THE 1994 EDITION OF THE CITY OF ANN ARBOR PUBLIC SERVICES DEPARTMENT STANDARD SPECIFICATIONS AND IT'S DETAILS WHICH ARE INCLUDED BY REFERENCE. THE OMISSION OF ANY CURRENT STANDARD DETAIL DOES NOT RELIEVE THE CONTRACTOR FROM THIS REQUIREMENT.

FOR PROTECTION OF UNDERGROUND UTILITIES AND IN CONFORMANCE WITH PUBLIC ACT 53, THE CONTRACTOR SHALL CALL 811 OR 1-800-482-7171 A MINIMUM OF THREE FULL WORKING DAYS, EXCLUDING SATURDAYS, SUNDAYS, AND HOLIDAYS PRIOR TO BEGINNING EACH EXCAVATION IN AREAS WHERE PUBLIC UTILITIES HAVE NOT BEEN PREVIOUSLY LOCATED. MEMBERS WILL THUS BE ROUTINELY NOTIFIED. THIS DOES NOT RELIEVE THE CONTRACTOR OF THE RESPONSIBILITY OF NOTIFYING UTILITY OWNERS WHO MAY NOT BE A PART OF THE "MISS DIG" ALERT SYSTEM.

THE UNDERGROUND LOCATIONS SHOWN FOR NATURAL GAS (GAS), TELEPHONE (TEL), ELECTRICAL POWER (PWR), CABLE TV (CTV) AND FIBER OPTIC LINES (FIBER) ARE APPROXIMATE. THE CITY OF ANN ARBOR ASSUMES NO RESPONSIBILITY FOR THEIR ACCURATE REPRESENTATION IN THIS DRAWING. MISS DIG MUST BE CONTACTED PRIOR TO CONSTRUCTION TO LOCATE THESE UTILITIES.



SHEET NO

1 TO 17


VICINITY MAP 05/16/2013

BID

AVENUE; FOREST


CONTRACTOR SHALL:


- 1. TAKE ALL PRECAUTIONS TO SUPPORT UTILITY POLES, COORDINATE WITH APPROPRIATE UTILITY COMPANIES AND MINIMIZE SCHEDULE DELAYS.
- 2. COMPLETE ALL WORK IN ACCORDANCE WITH APPLICABLE LOCAL, STATE AND FEDERAL CODES, RULES AND REGULATIONS. OBTAIN ALL NECESSARY LOCAL, STATE AND FEDERAL PERMITS AND PAY PERMIT FEES FOR THE WORK OR CONFIRM REQUIRED PERMITS HAVE BEEN OBTAINED BY OTHERS PRIOR TO COMMENCING CONSTRUCTION.
- 3. BE RESPONSIBLE AT ALL TIMES FOR SITE SAFETY IN ACCORDANCE WITH THE LATEST REQUIREMENTS OF THE OCCUPATIONAL HEALTH AND SAFETY AUTHORITY HAVING JURISDICTION.
- 4. CALL MISS DIG @ 1-800-482-7171 AT LEAST 3 WORKING DAYS PRIOR TO ANY EXCAVATION TO CONFIRM THE LOCATIONS OF EXISTING BURIED UTILITIES. THIS DOES NOT RELIEVE THE CONTRACTOR OF THE RESPONSIBILITY OF NOTIFYING UTILITY OWNERS WHO MAY NOT BE PART OF THE "MISS DIG" ALERT SYSTEM. COORDINATE THE RELOCATION OF EXISTING UTILITIES WITH THE UTILITY OWNER. BE RESPONSIBLE FOR PROTECTING EXISTING UTILITIES AND REPAIRING DAMAGE TO EXISTING UTILITIES RESULTING FROM THE WORK. THE CONTRACTOR SHALL BE RESPONSIBLE FOR THE COSTS OF REPAIRING OR REPLACING ANY DAMAGED UTILITIES AT NO EXPENSE TO THE
- 5. COMPLY WITH THE CONDITIONS AND REQUIREMENTS OF THE SOIL EROSION AND SEDIMENTATION CONTROL PERMIT, INCLUDING BUT NOT LIMITED TO, CERTIFIED STORM WATER OPERATOR REQUIREMENTS. INSTALL ALL CONTROL MEASURES PRIOR TO COMMENCING CONSTRUCTION.
- 6. PROVIDE TRAFFIC CONTROL BARRICADES, SIGNS, LIGHTS, ETC. IN ACCORDANCE WITH THE LATEST EDITION OF THE MICHIGAN MANUAL OF UNIFORM TRAFFIC CONTROL DEVICES PART 6 AS NECESSARY FOR THE PROTECTION AND SAFETY OF THE PUBLIC. MAINTAIN THESE DEVICES AT ALL TIMES DURING CONSTRUCTION.
- 7. MAINTAIN A CLEAN WORK AREA. THOROUGHLY CLEAN AND/OR SWEEP STREETS AND ROADWAYS AS NEEDED AND AS REQUIRED BY THE ENGINEER.
- 8. MAINTAIN ACCESS TO PROPERTIES AND FOR POSTAL SERVICE DURING CONSTRUCTION. COORDINATE WITH THE APPROPRIATE JURISDICTIONAL AUTHORITIES. CONDUCT OPERATIONS TO ENSURE MINIMUM INTERFERENCE WITH ROADS, STREETS. WALKS AND OTHER ADJACENT OCCUPIED OR USED FACILITIES. ANY CLOSURE REQUIRES PERMISSION FROM ENGINEER AND COORDINATION WITH PROPERTY OWNERS AND RESIDENTS.
- 9. RESTORE ALL DISTURBED AREAS NOT COVERED BY OTHER SURFACE TREATMENT WITH 4" TOPSOIL, SEED, FERTILIZER AND MULCH BLANKETS.
- 10. PROTECT EXISTING SITE IMPROVEMENTS AND LANDSCAPING FROM DAMAGE. RESTORE/REPLACE DAMAGED IMPROVEMENTS AND LANDSCAPING TO ORIGINAL CONDITION ACCEPTABLE TO THE ENGINEER.
- 11. PROTECT TREES AND SHRUBS FROM DAMAGE DURING CONSTRUCTION IN ACCORDANCE WITH THE CONTRACT DOCUMENTS.
- 12. REFER DISCREPANCIES TO THE ENGINEER FOR CLARIFICATION.
- 13. THE INFORMATION CONTAINED ON THESE DRAWINGS PERTAINING TO EXISTING CONDITIONS, SUCH AS BUT NOT LIMITED TO, UTILITIES, TOPOGRAPHY, SUBSURFACE CONDITIONS, IS FURNISHED SOLELY AS THE BEST INFORMATION AVAILABLE AND ITS ACCURACY IS NOT GUARANTEED. THE USE OF THIS INFORMATION DOES NOT PROVIDE RELIEF FOR THE CONTRACTOR FROM ANY RESPONSIBILITY FOR DAMAGES DUE TO ANY INACCURACIES.
- 14. ALL REMOVED MATERIALS ARE THE PROPERTY OF THE CONTRACTOR UNLESS OTHERWISE NOTED IN CONTRACT DOCUMENTS OR AS DIRECTED BY THE ENGINEER. CLEANUP AND DISPOSE OF ALL EXCESS MATERIALS OFF SITE AT A LOCATION DESIGNATED FOR THIS USE AND IN ACCORDANCE WITH LOCAL REGULATIONS OR AT AN ON SITE LOCATION DESIGNATED BY THE OWNER.
- 15. USE (2) TWO BENCHMARKS FOR VERIFICATION OF ALL CONSTRUCTION ELEVATIONS. SET ADDITIONAL BENCH MARKS TO COMPLY WITH THIS REQUIREMENT.
- 16. RESTORE ALL STREET SURFACES, DRIVEWAYS, CULVERTS, ROADSIDE DRAINAGE DITCHES, AND OTHER PUBLIC OR PRIVATE STRUCTURES THAT ARE DISTURBED OR DAMAGED AS A RESULT OF CONSTRUCTION ACTIVITIES TO A CONDITION EQUAL TO OR BETTER THAN EXISTING CONDITIONS AND TO THE SATISFACTION OF THOSE HAVING JURISDICTION, UNLESS NOTED OTHERWISE IN THE PLANS.
- 17. NO EQUIPMENT, MATERIALS, OR STOCKPILING SHALL BE ALLOWED ON WILLARD STREET. SWEEP WILLARD REGULARLY TO AND VACUUM ENTIRE STREET AFTER PROJECT COMPLETION.

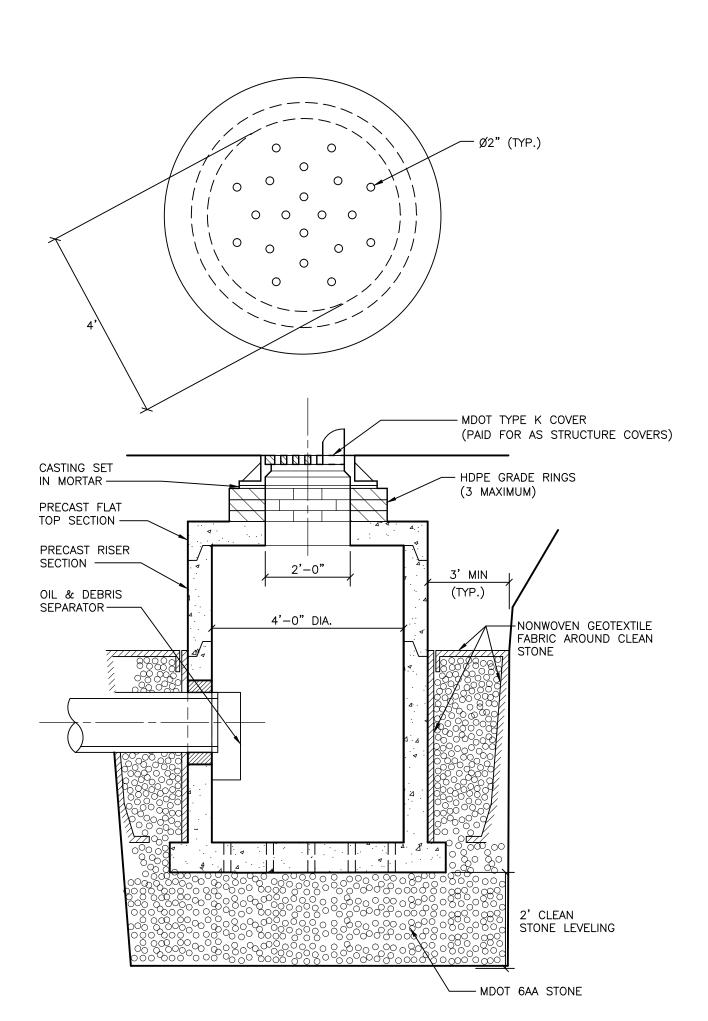



ALL ITEMS PAID FOR AS "LEACHING BASIN - 48" DIA" UNLESS SPECIFIED

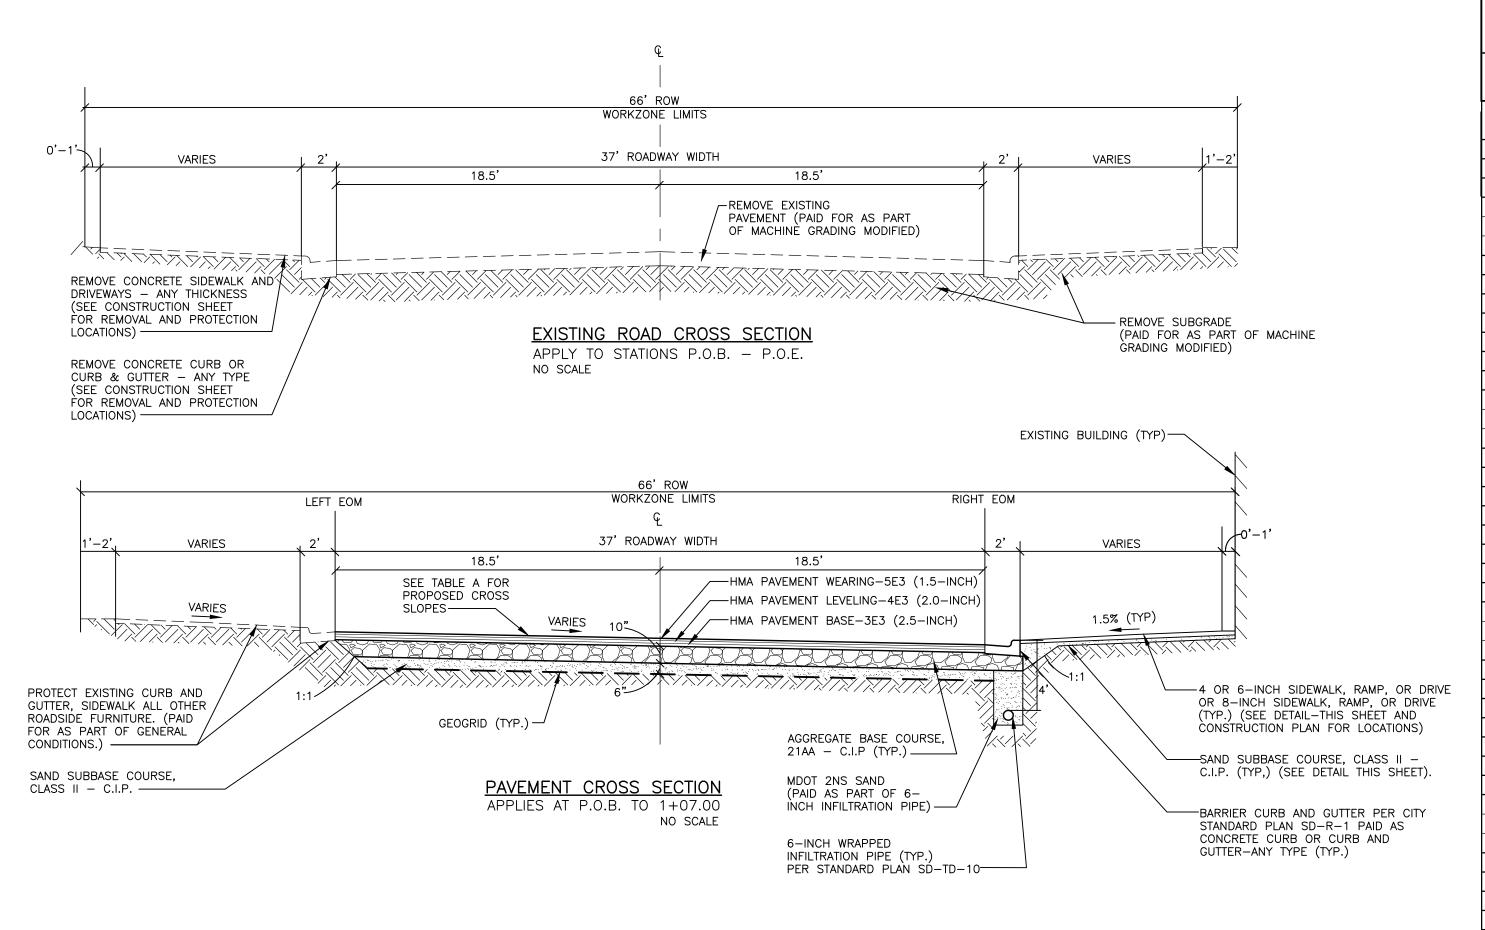

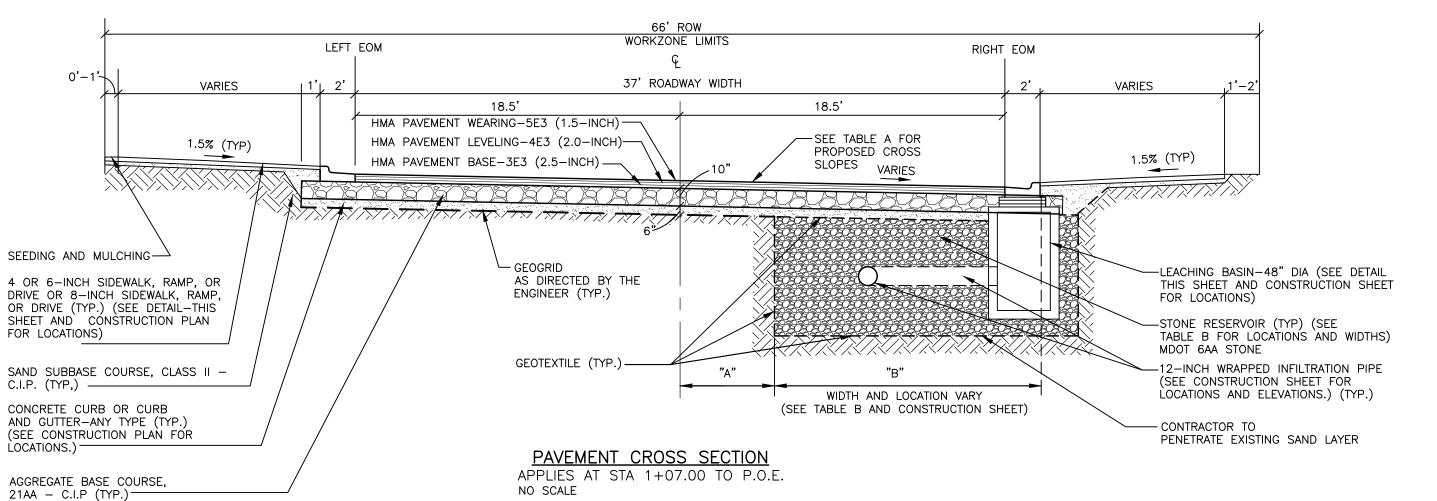


| HMA APPLICATION CHART | | | | | |
|---|-------|----------------------------|--------------------|----------------------|------------------------|
| PAY ITEM | MIX | EST RATE OF APPLICATION | FINAL THICKNESS | PERFORMANCE GRADE | REMARKS |
| HMA PAVEMENT WEARING, 5E3 | 5E3 | 165 LBS/SYD | 1.5" | 64-28 | FULL-DEPTH RECONSTRUCT |
| HMA PAVEMENT LEVELING, 4E3 | 4E3 | 220 LBS/SYD | 2.0" | 64-28 | FULL-DEPTH RECONSTRUCT |
| HMA PAVEMENT BASE, 3E3 | 3E3 | 275 LBS/SYD | 2.5" | 64-28 | FULL-DEPTH RECONSTRUCT |
| BIT BOND COAT SS-1h (FOR INFORMATION ONLY) NOT PAY ITEM | SS-1h | 0.05 to 0.15 GAL/SYD | | | BETWEEN LAYERS |

TABLE A

PROPOSED CROSS SLOPES*

| | I | RIGHT CROSS | | LEFT CROSS | |
|---|----------------|--|------------|------------|----------|
| STA | RIGHT EOM | | CENTERLINE | SLOPE | LEFT EOM |
| 0+29 | MATCH | MATCH | MATCH | MATCH | MATCH |
| 0+50 | 878.27 | -3.00% | 878.93 | -0.24% | MATCH |
| 0+75 | 877.37 | -3.00% | 877.93 | -3.00% | MATCH |
| 1+00 | 876.94 | -2.50% | 877.50 | -2.50% | MATCH |
| 1+25 | 876.56 | -2.25% | 877.03 | -2.25% | MATCH |
| 1+50 | 876.19 | -2.00% | 876.56 | -2.00% | MATCH |
| 1+75 | 875.84 | -2.00% | 876.20 | -2.00% | MATCH |
| 2+00 | 875.48 | -2.00% | 875.85 | -2.00% | MATCH |
| 2+25 | 875.22 | -2.00% | 875.59 | -2.00% | MATCH |
| 2+50 | 874.96 | -2.00% | 875.33 | -2.00% | MATCH |
| 2+75 | 874.62 | -2.00% | 874.99 | -2.00% | MATCH |
| 3+00 | 874.29 | -2.00% | 874.66 | -2.00% | MATCH |
| 3+25 | 873.82 | -2.00% | 874.22 | -2.00% | MATCH |
| 3+50 | MATCH | -2.41% | 873.79 | -2.41% | MATCH |
| 3+75 | MATCH | -2.41% | 873.52 | -2.41% | 873.93 |
| 4+00 | MATCH | -2.20% | 873.26 | -2.20% | 873.63 |
| | | | | | |
| 4+28 | MATCH | -2.00% -2.00% | 872.87 | -2.00% | 873.24 |
| 4+50 | 872.00 | The state of the s | 872.37 | -2.00% | 872.74 |
| 4+75 | 871.76 | -1.75% | 872.08 | -1.75% | 872.40 |
| 5+00 5+25 | MATCH | -1.50% | 871.79 | -1.50% | 872.07 |
| 110011 1110 | MATCH | -1.50% | 871.30 | -1.50% | 871.58 |
| 5+50 | MATCH | -1.50% | 870.81 | -1.50% | 871.09 |
| 5+75 | MATCH | -1.50% | 870.40 | -1.50% | 870.68 |
| 6+00 | MATCH | -1.50% | 870.00 | -1.50% | 870.28 |
| 6+25 6+50 | MATCH | -1.50% | 869.61 | -1.50% | 869.89 |
| 100000000000000000000000000000000000000 | MATCH | -1.50% | 869.23 | -1.50% | 869.51 |
| 6+75 | MATCH MATCH | -1.50% | 868.76 | -1.50% | 869.04 |
| 7+00 | | -1.50% | 868.50 | -1.50% | 868.78 |
| 7+25 | MATCH | -1.50% | 868.04 | -1.50% | 868.32 |
| 7+50 | MATCH | -1.50% | 867.65 | -1.50% | 867.93 |
| 7+75 | MATCH | -1.50% | 867.22 | -1.50% | 867.50 |
| 8+00 | MATCH | -1.50% -1.50% | 866.84 | -1.50% | 867.12 |
| 8+25 | MATCH | | 866.49 | -1.50% | 866.77 |
| 8+50 | MATCH | -1.50% | 866.15 | -1.50% | 866.43 |
| 8+75 | MATCH | -1.50% | 866.01 | -1.50% | 866.29 |
| 9+00 | MATCH | -1.50% | 865.90 | -1.50% | 866.18 |
| 9+25 | MATCH | -1.50% | 865.79 | -1.50% | 866.07 |
| 9+50 | MATCH | -1.50% | 865.53 | -1.50% | 865.81 |
| 9+75 | MATCH | -1.50% | 865.35 | -1.50% | 865.63 |
| 10+00 | MATCH | -1.50% | 865.10 | -1.50% | 865.38 |
| 10+31 | MATCH | 0.92% | 864.75 | 0.92% | 864.92 |
| 10+50 | MATCH | 2.76% | 865.24 | 0.24% | 865.285 |
| | | | | | |


| TABLE B | | | | | |
|-----------------|---------|-------|-------|--|--|
| STONE | RESE | RVOIR | | | |
| LOCATION | I AND | WIDTH | S | | |
| Α | В | | | | |
| RIGHT TRENCH | | FROM | | | |
| EDGE C/L OFFSET | WIDTH | STA | TOSTA | | |
| 20.5' | 13' | 1+09 | 2+05 | | |
| 15.5' | 8.5' | 2+05 | 3+06 | | |
| 20.5' | 13.5' | 3+06 | 3+16 | | |
| 15.5' | 8.5' | 3+16 | 4+34 | | |
| 20.5' | 13.5' | 4+34 | 4+44 | | |
| 15.5' | 8.5' | 4+44 | 5+52 | | |
| 20.5' | 13.5' | 5+52 | 5+62 | | |
| 15.5' | 8.5' | 5+62 | 6+57 | | |
| 20.5' | 13.5' | 6+57 | 6+67 | | |
| 15.5' | 8.5' | 6+67 | 8+60 | | |
| 20.5' | 18' | 8+60 | 8+70 | | |
| 13' | 13' | 8+70 | 10+21 | | |
| 20.5' | 13'-10' | 10+21 | 10+31 | | |

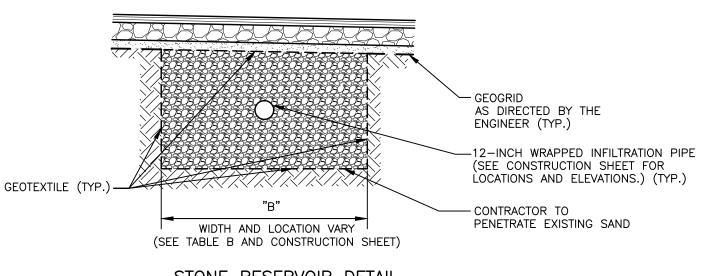

STONE RESERVOIR DETAIL


NO SCALE

| DRAWN CHECKED | DRAWN | DATE | DESCRIPTION | REV. |
|---------------|-------|------------|-------------|------|
| CEW | ATP | 05-08-2013 | 01 BID SET | 01 |
| | | | | |
| | | | | |
| | | | | |
| | | | | |

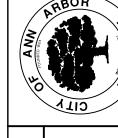

SERVICES

SHEET No.

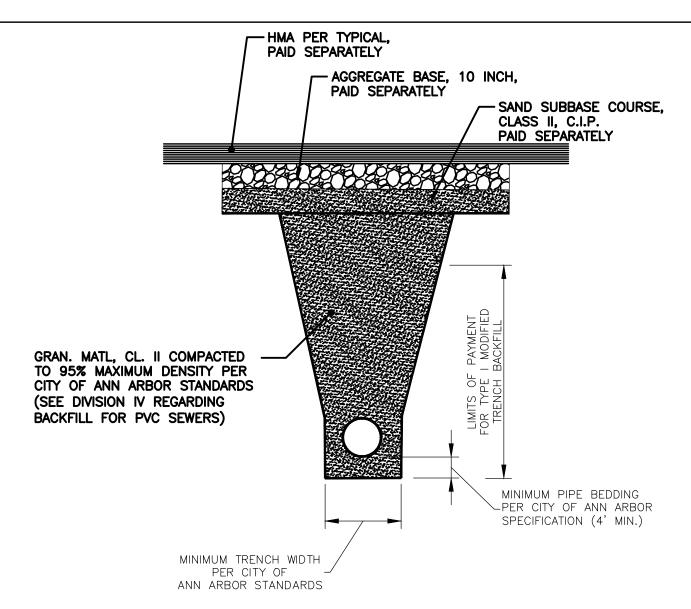

NOTE: DENSITY TESTING PER CITY ANN ARBOR

STANDARD SPECIFICATIONS


NOTE: TRENCH DETAILS SHOW TYPE OF BACKFILL ONLY


NOTE: ALL TRENCHING TO CONFORM TO ALL APPLICABLE M.I.O.S.H.A.

STANDARDS


NOTE: GEOGRID, STONE RESERVOIR (AT CROSSINGS), AGGREGATE BASE AND HMA PAID SEPARATELY

UTILITY TRENCH - TYPE I MODIFIED

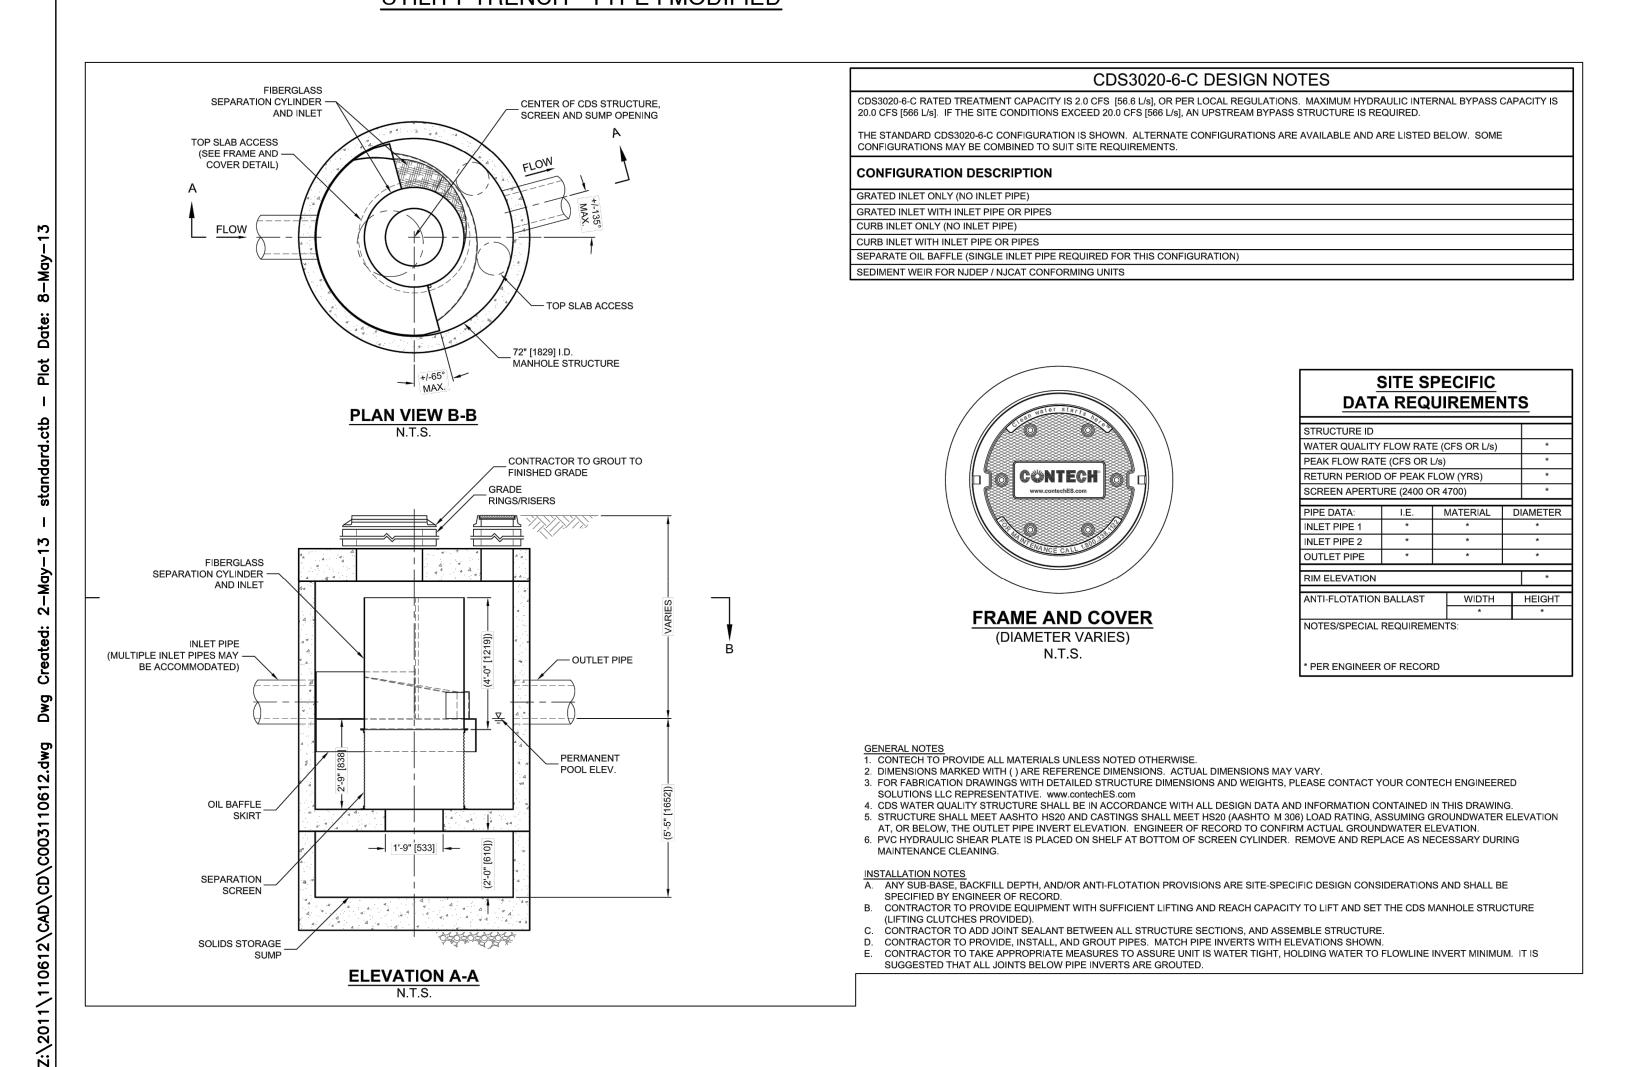

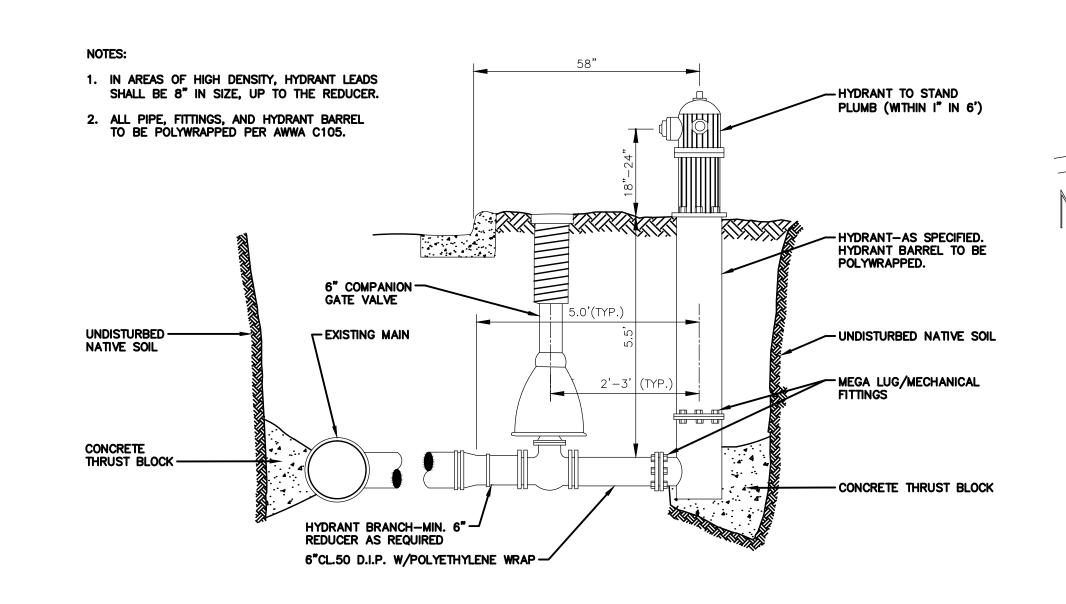

FIRE HYDRANT ASSEMBLY SD-W-1

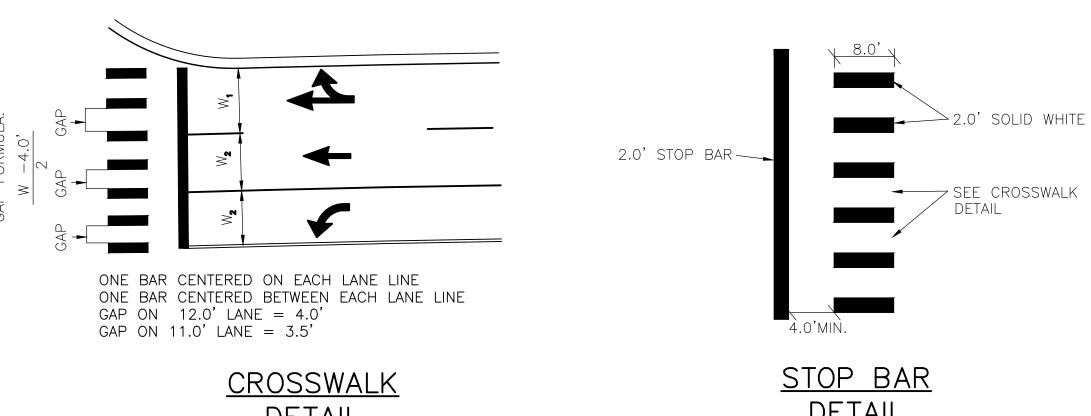

PERMITS REQUIRED TO BE OBTAINED BY THE CONTRACTOR PRIOR TO THE BEGINNING OF CONSTRUCTION.

| PERMIT | ISSUING AUTHORITY |
|---|--|
| LANE CLOSURE PERMIT | CITY OF ANN ARBOR PROJECT MANAGEMENT UNIT |
| "NO PARKING" SIGNS PERMIT | CITY OF ANN ARBOR PROJECT MANAGEMENT UNIT |
| GRADING/SOIL EROSION & SEDIMENTATION CONTROL PERMIT | CITY OF ANN ARBOR CUSTOMER SERVICE |
| RIGHT-OF-WAY PERMIT | CITY OF ANN ARBOR CUSTOMER SERVICE |
| | 1 |

* NO COST TO CONTRACTOR

PERMITS REQUIRED TO BE OBTAINED BY THE CITY OF ANN ARBOR PRIOR TO THE BEGINNING OF CONSTRUCTION.

| PERMIT | ISSUING AUTHORITY |
|---|---|
| M.D.E.Q. WATER MAIN CONSTRUCTION PERMIT | MICHIGAN DEPARTMENT OF ENVIRONMENTAL QUALITY |

CONTACT INFORMATION

| PUBLIC UTILITIES | OWNER | CONTACT |
|-----------------------------------|---|----------------------------------|
| WATER | | DAN WOODEN (734) 794-6350 |
| SANITARY | CITY OF ANN ARBOR | MARK COZART (734) 794-6350 |
| STORM | FIELD OPERATIONS SERVICE UNIT W.R. WHEELER SERVICE CENTER | KEVIN ERNST (734) 794-6350 |
| FORESTRY | 4251 STONE SCHOOL ROAD ANN ARBOR, MI 48108 | TRACY PENNINGTON (734) 794-6350 |
| SIGNS SIGNALS STREET LIGHTS | | CHUCK FOJTIK (734) 794-6361 |
| PRIVATE UTILITIES | OWNER | CONTACT |
| GAS | DTE ENERGY 17150 ALLEN ROAD MELVINDALE, MI 48122 | JAY WILLIAMS (313) 380-7303 |
| ELECTRIC | DTE ENERGY WESTERN WAYNE SERVICE CENTER 8001 HAGGERTY ROAD BELLEVILLE, MI 48111 | CLAY COMBEE (734) 397-4112 |
| CABLE | COMCAST 27800 FRANLKIN ROAD SOUTHFIELD, MI 48034 | RON SUTHERLAND (313) 999-8300 |
| PHONE | AT&T 550 S. MAPLE ROAD ANN ARBOR, MI 48103 | (734) 996–2135 |
| FIBER OPTIC | MCI 2800 N. GLENFILLE ROAD RICHARDSON, TX 75082 | DEAN BOYERS (972) 729-6016 |

CONSTRUCTION NOTES:

- 1. Driveways and entrances to buildings, real property, and the like shall not be blocked except for short durations and only when approved by the Engineer. Vehicular and pedestrian access shall be maintained at all times. It shall be the Contractor's responsibility to coordinate all necessary driveway closures with the property owner(s) and resident(s) in the areas of construction.
- 2. The location and depth of all existing utilities and service leads are to be field verified by the Contractor prior to construction.
- 3. Location and depth of utilities as depicted on the plans is approximate and shown according to the best information available. It is the Contractor's responsibility to excavate ahead and adjust depth of conflict utilities accordingly. Any damage to utilities is the Contractor's responsibility to avoid and/or repair as necessary. Supporting existing utilities shall be included in "Machine Grading Modified".
- 4. The Contractor is to take special care to protect the existing water main and be responsible for maintaining consistent water
- 5. During non-working hours no trench shall remain open; any open trench shall be properly secured with protective fencing. This work shall be included in the item of work "General Conditions".
- 6. Trenches for transferring water services shall be excavated to MIOSHA and City of Ann Arbor Field Services requirements.
- 7. City of Ann Arbor Field Services will install the corporation and copper service lead(s) to transfer the connection(s). If an existing water service is found to be failing or is not copper, the lead will be replaced to the curb box by Field Services.
- 8. For the installation of corporations, or any other related activities, the Contractor shall not receive additional compensation for delays due to the scheduling of or coordination with the City of Ann Arbor Field Services.
- 9. The Contractor shall backfill trenches in accordance with Trench Detail Type 1, Modified. This work shall be included in the item of work "Excavate and Backfill for Water Service Tap and Lead". All concrete removals and replacements required for this work will be paid for separately.
- 10. All ductile iron pipe and fittings shall be polyethylene wrapped per ANSI/AWWA C105/A21.5.
- 11. Cor-blu bolts to be used at all mechanical water main joints at hydrants and Megalug

1. The contractor shall implement

plans at all times during

and maintain the soil erosion

construction on this project.

control measures as shown on the

Any modifications or additions to

the soil erosion control measures

conditions shall be complied with

due to construction or changed

as required or directed by the

is required to obtain a Soil

Erosion Control Permit anytime

the disturbed area exceeds 1

2. All soil erosion and sedimentation

control work shall conform to the

Ann Arbor, Chapter 63, and the

inspections shall be made by the

contractor. Periodic inspections

erosion and sedimentation control

corrections shall be made without

delay, and without additional cost

contained on the site and not be

allowed to collect on any off-site

laws of the State of Michigan.

3. Daily or after storm events

owner/project engineer to

measures. Any necessary

4. Erosion and sedimentation from

work on the site shall be

areas or waterways.

determine the effectiveness of

may be made by the

to the Owner.

permit requirements of the City of

owner, project engineer, or the

City of Ann Arbor. The contractor

GENERAL

SOIL EROSION CONTROL NOTES:

- 12. When all water services are transferred the Contractor shall abandon the existing water main. Reference the Public Services Department Standard Specifications for water main abandonment procedures. Caps and plugs shall be installed by the Contractor where shown on the plans and shall be included in the item of work for water main abandonment or as directed by Engineer.
- 13. The Contractor shall construct, flush, and bacteriologically test the water main as detailed in the Public Services Department Standard Specifications. "Water Main Testing" (Item 3H, pg. IV-34) and as approved by the Engineer. All chloringted water shall be discharged directly into an approved sanitary sewer. The Contractor shall supply all necessary hoses, fittings and the like to accomplish this work.
- 14. Water main fittings, other than those specifically listed as separate pay items, which are required to complete the work, such as blow-off assemblies, concrete thrust blocks, solid sleeves and mechanical plugs, shall not be paid for separately, but shall be included in the pipe pay items.
- 15. "No Parking" signs shall be installed by the Contractor at locations as approved or directed by the Engineer. All signs shall be installed in accordance with the detailed specifications. Contractor to coordinate with DDA and Republic Parking to obtain meter bags for parking meters within the construction limits. The cost of parking meter bags to be included in pay item "General Conditions, Modified".
- 16. Postal delivery and refuse pickup service shall be maintained at all times by the Contractor.
- 17. All fittings, hydrants, valves and castings removed during construction are the property of the City of Ann Arbor. The Contractor within 48 hours shall deliver to City of Ann Arbor Field Operations and Maintenance Facility at the W.R. Wheeler Service Center located at 4251 Stone School Road.
- 18. Where street curbs are undermined due to construction activities, they shall be removed and replaced as directed by the Engineer.
- 19. The Contractor shall be responsible for the continuous maintenance of the temporary road surface and soil erosion control measures within the construction area until the full completion of the project. This work shall be included in the item of work "General Conditions".
- 20. All curb, sidewalk, driveway approach removals shall be approved by Engineer before the

5. All mud/dirt tracked onto roads

from the site due to construction.

shall be promptly removed by the

mechanical street sweeper at no

contractor. If so ordered, the

additional cost to the Owner.

6. Restoration of all disturbed areas,

including placement of topsoil,

seed, fertilizer and mulch and/or

sod shall be done within 5 days

of the completion of final grade

scheduled and performed so that

preventative soil erosion control

excavation in critical areas and

temporary stabilization measures

are in place immediately following

measures are in place prior to

8. Special precautions will be taken

equipment to prevent situations

maintained during construction by

chloride as required or as directed

in the use of construction

that promote erosion.

10. The contractor shall be

by Engineer.

stabilized.

9. Proper dust control shall be

use of water trucks and/or

responsible for maintaining all

temporary soil erosion control

measures and removal of some

not be authorized until all site

work and utility construction is

complete and all soils are

upon authorized completion of the

project. Completion of project will

backfilling operations.

7. Construction operations shall be

Contractor shall employ a

11. The contractor shall not grade

fence shall be installed and

12. Tree protection fencing must

SEQUENCE OF EROSION CONTROL

fencing and inlet filters on

. Install inlet filters immediately

following installation of proposed

3. Contractor to continually maintain

measures, as required to allow

Remove any accumulated

control measures around

6. Install stormwater management

7. Connect stormwater management

temporary stock piles.

drainage and sediment removal.

erosion and sedimentation control

. Strip and clear — maintain erosion

clearing or earth moving

storm drainage system.

Install silt fence, tree protection

existing storm inlets prior to any

the site is complete.

MEASURES:

operation.

sediment.

5. **Rough grade**

system.

into adjacent properties. Silt

maintained to prevent grading,

erosion and sedimentation into

remain intact until restoration of

- 21. Sawed sewer pipe connections shall be coupled with a Fernco flexible coupling and a stainless steel shear ring.
- 22. The location of material stock piles and on-site staging areas to be approved by the Engineer At no time shall the contractor be allowed to store materials or equipment on Willard Street.
- 23. For mainline paving, the width of the mat for each pass of the paver shall be not less than 10.5' or greater than 15', as directed by the Engineer. The Engineer will direct the layout of the longitudinal joints during construction.
- 24. All structures shall receive new castings as directed by the Engineer, either Type B or Type K, or as specified on the standard casting schedule. The existing castings are the property of the City of Ann Arbor. The Contractor shall deliver to City of Ann Arbor Field Operations and Maintenance Facility at the W.R. Wheeler Service Center located at 4251 Stone School Road.
- 25. Payment for drainage structure sumps, where specified, shall be included in the payment for the various drainage structure sizes and or types.
- . Where sewer pipes of different sizes or materials are joined, Fernco flexible couplings with stainless steel shear rings shall be used. The Contractor's purchase price for these devices, including shipping, shall be paid as an extra. Prior to payment for this item, the Contractor shall submit receipts for the Engineer's review and approval. All other costs associated with the installation of these devices shall be included in the payment for the sewer.
- . Where sewer and water main are to be removed & replaced or added, all pipe shall be installed using Trench Detail 1, Modified as detailed in the specifications. Trench Detail 1 backfill for sewer and water construction shall be MDOT Granular Material, Class II, Modified.
- 28. Existing street name, guide, and regulatory signs, and mailboxes which conflict with the proposed construction shall be removed prior to construction, stored in a manner which will prevent damage, and re—set in locations as directed by the Engineer. This work will not be paid for separately, but shall be included in "Machine Gradina, Modified"
- 29. In areas where edge drain cannot be installed in accordance with City of Ann Arbor Detail SD-TD-11, the edge drain shall be installed at the depth as indicated on the plans, or as directed by Engineer. In no case shall the edge drain be installed at a grade less than 0.50% or at a depth of less than 2' below top of proposed pavement.

control measures.

TEMPORARY SEEDING

1. Seed in accordance with project drawings and specifications.

Remove all temporary soil erosion

8. Ensure all soil is stabilized.

2. Any disturbed area not paved, seeded, mulched, sodded or built upon by November 15th or June 30th is to be temporarily stabilized per specifications.

ROADS:


- 1. During construction, all roads shall be protected from unvegetated areas washing onto road surface by placement of silt fence behind curb or a 10 foot wide straw mulch bank behind curb or other approved method and/or as shown on the plans.
- 2. During construction of any portion of the project, adjoining roads shall be maintained free of dirt, silt and construction debris. Contractor required to use vacuum sweeper equipment for cleaning construction site and adjoining roads. The use of broom sweeper is not permitted.

CATCH BASIN/MANHOLE PROTECTION

1. Protect storm sewer catch basins with approved inlet filters.

CIVIL SYMBOL LEGEND

TOPOGRAPHY - PLAN

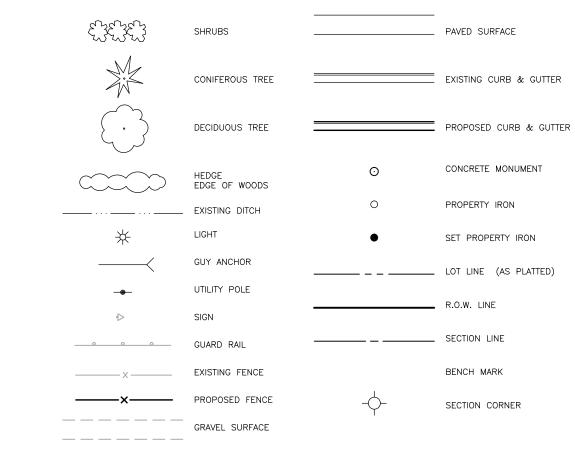

EXISTING UTILITIES

PIPE CONTENTS ABBREVIATIONS

SAN

STM

WTR

NATURAL GAS

STORM SEWER

FORCE MAIN

WATER

SANITARY SEWER

| 8" SAN | SANITARY SEWER & MANHOLE | | SANITARY SEWER & MANHOLE |
|----------------|--------------------------------------|-------------|--------------------------------|
| 12" STM | STORM SEWER & MANHOLE | J | |
| \blacksquare | CATCH BASIN CURB TYPE | | ■ WYE & LEAD |
| \oplus | CATCH BASIN LAWN TYPE | | ➡ RISER & LEAD |
| | — VALVE | | |
| <u></u> | HYDRANT | 0 | STANDARD SEWER CLEANOUT |
| | PLUG | 12" STM | |
| 6" | WTR WATER MAIN | <u></u> | STORM SEWER & MANHOLE |
| | | ⊕ ⊞ ⊖ 🖪 | CATCH BASIN |
| 2" | GAS GAS MAIN | | |
| | —— UNDERGROUND ELECTRIC | | UNDERDRAIN |
| OP | —— FIBER OPTICS | 8" WTR | → WATER MAIN |
| | UNDERGROUND TELEPHONE | | |
| 早 | TELEPHONE PEDESTAL | → | VALVE & BOX |
| MISC | <u>ELLANEOUS</u> | | |
| | EASEMENT LINE | М | METER |
| • | SOIL BORING LOCATION | | PLUG |
| 855.00 | PROPOSED PAVEMENT/GUTTER ELEVATION | | |
| | ~ | | STANDARD FIRE HYDRANT ASSEMBLY |
| | PROPOSED PAVEMENT MARKING (PAINTING) | | CURB STOP & BOX |
| <u></u> | PROPOSED BARRIER FREE | \phi | |

| PIPE | MATERIAL ABBREVIATIONS |
|----------|------------------------------|
| CSP | CORRUGATED STEEL PIPE |
| CSPA | CORRUGATED STEEL PIPE ARCH |
| DIP | DUCTILE IRON PIPE |
| NRCP | NON-REINFORCED CONCRETE PIPE |
| PE | POLYETHYLENE |
| PE PERF. | POLYETHYLENE PIPE PERFORATED |
| PVC | POLYVINYL CHLORIDE |
| RCP | REINFORCED CONCRETE PIPE |
| VCP | VITRIFIED CLAY PIPE |

PROPOSED UTILITIES

| TITOT COLD CHEHILO |
|---------------------------------|
| 8" SAN SANITARY SEWER & MANHOLE |
| WYE & LEAD |
| RISER & LEAD |
| O——— STANDARD SEWER CLEANOUT |
| 12" STM STORM SEWER & MANHOLE |
| ⊕ ⊞ ⊖ ⊟ CATCH BASIN |
| - UNDERDRAIN |
| 8" WTR WATER MAIN |
| VALVE & BOX |

| 3 | ⊗ | STANDARD FIRE HYDR. |
|---|----------|---------------------|
| , | → | CURB STOP & BOX |
| | | GAS MAIN |
| | | UNDERGROUND ELECT |
| | | UNDERGROUND TELEF |

MANAGEMENT **PROJECT**

R EC


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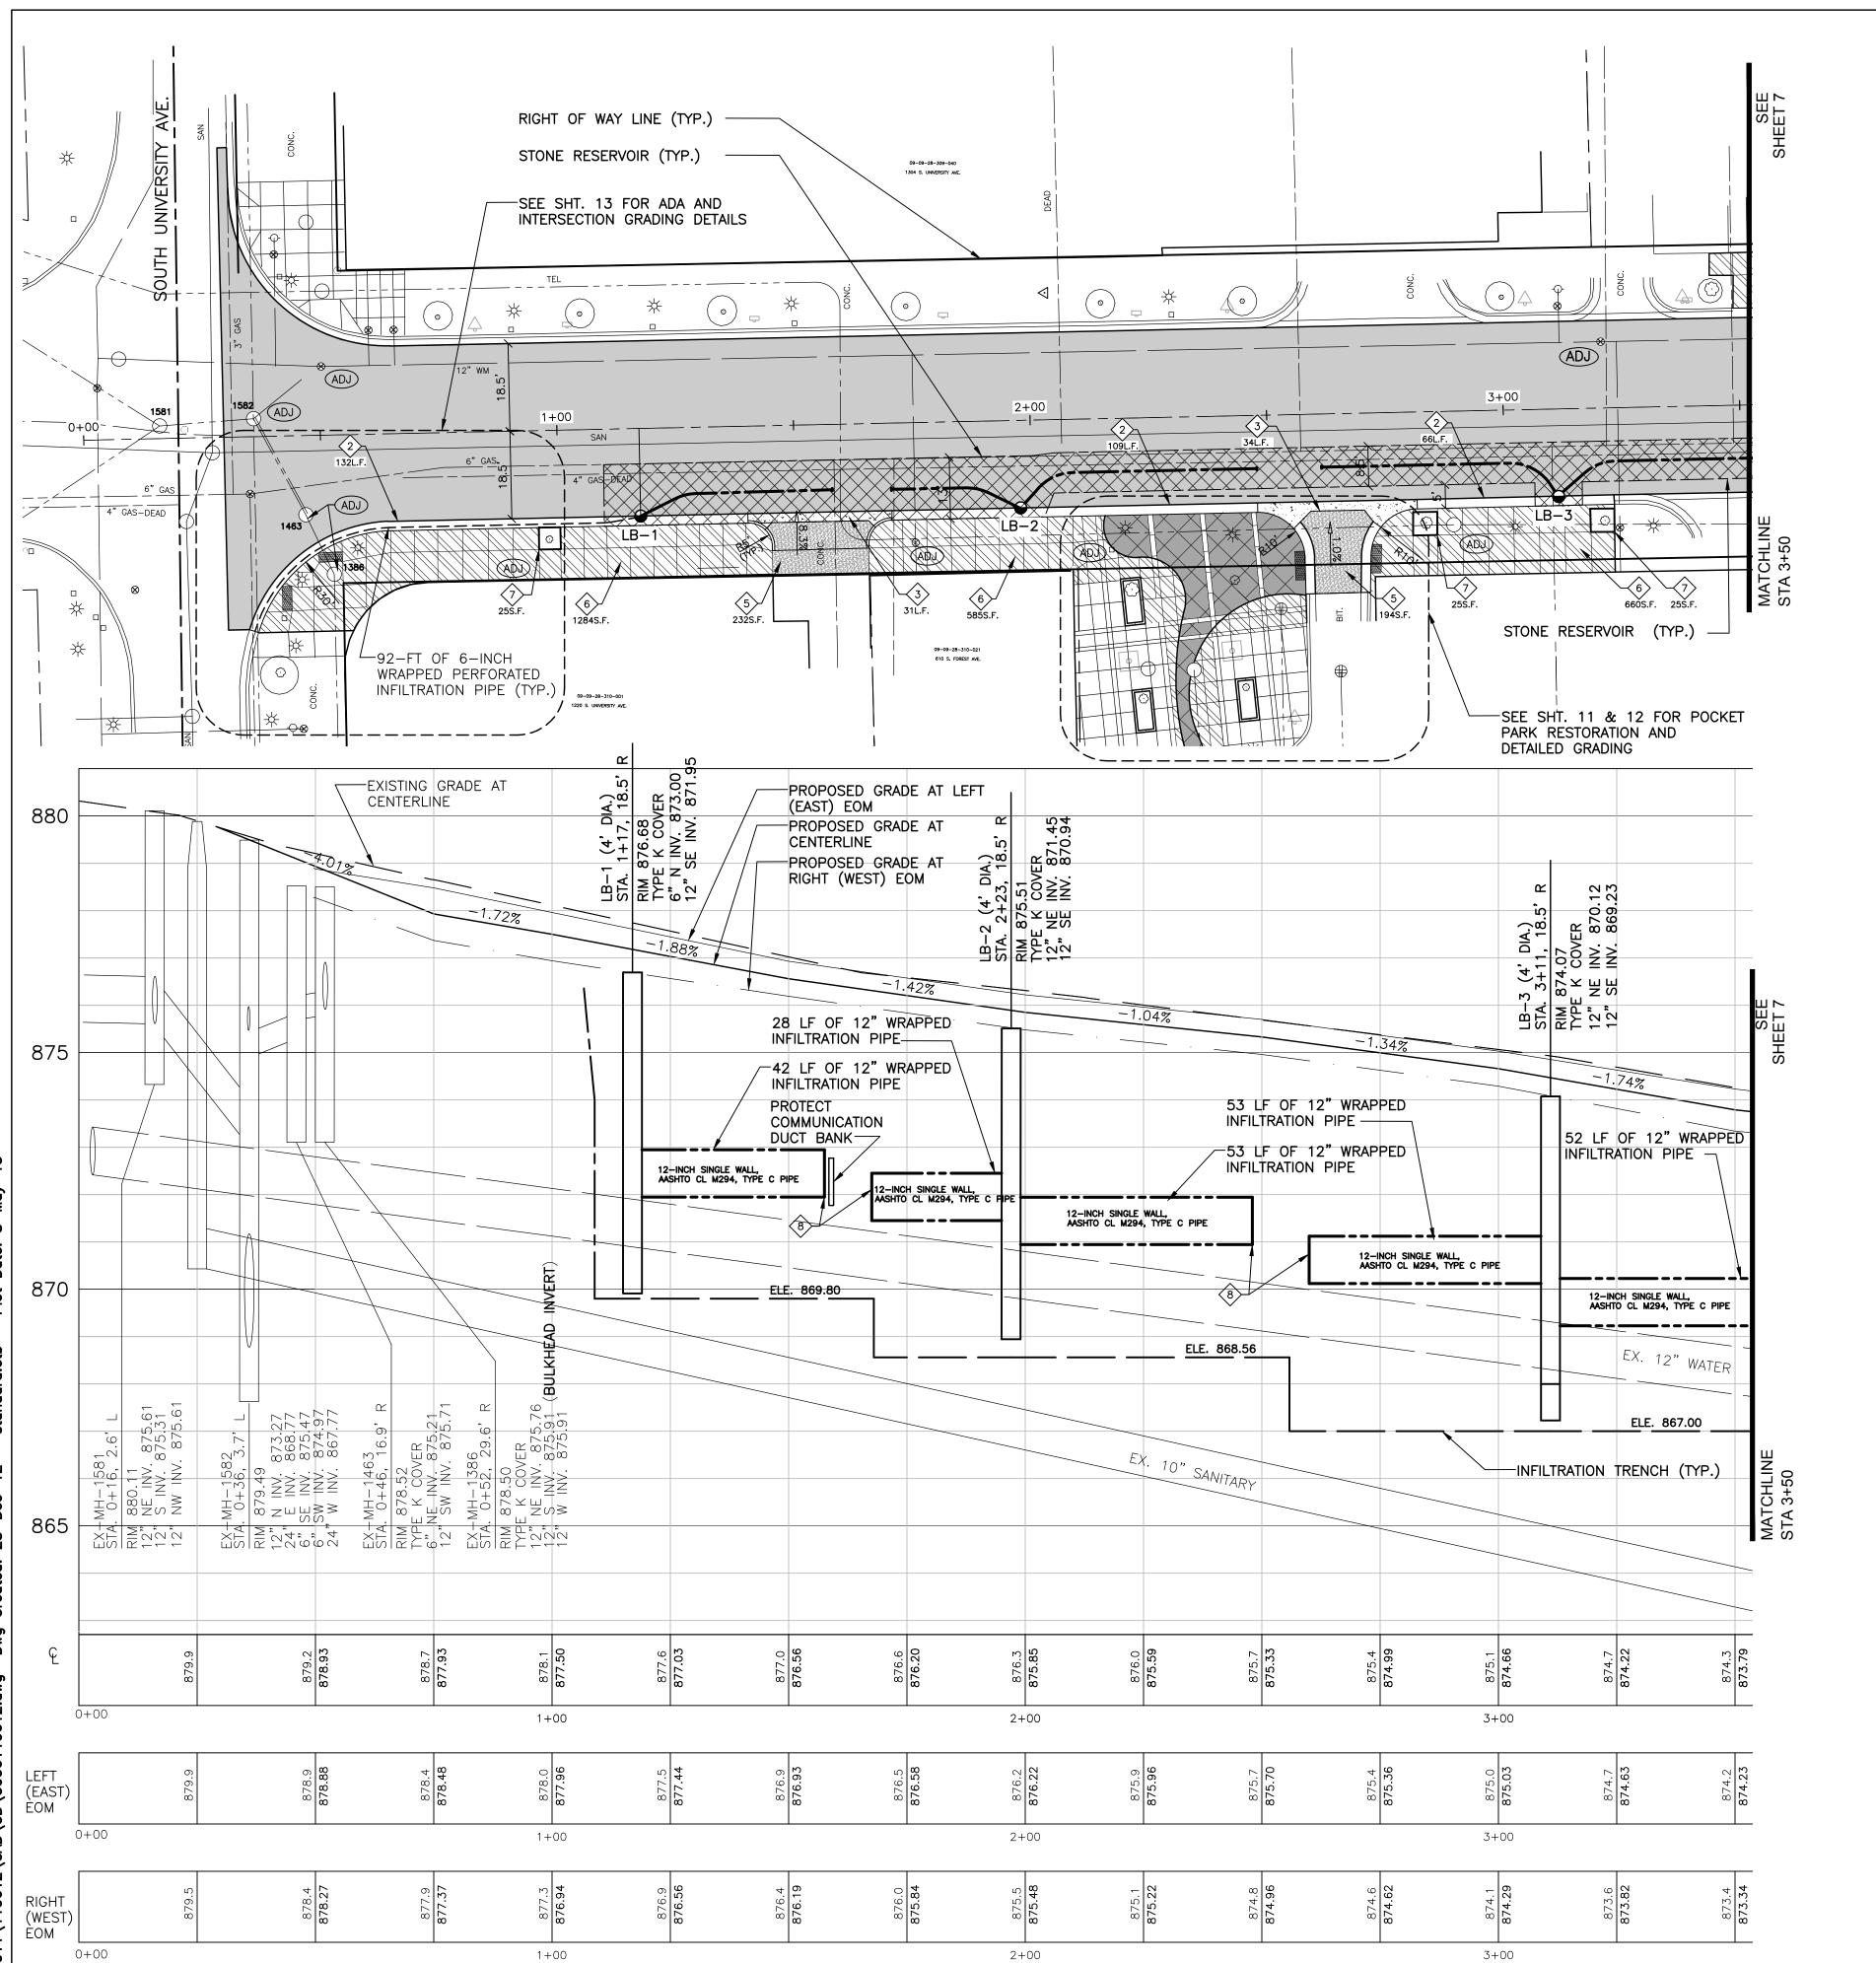
ANN ENT F

S - CITY OF A

PUBLIC FOREST

SHEET No.



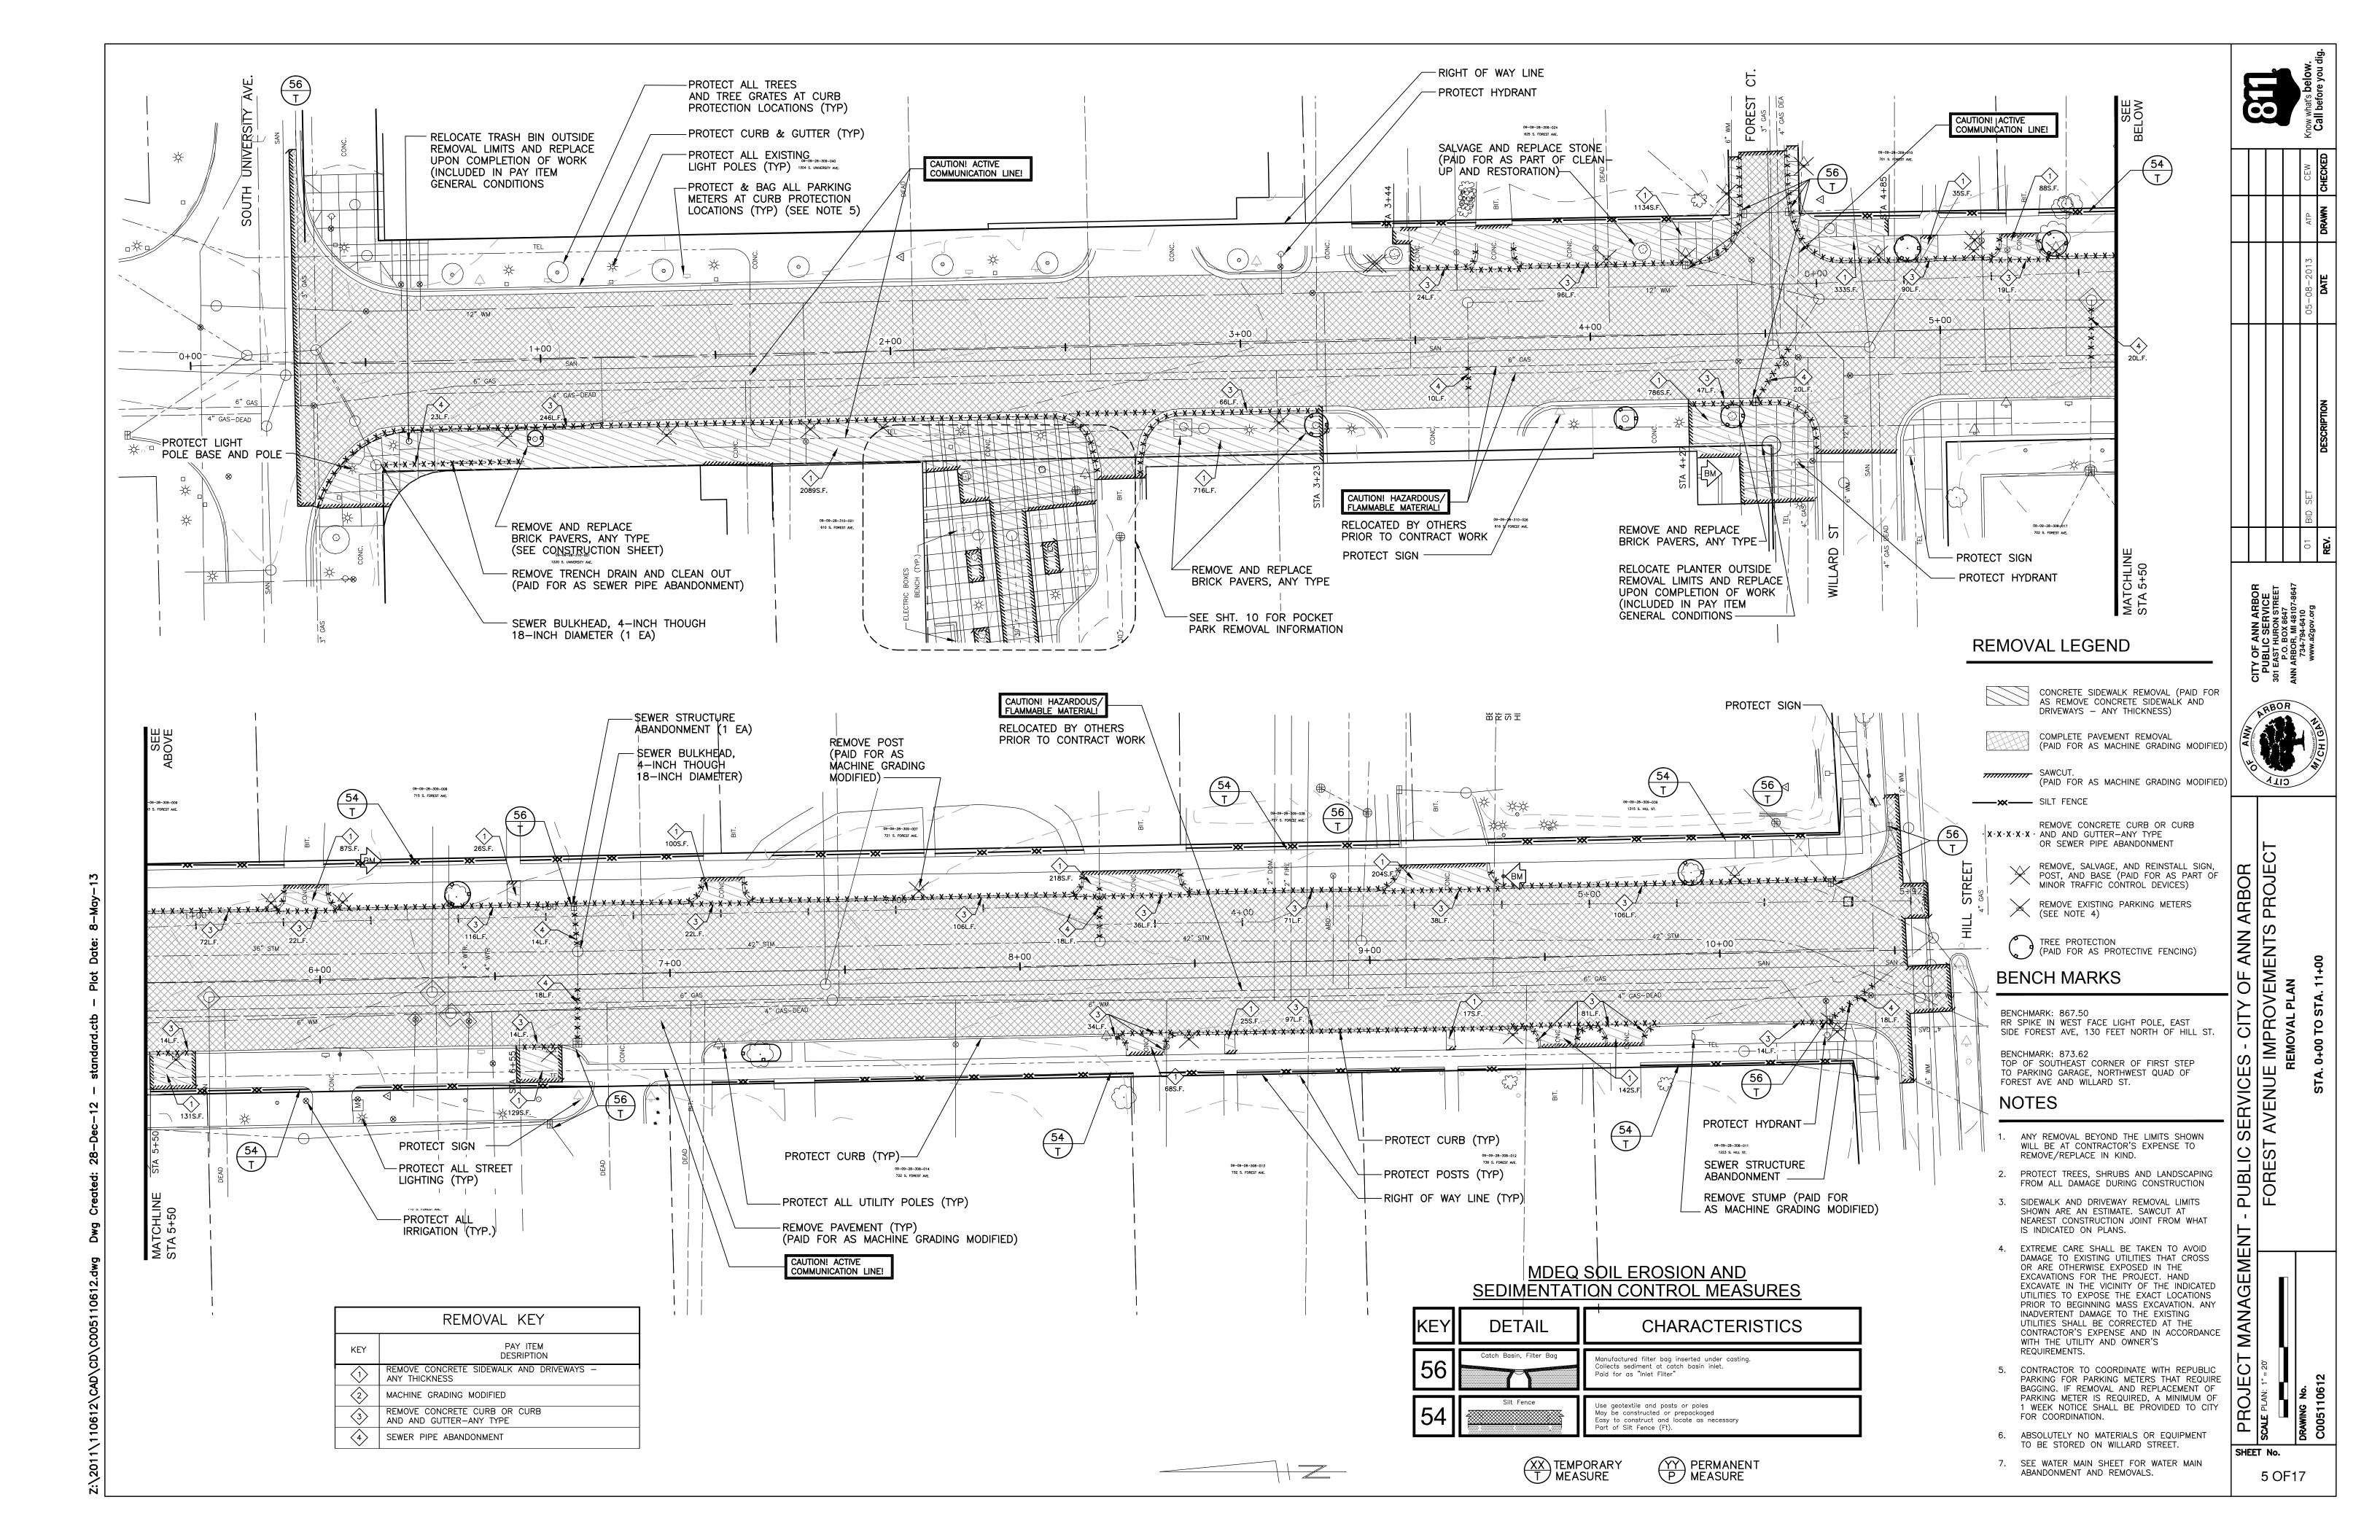

| | CONSTRUCTION KEY | |
|-------------------------------------|---|-------------------------------|
| KEY | PAY ITEM DESRIPTION | CITY OF ANN ARBOR DETAIL |
| $\langle 1 \rangle$ | SPILL-OUT BARRIER CURB AND GUTTER (PAID AS CONCRETE CURB OR CURB & GUTTER - ANY TYPE) | SD-R-3 |
| 2 | BARRIER CURB AND GUTTER (PAID AS CONCRETE CURB OR CURB & GUTTER — ANY TYPE) | SD-R-1 |
| $\langle 3 \rangle$ | 'M' OPENING (PAID AS CONCRETE CURB OR CURB & GUTTER — ANY TYPE) | SD-R-6 |
| 4 | 6-INCH DRIVE APPROACH (PAID AS 4 OR 6-INCH SIDEWALK, RAMP, OR DRIVE) | SD-R-6 |
| 5 | 8-INCH DRIVE APPROACH (PAID AS 4 OR 6-INCH SIDEWALK, RAMP, OR DRIVE) | SD-R-6 |
| 6 | 4 OR 6-INCH SIDEWALK, RAMP, OR DRIVE | MDOT R-28-F SD-SW & SD-R-9 |
| $\langle \overline{\gamma} \rangle$ | REMOVE AND REPLACE BRICK PAVERS, ANY TYPE | |
| 8 | SPLIT END CAP | |

| | CONSTRUCTION KEY | |
|------------|---|-------------------------------|
| KEY | PAY ITEM DESRIPTION | CITY OF ANN ARBOR DETAIL |
| \bigcirc | SPILL—OUT BARRIER CURB AND GUTTER (PAID AS CONCRETE CURB OR CURB & GUTTER — ANY TYPE) | SD-R-3 |
| 2 | BARRIER CURB AND GUTTER (PAID AS CONCRETE CURB OR CURB & GUTTER — ANY TYPE) | SD-R-1 |
| 3> | 'M' OPENING (PAID AS CONCRETE CURB OR CURB & GUTTER — ANY TYPE) | SD-R-6 |
| 4 | 6-INCH DRIVE APPROACH (PAID AS 4 OR 6-INCH SIDEWALK, RAMP, OR DRIVE) | SD-R-6 |
| 5 | 8-INCH DRIVE APPROACH (PAID AS 4 OR 6-INCH SIDEWALK, RAMP, OR DRIVE) | SD-R-6 |
| 6 | 4 OR 6-INCH SIDEWALK, RAMP, OR DRIVE | MDOT R-28-F SD-SW & SD-R-9 |
| ₹ | REMOVE AND REPLACE BRICK PAVERS, ANY TYPE | |
| 8 | SPLIT END CAP | |

| EXISTING STORM SEWER STRUCTURE TABLE | | | | | |
|--------------------------------------|-----------------|---------------------------|------|--|------------------------------|
| STRUCTURE NUMBER | ROAD STATION | PROPOSED RIM ELEVATION | TYPE | INVERTS | ADJUSTMENTS |
| 1581 | 0+16 | 880.11 | STMH | 12" NE = 875.61 12" S = 875.31 12" NW = 875.61 | N/A |
| 1582 | 0+36 | 879.49 | STMH | 12" N = 873.27 24" E = 868.77 6" SE = 875.47 6" SW = 874.97 24" W = 867.77 | ADJUST STRUCTURE COVER |
| 1463 | 0+46 | 878.52 | STMH | 6" NE = 875.21 12" SW = 875.71 | ADJUST STRUCTURE COVER |
| 1386 | 0+52 | 878.50 | STMH | 12" NE = 875.76 12" S = 875.91 (BH) 12" W = 875.91 | ADJUST STRUCTURE COVER |

| _ | | | | | |
|---|--------------------------------------|-----------------|---------------------------|--------------------------------------|--|
| | PROPOSED STORM SEWER STRUCTURE TABLE | | | | |
| | STRUCTURE NUMBER | ROAD STATION | PROPOSED RIM ELEVATION | STRUCTURE TYPE AND COVER | INVERTS |
| ľ | LB-1 | 1+17 | 876.68 | LEACHING BASIN-48" DIA W/ COVER K | N 6" INV. = 873.00 SE 12" INV. = 871.95 |
| | LB-2 | 2+23 | 875.51 | LEACHING BASIN-48" DIA W/ COVER K | NE INV. = 871.45 SE INV. = 870.94 |
| | LB-3 | 3+11 | 874.07 | LEACHING BASIN-48" DIA W/ COVER K | NE INV. = 870.12 SE INV. = 869.23 |



PROPOSED STANDARD PAVEMENT SECTION (SEE SHEET 2 FOR LIST OF PAY ITEMS AND THICKNESSES)

6-INCH DRIVE APPROACH
(PAID FOR AS 4 OR 6-INCH SIDEWALK,
RAMP OR DRIVE) PROPOSED 'M' DRIVE APPROACH PER SD-R-6 (PAID FOR AS

8-INCH DRIVE APPROACH (PAID FOR AS 8-INCH SIDEWALK, RAMP OR DRIVE)

PROPOSED SIDEWALK. (PAID FOR AS 4 OR 6-INCH SIDEWALK, RAMP OR DRIVE) STONE RESERVOIR (CYD)


REMOVE, REPLACE AND ADJUST
COVER/RIM/CASTING PER ENGINEER (PAID AS
EITHER "ADJUST STRUCTURE COVER" OR
"ADJUST MONUMENT BOX OR GATE VALVE AND
BOX")





PROJECT MANAGEMENT - PUBLIC SERVICES - CITY OF ANN ARBOI scale PLAN: 1"=20" PROFILE: 1"=20" FOREST AVENUE ROAD PLAN AND PROFILE ROAWING NO.

SHEET No.

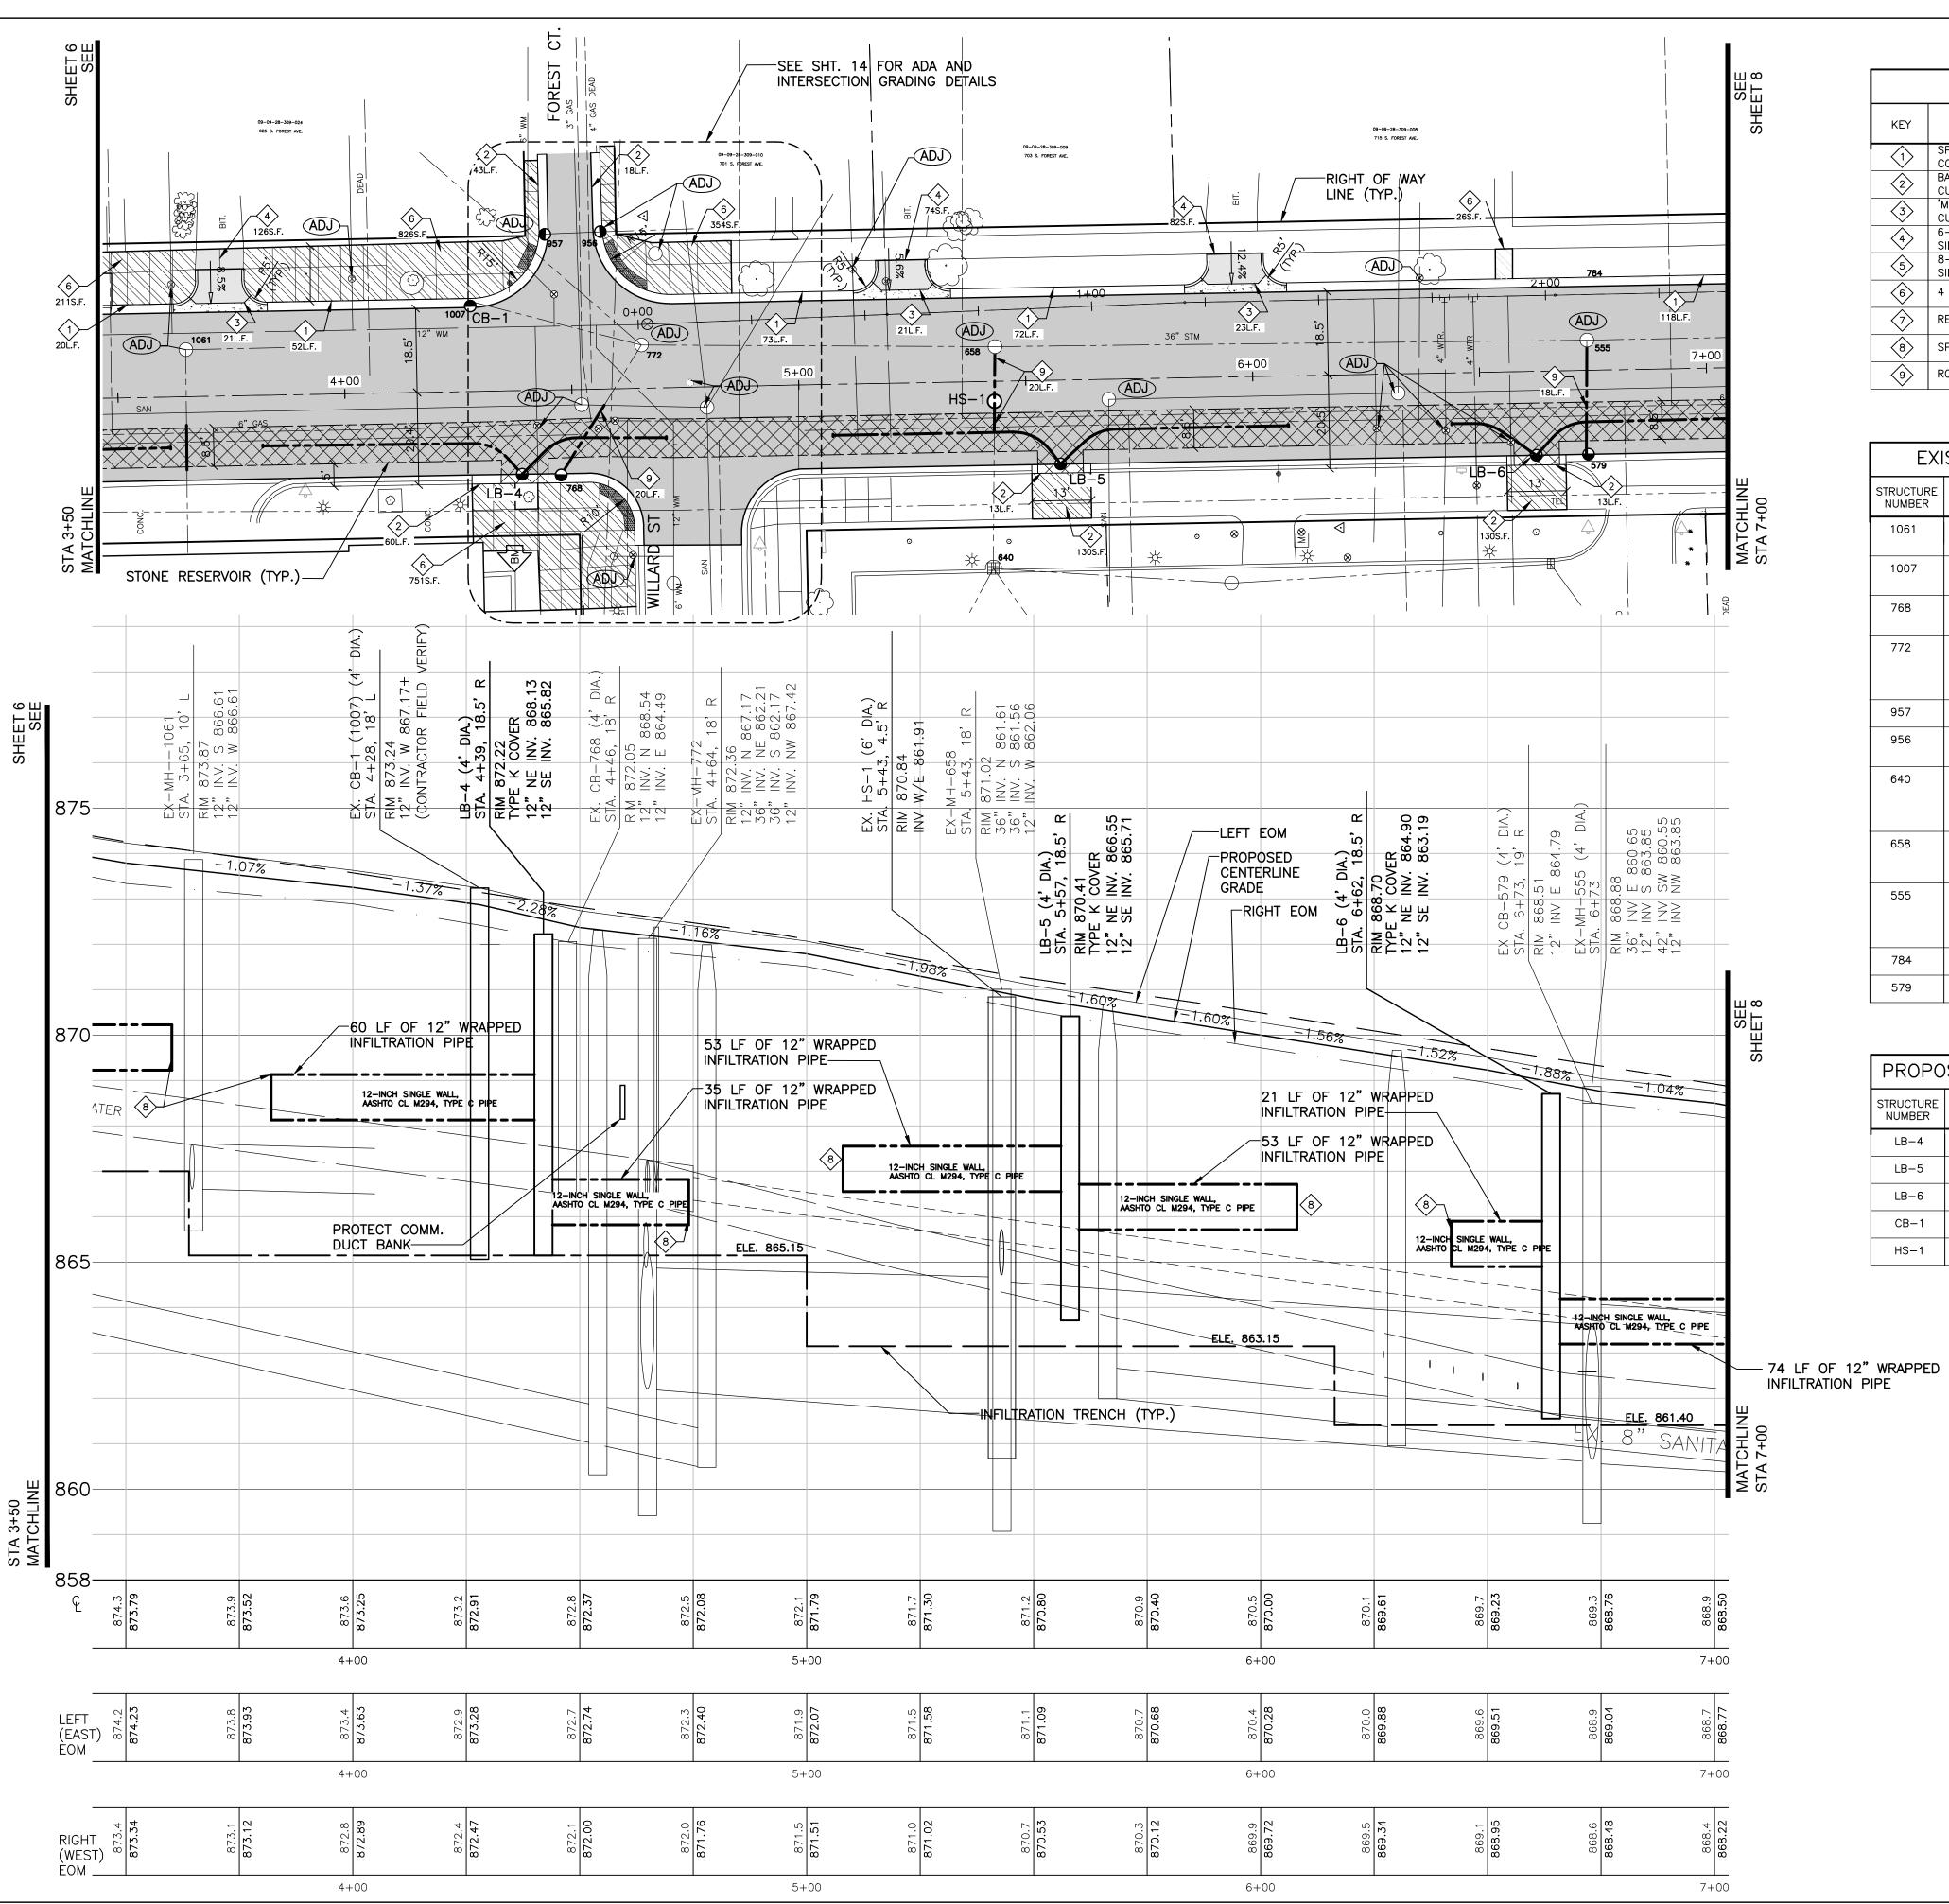

| | CONSTRUCTION KEY | | | | |
|-----|---|-----------------------------|--|--|--|
| KEY | PAY ITEM DESRIPTION | CITY OF ANN ARBOR DETAIL | | | |
| 1 | SPILL-OUT BARRIER CURB AND GUTTER (PAID AS CONCRETE CURB OR CURB & GUTTER - ANY TYPE) | SD-R-3 | | | |
| 2 | BARRIER CURB AND GUTTER (PAID AS CONCRETE CURB OR CURB & GUTTER — ANY TYPE) | SD-R-1 | | | |
| 3 | 'M' OPENING (PAID AS CONCRETE CURB OR CURB & GUTTER — ANY TYPE) | SD-R-6 | | | |
| 4 | 6-INCH DRIVE APPROACH (PAID AS 4 OR 6-INCH SIDEWALK, RAMP, OR DRIVE) | SD-R-6 | | | |
| 5 | 8-INCH DRIVE APPROACH (PAID AS 4 OR 6-INCH SIDEWALK, RAMP, OR DRIVE) | SD-R-6 | | | |
| 6 | 4 OR 6-INCH SIDEWALK, RAMP, OR DRIVE | MDOT R-28-F SD-SW | | | |
| 7 | REMOVE AND REPLACE BRICK PAVERS, ANY TYPE | | | | |
| 8 | SPLIT END CAP | | | | |
| 9 | RCP CL V, 12-INCH, TRENCH DETAIL I | SD-TD-1 | | | |

| | CONSTRUCTION KEY | | | | |
|-----|---|-----------------------------|--|--|--|
| KEY | PAY ITEM DESRIPTION | CITY OF ANN ARBOR DETAIL | | | |
| 1 | SPILL-OUT BARRIER CURB AND GUTTER (PAID AS CONCRETE CURB OR CURB & GUTTER - ANY TYPE) | SD-R-3 | | | |
| 2 | BARRIER CURB AND GUTTER (PAID AS CONCRETE CURB OR CURB & GUTTER — ANY TYPE) | SD-R-1 | | | |
| 3 | 'M' OPENING (PAID AS CONCRETE CURB OR CURB & GUTTER — ANY TYPE) | SD-R-6 | | | |
| 4 | 6-INCH DRIVE APPROACH (PAID AS 4 OR 6-INCH SIDEWALK, RAMP, OR DRIVE) | SD-R-6 | | | |
| 5 | 8-INCH DRIVE APPROACH (PAID AS 4 OR 6-INCH SIDEWALK, RAMP, OR DRIVE) | SD-R-6 | | | |
| 6 | 4 OR 6-INCH SIDEWALK, RAMP, OR DRIVE | MDOT R-28-F SD-SW | | | |
| 7> | REMOVE AND REPLACE BRICK PAVERS, ANY TYPE | | | | |
| 8 | SPLIT END CAP | | | | |
| 9 | RCP CL V, 12-INCH, TRENCH DETAIL I | SD-TD-1 | | | |

| EXI | STING S | STORM SE | EWER | STRUCTURE TA | BLE |
|---------------------|-----------------|---------------------------|------|--|-------------------------|
| STRUCTURE NUMBER | ROAD STATION | PROPOSED RIM ELEVATION | TYPE | INVERTS | ADJUSTMENT |
| 1061 | 3+65 | 873.87 | STMH | 12" S = 866.61 12" W = 866.61 | ADJUST STRUC COVER |
| 1007 | 4+27 | 873.23 | СВ | 12" S = ? | REMOVE CI (SEE CB-1 |
| 768 | 4+46 | 872.05 | СВ | 12" N = 868.54 12" S = 864.49 | ADJUST STRUC COVER |
| 772 | 4+65 | 872.36 | STMH | 12" N = 867.17 36" NE = 862.21 36" S = 862.17 12" NW = 867.42 | ADJUST STRUC COVER |
| 957 | 4+44 | | СВ | 12" N = 870.01 | REPLACE COV W/ COVER |
| 956 | 4+57 | | СВ | 12" N = 868.54 12" S = 864.49 | REPLACE COV W/ COVER |
| 640 | 5+42 | 869.45 | СВ | 12" E = 862.55 12" S = 862.55 8" SW = 865.40 12" NW = 864.25 | N/A |
| 658 | 5+43 | 871.02 | STMH | 36" N = 861.61 36" S = 861.56 12" W = 862.06 | ADJUST STRUC COVER |
| 555 | 6+73 | 868.88 | STMH | 36" E = 860.65 12" S = 863.85 42" SW = 860.55 12" NW = 863.85 | ADJUST STRUC COVER |
| 784 | 6+72 | SEE CB-1 | СВ | 12" W = 864.16 | REMOVE CE |
| 579 | 6+73 | 868.51 | СВ | 12" E = 864.79 | ADJUST STRUC COVER |

| PROPOSED STORM SEWER STRUCTURE TABLE | | | | |
|--------------------------------------|-----------------|---------------------------|--------------------------------------|--|
| STRUCTURE NUMBER | ROAD STATION | PROPOSED RIM ELEVATION | STRUCTURE TYPE AND COVER | INVERTS |
| LB-4 | 4+39 | 872.22 | LEACHING BASIN-48" DIA W/ COVER K | NE INV. = 868.13 SE INV. = 865.82 |
| LB-5 | 5+57 | 870.41 | LEACHING BASIN-48" DIA W/ COVER K | NE INV. = 866.55 SE INV. = 865.71 |
| LB-6 | 6+62 | 868.70 | LEACHING BASIN-48" DIA W/ COVER K | NE INV. = 864.90 SE INV. = 863.19 |
| CB-1 | 4+27 | 873.23 | SINGLE INLET W/ COVER K | S INV. = CONTRACTOR TO FIELD VERIFY |
| HS-1 | 5+43 | 870.84 | HYDRO SEPARATOR | W 12" INV. = 861.91 E 12" INV. = 861.91 |

| | below. |
|---------------------------|-----------------------------|
| MENT SECTION PAY ITEMS | now what's be Call before y |
| | Ca |

| | PROPOSED STANDARD PAVEMENT SECTION (SEE SHEET 2 FOR LIST OF PAY ITEMS AND THICKNESSES) |
|--------|--|
| | 6-INCH DRIVE APPROACH (PAID FOR AS 4 OR 6-INCH SIDEWALK RAMP OR DRIVE) |
| 14, 25 | PROPOSED 'M' DRIVE APPROACH PER |

PROPOSED 'M' DRIVE APPROACH PER SD-R-6 (PAID FOR AS

LEGEND

PROPOSED SIDEWALK. (PAID FOR AS 4 OR 6-INCH SIDEWALK, RAMP OR DRIVE) STONE RESERVOIR (CYD)

REMOVE, REPLACE AND ADJUST COVER/RIM/CASTING PER ENGINEER (PAID AS EITHER "ADJUST STRUCTURE COVER" OR "ADJUST MONUMENT BOX OR GATE VALVE AND BOX")

(PAID FOR AS 8-INCH SIDEWALK, RAMP OR DRIVE)

PROJECT MANAGEMENT - PUBLIC SERVICES - CITY OF ANN ARBOI


SCALE PLAN: 1"=20" PROFILE: 1"=20" FOREST AVENUE

BRAWING No. STA 3+50 TO 7+00

SCALE PLAN: 1"=20" FOREST AVENUE

ROAD PLAN AND PROFILE

STA 3+50 TO 7+00

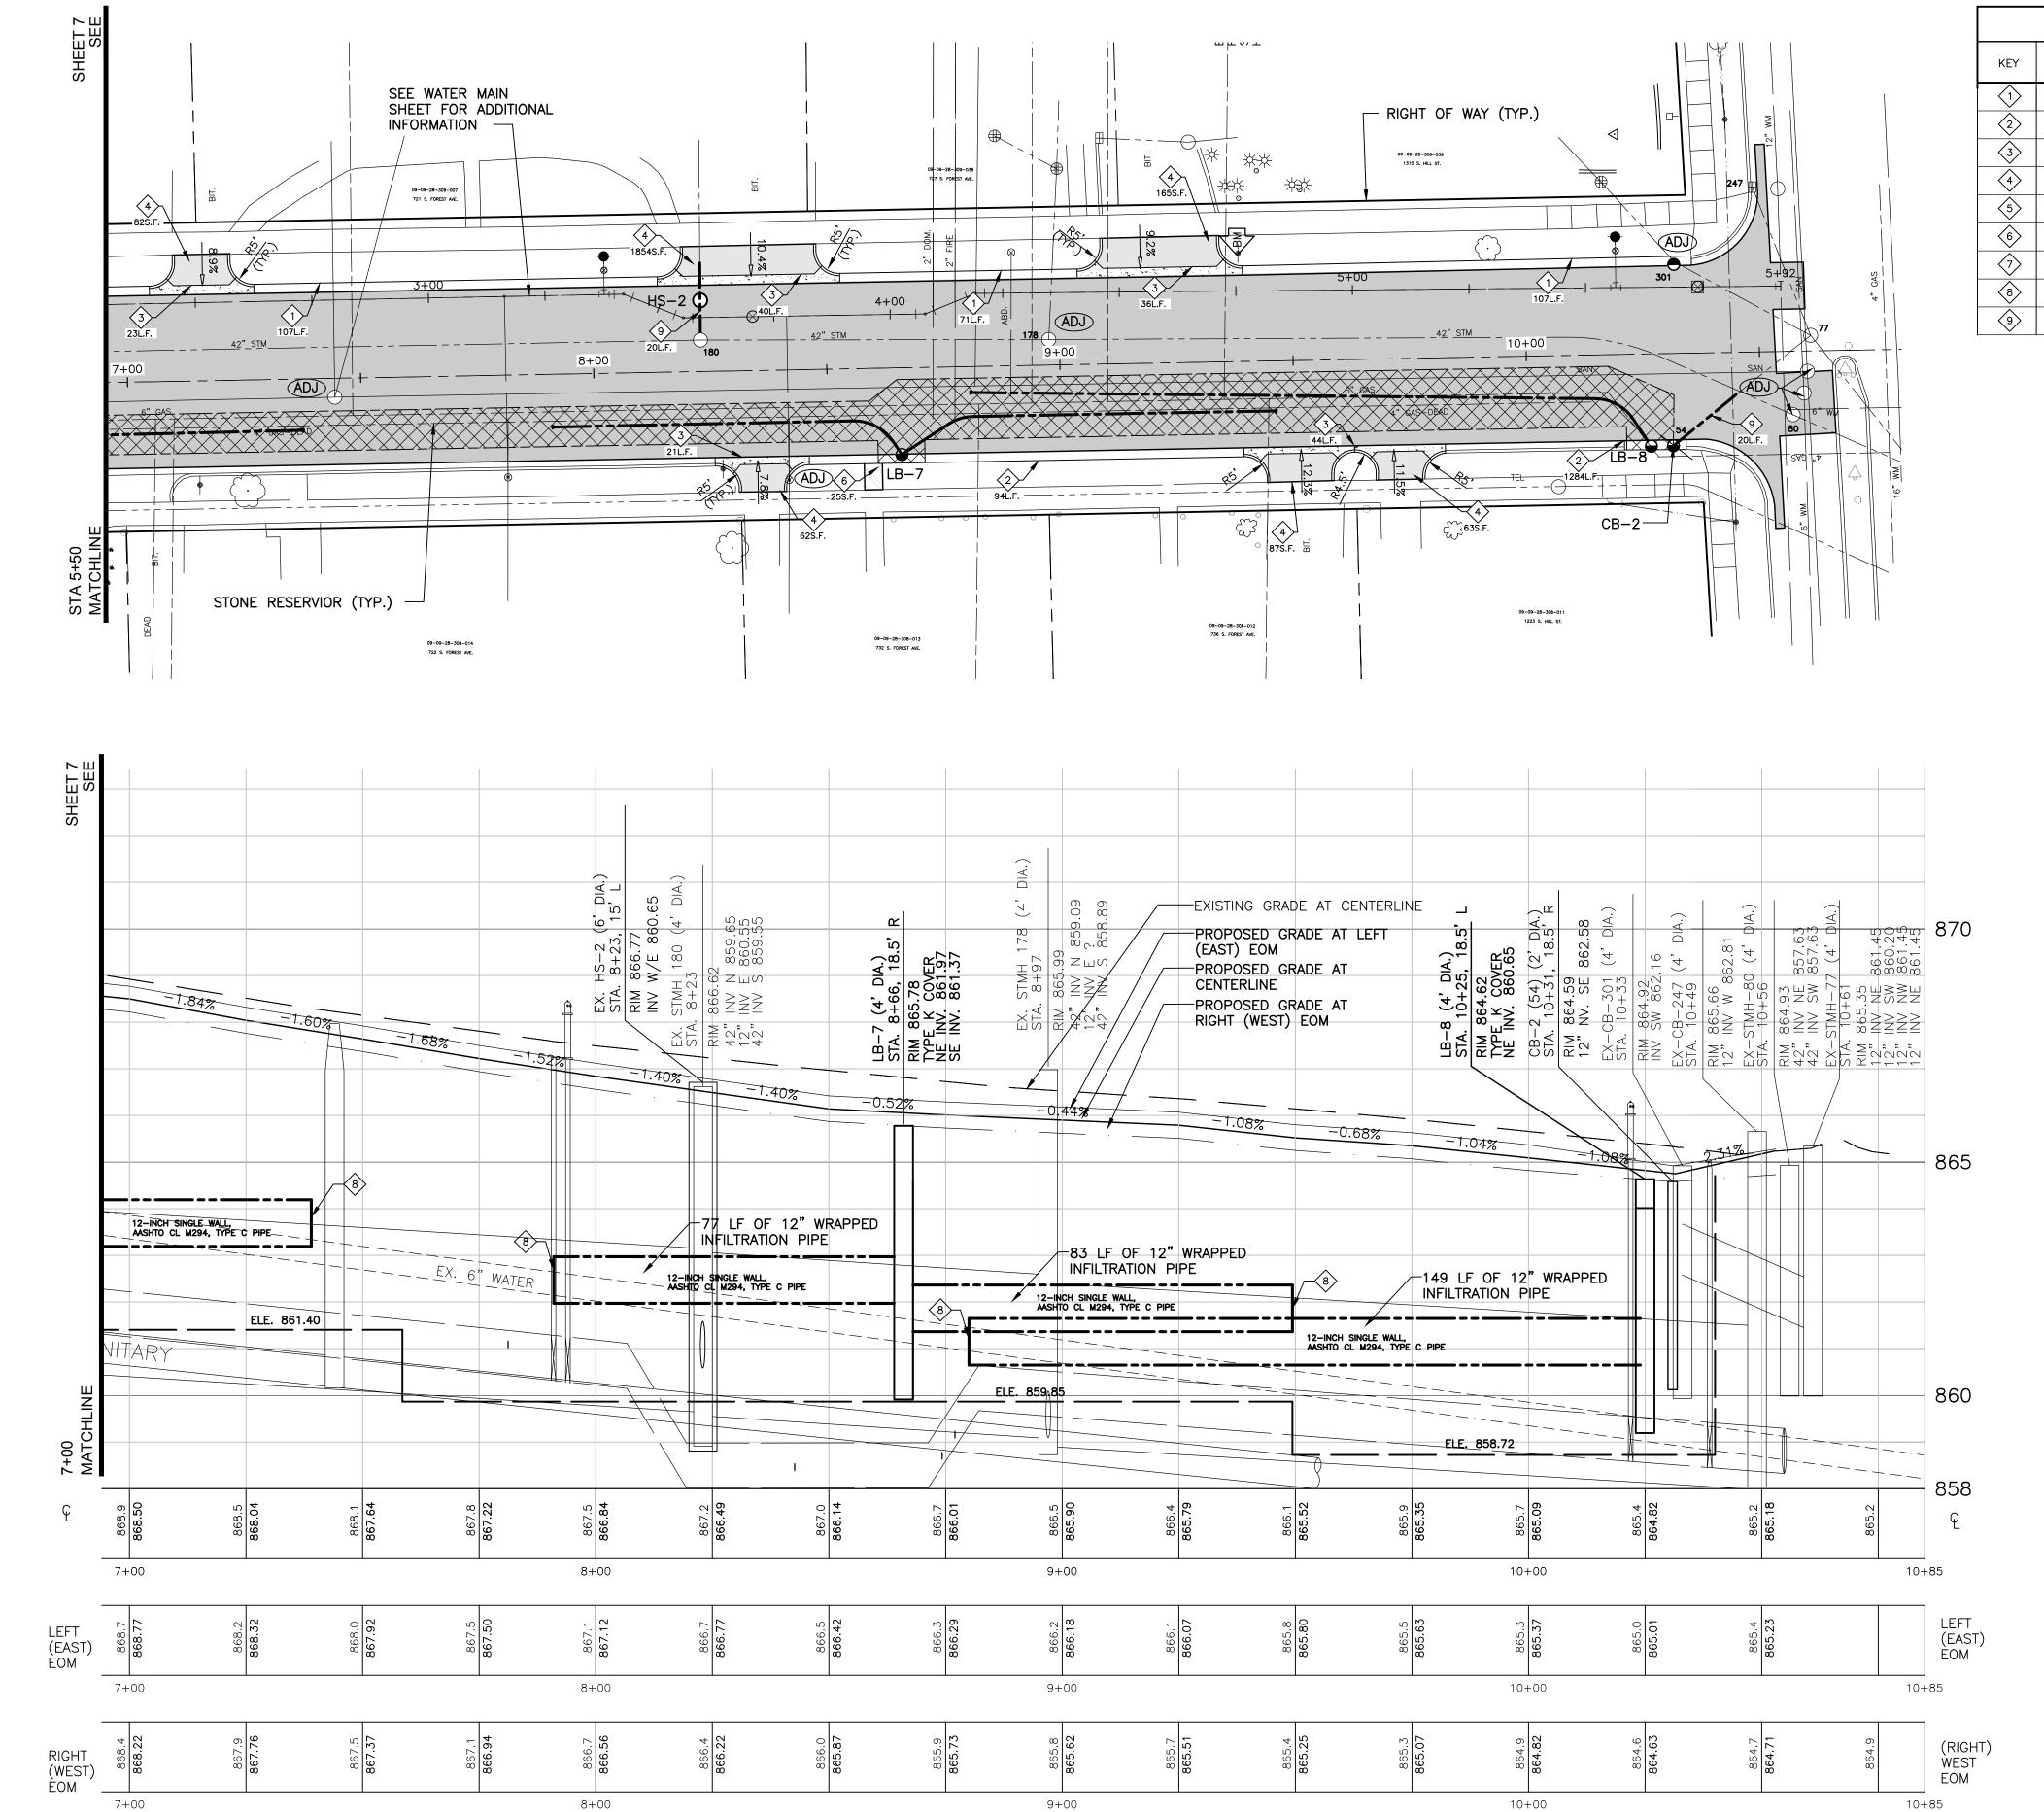

| | CONSTRUCTION KEY | | | | |
|-----|---|-----------------------------|--|--|--|
| KEY | PAY ITEM DESRIPTION | CITY OF ANN ARBOR DETAIL | | | |
| 1> | SPILL—OUT BARRIER CURB AND GUTTER (PAID AS CONCRETE CURB OR CURB & GUTTER — ANY TYPE) | SD-R-3 | | | |
| 2 | BARRIER CURB AND GUTTER (PAID AS CONCRETE CURB OR CURB & GUTTER — ANY TYPE) | SD-R-1 | | | |
| 3 | 'M' OPENING (PAID AS CONCRETE CURB OR CURB & GUTTER — ANY TYPE) | SD-R-6 | | | |
| 4 | 6-INCH DRIVE APPROACH (PAID AS 4 OR 6-INCH SIDEWALK, RAMP, OR DRIVE) | SD-R-6 | | | |
| 5 | 8-INCH DRIVE APPROACH (PAID AS 4 OR 6-INCH SIDEWALK, RAMP, OR DRIVE) | SD-R-6 | | | |
| 6 | 4 OR 6-INCH SIDEWALK, RAMP, OR DRIVE | MDOT R-28-F SD-SW | | | |
| 7> | REMOVE AND REPLACE BRICK PAVERS, ANY TYPE | | | | |
| 8 | SPLIT END CAP | | | | |
| 9 | RCP CL V, 12-INCH, TRENCH DETAIL I | SD-TD-1 | | | |


| LEGEND | | | | |
|--------|--|--|--|--|
| | PROPOSED STANDARD PAVEMENT SECTION (SEE SHEET 2 FOR LIST OF PAY ITEMS AND THICKNESSES) | | | |
| | 6-INCH DRIVE APPROACH (PAID FOR AS 4 OR 6-INCH SIDEWALK, RAMP OR DRIVE) | | | |
| | PROPOSED 'M' DRIVE APPROACH PER SD-R-6 (PAID FOR AS | | | |
| | 8—INCH DRIVE APPROACH (PAID FOR AS 8—INCH SIDEWALK, RAMP OR DRIVE) | | | |
| | PROPOSED SIDEWALK. (PAID FOR AS 4 OR 6-INCH SIDEWALK, RAMP OR DRIVE) STONE RESERVOIR (CYD) | | | |
| ADJ | REMOVE, REPLACE AND ADJUST COVER/RIM/CASTING PER ENGINEER (PAID AS EITHER "ADJUST STRUCTURE COVER" OR "ADJUST MONUMENT BOX OR GATE VALVE AND BOX") | | | |


| EXI | STING S | STORM SE | EWER | STRUCTURE T | ABLE |
|---------------------|-----------------|---------------------------|------|--|-------------------------|
| STRUCTURE NUMBER | ROAD STATION | PROPOSED RIM ELEVATION | TYPE | INVERTS | ADJUSTMENTS |
| 180 | 8+23 | 866.62 | STMH | 42" N = 859.65 12" E = 860.55 42" S = 859.55 | ADJUST STRUCTU COVER |
| 178 | 8+97 | 865.99 | STMH | 42" N = 859.09 12" E = ? 42" S = 858.89 | ADJUST STRUCTU COVER |
| 301 | 10+32 | 864.92 | СВ | 12" SW = 862.16 | ADJUST STRUCTU COVER |
| 54 | 10+31 | 864.59 | СВ | 12" SE = 862.58 | REMOVE CB (SEE CB-2) |
| 247 | 10+49 | 865.66 | СВ | 12" W = 862.81 | PROTECT STRUCTU |
| 77 | 10+61 | 865.35 | STMH | 12" NE = 861.45 12" SW = 860.20 12" NW = 861.45 12" NE = 861.45 | N/A |
| 80 | 10+56 | 864.93 | STMH | 42" NE = 857.63 42" SW = 857.63 | ADJUST STRUCTU COVER |

| PROPOSED STORM SEWER STRUCTURE TABLE | | | | | |
|--------------------------------------|-----------------|---------------------------|--------------------------------------|--|--|
| STRUCTURE NUMBER | ROAD STATION | PROPOSED RIM ELEVATION | STRUCTURE TYPE AND COVER | INVERTS | |
| LB-7 | 8+66 | 865.78 | LEACHING BASIN-48" DIA W/ COVER K | NE INV. = 861.97 SE INV. = 861.37 | |
| LB-8 | 10+25 | 864.62 | LEACHING BASIN-48" DIA W/ COVER K | NE INV. = 860.65 | |
| CB-2 | 10+31 | 864.59 | SINGLE INLET W/ COVER K | 12" W INV. = 862.58 | |
| HS-2 | 8+23 | 866.77 | HYDRO SEPARATOR | E 12" INV. = 860.65 W 12" INV. = 860.65 | |

PROJECT MANAGEMENT - PUBLIC SERVICES - CITY OF ANN ARBOR

SCALE PLAN: 1" = 20 PROFILE: 1" =

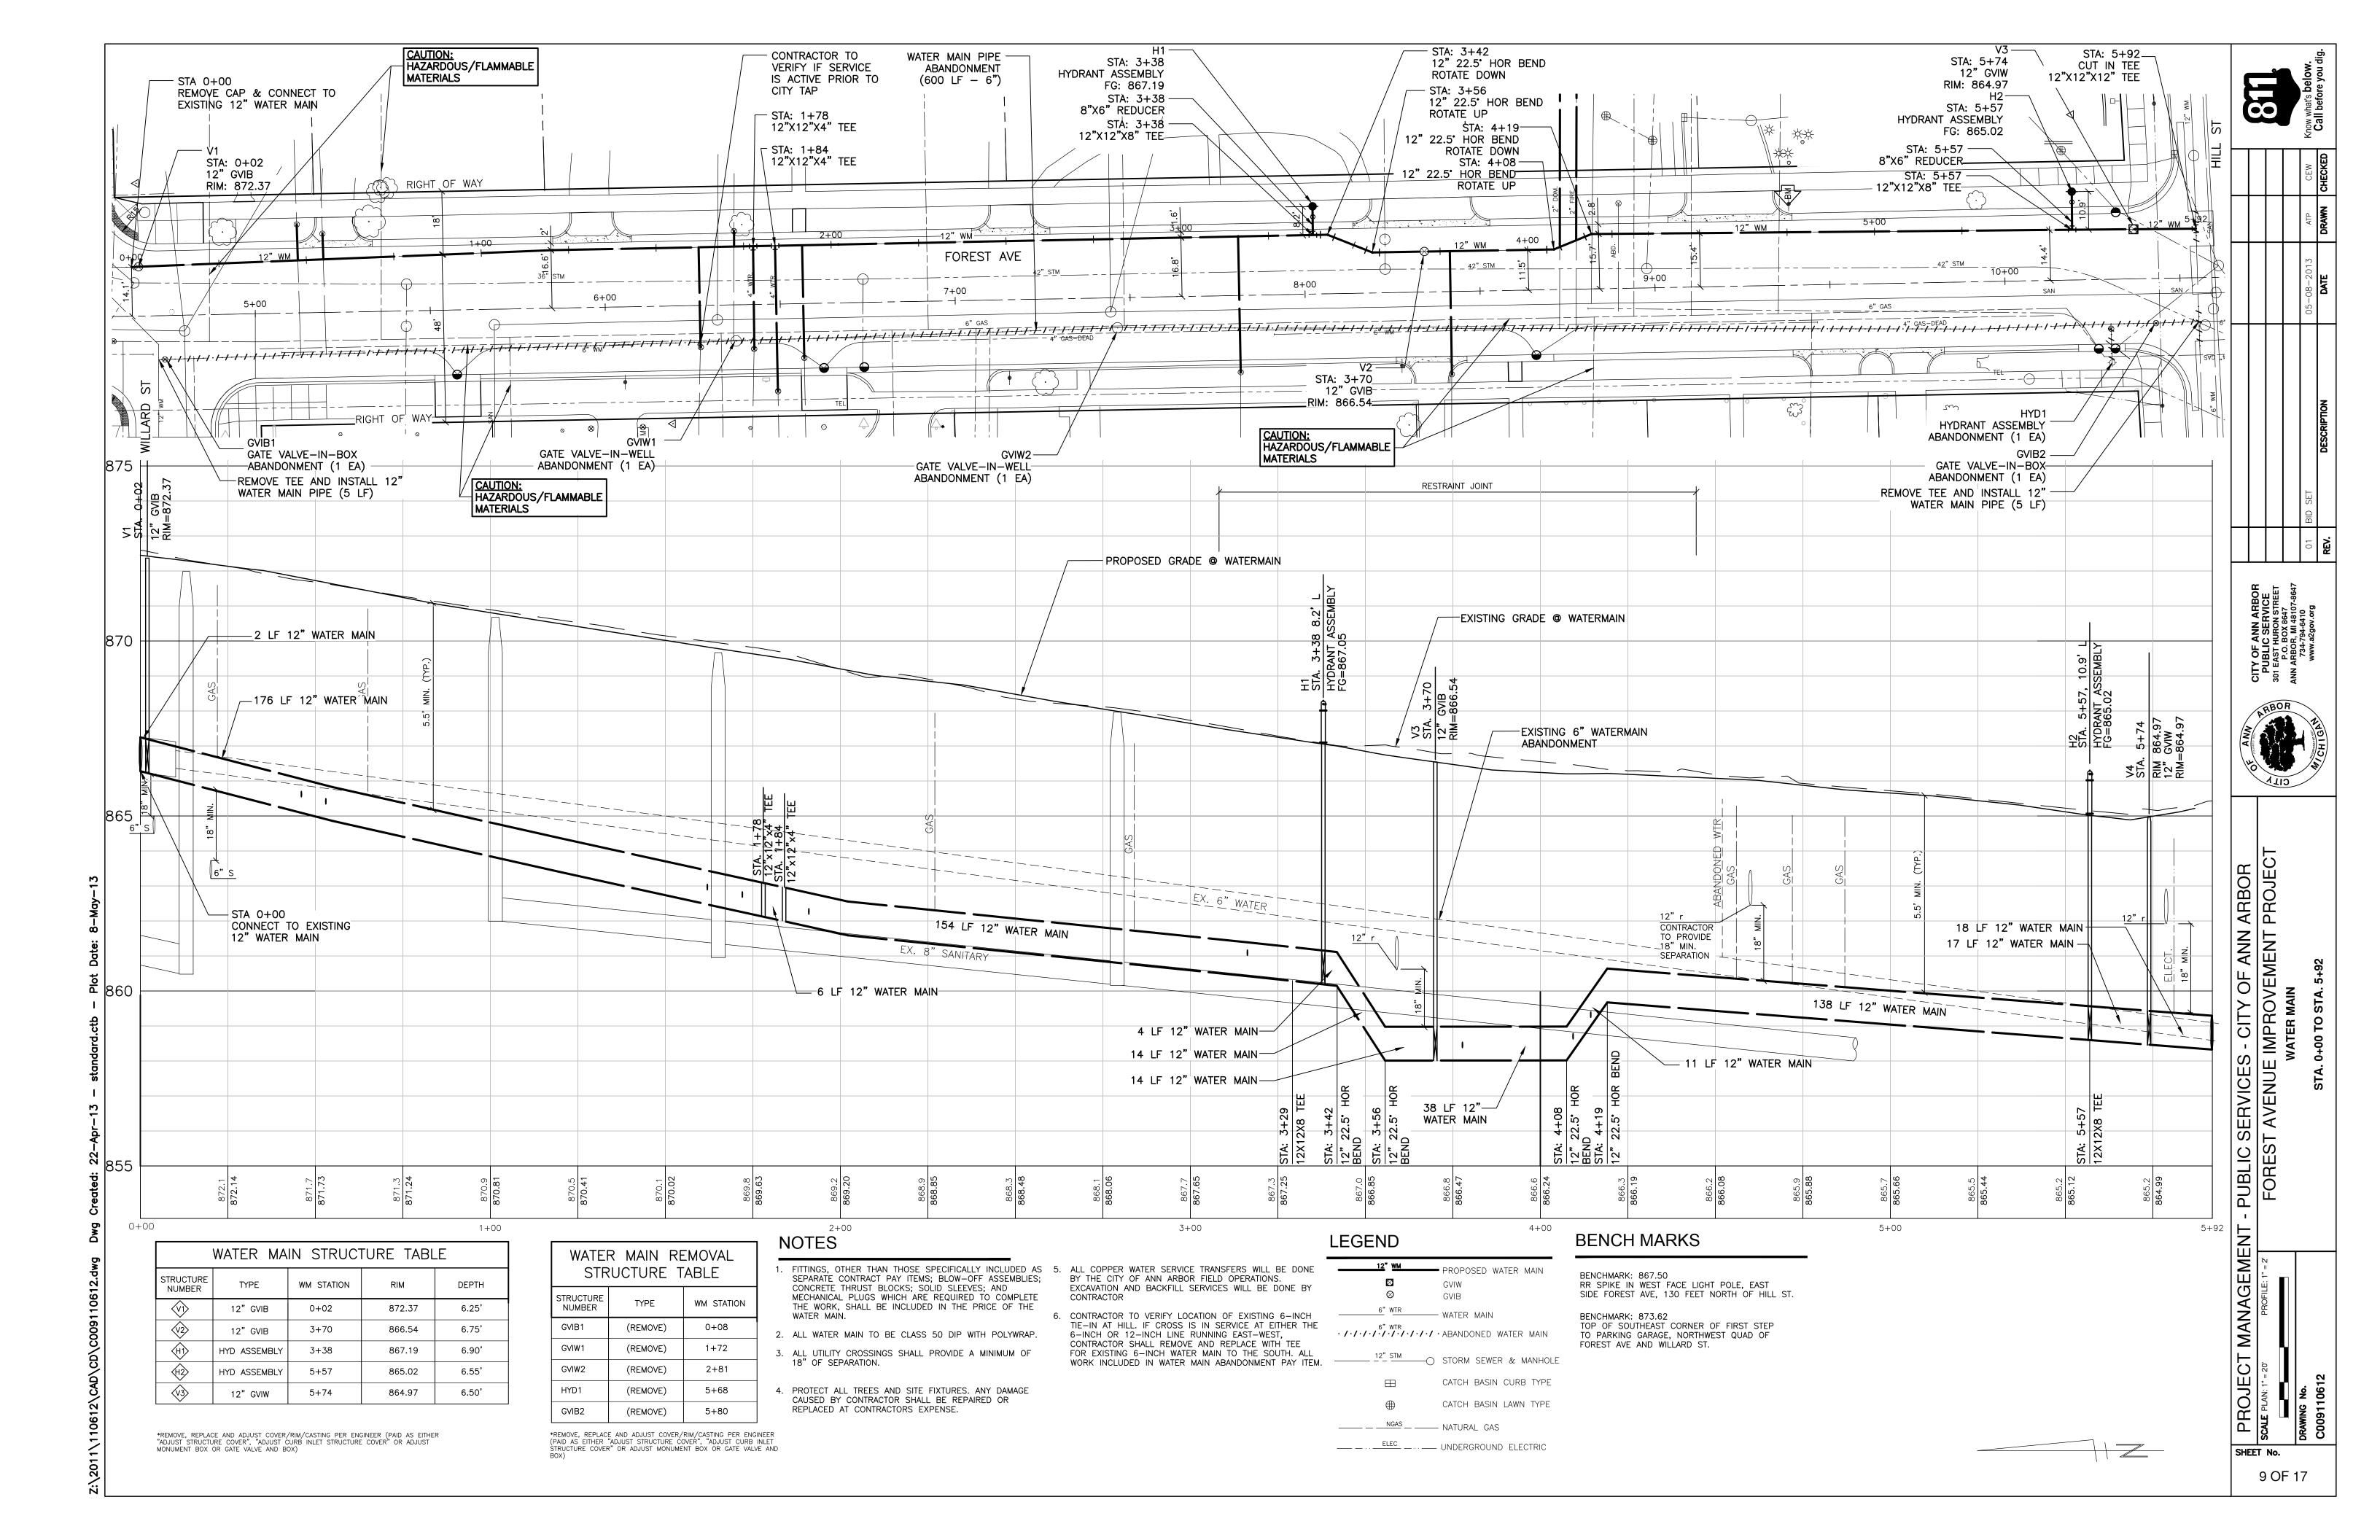

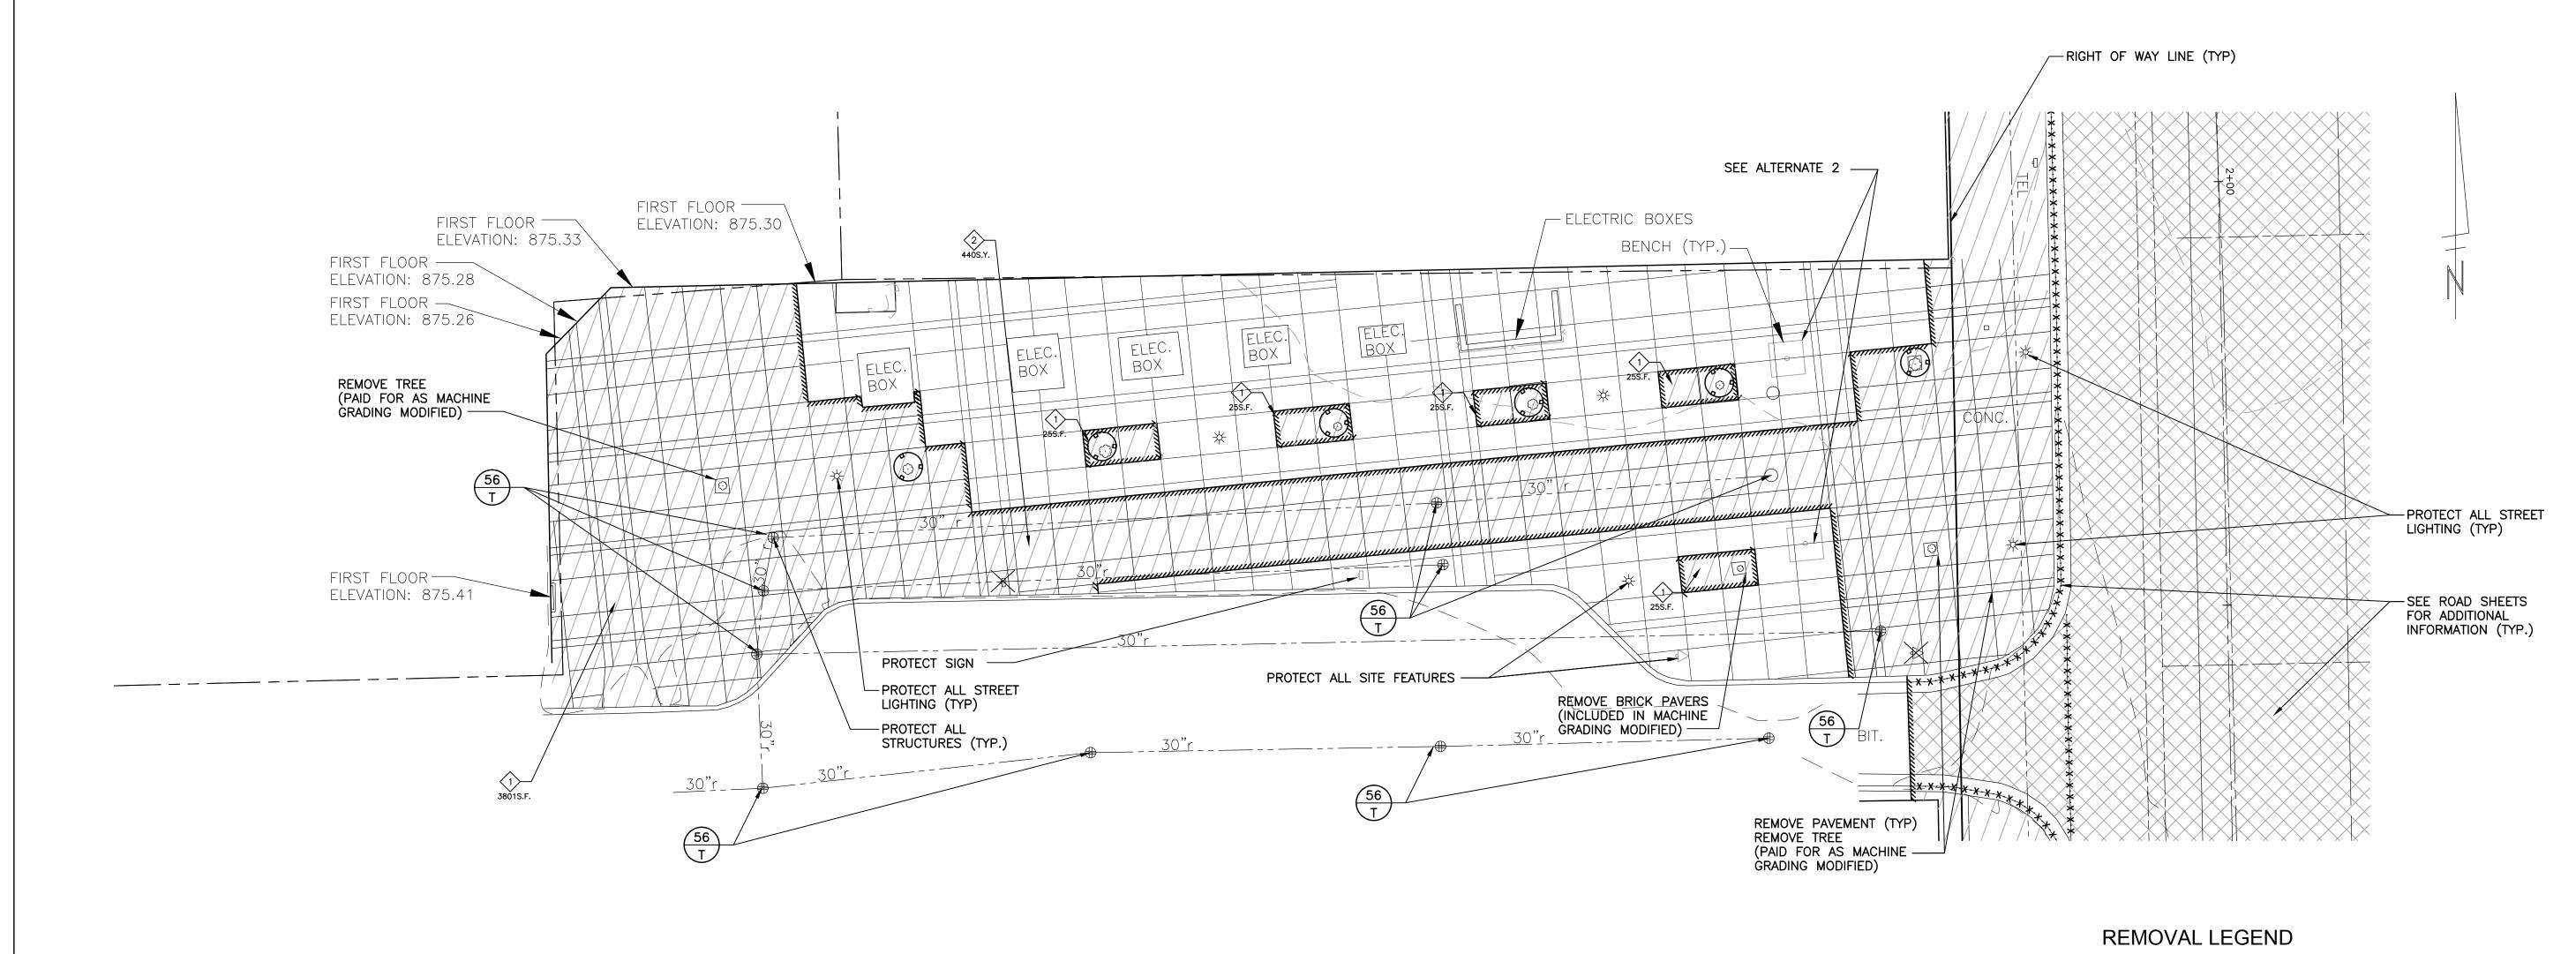

| | REMOVAL KEY |
|-----|--|
| KEY | PAY ITEM DESRIPTION |
| 1> | REMOVE CONCRETE SIDEWALK AND DRIVEWAYS — ANY THICKNESS |

NOTES

- ANY REMOVAL BEYOND THE LIMITS SHOWN WILL BE AT CONTRACTOR'S EXPENSE TO REMOVE/REPLACE IN KIND.
- 2. PROTECT TREES, SHRUBS AND LANDSCAPING FROM ALL DAMAGE DURING CONSTRUCTION
- 3. SIDEWALK AND DRIVEWAY REMOVAL LIMITS SHOWN ARE AN ESTIMATE. SAWCUT AT NEAREST CONSTRUCTION JOINT FROM WHAT IS INDICATED ON PLANS.
- 4. EXTREME CARE SHALL BE TAKEN TO AVOID DAMAGE TO EXISTING UTILITIES THAT CROSS OR ARE OTHERWISE EXPOSED IN THE EXCAVATIONS FOR THE PROJECT. HAND EXCAVATE IN THE VICINITY OF THE INDICATED UTILITIES TO EXPOSE THE EXACT LOCATIONS PRIOR TO BEGINNING MASS EXCAVATION. ANY INADVERTENT DAMAGE TO THE EXISTING UTILITIES SHALL BE CORRECTED AT THE CONTRACTOR'S EXPENSE AND IN ACCORDANCE WITH THE UTILITY AND OWNER'S REQUIREMENTS.
- 5. SEE TRANSFORMER PARK CONSTRUCTION SHEET FOR ALTERNATE INFORMATION.

MDEQ SOIL EROSION AND SEDIMENTATION CONTROL MEASURES

| | KEY | DETAIL | CHARACTERISTICS |
|-----|-----|-------------------------|--|
| R'S | 56 | Catch Basin, Filter Bag | Manufactured filter bag inserted under casting. Collects sediment at catch basin inlet. Paid for as part of General Conditions |

XX TEMPORARY T MEASURE



CONCRETE SIDEWALK REMOVAL (PAID FOR AS REMOVE CONCRETE SIDEWALK AND DRIVEWAYS — ANY THICKNESS)

COMPLETE PAVEMENT REMOVAL
(PAID FOR AS MACHINE GRADING MODIFIED)
SEE ROAD SHEETS.

SAWCUT.
(PAID FOR AS MACHINE GRADING MODIFIED)

• X • X • X • X • X • REMOVE CONCRETE CURB OR CURB AND AND GUTTER—ANY TYPE

REMOVE, SALVAGE, AND REINSTALL SIGN, POST, AND BASE (PAID FOR AS PART OF MINOR TRAFFIC CONTROL DEVICES)

REMOVE, SALVAGE AND REINSTALL EXISTING PARKING METERS (SEE NOTE 4)

TREE PROTECTION
(PAID FOR AS PROTECTIVE FENCING)

BENCH MARKS


BENCHMARK: 867.50 RR SPIKE IN WEST FACE LIGHT POLE, EAST SIDE FOREST AVE, 130 FEET NORTH OF HILL ST.

BENCHMARK: 873.62
TOP OF SOUTHEAST CORNER OF FIRST STEP
TO PARKING GARAGE, NORTHWEST QUAD OF
FOREST AVE AND WILLARD ST.

CEW Know what's below.

Call before you dig.

CITY OF ANN ARBOR
PUBLIC SERVICE
301 EAST HURON STREET
P.O. BOX 8647
ANN ARBOR, MI 48107-8647
734-794-6410
www.a2gov.org

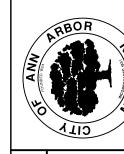


C SERVICES - CITY OF ANN ARBOR
ST AVENUE IMPROVEMENT PROJECT
TRANSFORMER PARK
REMOVAL AND SESC PLAN

ALE PLAN: 1" = 20"


AMING No.

SHEET No.

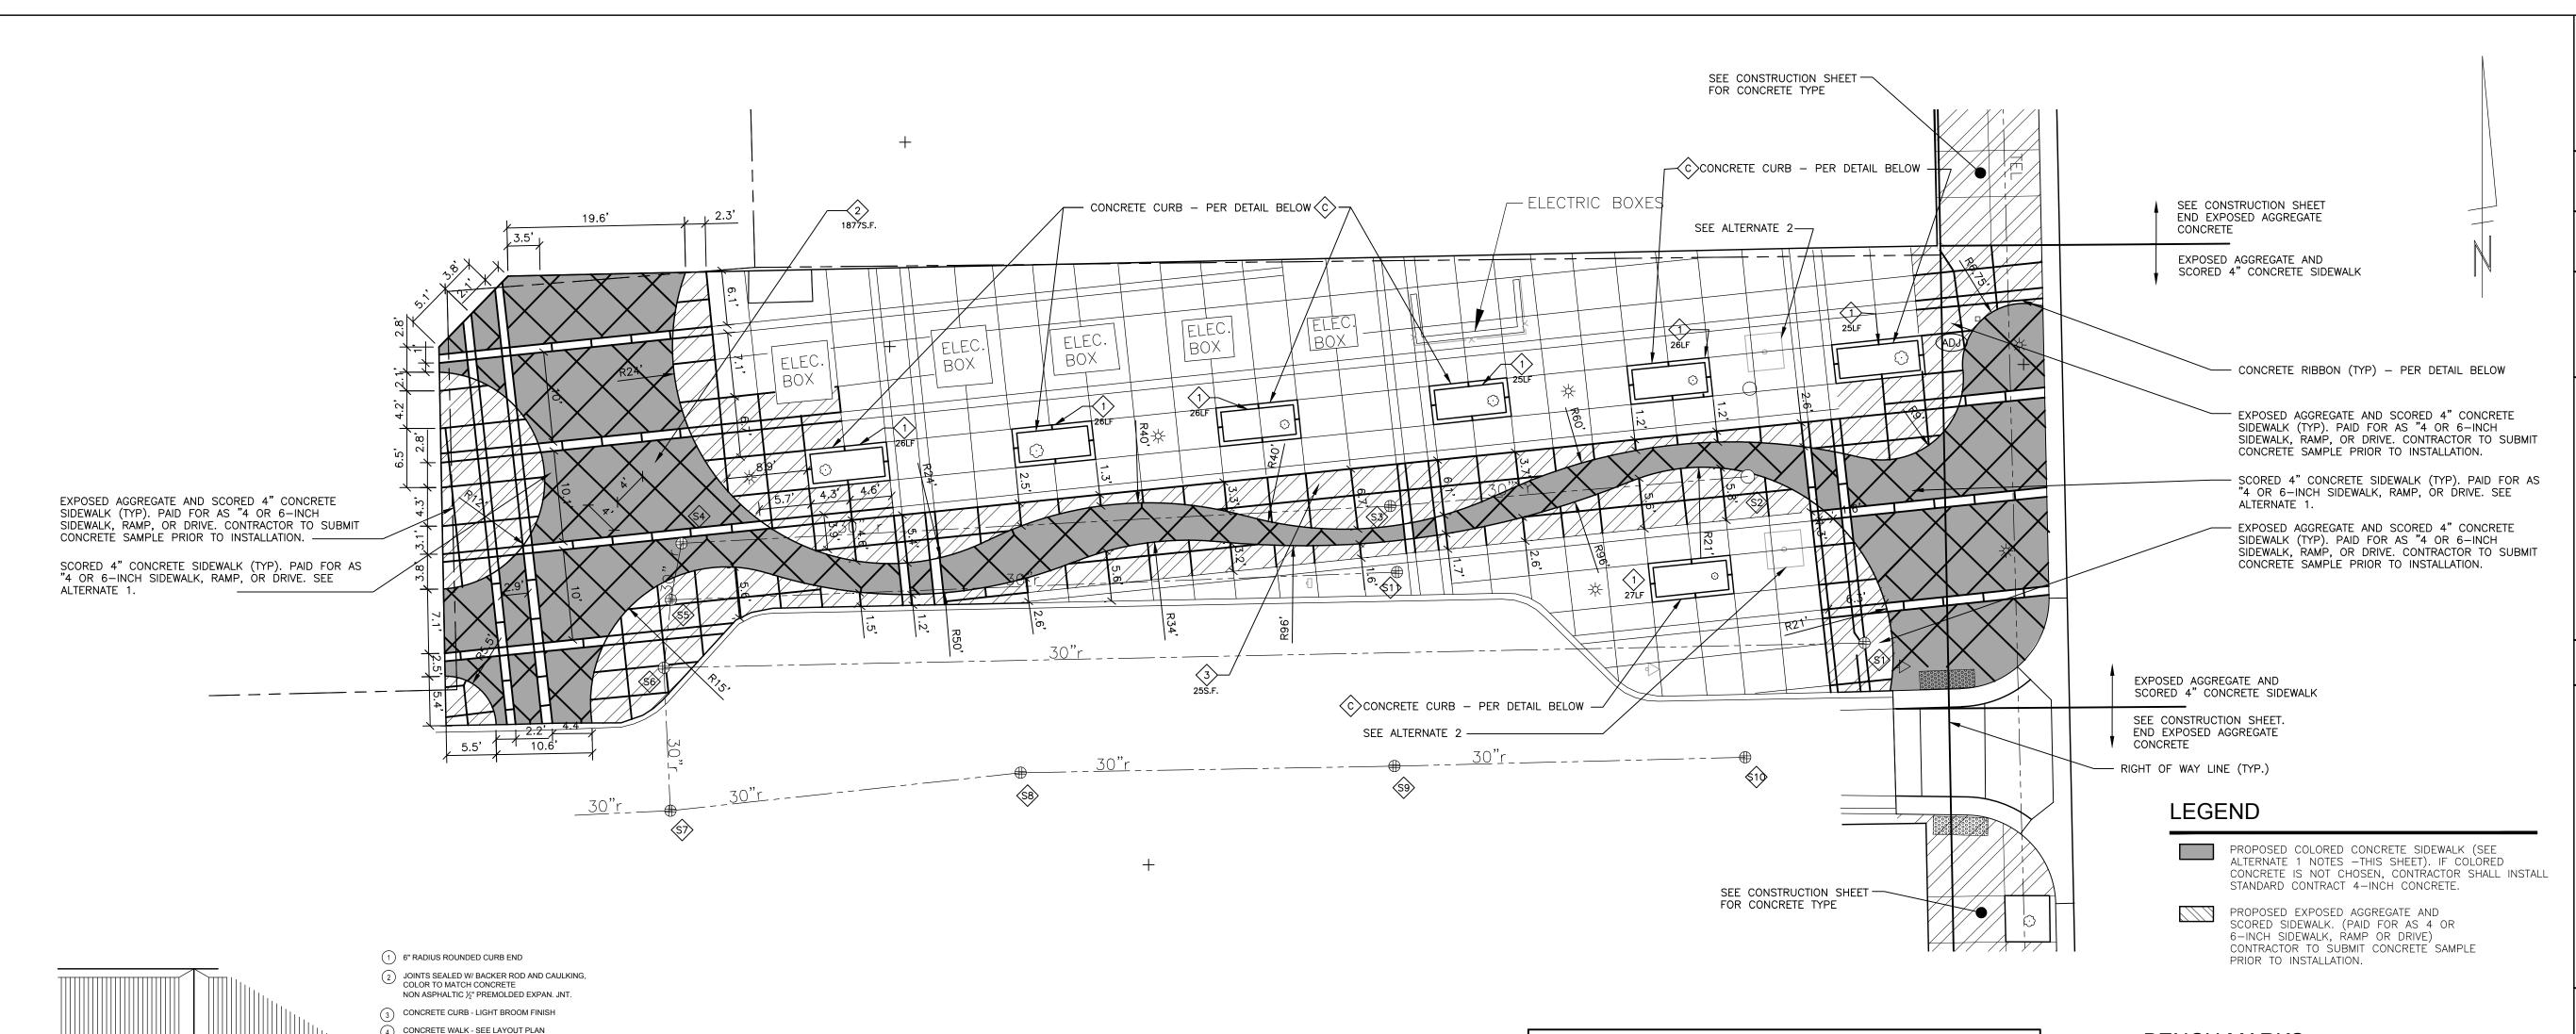

| 3 | NOTE: ALL WORK CONSIDERED INCIDENTAL TO CONCRETE SIDEWALK OR CURB PAY ITEMS. |
|---|--|

CONCRETE CURB EDGE END - ISOMETRIC VIEW © NOT TO SCALE

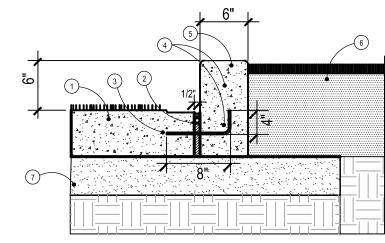

SIDEWALK W/ CURB SECTION ©

- 4-INCH SIDEWALK PAID FOR AS "4 OR 6-INCH SIDEWALK, RAMP, OR DRIVE" (SF).
- 2 JOINTS SEALED W/ BACKER ROD AND CAULKING, COLOR TO MATCH CONCRETE
 NON ASPHALTIC ½" PREMOLDED EXPAN. JNT. INCIDENTAL TO CURB WORK.
- (3) 12" LONG #4 RE-BAR, 18" O.C. INCIDENTAL TO CURB WORK. INCIDENTAL TO CURB WORK.
- (4) #4 RE-BAR. INCIDENTAL TO CURB WORK.
- (5) CONCRETE CURB LIGHT BROOM FINISH. INCIDENTAL TO CURB WORK.
- (6) PLACE WOOD CHIPS, PAID FOR AS "CLEAN-UP & RESTORATION".
- 7) 4-INCH CLASS II SAND PAID FOR "SAND SUBBASE COURSE, CLASS II C.I.P.

| 12" 3 | |
|-------|--|
| | |

CONCRETE RIBBON SECTION

NOT TO SCALE
PAID FOR AS "4 OR 6-INCH SIDEWALK, RAMP, OR DRIVE" (SF).

- 4-INCH SIDEWALK PAID FOR AS "4 OR 6-INCH SIDEWALK, RAMP, OR DRIVE" (SF).

 2 #4 RE-BAR. INCIDENTAL TO 4 OR 6-INCH SIDEWALK,
- RAMP, OR DRIVE PAY ITEM.
- © CONCRETE CURB LIGHT BROOM FINISH. INCIDENTAL TO CURB WORK.
- 4-INCH CLASS II SAND PAID FOR "SAND SUBBASE COURSE, CLASS II C.I.P.
- (5) EXISTING OR PROPOSED SIDEWALK.
- 6 EXISTING GRADE

| | CONSTRUCTION KEY | | | |
|-----|--|-----------------------------|--|--|
| KEY | PAY ITEM DESRIPTION | CITY OF ANN ARBOR DETAIL | | |
| 1 | CONCRETE CURB OR CURB & GUTTER - ANY TYPE | THIS SHEET | | |
| 2 | 4 OR 6—INCH COLORED CONCRETE SIDEWALK, RAMP, OR DRIVE — PARK | SD-R-6 | | |
| 3 | 4 OR 6-INCH SIDEWALK, RAMP, OR DRIVE | SD-R-6 | | |

| STI | STRUCTURE TABLE | | | | |
|---------------------|---------------------------|--------------------------|--|--|--|
| STRUCTURE NUMBER | EXISTING RIM ELEVATION | ADJUSTMENT ELEVATION* | | | |
| <u>\$1</u> > | 875.70 | 875.70 | | | |
| \$2 | 875.88 | 875.88 | | | |
| \$3 | 875.66 | 875.66 | | | |
| \$4 | 874.99 | 874.90 | | | |
| \$ 5 | 874.88 | 874.87 | | | |
| \$6 | 874.91 | 874.91 | | | |
| \$7> | 874.21 | N/A | | | |
| \$8 | 874.65 | N/A | | | |
| \$9> | 874.74 | N/A | | | |
| \$10 | 874.73 | N/A | | | |
| \$1> | 875.48 | N/A | | | |

*REMOVE, REPLACE AND ADJUST COVER/RIM/CASTING PER ENGINEER (PAID AS EITHER "ADJUST STRUCTURE COVER", "ADJUST CURB INLET STRUCTURE COVER" OR ADJUST MONUMENT BOX OR GATE VALVE AND

BENCH MARKS

BENCHMARK: 867.50 RR SPIKE IN WEST FACE LIGHT POLE, EAST SIDE FOREST AVE, 130 FEET NORTH OF HILL ST.

BENCHMARK: 873.62 TOP OF SOUTHEAST CORNER OF FIRST STEP TO PARKING GARAGE, NORTHWEST QUAD OF FOREST AVE AND WILLARD ST.

NOTES

1. PROTECT ALL TREES AND SITE FIXTURES. ANY DAMAGE CAUSED BY CONTRACTOR SHALL BE REPAIRED OR REPLACED AT CONTRACTORS EXPENSE.

2. CONTRACTOR TO ENSURE POSITIVE DRAINAGE ON NORTH SIDE OF PLANTERS PRIOR TO RAISED CURB INSTALLATION. THE ENGINEER SHALL BE NOTIFIED OF ANY POTENTIAL AREAS WITH LOW POINTS OR INSUFFICIENT SLOPE IMMEDIATELY.


ALTERNATE 1

INSTALL COLORED CONCRETE PER PLAN AND AS DIRECTED BY ENGINEER. COLORED CONCRETE SAMPLE SHALL BE SUBMITTED TO CITY ENGINEER FOR APPROVAL PRIOR TO INSTALLATION. COLORED CONCRETE MATERIAL SHALL BE SCOFIELD CONCRETE COLORING, TEXTURING & PERFORMANCE (www.scofield.com/coloredconcrete_main.html) OR APPROVED EQUAL. ALL WORK TO BE PAID FOR AS "ALTERNATE 1: 4 OR 6-INCH COLORED CONCRETE SIDEWALK, RAMP, OR DRIVE."

ALTERNATE 2

REMOVE BENCHES AND ALL ASSOCIATED FOOTINGS AND HARDWARE. REMOVE CONCRETE SIDEWALK TO PERFORM WORK AS DIRECTED BY THE ENGINEER. REPLACE REMOVED CONCRETE WITH EXPOSED AGGREGATE CONCRETE TO MATCH EXISTING. CONTRACTOR TO PROVIDED SAMPLES OF EXPOSED AGGREGATE CONCRETE PRIOR TO CONCRETE INSTALLATION. ALL WORK TO BE PAID FOR AS "ALTERNATE 2: REMOVE BENCHES"

S SERVICES - CITY OF ANN A ST AVENUE IMPROVEMENT P TRANSFORMER PARK CONSTRUCTION PLAN SHEET No.

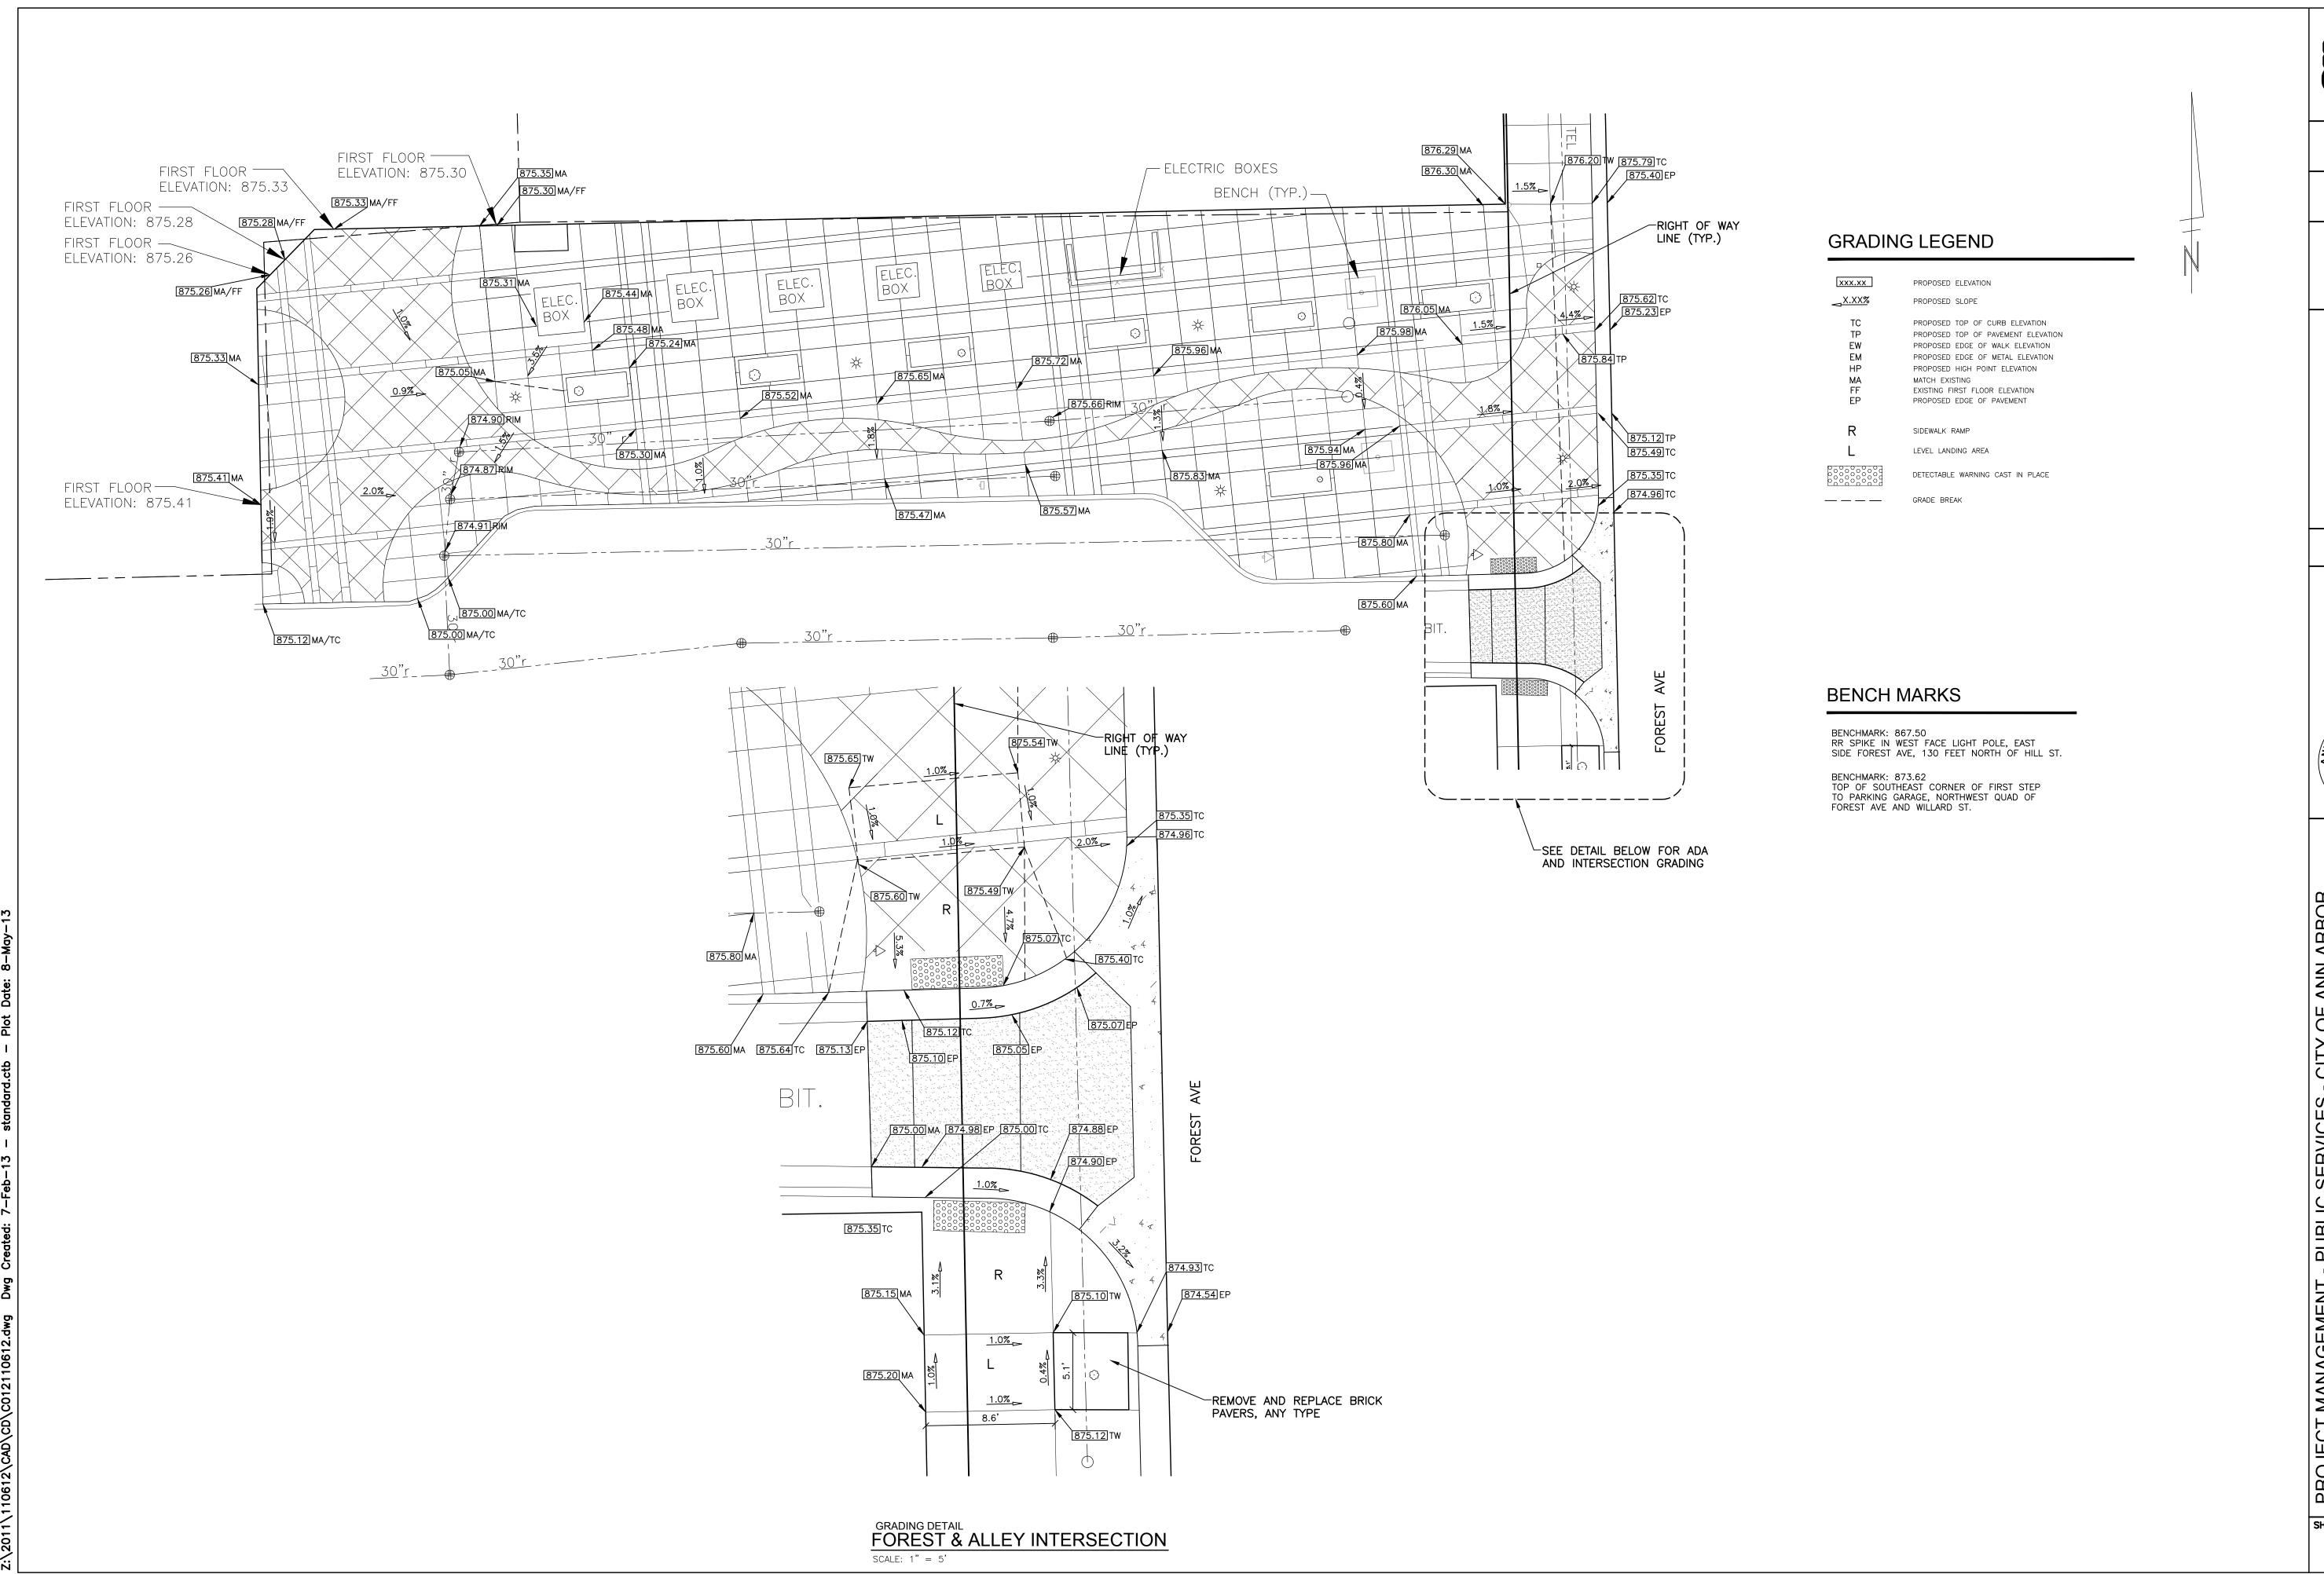

Know what's below.

| DRAWN CHECKED | DRAWN | DATE | DESCRIPTION |
|---------------|-------|------------|-------------|
| CEW | ATP | 05-08-2013 | BID SET |
| | | | |
| | | | |
| | | | |
| | | | |

CITY OF ANN ARBOR
PUBLIC SERVICE
301 EAST HURON STREET
P.O. BOX 8647
ANN ARBOR, MI 48107-8647
734-794-6410
www.a2gov.org



ROJECT E

AVENUE IMPROVEMENT PROTRANSFORMER PARK

FOREST AVENUE IM

PLAN: 1" = 20'

SHEET No.

GRADING LEGEND

xxx.xx

| <u> </u> | PROPOSED SLOPE |
|---|--|
| TC TP EW EM HP MA FF | PROPOSED TOP OF CURB ELEVATION PROPOSED TOP OF PAVEMENT ELEVATION PROPOSED EDGE OF WALK ELEVATION PROPOSED EDGE OF METAL ELEVATION PROPOSED HIGH POINT ELEVATION MATCH EXISTING EXISTING FIRST FLOOR ELEVATION PROPOSED EDGE OF PAVEMENT |
| Li | THO GOLD EDGE OF TAXEMENT |
| S | SIDEWALK |
| R | SIDEWALK RAMP |
| L | LEVEL LANDING AREA |
| 000000000000000000000000000000000000000 | DETECTABLE WARNING, CAST IN PLACE |

GRADE BREAK

PROPOSED ELEVATION

BENCH MARKS

BENCHMARK: 867.50 RR SPIKE IN WEST FACE LIGHT POLE, EAST SIDE FOREST AVE, 130 FEET NORTH OF HILL ST.

BENCHMARK: 873.62
TOP OF SOUTHEAST CORNER OF FIRST STEP
TO PARKING GARAGE, NORTHWEST QUAD OF
FOREST AVE AND WILLARD ST.

05-08-2013 ATP
TION DATE DRAWN

SERVICE
AND STREET
X 8647
4-6410
90v.org
REV. DESC

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PUBLIC SERVICE
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ANN ARBOR, MI 48107-8
734-794-6410
www.a2gov.org



E IMPROVEMENT PROJECT

EST AVENUE IMPRO

NAGEMENI - PUBL


PROJECT MANAGE


SCALE PLAN: 1" = 5'


DRAWING NO.

13 OF 18


INTERSECTION OF S. UNIVERSITY AND FOREST AVE SCALE: 1" = 5'

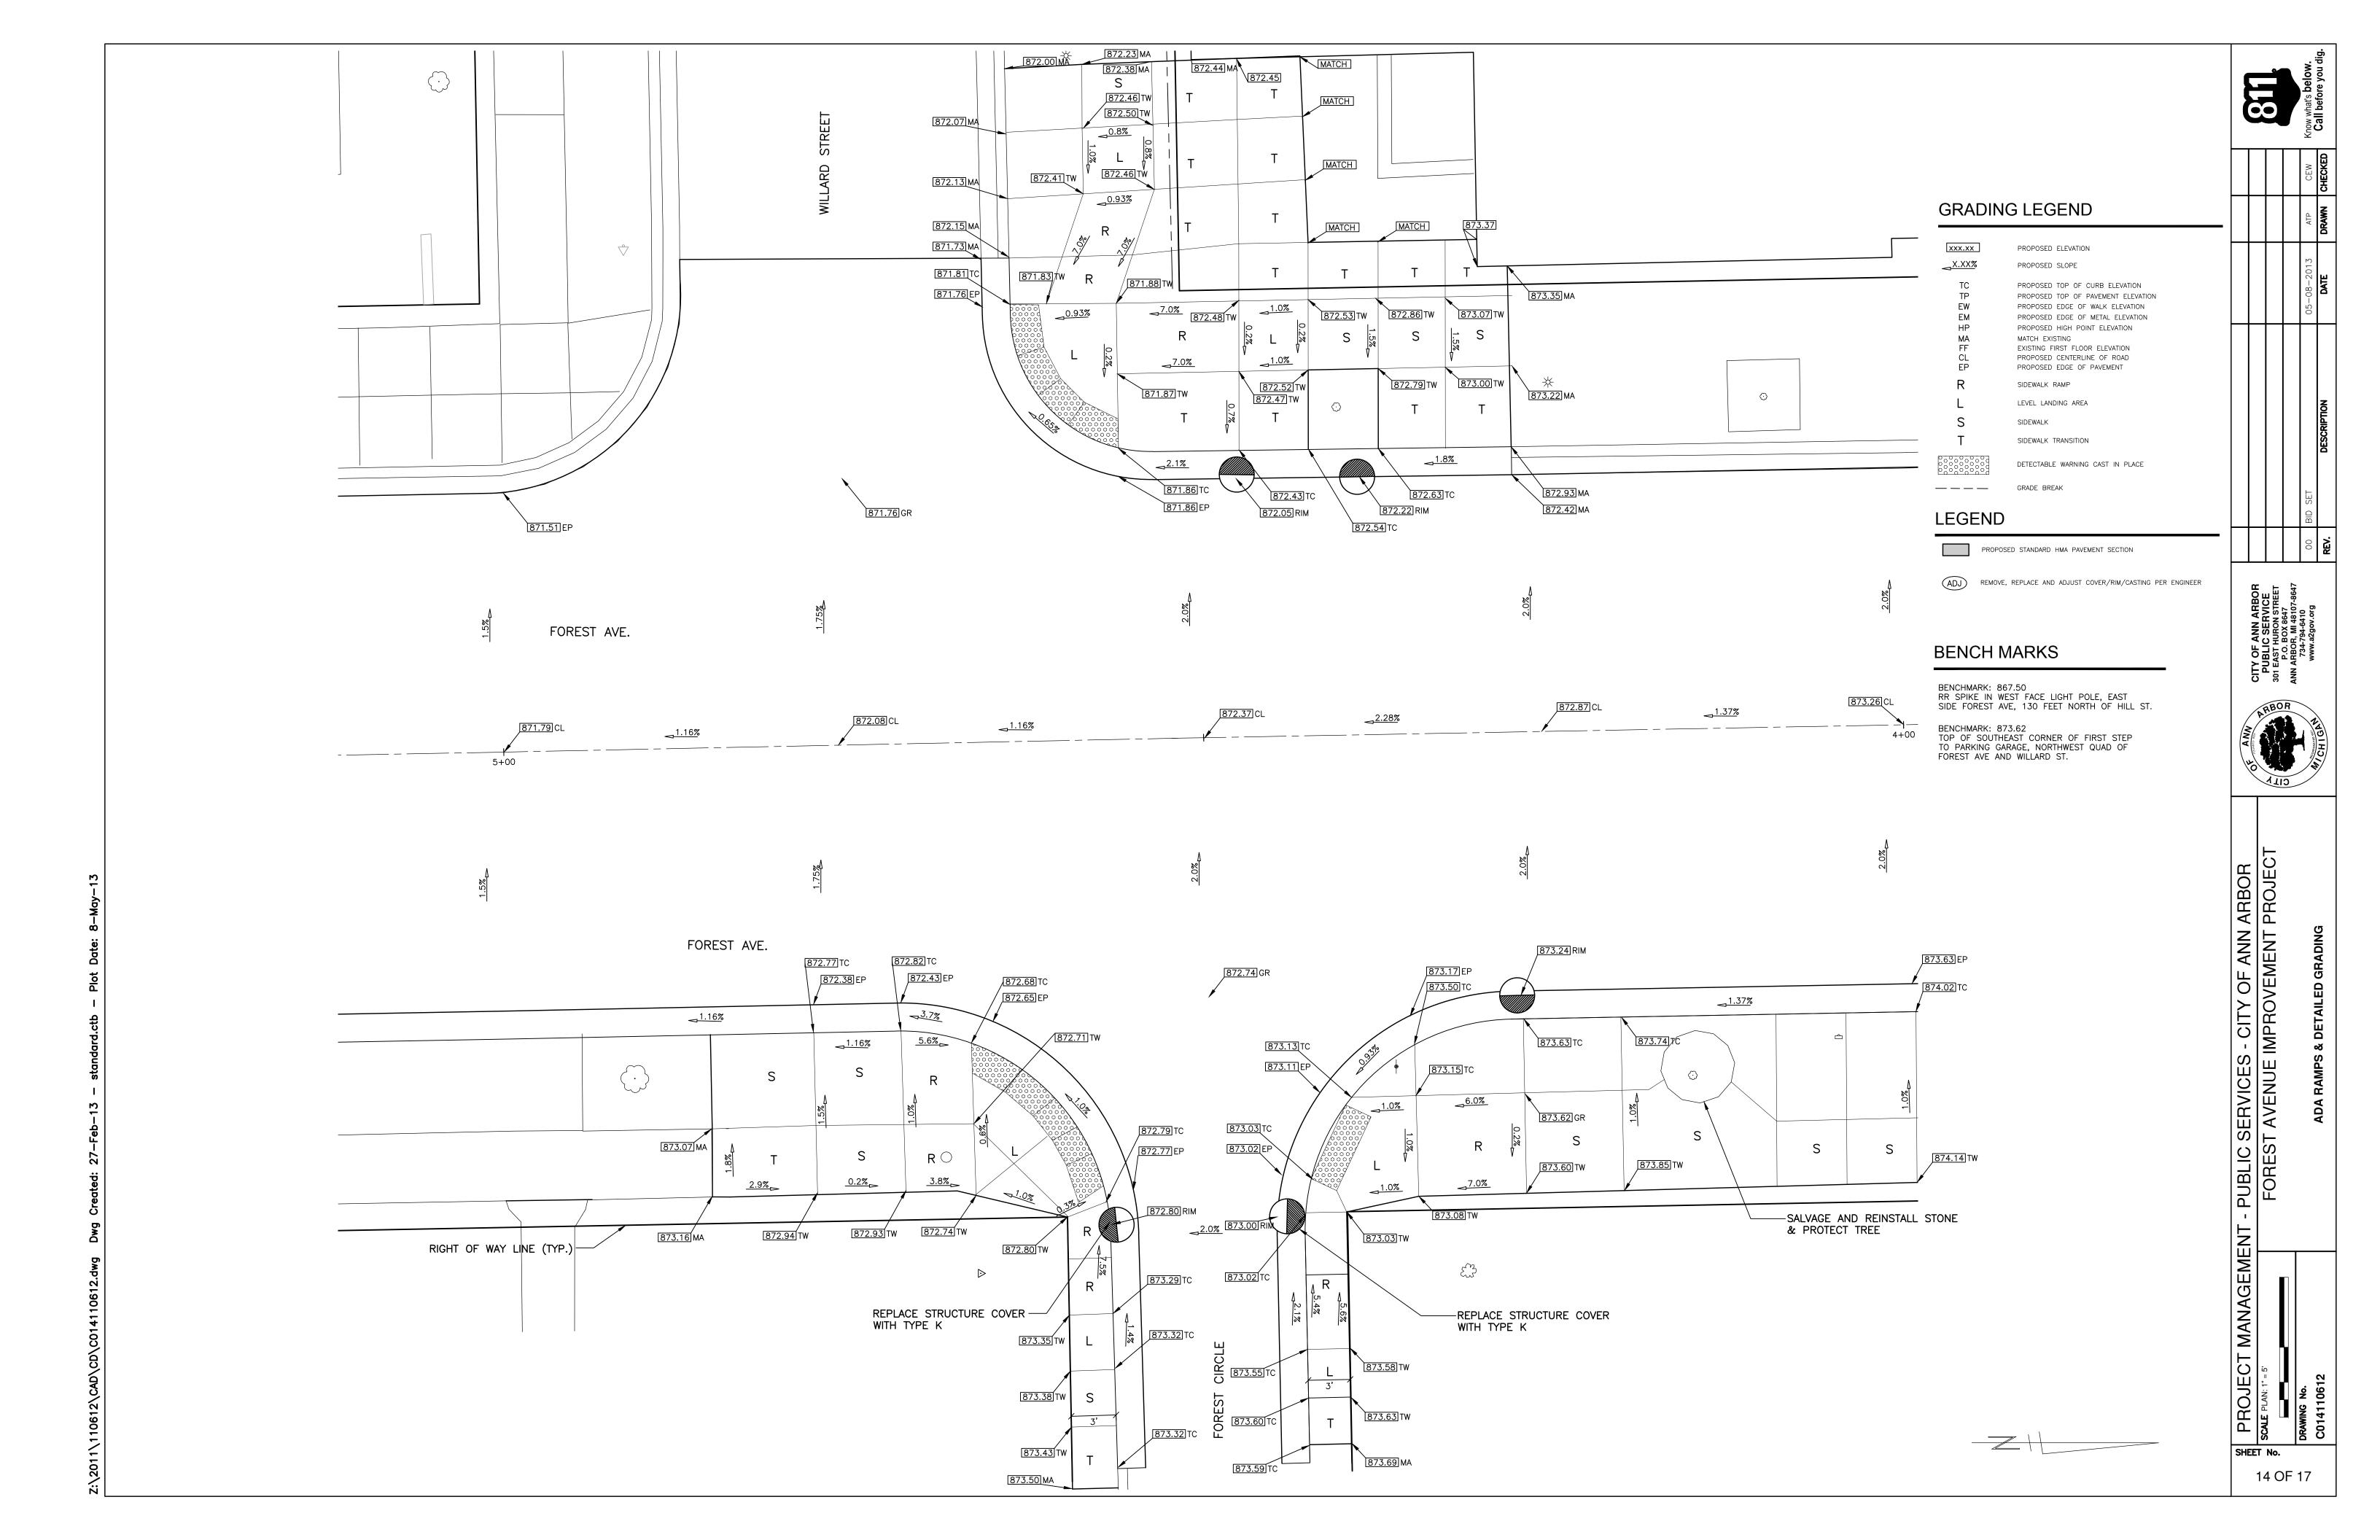

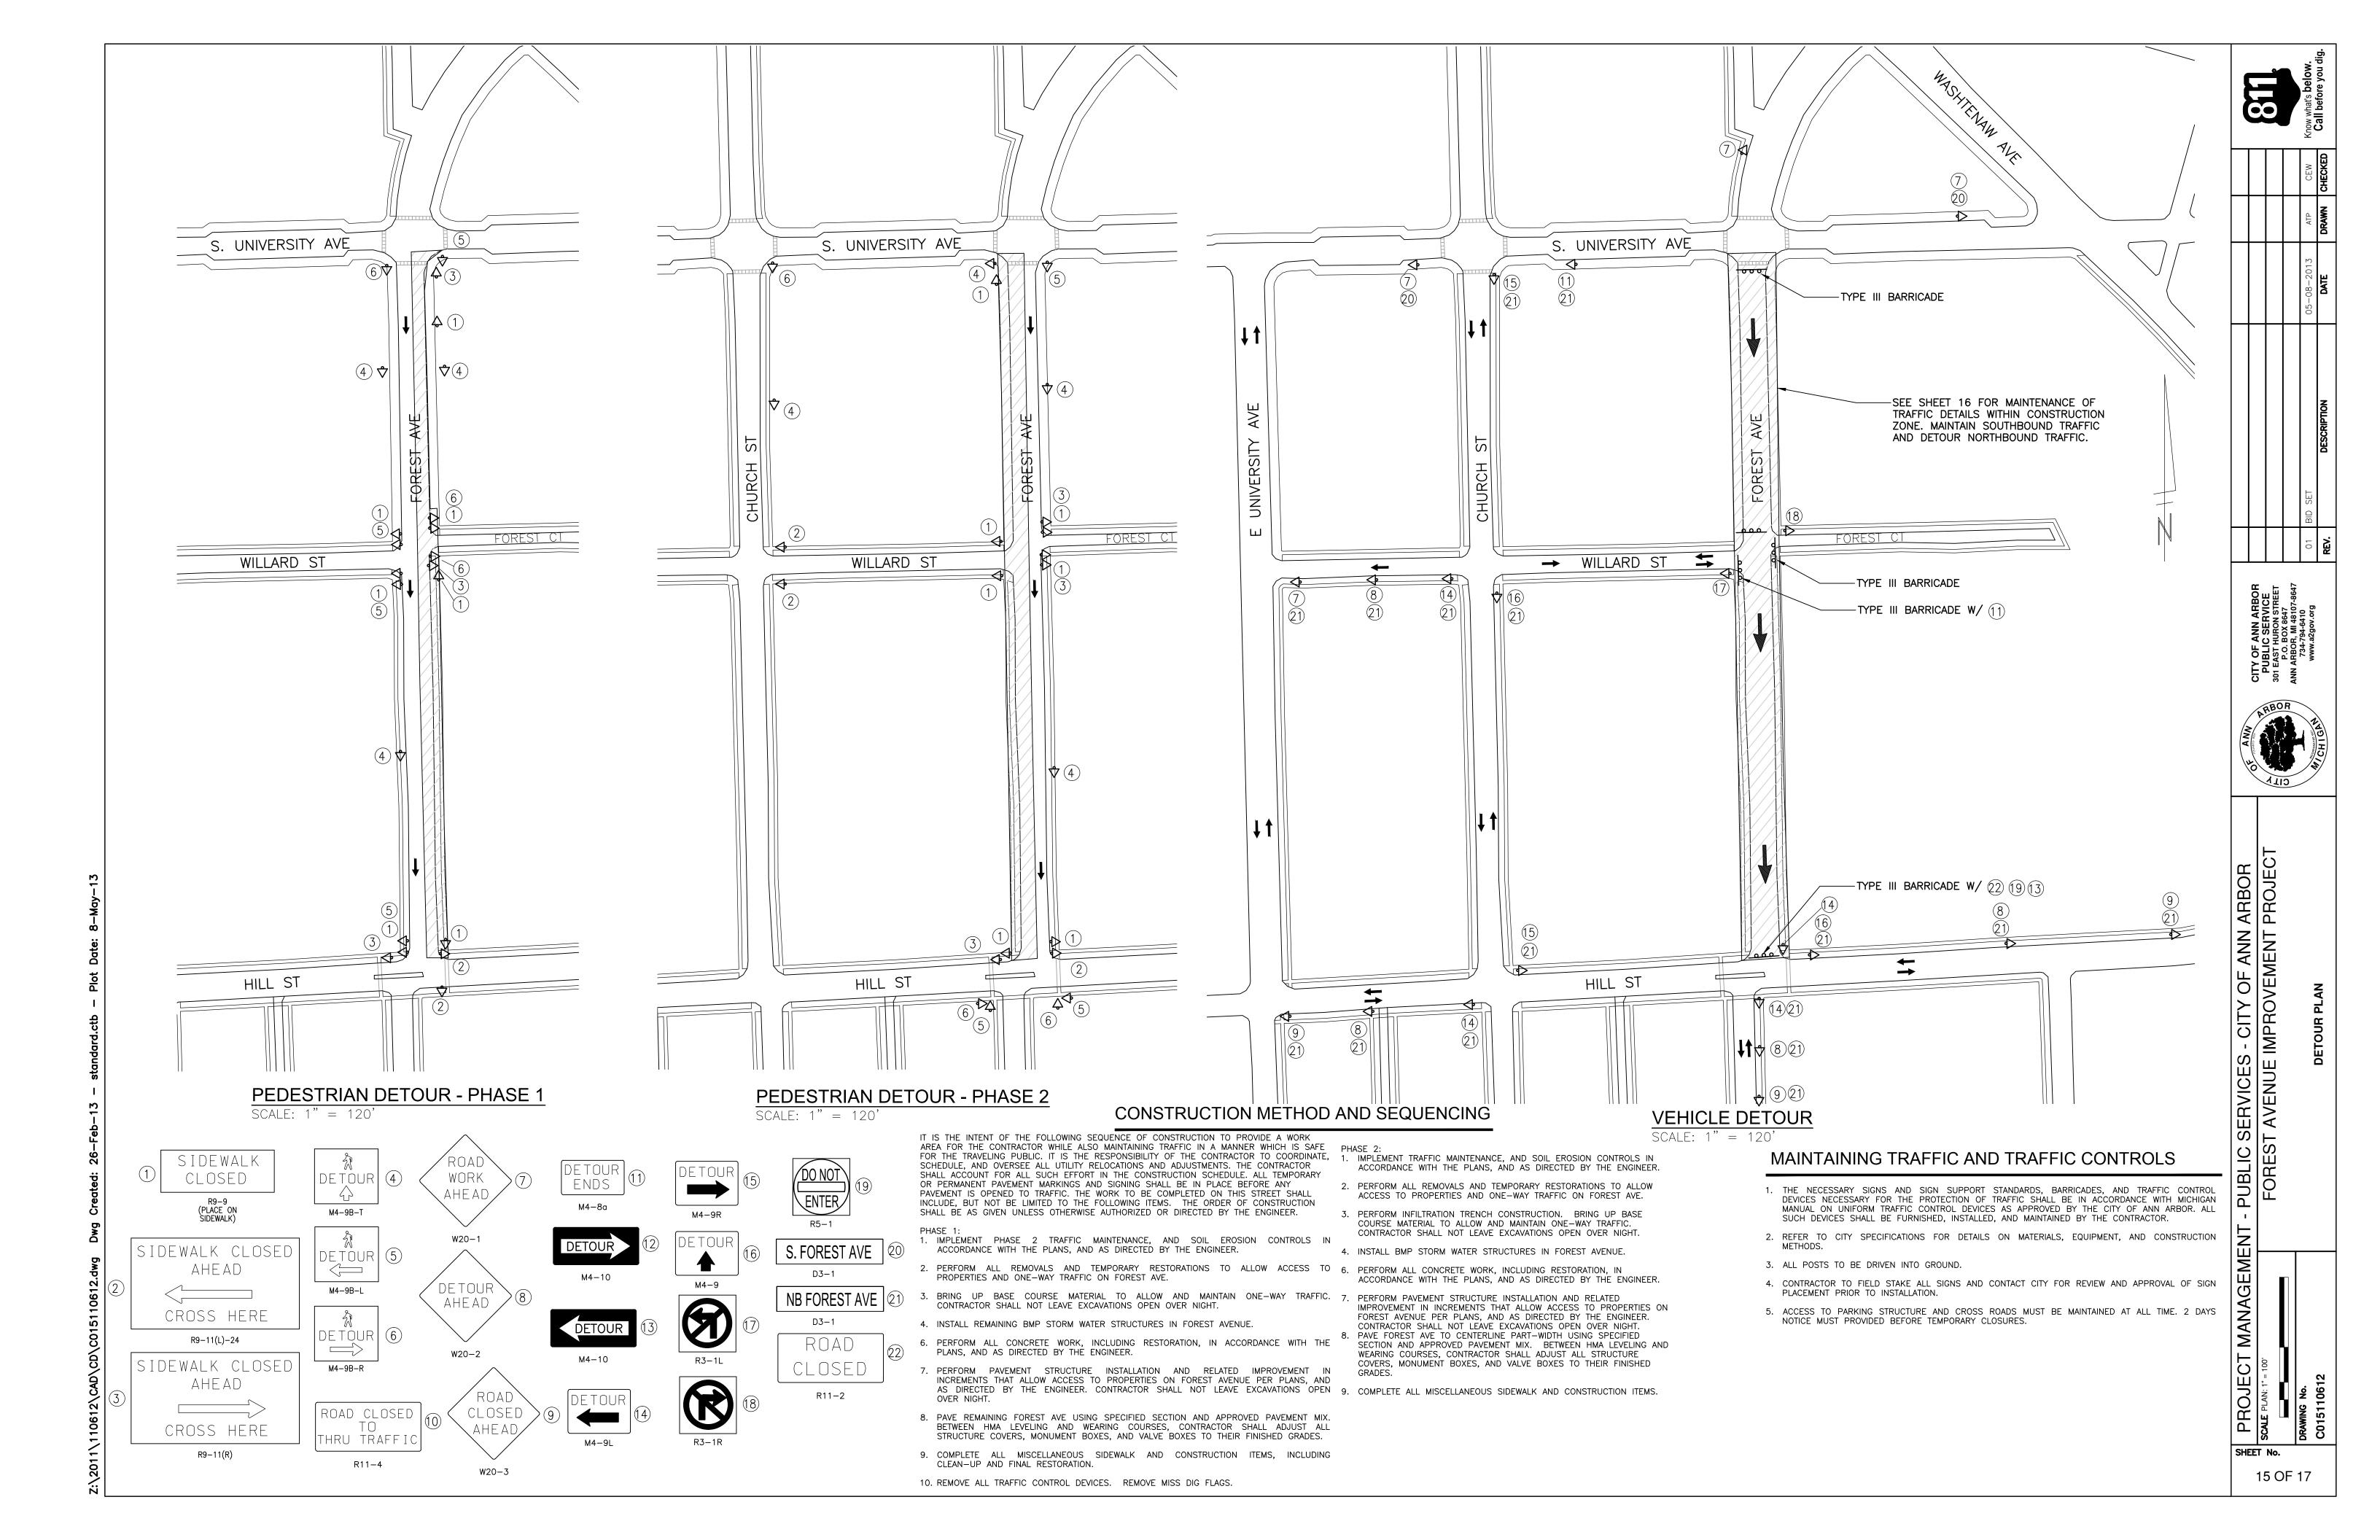


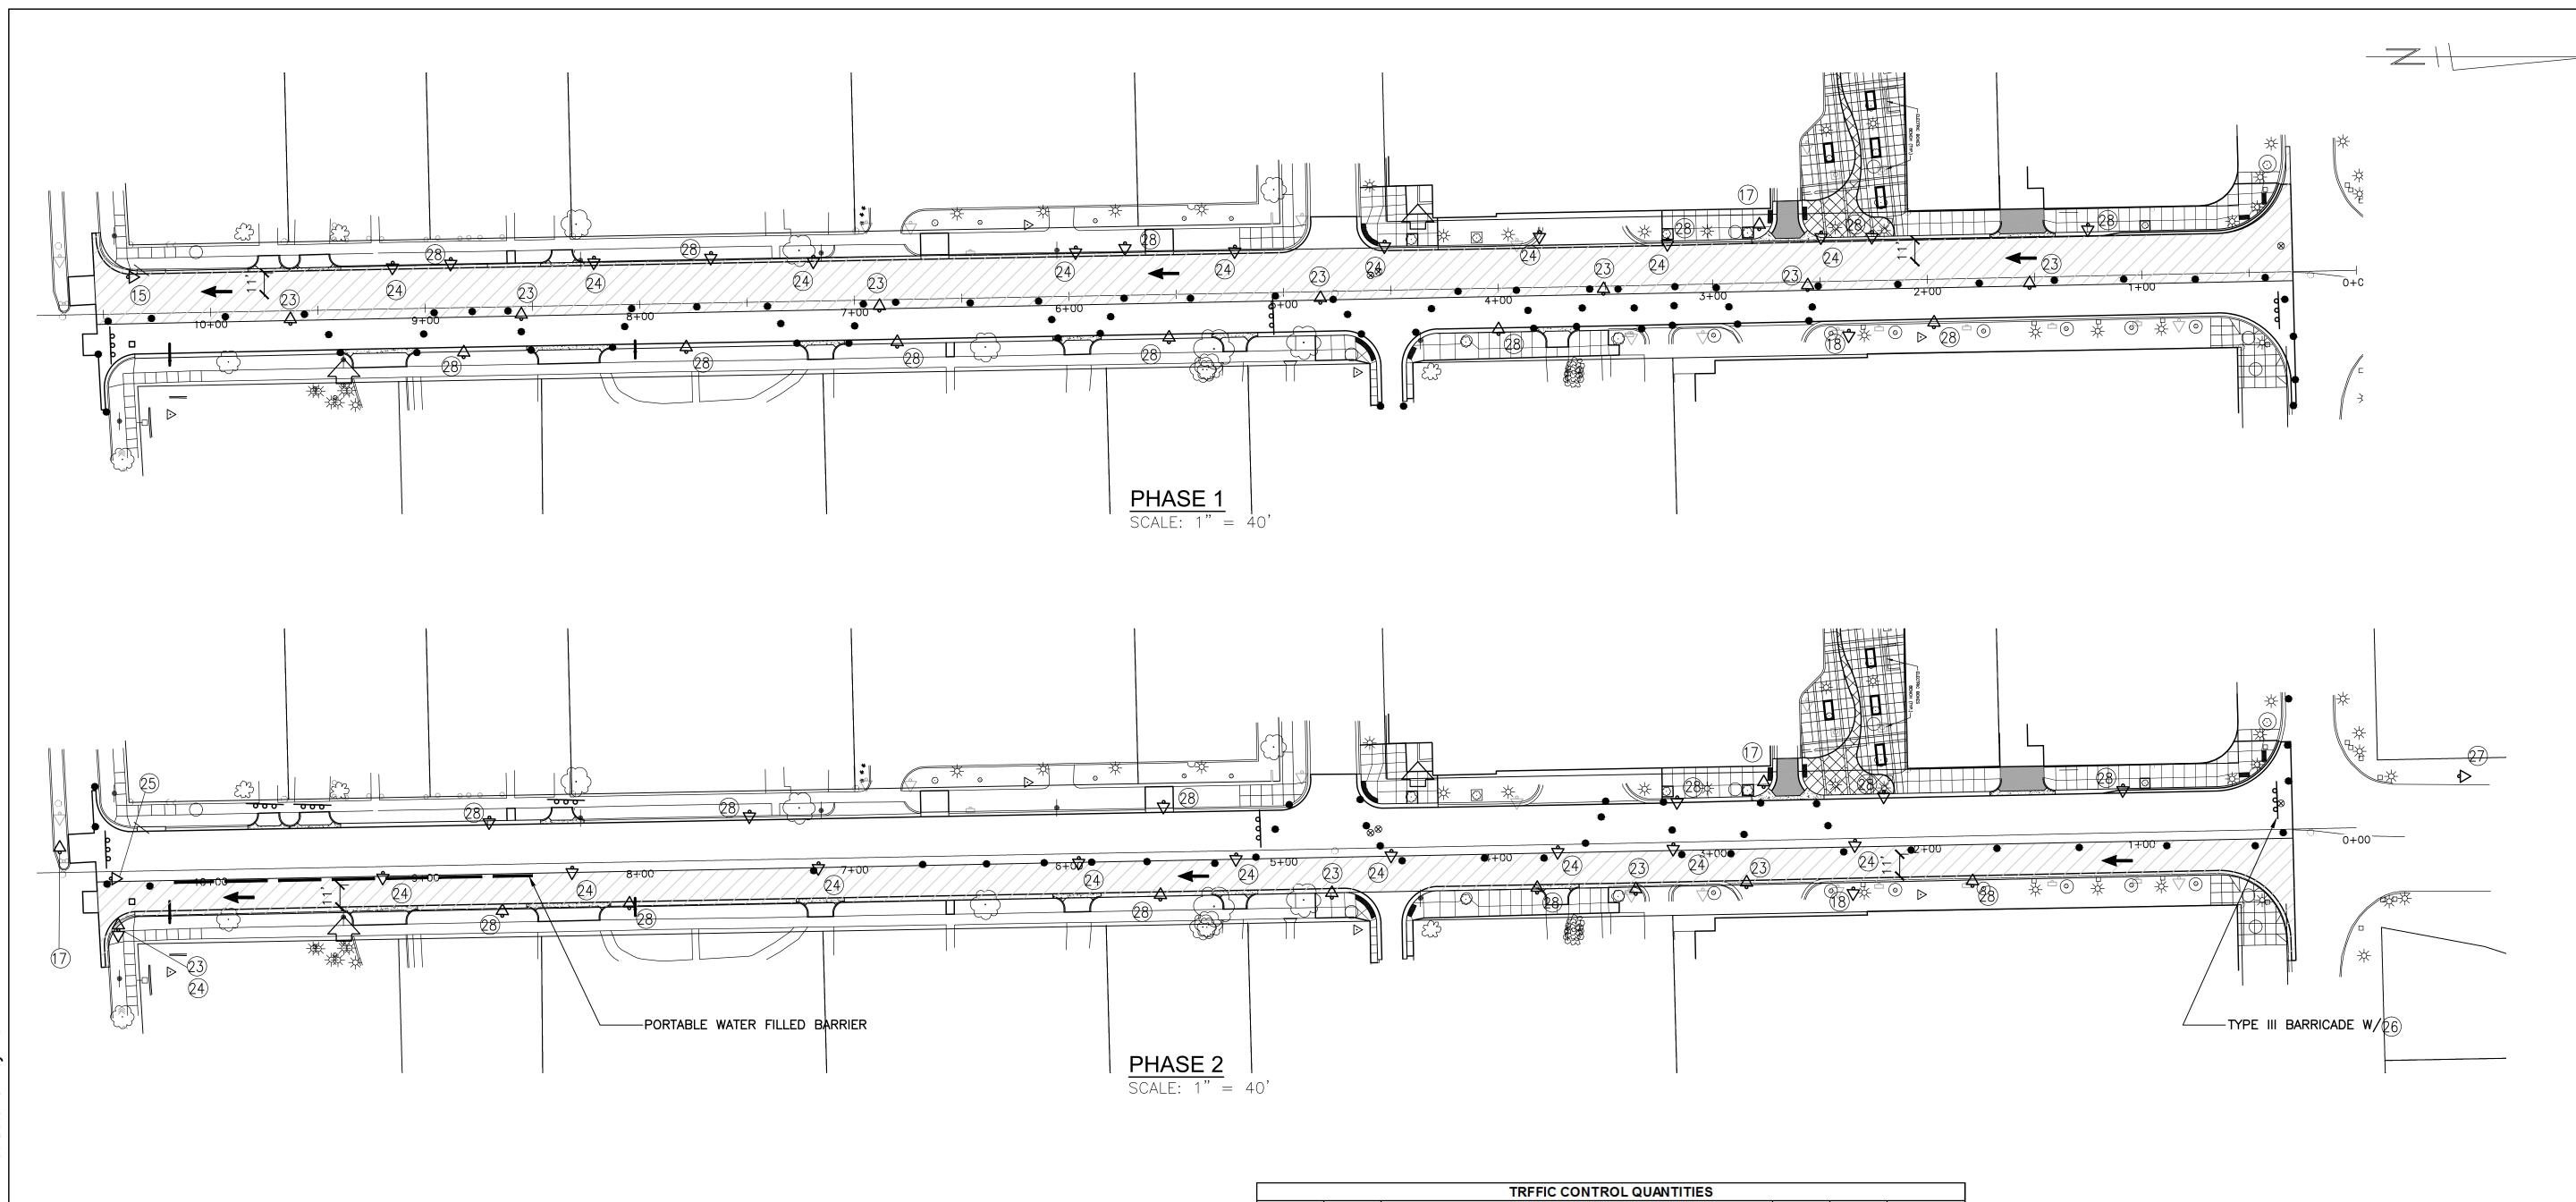





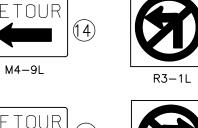



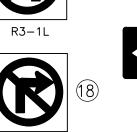

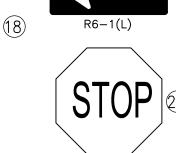

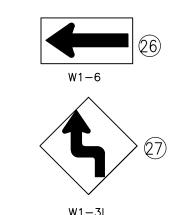



LANE CLOSURE DETAIL

USE OF TRAFFIC REGULATOR OPERATIONS ARE ALLOWED GIVEN PERMISSION FROM THE ENGINEER. SUCH OPERATIONS SHALL COMPLY WITH THE MMUTCD AND CORRESPONDING FIGURE $6H\!-\!10$.

| QTY. | TYPE | DESCRIPTION | SIZE | AREA | TOTAL AREA |
|------|----------|--|-------|------|------------|
| 16 | D3-1 | NB FOREST AVE | 12X36 | 3 | 48 |
| 2 | D3-1 | S FOREST AVE | 12X36 | 3 | 6 |
| 7 | R9-9 | SIDEWALK CLOSED | 30X18 | 3.75 | 26.25 |
| 3 | R9-11L | SIDEWALK CLOSED - CROSS HERE | 24X12 | 2 | 6 |
| 3 | R9-11R | SIDEWALK CLOSED - CROSS HERE | 24X12 | 2 | 6 |
| 4 | M4-9B-T | PED DETOUR - THRU | 30X30 | 6.25 | 25 |
| 4 | M4-9B-L | PED DETOUR - LEFT | 30X30 | 6.25 | 25 |
| 3 | M4-9B-R | PED DETOUR - RIGHT | 30X30 | 6.25 | 18.75 |
| 4 | W20-1 | ROAD WORK AHEAD | 36X36 | 9 | 36 |
| 4 | W20-2 | DETOUR AHEAD | 36X36 | 9 | 36 |
| 3 | W20-3 | ROAD CLOSED AHEAD | 36X36 | 9 | 27 |
| 2 | R11-4 | ROAD CLOSED TO THRU TRAFFIC | 30X60 | 12.5 | 25 |
| 1 | M4-8A | DETOUR ENDS | 18X24 | 3 | 3 |
| 0 | M4-10R | DETOUR - RIGHT | 18X48 | 6 | 0 |
| 1 | M4-10L | DETOUR - LEFT | 18X48 | 6 | 6 |
| 4 | M4-9L | DETOUR - LEFT | 30X24 | 5 | 20 |
| 3 | M4-9R | DETOUR - RIGHT | 30X24 | 5 | 15 |
| 2 | M4-9 | DETOUR - THRU | 30X24 | 5 | 10 |
| 2 | R3-1L | NO LEFT TURN | 24X24 | 4 | 8 |
| 2 | R3-1R | NO RIGHT TURN | 24X24 | 4 | 8 |
| 1 | R5-1 | DO NOT ENTER | 30X30 | 6.25 | 6.25 |
| 1 | R11-2 | ROAD CLOSED | 30X48 | 10 | 10 |
| 7 | R6-1R | ONE-WAY RIGHT | 36X12 | 3 | 21 |
| 9 | R6-1L | ONE-WAY LEFT | 36X12 | 3 | 27 |
| 1 | R1-1 | STOP | 30X30 | 6.25 | 6.25 |
| 1 | W1-6 | LEFT ARROW | 48X24 | 8 | 8 |
| 1 | W1-3L | SHIFT LEFT | 36X36 | 9 | 9 |
| 14 | R7-2A | NO PARKING* | 18X12 | 1.5 | 21 |
| 2 | W20-7A | FLAGGER | 36X36 | 9 | 18 |
| 2 | W3-4 | BE PREPARED TO STOP | 36X36 | 9 | 18 |
| 10 | TYPE III | TYPE III LIGHTED BARRICADE | | | |
| 70 | TYPE II | LIGHTED DRUM | | | |
| 150 | тсв | PORTABLE WATER FILLED BARRIER (LF) | | | |
| 2 | PCMS | SIGN, PORTABLE CHANGEABLE MESSAGE, FURNISH AND OPERATE | | | |
| | | *PROVIDED BY CITY | | | |

LEGEND



WORK ZONE DIRECTION OF TRAFFIC

TYPE III BARRICADE

PLASTIC DRUM, HIGH INTENSITY (25' SPACING)

TEMP CONSTRUCTION SIGN

