


CITY OF ANN ARBOR ENGINEERING

LIBERTY STREET CREEK RESTORATION

RFP # 25-53

	SHEET LIST TABLE
SHEET NUMBER	SHEET TITLE
	COVER SHEET
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NOT

FOR PROTECTION OF UNDERGROUND UTILITIES AND IN CONFORMANCE WITH PUBLIC ACT 174 OF 2013, THE CONTRACTOR SHALL CALL 811 OR 1-800-482-7171 A MINIMUM OF THREE FULL WORKING DAYS, EXCLUDING SATURDAYS, SUNDAYS AND HOLIDAYS, PRIOR TO BEGINNING EACH EXCAVATION IN AREAS WHERE PUBLIC UTILITIES HAVE NOT BEEN PREVIOUSLY LOCATED. MEMBERS WILL THUS BE ROUTINELY NOTIFIED THIS DOES NOT RELIEVE THE CONTRACTOR OF THE RESPONSIBILITY OF NOTIFYING UTILITY OWNERS WHO MAY NOT BE A PART OF THE "MISS DIG" ALERT SYSTEM.

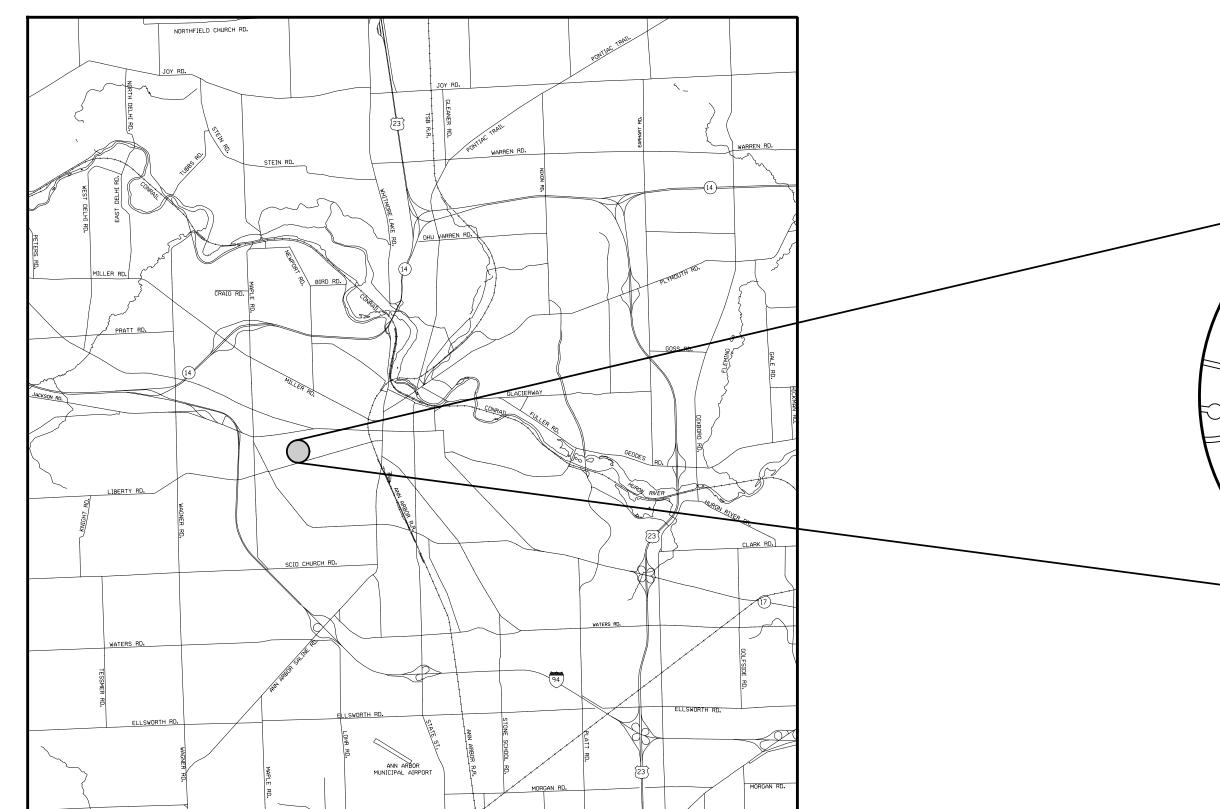THE UNDERGROUND LOCATIONS SHOWN FOR EXISTING UTILITIES ON THESE PLANS ARE APPROXIMATE. THE CITY OF ANN ARBOR ASSUME NO RESPONSIBILITY FOR THEIR ACCURATE REPRESENTATION. MISS DIG MUST BE CONTACTED PRIOR TO CONSTRUCTION TO LOCATE AN OF THESE UTILITIES.

THE CONSTRUCTION COVERED BY THESE PLANS SHALL CONFORM
TO THE 2024 EDITION OF THE CITY OF ANN ARBOR PUBLIC SERVICES
DEPARTMENT STANDARD SPECIFICATIONS, ITS DETAILS WHICH ARE
INCLUDED FOR REFERENCE AND THIS PROJECT'S CONTRACT DOCUMENT
THE OMISSION OF ANY CURRENT STANDARD DETAILS DOES NOT RELIEVE

F.B.
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CHECKED

11-0	11-07-2025	J.A.R.	F.B.
COMMENTS 05-1	05-16-2025	J.A.R.	F.B.
PERMIT 02-2	02-24-2025	J.A.R.	F.B.
INARY REVIEW 01-1	01-16-2025	J.A.R.	F.B.
PT REVIEW 10-3	10-31-2024	J.A.R.	F.B.
CRIPTION	DATE	DRAWN	CHECKE

REVISED PER EGLE COMMENTS	ISSUED FOR EGLE PERMIT	ISSUED FOR PRELIMINARY REVIEW	ISSUED FOR CONCEPT REVIEW	DESCRIPTION	
				REV.	

PUBLIC SERVICES
PUBLIC SERVICES
801 EAST HURON STREET
P.O. BOX 8647
NN ARBOR, MI 48107-864
www.a2gov.org



GINEERING REEK RESTORATION

BLIC SERVICES - ENGINEERING SERTY STREET CREEK RE

FY OF ANN ARBOR - PUB

CITY OF AN SCALE

SHEET No.

COVER

PREPARED UNDER THE SUPERVISION OF

OF MICHO
JOHN
VINCENT
BALINT, III
PROFESSIONAL
ENGINEER
No.
6201054062

JOHN V. BALINT, P.E. DATE
MI LICENSE No. 6201054062
HUBBELL, ROTH & CLARK, INC.

THERESA CISCO BRIDGES, P.E. MI LICENSE No. 6201052180 PROJECT MANAGER

PROJECT


LOCATION

ES, P.E. DATE

CITY APPROVAL

BRIDGES

PROFESSIONAL ENGINEER No.

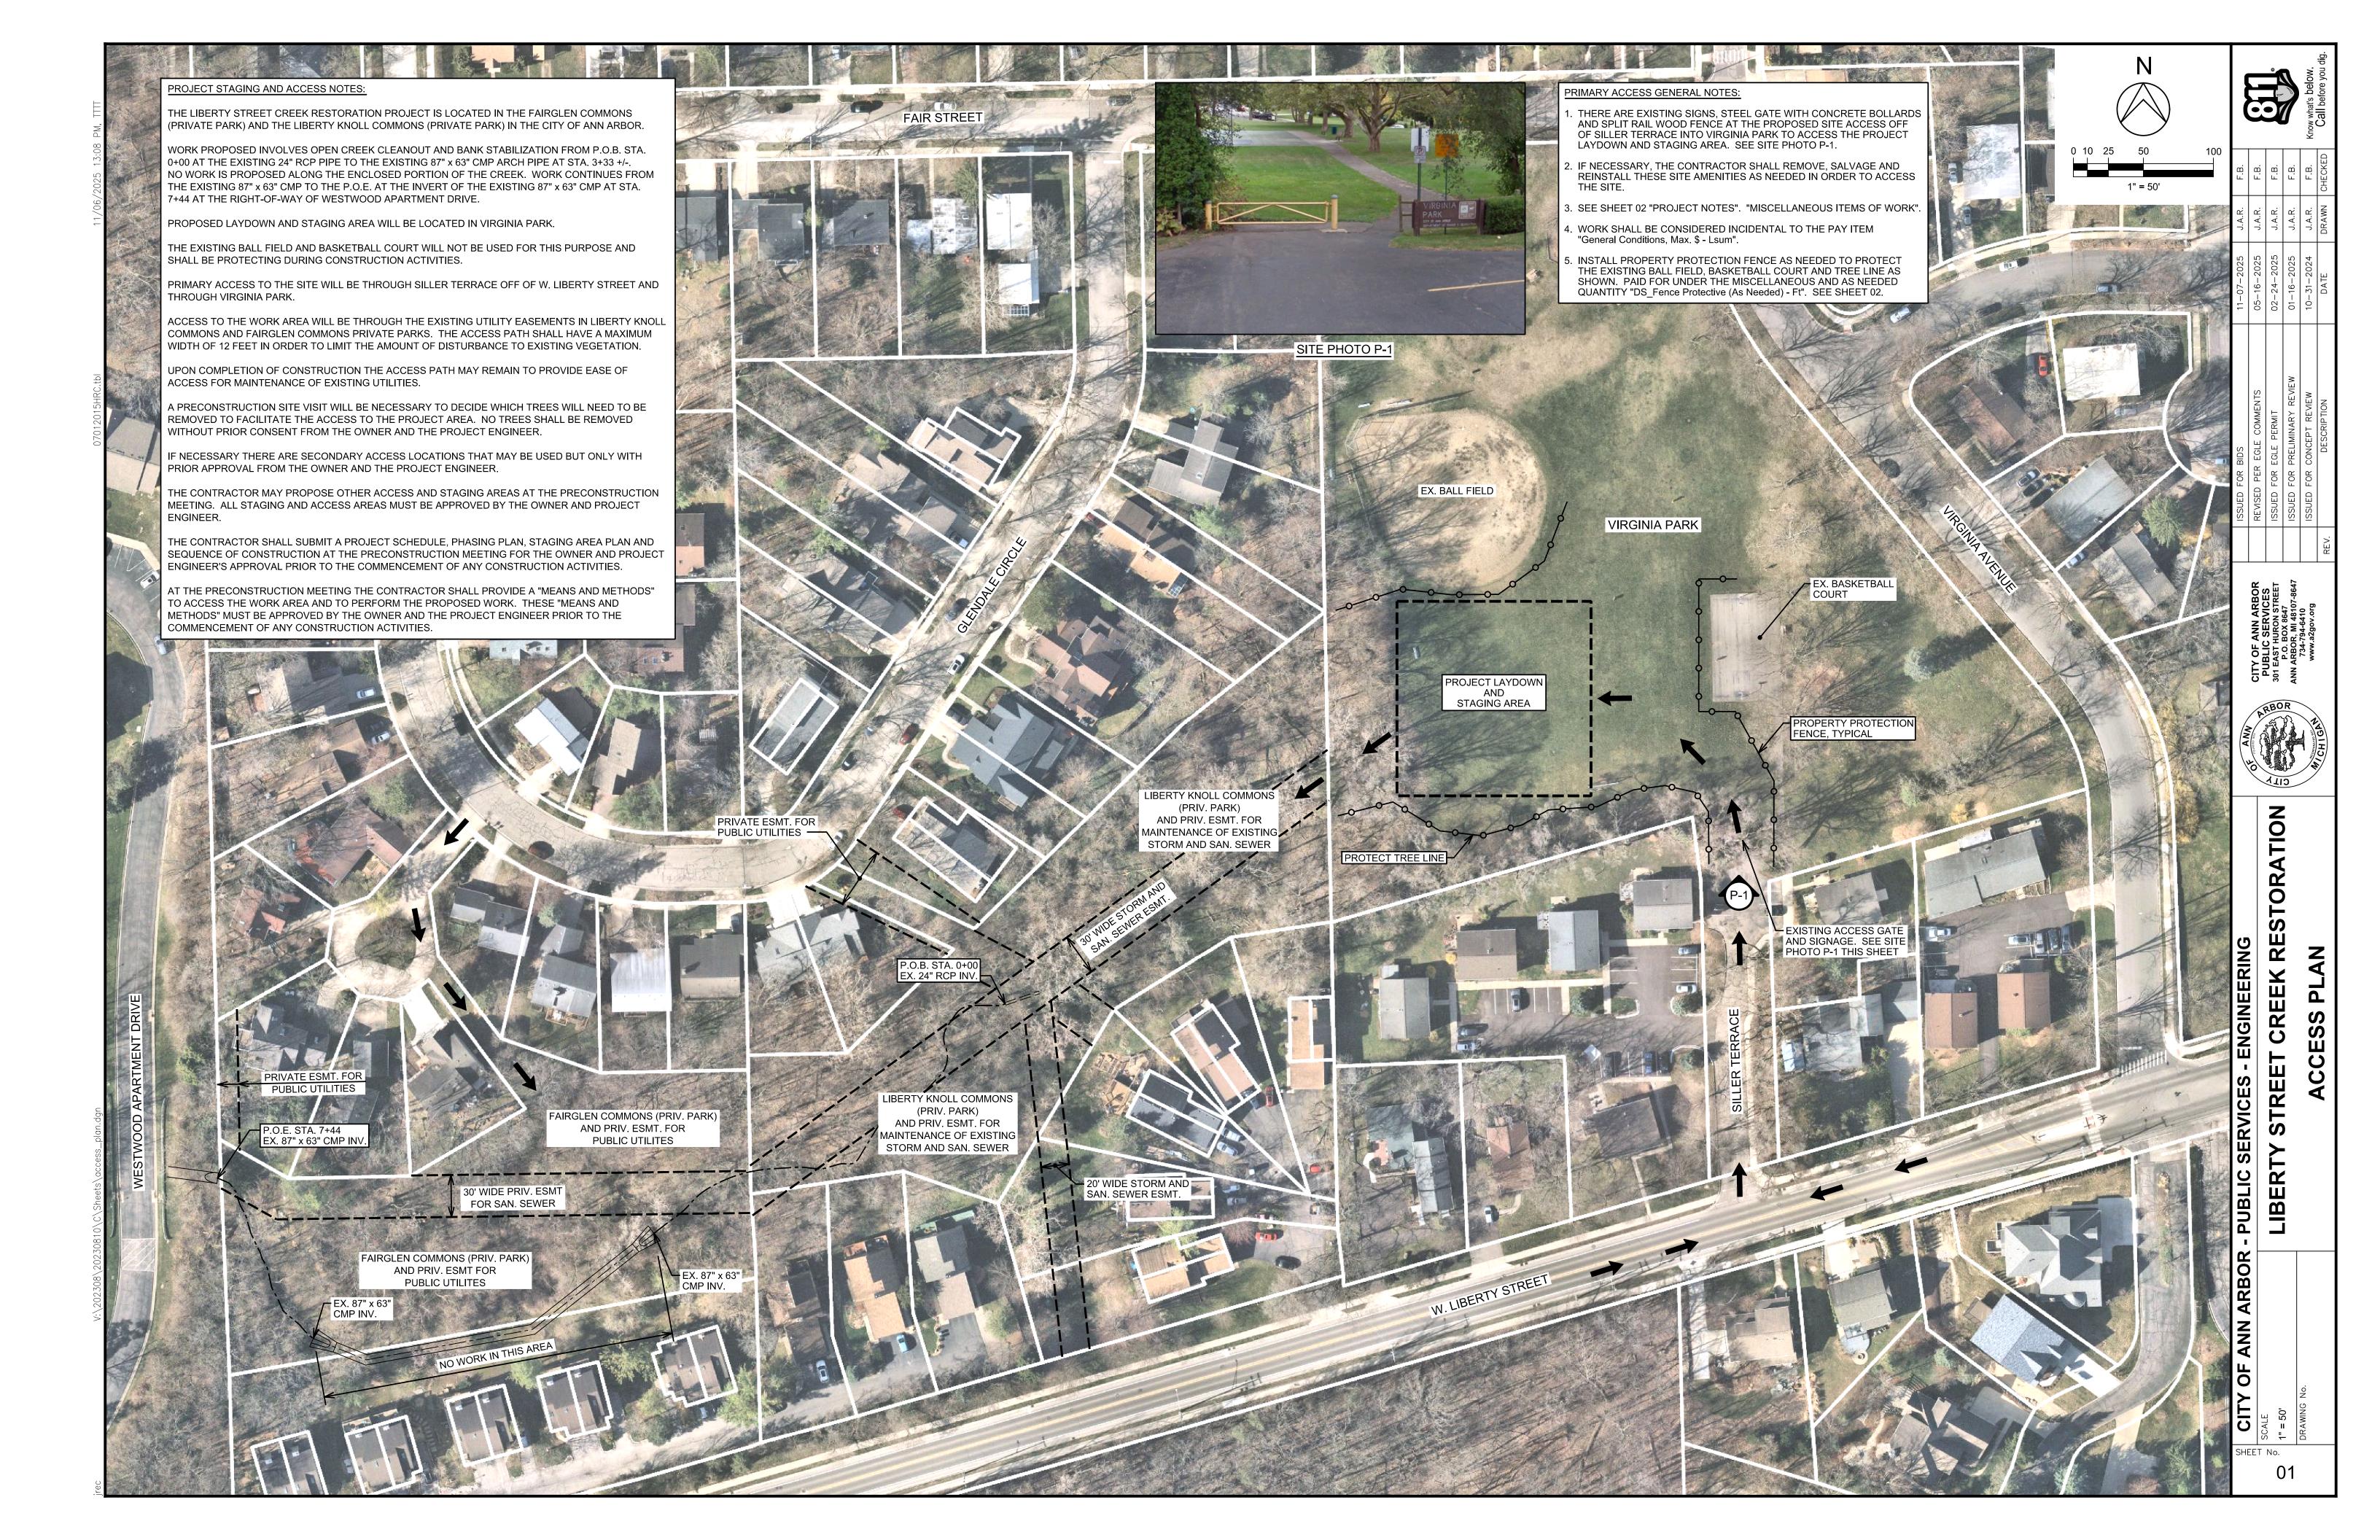

GENERAL NOTES:

THIS PROJECT SHALL BE CONSTRUCTED IN ACCORDANCE WITH THE MDOT 2020 STANDARD SPECIFICATIONS FOR CONSTRUCTION AND THE 2025 PUBLIC SERVICES STANDARD SPECIFICATIONS UNLESS OTHERWISE SPECIFIED IN THE STANDARD SPECIFICATIONS, DETAILS OR SPECIAL PROVISIONS AND THE SPECIFICATIONS CONTAINED HEREIN.

COOPERATION BY THE CONTRACTOR: NO ADDITIONAL COMPENSATION WILL BE PAID TO THE CONTRACTOR FOR ANY DELAY OR INCONVENIENCE DUE TO MATERIAL SHORTAGES OR REASONABLE DELAYS DUE TO THE OPERATIONS OF SUCH OTHER PARTIES DOING WORK INDICATED OR SHOWN ON THE PLANS OR IN THE PROPOSAL OR FOR ANY REASONABLE DELAYS IN CONSTRUCTION DUE TO THE ENCOUNTERING OF EXISTING UTILITIES THAT MAY OR MAY NOT BE SHOWN ON THE PLANS.

THE CONTRACTOR SHALL CONDUCT HIS OPERATIONS IN SUCH A MANNER TO COMPLY WITH ALL FEDERAL, STATE, AND LOCAL CODES FOR NOISE LEVELS, VIBRATIONS, OR ANY OTHER RESTRICTIONS WHILE PERFORMING ANY CONSTRUCTION OPERATIONS WITHIN THIS CONTRACT, COSTS TO BE INCLUDED IN THE RESPECTIVE ITEM OF WORK

THE CONTRACTOR SHALL, BEFORE EACH DAYS WORK, DETERMINE AND EVALUATE THE LOCATION OF ALL UNDERGROUND FACILITIES IN THE AREA. IF LOCATION STAKES HAVE BEEN MOVED OR DO NOT APPEAR CORRECT, THE CONTRACTOR SHALL NOT EXCAVATE UNTIL ALL UTILITIES HAVE HAD AN OPPORTUNITY TO CHECK OR RESTAKE THEIR LOCATIONS. ANY DELAYS INCURRED, DUE TO THE CHECKING OR RESTAKING OF UTILITIES SHALL NOT BE A BASIS FOR ADDITIONAL COMPENSATION.

THERE WILL BE NO ADJUSTMENT IN THE CONTRACT UNIT PRICE REGARDLESS OF THE PERCENTAGE OF INCREASE OR DECREASE ABOVE OR BELOW THE CONTRACT QUANTITY FOR ANY ITEM OF WORK.

IT IS THE INTENT THAT ALL GOVERNMENT CORNERS ON THIS PROJECT BE PRESERVED AND THAT, WHERE NECESSARY, MONUMENT BOXES BE PLACED OR ADJUSTED AT THE CONTRACTORS EXPENSE WHETHER SHOWN OR NOT.

THE LOCATION OF ALL PUBLIC UTILITIES SHOWN ON THESE PLANS ARE TAKEN FROM THE BEST AVAILABLE DATA. THE CITY OF ANN ARBOR & HUBBELL, ROTH AND CLARK, INC. WILL NOT BE HELD RESPONSIBLE FOR ANY OMISSION OR VARIATIONS FROM THE LOCATIONS SHOWN. PURSUANT TO ACT 53 OF THE PA OF 1974 AS A CONDITION OF THIS CONTRACT NOTICE SHALL BE GIVEN TO MISS DIG PRIOR TO UNDERGROUND WORK TO BE PERFORMED IN ACCORDANCE WITH THIS CONTRACT. PHONE (800)-482-7171 OR 647-7344.

IT IS THE CONTRACTOR'S RESPONSIBILITY TO EXCAVATE AHEAD AND ADJUST DEPTH OF UTILITIES ACCORDINGLY IN ORDER TO AVOID ANY POTENTIAL CONFLICTS. ANY DAMAGE INCURRED TO UTILITIES IS THE CONTRACTOR'S RESPONSIBILITY AND WILL BE REPAIRED IMMEDIATELY AT NO COST TO THE OWNER.

STAGING AND ACCESS:

SEE PLAN SHEET 01 "ACCESS PLAN" FOR DESCRIPTION AND RECOMMENDATIONS FOR THE STAGING AND LAYDOWN AREAS ALONG WITH THE RECOMMENDED ACCESS ROUTE TO THE PROPOSED SITE.

CONSTRUCTION NOTES:

THE LOCATION AND DEPTH OF EXISTING UTILITIES ARE TO BE FIELD VERIFIED BY THE CONTRACTOR PRIOR TO CONSTRUCTION.

THE LOCATION OF MATERIAL STOCKPILES AND ONSITE STAGING AREAS SHALL BE APPROVED BY THE CITY OF ANN ARBOR AND THE ENGINEER.

THE CONTRACTOR SHALL BE RESPONSIBLE FOR ANY DAMAGE TO THE PROPERTY BEYOND THE SLOPE STAKE LINE, INCLUDING EXISTING FENCING, LAWN, TREES, SHRUBBING, PAVEMENT, ETC.

STREAM BANK DIRECTION:

ALL LEFT AND RIGHT STREAM BANKS / CROSS SECTIONS ARE REFERENCED LOOKING UPSTREAM PER PLAN.

PERMITS:

EGLE PERMIT No	PENDING
WCWRC DRAIN PERMIT No.	PENDING
CITY OF ANN ARBOR SESC No	PENDING

THE CONTRACTOR SHALL STRICTLY FOLLOW ALL PERMIT CONDITIONS SET FORTH.

CONSTRUCTION STAKING:

GRADING LIMITS, ELEVATIONS, AND LOCATIONS OF STRUCTURES AND BANK TREATMENTS SHALL BE STAKED BY THE ENGINEER. THE CONTRACTOR SHOULD PROVIDE 72 HOURS NOTICE OF STAKING NEEDS PRIOR TO WORK COMMENCING. THE CONTRACTOR SHALL MAINTAIN ALL STAKING THROUGH THE DURATION OF THE PROJECT.

LIMITS OF DISTURBANCE (LOD) SHOWN ON THE PLANS IS APPROXIMATE. THE CONTRACTOR SHALL CONDUCT HIS OPERATIONS SO THAT ALL WORK PERFORMED IS WITHIN THE PROJECT

UTILITIES:

ALL UTILITIES WITHIN THE ZONE OF INFLUENCE OF PROPOSED WORK ARE TO BE FIELD LOCATED AND HAND DUG INCLUDED IN THE UNIT BID PRICES FOR APPROPRIATE ITEMS.

ALL GAS FACILITIES SHALL BE PROTECTED AND SUPPORTED PER MICHCON OR CONSUMER ENERGY STANDARDS AS APPLICABLE.

PRIOR TO WORK ON FACILITIES BELONGING TO THE ABOVE AGENCIES, A MINIMUM OF 72 HOURS NOTICE MUST BE GIVEN IN ORDER TO INSURE PROPER INSPECTION BY THE RESPECTIVE AGENCIES.

CONCRETE, GRADE S3, SHALL BE USED TO ENCASE UTILITIES THAT ARE IN CLOSE PROXIMITY TO THE PROPOSED CONSTRUCTION ONLY AS DIRECTED BY THE ENGINEER.

ALL EXPLORATORY WORK REQUIRED FOR LOCATING EXISTING UTILITIES SHALL NOT BE PAID FOR SEPARATELY BUT SHALL BE INCLUDED IN THE CONSTRUCTION OF THE PROJECT.

THE EXISTING UTILITIES LISTED HEREIN AND SHOWN ON THESE PLANS REPRESENT THE BEST INFORMATION AVAILABLE AS OBTAINED FROM SURVEYS AND FROM UTILITY RECORD MAPS. THIS INFORMATION DOES NOT RELIEVE THE CONTRACTOR OF THE RESPONSIBILITY TO SATISFY HIMSELF AS TO THEIR ACCURACY OR OF HIS RESPONSIBILITY IN CASE UTILITIES HAVE BEEN CONSTRUCTED, RELOCATED OR REMOVED. OWNERS OF PRIVATE UTILITIES WILL NOT BE REQUIRED TO MOVE ADDITIONAL POLES AND STRUCTURES THAT ARE NOT SPECIFICALLY INDICATED AS SUCH ON THE PLANS.

THE CONTRACTOR SHALL LOCATE ALL ACTIVE UNDERGROUND UTILITIES PRIOR TO STARTING WORK, AND SHALL CONDUCT HIS OPERATIONS IN SUCH A MANNER AS TO INSURE THAT THOSE UTILITIES NOT REQUIRING RELOCATION WILL NOT BE DISTURBED.

FOR PROTECTION OF UNDERGROUND UTILITIES, THE CONTRACTOR SHALL DIAL 800-482-7171 A MINIMUM OF 3 WORKING DAYS, EXCLUDING SATURDAYS, SUNDAYS AND HOLIDAYS, PRIOR TO EXCAVATING IN THE VICINITY OF UTILITY LINES. ALL "MISS DIG" PARTICIPATING WILL THUS BE ROUTINELY NOTIFIED. THIS DOES NOT RELIEVE THE CONTRACTOR OF THE RESPONSIBILITY OF NOTIFYING UTILITY OWNERS WHO MAY NOT BE A PART OF THE 'MISS DIG' ALERT SYSTEM.

THE CONTRACTOR SHALL PROTECT ALL SIDE DRAIN STORM OUTLETS DURING CONSTRUCTION. ALL SIDE DRAIN OUTLETS MUST REMAIN UNOBSTRUCTED AND SHALL NOT BE COVERED WHEN PORTIONS OF THE EXISTING DRAIN ARE FILLED IN. IF DISTURBED, OUTLETS SHALL BE RESET AS NECESSARY TO PROVIDE POSITIVE FLOW TO THE CREEK.

THE CONTRACTOR SHALL PROTECT ALL SANITARY MANHOLES DURING CONSTRUCTION. THERE ARE MULTIPLE SANITARY SEWER CROSSINGS NOTED ON THE PLAN SHEETS. THE CONTRACTOR SHALL PROTECT THE EXISTING SANITARY SEWER AT THESE LOCATIONS. PRIOR TO ANY WORK, THE CONTRACTOR SHALL FIELD VERIFY THE DEPTH AND LOCATION OF THE SANITARY SEWER AND IF NECESSARY HAND DIG AT THESE LOCATIONS.

HEAVY EQUIPMENT ACCESS AND OPERATION:

THE CONTRACTOR SHALL STAY WITHIN THE LIMITS OF CONSTRUCTION AND MINIMIZE THE AREA AND DURATION OF DISTURBANCE AT ALL TIMES. ALL OTHER TREE CLEARING NECESSARY TO CONSTRUCT THE PROJECT PER THE PLANS AND FOR SITE ACCESS SHALL BE MINIMIZED TO THE EXTENT POSSIBLE, AND APPROVED BY THE CITY OF ANN ARBOR AND THE PROJECT ENGINEER.

THE CONTRACTOR SHALL USE REASONABLE MEASURES TO AVOID SOIL COMPACTION BY HEAVY EQUIPMENT.

CONTRACTOR SHALL USE EQUIPMENT SUITABLE FOR WORK IN THE CREEK. THE INSPECTOR RESERVES THE RIGHT TO EXCLUDE ANY EQUIPMENT HE DEEMS UNACCEPTABLE TO ENTER THE CREEK DUE TO LEAKING FLUIDS. ACCUMULATED SEDIMENT OR OTHER POTENTIAL HAZARDS TO WATER QUALITY. TEMPORARY RIP RAP OR OTHER MEANS AS NECESSARY SHALL BE USED TO PROTECT THE EDGE OF THE CREEK BANK WHEN ENTERING OR EXITING THE CREEK. THE ACCESS PATH WILL BE GRADED AND STABILIZED BY THE CONTRACTOR TO SUPPORT HIS OPERATIONS WHILE MINIMIZING DISRUPTION AND RESTORATION. THE CONTRACTOR SHALL PROVIDE ACCESS PLANS AND DETAILS FOR REVIEW AT THE PRECONSTRUCTION MEETING. ALL COSTS ASSOCIATED WITH THE CONTRACTOR'S CHOSEN MEANS OF ACCESS SHALL BE INCIDENTAL TO THE PROJECT AND INCLUDED IN OTHER LINE ITEMS AS NECESSARY. THE CONTRACTOR WILL NOT BE COMPENSATED FOR EXCESS CLEARING, GRADING, OR RESTORATION DUE TO THE CONTRACTOR'S OPERATIONS

TRACK HOES USED FOR VANE, BOULDER, AND TOE WOOD INSTALLATION SHALL BE EQUIPPED WITH A SWIVEL BUCKET AND HYDRAULIC THUMB.

TREE REMOVAL WORK:

TREES DESIGNATED FOR REMOVAL ARE SHOWN AS SUCH 💢. TREES SHALL BE REMOVED IN THEIR ENTIRETY INCLUDING ROOT WADS, ETC. AND USED IN THE CONSTRUCTION OF THE TOE WOOD BANK STABILIZATION STRUCTURES AS DIRECTED BY THE PROJECT ENGINEER.

REMOVAL OF SHRUBS, BRUSH AND TREES LESS THAN 6 INCH IN DIAMETER (DBH) AS SHOWN ON THE PLANS OR AS DIRECTED SHALL BE PAID FOR UNDER THE MISCELLANEOUS AND AS NEEDED QUANTITY "General Conditions, Max. \$ - Lsum".

ALL WOODY MATERIAL FOR THE TOE WOOD STRUCTURES MUST BE APPROVED BY THE PROJECT ENGINEER.

NO TREES SHALL BE REMOVED WITHOUT PRIOR CONSENT FROM THE OWNER AND THE PROJECT ENGINEER.

EARTH REMOVAL

EXCAVATED MATERIAL TO CONSTRUCT THE NEW CREEK SHALL BE KEPT ON SITE AND USED AS FILL WHERE NEEDED.

ANY EXTRA MATERIALS REMAINING MAY BE TEMPORARILY STOCKPILED ON SITE. SEE "SPOILS" NOTE THIS SHEET.

SOIL EROSION, SILT FENCE:

SOIL EROSION SILT FENCE IS NOT DEPICTED ON THE PLANS AND IS CONSIDERED AN "AS NEEDED" QUANTITY. SOIL EROSION SILT FENCE SHALL BE PLACED AROUND ALL TEMPORARY SPOIL AREAS AND AROUND THE PROJECT LAYDOWN AND STAGING AREA TO PREVENT RUNOFF OF MATERIALS TO SURROUNDING AREAS. PAID FOR UNDER THE MISCELLANEOUS AND AS NEEDED PAY ITEM "DS Erosion Control, Silt Fence (As Needed) - Ft".

SPOILS:

SPOILS MAY BE TEMPORARILY STORED ON SITE. SPOILS INCLUDING DIRT AND TREES, ETC. SHALL BE USED WHERE NEEDED FOR BANK STABILIZATION, i.e. TOE WOOD STRUCTURES. ANY REMAINING STORED SPOILS SHALL HAVE EROSION CONTROL SILT FENCE AND / OR OTHER CONTAINMENT MEASURES PLACED AROUND THE SITE TO PREVENT RUNOFF. TEMPORARY SEEDING AND MULCHING OF STOCKPILED SPOIL AREAS MAY BE NECESSARY WHERE THEY ARE TO REMAIN FOR MORE THAN ONE MONTH. UPON COMPLETION OF WORK, ANY REMAINING SPOILS SHALL BE REMOVED OFFSITE TO A SUITABLE LANDFILL BY THE CONTRACTOR AND THE SPOILS AREA RESTORED WITH TOPSOIL, SEED AND MULCH PER THE CONTRACT SPECIFICATIONS.

CONSTRUCTION FENCING:

CONSTRUCTION / PROTECTION FENCING SHALL BE INSTALLED AT THE OWNER'S OR ENGINEER'S DIRECTION. FENCING SHALL BE PAID FOR UNDER THE MISCELLANEOUS AND AS NEEDED QUANTITY "DS Protection Fence - Ft".

RESTORATION:

RESTORATION OF THE SITE SHALL BE IN ACCORDANCE WITH THE FOLLOWING AND SHALL BE PAID FOR AS INDICATED BELOW:

ALL DISTURBED AREAS IN THE CREEK BANK SHALL BE RESTORED WITH SPECIFIED SEED MIX AS INDICATED ON THE PLANS AND IN THE SPECIFICATIONS.

REMOVE ALL CONSTRUCTION EQUIPMENT, EXCESS MATERIALS, DEBRIS, ETC., ESTABLISH FINE GRADE, AND RESTORE (PER PLANS AND SPECIFICATIONS), ALL COSTS FOR THE LABOR. EQUIPMENT AND MATERIALS SHALL BE CONSIDERED INCIDENTAL TO RESTORATION ITEMS.

REMOVE ANY HAUL ROADS OR ACCESS ROADS, MATERIAL STOCKPILES, AND CONSTRUCTION FENCING. THIS SHALL BE CONSIDERED INCIDENTAL TO PROJECT ITEM.

ALL PAVEMENT DAMAGED DURING CONTRACTOR OPERATIONS SHALL BE REPLACED AT THE EXPENSE OF THE CONTRACTOR TO THE CITY OF ANN ARBOR SPECIFICATIONS.

WATER REQUIRED FOR SOD AND SEEDING SHALL BE INCLUDED IN THE CONTRACT COST FOR THESE ITEMS. WATER REQUIRED FOR COMPACTION SHALL BE INCLUDED IN THE COST OF CONSTRUCTION FOR THIS PROJECT. CONTRACTOR SHALL WATER THE PLANTINGS AND SEEDED AREAS DAILY FOR A MINIMUM OF 14 DAYS WITH AN ADDITIONAL FOUR (4) WATERING EVENTS IN THE FOLLOWING TWO WEEKS AFTER THE DAILY WATERING. WATERING SHALL NOT OCCUR ON SATURDAYS, SUNDAYS, OR IMMEDIATELY AFTER RAIN EVENTS. ALL EXCEPTIONS SHALL BE APPROVED BY THE PROJECT ENGINEER.

ALL AREAS DISTURBED BY THE CONTRACTOR AND / OR HIS SUBCONTRACTOR(S) BEYOND THE NORMAL CONSTRUCTION LIMITS OF THIS PROJECT SHALL BE RESTORED AS SPECIFIED OR DIRECTED BY THE ENGINEER. NO ADDITIONAL PAYMENT OR COMPENSATION WILL BE ALLOWED FOR THIS ACTIVITY. THIS INCLUDES RESTORATION TO ALL MATERIAL STORAGE OR STAGING AREAS.

ALL DISTURBED AREAS TO BE RESTORED WITHIN SEVEN (7) DAYS OF COMPLETION.

CONTRACTOR TO CHECK ON SEED AND SOD GROWTH & SUPPLEMENT AS NEEDED. COSTS FOR RESEEDING AND RESODDING TO BE CONSIDERED INCIDENTAL TO RESTORATION ITEMS.

TREE PLANTINGS:

TREE PLANTINGS ARE PROPOSED FOR THIS PROJECT. SEE MISCELLANEOUS AND AS NEEDED QUANTITIES THIS SHEET.

TREE LOCATIONS AND SPECIES SHALL BE DETERMINED BY THE OWNER AND / OR THE PROJECT ENGINEER. THE PROJECT ENGINEER SHALL STAKE THE LOCATION OF THE PROPOSED TREES

CARE SHOULD BE TAKEN WHEN CHOOSING THE PROPOSED TREE LOCATIONS AS EXISTING STORM AND SANITARY SEWERS ARE IN THE PROJECT AREA. IT IS IMPERATIVE THAT THE PROPOSED TREE LOCATIONS AND THEIR ROOT SYSTEMS WILL NOT BE IN CONFLICT WITH SAID UTILITIES.

SEE DETAIL SHEETS FOR PLANTING DETAILS.

CONTRACTOR SHALL REFER TO THE PROJECT SPECIFICATIONS FOR SPECIAL LANDSCAPING REQUIREMENTS AND MAINTENANCE AND GUARANTEE STANDARDS FOR PROPOSED PLANTINGS.

MAINTENANCE RESPONSIBILITIES:

ONCE RESTORATION OF ALL DISTURBED AREAS HAS BEEN COMPLETED AND SEEDING HAS BEEN ESTABLISHED BY THE CONTRACTOR, IT WILL BE THE CITY OF ANN ARBOR'S RESPONSIBILITY TO MAINTAIN ALL AREAS INSIDE AND OUTSIDE OF THE MAIN CHANNEL (LIBERTY CREEK).

SEQUENCE OF CONSTRUCTION - SOIL EROSION AND SEDIMENTATION CONTROL:

- 1. THE CONTRACTOR SHALL INSTALL AND MAINTAIN THE SEDIMENT TRAP AND TEMPORARY SOIL EROSION AND SEDIMENT CONTROL MEASURES AS NECESSARY PRIOR TO AND DURING THEIR CONSTRUCTION ACTIVITIES.
- 2. INSTALL ALL TEMPORARY SOIL EROSION AND SEDIMENT CONTROL MEASURES
- 3. REMOVE VEGETATION AND DEBRIS AS DESCRIBED IN THE CREEK PER THE PLANS.
- 4. BEGIN CONSTRUCTION.
- 5. CONSTRUCT RESTORATION IMPROVEMENTS TO THE LIBERTY STREET CREEK.
- 6. COMPLETE CONSTRUCTION.
- 7. STABILIZE ALL DISTURBED AREAS WITH TURF REINFORCEMENT MATS AND NATIVE SEED MIX.
- 8. REMOVE ALL TEMPORARY SOIL EROSION AND SEDIMENTATION CONTROL MEASURES.
- 9. RESTORE CONSTRUCTION AREA AND STAGING / LAYDOWN AREA AND ALL SITE ACCESS POINTS WITH TOPSOIL, SEED AND MULCH.

SOIL EROSION AND SEDIMENTATION CONTROL - GENERAL NOTES:

- 1. ALL SOIL EROSION AND SEDIMENTATION CONTROL MEASURES SHALL CONFORM TO THE CURRENT STANDARDS AND SPECIFICATIONS OF THE WASHTENAW COUNTY WATER RESOURCES COMMISSIONER AND / OR THE CITY OF ANN ARBOR.
- 2. DAILY INSPECTIONS SHALL BE MADE BY THE CONTRACTOR TO DETERMINE THE EFFECTIVENESS OF THE SOIL EROSION AND SEDIMENTATION CONTROL MEASURES. ANY NECESSARY REPAIRS SHALL BE PERFORMED WITHOUT DELAY.
- 3. THE CONTRACTOR SHALL PERIODICALLY CHECK AND MAINTAIN THE PROPOSED SEDIMENT TRAPS AS NEEDED.
- 4. EROSION AND SEDIMENTATION FROM WORK ON THE SITE SHALL BE CONTAINED WITHIN THE LIMITS OF CONSTRUCTION AND NOT ALLOWED TO COLLECT ON ANY OFF SITE AREAS OR IN WATERWAYS. WATERWAYS INCLUDE BOTH NATURAL AND MAN MADE OPEN DITCHES, STREAMS, STORM DRAINS, LAKES, PONDS AND WETLANDS.
- 5. THE CONTRACTOR SHALL APPLY TEMPORARY SOIL EROSION AND SEDIMENTATION CONTROL MEASURES AS DIRECTED ON THESE PLANS AND WHERE OTHERWISE
- 6. THE CONTRACTOR SHALL TAKE ACTIONS AS NECESSARY TO PRESERVE NATURAL VEGETATION OUTSIDE THE LIMITS OF CONSTRUCTION.
- 7. STABILIZATION OF ALL DISTURBED AREAS SHALL BE ESTABLISHED USING THE APPROPRIATE VEGETATION WITHIN FIVE (5) WORKING DAYS OF THE COMPLETION OF FINAL GRADING.
- 8. THE CONTRACTOR SHALL SWEEP THE EXISTING STREETS SURROUNDING THE PROJECT SITE AS NEEDED.
- 9. SOIL EROSION AND SEDIMENTATION CONTROLS WILL BE MAINTAINED WEEKLY AND AFTER EVERY STORM EVENT BY THE CONTRACTOR.
- 10. TEMPORARY SOIL EROSION AND SEDIMENTATION CONTROLS SHALL REMAIN IN PLACE THROUGHOUT THE DURATION OF THE PROJECT. UPON FINAL RESTORATION THE CONTRACTOR SHALL REMOVE ALL TEMPORARY SOIL EROSION AND SEDIMENTATION CONTROL MEASURES.
- 11. ALL SOIL EROSION CONTROL MEASURES AS SHOWN ON THESE PLANS OR AS NEEDED TO COMPLETE THIS PROJECT SHALL BE PAID FOR AT THE UNIT PRICES INCLUDED IN THE PROPOSAL.

MISCELLANEOUS ITEMS OF WORK:

SEVERAL PAY ITEMS INCLUDED IN THE PROPOSAL ARE NOT SPECIFICALLY SHOWN ON THE PLANS. THESE ITEMS SHALL BE CONSTRUCTED AS DIRECTED BY THE PROJECT ENGINEER OR USED AS NEEDED. THEY ARE:

	MISCELLANEOUS AND AS NEEDED QUANTITIES		
No.	DESCRIPTION	QTY	UNIT
1	General Conditions, Max. \$35,000	1	Lsum
2	DS_Access Allowance	1	Lsum
3	Digital Audio Visual Coverage	1	Lsum
4	DS_Fence, Protective (As Needed) *	2500	Ft
5	DS_Erosion Control, Silt Fence (As Needed) *	500	Ft
6	Project Clean-Up and Restoration	1	Lsum
7	Tree, Large, B&B	30	Ea
8	Tree, Medium, B&B	30	Ea
9	DS_Restoration, Side Slope Native Seed Mix (As Directed)	1100	Syd
10	DS_Restoration, Bankfull Bench Seed Mix (As Directed)	300	Syd
11	DS_Restoration, Native Upland Woodland Seed Mix (As Directed)	900	Syd
12	Landscape Maintenance and Warranty, 1 Year	1	Lsum


* THE AUTHORITY TO DETERMINE IF AN ITEM IS "AS NEEDED" IS THE OWNERS AND NOT THE CONTRACTORS. THE USE OF "AS NEEDED" ITEMS BY THE CONTRACTOR WITHOUT AUTHORIZATION FROM THE OWNER SHALL BE CONSIDERED PART OF THE CONTRACTOR'S MOBILIZATION RESPONSIBILITIES AND WILL NOT BE PAID FOR SEPARATELY.

LEGEND:

PROPOSED:
— скеек ф — - —
TOP OF TERRACE
LIMITS OF DISTURBANCE ———LOD—
TREE, REMOVE
TOE WOOD
POOL
RIFFLE, CONSTRUCTED
RIP RAP
— CROSS VANE
LEDGE ROCK
— STONE
SITE ACCESS




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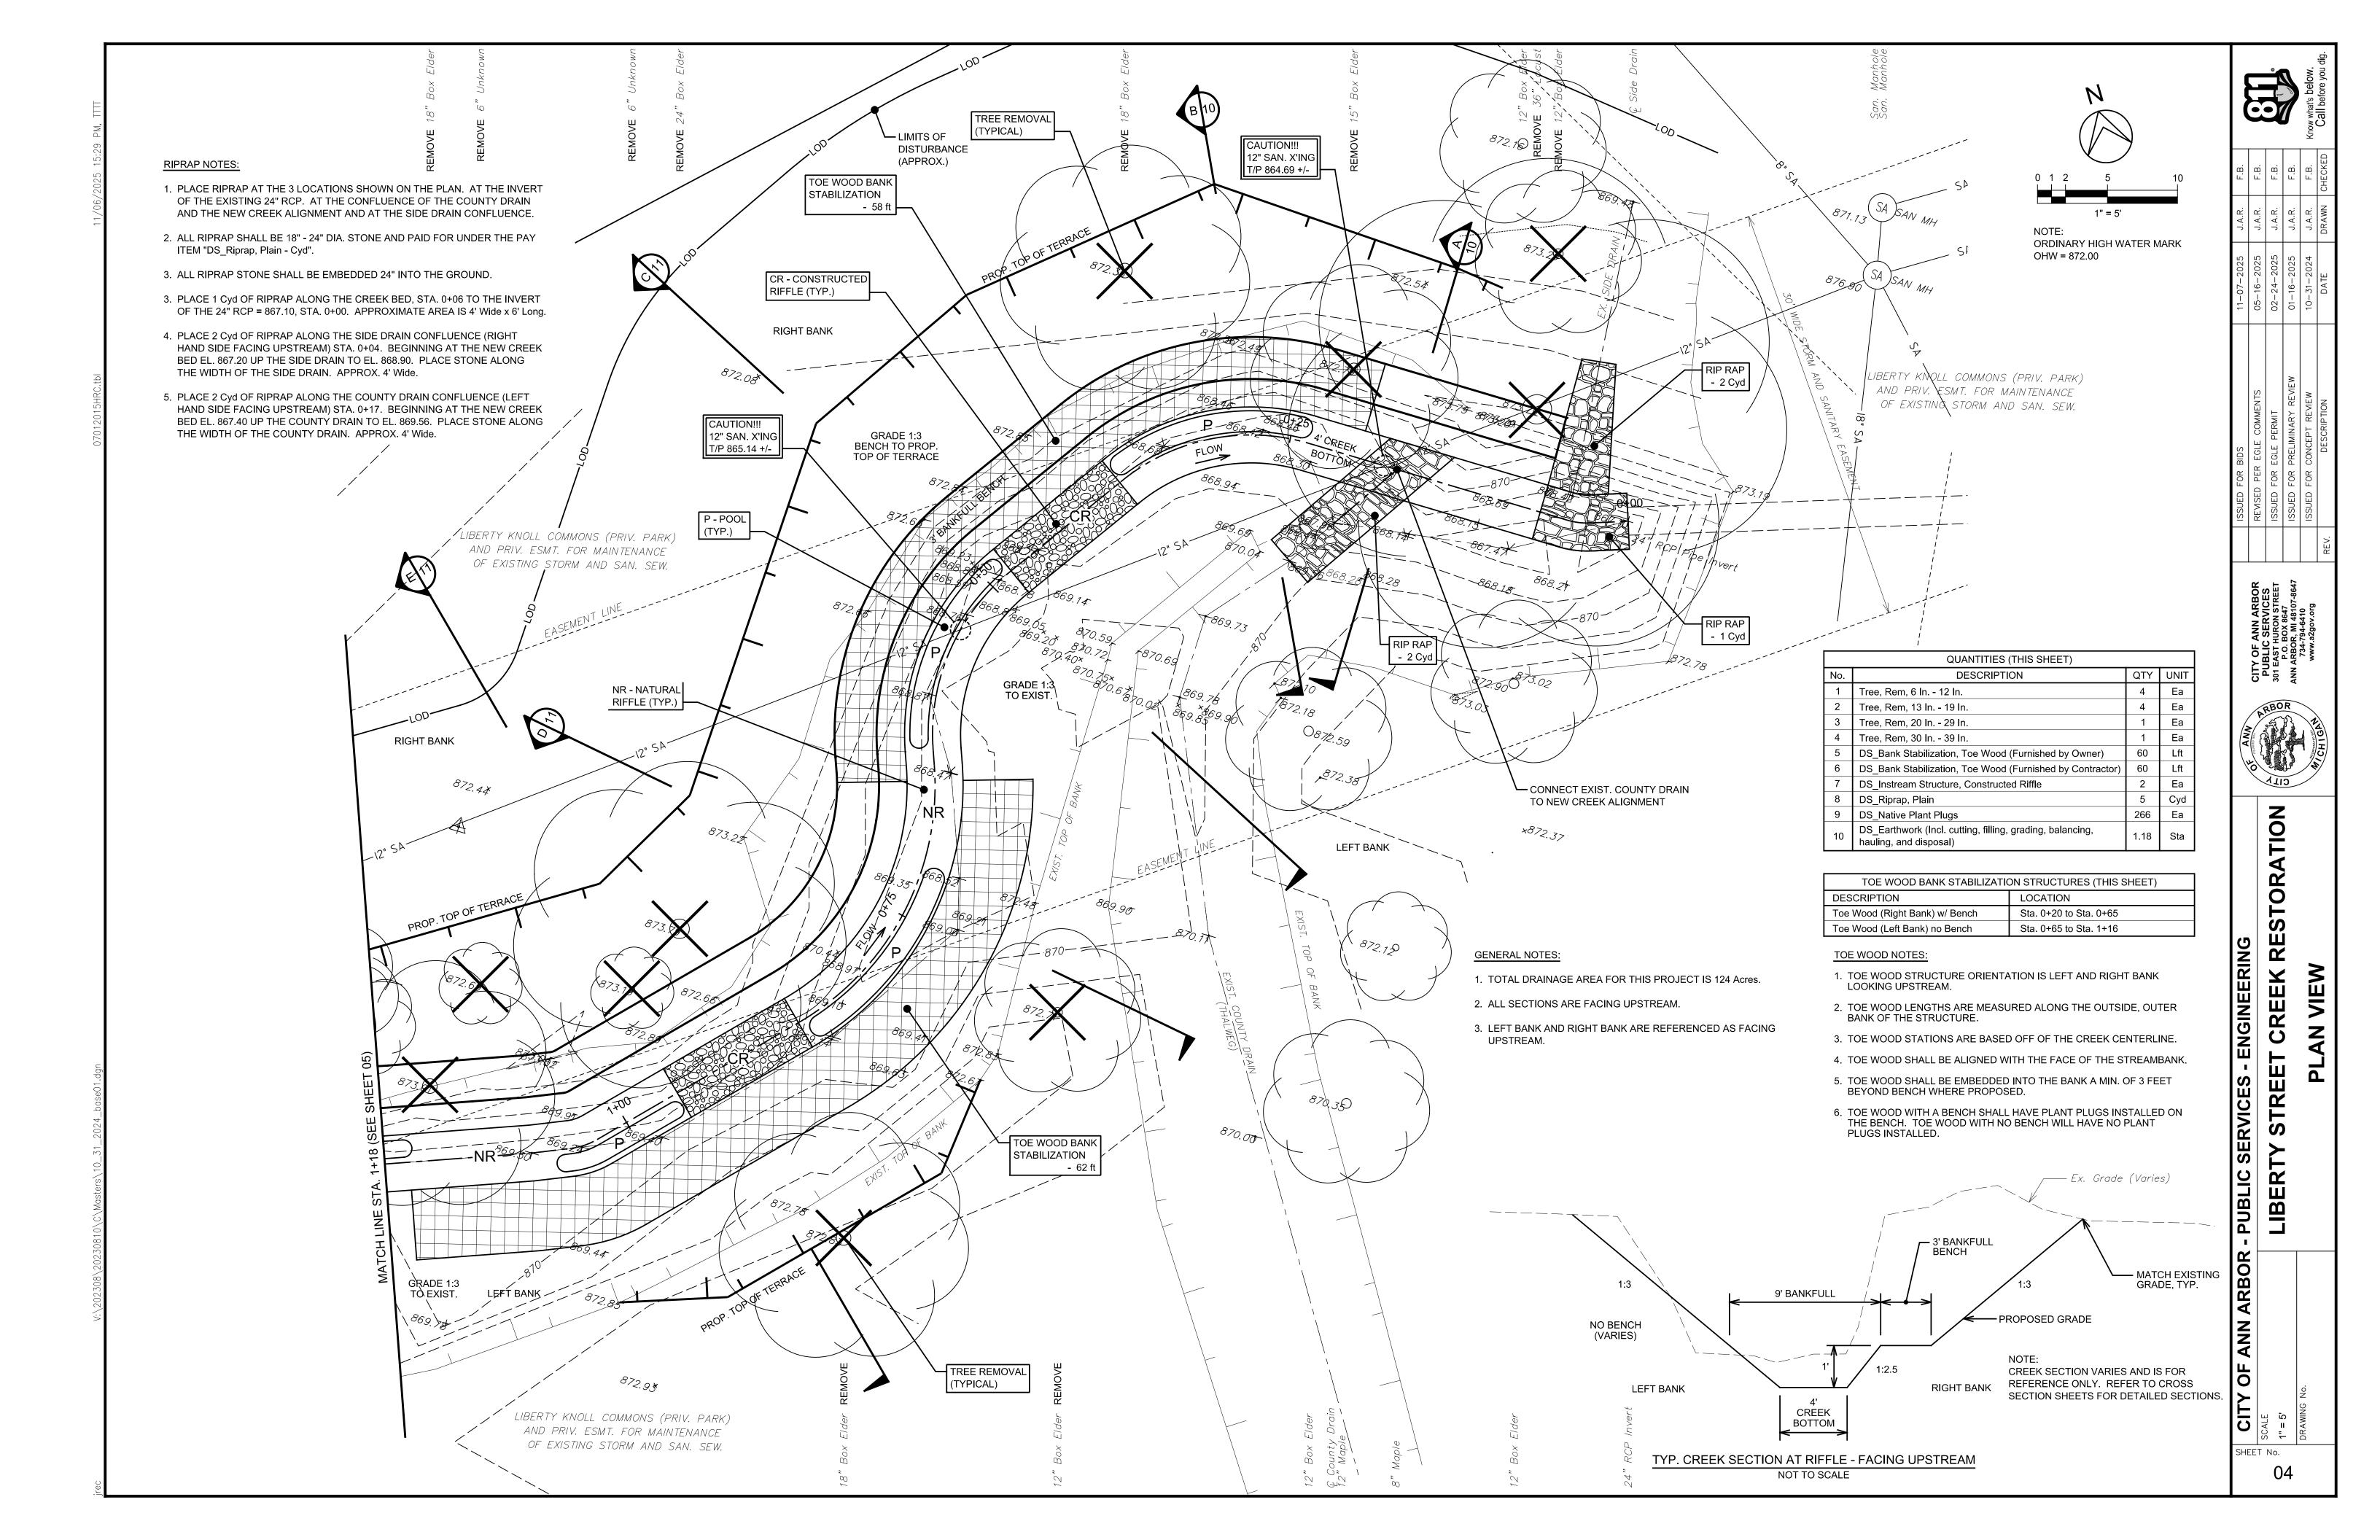


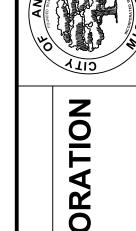
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SHEET No.





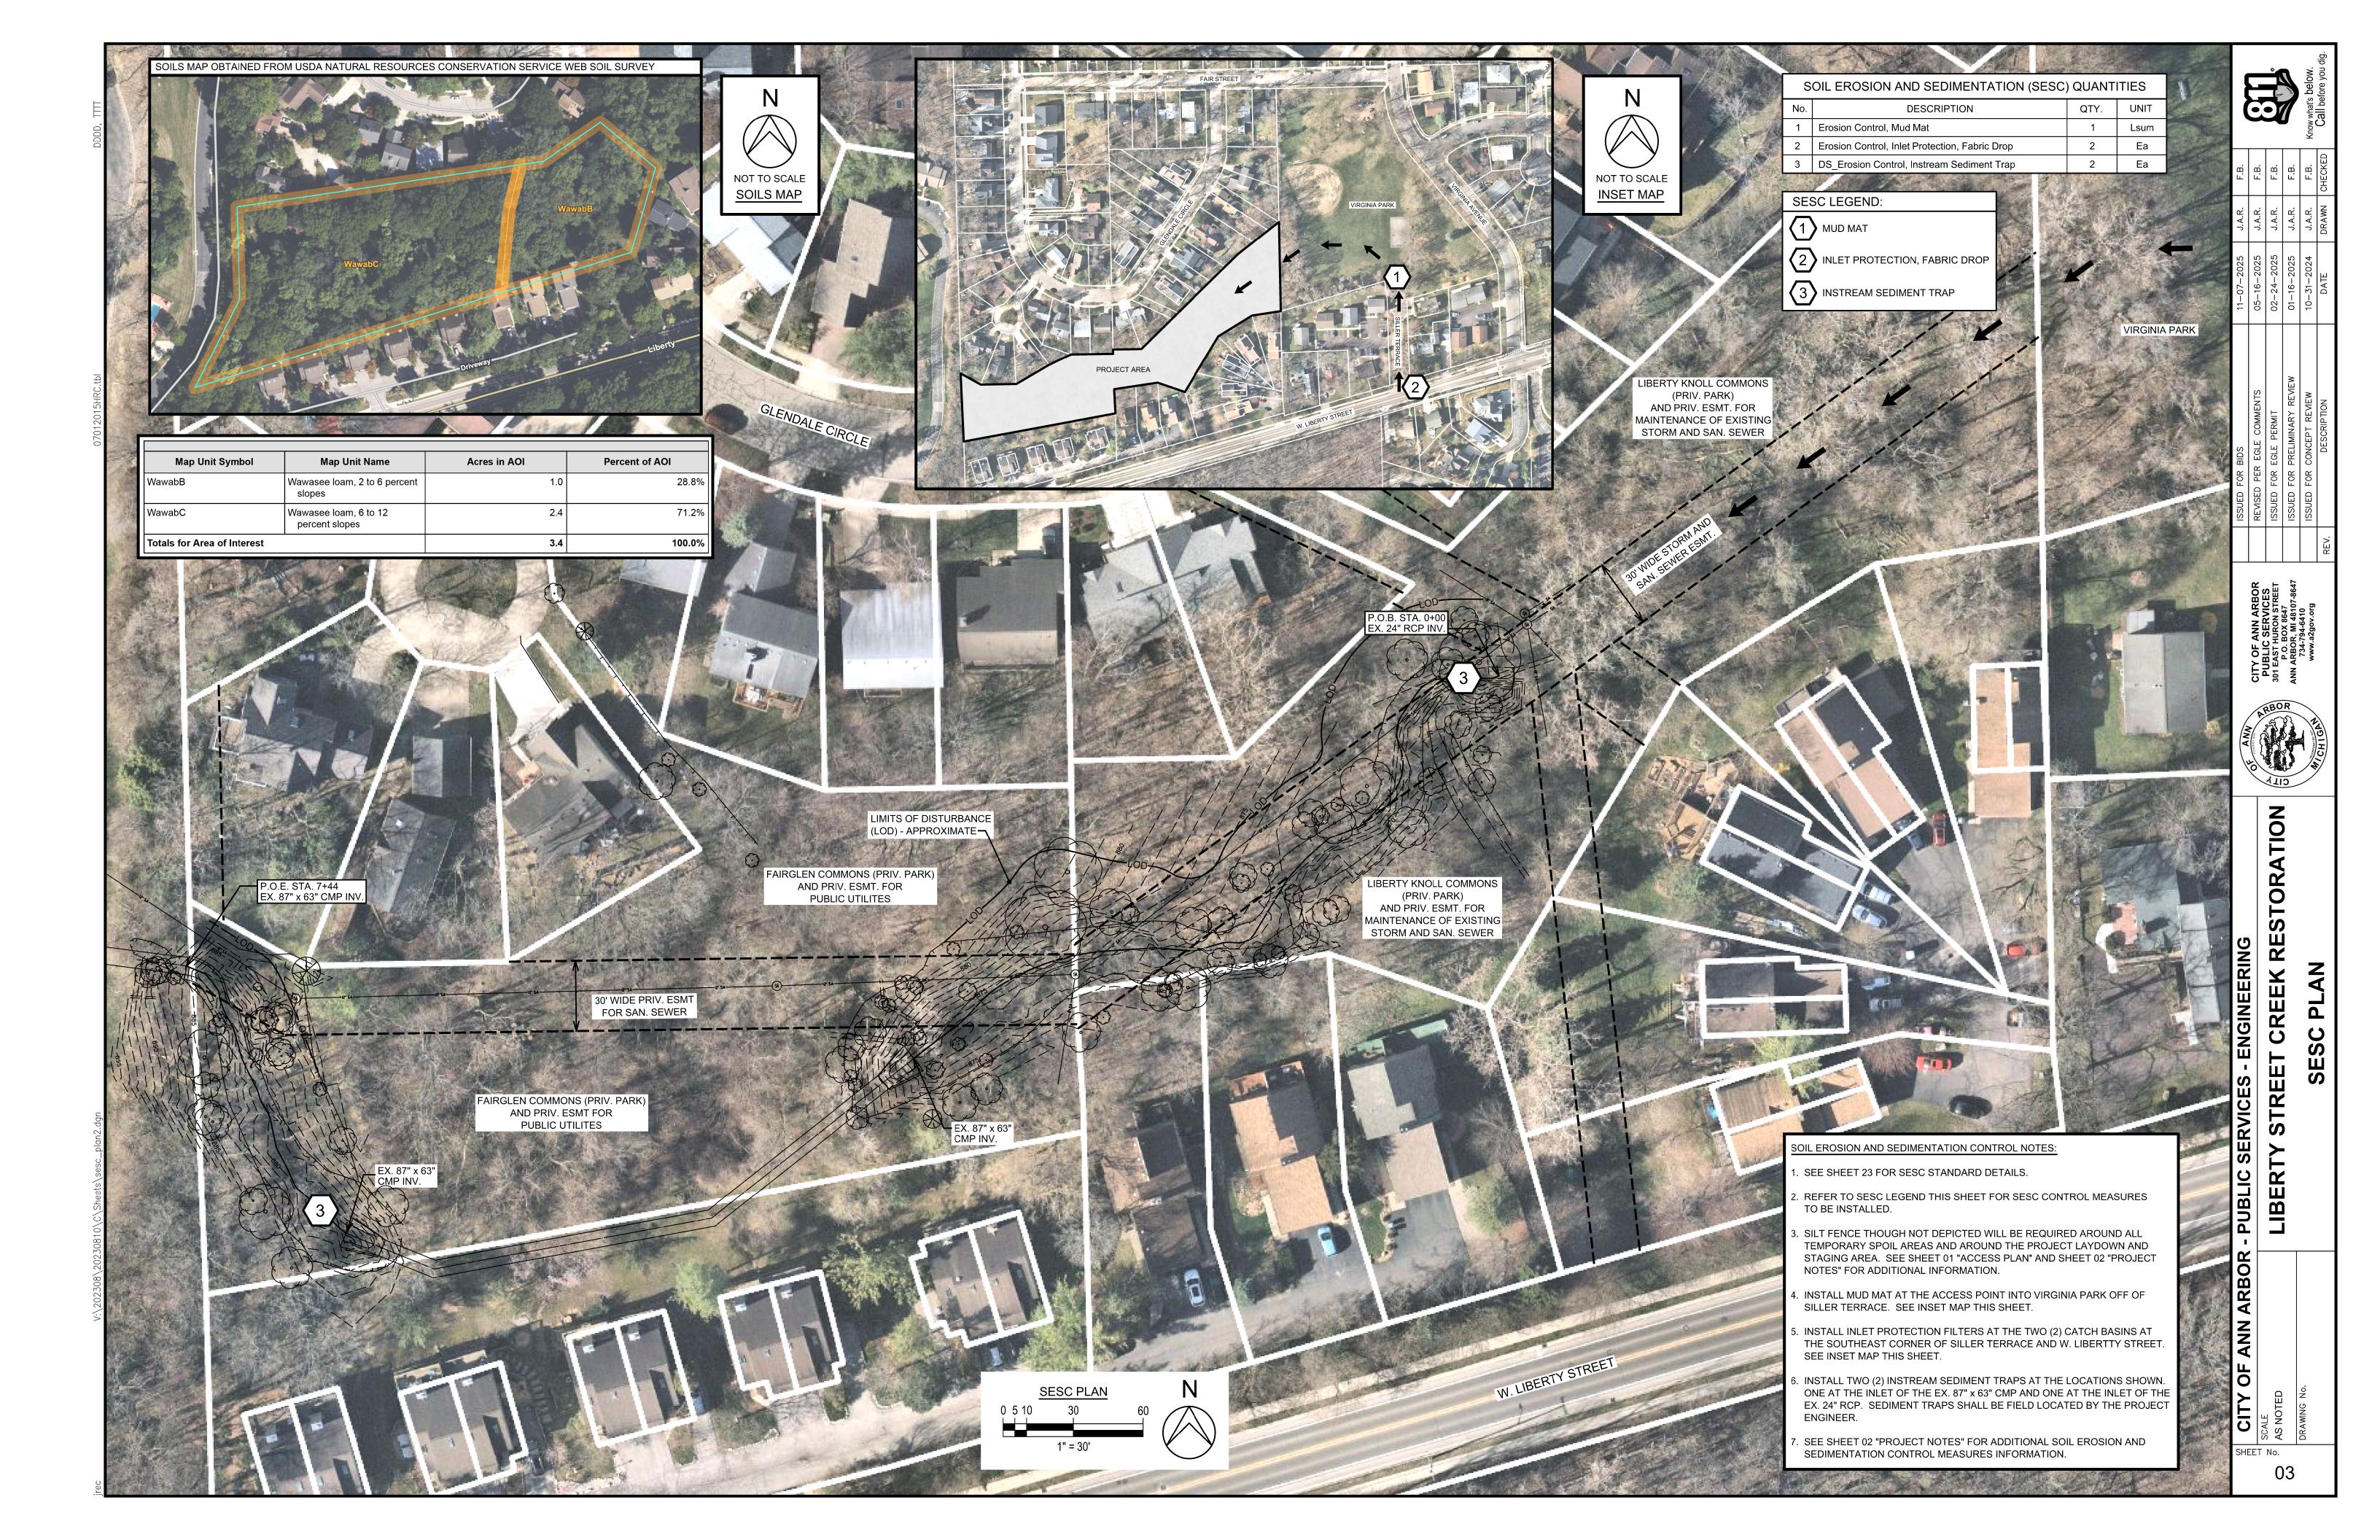

	QUANTITIES (THIS SHEET)		
No.	DESCRIPTION	QTY	UNIT
1	Tree, Rem, 6 In 12 In.	10	Ea
2	Tree, Rem, 13 In 19 In.	1	Ea
3	DS_Bank Stabilization, Toe Wood (Furnished by Owner)	29	Lft
4	DS_Bank Stabilization, Toe Wood (Furnished by Contractor)	29	Lft
5	DS_Instream Structure, Constructed Riffle	3	Ea
6	DS_Native Plant Plugs	238	Ea
7	DS_Earthwork (Incl. cutting, filling, grading, balancing, hauling, and disposal)	1.03	Sta

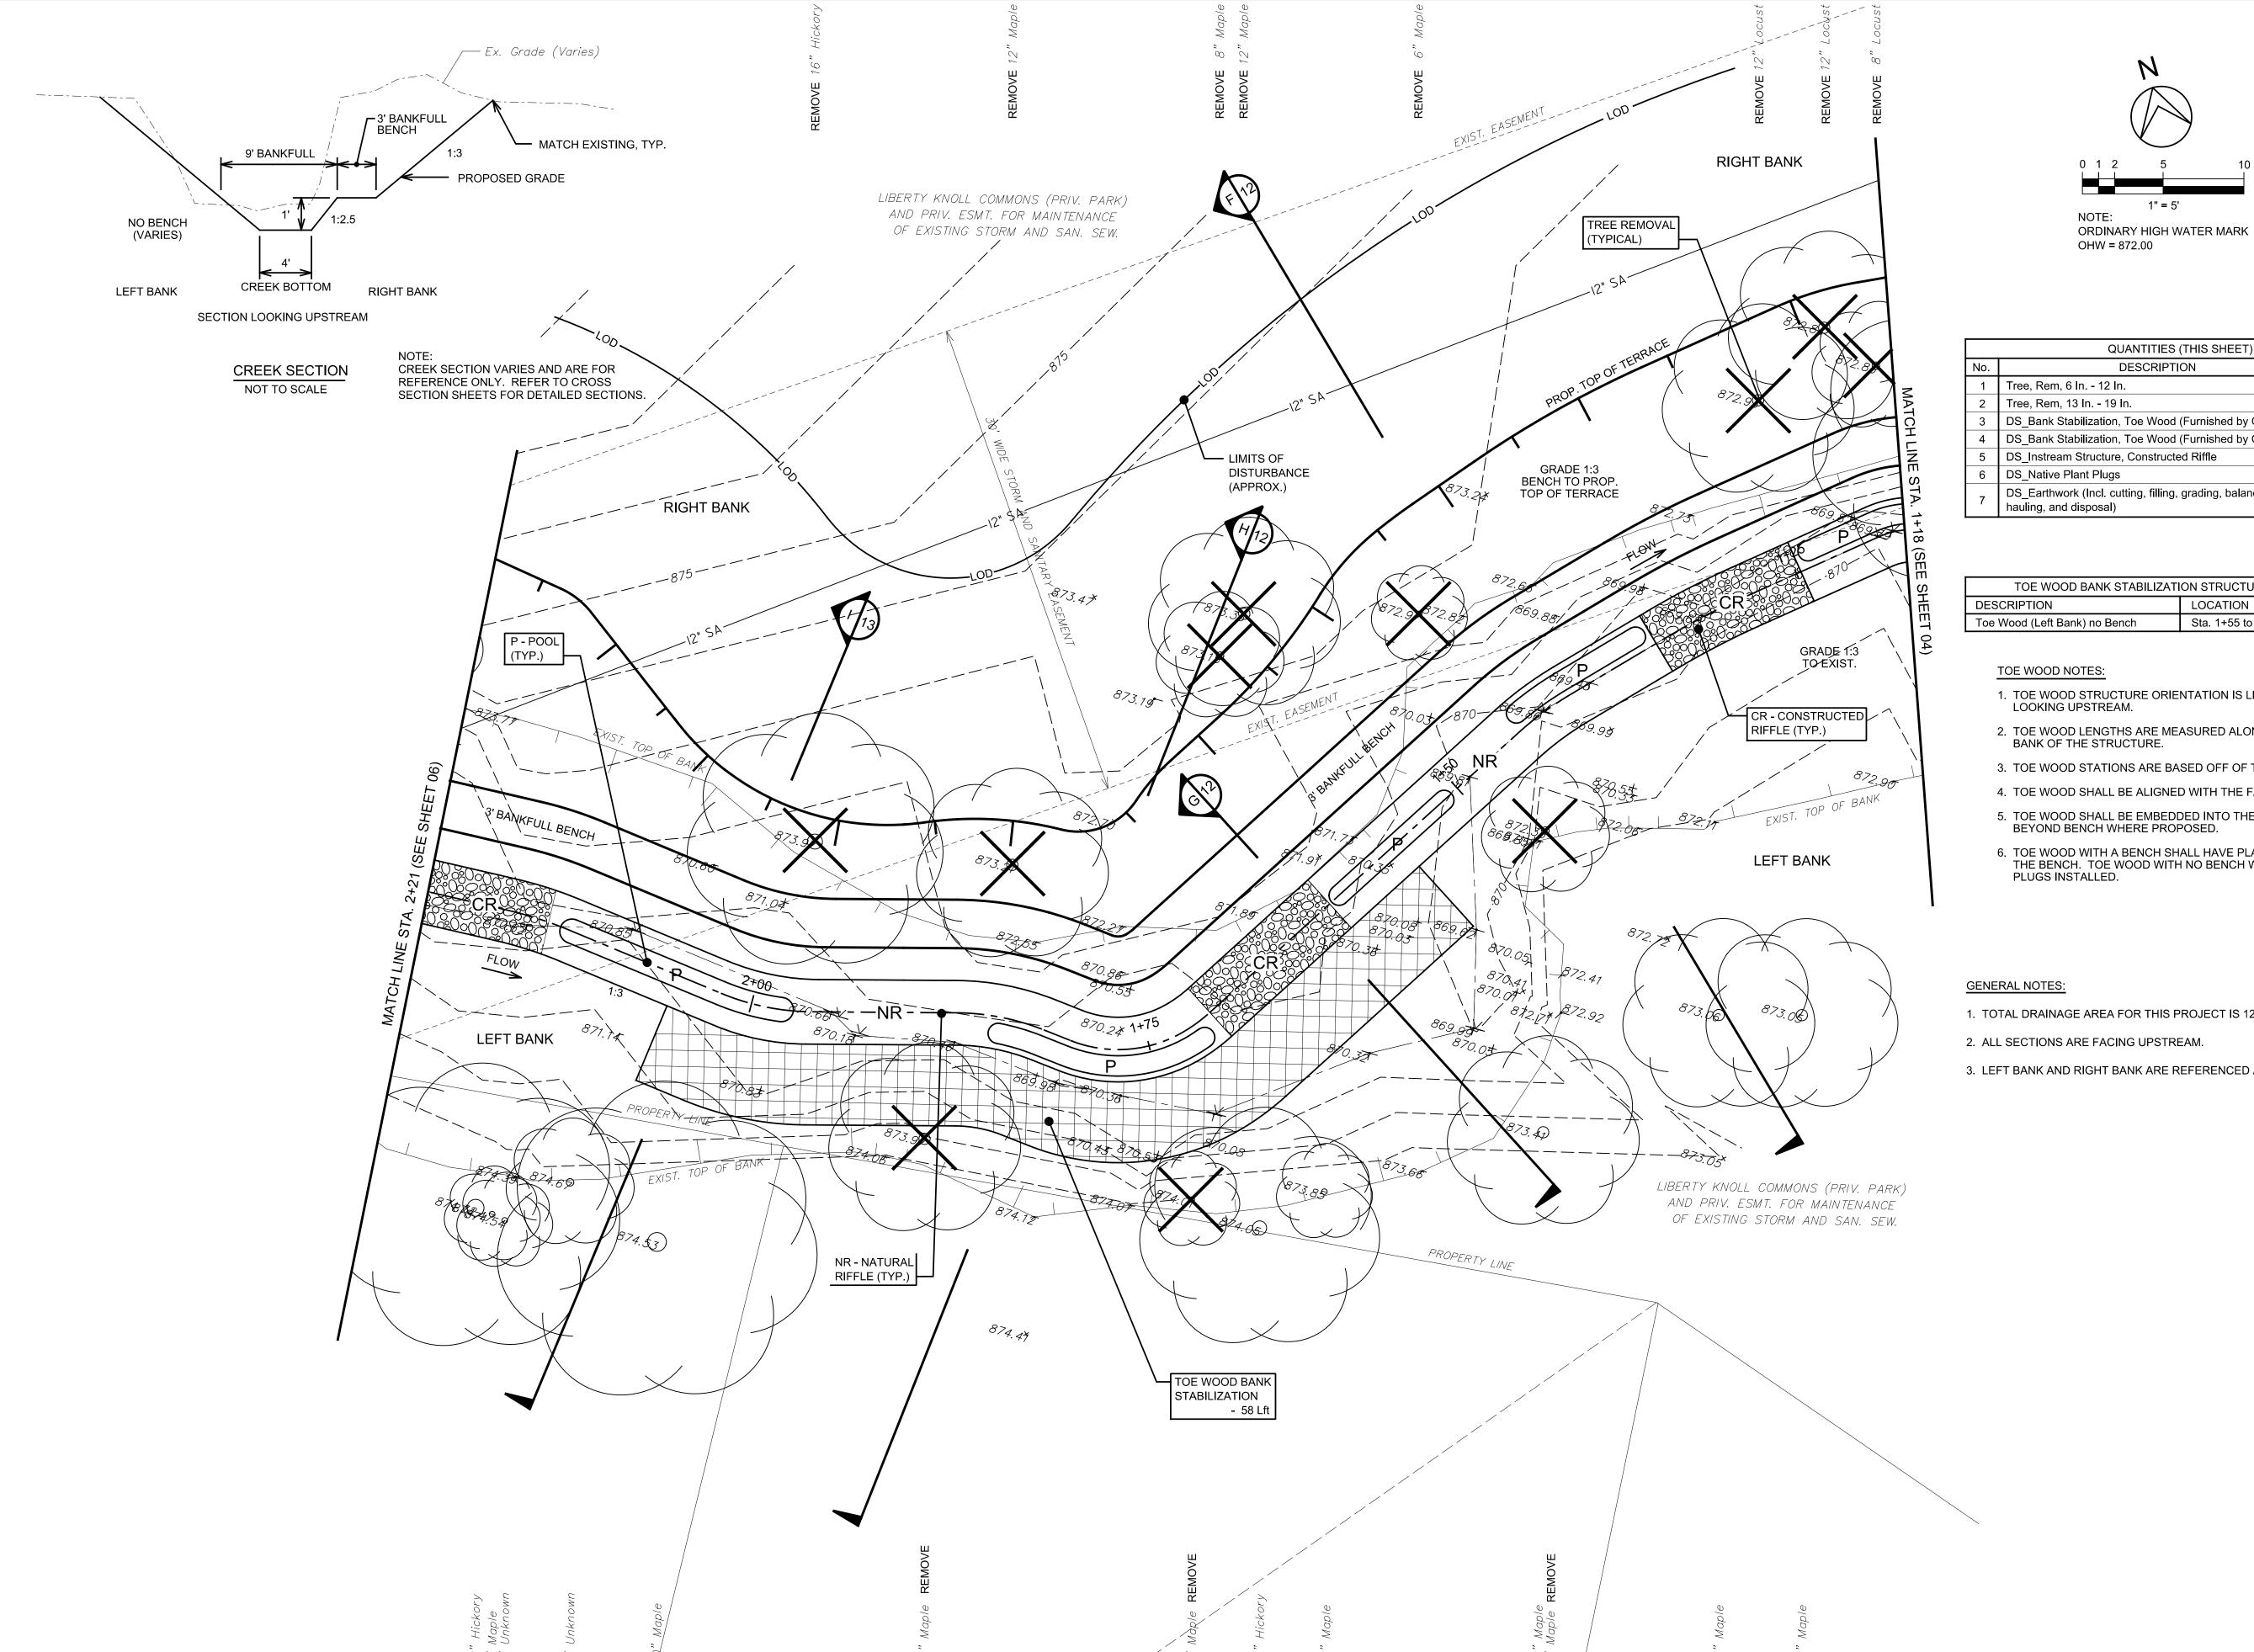TOE WOOD BANK STABILIZATI	ON STRUCTURES (THIS SHEET)
DESCRIPTION	LOCATION
Toe Wood (Left Bank) no Bench	Sta. 1+55 to Sta. 2+05

- 1. TOE WOOD STRUCTURE ORIENTATION IS LEFT AND RIGHT BANK
- 2. TOE WOOD LENGTHS ARE MEASURED ALONG THE OUTSIDE, OUTER
- 3. TOE WOOD STATIONS ARE BASED OFF OF THE CREEK CENTERLINE.
- 4. TOE WOOD SHALL BE ALIGNED WITH THE FACE OF THE STREAMBANK.
- 5. TOE WOOD SHALL BE EMBEDDED INTO THE BANK A MIN. OF 3 FEET
- 6. TOE WOOD WITH A BENCH SHALL HAVE PLANT PLUGS INSTALLED ON THE BENCH. TOE WOOD WITH NO BENCH WILL HAVE NO PLANT
- 1. TOTAL DRAINAGE AREA FOR THIS PROJECT IS 124 Acres.
- 3. LEFT BANK AND RIGHT BANK ARE REFERENCED AS FACING UPSTREAM.

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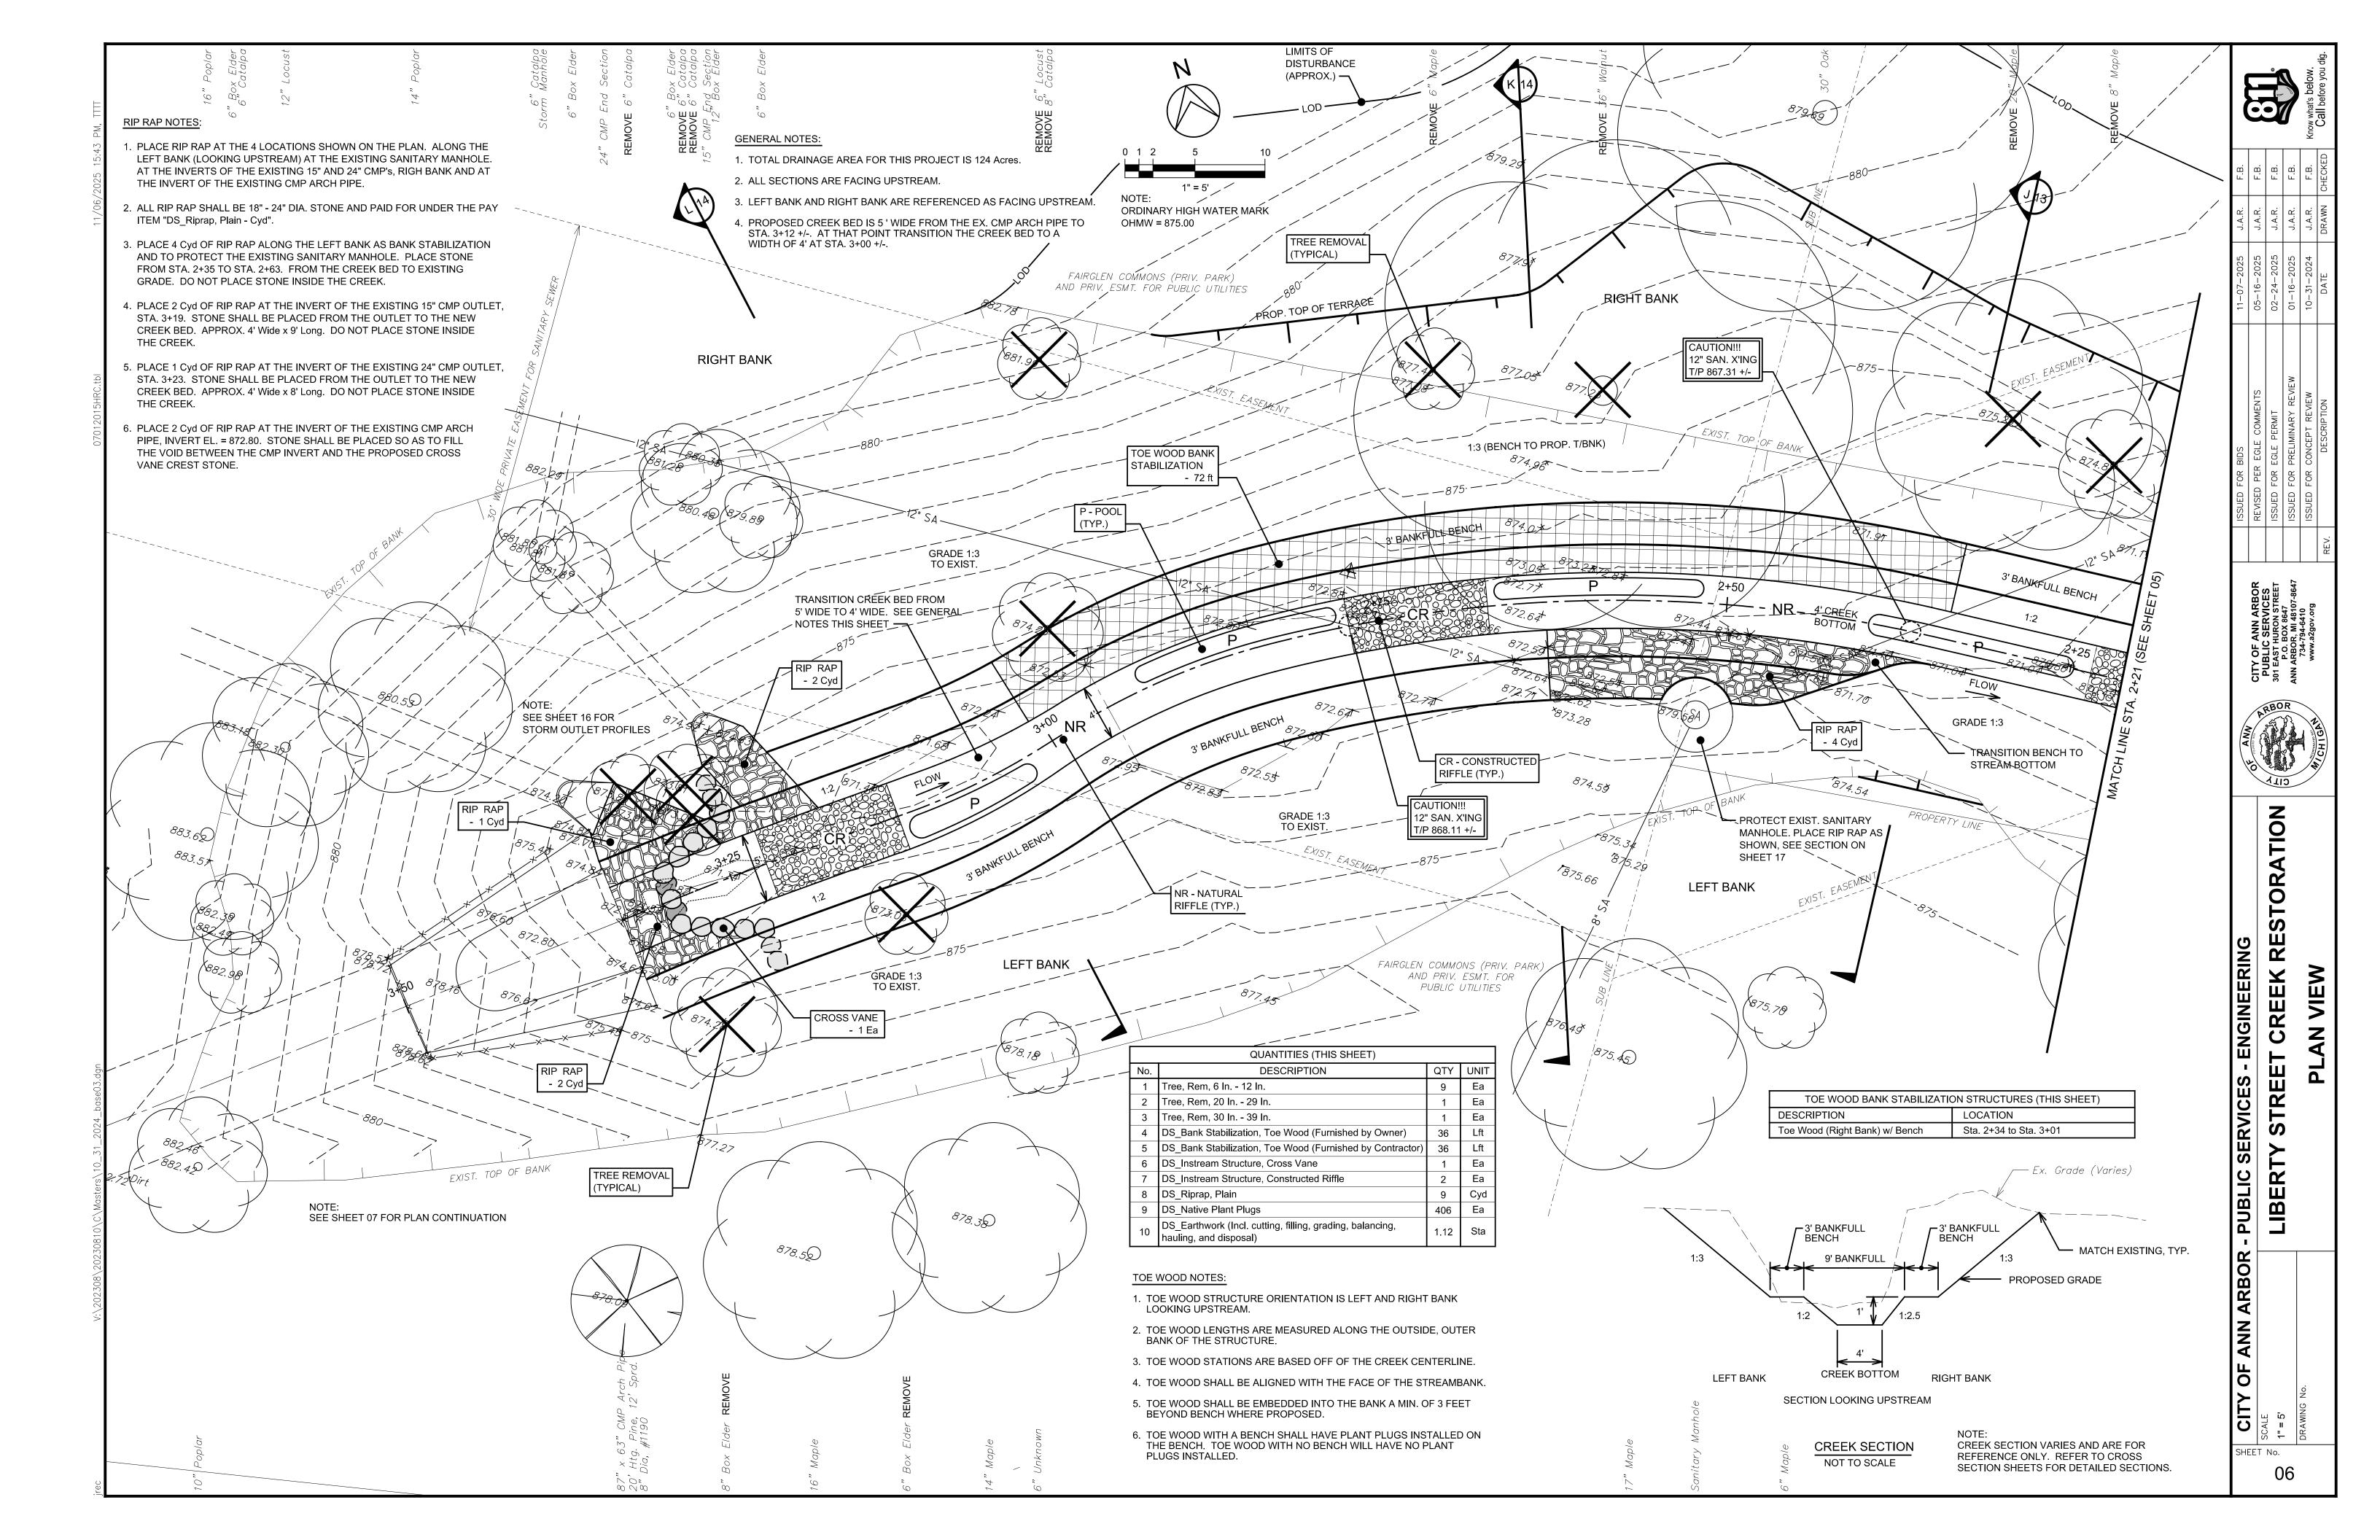



STOR STREET CREEK RE PLAN VIEW


- PUBLIC SERVICES - ENGINEERING LIBERTY

CITY OF ANN ARBOR - SCALE 1" = 5'

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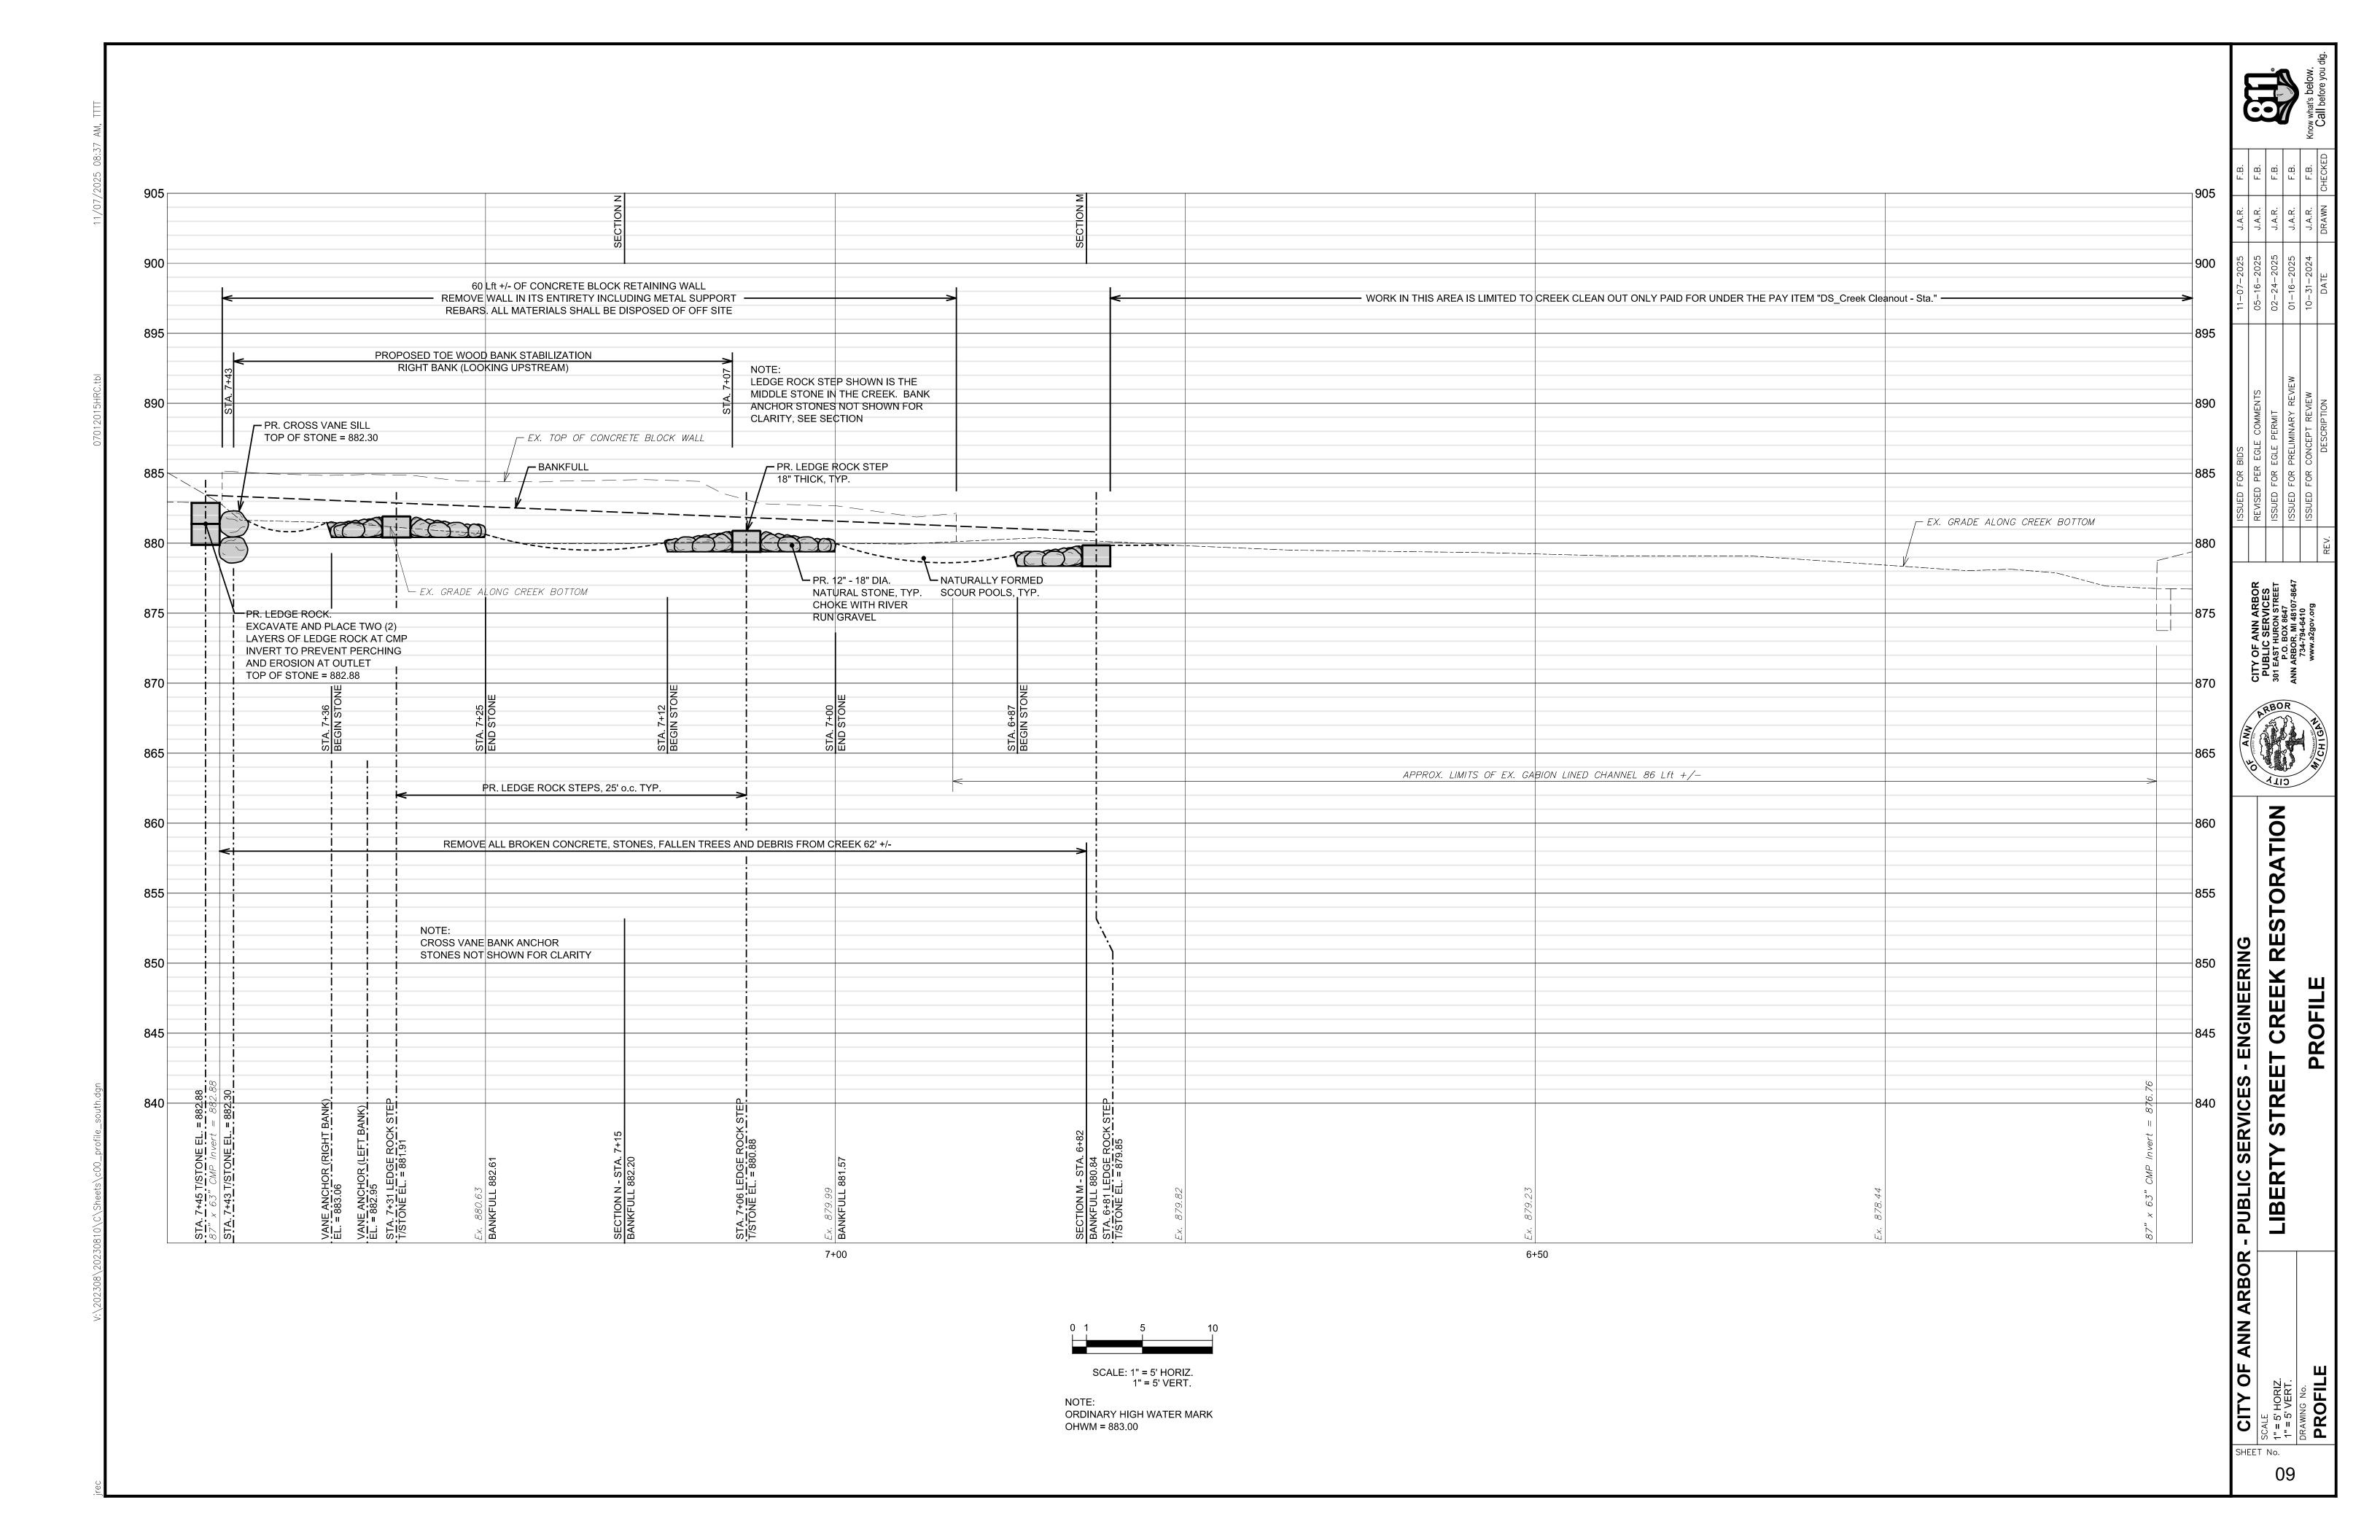


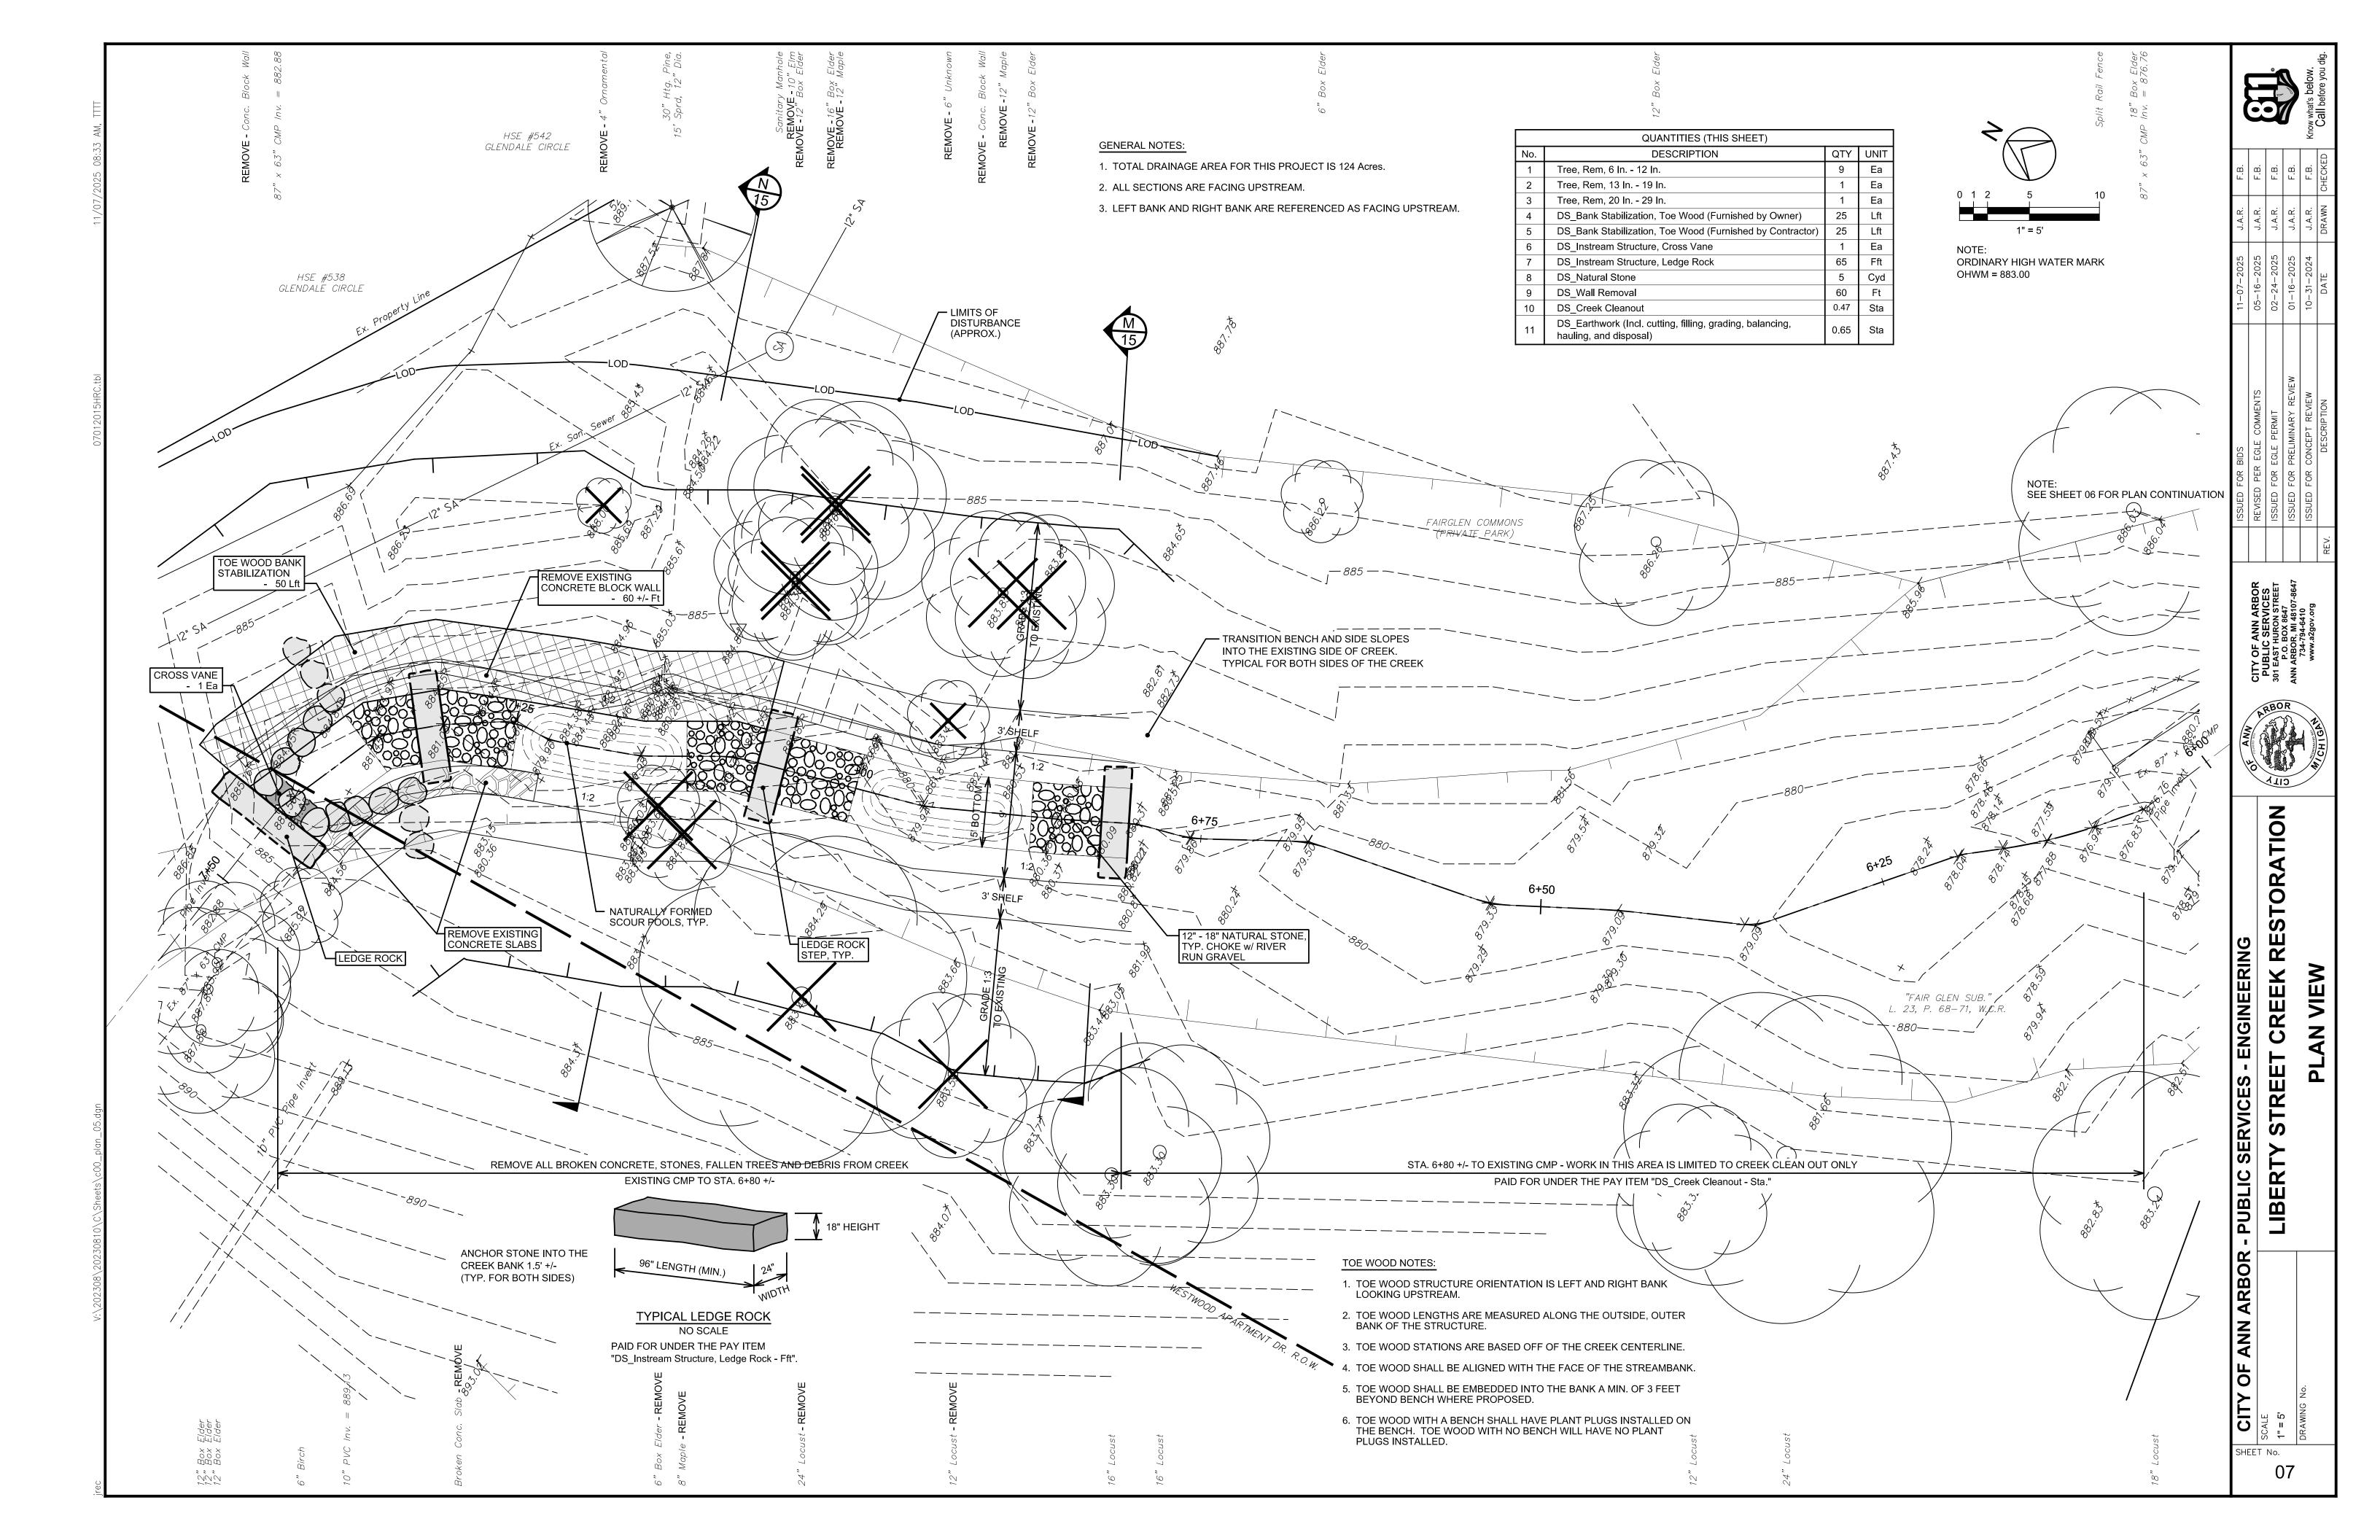

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	F.B.	J.A.R.	11-07-2025	

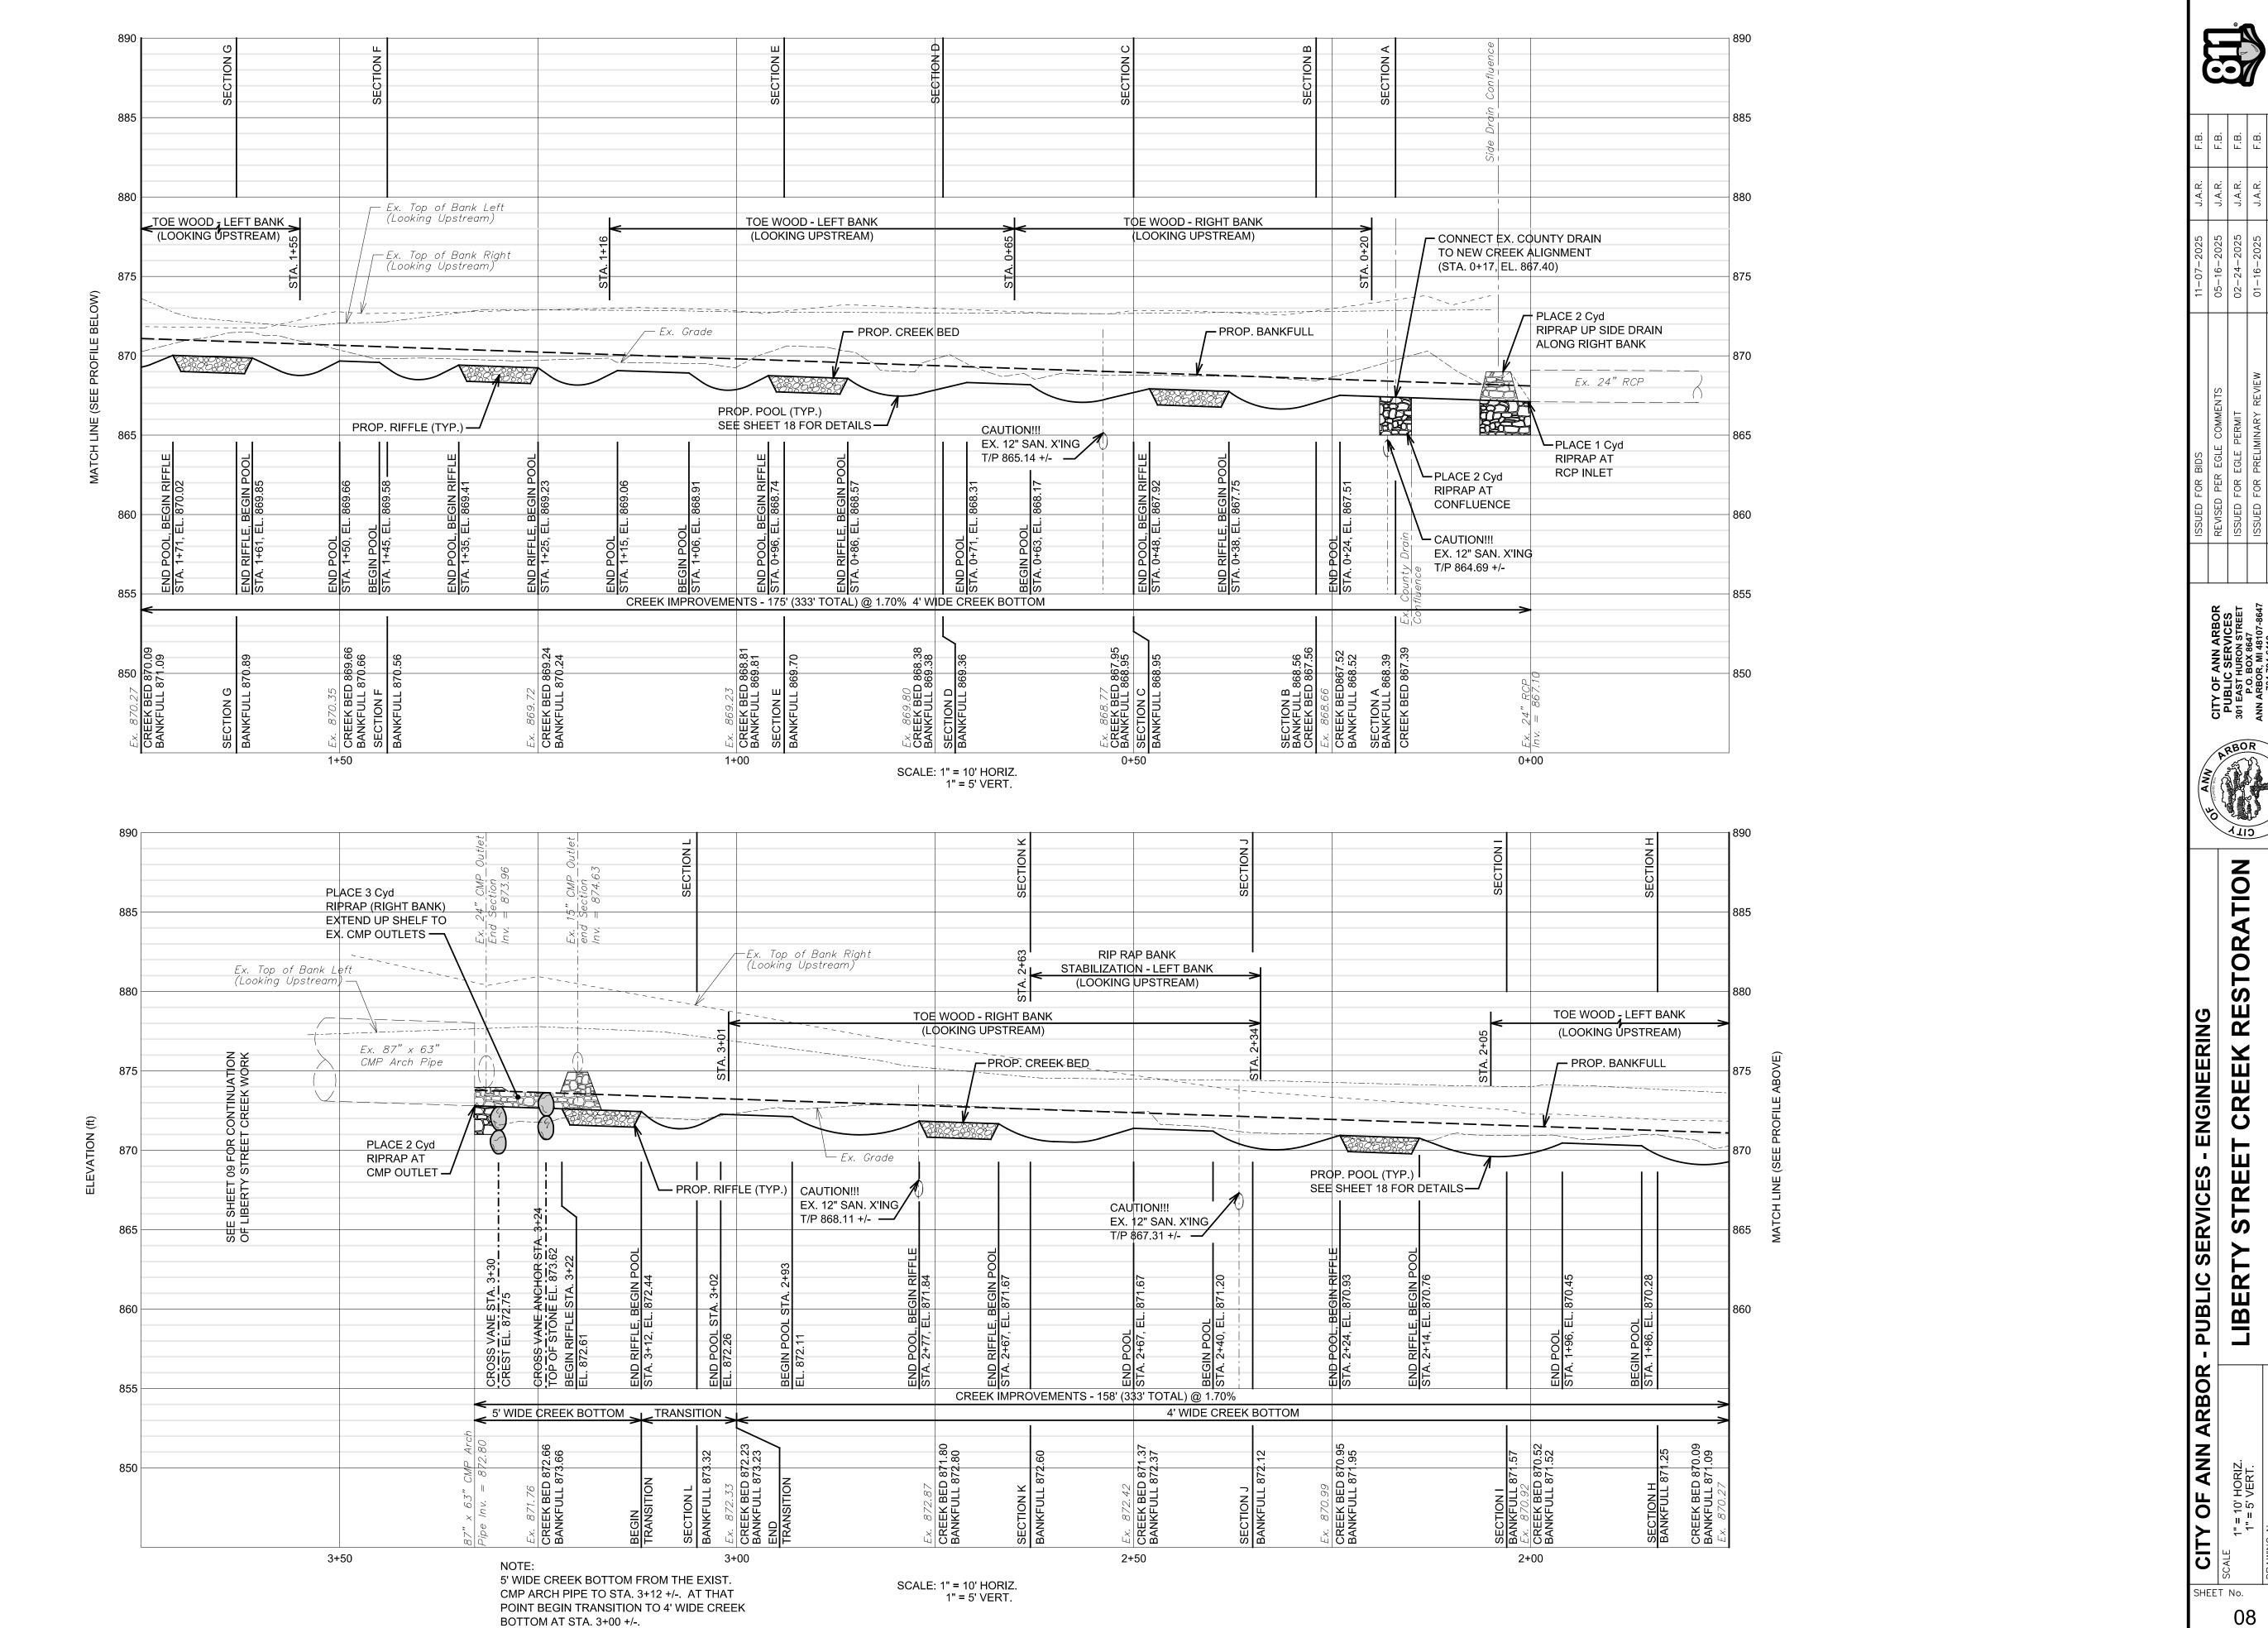UED FOR BIDS	11-07-2025	J.A.R.	F.E
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UED FOR EGLE PERMIT	02-24-2025	J.A.R.	F.E
UED FOR PRELIMINARY REVIEW	01-16-2025	J.A.R.	F.E
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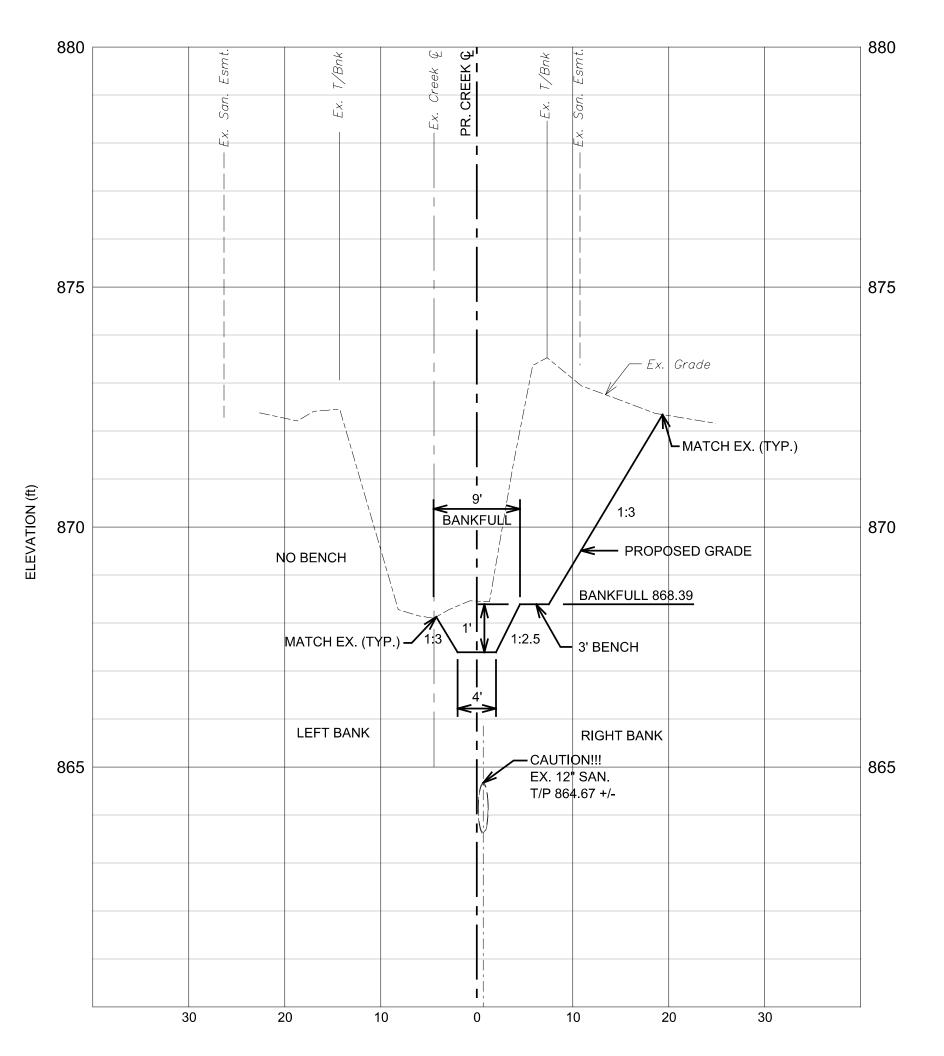
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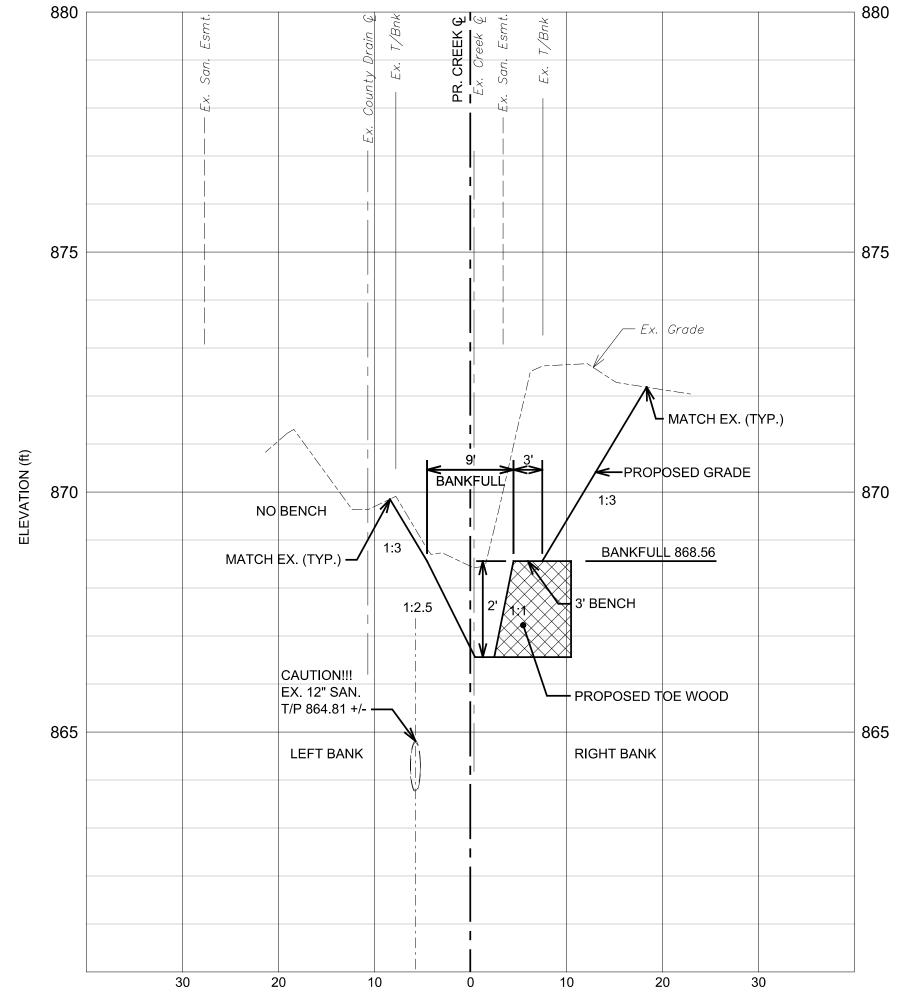
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SHEET No.

SEEDING AND STABILIZATION NOTES:

- 1. ALL PROPOSED BANKS SHALL BE SEEDED WITH NATIVE SEED MIX (AS DIRECTED) AND STABILIZED WITH TURF REINFORCEMENT BLANKETS.
- 2. ALL PROPOSED BANKFULL SHELVES SHALL BE SEEDED WITH BANKFULL BENCH SEED MIX (AS DIRECTED) AND STABILIZED WITH TURF REINFORCEMENT BLANKETS.
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- 3. REFER TO THE PROJECT SPECIFICATIONS FOR DETAILED SPECIES, PROPORTIONS AND APPLICATION RATES OF THE SEED MIXES.





TOE WOOD NOTES:

- TOE WOOD SHALL BE ALIGNED WITH THE FACE OF THE STREAMBANK.
- EMBED TOEWOOD INTO THE BANK A MIN. OF 3 FEET BEYOND BENCH WHERE PROPOSED. 3. TOE WOOD WITH A BENCH SHALL HAVE PLANT PLUGS INSTALLED ON THE BENCH. TOE WOOD WITH NO BENCH

WILL HAVE NO PLANT PLUGS INSTALLED.

DISTANCE (ft)

CREEK SECTION SCALE: 1" = 10' HORIZ. 1" = 2' VERT. STA. NOTE:

ORDINARY HIGH WATER MARK OHWM = 872.00

CREEK SECTION SCALE: 1" = 10' HORIZ. 1" = 2' VERT. STA. 0+27


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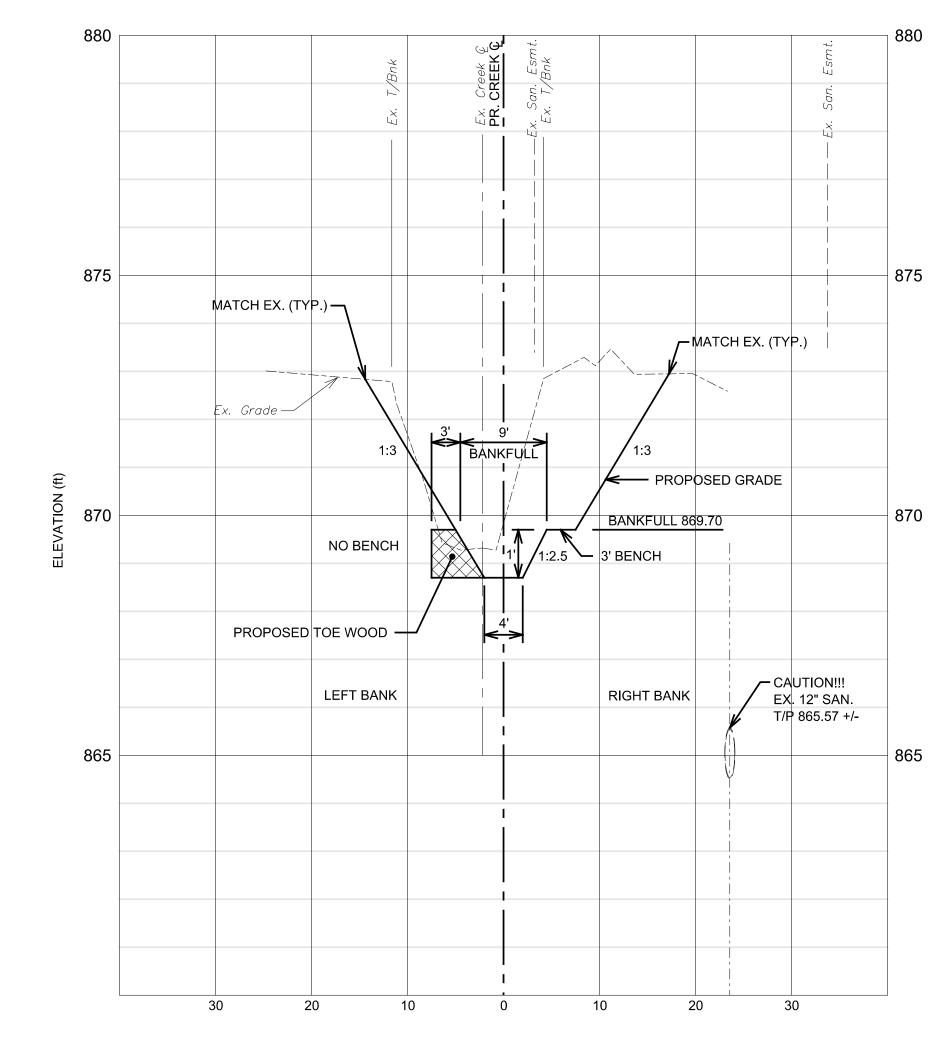
ALL SECTIONS ARE LOOKING UPSTREAM.

0+17 ALL SECTIONS ARE LOOKING UPSTREAM.

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CREEK SECTION C

SCALE: 1" = 10' HORIZ.
1" = 2' VERT.

STA.
0+50

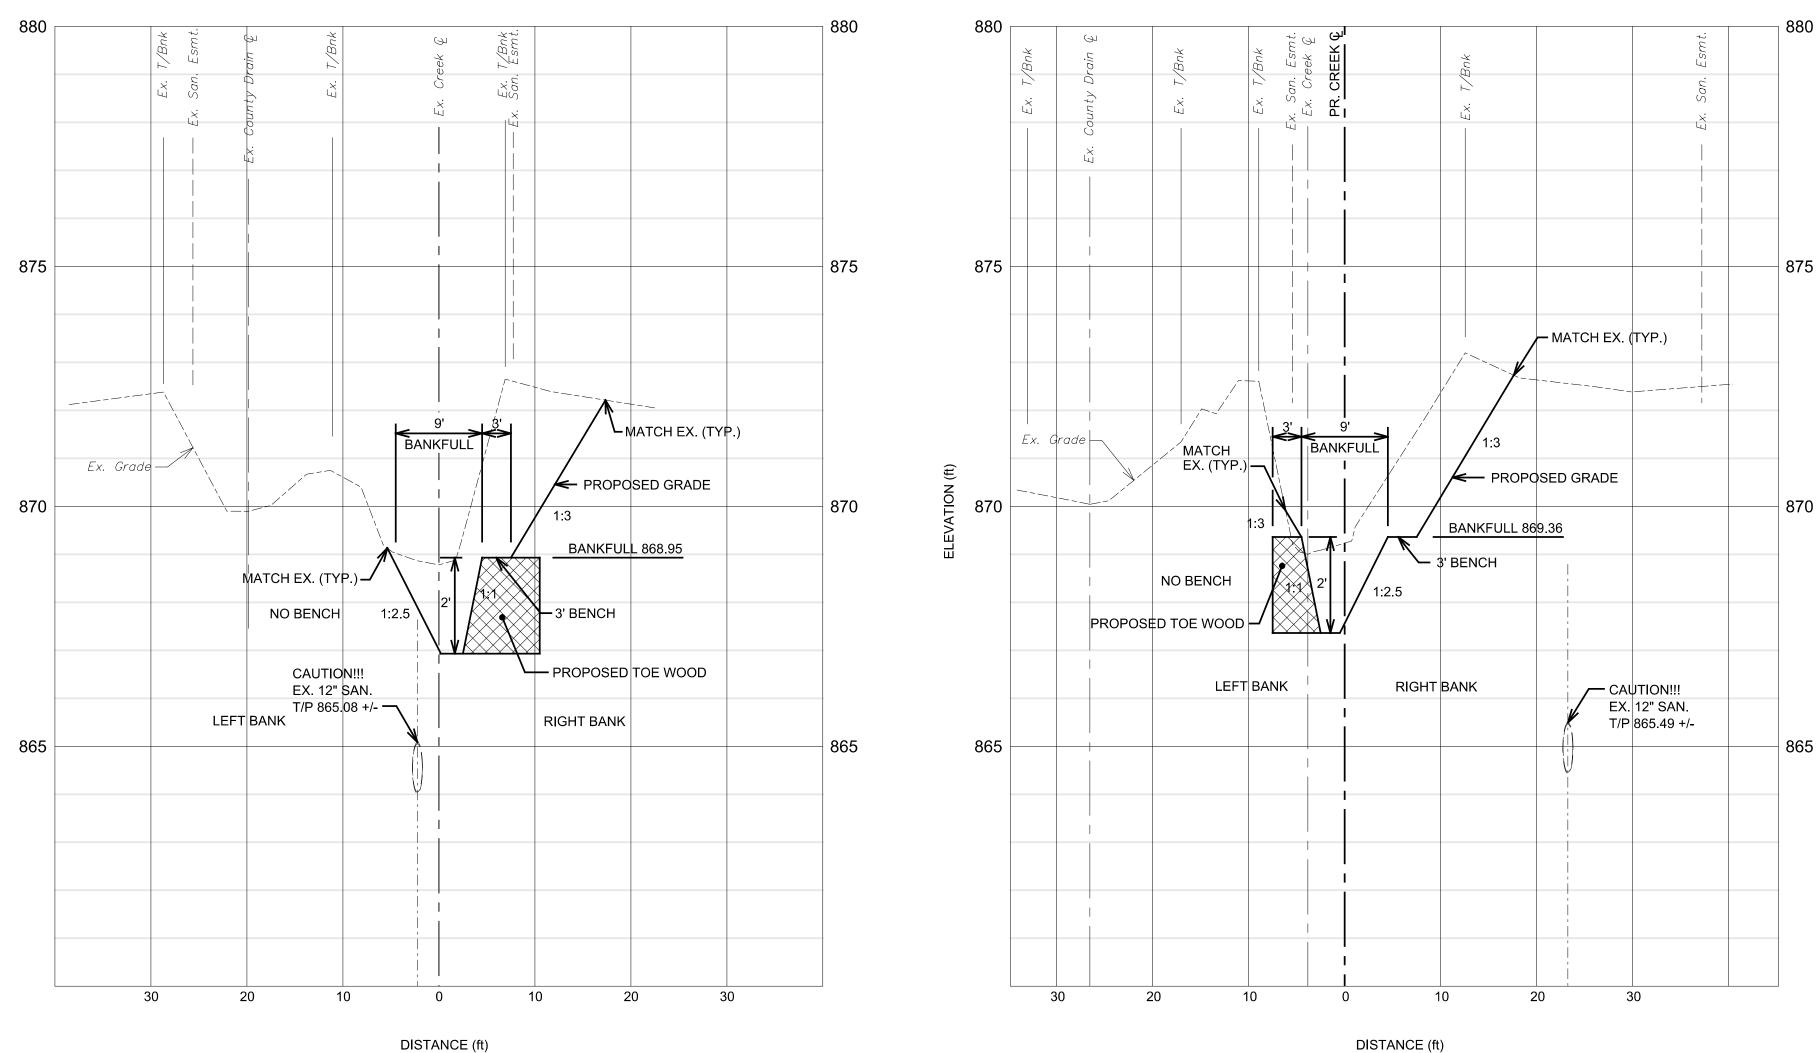ALL SECTIONS ARE LOOKING UPSTREAM.

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CREEK SECTION D

SCALE: 1" = 10' HORIZ.
1" = 2' VERT.

STA.
0+74

NOTE: ALL SECTIONS ARE LOOKING UPSTREAM.

NOTE: ORDINARY HIGH WATER MARK OHWM = 872.00 CREEK SECTION E

SCALE: 1" = 10' HORIZ.
1" = 2' VERT.

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0+94

NOTE: ALL SECTIONS ARE LOOKING UPSTREAM.

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A OF ANN ARBOR - PUBLIC SERVICES - ENGINEERING

CITY OF ANN ARBOR

SCALE

1" = 10' HORIZ.

1" = 2' VERT.

DRAWING No.

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STREET CREEK RE

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	F.B.	J.A.R.	05-16-2025
	F.B.	J.A.R.	11-07-2025

	11-07-2025	J.A.R.	F.B.
ENTS	05-16-2025	J.A.R.	F.B.
	02-24-2025	J.A.R.	F.B.
REVIEW	01-16-2025	J.A.R.	F.B.
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ISSUED FOR BIDS	11-07-2025	J.A.R.	
REVISED PER EGLE COMMENTS	05-16-2025	J.A.R.	
ISSUED FOR EGLE PERMIT	02-24-2025	J.A.R.	
ISSUED FOR PRELIMINARY REVIEW	01-16-2025	J.A.R.	
ISSUED FOR CONCEPT REVIEW	10-31-2024	J.A.R.	
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SERVICES -CRO LIBERTY

CITY OF ANN ARBOR 1" = 10' l 1" = 2'

SHEET No.

SEEDING AND STABILIZATION NOTES:


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885



885 880 MATCH EX. (TYP.) 875 875 PROPOSED GRADE Ex. Grade — BANKFULL 3' NO BENCH BANKFULL 872.12 MATCH EX. (TYP.) ►3' BENCH, TYP. 870 PROPOSED TOE WOOD LEFT BANK RIGHT BANK CAUTION!!! EX. 12" SAN. T/P 867.28 +/-865 30 20

DISTANCE (ft)

CREEK SECTION SCALE: 1" = 10' HORIZ. 1" = 2' VERT. STA.

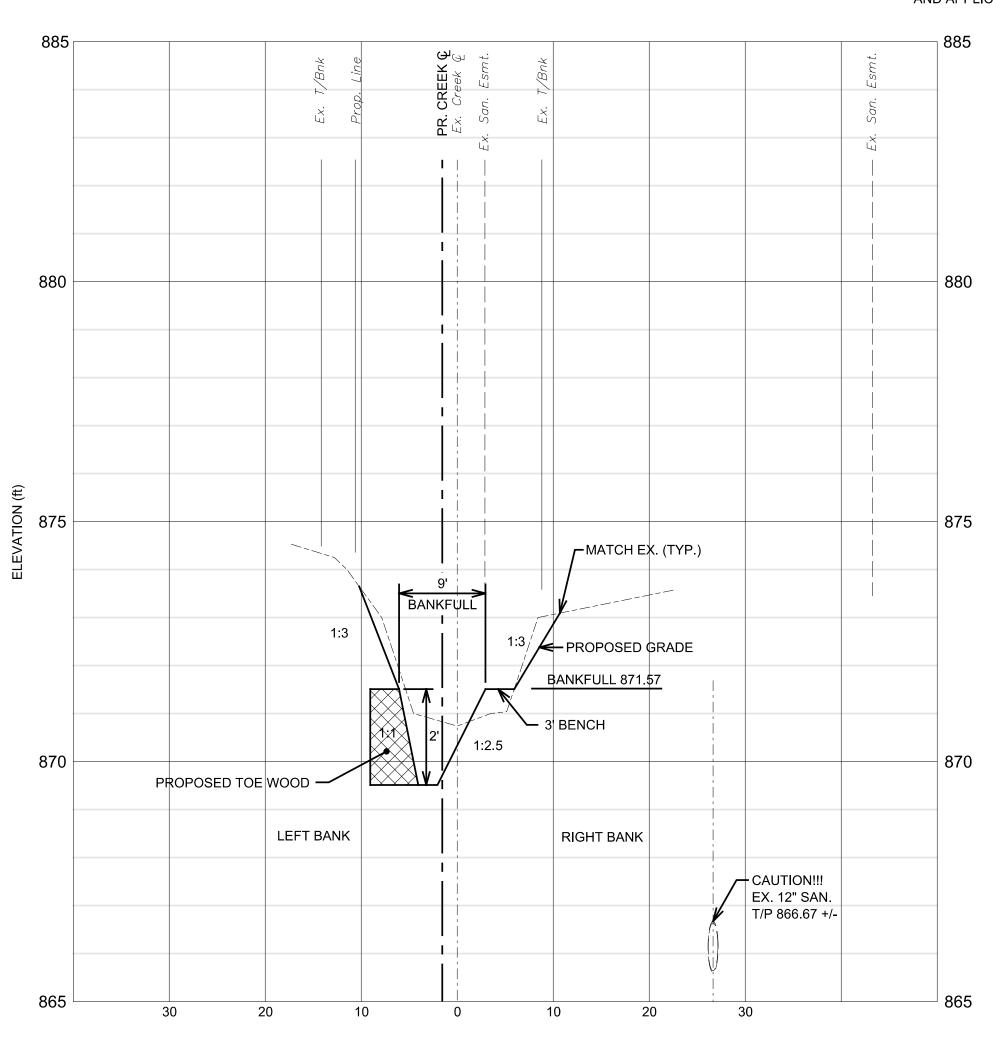2+03 ALL SECTIONS ARE LOOKING UPSTREAM.

ORDINARY HIGH WATER MARK OHWM = 872.00

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CREEK SECTION SCALE: 1" = 10' HORIZ. 1" = 2' VERT.

DISTANCE (ft)

2+35 ALL SECTIONS ARE LOOKING UPSTREAM.

> NOTE: ORDINARY HIGH WATER MARK OHWM = 875.00

SHEET No.


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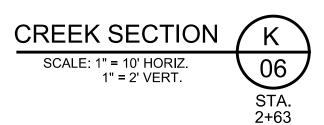
ORDINARY HIGH WATER MARK

OHWM = 875.00

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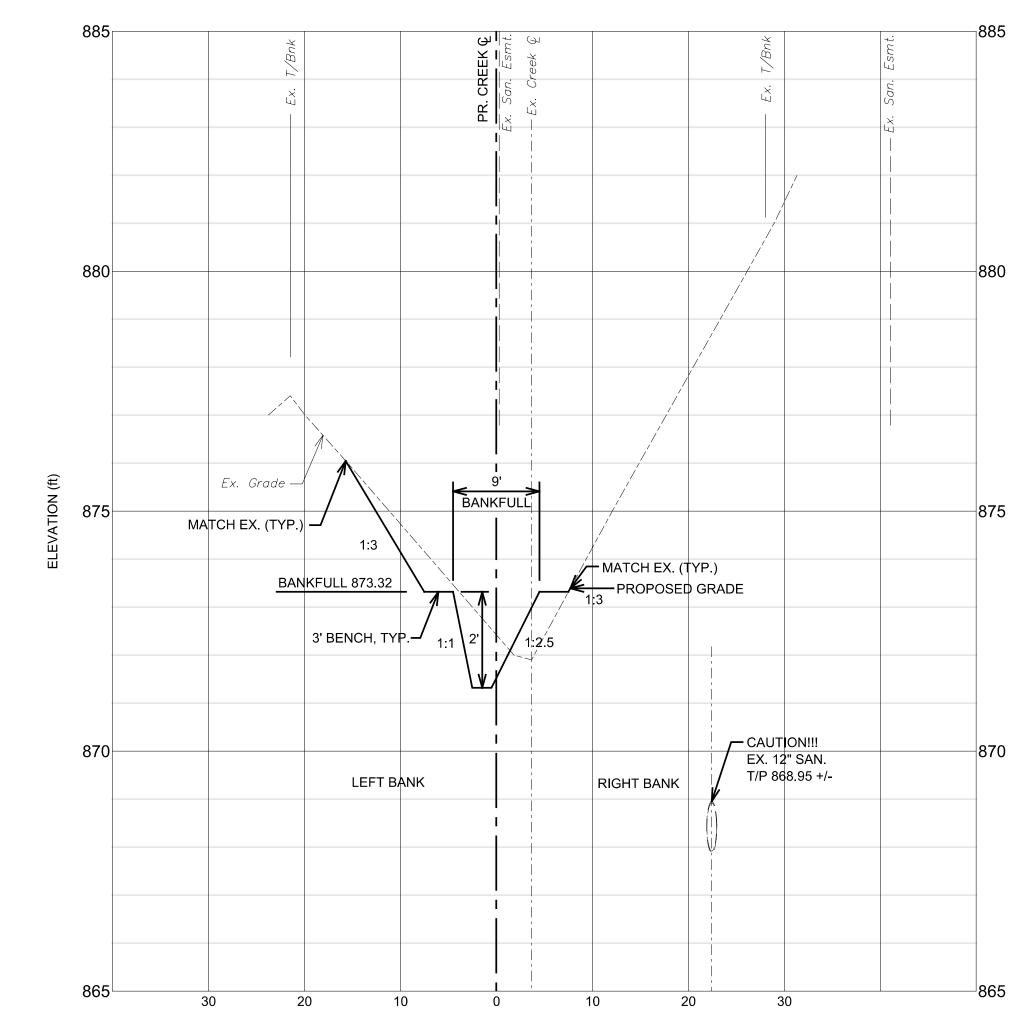


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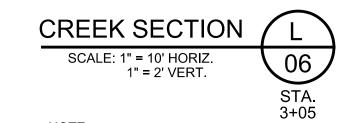


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DISTANCE (ft)

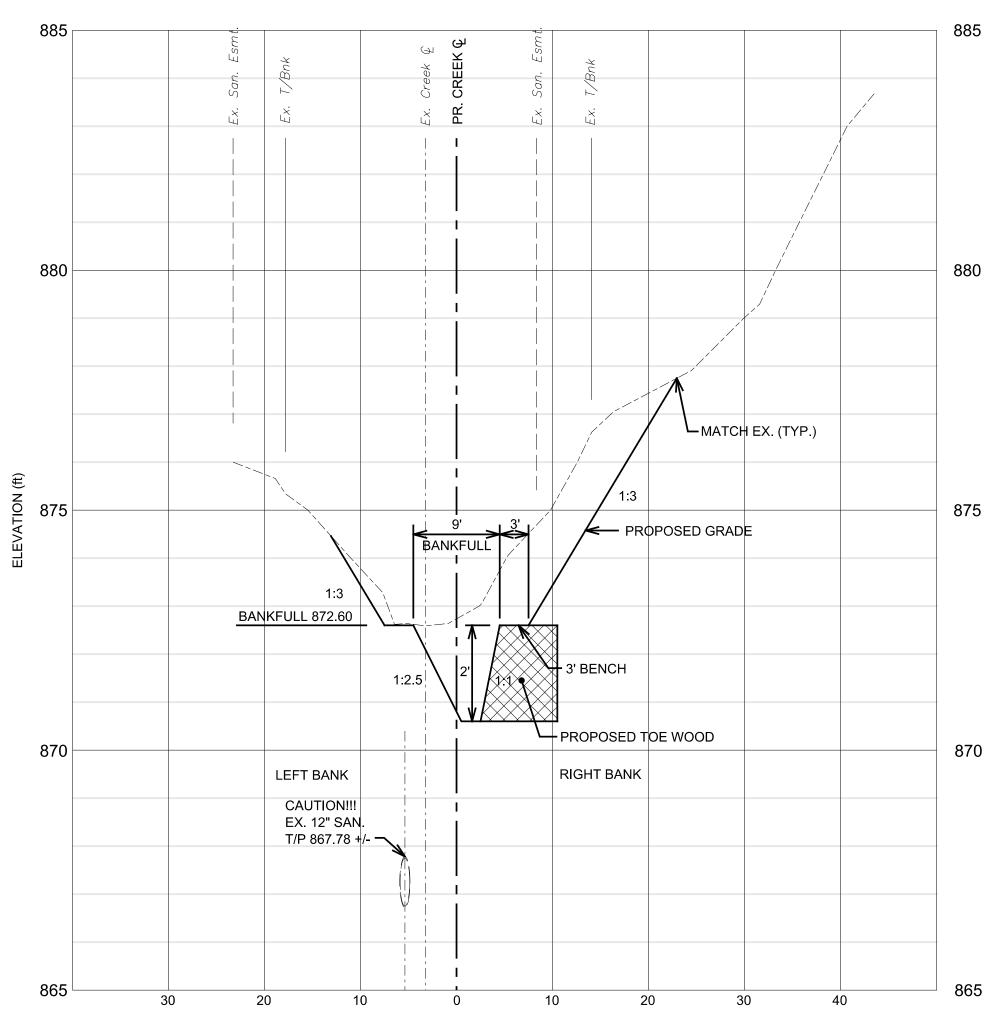

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	REVISED PER EGLE COMMENTS	05-16-2025	J.
	ISSUED FOR EGLE PERMIT	02-24-2025	J.
	ISSUED FOR PRELIMINARY REVIEW	01-16-2025	J.
	ISSUED FOR CONCEPT REVIEW	10-31-2024	J.
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STREET CREEK RE SECTION PUBLIC SERVICES - ENGINEERING CROS

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LIBERTY

CITY OF ANN ARBOR
SCALE

1" = 10" HORIZ.
1" = 2" VERT.

DRAWING No.

S BIDS	11-07-2025	J.A.R.	F.B.
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CITY OF ANN ARBOR 1" = 10' HORIZ. 1" = 2' VERT.

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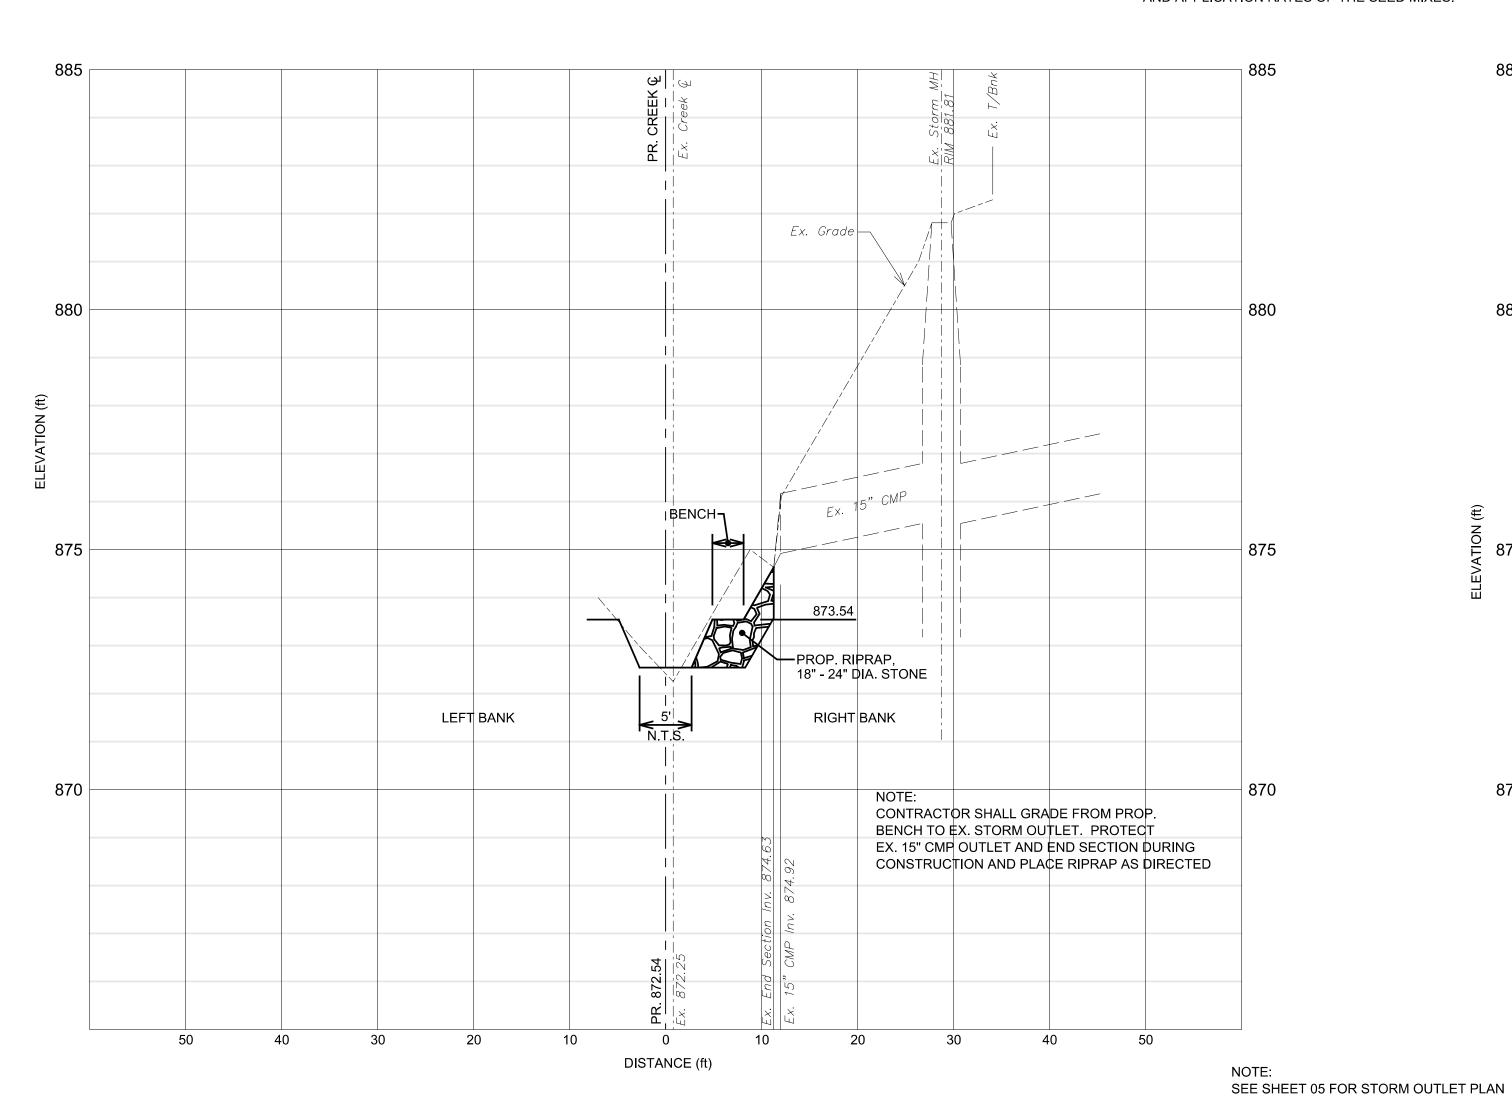
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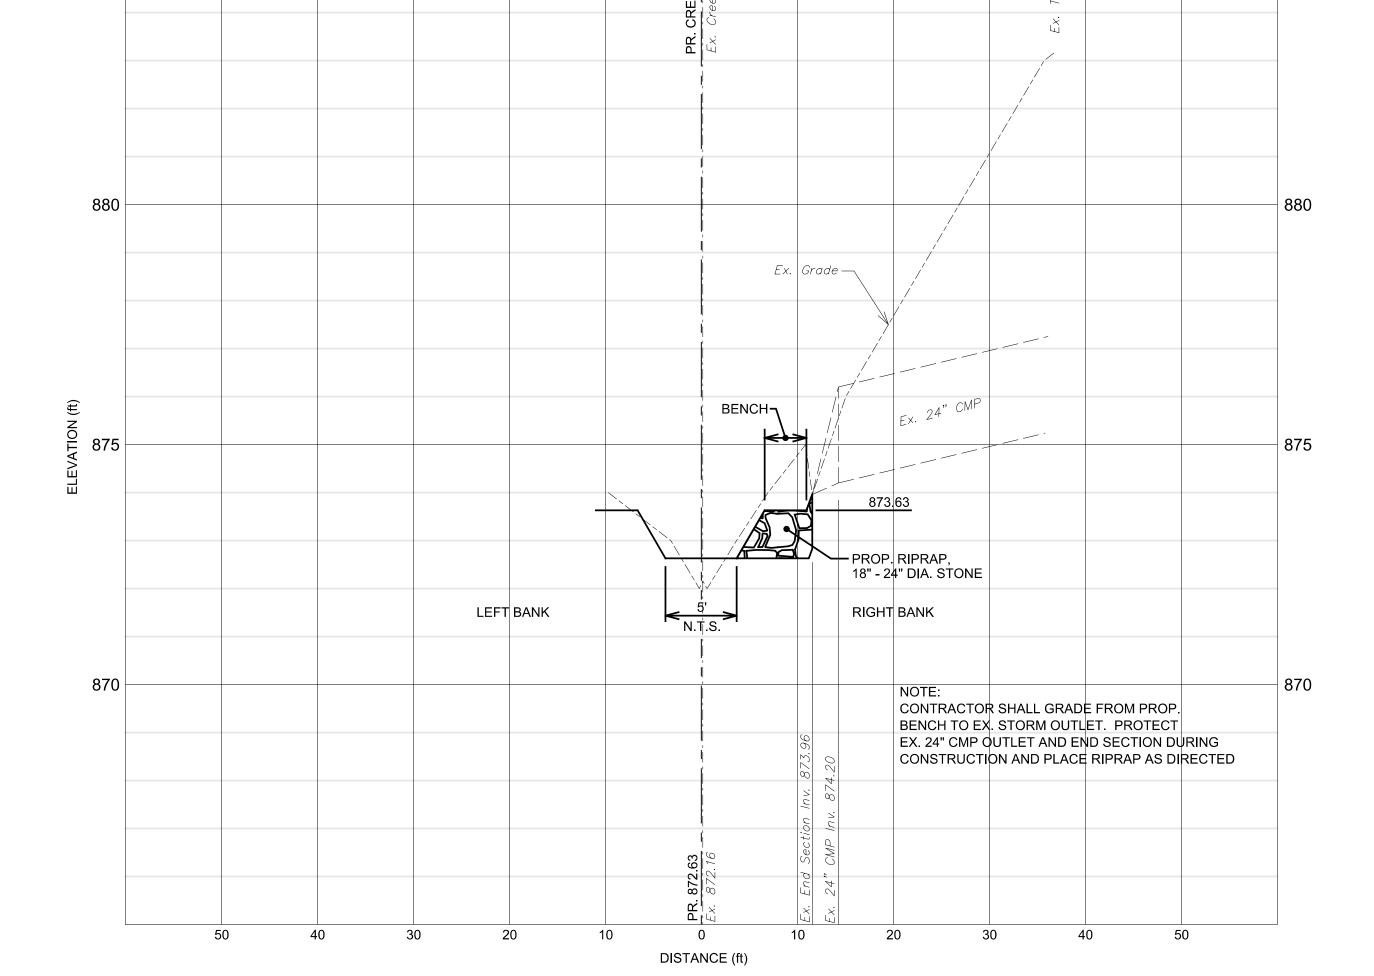
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15" CMP CULVERT SECTION SCALE: 1" = 10' HORIZ. 1" = 2' VERT.

ALL SECTIONS ARE LOOKING UPSTREAM.

LOCATIONS. SECTIONS SHOWN ARE THROUGH THE EXISTING 15" AND 24" OUTLETS. DIMENSIONS SHOWN FOR THE CREEK BOTTOM ARE N.T.S. (NOT TO SCALE)

ORDINARY HIGH WATER MARK OHWM = 875.00

24" CMP CULVERT SECTION

SCALE: 1" = 10' HORIZ. 1" = 2' VERT.

NOTE: ALL SECTIONS ARE LOOKING UPSTREAM.

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ISSUED FOR BIDS	11-07-2025	J.A.R.	H.
REVISED PER EGLE COMMENTS	05-16-2025	J.A.R.	Ħ.
ISSUED FOR EGLE PERMIT	02-24-2025	J.A.R.	Ŀ.
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CITY OF ANN ARBOR

1" = 10' HORIZ. 1" = 2' VERT. No.

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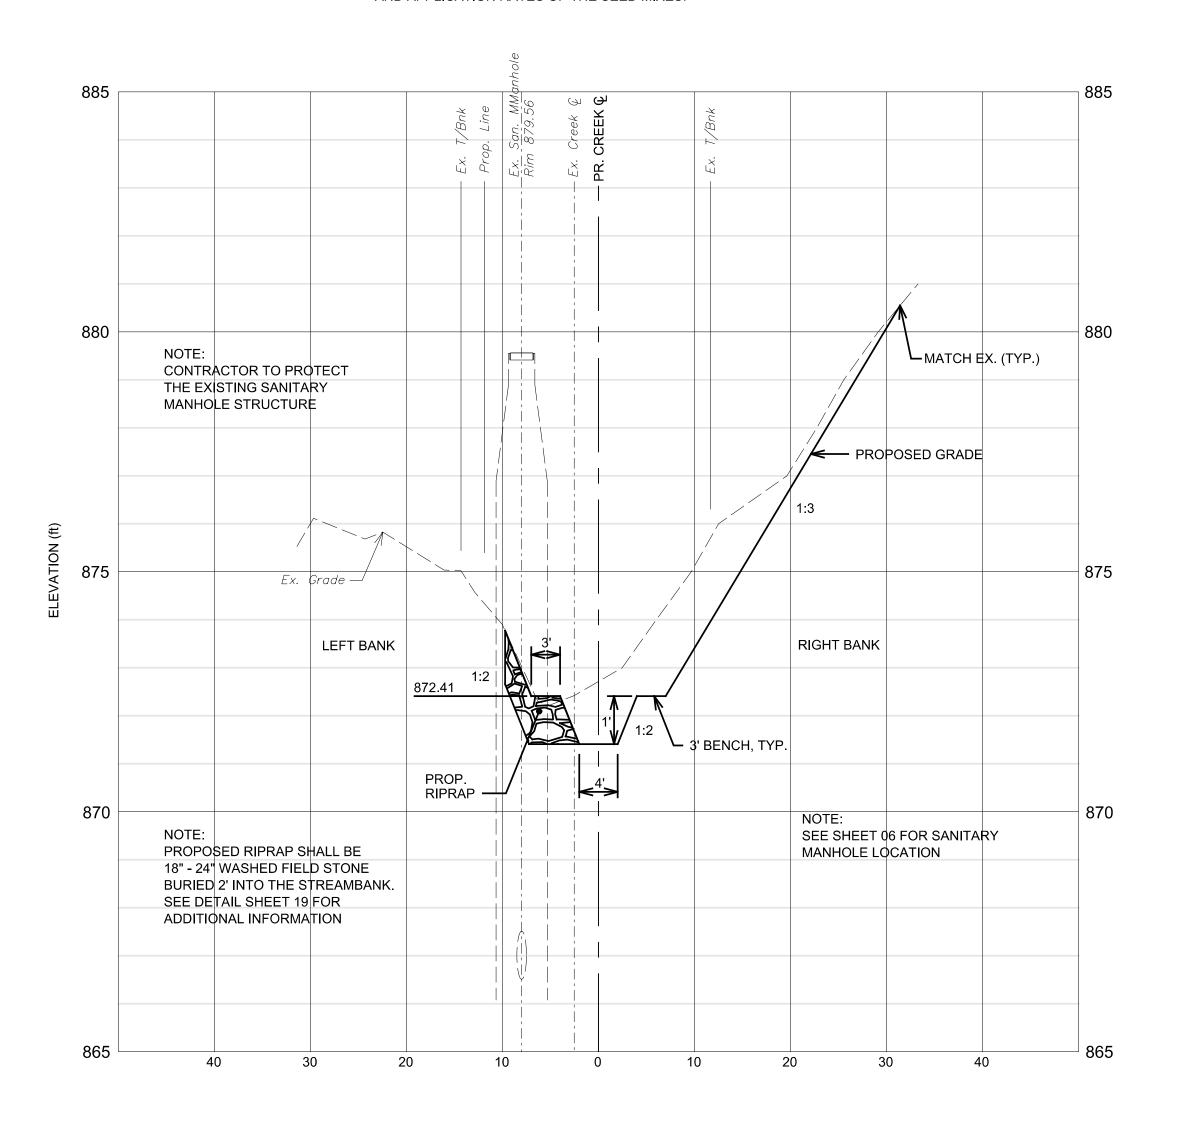
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SECTION AT EX. SANITARY MANHOLE


SCALE: 1" = 10' HORIZ. 1" = 2' VERT.

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LEDGE ROCK STEP SECTION SCALE: 1" = 10' HORIZ. 1" = 2' VERT.

NOTE: ORDINARY HIGH WATER MARK OHWM = 883.00

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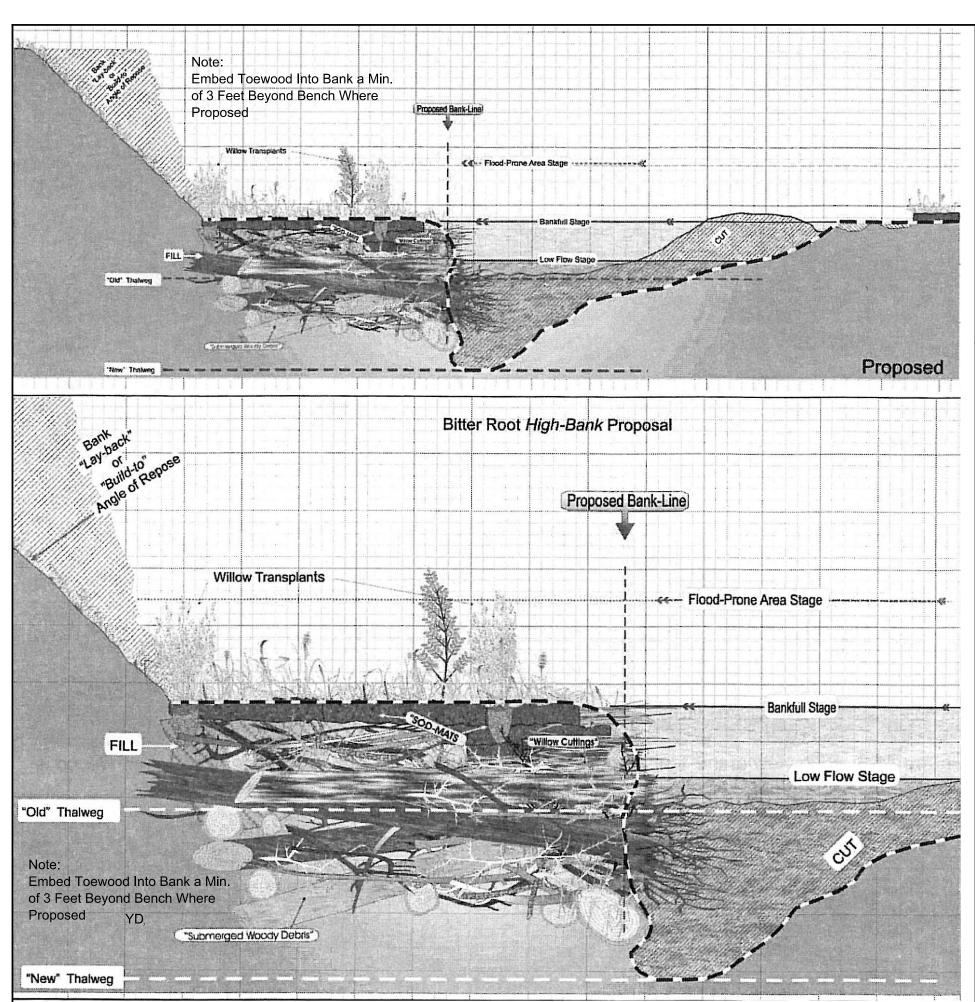
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TOE WOOD GENERAL NOTES:

- . ALL WOODY MATERIAL REQUIRED TO CONSTRUCT THE TOE WOOD STRUCTURE SHALL BE TAKEN FROM EXISTING ON SITE MATERIALS THAT HAVE BEEN DESIGNATED FOR REMOVAL, i.e. TREES, LOGS, BRUSH, WOODY DEBRIS, ETC.
- 2. ADDITIONAL WOODY MATERIAL WILL NEED TO BE BROUGHT IN FROM OFFSITE TO CONSTRUCT THE TOE WOOD STRUCTURE.
- 3. ANY OUTSIDE MATERIALS MUST FIRST BE APPROVED BY THE OWNER AND / OR THE PROJECT ENGINEER.
- I. EMBED THE TOE WOOD INTO THE BANK A MINIMUM OF 3 FEET BEYOND THE BENCH WHERE PROPOSED.
- 5. COARSE WOODY DEBRIS SHALL CONSIST OF LOGS, ROOTWADS AND LARGE BRANCHES.
- 5. TOE WOOD SHALL BE CONSTRUCTED WITH THE LARGEST MATERIAL PLACED FIRST WITH NO LOGS BEING PLACED PARALLEL TO THE FLOW OF THE RIVER. LOGS SHALL BE PLACED IN A CROSSING PATTERN SUCH THAT EACH LOG IS ANCHORED BY ANOTHER LOG.
- SMALL/FINE WOODY DEBRIS SHALL CONSIST OF MEDIUM TO SMALL LIMBS, BRANCHES, BUSHES AND/OR LOGS.
- . SMALL/FINE WOODY DEBRIS SHALL BE PLACED ABOVE THE COARSE WOODY DEBRIS WITH THE LARGEST MATERIAL BEING PLACED FIRST AND THE SMALLEST MATERIAL PLACED LAST.
- 9. ALL WOODY DEBRIS SHALL BE COMPACTED WITH THE EXCAVATOR BUCKET IN ORDER TO REDUCE THE PRESENCE OF VOIDS IN THE SMALL/FINE WOODY DEBRIS LAYER.
- 10. AT THE UPSTREAM AND DOWNSTREAM LIMITS OF THE TOE WOOD STRUCTURE, TRANSITION THE WOODY DEBRIS BY BURYING THEM SECURELY INTO THE BANK.
- 11. THE SOIL BACKFILL AND TOPSOIL USED FOR LAYERING WITH THE LIVE BRANCHES SHALL BE FREE OF ANY LARGE ROOTS OR WOODY DEBRIS AND SHALL GENERALLY BE FREE FROM ANY GRAVEL OR COBBLE MATERIAL.
- 12. SOIL BACKFILL SHALL BE COMPACTED SUCH THAT FUTURE SETTLEMENT OF THE MATERIAL IS KEPT TO A MINIMUM, YET NOT SUCH THAT THE UNDERLAYING BRUSH IS NOT DISPLACED OR DAMAGED.
- 13. CONTINUE PLACING SOIL BACKFILL, LIVE BRANCHES AND SMALL/FINE WOODY DEBRIS AS NECESSARY UNTIL THE DESIRED HEIGHT IS REACHED.
- 14. SOD MATS MAY BE USED FOR THE FINAL LAYER OF THE TOE WOOD STRUCTURE.
- 15. ONCE THE TOE WOOD STRUCTURE IS IN PLACE TO THE DESIGNED BANKFULL ELEVATION, FILL AND GRADE FROM THE TOP FACE OF THE TOE WOOD STRUCTURE TO THE EXISTING GRADE AT THE PROPOSED SLOPE INDICATED ON THE CROSS SECTIONS.
- 16. INSTALL PLANT PLUGS AS DIRECTED ON TOP OF THE TOE WOOD STRUCTURE BENCH WHERE A BENCH IS PROPOSED.
- 17. INSTALL TURF REINFORCEMENT MAT AND NATIVE SEED MIX ALONG THE PROPOSED SLOPE.
- 18. INSTALL ADDITIONAL EROSION CONTROL BLANKET AS NEEDED ALONG THE TOP OF BANK.
- 19. RESTORE ALL DISTURBED AREAS WITH TOPSOIL AND LAWN SEED MIX.
- 20. TOE WOOD SHALL BE PAID FOR UNDER THE TWO PAY ITEMS: "DS_Bank Stabilization, Toe Wood (Woody Material Furnished by Owner) - Lft" "DS Bank Stabilization, Toe Wood (Woody Material Furnished by Contractor) - Lft"
- 21. SEE PLAN AND PROFILE SHEETS FOR TOE WOOD QUANTITIES.

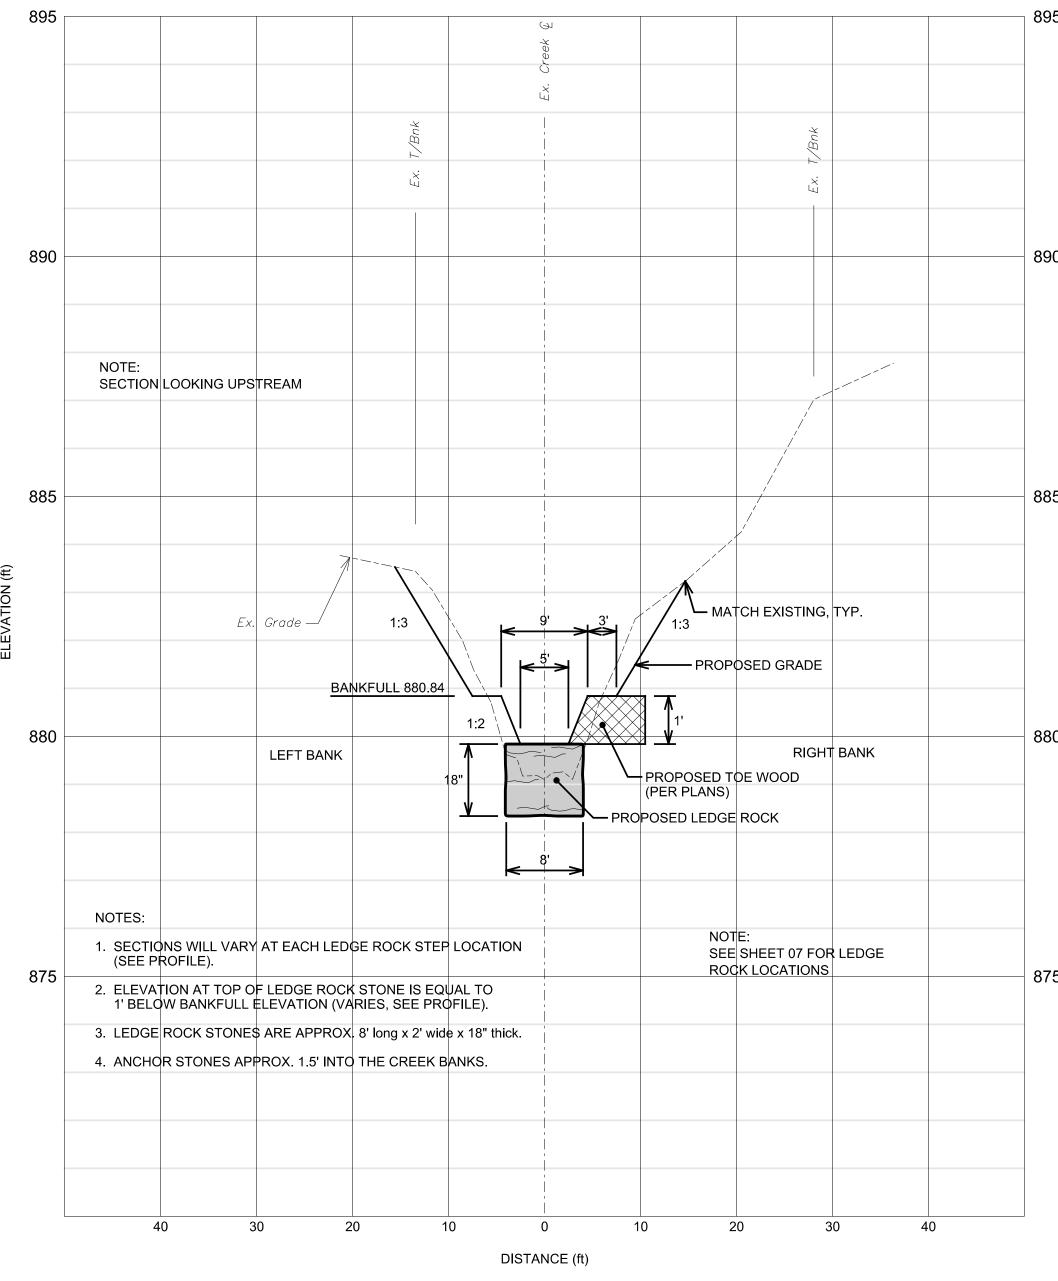MOUNDED EARTH

SAUCER -

PLANTING

UNDISTURBED SOIL

PLANT PLUG NOTES:

MIXTURE

NATIVE SEED MIX AND PLANTINGS LIST

Big Bluestem Frost Aster

Heart-leaved Blue Wood Aster Little Bluestem

Marsh Marigold

Golden Ragwort

Side Oats Grama Turtlehead

Canada Thimbleweed Fox Sedge

Crested Sedge Blue Flag Iris

Palm Sedge Cardinal Lobelia

Lance-fruited Oval Sedge Great Blue Lobelia

Great Bulrush Wild Columbine

Great Spikerush Pickeral Weed

Dudley's Rush Purple Coneflower

Canada Wild Rye Black-eyed Susan

Silky Wild Rye Common Arrowhead

Virginia Wild Rye Fowl Manna Grass

Bebb's Oval Sedge


Rice Cut Grass

Prairie Switch Grass

Indian Grass Prairie Cord Grass

Common Water Plantain


SEE CONTRACT SPECIFICATIONS AND SUPPLIER'S RECOMMENDATIONS FOR SEED MIX SOWING RATES.

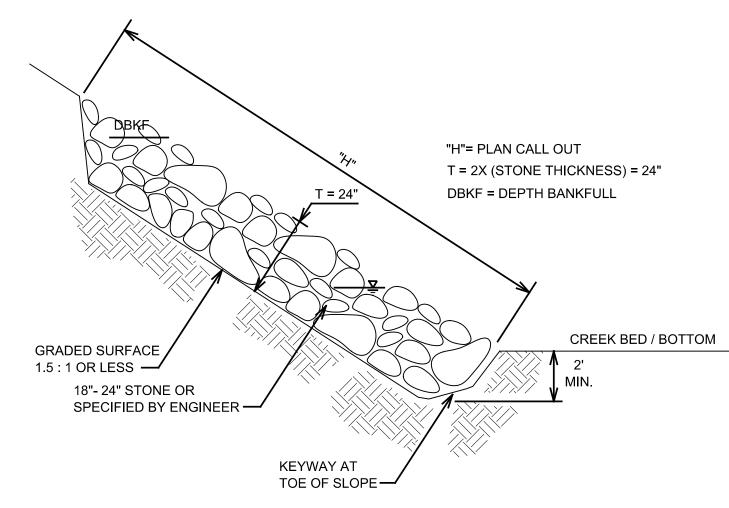


RIP RAP BANK STABILIZATION NOTES:


- 1. EXCAVATE A 2 FT. DEEP AND 1.5 FT. WIDE TRENCH ALONG THE TOE (BASE) OF THE CREEK BANK. INCLUDED IN UNIT PRICE. EXCESS MATERIAL TO BE USED ON SITE AS CALLED FOR OR DISPOSED OF OFF SITE.
- 2. PLACE A (MIN. 2 FT. HIGH, 2 2.5 FT. THICK) STONE REVETMENT ALONG THE BASE OF THE CREEK BANK.
- 3. USE 18" 24" WASHED FIELD STONE FOR THE RIP RAP UNLESS OTHERWISE SPECIFIED BY THE ENGINEER.
- 4. FILL IN VOIDS WITH SMALLER STONES 4" 12".
- 5. INSTALL TO HEIGHT CALLED FOR ON PLANS OR AS DIRECTED BY PROJECT ENGINEER. HEIGHT TO BE MEASURED ALONG SLOPE FROM CUT IN TRENCH.
- 6. PAID FOR UNDER THE PAY ITEM "DS_Riprap, Plain Cyd".

RIP RAP BANK STABILIZATION

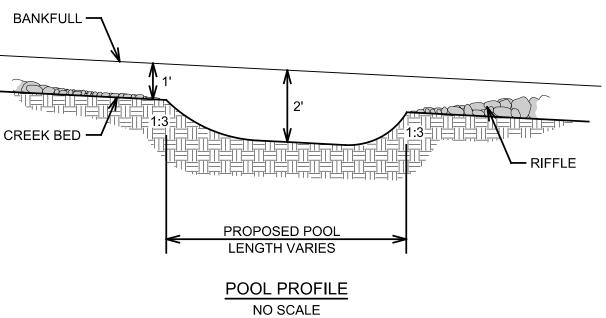

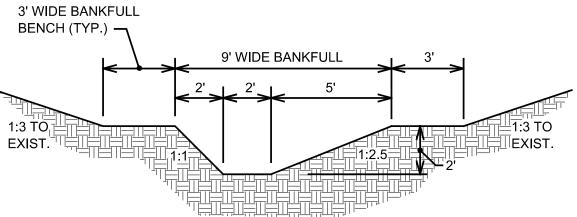

NO SCALE

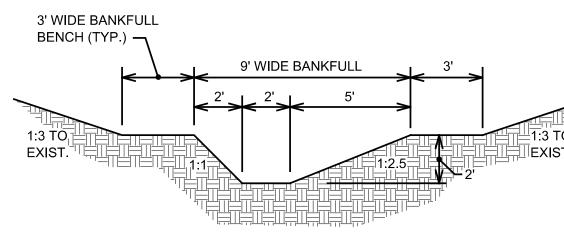

POOL CROSS SECTION

NOTE:
POOLS SHALL BE CONSTRUCTED AS INDICATED OR AS DIRECTED BY THE PROJECT ENGINEER.

POOL DETAILS

TOE WOOD SECTION NO SCALE

PLANT PLUG

1. PLUGS TO BE PLANTED 3 ft ON CENTER (o.c.) ALONG THE TOP OF ALL BANKFULL BENCHES

3. PLANT PLUGS IN CLUSTERS OF 5 - 9 PLANTS OR AS DIRECTED BY THE PROJECT ENGINEER.

6. SEE THE SPECIAL PROVISION FOR NATIVE PLANTINGS IN THE PROJECT SPECIFICATIONS.

INCLUDING TOE WOOD STRUCTURES THAT HAVE A BENCH.

5. PAID FOR UNDER THE PAY ITEM "DS_Native Plant Plugs - Ea".

2. NOT ALL TOE WOOD STRUCTURES WILL HAVE A BENCH FOR PLANTINGS.

4. PLANT PLUG CLUSTERS SHALL CONSIST OF ONE SPECIES PER CLUSTER



3' o.c. (TYP.) 3' o.c. (TYP.)

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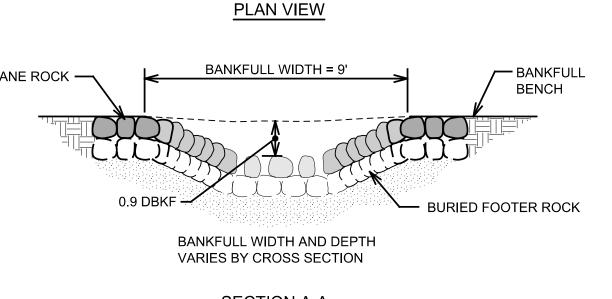
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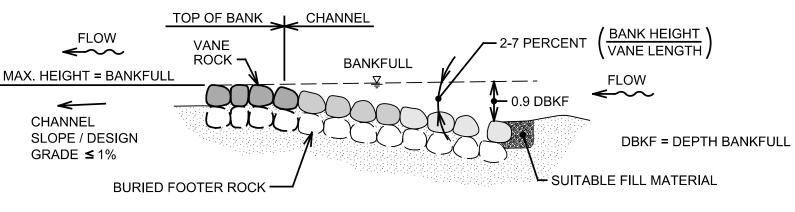
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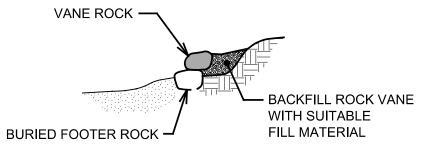
CITY OF ANN ARBOR

DETAIL


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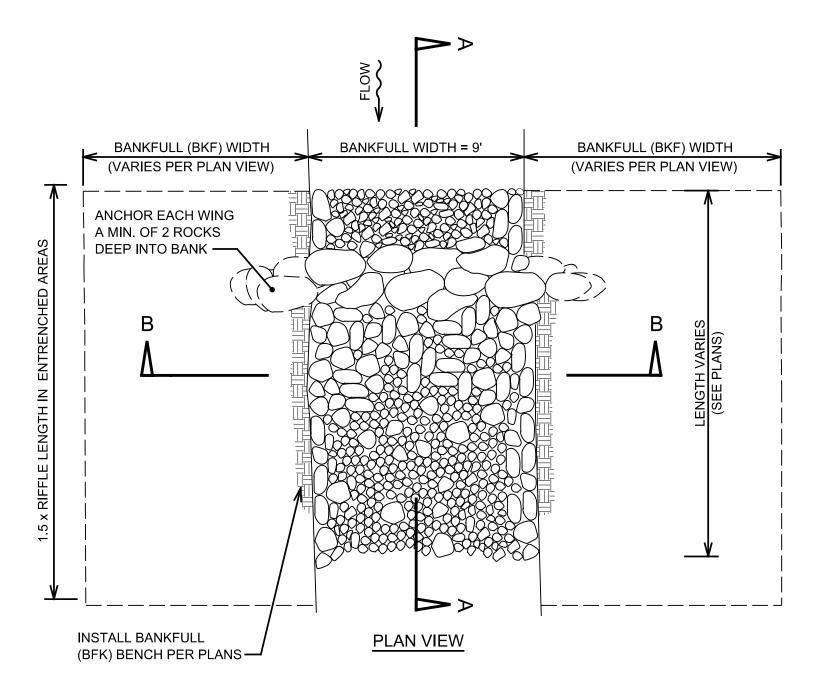
SECTION C-C




SECTION D-D

CROSS VANE DETAIL

CROSS VANES PAID FOR UNDER THE PAY ITEM "DS_Instream Structure, Cross Vane - Ea".

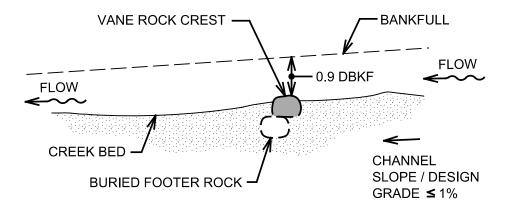


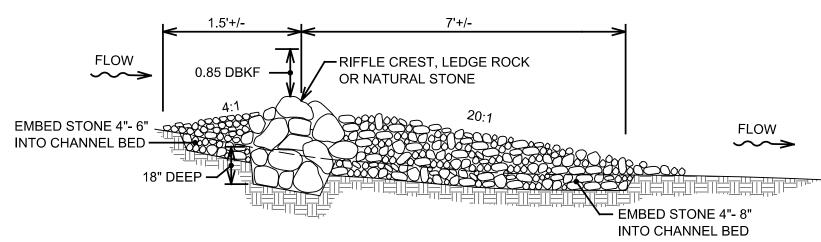

BURIED FOOTER - NATURAL STONE

SECTION A-A

DBKF = DEPTH BANKFULL

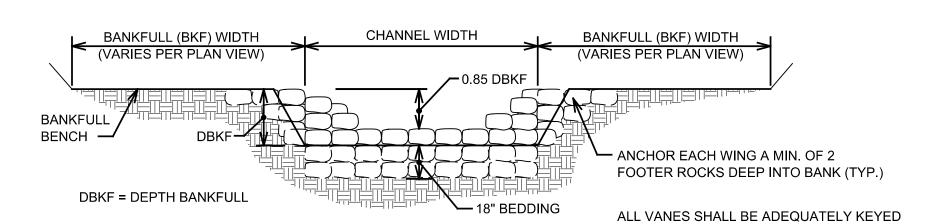

INTO THE BANK AS TO PREVENT EROSION

THE RIFFLE.

OF THE BANK (i.e. AT LEAST 2 FOOTER ROCKS).

RIFFLES SHALL BE KEYED IN AT THE CREST OF

RIFFLE MATERIALS:

18" - 24" NATURAL FIELD STONE 20%

12" - 18" NATURAL FIELD STONE 15%

3" - 8" NATURAL FIELD STONE 15% 1/2" - 3" RIVER RUN GRAVEL 50%

RIFFLE DETAIL

SECTION B-B

RIFFLES PAID FOR UNDER THE PAY ITEM "DS_Instream Structure, Constructed Riffle - Ea".

NO SCALE

RIFFLE NOTES:

- CONSTRUCTED RIFFLES (CR) AND NATURAL RIFFLES (NR) ARE PROPOSED FOR THIS PROJECT.
- 2. ONLY CONSTRUCTED RIFFLES ARE DEPICTED ON THE PLAN AND PROFILES.
- 3. CONSTRUCTED RIFFLES SHALL BE CONSTRUCTED BY THE
- CONTRACTOR PER THE DETAIL AND THE PROJECT ENGINEER. 4. NATURAL RIFFLES ARE NOT CONSTRUCTED BUT SHALL FORM NATURALLY IN THE CREEK BED.
- 5. ALL RIFFLES FOR THIS PROJECT, CONSTRUCTED AND NATURAL SHALL HAVE THE SAME DIMENSIONS

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	J.A.R.	J.A.R.	J.A.R.	DRAWN
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	REVISED PER EGLE COMMENTS	05-16-2025	J.A.R.	Г.
	ISSUED FOR EGLE PERMIT	02-24-2025	J.A.R.	ь.
	ISSUED FOR PRELIMINARY REVIEW	01-16-2025	J.A.R.	Ħ,
	ISSUED FOR CONCEPT REVIEW	10-31-2024	J.A.R.	ь.
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TOR S **CREEK RE** ENGINEERING DETAIL

PROJE SERVICES -STRE RTY

CITY OF ANN ARBOR

SHEET No.

VARIES

RING FENCE AROUND EXISTING TREE

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REV. NO. DATE DRAWN BY CHECKED BY

- 6' STEEL T-POSTS OR 2x2 WOOD STAKES

SET 4' HIGH ORANGE
VINYL CONSTRUCTION
FENCE AT DRIP LINE OR
EDGE OF CRITICAL ROOT
ZONE, WHICHEVER IS

- NO EQUIPMENT, GRADING, OR

COMPACTION IN CRITICAL ROOT ZONE.

PRESERVE GRADE


GREATER.

TREE PROTECTION

CRITICAL ROOT ZONE (IN FEET OF RADIUS) =

12 x D.B.H. (IN INCHES)

DR. ENG CH. ENG DRAWING NO. SD-L-3 DATE 12/8/2023 SCALE N.T.S.

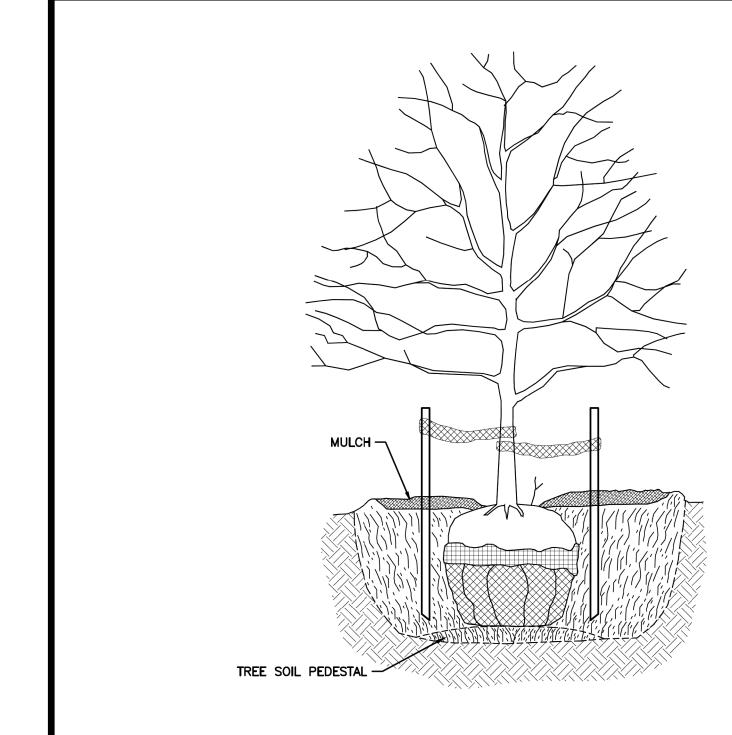

TREE STAKING IS ONLY PERMITTED UNDER ONE OR MORE OF THE FOLLOWING CIRCUMSTANCES:

- 1) IN HEAVY CLAY SOIL
 2) IN WINDY CONDITIONS
- 3) 3" OR GREATER DIAMETER TREE TRUNK
- 4) TREE WITH LARGE CROWN

IF STAKING IS NEEDED DUE TO THESE CONDITIONS:

- STAKE WITH 2 \times 2 HARDWOOD STAKES, OR APPROVED EQUAL, DRIVEN 6"-8" OUTSIDE OF ROOTBALL.
- LOOSELY STAKE TREE TRUNK TO ALLOW FOR TRUNK FLEXING.
- STAKE TREES JUST BELOW FIRST BRANCH WITH 2"-3" WIDE BELT-LIKE NYLON OR PLASTIC STRAPS (2 PER TREE ON OPPOSITE SIDES OF TREE).
- CONNECT STRAPS FROM TREE TO STAKE HORIZONTALLY.
- DO NOT USE ROPE OR WIRE THROUGH A HOSE.
- REMOVE ALL STAKING MATERIALS AFTER 1 YEAR.



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TREE STAKING						
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	F.B.	J.A.R.	05-16-2025

DRAW	DATE	DESCRIPTION	REV.
J.A.R	10-31-2024	ISSUED FOR CONCEPT REVIEW	
J.A.R	01-16-2025	ISSUED FOR PRELIMINARY REVIEW	
J.A.R	02-24-2025	ISSUED FOR EGLE PERMIT	
J.A.R	05-16-2025	REVISED PER EGLE COMMENTS	
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TOR STREET CREEK RES DETAIL SERVICES - ENGINEERING PROJECT

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CITY OF ANN ARBOR -

 R. H.

 <t

- DO NOT PRUNE TERMINAL LEADER OR BRANCH TIPS.

- PRUNE AWAY DEAD OR BROKEN BRANCHES ONLY.

EXCAVATE HOLE TO TWO TO THREE TIMES THE WIDTH

BREAK UP (SCARIFY) SIDES OF PLANTING HOLE.

COMPACT SOIL AT BOTTOM OF HOLE TO CREATE A

BEFORE SETTING TREE IN HOLE, EXPOSE THE TRUNK FLARE BY REMOVING BURLAP AROUND TRUNK AND

SET AND CENTER ROOTBALL SO THAT TRUNK FLARE IS

LEVEL TO GRADE OR VERY SLIGHTLY HIGHER IN CLAY

WITHOUT DISTURBING DEVELOPED ROOTS, FOLD DOWN

REMOVE AND DISPOSE OF ALL NON-BIODEGRADABLE

BACKFILL HOLE WITH EXCAVATED SOIL, TAMP DOWN

PLACE DOUBLE-SHREDDED HARDWOOD MULCH 2"-3"

DO NOT STAKE TREE UNLESS PERMITTED PER DETAIL

NO UTILITIES SHALL BE PERMITTED IN OR UNDER THE PLANTING HOLE EXCEPT WHERE TREE TUNNELING IS

DRAWN BY

TREE PLANTING

DATE 12/8/2023

CH. ENG

CHECKED BY

SD-L-1

DRAWING NO.

DEEP LEAVING A 3" RADIUS CIRCLE OF BARE SOIL

MATERIALS, CUTTING AWAY WIRE BASKET TO 10" DEPTH.

SOIL TO REMOVE AIR POCKETS, AND FIRMLY SET TREE. DO NOT AMEND SOIL UNLESS PLANTING IN SEVERELY

AND REMOVE ONE-THIRD TO ONE-HALF OF BURLAP TO

REMOVE ALL LABELS, TAGS, TREE WRAP, TAPE OR STRING

TREE PEDESTAL AS SHOWN.

PULLING BACK SOIL.

EXPOSE ROOTBALL.

DISTURBED SOIL.

SD-L-2.

DATE

REV. NO.

DR. ENG

SCALE N.T.S.

AROUND TRUNK OF TREE.

PERMITTED PER SD-L-4.

- PRUNE OFF SUCKERS.

FROM TREE TRUNK AND CROWN.





- PUBLIC SERVICES - ENGINEERING LIBERTY

22

- 2"- 3" WIDE BELT-LIKE NYLON OR PLASTIC STRAP. CONNECT FROM TREE TO STAKE OPPOSITE AND METAL FENCE POST STAKES - 3 PER TREE. ALLOW FOR SOME FLEXING OF THE DRIVE STAKES 18" BELOW TREE PIT TREE. REMOVE AFTER ONE (1) YEAR INTO UNDISTURBED SOIL. 6"- 8" OUTSIDE OF ROOTBALL. REMOVE AFTER ONE (1) YEAR -- MULCH 4" IN DEPTH WITH SHREDDED HARDWOOD BARK. NATURAL IN COLOR. LEAVE 3" CIRCLE OF BARE SOIL AT BASE OF TREE TRUNK PLANTING MIXTURE (AS SPECIFIED) — TREE SAUCER REMOVE WIRE, BURLAP AND TWINE FROM TOP ⅓ OF 1½ x BALL DIA. ROOTBALL, MIN. REMOVE (TYP.) ALL NON-BIODEGRADABLE NYLON OR PLASTIC —— SCARIFY SUBGRADE AND PLANTING PIT SIDES —

NOTES:

- 1. TREE SHALL BE PLANTED SLIGHTLY HIGHER THAN FINISH GRADE AS DIRECTED BY THE ENGINEER/LANDSCAPE ARCHITECT.
- 2. DO NOT PRUNE TERMINAL LEADER. PRUNE ONLY DEAD OR BROKEN BRANCHES.
- 3. WATER-IN ALL PLANT MATERIAL IMMEDIATELY AFTER INSTALLATION.
- 4. SEE SPECIFICATIONS FOR SPECIAL LANDSCAPING REQUIREMENTS AND MAINTENANCE AND GUARANTEE STANDARDS.

EVERGREEN TREE PLANTING NO SCALE



MULCH -

TREE SOIL PEDESTAL -

HOLE WIDTH = 2-3x WIDTH OF ROOTBALL

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SHEET No.

LONGITUDINAL OVERLAP

AND STAKE* 12" O.C.

OVERLAP EDGES 6"

TERMINAL FOLD TURN END UNDER 6" AND STAKE* 12" O.C.


DOWN CENTER OF ALL ROWS


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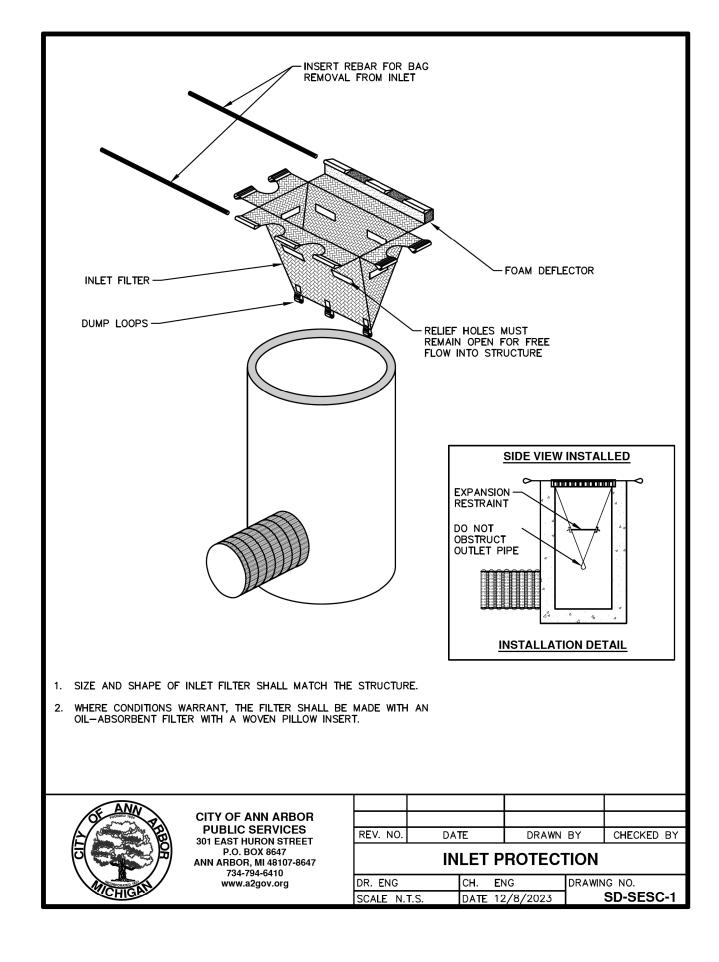
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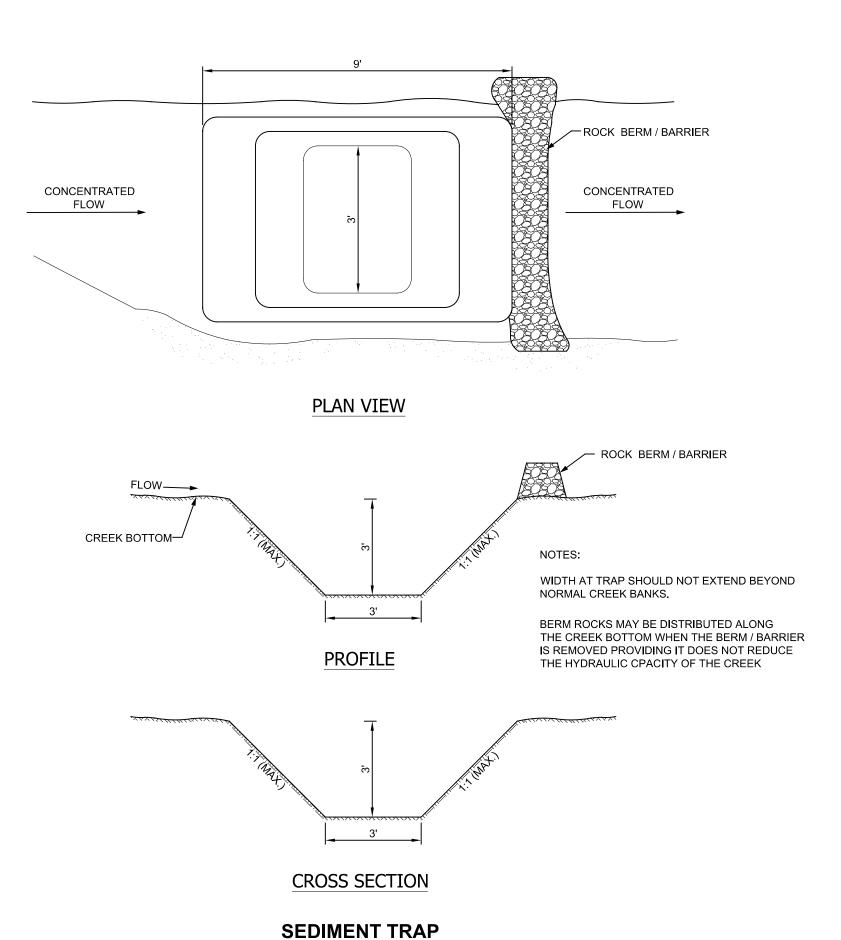
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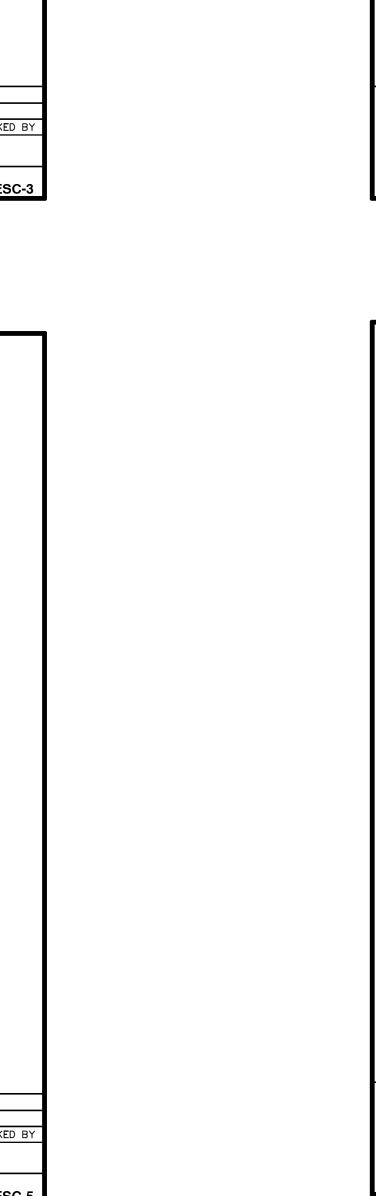







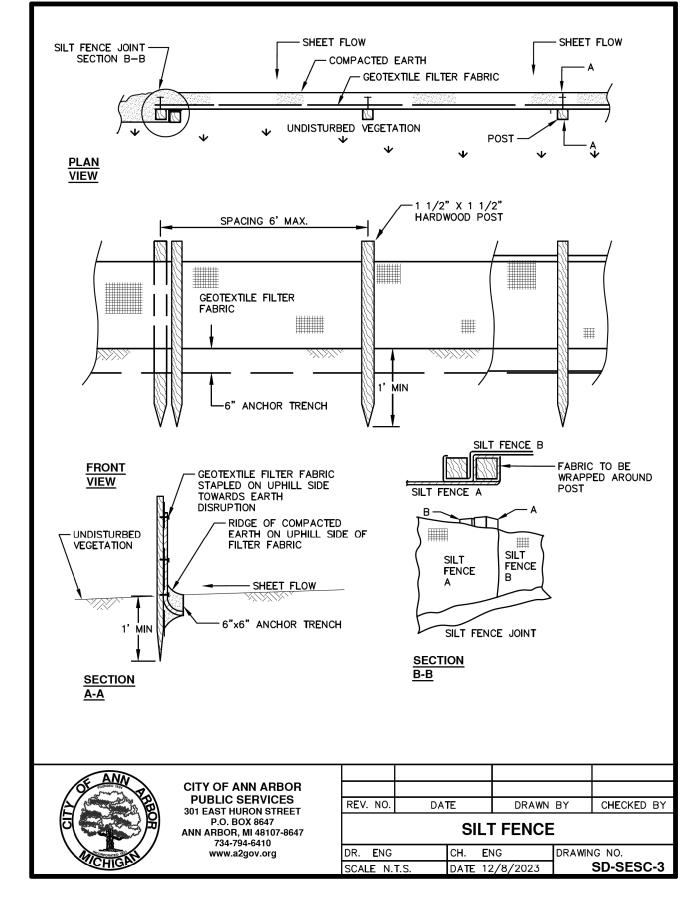


N.T.S.

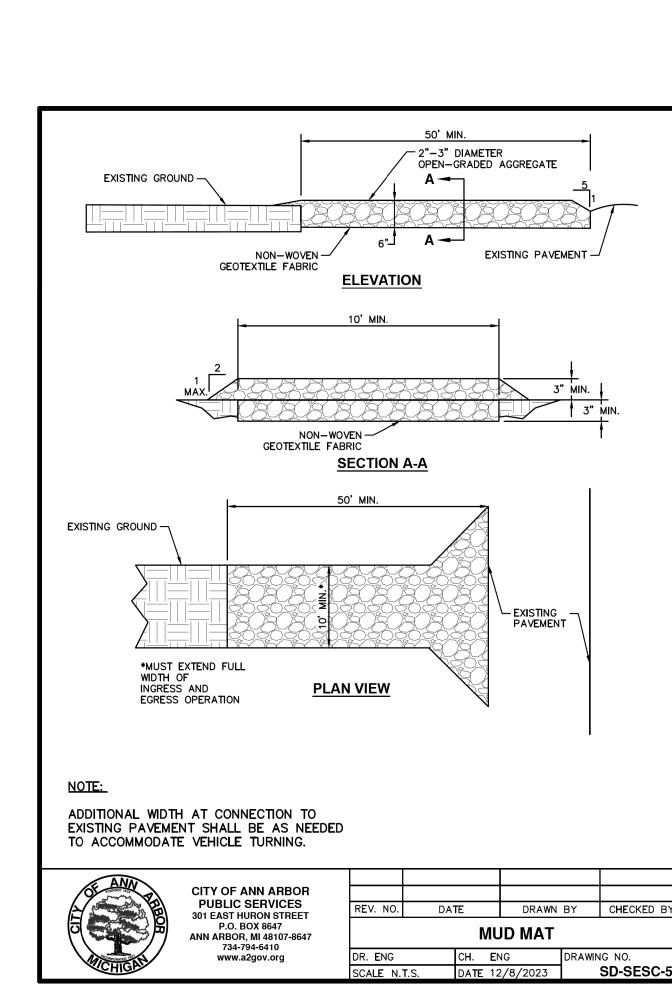

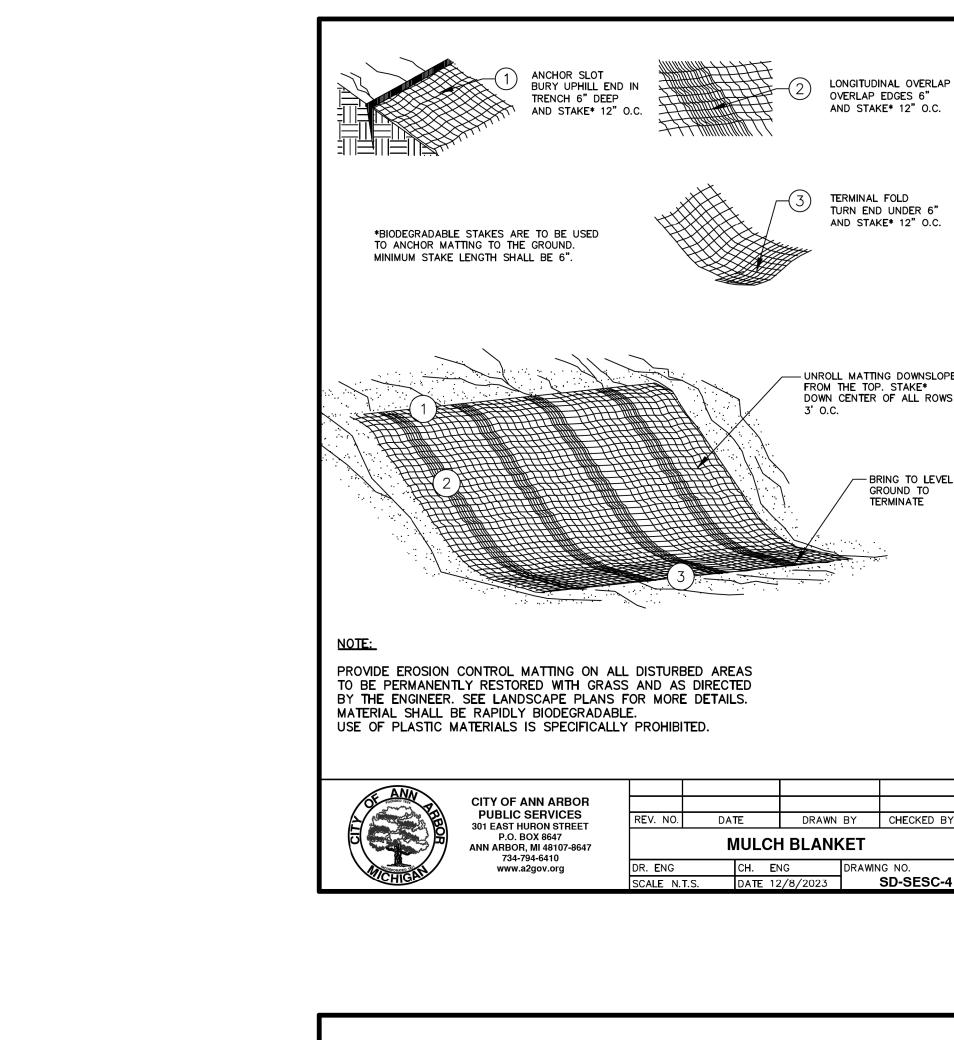

- 1. THE CONTRACTOR SHALL IMPLEMENT AND MAINTAIN THE SOIL EROSION CONTROL MEASURES AS SHOWN ON THE PLANS AND AS DIRECTED BY THE ENGINEER AT ALL TIMES DURING CONSTRUCTION. ANY MODIFICATIONS OR ADDITIONS TO THE SOIL EROSION CONTROL MEASURES DUE TO CONSTRUCTION OR CHANGED CONDITIONS SHALL BE AS DIRECTED AND APPROVED BY THE ENGINEER.
- 2. ALL SOIL EROSION AND SEDIMENTATION CONTROL WORK SHALL CONFORM TO THE PERMIT REQUIREMENTS OF THE CITY OF ANN ARBOR, CHAPTER 55 ANN ARBOR UNIFIED DEVELOPMENT CODE, CITY OF ANN ARBOR STANDARDS DIVISION VII, THE LAWS OF THE STATE OF MICHIGAN, AND THE REQUIREMENTS OF THE CONTRACT DOCUMENTS.
- 3. DAILY, OR AFTER ANY STORM EVENT, INSPECTIONS OF EROSION CONTROL MEASURES SHALL BE MADE BY THE CONTRACTOR. PERIODIC INSPECTIONS MAY BE MADE BY THE ENGINEER TO DETERMINE THE EFFECTIVENESS OF EROSION AND SEDIMENTATION CONTROL MEASURES. ANY NECESSARY CORRECTIONS SHALL BE MADE WITHOUT DELAY, AND WITHOUT ADDITIONAL COST TO THE CITY OF ANN ARBOR.
- 4. EROSION AND SEDIMENTATION FROM WORK ON THE SITE SHALL BE CONTAINED ON THE SITE AND NOT BE ALLOWED TO COLLECT ON ANY OFF-SITE AREAS, ROADWAYS OR WATERWAYS.
- 5. ALL MUD/SOIL TRACKED ONTO ROADWAYS FROM THE SITE DUE TO CONSTRUCTION, SHALL BE PROMPTLY REMOVED BY THE CONTRACTOR. IF SO ORDERED, THE CONTRACTOR SHALL PROVIDE AND OPERATE A VACUUM—TYPE STREET SWEEPER, AT NO ADDITIONAL COST TO THE CITY OF ANN ARBOR.
- 6. RESTORATION OF ALL DISTURBED AREAS, INCLUDING PLACEMENT OF TOPSOIL, SEED, FERTILIZER AND MULCH AND/OR SOD SHALL BE PERFORMED WITHIN FIVE (5) DAYS OF THE COMPLETION OF FINAL GRADE EXCEPT WHERE TEMPORARY SEEDING OR AN ANCHORED MULCH BLANKET ARE SET FORTH AS TEMPORARY MEASURES PER THE APPROVED SEQUENCE OF SOIL EROSION MEASURES.
- 7. CONSTRUCTION OPERATIONS SHALL BE SCHEDULED AND PERFORMED SO THAT PREVENTATIVE SOIL EROSION CONTROL MEASURES ARE IN PLACE PRIOR TO EXCAVATION IN CRITICAL AREAS AND TEMPORARY STABILIZATION MEASURES ARE IN PLACE IMMEDIATELY FOLLOWING BACKFILLING OPERATIONS.
- 8. SPECIAL PRECAUTIONS WILL BE TAKEN IN THE USE OF CONSTRUCTION EQUIPMENT TO PREVENT SITUATIONS THAT PROMOTE EROSION.
- 9. PROPER DUST CONTROL SHALL BE MAINTAINED DURING CONSTRUCTION BY USE OF WATER TRUCKS AND/OR DUST PALLIATIVE AS REQUIRED.
- 10. THE CONTRACTOR SHALL BE RESPONSIBLE FOR MAINTAINING ALL TEMPORARY SOIL EROSION CONTROL MEASURES AND REMOVAL OF SOME MEASURES UPON AUTHORIZED COMPLETION OF THE PROJECT. FINAL COMPLETION OF PROJECT WILL NOT BE AUTHORIZED UNTIL ALL SITE WORK AND UTILITY CONSTRUCTION IS COMPLETE AND ALL SOILS ARE STABILIZED.
- 11. THE CONTRACTOR SHALL NOT GRADE INTO ADJACENT PROPERTIES. SILT AND PROTECTIVE FENCE SHALL BE INSTALLED AND MAINTAINED TO PREVENT GRADING, EROSION AND SEDIMENTATION INTO THE ADJACENT PROPERTIES.
- 12. TREE PROTECTION FENCING MUST REMAIN INTACT UNTIL RESTORATION OF THE SITE IS COMPLETE.

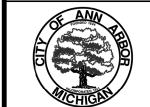

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