

CITY OF ANN ARBOR

GEDDES DAM - TAINTER GATE #4 REPLACEMENT

OCTOBER 2014


ITB#: 4356

Stantec Project Number: 2075129506

BID SET

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- (1) NEW WORK AREA.
- 2 PROTECT EXISTING TREE.
- 3 INSTALL 6' CONSTRUCTION FENCE IF EQUIPMENT OR MATERIALS ARE STORED OVERNIGHT.
- 4 BAYS TO REMAIN ACTIVE DURING CONSTRUCTION.
- 5 BRIDGE SHALL NOT BE USED FOR STAGING OR AS A LIFT
- (6) FASTEN DEBRIS BARRIER TO CONCRETE SILL. MIN 18" HIGH.
- 7 PROTECT PATHWAY FROM DAMAGE.
- 8 RESTORE STAGING AREA AND ROUTE OF EGRESS. GRADE, TOPSOIL, SEED AND MULCH AS REQUIRED.

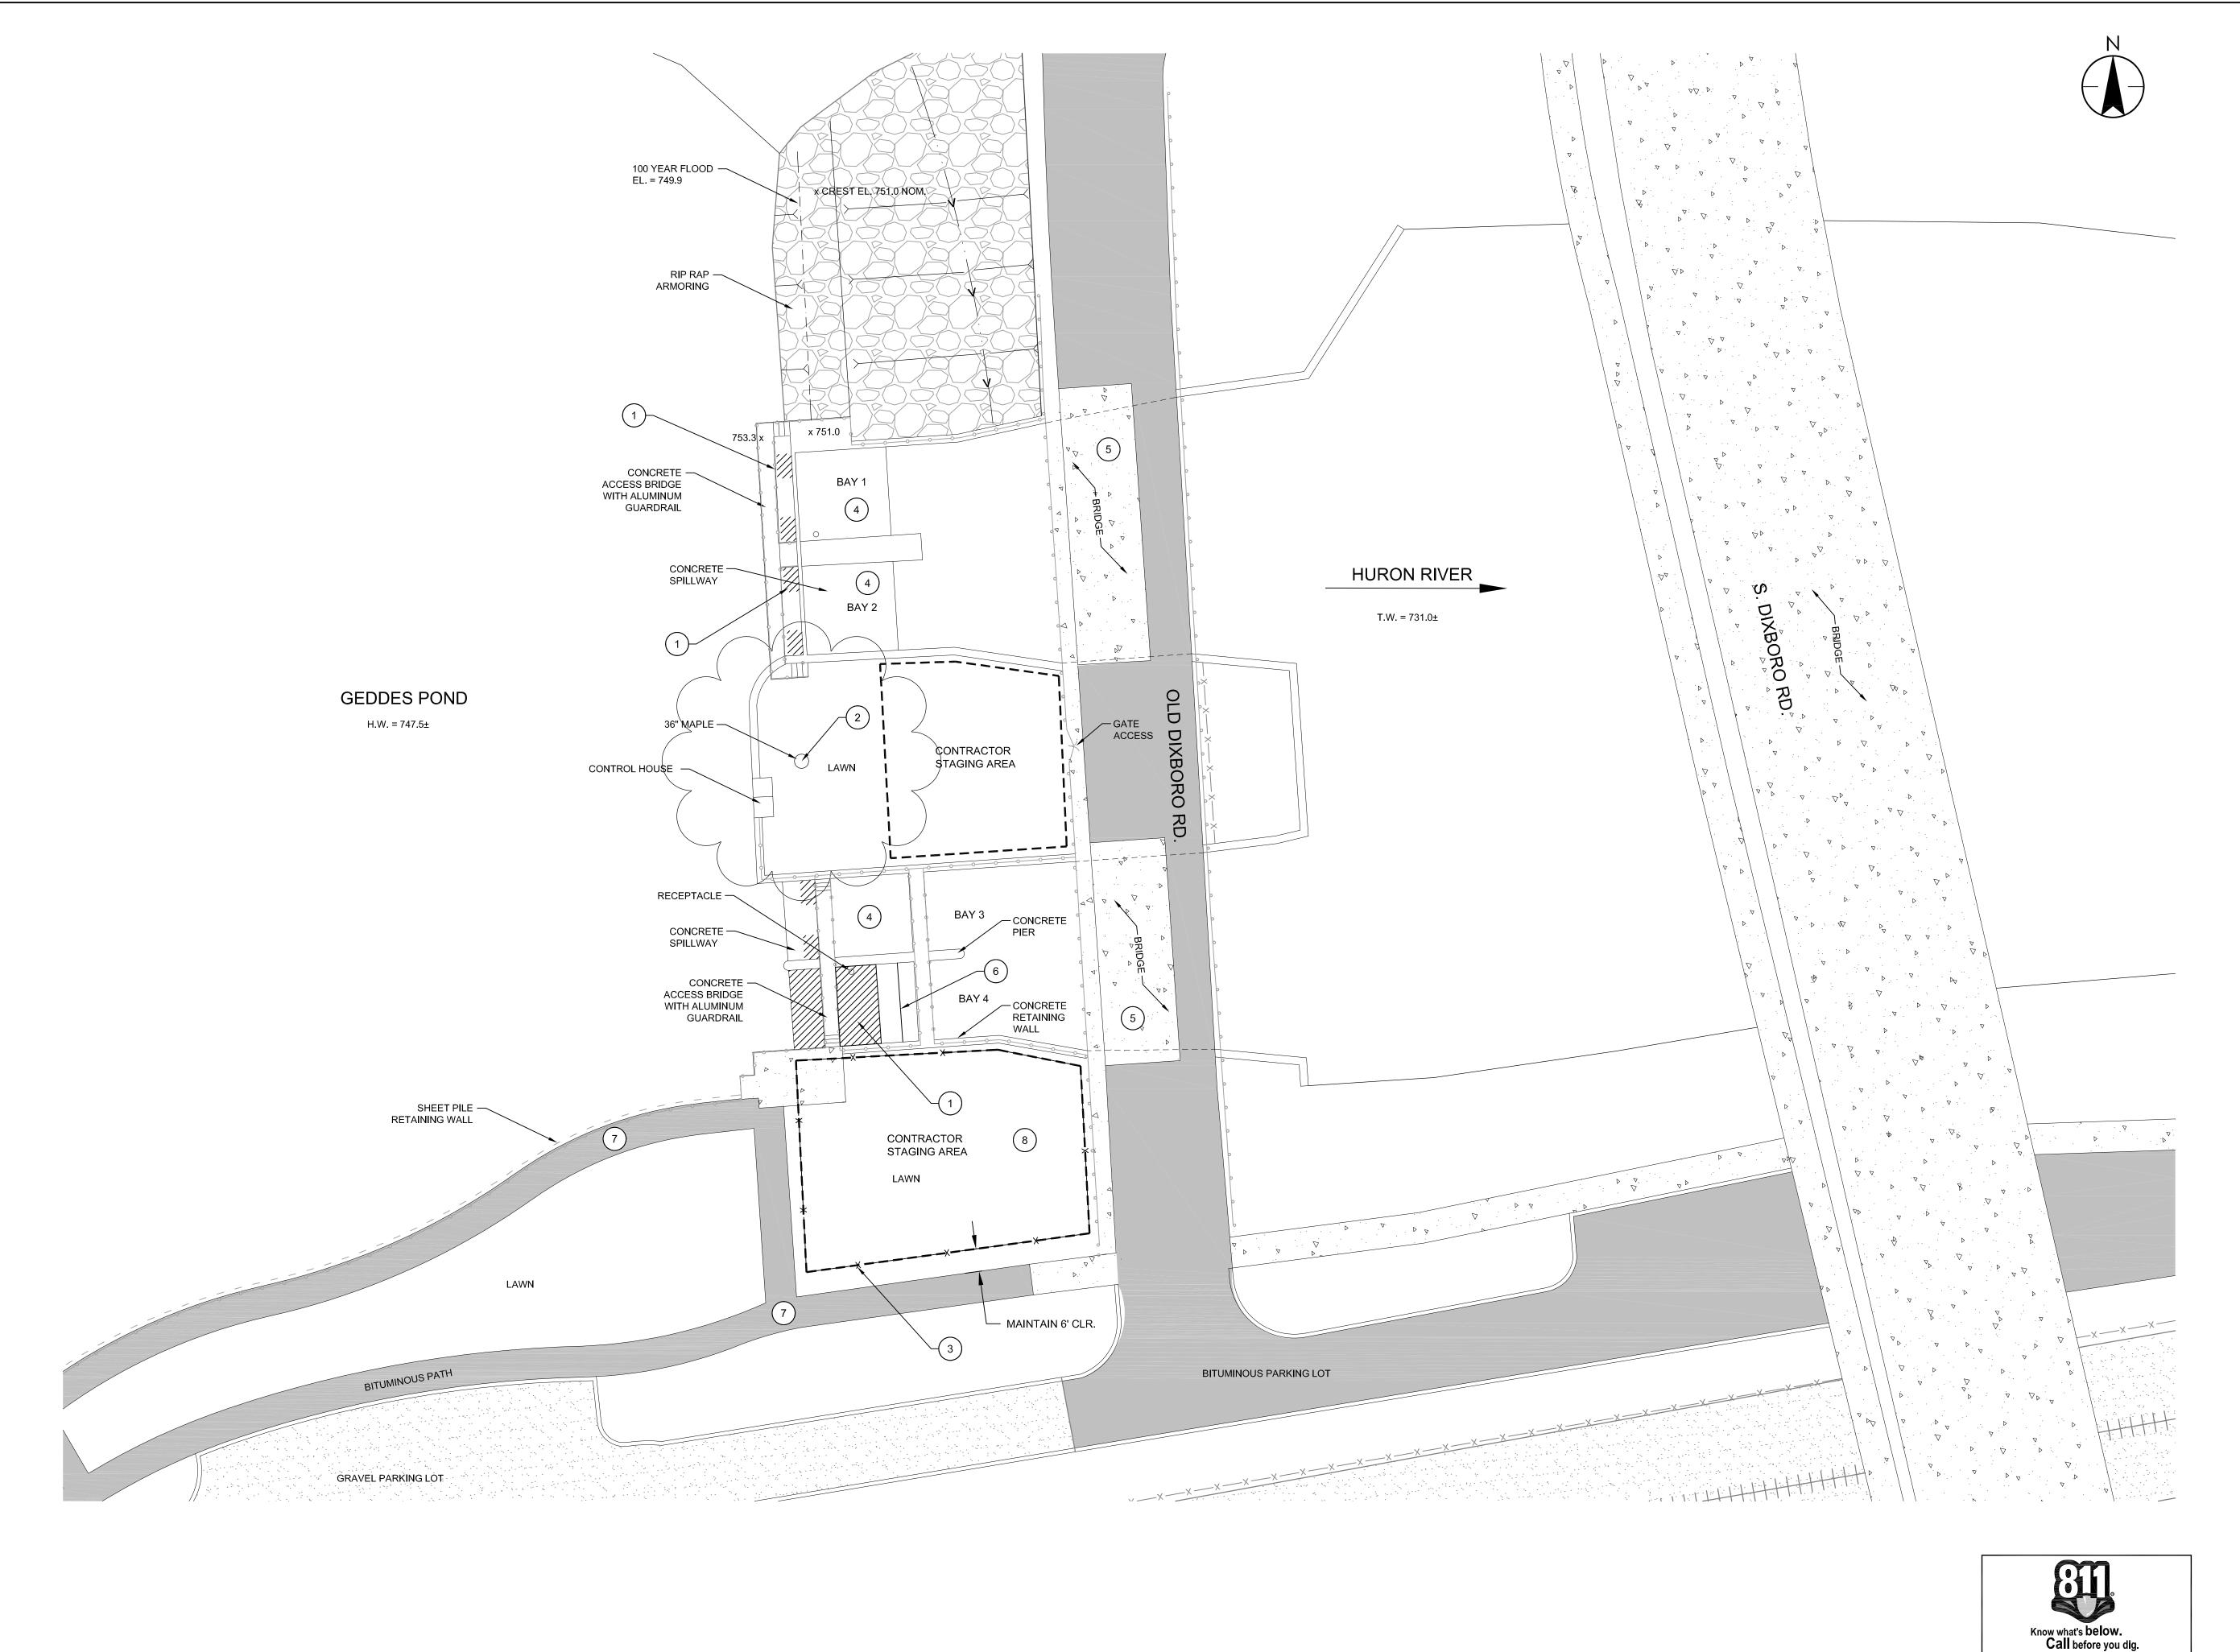


CONCRETE PAVEMENT



BITUMINOUS PAVEMENT



GRAVEL SURFACE

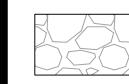

C BID SET		BWA	 	14.10.22
B 95% PLANS		BWA	PJM	14.10.22
A 60% PLANS		BWA	PJM	14.06.05
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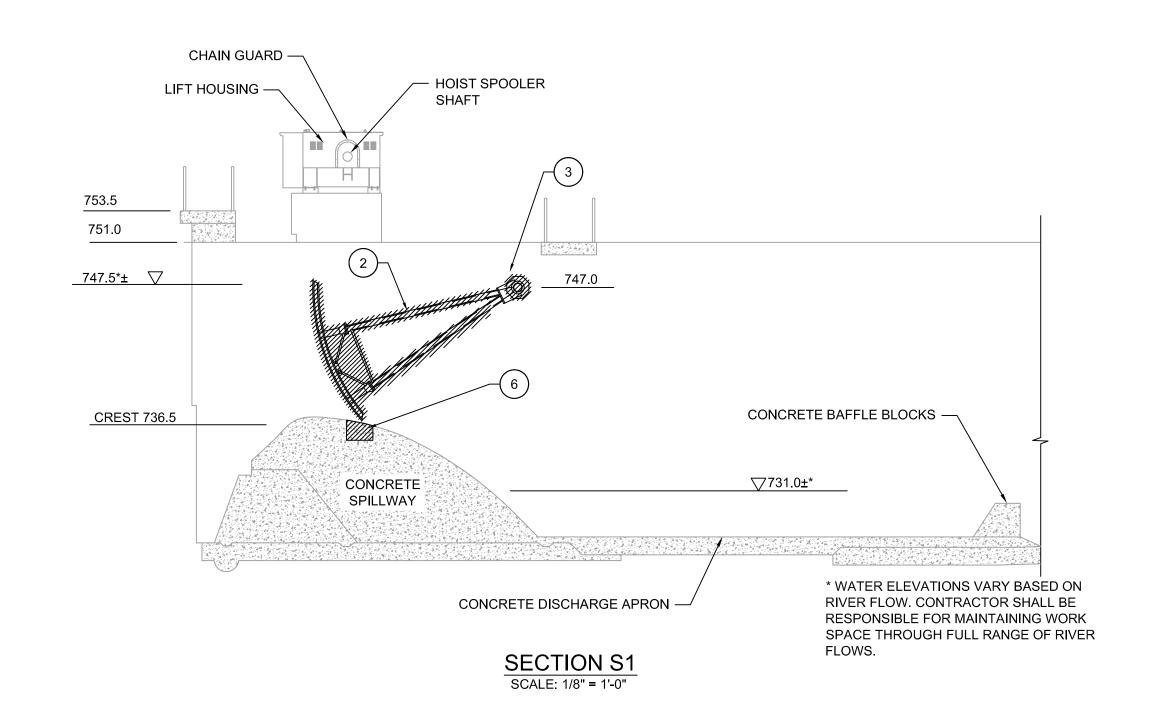
GEDDES DAM - TAINTER GATE #4 REPLACEMENT Ann Arbor, Michigan


THE LOCATIONS AND ELEVATIONS OF
EXISTING UNDERGROUND UTILITIES AS SHOWN
ON THIS DRAWING ARE ONLY APPROXIMATE.
NO GUARANTEE IS EITHER EXPRESSED OR
IMPLIED AS TO THE COMPLETENESS OR
ACCURACY THEREOF. THE CONTRACTOR
SHALL BE RESPONSIBLE FOR CONTACTING
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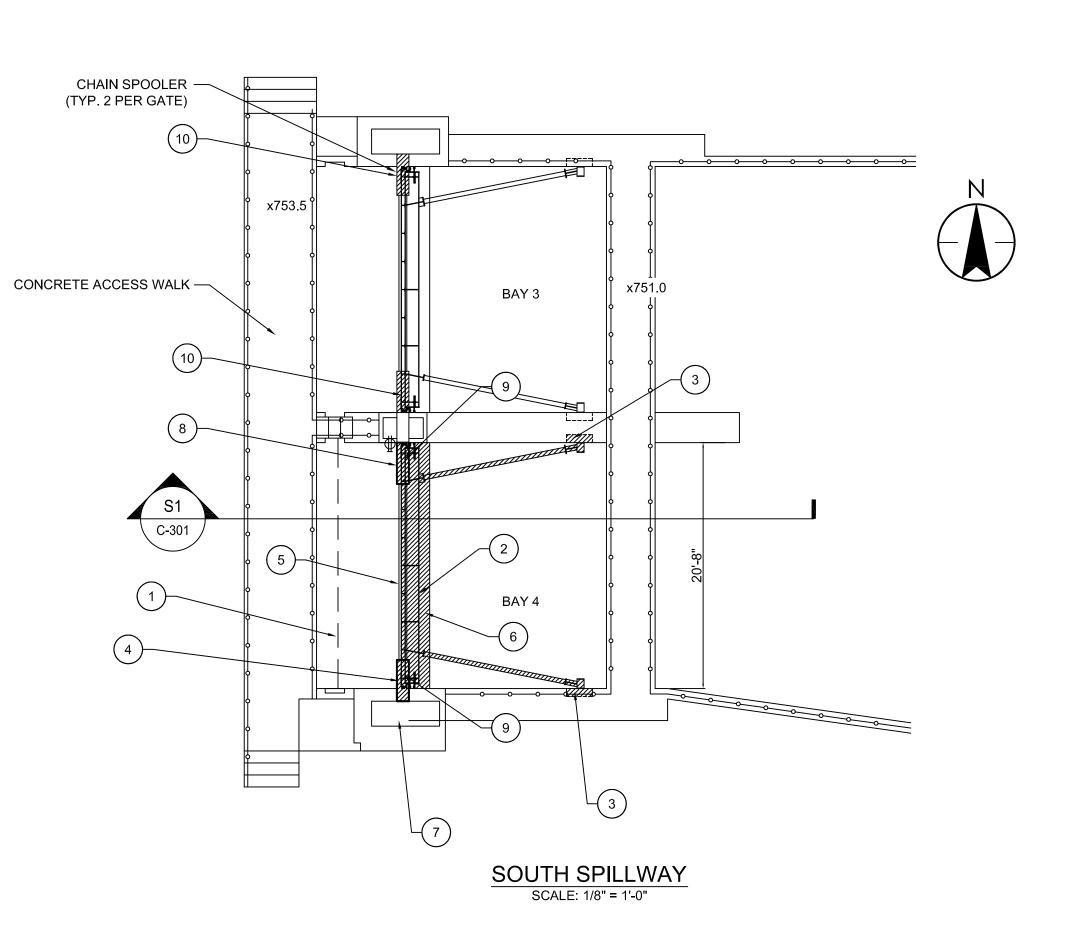
GENERAL SITE PLAN

Project No. 2075129506	Scale	0	20'	40'
Drawing No.	Sheet		Revis	ion
C-101	2	of 8	C)





SCALE: 1/8" = 1'-0"

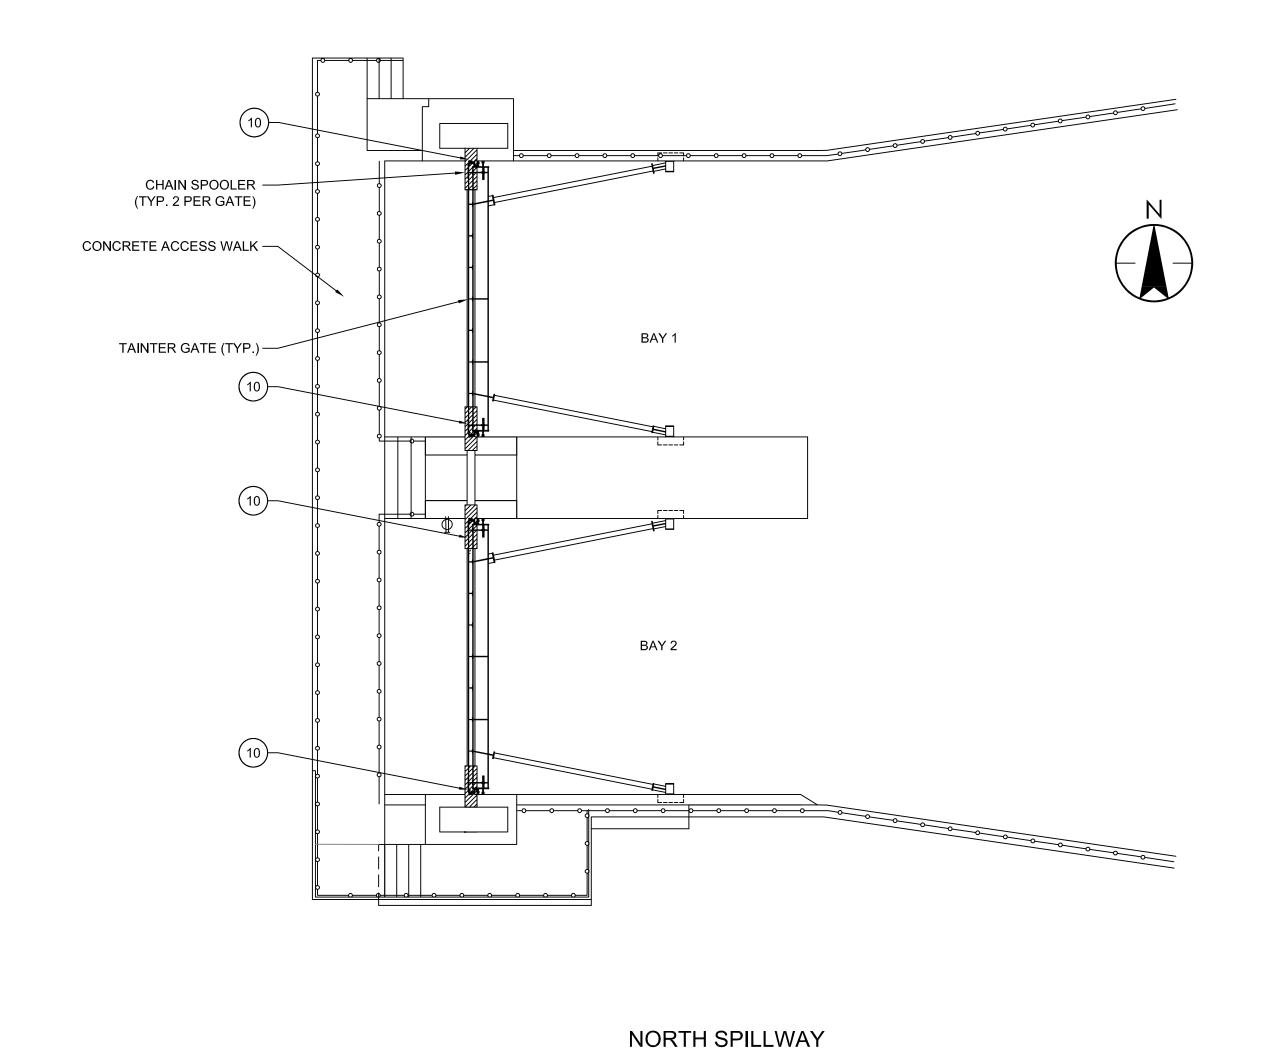



NOTF:

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Notes

- 1 INSTALL TEMPORARY STOPLOGS. REMOVE STOPLOGS UPON COMPLETION OF PROJECT AND RETURN TO OWNER'S STORAGE LOCATION. (STOPLOGS ARE LOCATED AT BARTON PUMP STATION).
- 2 DEMOLISH EXISTING TAINTER GATE. FURNISH AND INSTALL NEW TAINTER GATE.
- 3 SAW CUT AND REMOVE EXISTING CONCRETE AND DEMOLISH TRUNNION PIN. INSTALL NEW PIN AND CAST INTO CONCRETE. SEE DETAILS ON DWG S-303. TYP. BOTH SIDES.
- (4) REMOVE AND REPAIR CHAIN GUARD, THIS SIDE ONLY. BLAST TO BARE METAL AND REPAINT.
- (5) BLAST AND REPAINT HOIST SPOOLER SHAFT. NOM. 8"Ø.
- 6 DEMOLISH EXISTING SILL AND RECONSTRUCT NEW SILL PER DETAIL 7 S-302, 8 S-302.

 7 RE-CALIBRATE HOIST POSITION INDICATOR, LIMIT SWITCHES AND ALARMS LIBON INSTALL ATION OF NEW CATE
- AND ALARMS UPON INSTALLATION OF NEW GATE.

 8 REMOVE EXISTING CHAIN GUARD AND RE-INSTALL AFTER
- 8 REMOVE EXISTING CHAIN GUARD AND RE-INSTALL AFTER PAINTING.
- (9) ATTACH NEW CHAIN TO EXISTING SPOOLS.
- (10) REPLACE CHAIN, MASTER LINK AND COUPLING. NOTE: LIFT LUG AND COUPLING ARE SUBMERGED, DIVING REQUIRED AT EACH LOCATION.



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C BID SET		BWA	PJM	14.10.22
B 95% PLANS		BWA	PJM	14.10.02
A 60% PLANS		BWA	PJM	14.06.05
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GEDDES DAM - TAINTER GATE #4 REPLACEMENT Ann Arbor, Michigan

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NEW WORK PLAN

Project No. 2075129506	Scale AS SHOWN	
Drawing No.	Sheet	Revision
C-301	3 of 8	0

1 - GENERAL NOTES

- A. ALL STRUCTURAL DRAWINGS SHALL BE USED IN CONJUNCTION WITH OTHER PROJECT DRAWINGS AND SPECIFICATIONS.
- B. CONTRACTOR SHALL VERIFY ALL EXISTING CONDITIONS, DIMENSIONS, ELEVATIONS, ETC., IN FIELD AND NOTIFY THE OWNER'S REPRESENTATIVE OF ANY DISCREPANCIES PRIOR TO THE START OF CONSTRUCTION OR SHOP DRAWINGS.
- C. THE DRAWINGS ARE INTENDED TO REQUIRE AND TO INCLUDE ALL LABOR, MATERIAL AND EQUIPMENT PROPER FOR THE
- D. ALL WORK SHALL COMPLY WITH ALL LOCAL, STATE AND NATIONAL CODES AND REQUIREMENTS.
- E. THE CONTRACTOR SHALL BE HELD RESPONSIBLE FOR CONSTRUCTION MEANS, METHODS, TECHNIQUES, SEQUENCES AND SAFETY PROCEDURES. THE ARCHITECT/ENGINEER SHALL NOT BE RESPONSIBLE FOR THE ACTS OR OMISSIONS OF THE CONTRACTOR, SUBCONTRACTORS OR THEIR AGENTS OR EMPLOYEES OR ANY OTHER PERSONS PERFORMING ANY OF THE
- F. OBSERVE ALL OSHA AND OTHER APPLICABLE SAFETY REQUIREMENTS INCLUDING THE USE OF SAFETY GLASSES, HARD HATS, AND PROTECTION OF AREA WHEN WORKING OVERHEAD. THE CONTRACTOR SHALL ASSUME RESPONSIBILITY FOR CONSTRUCTION SAFETY AT ALL TIMES.
- G. COORDINATE WORK OF ALL DISCIPLINES (ARCH., STRUCT., ELECT., ETC.) WITH EXISTING CONDITIONS, SPECIAL REQUIREMENTS, CONSTRUCTION SCHEDULE AND OTHER CONTRACTORS PERFORMING WORK AT THE SITE.
- H. THE CONTRACTOR SHALL DESIGN AND PROVIDE ANY TEMPORARY SHORING, BRACING, ETC., AS NEEDED FOR THE WORK SO AS NOT TO ENDANGER THE STRUCTURAL INTEGRITY OF ANY EXISTING FEATURE.
- I. IT SHALL BE THE CONTRACTOR'S RESPONSIBILITY TO REPAIR ANY DAMAGE DONE TO EXISTING FEATURES AS A RESULT OF THIS WORK. DAMAGED ITEMS SHALL BE REPLACED IN KIND AND AT NO ADDITIONAL COST TO THE OWNER.
- J. SEE SPECIFICATIONS FOR FULL SCOPE OF REQUIREMENTS APPLICABLE TO THIS PROJECT.
- K. SHOP DRAWINGS: REPRODUCTION OF DESIGN DRAWINGS SHALL NOT BE PERMITTED FOR SHOP DRAWING SUBMISSIONS. THE GENERAL CONTRACTOR/CONSTRUCTION MANAGER SHALL REVIEW AND PROVIDE REVIEW STAMP ON SHOP DRAWING SUBMISSIONS PRIOR TO SUBMITTAL TO ARCHITECT/ENGINEER INDICATING UNDERSTANDING AND ACCEPTANCE OF SUBMITTAL AND CONFIRMING CONFORMANCE TO PROJECT PLANS/SPECIFICATIONS.
- L. NO DEBRIS, DEMOLISHED ITEMS, CONSTRUCTION MATERIALS, ETC. SHALL BE PERMITTED TO ENTER THE RIVER. ANY ITEMS FALLING IN THE RIVER SHALL BE RETRIEVED IMMEDIATELY AND REMOVED THE SITE.
- M. TEMPORARY CLOSURES OF OLD GEDDES ROAD SHALL NOT BE PERMITTED.

2 - DESIGN CRITERIA

- A. HORIZONTAL ICE LOAD = 2,000 #/FT.
- B. NORMAL LIFTING PULL = 16,000 # TOTAL.
- C. MAXIMUM OVERLOAD PULL ON SINGLE STOP = 36,400#.

3 - STRUCTURAL STEEL

- A. STRUCTURAL STEEL WORK INCLUDES ALL STRUCTURAL STEEL TO BE FURNISHED AND ERECTED, BEAMS, COLUMNS, CHANNELS, ANGLES, JOISTS, LINTELS, BEARING PLATES, ETC., AS INDICATED ON THE DRAWINGS.
- B. COMPLY WITH THE FOLLOWING CODES AND STANDARDS:
- 1. AISC STEEL CONSTRUCTION MANUAL, ASD, 9TH EDITION 2. AMERICAN WELDING SOCIETY (AWS) DI.1 "STRUCTURAL WELDING CODE STEEL", 2000. 3. CURRENT OSHA ERECTION AND FABRICATION REQUIREMENTS.
- C. MATERIALS:
- 1. BEAMS, GIRDERS AND COLUMNS: ASTM A992 2. ANGLES, BARS AND PLATES: ASTM A572 Gr50.
- 3. TUBE STEEL: ASTM A500, GRADE B Fy=42 KSI 4. PIPE: SCHEDULE 40 CONFORMING TO ASTM A53, GRADE B. U.N.O. 5. HIGH STRENGTH BOLTS: ASTM A 325.
- 6. WELDS: E70XX ELECTRODES.
- D. ALL STRUCTURAL STEEL SHOP CONNECTIONS SHALL BE WELDED AND ALL FIELD CONNECTIONS SHALL BE HIGH-STRENGTH BOLTED UNLESS SHOWN OTHERWISE.
- E. ALL BOLTS SHALL BE TIGHTENED TO THE SNUG TIGHT CONDITION UNLESS NOTED OTHERWISE. SLIP CRITICAL BOLTS SHALL BE USED AT ALL MOMENT CONNECTIONS.
- F. PROVIDE S.S. ANCHORS AND OTHER DEVICES TO BE BUILT INTO CONCRETE WORK.
- G. STEEL SHALL RECEIVE PAINT SYSTEM AS PER PAINT SPECIFICATIONS (SECTION 09900). IT IS ANTICIPATED THAT ALL PAINTING EXCEPT FOR TOUCH UP SHALL BE SHOP PERFORMED, ANY FIELD PAINTING SHALL BE FULLY CONTAINED.
- H. SHOP DRAWINGS: SUBMIT SHOP DRAWINGS INCLUDING COMPLETE DETAILS AND SCHEDULES FOR FABRICATION AND ASSEMBLY OF STRUCTURAL STEEL MEMBERS, PROCEDURES AND DIAGRAMS.
- I. PIPE SCHEDULE DIMENSIONS AS FOLLOWS:

LŁ	DIMENSIONS	AS FOLLOWS:		
	SCH	NOM. SIZE	0.D.	WALL
	80	$2\frac{1}{2}$	2.875	0.276
	80	5	5.563	0.375
	160	8	8.625	0.906

4 - FABRICATION

- A. GATE TO BE SHOP WELDED AND FIELD BOLTED.
- B. ALL WELDS TO BE CONTINUOUS FILLET. RIB TO SKIN PLATE WELDS TO BE 3/16". OTHER WELDS TO BE 1/4" UNLESS NOTED.
- C. ALL CORNERS AND EDGES IN CONTRACT WITH RUBBER SEALS TO BE ROUNDED.
- D. ENDS OF ALL PIPE MEMBERS TO BE CLOSED AND WELDED WATERTIGHT.
- E. FOR TOLERANCES SEE SPECIFICATIONS.
- F. SEALS SHALL BE CONTINUOUS, WATERTIGHT AND SPLICES IF REQUIRED SHALL BE VULCANIZED.
- G. SKIN PL JOINTS TO BE WATERTIGHT, FULL PENETRATION BEVEL BUTT WELDS WELDED FROM BOTH SIDES. WELDS TO BE GROUND FLUSH WHERE IN CONTACT WITH SEALS.
- H. ALL SURFACE FINISHES SPECIFIED IN µ-INCHES (MICRONS) TEXTURE.
- SURFACE FINISH ON BEARING PINS FOR RUNNING FIT SUBJECT TO RECOMMENDATIONS OF BEARING MANUFACTURER. GATE FABRICATOR SHALL COORDINATE WITH BEARING MANUFACTURER.
- J. UNLESS NOTED OTHERWISE, FAYING SURFACES SHALL BE FINISHED TO 125µ-INCHES.



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A 60% PLANS		BWA	PJM	14.06.05
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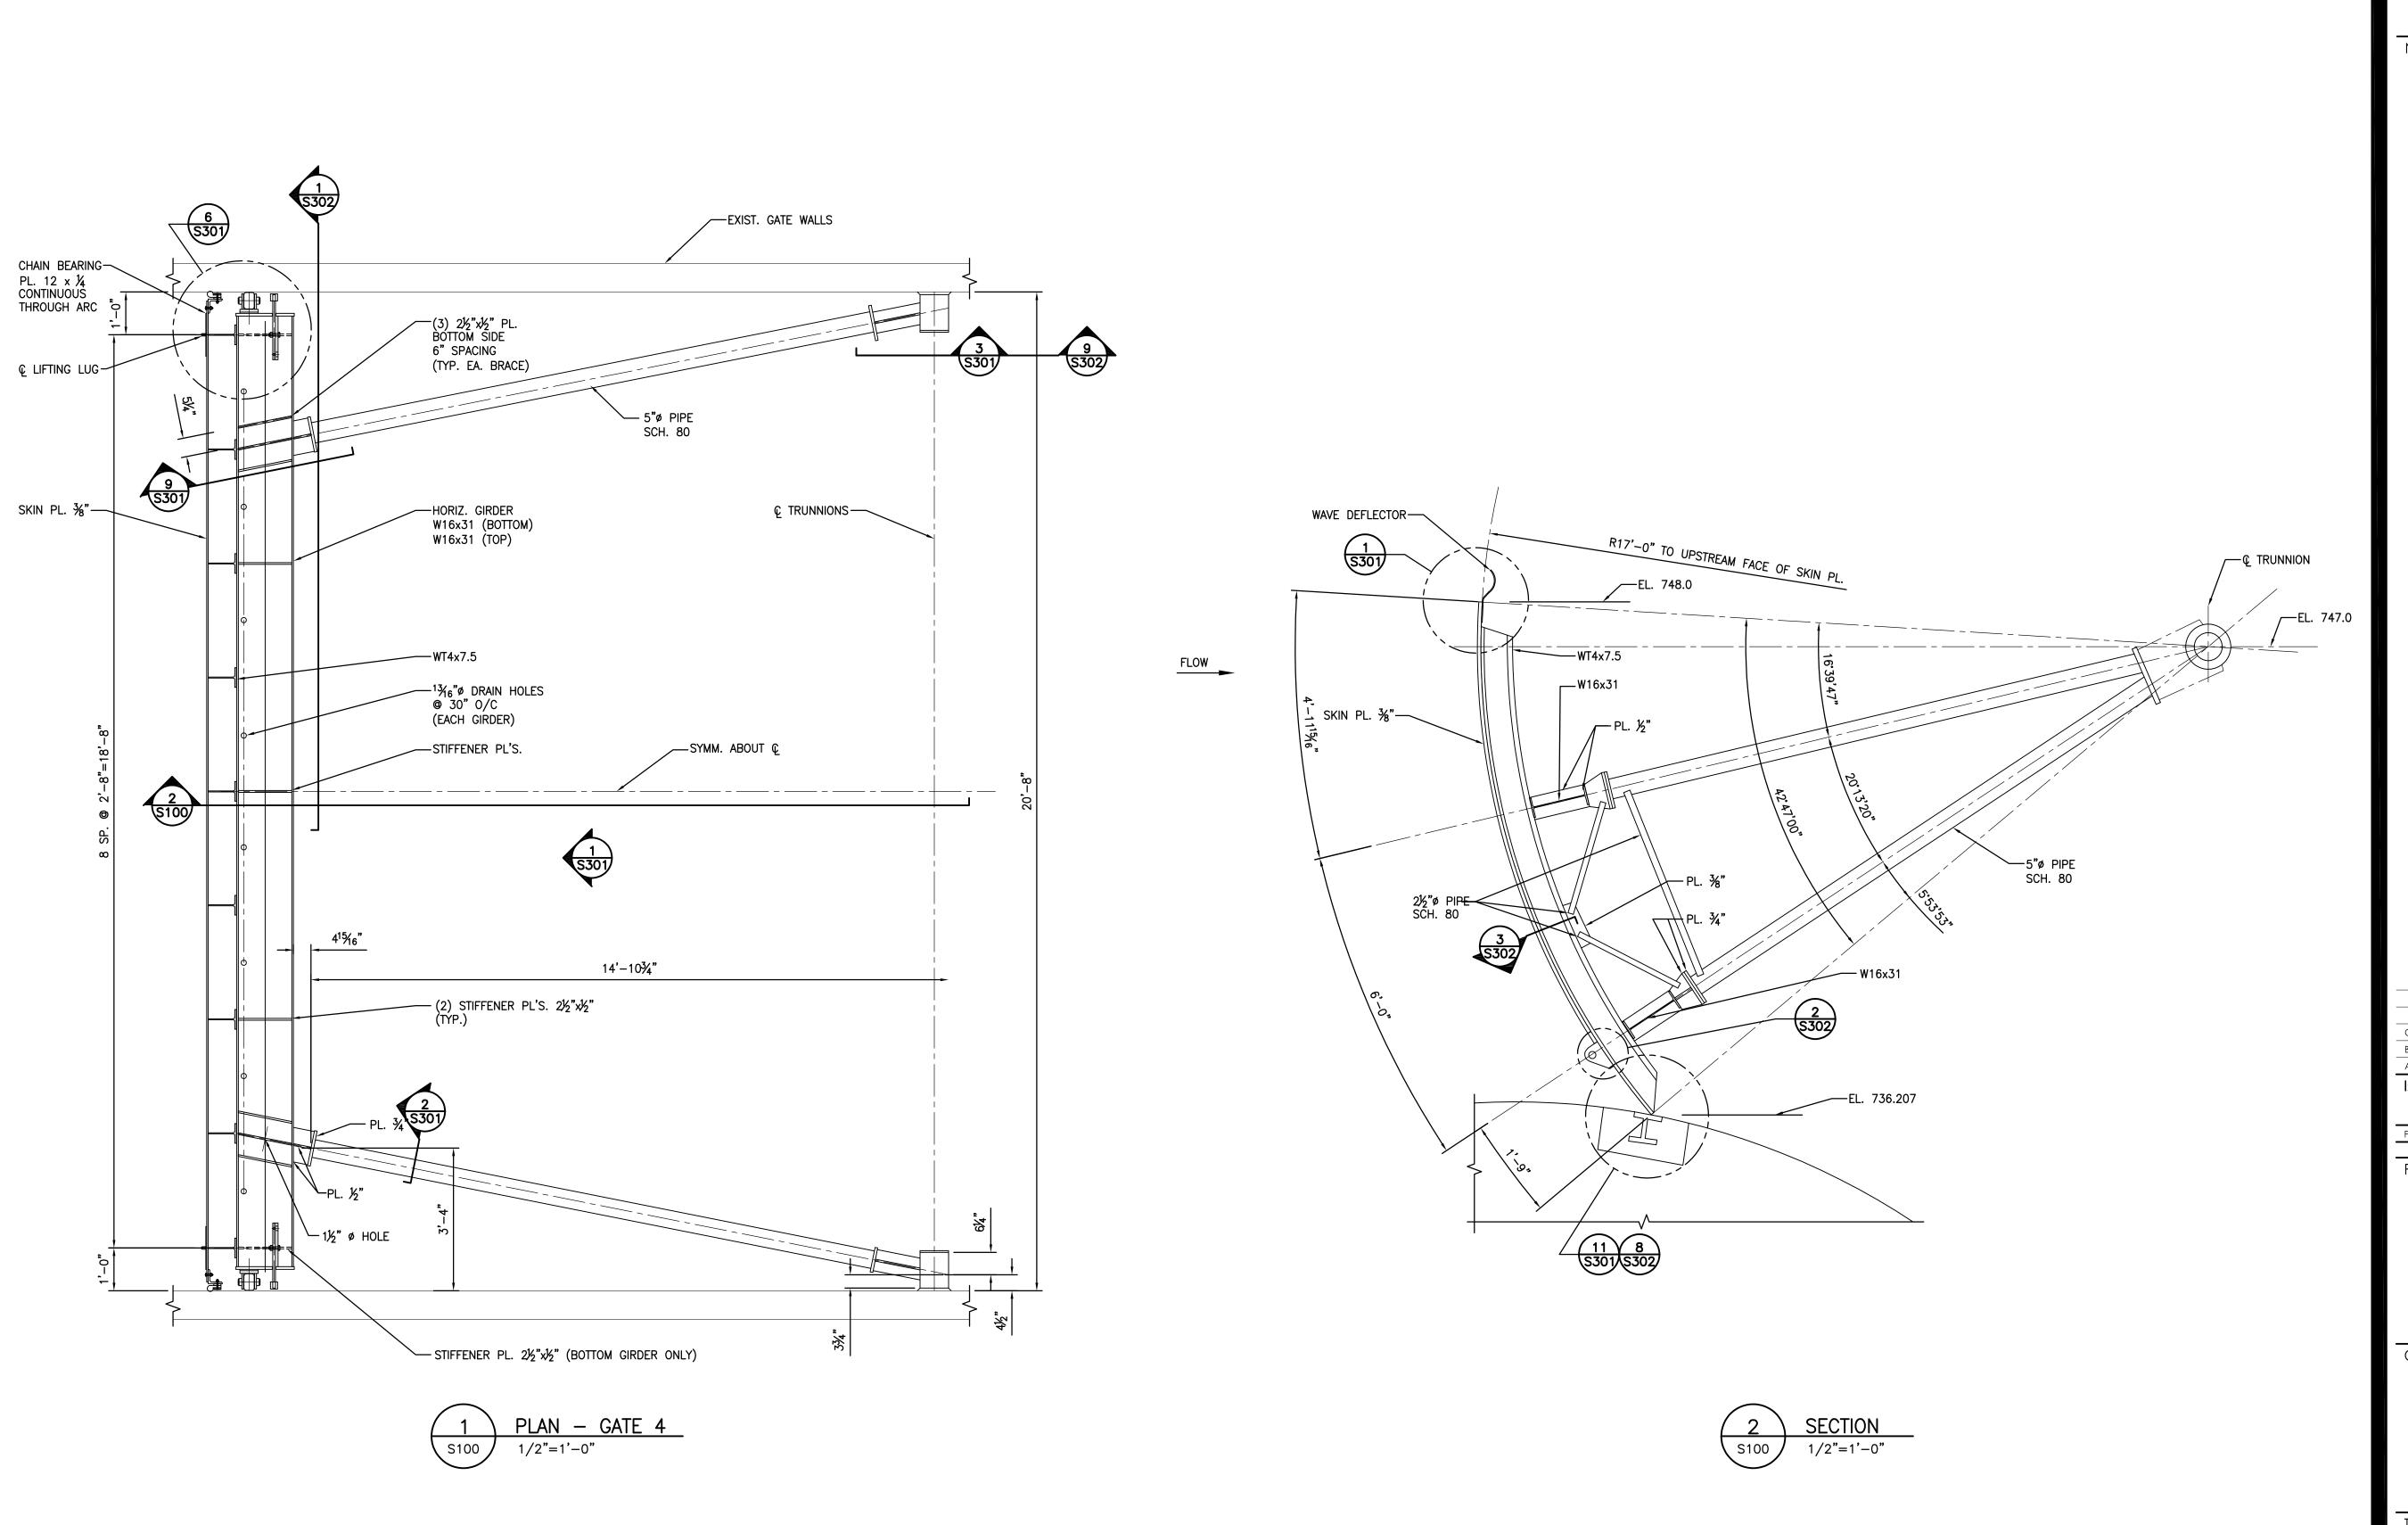
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NOTES

Project No.	Scale	
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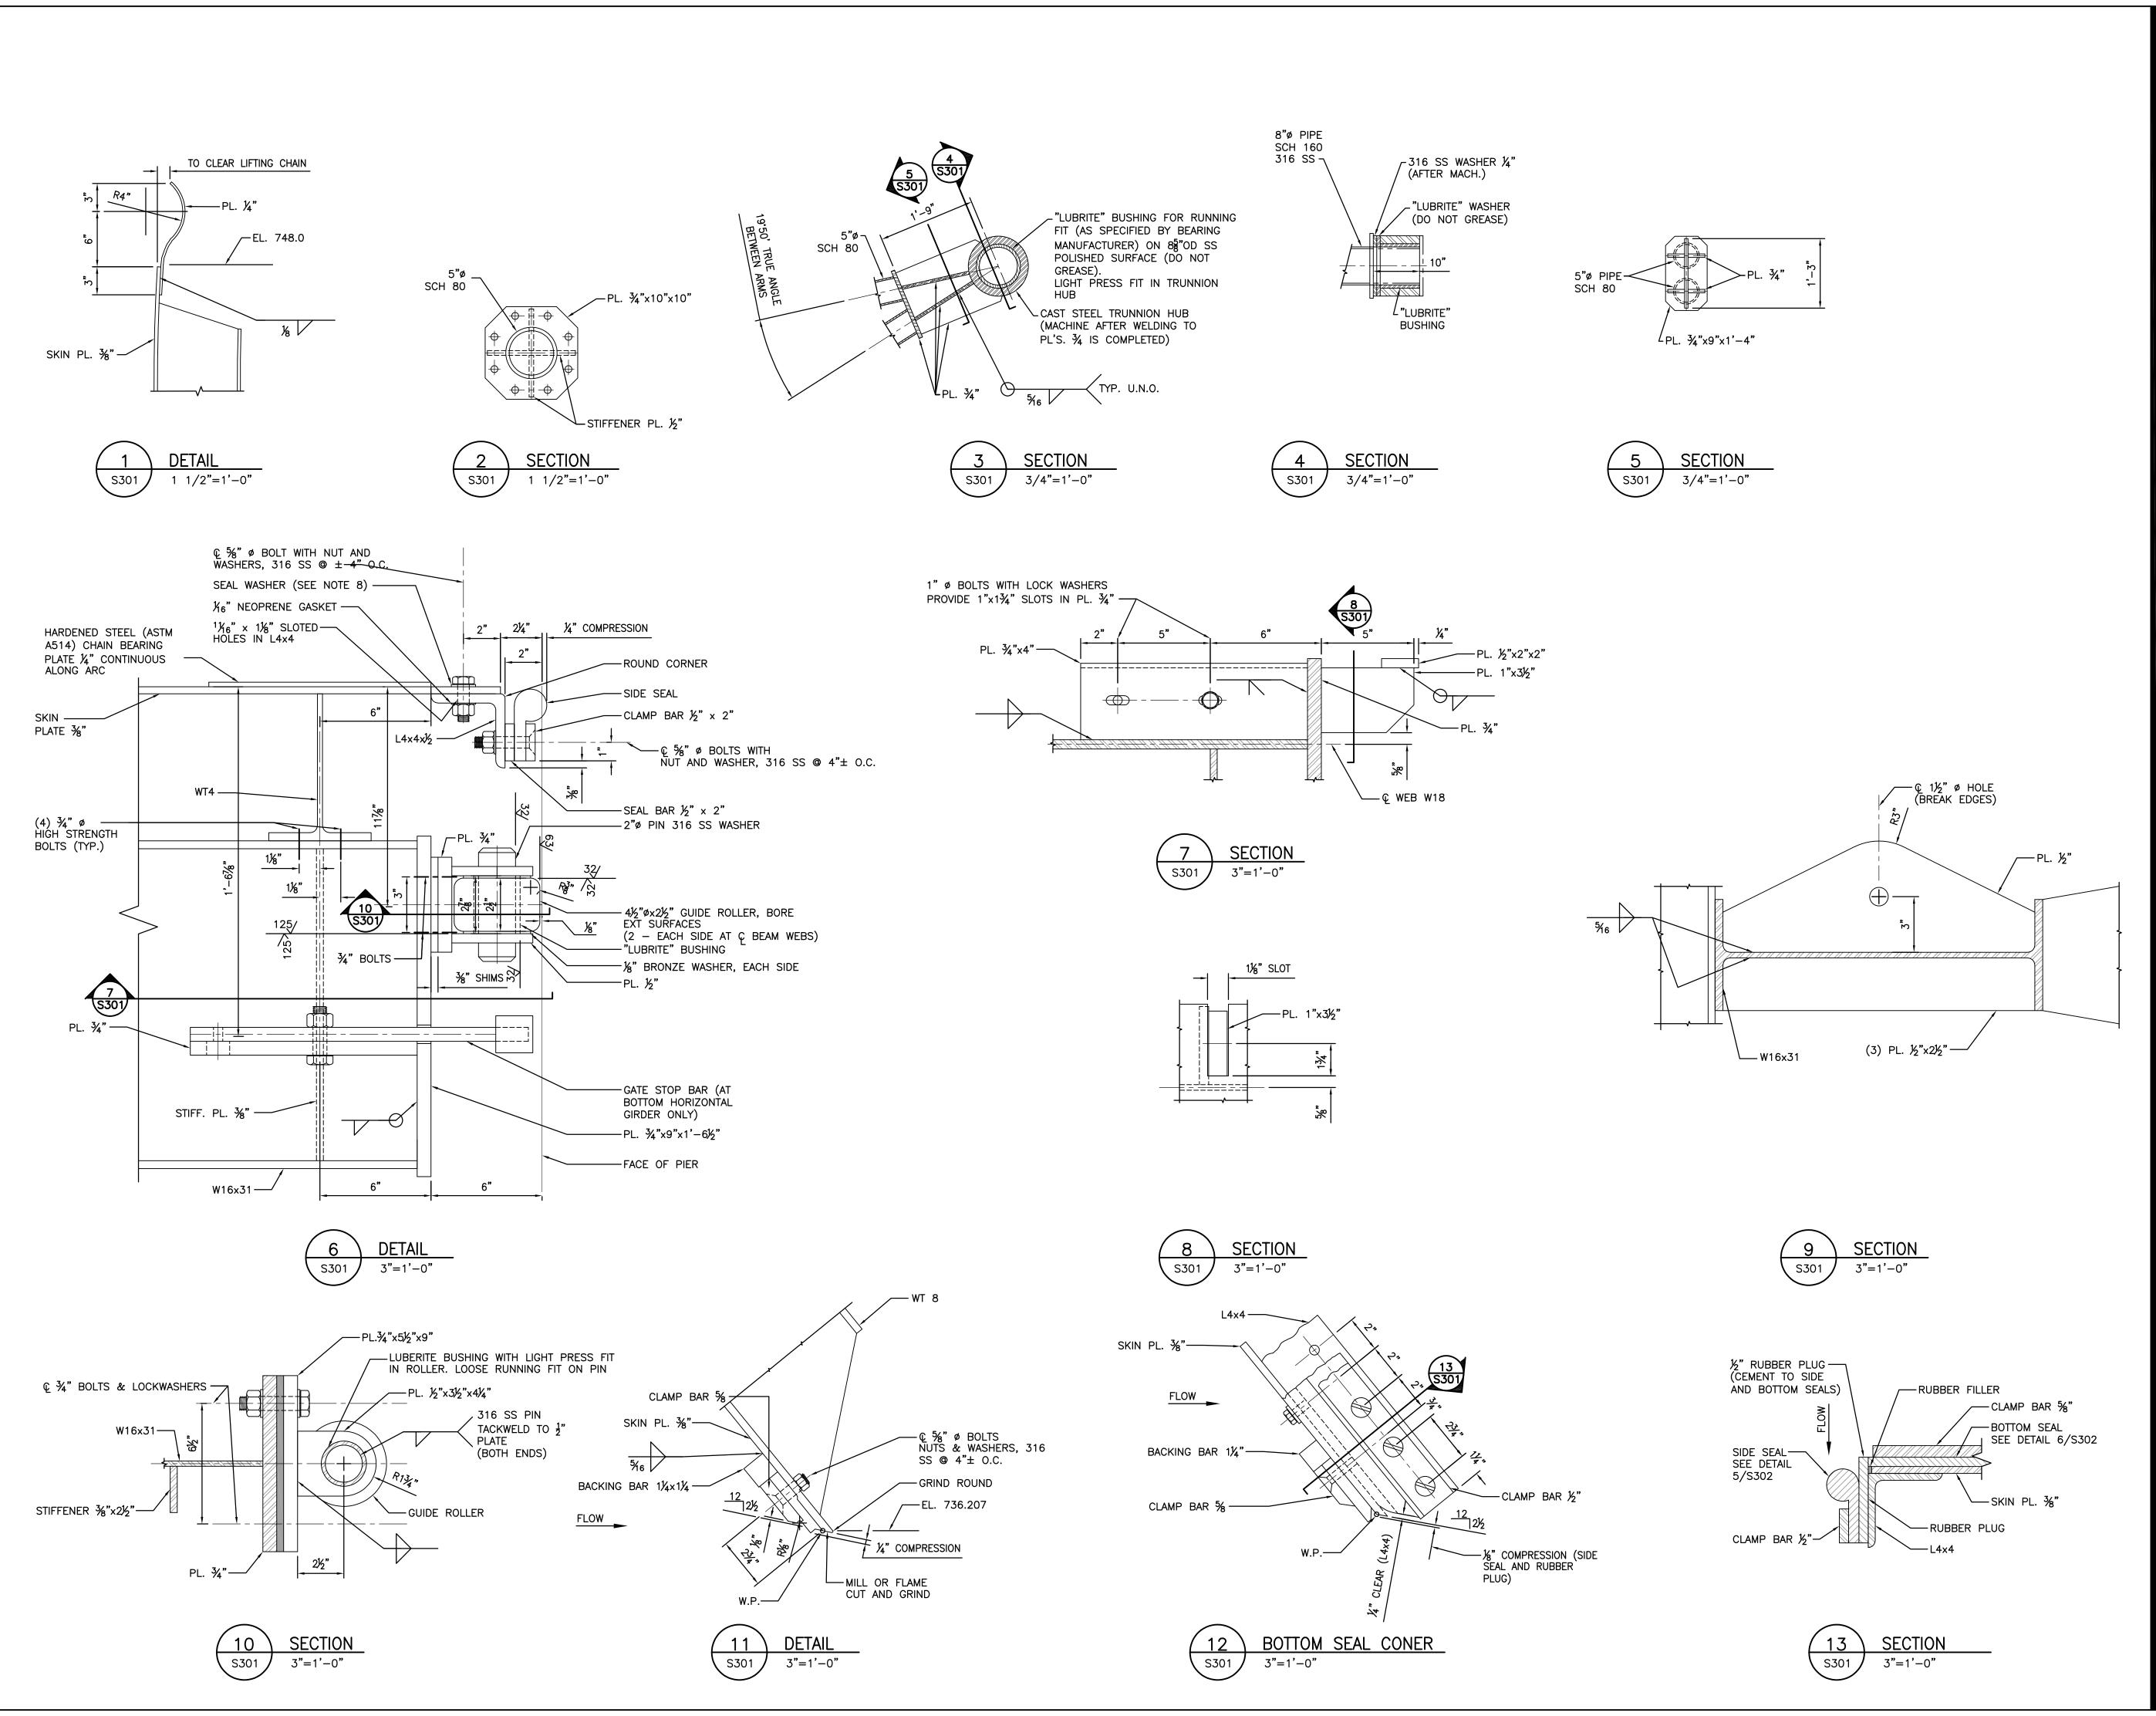
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GEDDES DAM - TAINTER GATE #4 REPLACEMENT Ann Arbor, Michigan

PLAN & SECTION

Project No.	Scale	
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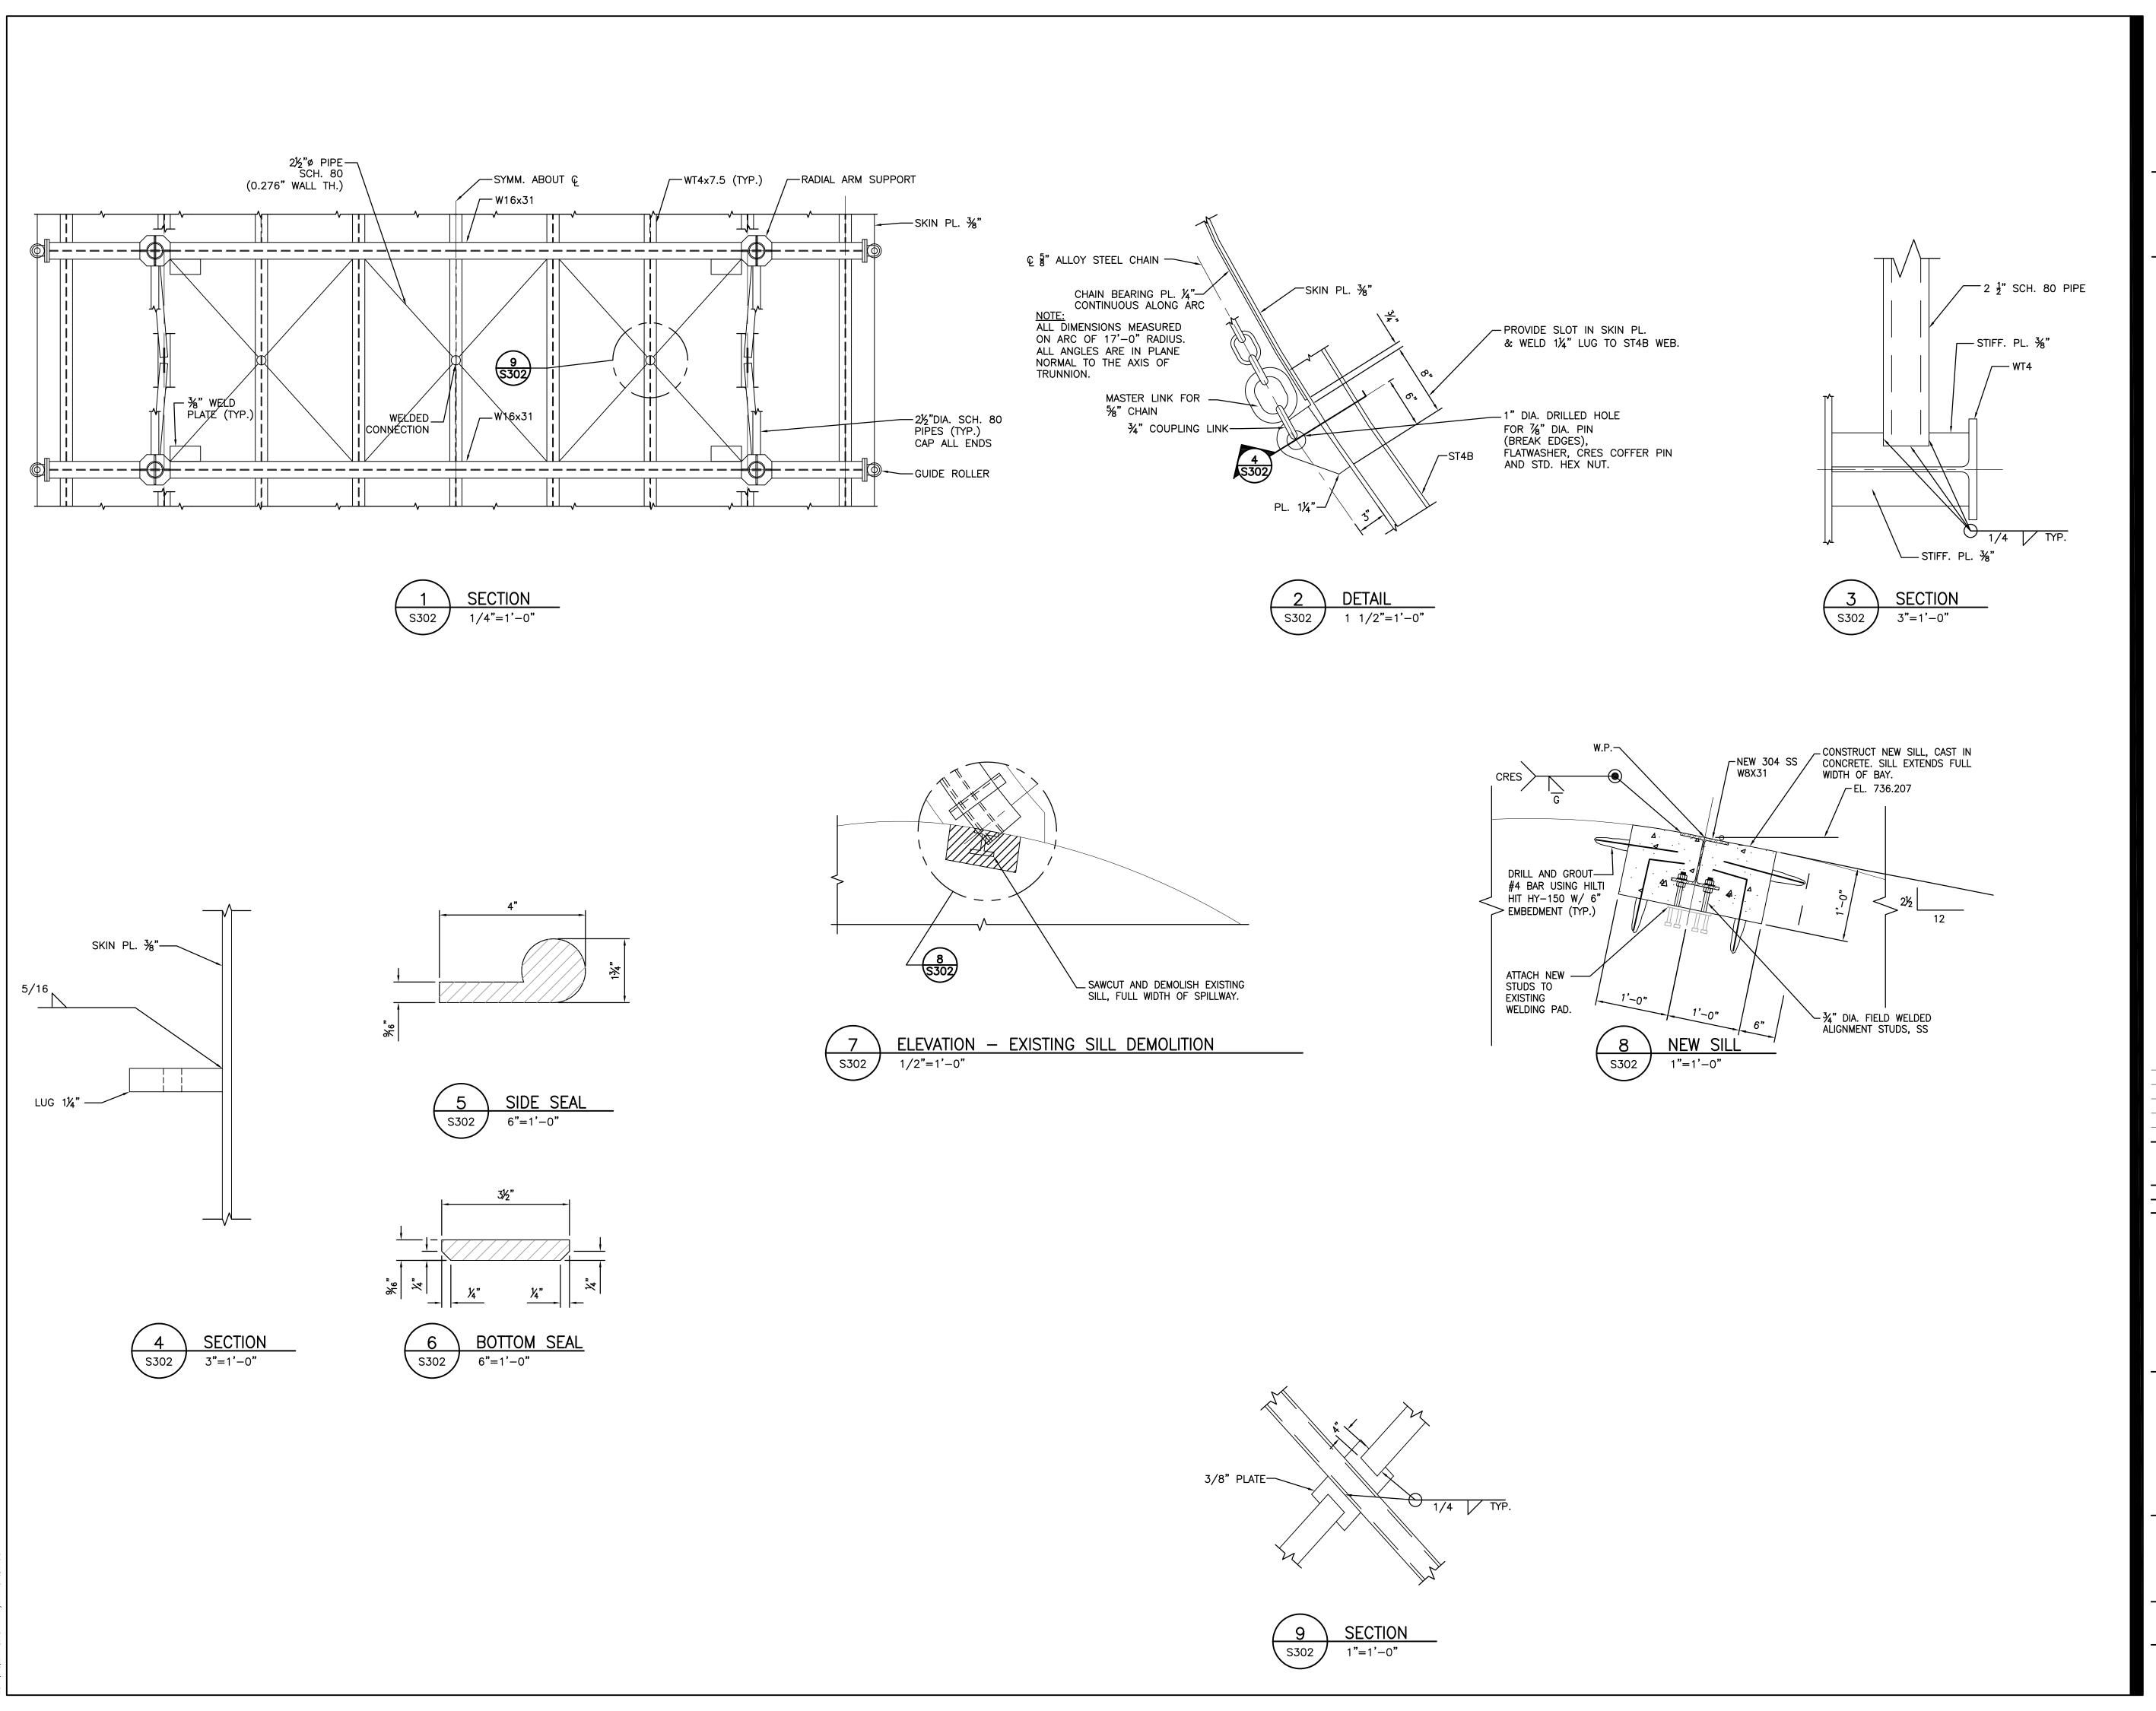
CITY OF ANN ARBOR

GEDDES DAM - TAINTER GATE #4 REPLACEMENT Ann Arbor, Michigan

Title

SECTIONS & DETAILS I

Project No. 2075129506	Scale	
Drawing No.	Sheet	Revision
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A 60% PLANS	BWA	PJM	14.06.05
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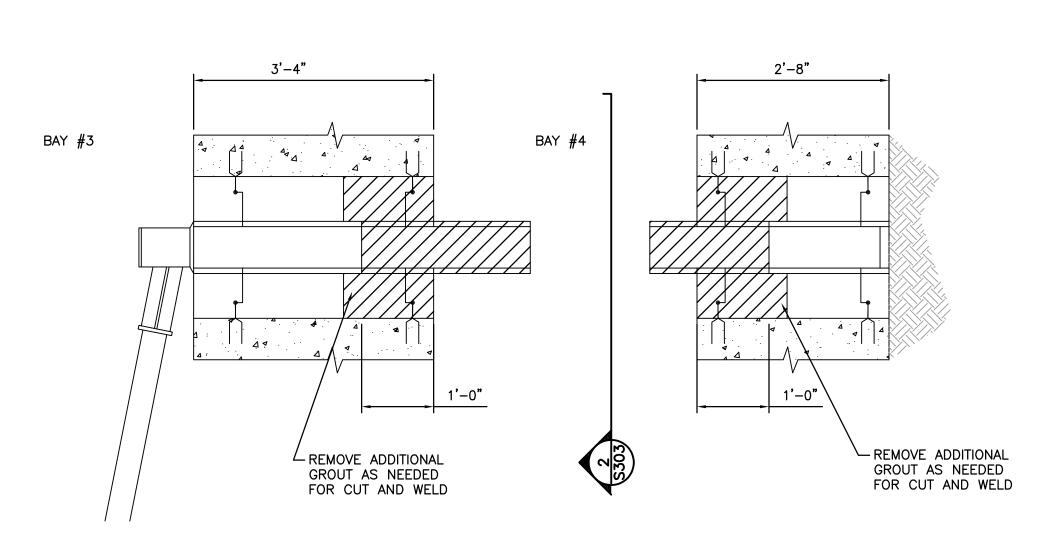
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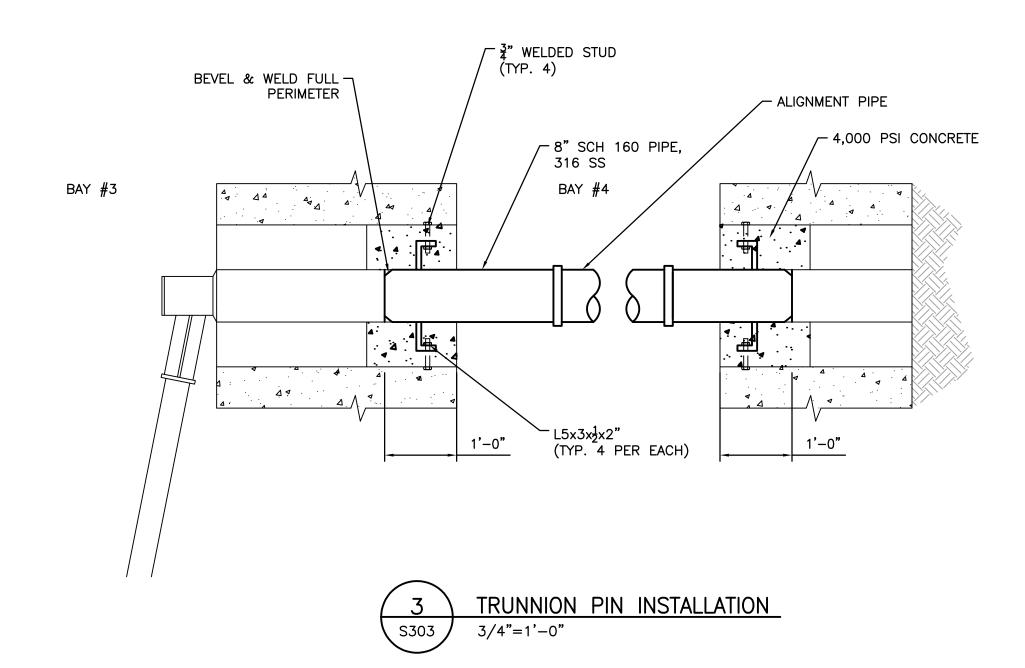
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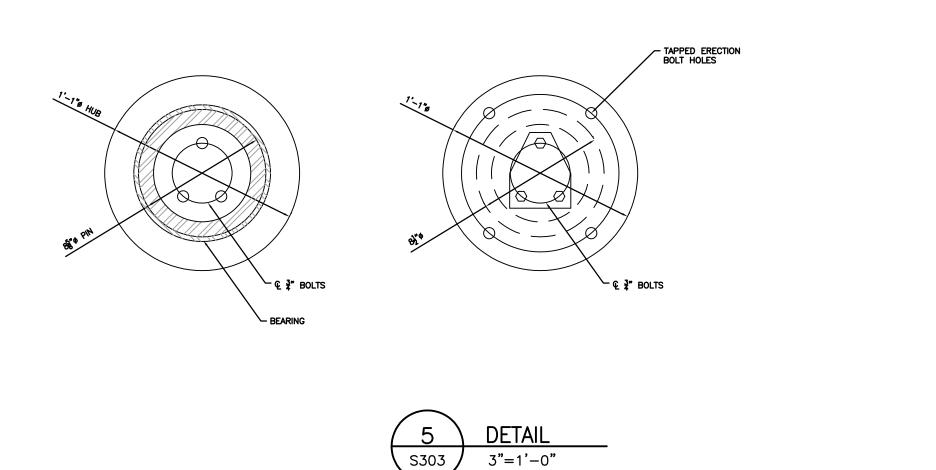
SECTIONS & DETAILS II


Project No. 2075129506	Scale	
Drawing No.	Sheet	Revision
S-302	7 of 8	0





1 TRUNNION PIIN DEMOLITION S303 3/4"=1'-0"





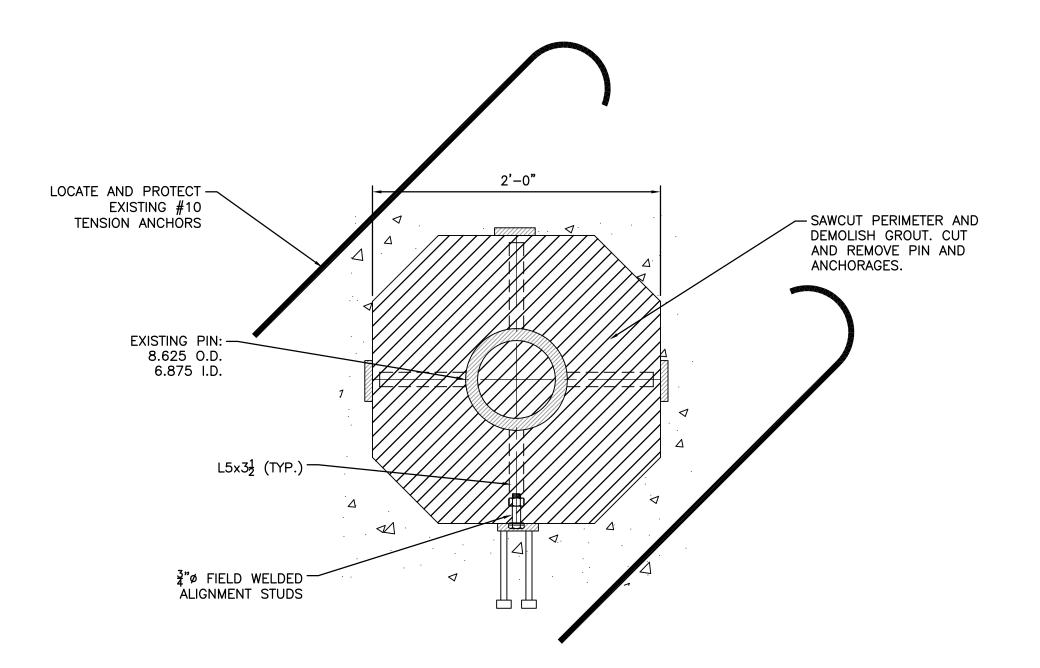

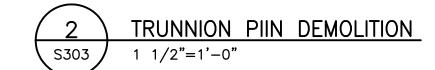

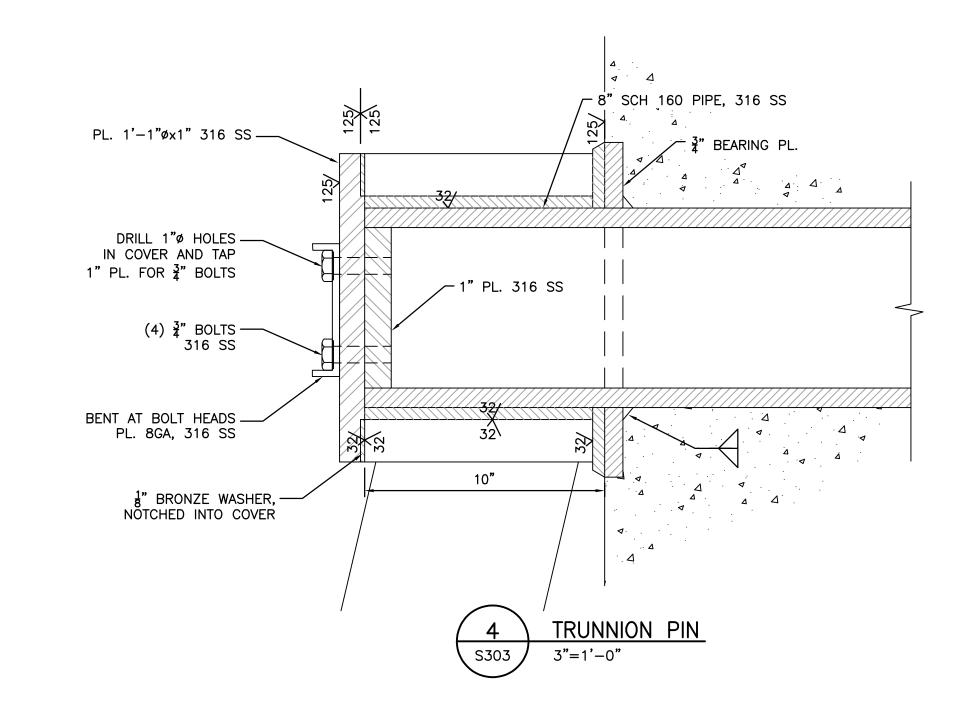



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Title

SECTIONS & DETAILS III

Project No.	Scale	
2075129506		
Drawing No.	Sheet	Revision
S-303	8 of 8	\cap