Ann Arbor, Michigan RFP Number 25-48

Issued for Bids and Construction October 7, 2025

Project Number: 160804

File Number 26001



11snbeck.com 800.456.3824 1515 Arboretum Drive Grand Rapids, Michigan

GENERAL

G101 COVER SHEET G102 SITE LAYOUT

DEMOLITION

D401 DEMOLITION PLAN
D402 DEMOLITION SECTION

PROCESS

P001 DETAILS
P201 PIPING PLAN



SCALE: NOT TO SCALE


SEAL

GRAPHIC SYMBOLS


ELEVATION, SECTION AND DETAIL DESIGNATION






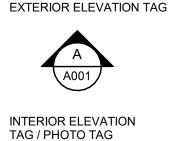





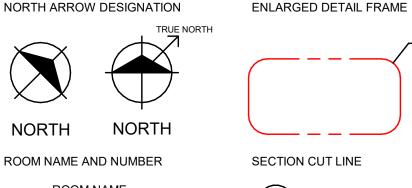

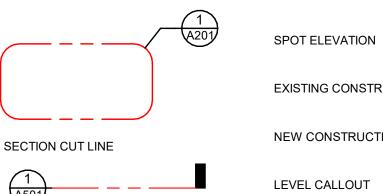

ELEVATION TARGET

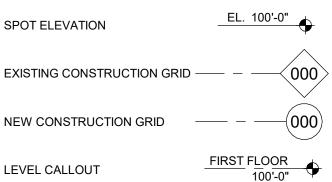

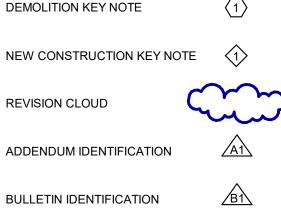

BUILDING CODE INFORMATION

FSPBCCK
Engineers | Architects | Scientists | Constructor

In Arbor

Ann Arbor, Michigan

REVISIONS

Drawn By RSECORD
Designer AWADE
Reviewer JSIWEK
Manager BDPHILLIPS

Hard copy is intended to be 24"x36" when plotted. Scale(s) indicated and graphic quality may not be accurate for any other size.

PROJECT NO. 160804

SHEET NO.

G101

WORK AREA

SITE LAYOUT SCALE: NOT TO SCALE

Arbor of City

REVISIONS

locculation

10/7/2025 BIDS AND CONSTRUCTION

Drawn By RSECORD Designer AWADE Reviewer JSIWEK

Manager BDPHILLIPS

Hard copy is intended to be 24"x36" when plotted. Scale(s) indicated and graphic quality may not be accurate for any other size.

PROJECT NO. 160804

SHEET NO.

G102

SYMBOL LEGEND

PROCESS DEMOLITION NOTES

DEMOLITION DRAWINGS.

1. PROCESS DEMOLITION NOTES APPLY TO ALL PROCESS

EQUIPMENT AND PIPING TO BE REMOVED (PATTERN MAY BE ROTATED FOR READABILITY)

Improvements

Gallery TION PLAN

4/5 MOLIT

C

Drawn By RSECOR
Designer AWADE
Reviewer JSIWEK

Manager BDPHILLIPS

Hard copy is intended to be 24"x36" when plotted. Scale(s) indicated and graphic quality may not be accurate for any other size.


PROJECT NO.

160804

SHEET NO.


D401

© Copyright 2025 All Rights Reserved

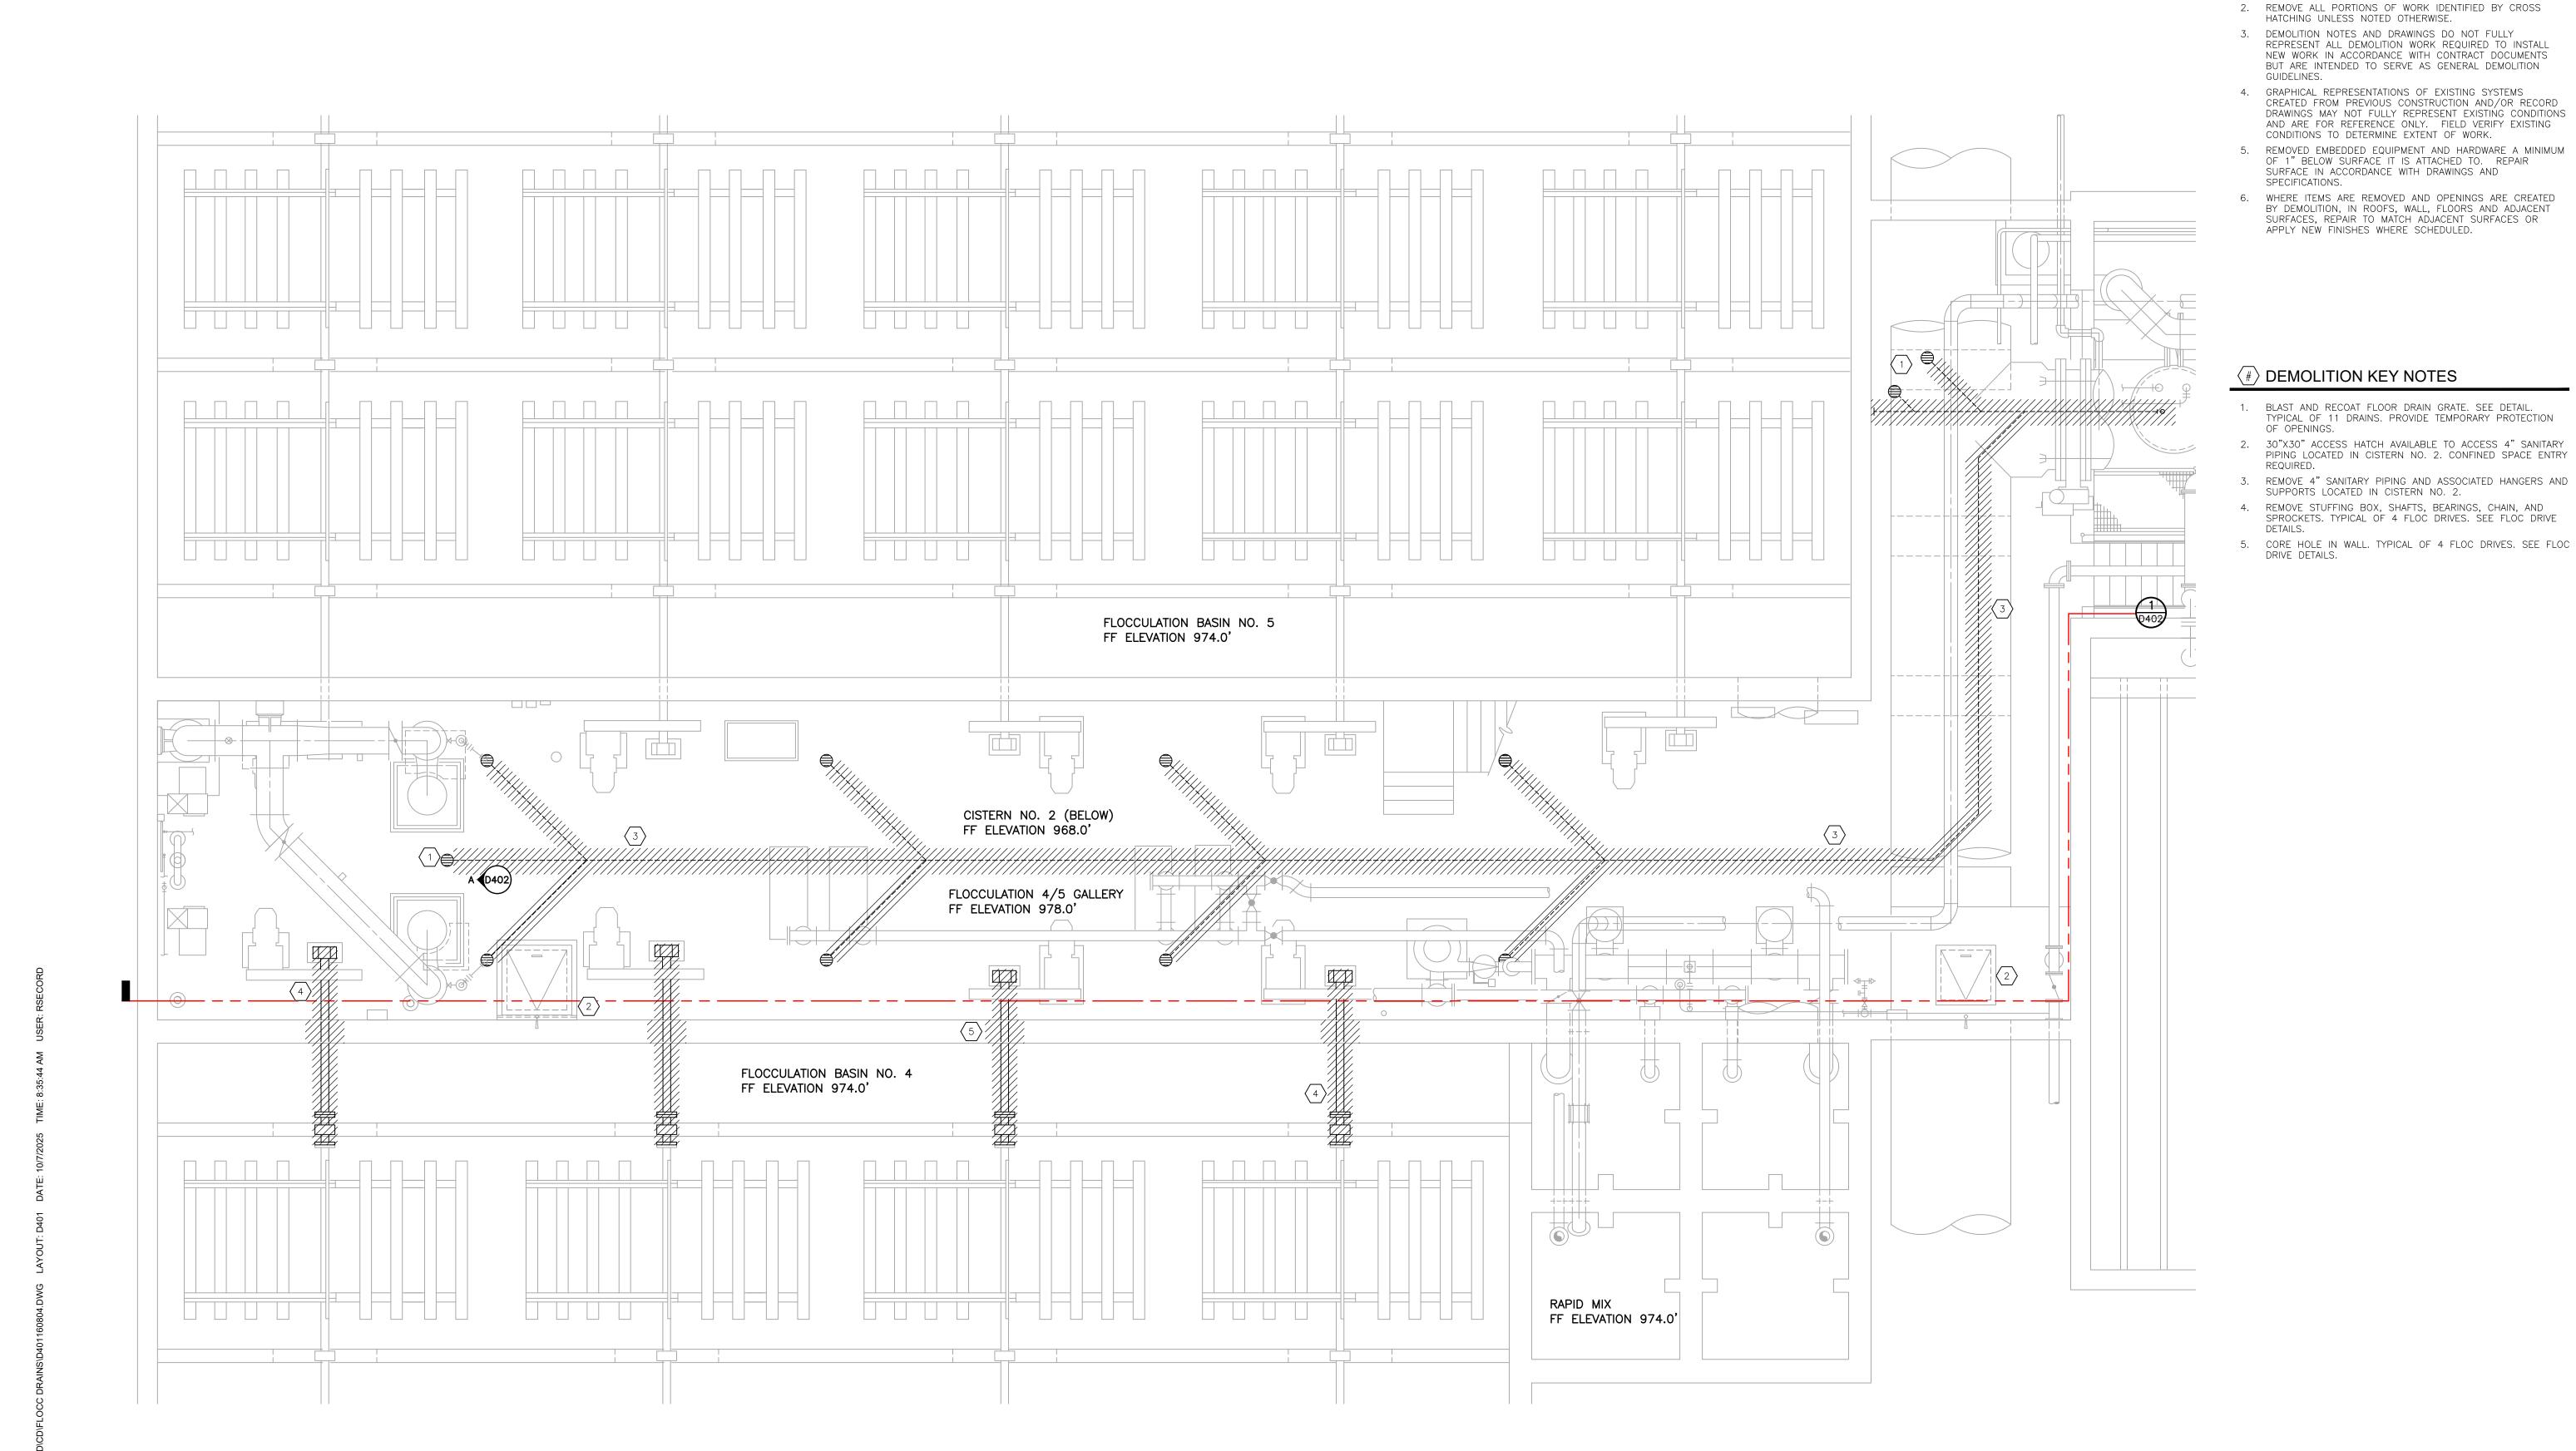

DEMOLITION PLAN

SCALE: 1/4" = 1'-0"

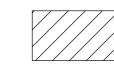

EQUIPMENT AND PIPING TO BE REMOVED (PATTERN MAY BE ROTATED FOR READABILITY)

DEMOLITION KEY NOTES

- BLAST AND RECOAT FLOOR DRAIN GRATE. SEE FLOOR DRAIN DETAIL. TYPICAL OF 11 DRAINS.
- 2. 30"X30" ACCESS HATCH AVAILABLE TO ACCESS 4" SANITARY
- 3. UPSIZE AND REUSE EXISTING PENETRATION FOR NEW 6" SANITARY PIPING.
- 4. REMOVE 4" SANITARY PIPING AND ASSOCIATED HANGERS AND SUPPORTS.
- 5. CLEAN AND RECOAT EXISTING CASTING IN PLACE. SEE FLOOR DRAIN DETAIL. TYPICAL OF 11 DRAINS.



FLOCCULATION 4/5 GALLERY PIPE GALLERY
EL. 978'-0" CISTERN NO. 2 CISTERN

EL. 968'-0"



Arbor City

REVISIONS

10/7/2025 BIDS AND CONSTRUCTION

Drawn By Designer


Reviewer

Manager BDPHILLIPS


Hard copy is intended to be 24"x36" when plotted. Scale(s) indicated and graphic quality may not be accurate for any other size.


PROJECT NO. 160804

SHEET NO.

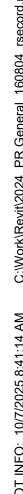



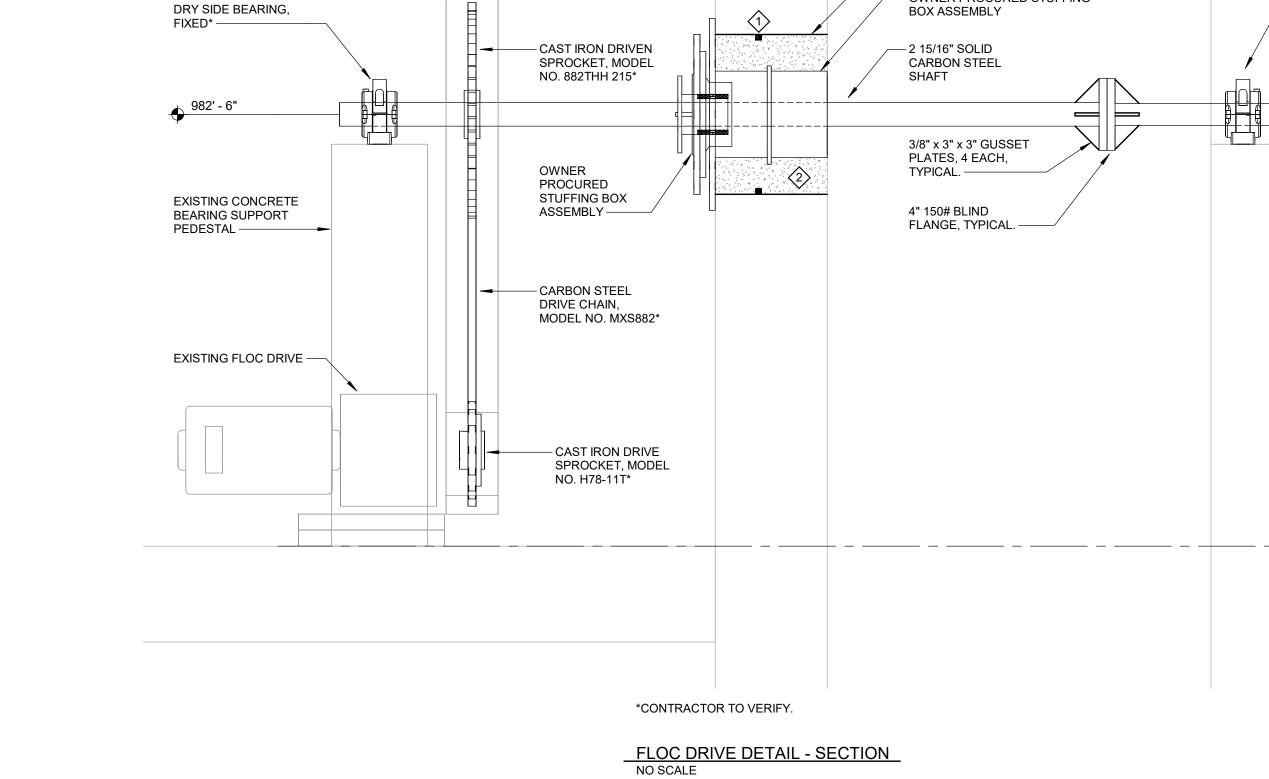

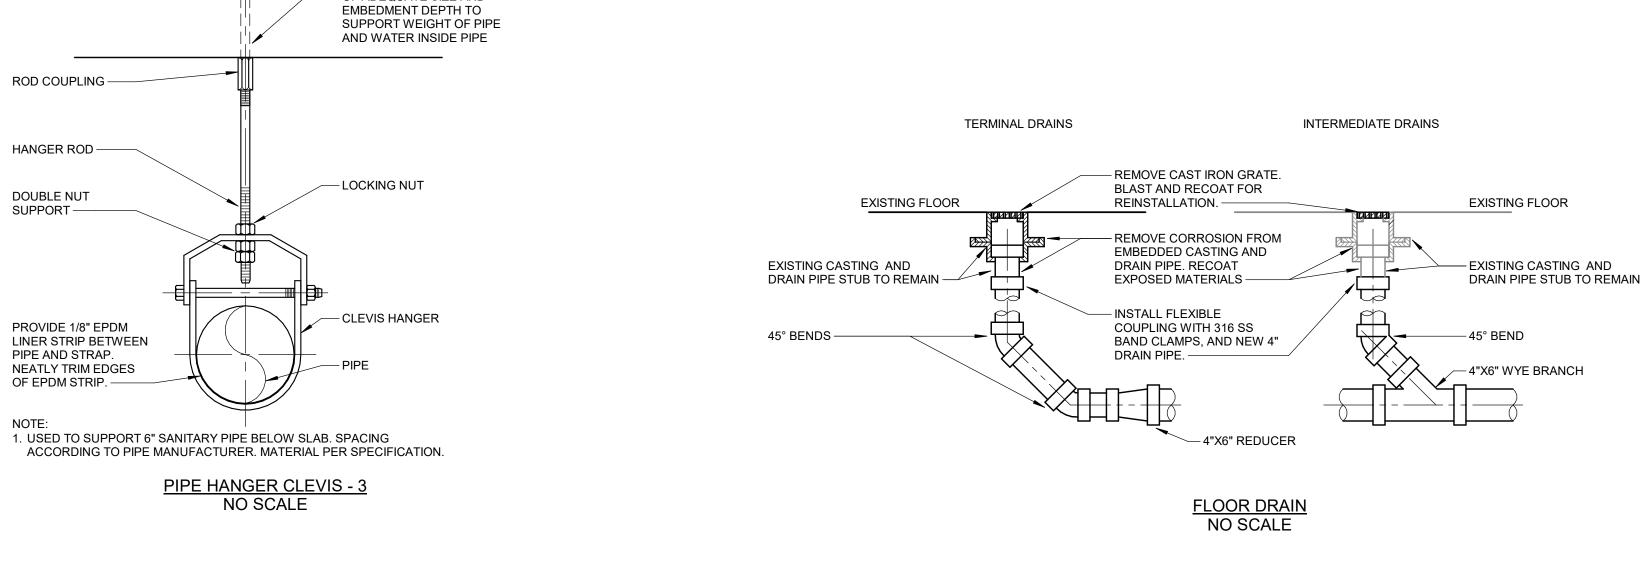

– 24" CIRCULAR CORED OPENING THROUGH EXISTING CONCRETE WALL


— SUBMERGED 2 3/4" BEARING, FLOATING*


— 2 3/4" SOLID CARBON

STEEL SHAFT

OWNER PROCURED STUFFING


PROVIDE ADHESIVE ANCHORS
OF ADEQUATE SIZE AND

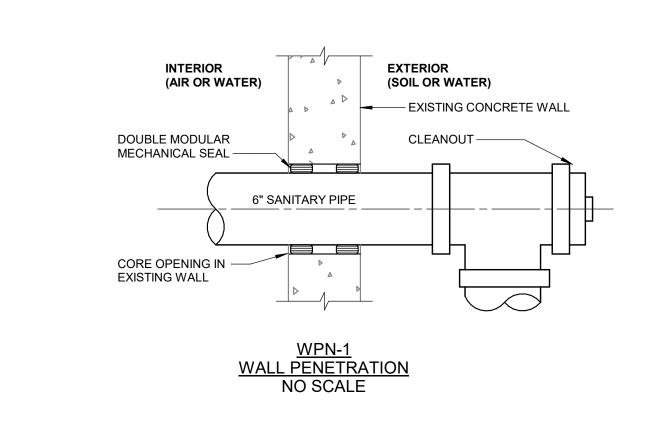

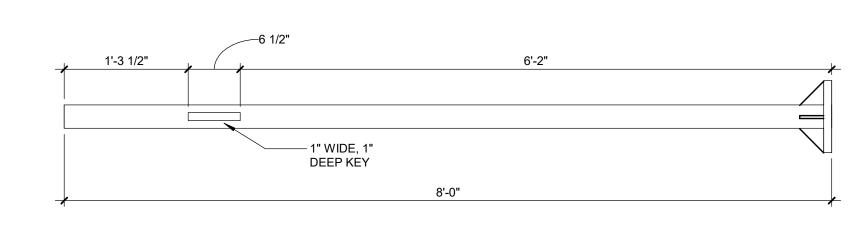

- PROVIDE WATERPROOF BEAD ADHERED TO EXISTING CONCRETE FACE. PROVIDE 3" MINIMUM COVER.
- 2 GROUT STUFFING BOX AFTER ALIGNMENT OF SHAFT.

DRIVE SHAFT DETAIL
NO SCALE

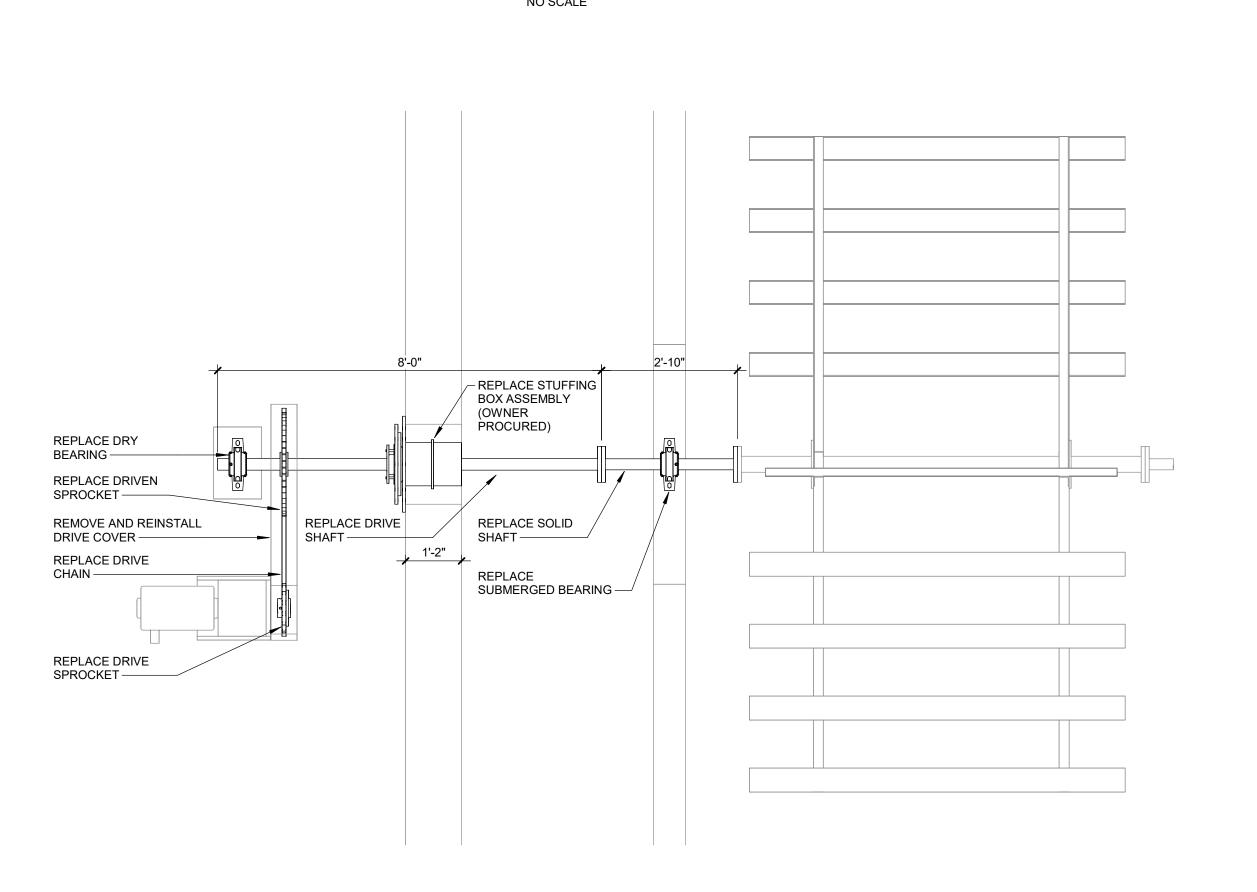

FLOC DRIVE DETAIL - PLAN
NO SCALE

Arbor of City

Gallery FALLS

REVISIONS

10/7/2025 BIDS AND CONSTRUCTION

Drawn By RSECORD Designer AWADE Reviewer JSIWEK

Manager BDPHILLIPS

Hard copy is intended to be 24"x36" when plotted. Scale(s)

indicated and graphic quality may not be accurate for any other size.

PROJECT NO. 160804

SHEET NO.

4/5 Gallery Improvements

locculation

Reviewer JSIWEK

Manager BDPHILLIPS Hard copy is intended to be


24"x36" when plotted. Scale(s) indicated and graphic quality may not be accurate for any other size.

> PROJECT NO. 160804

SHEET NO.

P201

©Copyright 2025 All Rights Reserved

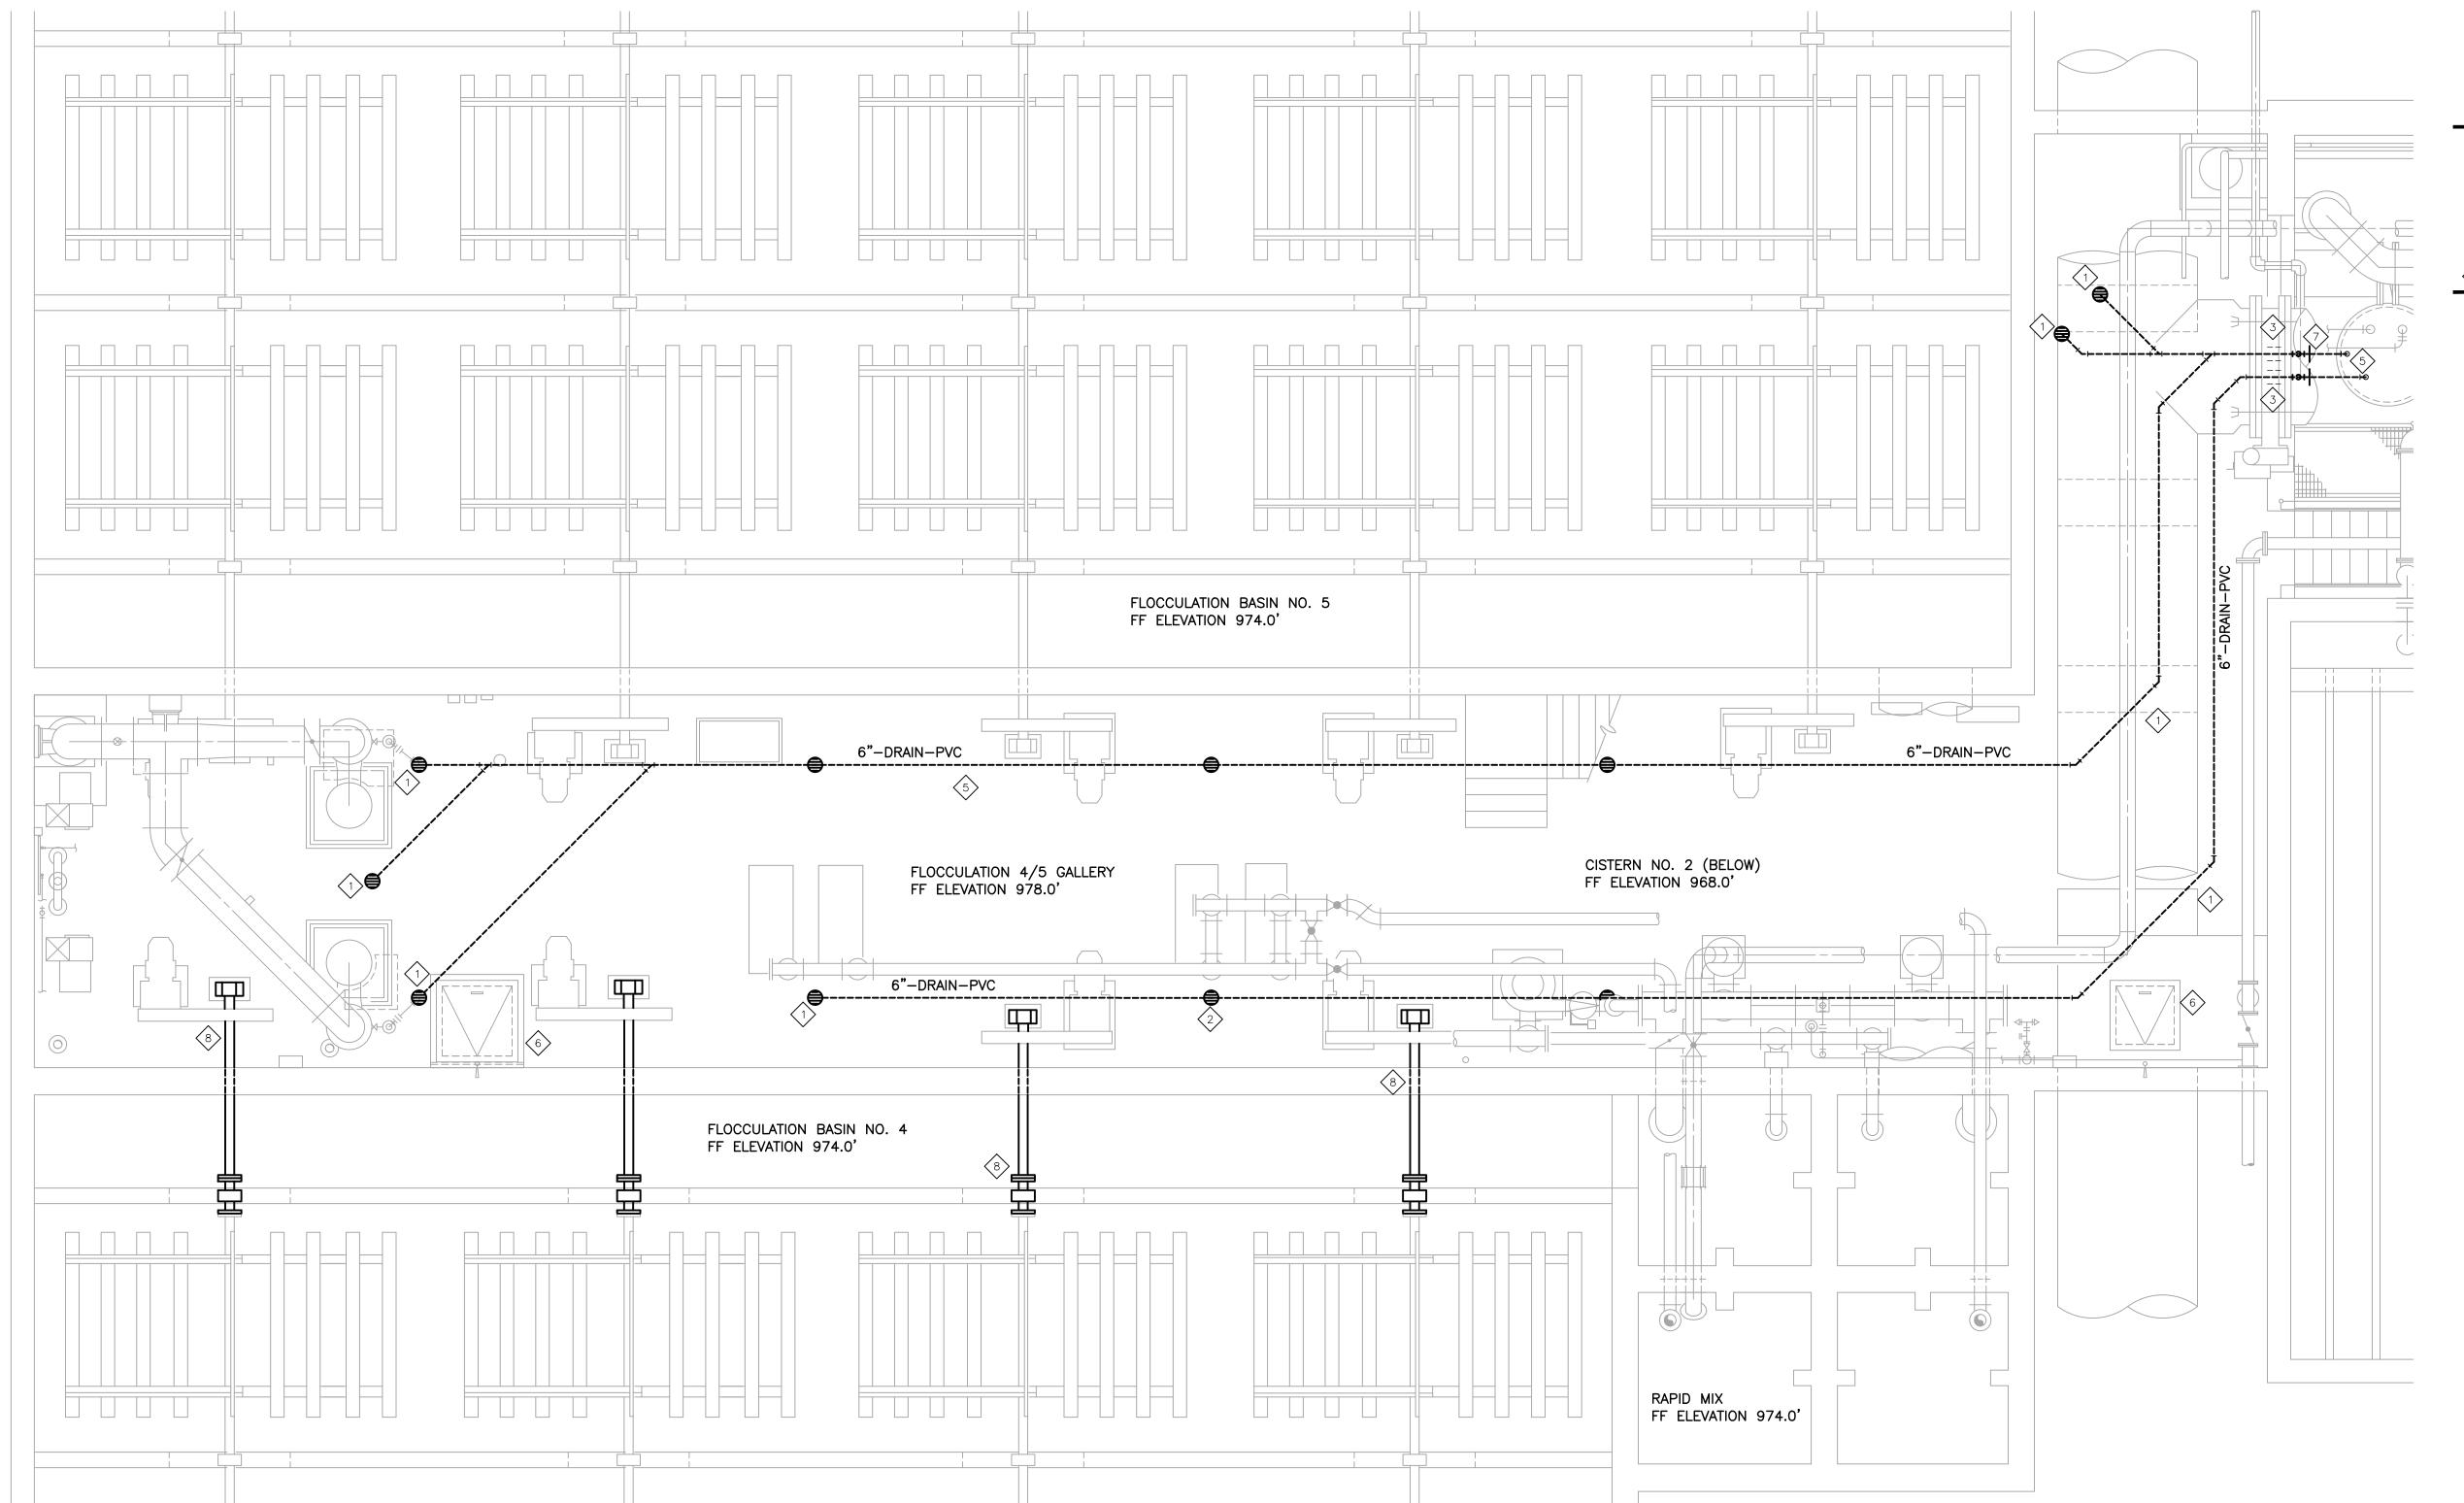

NOTES

EXISTING PIPE ROUTING SHOWN IS APPROXIMATE. FIELD VERIFY.

KEY NOTES

- 1. TERMINAL DRAIN, SEE DETAIL.
- 2. REINSTALL RECOATED DRAIN GRATE. SEE FLOOR DRAIN DETAIL. TYPICAL OF 11 DRAINS.
- 4. ROUTE DRAIN PIPING TO EXISTING SUMP.

- 7. TEE AND CLEANOUT AT WALL PENETRATION. SEE WALL
- 8. INSTALL NEW STUFFING BOX, SHAFTS, BEARINGS, CHAIN, AND SPROCKETS. TYPICAL OF 4 FLOC DRIVES. SEE FLOC DRIVE DETAILS.

3. PIPE PENETRATION, SEE WALL PENETRATION DETAIL.

5. 6" PVC DRAIN PIPING AT MINIMUM 1/8" PER 1 FOOT SLOPE LOCATED IN CISTERN NO. 2. SUPPORT PIPING FROM SLAB. SEE CLEVIS DETAIL.

6. 30"X30" ACCESS HATCH AVAILABLE FOR ACCESS IN CISTERN NO. 2 BELOW SLAB. CONFINED ENTRY REQUIRED.

PENETRATION DETAIL.

PIPING PLAN SCALE: 1/4" = 1'-0"