

CITY OF ANN ARBOR PROJECT MANAGEMENT

2014 ANNUAL RESURFACING PROGRAM

BID No. 4325, FILE No. 2014004


SHEET INDEX			
SHEET NO.	TITLE	MAP NO. (THIS SHEET)	
1	COVER SHEET		
2	TRAFFIC CALMING DETAILS		
3-11	Washington St.	1	
12-16	Linwood Ave.	2	
17-19	Northside Grill Alley	3	
20-39	Fuller Rd.	4	
40-46	Vinewood Dr.	5	
*	Larchmont St.	6	
*	Pomona St.	7	
*	Wells St.	8	
47-50	Steeplechase St.	9	
51-53	St. Aubin	10	
5479	Newport Rd.	11	
80-84	Woodbury Dr.	12	
85-89	Prairie St.	13	
90-91	Burlington Ct.	14	
92-102	Waldenwood Dr.	15	

- * See Traffic Calming Details.

 ** 887 Manhattan Dr., Driveway Repair.

WASTE COLLECTION SCHEDULE

STREET	COLLECTION DAY
Washington St.	MONDAY
Linwood Ave.	FRIDAY
Northside Grill Alley	WEDNESDAY
Fuller Rd.	WEDNESDAY
Vinewood Dr.	WEDNESDAY
Larchmont St.	TUESDAY
Pomona St.	FRIDAY
Wells Rd.	TUESDAY
Steeplechase St.	THURSDAY
St. Aubin	MONDAY
Newport Rd.	FRIDAY
Woodbury Dr.	MONDAY
Prairie St.	WEDNESDAY
Burlington Ct.	TUESDAY
Waldenwood Dr.	TUESDAY
Manhattan Dr.	THURSDAY

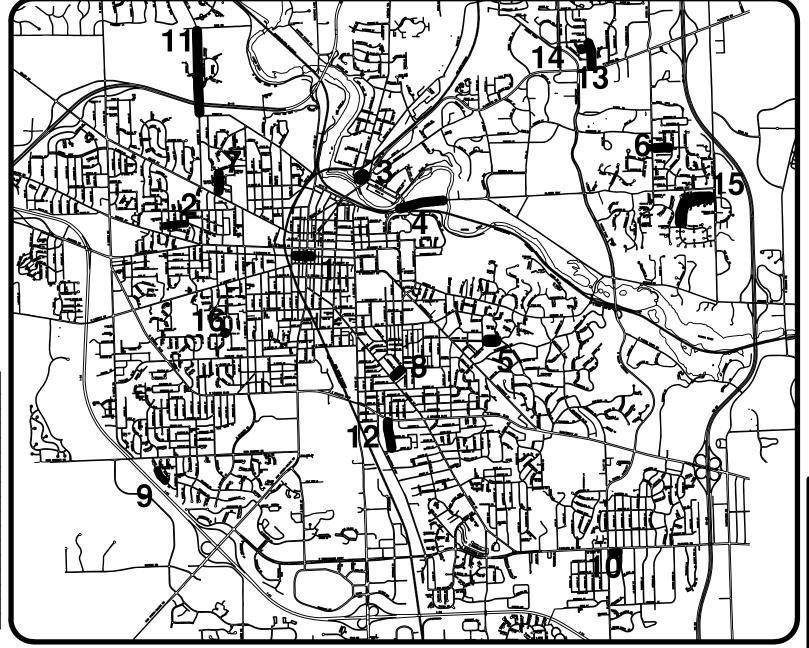

THE CONSTRUCTION COVERED BY THESE PLANS SHALL CONFORM TO THE 1994 EDITION OF THE CITY OF ANN ARBOR PUBLIC SERVICES DEPARTMENT STANDARD SPECIFICATIONS AND IT'S DETAILS WHICH ARE INCLUDED BY REFERENCE. THE OMISSION OF ANY CURRENT STANDARD DETAIL DOES NOT RELIEVE THE CONTRACTOR FROM THIS REQUIREMENT. THE WORK SHALL BE PERFORMED IN COMPLETE CONFORMANCE WITH THE CURRENT PUBLIC SERVICES STANDARD SPECIFICATIONS AND DETAILS.

FOR PROTECTION OF UNDERGROUND UTILITIES AND IN CONFORMANCE WITH PUBLIC ACT 53, THE CONTRACTOR SHALL CALL 811 OR 1-800-482-7171 A MINIMUM OF THREE FULL WORKING DAYS, EXCLUDING SATURDAYS, SUNDAYS, AND HOLIDAYS PRIOR TO BEGINNING EACH EXCAVATION IN AREAS WHERE PUBLIC UTILITIES HAVE NOT BEEN PREVIOUSLY LOCATED. MEMBERS WILL THUS BE ROUTINELY NOTIFIED. THIS DOES NOT RELIEVE THE CONTRACTOR OF THE RESPONSIBILITY OF NOTIFYING UTILITY OWNERS WHO MAY NOT BE A PART OF THE "MISS DIG" ALERT SYSTEM.

THE UNDERGROUND LOCATIONS SHOWN FOR NATURAL GAS (GAS), TELEPHONE (TEL), ELECTRICAL POWER (PWR), CABLE TV (CTV) AND FIBER OPTIC LINES (FIBER) ARE APPROXIMATE. THE CITY OF ANN ARBOR ASSUMES NO RESPONSIBILITY FOR THEIR ACCURATE REPRESENTATION IN THIS DRAWING. MISS DIG MUST BE CONTACTED PRIOR TO CONSTRUCTION TO LOCATE THESE UTILITIES.



PROJECT MANAGEMENT SERVICE UNIT


CITY OF ANN ARBOR PUBLIC SERVICE 301 EAST HURON STREET, P.O. BOX 8647 ANN ARBOR, MICHIGAN 48107-8647 734-794-6410 www.a2gov.org

DATE


NICHOLAS S. HUTCHINSON, P.E MI LICENSE No. 46	78
CITY ENGINEER	

PREPARED UNDER THE SUPERVISION OF


FLIZABETH ROLLA P.E. - MILLICENSE No. 40106

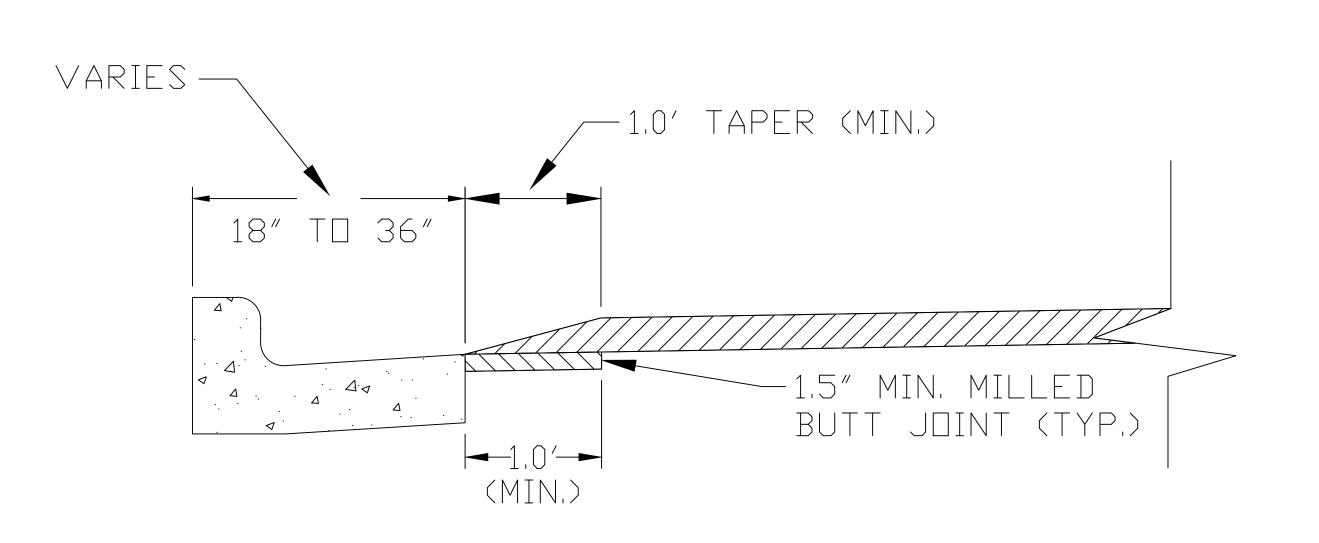

SPEED HUMP CROSS SECTION SECTION B-B

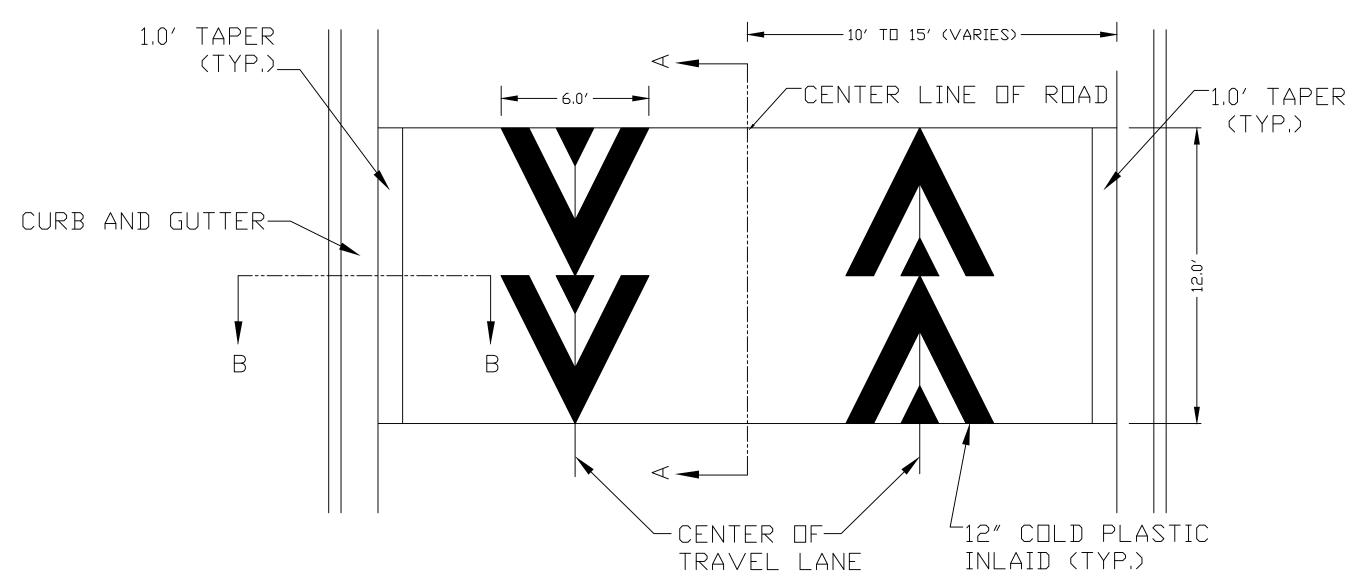

PAVEMENT MARKING DETAIL

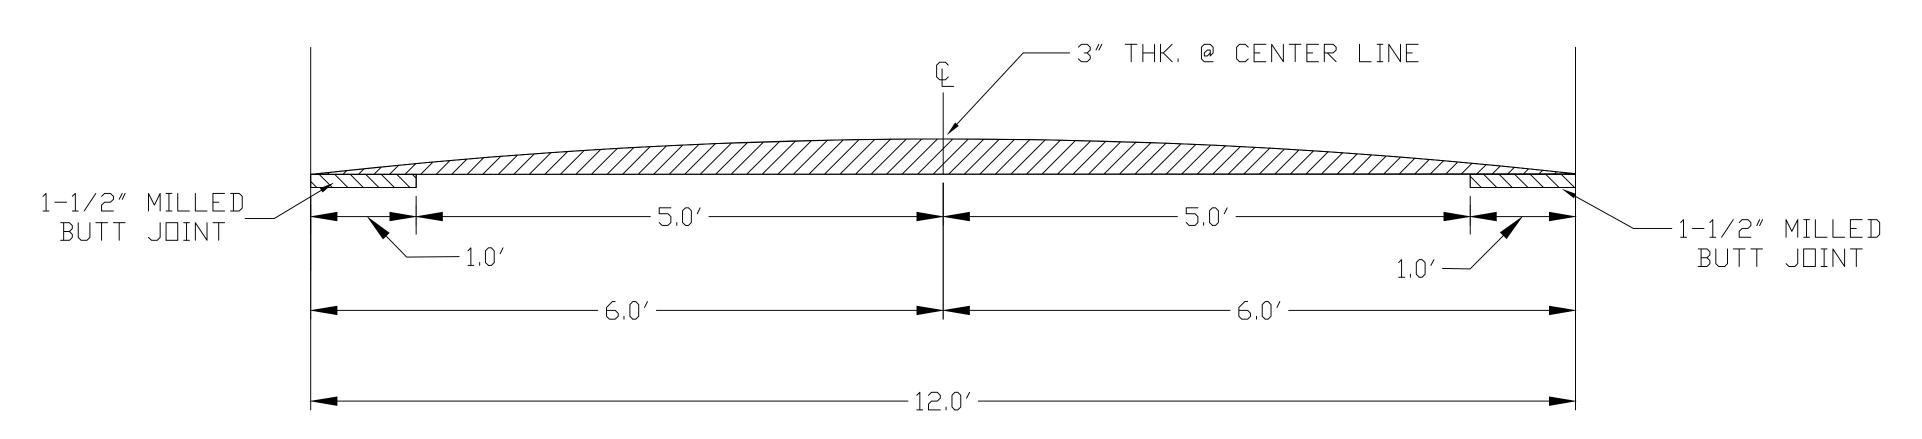

GENERAL NOTES

- 1. RAISED INTERSECTIONS SHALL FOLLOW THE SAME TAPER REQUIREMENT AS THE SPEED HUMPS DETAILED HEREIN.
- 2. PAYMENT FOR PAVEMENT MARKINGS FOR SPEED HUMPS AND RAISED INTERSECTIONS SHALL BE INCLUDED IN THE RESPECTIVE BID ITEMS AND SHALL NOT BE PAID FOR SEPARATELY.

SPEED HUMP CROSS SECTION SECTION A-A

2 of 102



CITY OF ANN ARBOR PROJECT MANAGEMENT 2014 ANNUAL RESURFACING **PROGRAM** PROJECT LOCATION: WASHINGTON STREET

FILE No. 2014004

	QUANTITIES			
ITEM#	DESCRIPTION	Units	Total	
205	Remove HMA Pavement Alleys	Tons	55	
207	Cold Mill Pavement	Tons	920	
209	Subgrade Undercutting	C.Y.	460	
220	HMA Patching	Tons	18	
226	HMA Pavement Wearing, 5E3	Tons	400	
227	HMA Pavement Base or Leveling, 4E3	Tons	530	
230	Rem. Curb & Gutter Any Type	L.F.	670	
232	Rem. Conc. SideWalk & Drive - Any Thickness	S.F.	3430	
237	Conc. Curb & Gutter - Any Type - Fixed Form	L.F.	540	
238	Conc. Curb & Gutter - Any Type - High Early	L.F.	140	
240	4" Sidewalk or Ramp	S.F.	850	
241	6" Drive, Sidewalk or Ramp	S.F.	1580	
242	6" Drive, Sidewalk or Ramp - High Early	S.F.	1100	
243	8" Drive, Sidewalk or Ramp - High Early	S.F.	1500	
245	Detectable Warning, Cast in Place	S.F.	100	
246	Integral Sidewalk Ret. Wall (< 6")	S.F.	20	
250	2' Dia. Structure	Each	8	
254	Lower Structure Cover	Each	42	
255	Lower Mon. / Gate Valve Box	Each	23	
256	Adjust Structure Covers	Each	42	
257	Adjust Curb Inlet Structure Cover	Each	9	
258	Adjust Mon. / Gate Valve Box	Each	23	
259	Manhole Flange & Cover (MDOT Type A)	Each	11	
260	Inlet Structure Cover (MDOT Type K)	Each	1	
264	12" Sewer, Trench Detail I, Modified	L.F.	30	
268	Flowable Fill	C.Y.	10	
271	21AA Limestone - C.I.P.	C.Y.	460	
282	Plastic Drum - Lighted - Furn. & Operate	Each	50	
283	Barricade Type III - Furn. & Operate	Each	10	
284	Temporary Sign - Type B	S.F.	1090	
297	Cold plastic Bike Symbol - "Sharrow"	Each	8	
594	Rec. Polyurea Pvmt. Mkg., 4" White	L.F.	500	
595	Rec. Polyurea Pvmt. Mkg., 4" Yellow	L.F.	1500	
596	Rec. Polyurea Pvmt. Mkg., 6" White or Yellow	L.F.	770	
597	Rec. Polyurea Pvmt. Mkg., 24" White	L.F.	900	
598	Rec. Polyurea Pvmt. Mkg., Symbol or Legend	Each	10	

TRAFFIC CONTROL & SIGN LEGEND		
QTY.	TYPE	DESCRIPTION
16	W20-1	"ROAD WORK AHEAD"
16	W20-2	"DETOUR AHEAD"
16	W20-3	"ROAD CLOSED AHEAD"
48	D3-1	CONVENTIONAL GUIDE
10	TYPE III	TYPE III LIGHTED BARRICADE
50	TYPE II	TYPE II LIGHTED BARRICADE (DRUM)
10	R11-4	"ROAD CLOSED TO THRU TRAFFIC"

CONSTRUCTION METHOD AND SEQUENCING

- THE WORK TO BE COMPLETED ON THIS STREET SHALL INCLUDE, BUT NOT BE LIMITED TO THE FOLLOWING ITEMS. THE ORDER OF CONSTRUCTION SHALL BE AS GIVEN UNLESS OTHERWISE AUTHORIZED
- IMPLEMENT TRAFFIC MAINTENANCE, AND SOIL EROSION CONTROLS IN ACCORDANCE WITH THE PLANS, AND AS DIRECTED BY THE ENGINEER. THERE ARE 14 METER BAGS TO BE COVERED.
- 3. INSTALL ANY PROPOSED STORM SEWER, AND UNDERDRAIN AS SHOWN ON THE PLANS, AND AS DIRECTED BY THE ENGINEER.
- 4. LOWER ALL STRUCTURE COVERS, INCLUDING VALVE AND MONUMENT BOXES.
- 5. PERFORM ALL CONCRETE WORK, INCLUDING RESTORATION, IN ACCORDANCE WITH THE PLANS, AND AS DIRECTED BY THE ENGINEER.
- 6. MILL 3-1/2 INCHES OF BITUMINOUS MATERIAL FROM EXISTING ROADWAY. THIS MAY INCLUDE GRANULAR ROAD BASE MATERIAL. DEPTH TO BE DETERMINED BY THE ENGINEER. PROOF ROLL WITH
- 7. PERFORM UNDERCUTS AND AND/OR BASE REPAIRS AS DIRECTED BY THE ENGINEER.
- 8. GRADE, SHAPE, AND RE-COMPACT THE EXISTING ROAD BASE AS REQUIRED, AND AS DIRECTED BY THE
- 9. PAVE 2-1/2 INCHES OF THE BITUMINOUS MIX AS SPECIFIED OR DIRECTED BY THE ENGINEER, AS THE LEVELING COURSE, IN ONE LIFT.
- 10. ADJUST ALL STRUCTURE COVERS, MONUMENT BOXES, AND VALVE BOXES TO THEIR FINISHED ELEVATIONS.
- 11. PAVE 1-1/2 INCHES OF THE BITUMINOUS MIX AS SPECIFIED OR DIRECTED BY THE ENGINEER, AS THE WEARING COURSE, IN ONE LIFT.
- 12. COMPLETE ALL PAVEMENT MARKINGS IN ACCORDANCE WITH THE PLANS, AND AS DIRECTED BY THE
- 13. COMPLETE ALL MISCELLANEOUS CONSTRUCTION INCLUDING ALL CLEAN-UP AND FINAL RESTORATION.
- 14. REMOVE ALL TRAFFIC CONTROL DEVICES. REMOVE MISS DIG FLAGS.

NOTES:

THE CONSTRUCTION COVERED BY THESE PLANS SHALL CONFORM TO THE THE CONSTRUCTION COVERED BY THESE PLANS SHALL COMPOND TO THE 1994 EDITION OF THE CITY OF ANN ARBOR PUBLIC SERVICES DEPARTMENT STANDARD SPECIFICATIONS AND IT'S DETAILS WHICH ARE INCLUDED BY REFERENCE. THE OMISSION OF ANY CURRENT STANDARD DETAIL DOES NOT RELIEVE THE CONTRACTOR FROM THIS REQUIREMENT. THE WORK SHALL BE PERFORMED IN COMPLETE CONFORMANCE WITH THE CURRENT PUBLIC SERVICES STANDARD SPECIFICATIONS AND DETAILS.


FOR PROTECTION OF UNDERGROUND UTILITIES AND IN CONFORMANCE WITH PUBLIC ACT 53, THE CONTRACTOR SHALL CALL 811 OR 1-800-482-7171 A MINIMUM OF THREE FULL WORKING DAYS, EXCLUDING SATURDAYS, SUNDAYS, AND HOLIDAYS PRIOR TO BEGINING EACH EXCAVATION IN AREAS WHERE PUBLIC UTILITIES HAVE NOT BEEN PREVIOUSLY LOCATED. MEMBERS WILL THUS BE ROUTINELY NOTIFIED. THIS DOES NOT RELIEVE THE CONTRACTOR OF THE RESPONSIBILITY OF NOTIFYING UTILITY OWNERS WHO MAY NOT BE A PART OF THE "MISS DIG" ALERT SYSTEM.

THE UNDERGROUND LOCATIONS SHOWN FOR NATURAL GAS (GAS), TELEPHONE (TEL), ELECTRICAL POWER (PWR), CABLE TV (CTV) AND FIBER OPTIC LINES (FIBER) ARE APPROXIMATE. THE CITY OF ANN ARROR ASSUMES NO RESPONSIBILITY FOR THEIR ACCURATE REPRESENTATION IN THIS DRAWING. MISS DIG MUST BE CONTACTED PRIOR TO CONSTRUCTION TO LOCATE THESE UTILITIES.

PROJECT MANAGEMENT SERVICE UNIT

CITY OF ANN ARBOR PUBLIC SERVICE 301 EAST HURON STREET, P.O. BOX 8647 ANN ARROR MICHIGAN 48107-8647 734-794-6410 www.a2gov.org


3 TO 102

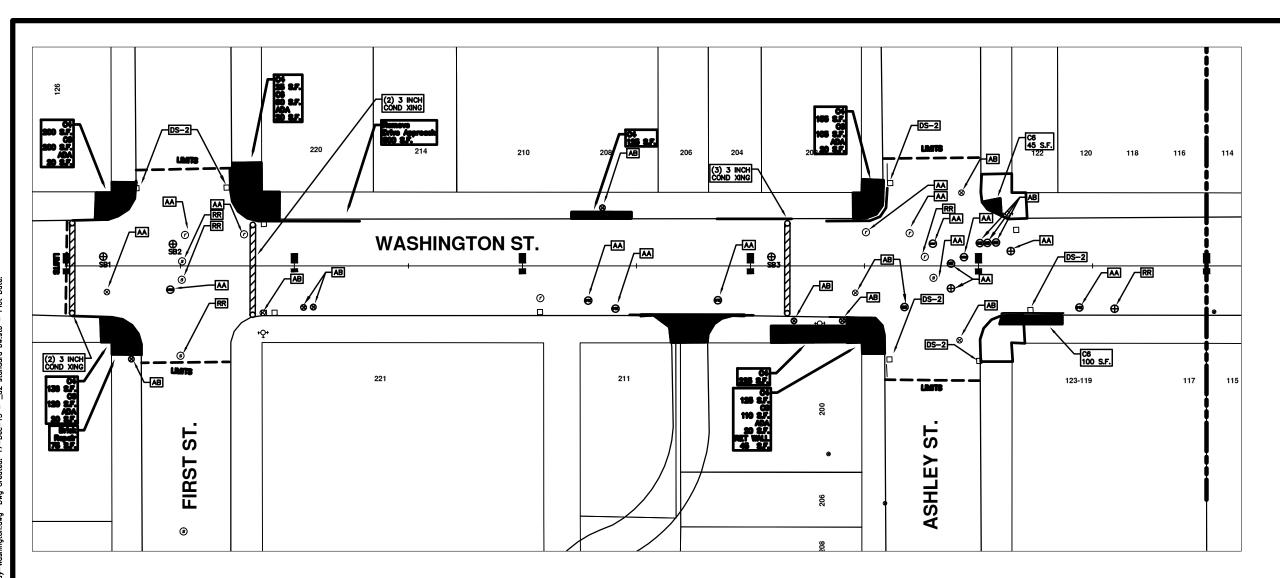




	CONSTRUCTION KEY	
KEY	DESCRIPTION	
C/G	REMOVE AND REPLACE CURB AND GUTTER	
C/GHE	REMOVE CURB AND GUTTER, REPLACE WITH CONCRETE CURB AND GUTTER H.E.	
C4HE	REMOVE EXISTING RAMP OR SIDEWALK. REPLACE WITH 4" SIDEWALK OR TYPE 1 SIDEWALK RAMP,H.E.	
CR	REMOVE SIDEWALK, DRIVE OR RAMP.	
AA	ADJUST MDOT TYPE A CASTINGS.	
AB	ADJUST GATE VALVE BOX OR MONUMENT BOX.	
ADST	ADDITIONAL DEPTH STRUCTURE REPAIR.	
RRA	REMOVE AND REPLACE MOOT TYPE A CASTING ADJUST TO FINISH GRADE.	
CPRHE	CONCRETE PAVEMENT REPAIR, H.E.	
DS	CONSTRUCT 2, 3 OR 4' DIAM. DRAINAGE STRUCTURE.	
PT	POINT STRUCTURE.	
C4	REMOVE EXISTING RAMP OR SIDEWALK, REPLACE WITH 4" SIDEWALI OR RAMP.	
C6	REMOVE EXISTING RAMP OR SIDEWALK, REPLACE WITH 6" SIDEWALK OR RAMP	
СВ	PLACE 8" SIDEWALK OR RAMP ONLY	
C HE	REMOVE EXISTING DRIVE APPROACH, RAMP OR SIDEWALK. REPLACE WITH 6" OR 8" APPROACH, RAMP,OR SIDEWALK, H.E.	
CP	PLACE 4" SIDEWALK OR RAMP.	
AK	ADJUST MDOT TYPE K CASTING.	
TYPE II	MDOT TYPE II BARRICADE.	
TYPE III	MDOT TYPE III BARRICADE.	
RRK	REMOVE AND REPLACE MDOT TYPE K CASTING. ADJUST TO FINISH GRADE.	
RS	RECONSTRUCT STRUCTURE.	
RCP	REMOVE CONC. PAVEMENT - ANY THICKNESS	
RCW	RAISED CROSSWALK	

	LEGEND
SYMBOL	DESCRIPTION
•	EXISTING SANITARY SEWER MANHOLE
•	EXISTING STORM SEWER MANHOLE
•	EXISTING WATER MAIN VALVE IN WELL
+	WATER MAIN GATE VALVE IN BOX
*	FIRE HYDRANT
•	MICHOON GAS CO. VALVE BOX/WELL
•	AMERITECH TELEPHONE VAULT
•	ELECTRIC MANHOLE
•	SOIL BORING
0	EXISTING STORM SEWER INLET
•	MONUMENT BOX
	REMOVE AND REPLACE CONC. SIDEWALK
	PLACE CONCRETE SIDEWALK
	REMOVE & REPLACE CONC. CURB & GUTTER
	CONSTRUCTION LIMITS
	6" WRAPPED UNDERDRAIN
	REMOVE CONCRETE SIDEWALK
	SUBGRADE UNDERCUT
PILE AND IT W	B A REPERENCE PILE. MANE CHANGES TO THE REPERENCE LL UPDATE ALL SHEETS. TO MANE A CHANGE NIGHT K CPEN WEST, MANE YOUR EDIT AND SANE.

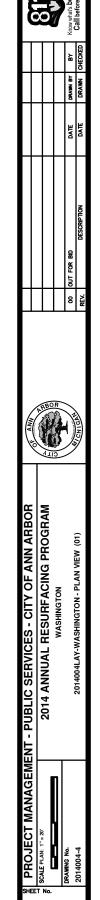

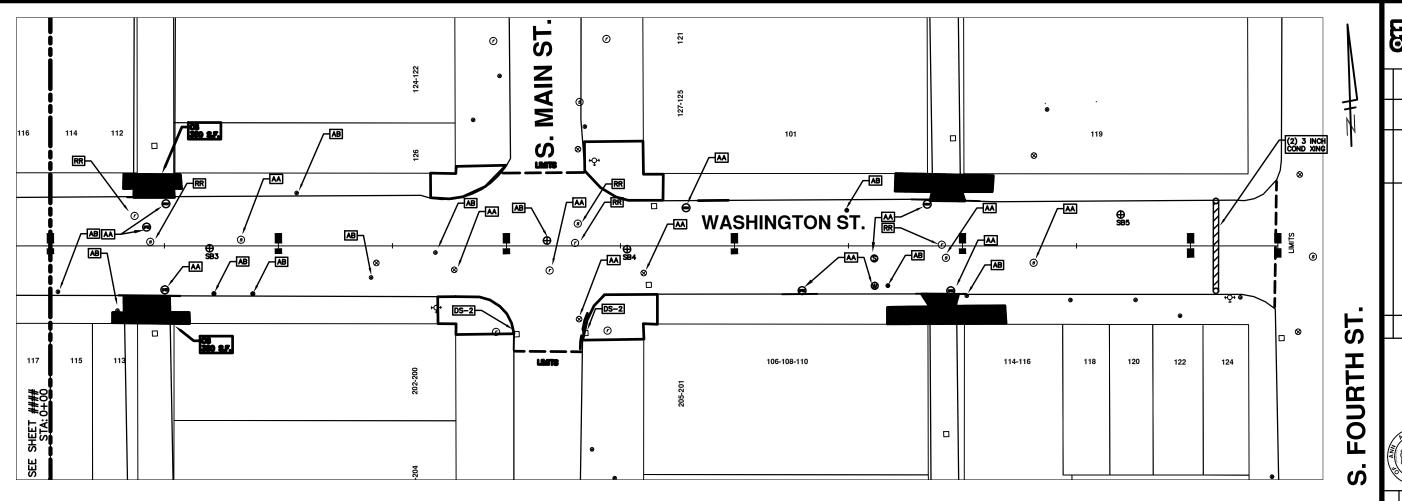


WASHINGTON ST.


	CONSTRUCTION KEY
KEY	DESCRIPTION
C/G	REMOVE AND REPLACE CURB AND GUTTER
C/GHE	REMOVE CURB AND GUTTER, REPLACE WITH CONCRETE CURB ANI GUTTER H.E.
C4HE	REMOVE EXISTING RAMP OR SIDEWALK. REPLACE WITH 4" SIDEWALK OR TYPE 1 SIDEWALK RAMP, H.E.
CR	REMOVE SIDEWALK, DRIVE OR RAMP.
AA	ADJUST MDOT TYPE A CASTINGS.
AB	ADJUST GATE VALVE BOX OR MONUMENT BOX.
ADST	ADDITIONAL DEPTH STRUCTURE REPAIR.
RRA	REMOVE AND REPLACE MDOT TYPE A CASTING ADJUST TO FINISH GRADE.
CPRHE	CONCRETE PAVEMENT REPAIR, H.E.
DS	CONSTRUCT 2, 3 OR 4' DIAM. DRAINAGE STRUCTURE.
PT	POINT STRUCTURE.
C4	REMOVE EXISTING RAMP OR SIDEWALK, REPLACE WITH 4" SIDEWA OR RAMP.
C6	REMOVE EXISTING RAMP OR SIDEWALK, REPLACE WITH 6" SIDEWA
C8	PLACE 8" SIDEWALK OR RAMP ONLY
C HE	REMOVE EXISTING DRIVE APPROACH, RAMP OR SIDEWALK. REPLAI WITH 6" OR 8" APPROACH, RAMP, OR SIDEWALK, H.E.
CP	PLACE 4" SIDEWALK OR RAMP.
AK	ADJUST MDOT TYPE K CASTING.
TYPE II	MDOT TYPE II BARRICADE.
TYPE III	MDOT TYPE III BARRICADE.
RRK	REMOVE AND REPLACE MDOT TYPE K CASTING. ADJUST TO FINIS GRADE.
RS	RECONSTRUCT STRUCTURE.
RCP	REMOVE CONC. PAVEMENT - ANY THICKNESS
RCW	RAISED CROSSWALK


LEGEND		
SYMBOL	DESCRIPTION	
•	EXISTING SANITARY SEWER MANHOLE	
۰	EXISTING STORM SEWER MANHOLE	
•	EXISTING WATER MAIN VALVE IN WELL	
+	WATER MAIN GATE VALVE IN BOX	
-&-	FIRE HYDRANT	
•	MICHCON GAS CO. VALVE BOX/MELL	
•	AMERITECH TELEPHONE VAULT	
•	ELECTRIC MANHOLE	
•	SOIL BORING	
0	EXISTING STORM SEWER INLET	
•	MONUMENT BOX	
	REMOVE AND REPLACE CONG. SIDEWALK	
	PLACE CONCRETE SIDEWALK	
	REMOVE & REPLACE CONG. CURB & GUTTER	
	CONSTRUCTION LIMITS	
	6" WRAPPED UNDERDRAIN	
	REMOVE CONCRETE SIDEWALK	
	SUBGRADE UNDERCUT	
FILE AND IT W	S A REFERENCE FILE. MAKE CHANGES TO THE REFERENCE IL UPDATE ALL SHEETS. TO MAKE A CHANGE MIGHT K OPEN WEF, MAKE YOUR EDIT AND SAVE.	


PUBLIC SERVICES - CITY OF ANN ARBOR 2014 ANNUAL RESURFACING PROGRAM WASHINGTON


EET No. 5 OF 102

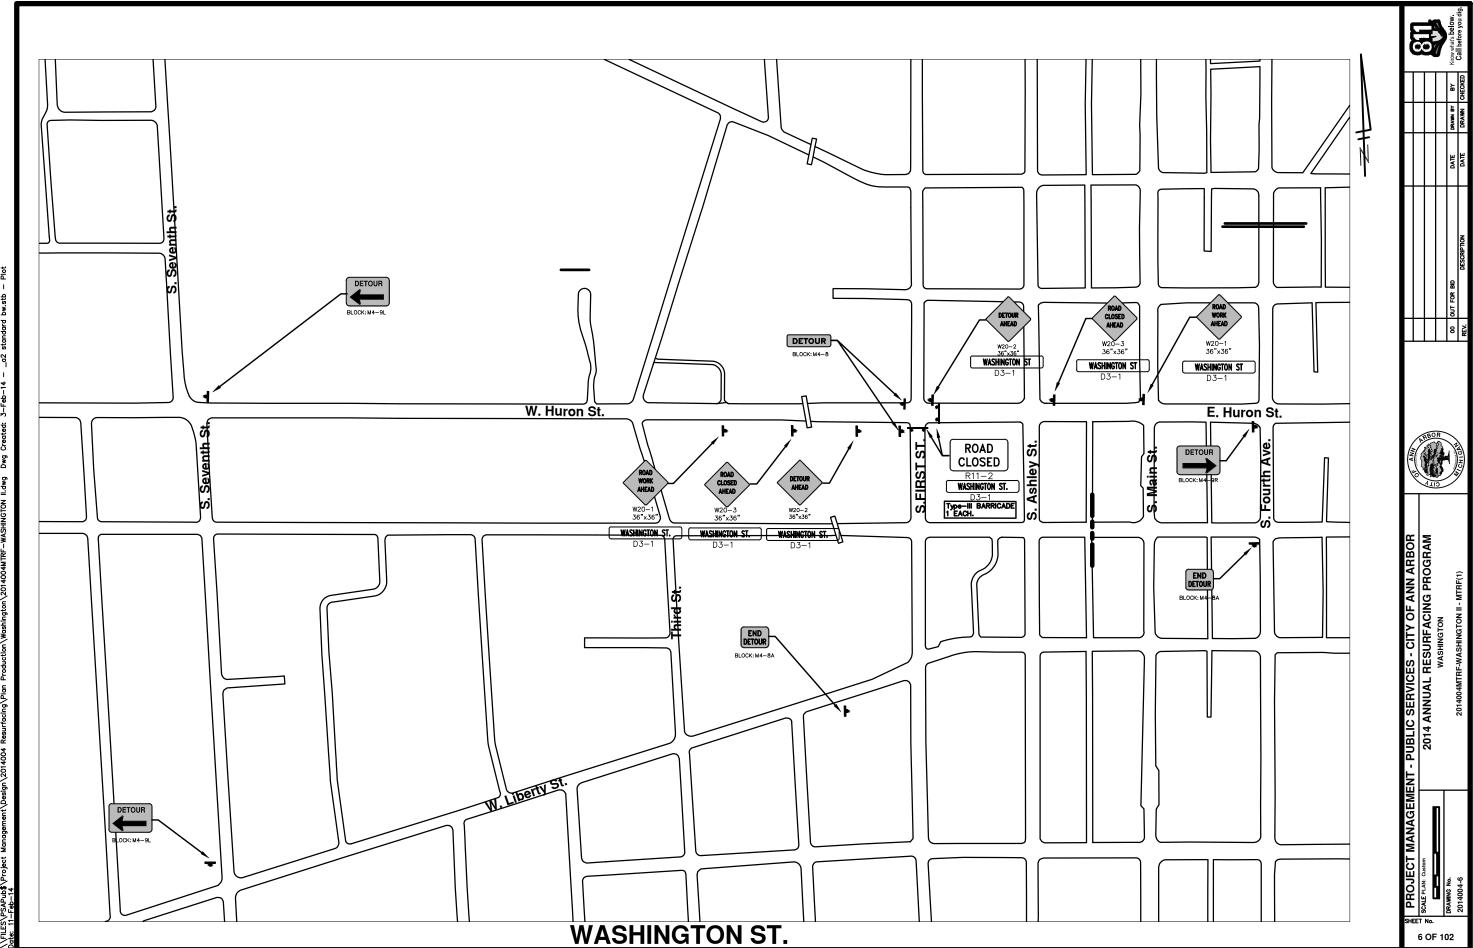


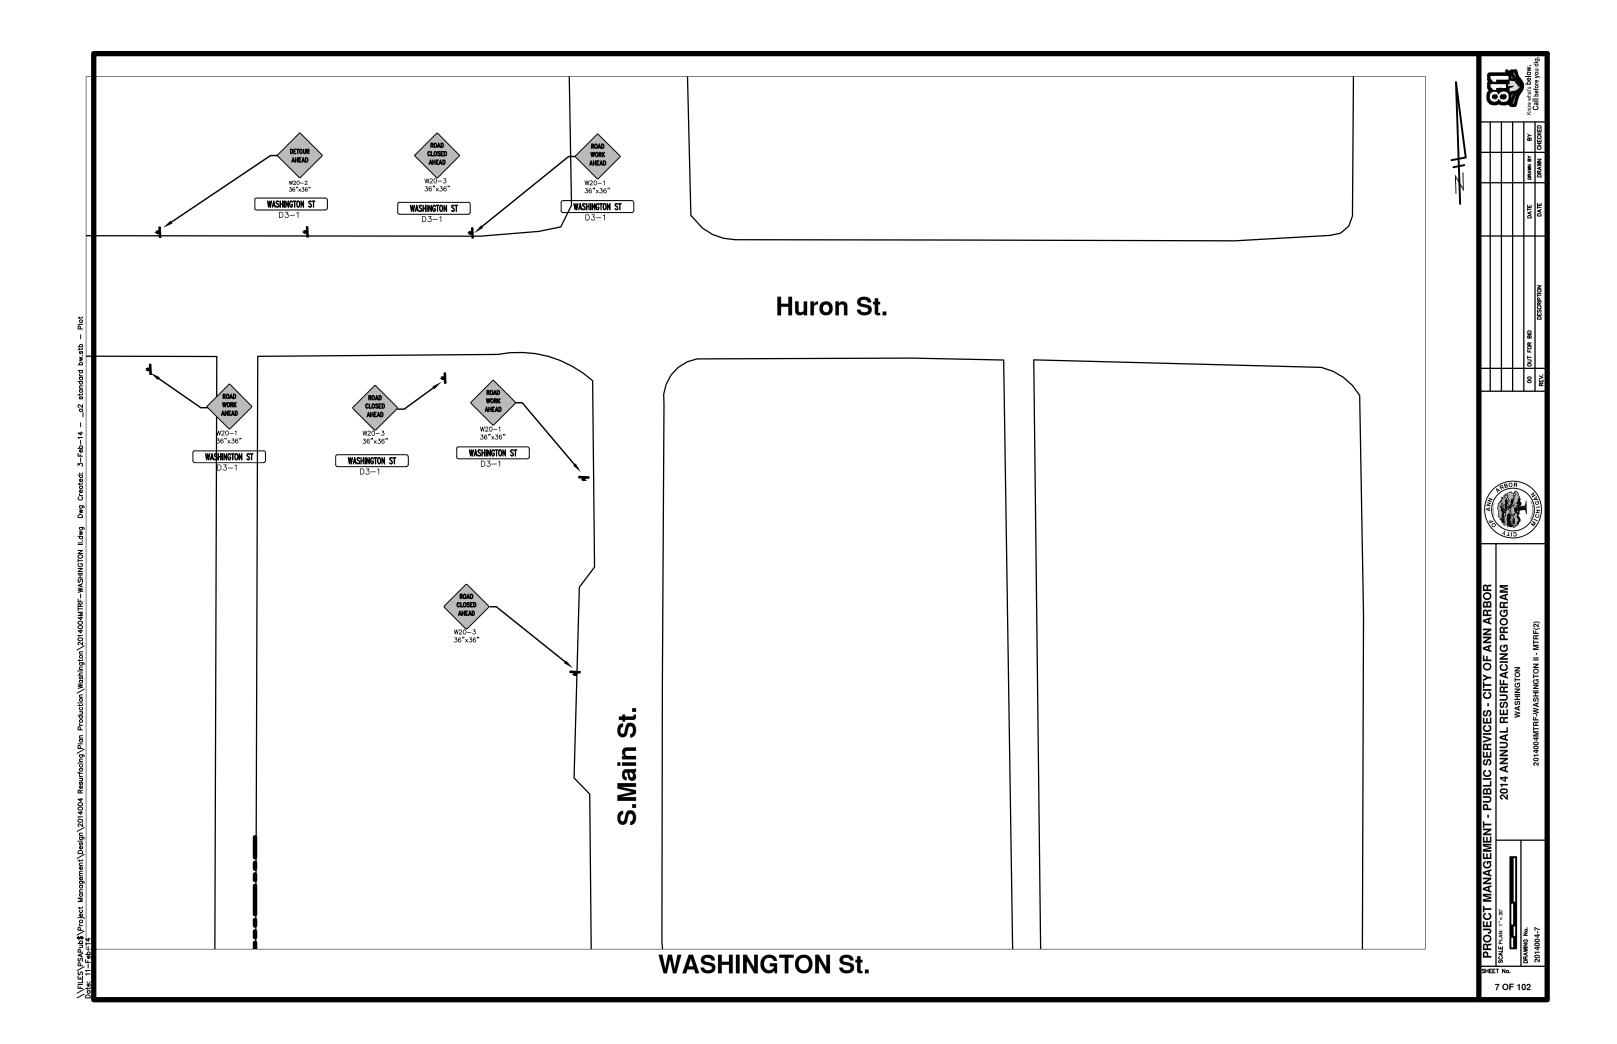

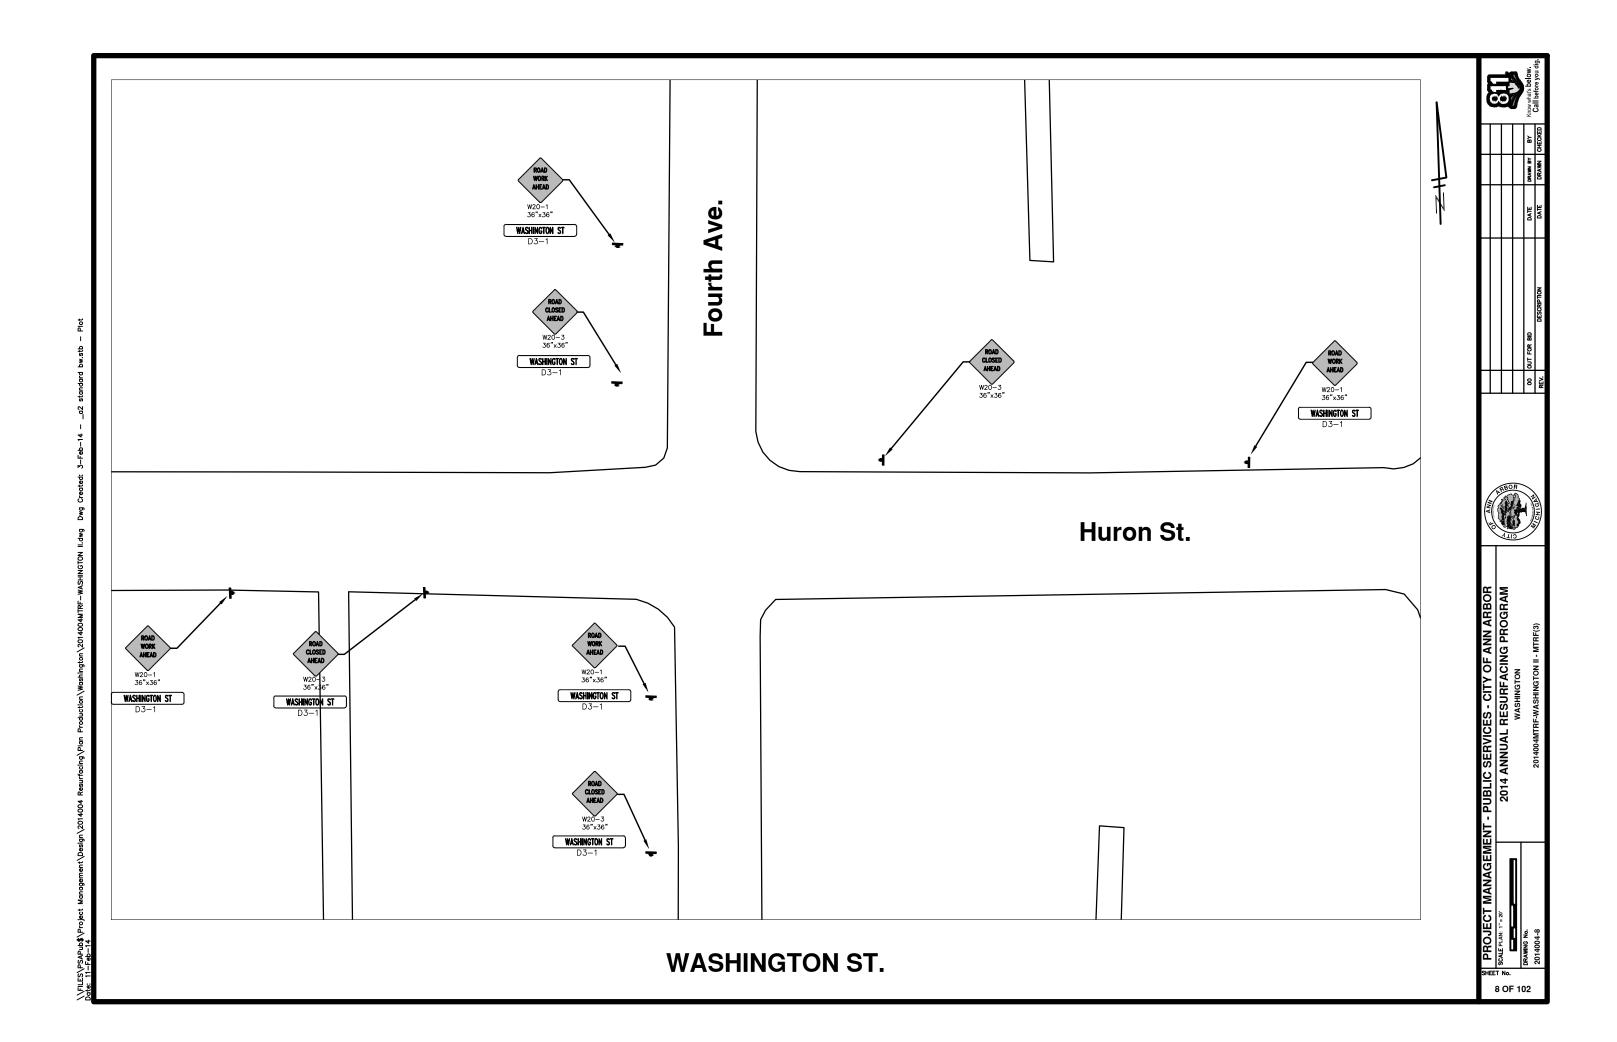

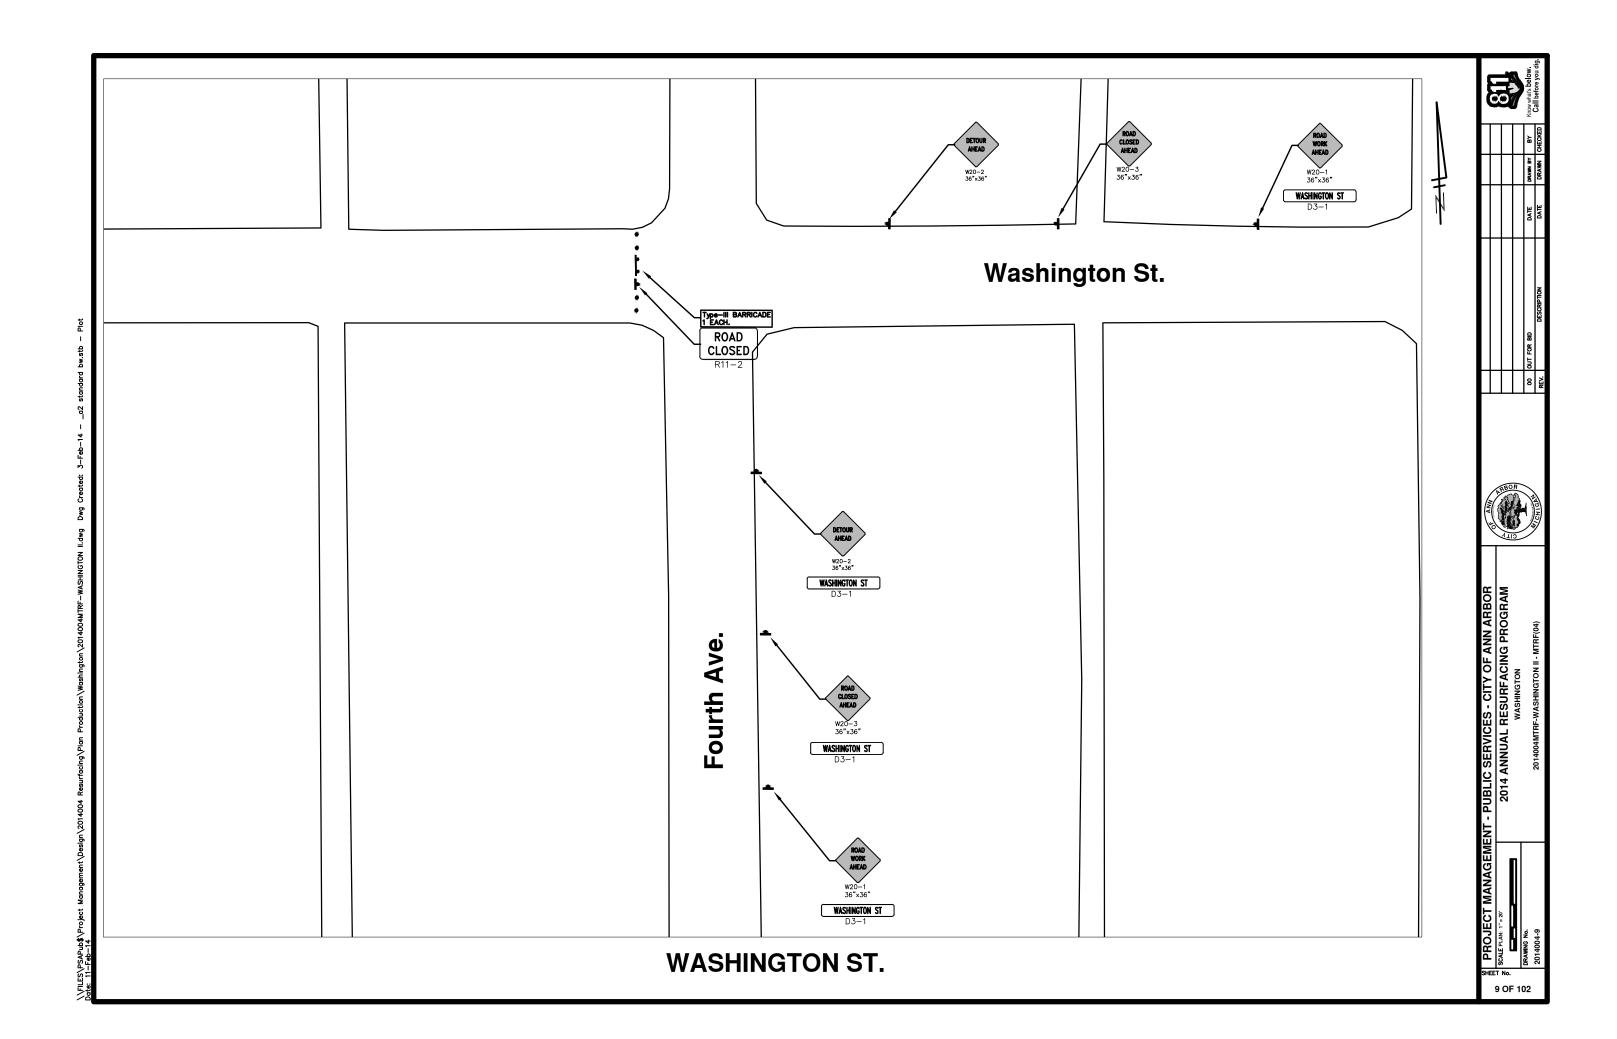

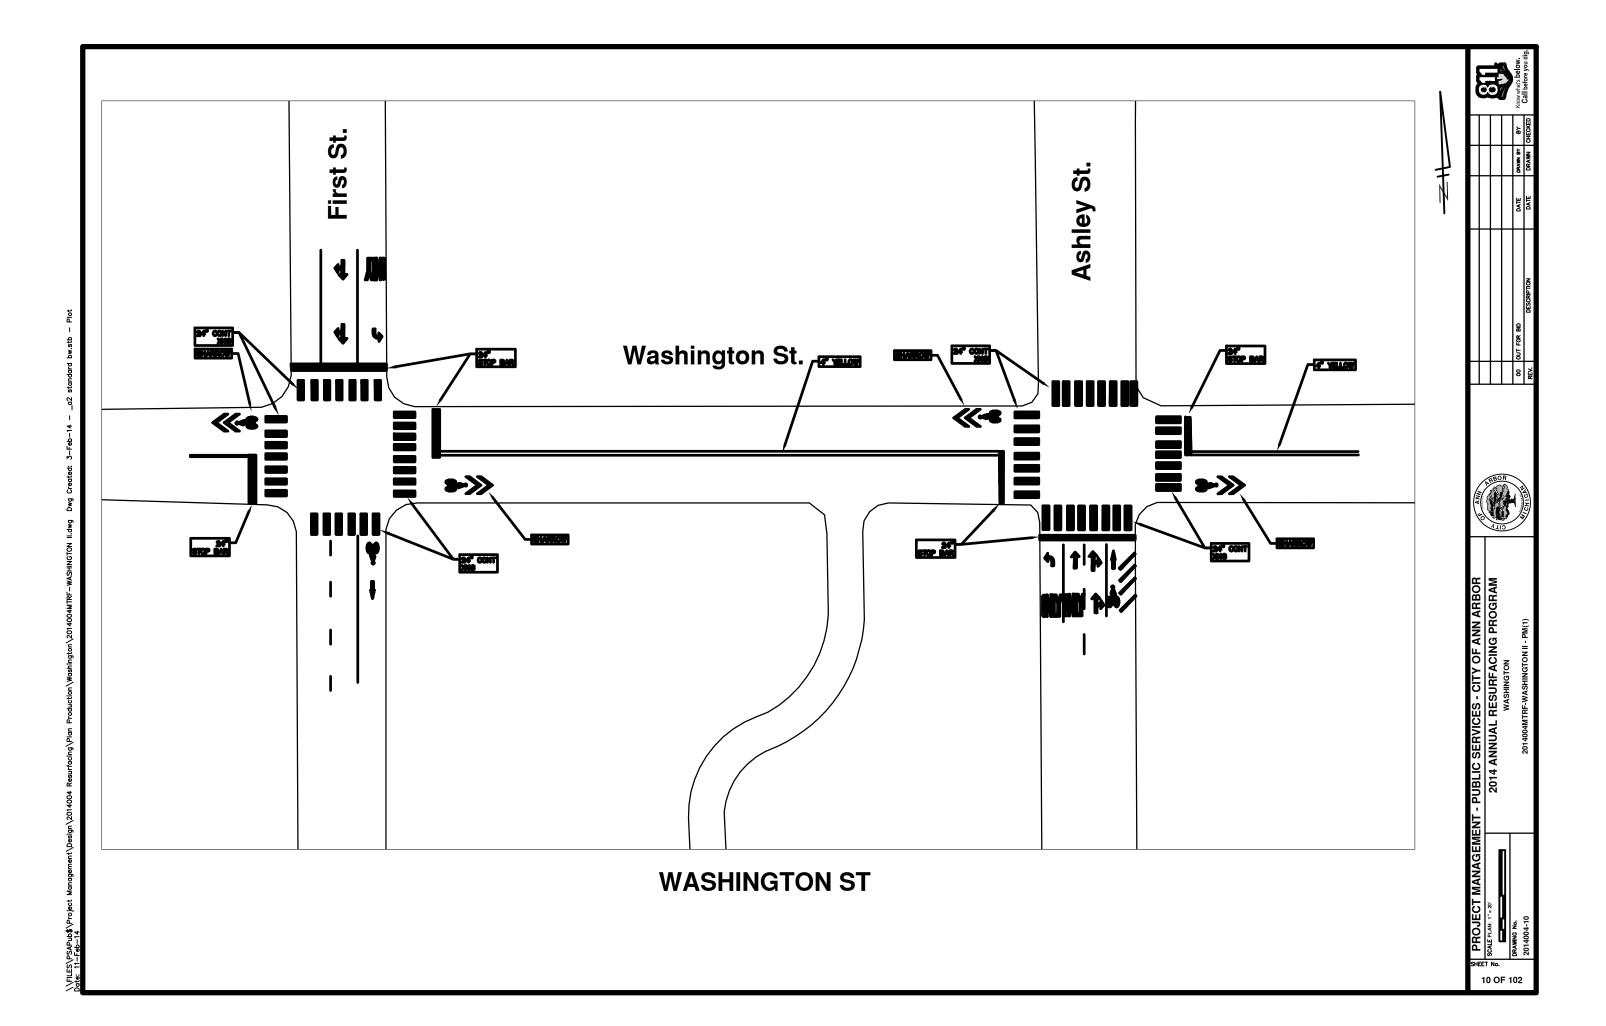

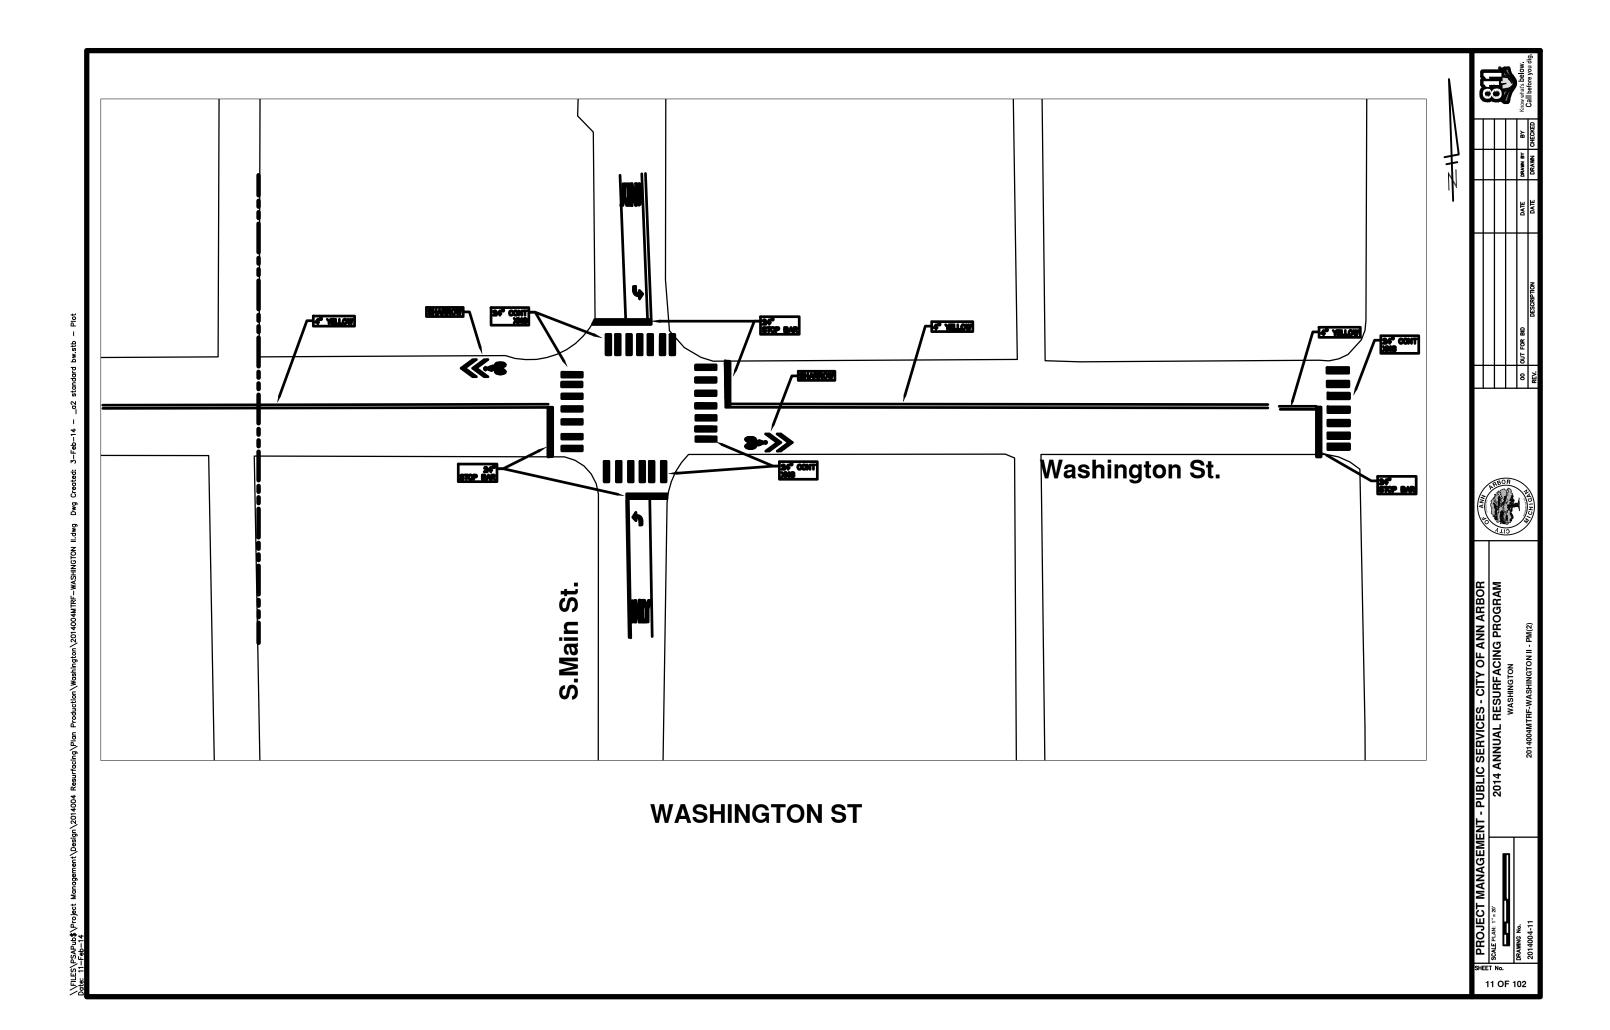



CITY OF ANN ARBOR PROJECT MANAGEMENT 2014 ANNUAL RESURFACING PROGRAM

PROJECT LOCATION: LINWOOD AVENUE

FILE No. 2014004

	QUANTITIES		
ITEM#	DESCRIPTION	Units	Total
207	Cold Miling Pavement	Tons	1150
209	Subgrade Undercutting - Type II	C.Y.	470
222	HMA Pavement Leveling, Regular	Tons	690
223	HMA Pavement Wearing, Regular	Tons	460
230	Rem. Curb & Gutter, Any Type	L.F.	1540
232	Rem. Conc. Sidewalk & Drive - Any Thickness	S.F.	2630
237	Conc. Curb & Gutter - Any Type - Fixed Form	L.F.	1540
240	4" Sidewalk or Ramp	S.F.	1730
241	6" Drive, Sidewalk or Ramp	S.F.	910
245	Detectable Warning, Cast in Place	S.F.	120
247	Integral Sidewalk Ret. Wall (6"-18")	S.F.	60
250	2' Dia. Structure	Each	7
254	Lower Structure Cover	Each	12
255	Lower Mon./Gate Valve Box	Each	5
256	Adjust Structure Cover	Each	12
257	Adjust Curb Inlet Structure Cover	Each	7
258	Adjust Mon. or Gate Valve Box	Each	5
259	Manhole Flange & Cover (MDOT Type A)	Each	12
264	12" Sewer, Trench Detail I, Modified	L.F.	35
271	21AA Limestone - C.I.P.	C.Y.	470
282	Plastic Drum - Lighted - Furn. & Operate	Each	110
283	Barricade Type III - Furn. & Operate	Each	12
284	Temp Signs Type - B	S.F.	420
285	No Parking Sign	Each	53
596	Rec. Polyurea Pvmt. Mkg., 6" White or Yellow	L.F.	525
597	Rec. Polyurea Pvmt. Mkg., 24" White	L.F.	60

TRAFFIC CONTROL & SIGN LEGEND		
QTY.	TYPE	DESCRIPTION
15	W20-1	"ROAD WORK AHEAD"
16	W20-3	"ROAD CLOSED AHEAD"
32	D3-1	CONVENTIONAL GUIDE
12	TYPE III	TYPE III LIGHTED BARRICADE
110	TYPE II	TYPE II BARRICADE DRUM

CONSTRUCTION METHOD AND SEQUENCING

- THE WORK TO BE COMPLETED ON THIS STREET SHALL INCLUDE, BUT NOT BE LIMITED TO THE FOLLOWING ITEMS. THE ORDER OF CONSTRUCTION SHALL BE AS GIVEN UNLESS OTHERWISE AUTHORIZED OR DIRECTED BY THE ENGINEER.
- IMPLEMENT TRAFFIC MAINTENANCE, AND SOIL EROSION CONTROLS IN ACCORDANCE WITH THE PLANS, AND AS DIRECTED BY THE ENGINEER.
- 3. INSTALL ANY PROPOSED STORM SEWER, AND UNDERDRAIN AS SHOWN ON THE PLANS, AND AS DIRECTED BY THE ENGINEER.
- 4. LOWER ALL STRUCTURE COVERS, INCLUDING VALVE AND MONUMENT BOXES.
- 5. PERFORM ALL CONCRETE WORK, INCLUDING RESTORATION, IN ACCORDANCE WITH THE PLANS, AND AS DIRECTED BY THE ENGINEER.
- 6. MILL 5 INCHES OF BITUMINOUS MATERIAL FROM EXISTING ROADWAY. THIS MAY INCLUDE GRANULAR ROAD BASE MATERIAL. DEPTH TO BE DETERMINED BY THE ENGINEER. PROOF ROLL WITH FULL TRUCK.
- 7. PERFORM UNDERCUTS AND/OR BASE REPAIRS AS DIRECTED BY THE ENGINEER.
- 8. GRADE, SHAPE, AND RE—COMPACT THE EXISTING ROAD BASE AS REQUIRED, AND AS DIRECTED BY THE ENGINEER.
- PAVE 3 INCHES OF THE BITUMINOUS MIX AS SPECIFIED OR DIRECTED, AS THE LEVELING COURSE, IN ONE LIFT.
- 10. ADJUST ALL STRUCTURE COVERS, MONUMENT BOXES, AND VALVE BOXES TO THEIR FINISHED ELEVATIONS.
- PAVE 2 INCHES OF THE BITUMINOUS MIX AS SPECIFIED OR DIRECTED, AS THE WEARING COURSE, IN ONE LIFT.
- 12. COMPLETE ALL PAVEMENT MARKINGS IN ACCORDANCE WITH THE PLANS, AND AS DIRECTED BY THE ENGINEER.
- 13. COMPLETE ALL MISCELLANEOUS CONSTRUCTION INCLUDING ALL CLEAN-UP AND FINAL RESTORATION.
- 14. REMOVE ALL TRAFFIC CONTROL DEVICES. REMOVE MISS DIG FLAGS.

NOTES:

THE CONSTRUCTION COVERED BY THESE PLANS SHALL CONFORM TO THE 1994 EDITION OF THE CITY OF ANN ARBOR PUBLIC SERVICES DEPARTMENT STANDARD SPECIFICATIONS AND IT'S DETAILS WHICH ARE INCLUDED BY REFERENCE. THE OMISSION OF ANY CURRENT STANDARD DETAIL DOES NOT RELIEVE THE CONTRACTOR FROM THIS REQUIREMENT. THE WORK SHALL BE PERFORMED IN COMPLETE CONFORMANCE WITH THE CURRENT PUBLIC SERVICES STANDARD SPECIFICATIONS AND DETAILS.

FOR PROTECTION OF UNDERGROUND UTILITIES AND IN CONFORMANCE WITH PUBLIC ACT 53, THE CONTRACTOR SHALL CALL 811 OR 1-800-482-7171 A MINIMUM OF THREE FULL WORKING DAYS, EXCLUDING SATURDAYS, SUNDAYS, AND HOLDAYS PRIOR TO BEGINNING EACH EXCAVATION IN AREAS WHERE PUBLIC UTILITIES HAVE NOT BEEN PREVIOUSLY LOCATED. MEMBERS WILL THUS BE ROUTINELY NOTIFIED. THIS DOES NOT RELIEVE THE CONTRACTOR OF THE RESPONSIBILITY OF NOTIFYING UTILITY OWNERS WHO MAY NOT BE A PART OF THE "MISS DIG" ALERT SYSTEM.

THE UNDERGROUND LOCATIONS SHOWN FOR NATURAL GAS (GAS), TELEPHONE (TEL), ELECTRICAL POWER (PWR), CABLE TV (CTV) AND FIBER OPTIC LINES (FIBER) ARE APPROXIMATE. THE CITY OF ANN ARBOR ASSUMES NO RESPONSIBILITY FOR THEIR ACCURATE REPRESENTATION IN THIS DRAWING. MISS DIG MUST BE CONTACTED PRIOR TO CONSTRUCTION TO LOCATE THESE UTILITIES.

PROJECT MA
CITY OF A
301 EAST H
ANN AR
734-7

PROJECT MANAGEMENT SERVICE UNIT

CITY OF ANN ARBOR PUBLIC SERVICE 301 EAST HURON STREET, P.O. BOX 8647 ANN ARBOR, MICHIGAN 48107-8647 734-794-6410 www.a2gov.org Know what's below


CSENVICES - CITT OF AINN ANDO

DESCRIPTION

MENT - PUBLIC
PROJECT DESCRIPTION

DRAWING No. 2014004 - 12

12 TO 102

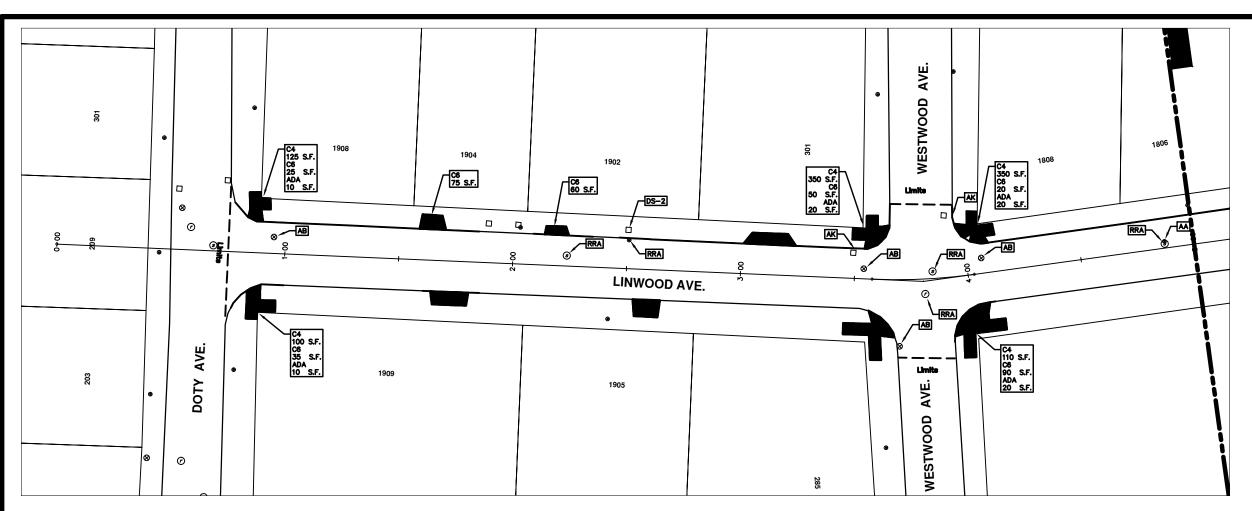




	CONSTRUCTION KEY
KEY	DESCRIPTION
C/G	REMOVE AND REPLACE CURB AND GUTTER
C/GHE	REMOVE CURB AND GUTTER, REPLACE WITH CONCRETE CURB AND GUTTER H.E.
C4HE	REMOVE EXISTING RAMP OR SIDEWALK. REPLACE WITH 4" SIDEWALK OR TYPE 1 SIDEWALK RAMP, H.E.
CR	REMOVE SIDEWALK, DRIVE OR RAMP.
AA	ADJUST MDOT TYPE A CASTINGS.
AB	ADJUST GATE VALVE BOX OR MONUMENT BOX.
ADST	ADDITIONAL DEPTH STRUCTURE REPAIR.
RRA	REMOVE AND REPLACE MDOT TYPE A CASTING ADJUST TO FINISH GRADE.
CPRHE	CONCRETE PAVEMENT REPAIR, H.E.
DS	CONSTRUCT 2, 3 OR 4' DIAM. DRAINAGE STRUCTURE.
PT	POINT STRUCTURE.
C4	REMOVE EXISTING RAMP OR SIDEWALK, REPLACE WITH 4" SIDEWAL OR RAMP.
C6	REMOVE EXISTING RAMP OR SIDEWALK, REPLACE WITH 6" SIDEWAL OR RAMP
СВ	PLACE 8" SIDEWALK OR RAMP ONLY
C HE	REMOVE EXISTING DRIVE APPROACH, RAMP OR SIDEWALK. REPLAC WITH 6" OR 8" APPROACH, RAMP, OR SIDEWALK, H.E.
CP	PLACE 4" SIDEWALK OR RAMP.
AK	ADJUST MDOT TYPE K CASTING.
TYPE II	MDOT TYPE II BARRICADE.
TYPE III	MDOT TYPE III BARRICADE.
RRK	REMOVE AND REPLACE MDOT TYPE K CASTING. ADJUST TO FINISH GRADE.
RS	RECONSTRUCT STRUCTURE.
RCP	REMOVE CONC. PAVEMENT - ANY THICKNESS
RCW	RAISED CROSSWALK

	LEGEND
SYMBOL	DESCRIPTION
•	EXISTING SANITARY SEWER MANHOLE
•	EXISTING STORM SEWER MANHOLE
•	EXISTING WATER MAIN VALVE IN WELL
+	WATER MAIN GATE VALVE IN BOX
-\$•	FIRE HYDRANT
•	MICHOON GAS CO. VALVE BOX/MELL
•	AMERITECH TELEPHONE VAULT
•	ELECTRIC MANHOLE
•	SOIL BORING
0	EXISTING STORM SEWER INLET
•	MONUMENT BOX
	REMOVE AND REPLACE CONG. SIDEWALK
- F-4 -	PLACE CONCRETE SIDEWALK
	REMOVE & REPLACE CONC. CURB & GUTTER
	CONSTRUCTION LIMITS
	6" WRAPPED UNDERDRAIN
	REMOVE CONCRETE SIDEWALK
	SUBGRADE UNDERCUT
PILE AND IT WE CLICK AND PIC	B A REFERENCE FILE. MANE CHANGES TO THE REFERENCE IL UPDATE ALL SHEETS. TO MANE A CHANGE MIGHT K OPEN WIEF, MANE YOUR EDIT AND SAVE.

) (X			Know what's below	
				¥8	DRAWN CHECKED
				DRAWN BY	DRAWN
				DATE	DATE
				00 OUT FOR BID	DESCRIPTION
				00	REV.
AMA		ABO TIME	R O		CHIEF



PUBLIC SERVICES - CITY OF ANN ARBOR
2014 ANNUAL RESURFACING PROGRAM
LINWOOD

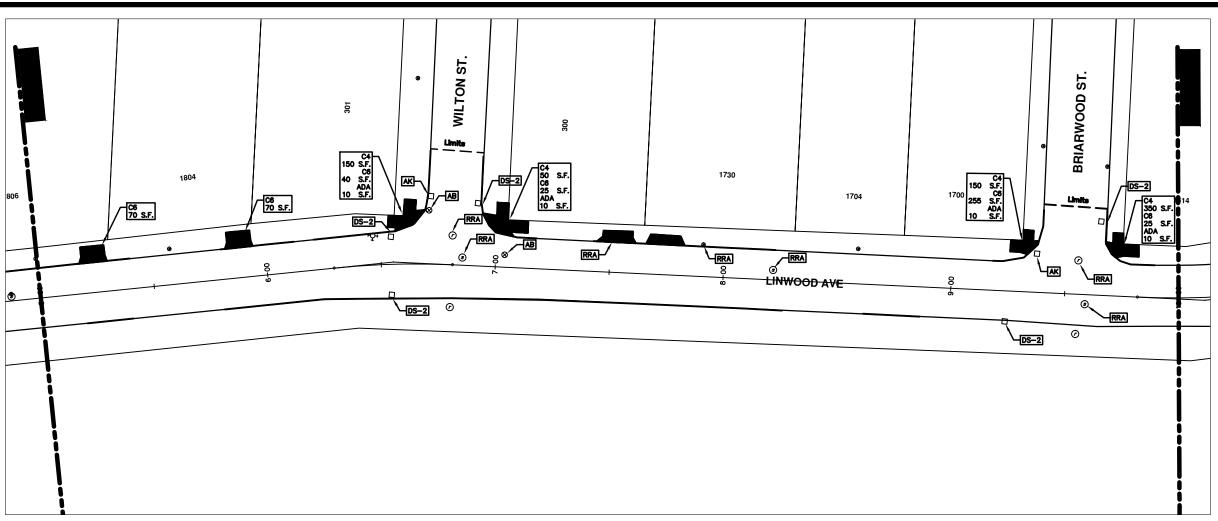


LINWOOD AVE.

	CONSTRUCTION KEY
KEY	DESCRIPTION
C/G	REMOVE AND REPLACE CURB AND GUTTER
C/GHE	REMOVE CURB AND GUTTER, REPLACE WITH CONCRETE CURB AND GUTTER H.E.
C4HE	REMOVE EXISTING RAMP OR SIDEWALK. REPLACE WITH 4" SIDEWALK OR TYPE 1 SIDEWALK RAMP, H.E.
CR	REMOVE SIDEWALK, DRIVE OR RAMP.
AA	ADJUST MDOT TYPE A CASTINGS.
AB	ADJUST GATE VALVE BOX OR MONUMENT BOX.
ADST	ADDITIONAL DEPTH STRUCTURE REPAIR.
RRA	REMOVE AND REPLACE MDOT TYPE A CASTING ADJUST TO FINISH GRADE.
CPRHE	CONCRETE PAVEMENT REPAIR, H.E.
DS	CONSTRUCT 2, 3 OR 4' DIAM. DRAINAGE STRUCTURE.
PT	POINT STRUCTURE.
C4	REMOVE EXISTING RAMP OR SIDEWALK, REPLACE WITH 4" SIDEWAL OR RAMP.
C6	REMOVE EXISTING RAMP OR SIDEWALK, REPLACE WITH 6" SIDEWAL OR RAMP
C8	PLACE 8" SIDEWALK OR RAMP ONLY
C HE	REMOVE EXISTING DRIVE APPROACH, RAMP OR SIDEWALK. REPLACI WITH 6" OR 8" APPROACH, RAMP,OR SIDEWALK, H.E.
CP	PLACE 4" SIDEWALK OR RAMP.
AK	ADJUST MDOT TYPE K CASTING.
TYPE II	MDOT TYPE II BARRICADE.
TYPE III	MDOT TYPE III BARRICADE.
RRK	REMOVE AND REPLACE MDOT TYPE K CASTING. ADJUST TO FINISH GRADE.
RS	RECONSTRUCT STRUCTURE.
RCP	REMOVE CONC. PAVEMENT - ANY THICKNESS
RCW	RAISED CROSSWALK

	LEGEND
SYMBOL	DESCRIPTION
•	EXISTING SANITARY SEWER MANHOLE
•	EXISTING STORM SEVER MANHOLE
•	EXISTING WATER MAIN VALVE IN WELL
+	WATER MAIN GATE VALVE IN BOX
40.	FIRE HYDRANT
•	MICHCON GAS CO. VALVE BOX/MELL
•	AMERITECH TELEPHONE VAULT
•	ELECTRIC MANHOLE
•	SOIL BORING
0	EXISTING STORM SEWER INLET
•	MONUMENT BOX
	REMOVE AND REPLACE CONG. SIDEWALK
	PLACE CONCRETE SIDEWALK
	REMOVE & REPLACE CONC. CURB & GUTTER
	CONSTRUCTION LIMITS
	6" WRAPPED UNDERDRAIN
	REMOVE CONCRETE SIDEWALK
	SUBGRADE UNDERCUT
PILE AND IT Y	IE A REFERENCE FILL. MAKE CHANGES TO THE REFERENCE BLL UPDATE ALL SHEETS. TO MAKE A CHANGE RIGHT IX OPEN XIEF, MAKE YOUR EDIT AND SAVE.

ľ	2		Know what's be	Call before
			λg	
			DRAWN BY	DRAWN CHECKED
			DATE	DATE
			00 OUT FOR BID	DESCRIPTION
			8	REV.
PBO.IECT MANAGEMENT - PUBLIC SERVICES - CITY OF ANN ARBOR	2014 ANNUAL RESURFACING PROGRAM	(E/(Salar))		2014004LAY-LINWOOD - PLAN VIEW (02)
	_	\neg	_	

SHEET No.

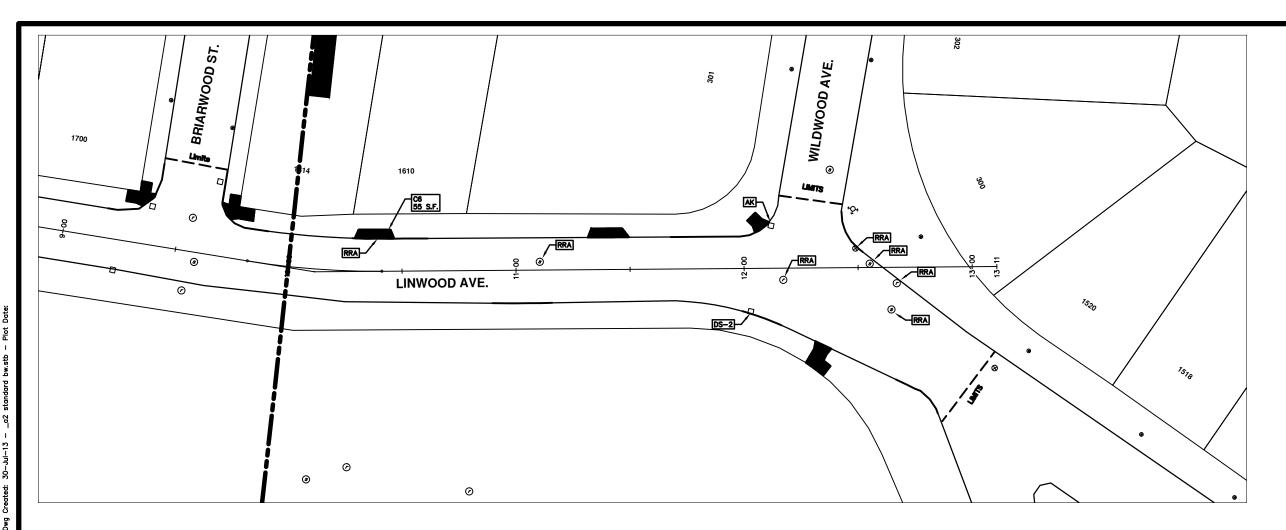




	CONSTRUCTION KEY
KEY	DESCRIPTION
C/G	REMOVE AND REPLACE CURB AND GUTTER
C/GHE	REMOVE CURB AND GUTTER, REPLACE WITH CONCRETE CURB AND GUTTER H.E.
C4HE	REMOVE EXISTING RAMP OR SIDEWALK. REPLACE WITH 4" SIDEWALK OR TYPE 1 SIDEWALK RAMP, H.E.
CR	REMOVE SIDEWALK, DRIVE OR RAMP.
AA	ADJUST MDOT TYPE A CASTINGS.
AB	ADJUST GATE VALVE BOX OR MONUMENT BOX.
ADST	ADDITIONAL DEPTH STRUCTURE REPAIR.
RRA	REMOVE AND REPLACE MDOT TYPE A CASTING ADJUST TO FINISH GRADE.
CPRHE	CONCRETE PAVEMENT REPAIR, H.E.
DS	CONSTRUCT 2, 3 OR 4' DIAM. DRAINAGE STRUCTURE.
PT	POINT STRUCTURE.
C4	REMOVE EXISTING RAMP OR SIDEWALK, REPLACE WITH 4" SIDEWAL OR RAMP.
C6	REMOVE EXISTING RAMP OR SIDEWALK, REPLACE WITH 6" SIDEWAL OR RAMP
C8	PLACE 8" SIDEWALK OR RAMP ONLY
C HE	REMOVE EXISTING DRIVE APPROACH, RAMP OR SIDEWALK. REPLAC WITH 6" OR 8" APPROACH, RAMP, OR SIDEWALK, H.E.
CP	PLACE 4" SIDEWALK OR RAMP.
AK	ADJUST MDOT TYPE K CASTING.
TYPE II	MDOT TYPE II BARRICADE.
TYPE III	MDOT TYPE III BARRICADE.
RRK	REMOVE AND REPLACE MDOT TYPE K CASTING. ADJUST TO FINISH GRADE.
RS	RECONSTRUCT STRUCTURE.
RCP	REMOVE CONC. PAVEMENT - ANY THICKNESS
RCW	RAISED CROSSWALK

	LEGEND
SYMBOL	DESCRIPTION
•	EXISTING SANITARY SEWER MANHOLE
0	EXISTING STORM SEWER MANHOLE
•	EXISTING WATER MAIN VALVE IN WELL
+	WATER MAIN GATE VALVE IN BOX
φ.	FIRE HYDRANT
•	MICHOON GAS CO. VALVE BOX/WELL
•	AMERITECH TELEPHONE VAULT
•	ELECTRIC MANHOLE
•	SOIL BORING
0	EXISTING STORM SEWER INLET
	MONUMENT BOX
	REMOVE AND REPLACE CONG. SIDEWALK
	PLACE CONCRETE SIDEWALK
	REMOVE & REPLACE CONC. CURB & GUTTER
	CONSTRUCTION LIMITS
	6" WRAPPED UNDERDRAIN
	REMOVE CONCRETE SIDEWALK
	SUBGRADE UNDERCUT
FILE AND IT W	S A REFERENCE FILE. MANE CHANGES TO THE REFERENCE LL UPDATE ALL SMEETS. TO MANE A CHANGE RIGHT K OPEN XNEF, MANE YOUR EDIT AND SAVE.

) O		Know what's below	
			BY	DRAWN CHECKED
			DRAWN BY	DRAWN
			DATE	DATE
			00 OUT FOR BID	DESCRIPTION
			8	REV.



PUBLIC SERVICES - CITY OF ANN ARBOR
2014 ANNUAL RESURFACING PROGRAM
LINWOOD

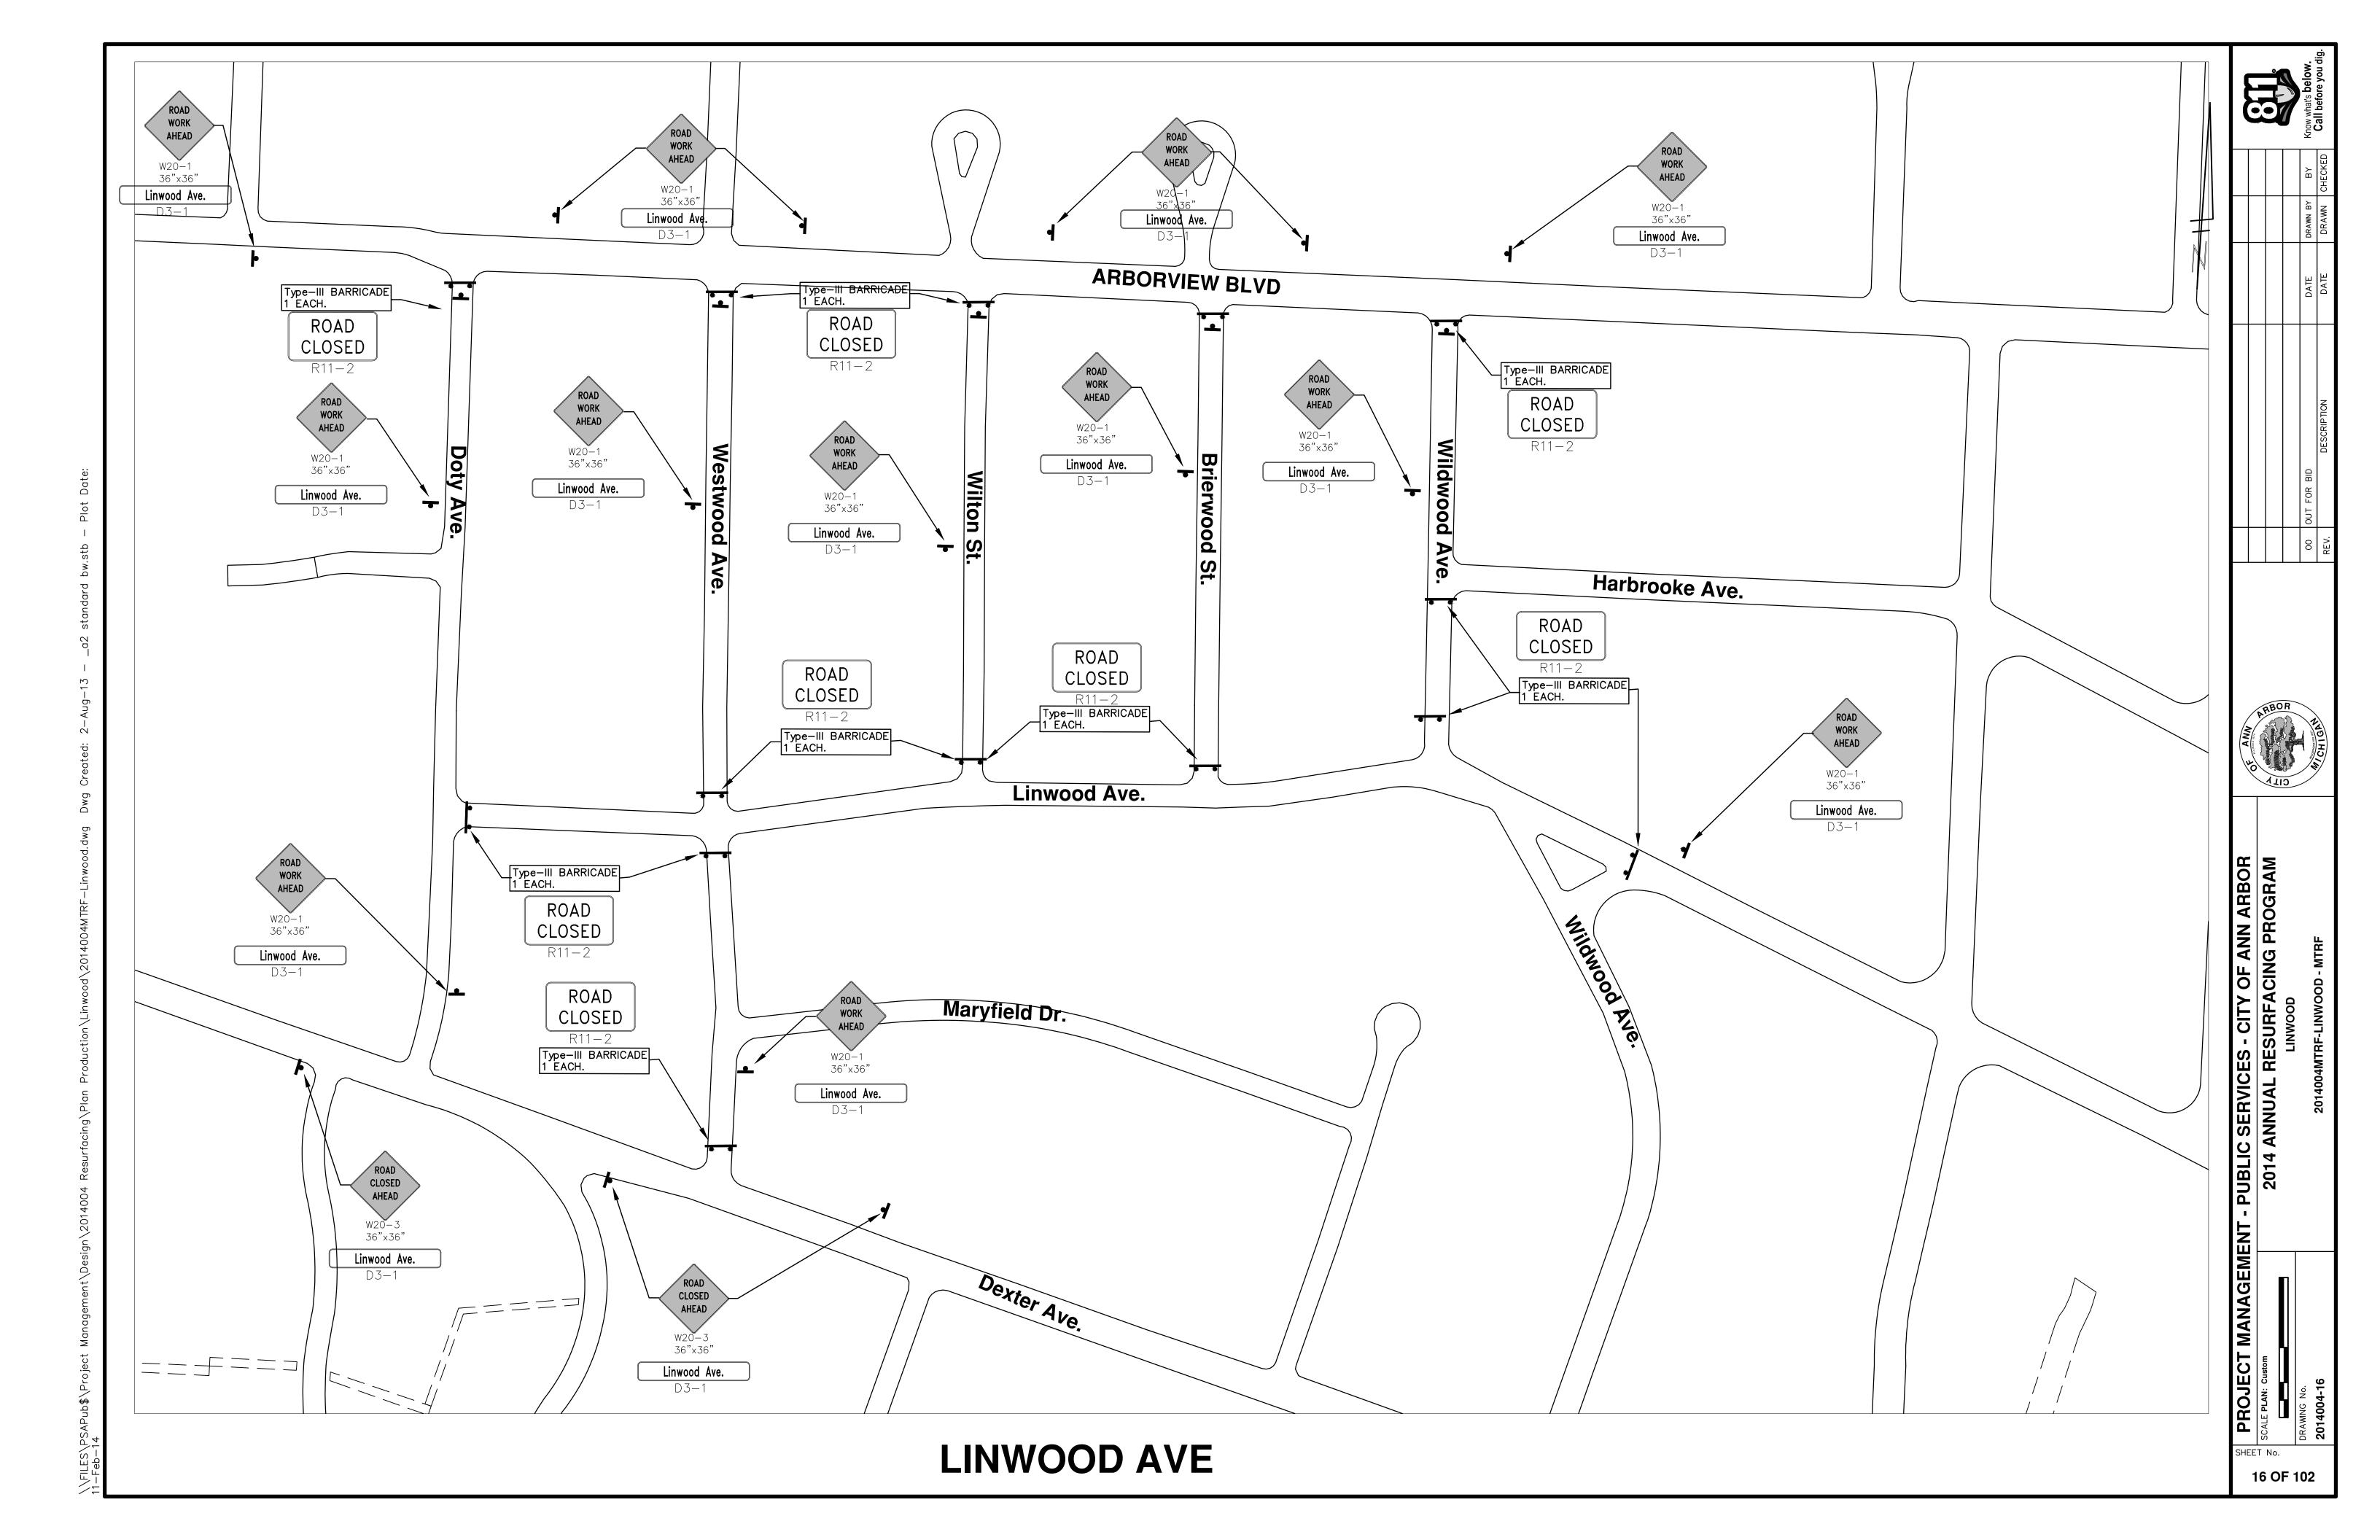



CITY OF ANN ARBOR PROJECT MANAGEMENT 2014 ANNUAL RESURFACING PROGRAM

PROJECT LOCATION: NORTHSIDE GRILL ALLEY

FILE No. 2014004

QUANTITIES

ITEM#	DESCRIPTION	Units	Total
205	Remove HMA Pavement, Alley	Tons	100
209	Subgrade Undercutting - Type II	C.Y.	150
222	HMA Pavement Leveling, Regular	Tons	70
223	HMA Pavement Wearing, Regular	Tons	40
254	Lower Structure Cover	Each	1
255	Lower Mon. / Gate Valve Box	Each	1
256	Adjust Structure Cover	Each	1
258	Adj. Monument or Gate Valve Box	Each	1
259	Manhole Flange & Cover (MDOT Type A)	Each	1
271	21AA Limestone - C.I.P.	C.Y.	150
281	Arrow Panel - Furnish & Operate	Each	1
282	Plastic Drum - Lighted - Furn. & Operate	Each	35
283	Barricade Type III - Furn. & Operate	Each	3
284	Temporary Sign - Type B	S.F.	60
285	No Parking Sign	Each	4
594	Rec. Polyurea Pvmt. Mkg., 4" White	L.F.	150

TRAFFIC CONTROL & SIGN LEGEND

TY.	TYPE	DESCRIPTION
2	W20-1	"ROAD WORK AHEAD"
1	W21-4	"RT. LANE CLOSED AHEAD"
4	D3-1	CONVENTIONAL GUIDE
3	TYPE III	TYPE III LIGHTED BARRICADE
35	TYPE II	TYPE II LIGHTED BARRICADE (DRUM
1	TYPE C	LIGHTED ARROW, TYPE C

CONSTRUCTION METHOD AND SEQUENCING

- THE WORK TO BE COMPLETED ON THIS STREET SHALL INCLUDE, BUT NOT BE LIMITED TO THE FOLLOWING ITEMS. THE ORDER OF CONSTRUCTION SHALL BE AS GIVEN UNLESS OTHERWISE AUTHORIZED OR DIRECTED BY THE ENGINEER.
- 2. IMPLEMENT TRAFFIC MAINTENANCE, AND SOIL EROSION CONTROLS IN ACCORDANCE WITH THE PLANS, AND AS DIRECTED BY THE ENGINEER.
- 3. INSTALL ANY PROPOSED STORM SEWER, AND UNDERDRAIN AS SHOWN ON THE PLANS, AND AS DIRECTED BY THE ENGINEER.
- 4. LOWER ALL STRUCTURE COVERS, INCLUDING VALVE AND MONUMENT BOXES.
- 5. PERFORM ALL CONCRETE WORK, INCLUDING RESTORATION, IN ACCORDANCE WITH THE PLANS, AND AS DIRECTED BY THE ENGINEER.
- 6. EXCAVATE AND REMOVE 4 INCHES OF BITUMINOUS MATERIAL FROM EXISTING ROADWAY. THIS MAY INCLUDE GRANULAR ROAD BASE MATERIAL. DEPTH TO BE DETERMINED BY THE ENGINEER. PROOF ROLL WITH FULL TRUCK.
- 7. PERFORM UNDERCUTS AND/OR BASE REPAIRS AS DIRECTED BY THE ENGINEER.
- 8. Grade, shape, undercut and re-compact the existing road base as required, and as directed by the engineer.
- 9. PAVE 2-1/2 INCHES OF THE BITUMINOUS MIX AS SPECIFIED OR DIRECTED BY THE ENGINEER, AS THE LEVELING COURSE, IN ONE LIFT.
- 10. ADJUST ALL STRUCTURE COVERS, MONUMENT BOXES, AND VALVE BOXES TO THEIR FINISHED ELEVATIONS
- 11. PAVE 1-1/2 INCHES OF THE BITUMINOUS MIX AS SPECIFIED OR DIRECTED BY THE ENGINEER, AS THE WEARING COURSE, IN ONE LIFT.
- 12. COMPLETE ALL PAVEMENT MARKINGS IN ACCORDANCE WITH THE PLANS, AND AS DIRECTED BY THE ENGINEER.
- 13. COMPLETE ALL MISCELLANEOUS CONSTRUCTION INCLUDING ALL CLEAN-UP AND FINAL RESTORATION.
- 14. REMOVE ALL TRAFFIC CONTROL DEVICES. REMOVE MISS DIG FLAGS.

NOTES:

THE CONSTRUCTION COVERED BY THESE PLANS SHALL CONFORM TO THE 1994 EDITION OF THE CITY OF ANN ARBOR PUBLIC SERVICES DEPARTMENT STANDARD SPECIFICATIONS AND IT'S DETAILS WHICH ARE INCLUDED BY REFERENCE. THE OMISSION OF ANY CURRENT STANDARD DETAIL DOES NOT RELIEVE THE CONTRACTOR FROM THIS REQUIREMENT. THE WORK SHALL BE PERFORMED IN COMPLETE CONFORMANCE WITH THE CURRENT PUBLIC SERVICES STANDARD SPECIFICATIONS AND DETAILS.

FOR PROTECTION OF UNDERGROUND UTILITIES AND IN CONFORMANCE WITH PUBLIC ACT 53, THE CONTRACTOR SHALL CALL 811 OR 1-800-482-7171 A MINIMUM OF THREE FULL WORKING DAYS, EXCLUDING SATURDAYS, SUNDAYS, AND HOLIDAYS PRIOR TO BEGINNING EACH EXCAVATION IN AREAS WHERE PUBLIC UTILITIES HAVE NOT BEEN PREVIOUSLY LOCATED. MEMBERS WILL THUS BE ROUTINELY NOTIFIED. THIS DOES NOT RELIEVE THE CONTRACTOR OF THE RESPONSIBILITY OF NOTIFYING UTILITY OWNERS WHO MAY NOT BE A PART OF THE "MISS DIC" ALEFT EXSTEM

THE UNDERGROUND LOCATIONS SHOWN FOR NATURAL GAS (GAS), TELEPHONE (TEL), ELECTRICAL POWER (PWR), CABLE TV (CTV) AND FIBER OPTIC LINES (FIBER) ARE APPROXIMATE. THE CITY OF ANN ARBOR ASSUMES NO RESPONSIBILITY FOR THEIR ACCURATE REPRESENTATION IN THIS DRAWING. MISS DIG MUST BE CONTACTED PRIOR TO CONSTRUCTION TO LOCATE THESE UTILITIES.

MANAGEMENT - PUBLIC SERVICES - CITY OF

OF AMV


PROJECT MANAGEMENT SERVICE UNIT

CITY OF ANN ARBOR PUBLIC SERVICE 301 EAST HURON STREET, P.O. BOX 8647 ANN ARBOR, MICHIGAN 48107-8647 734-794-6410 www.a2gov.org DRAWING N

17 TO 102

7-roject management/Lesign (2014-004 Resultacing Vrian Froduction (Northside Grill Alle) (2014-004-03-100 rolls) will blie) Gwg Uwg Greated: 11-Feb-14

S: \Project Management\Design\2014004

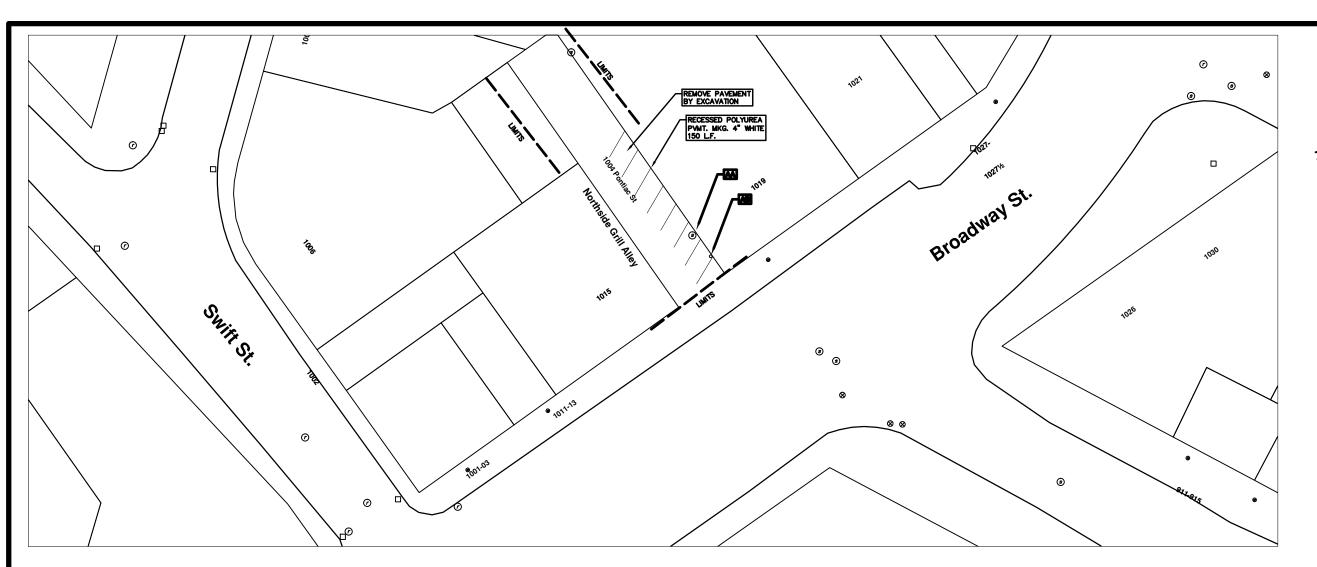


NORTHSIDE GRILL ALLEY

	CONSTRUCTION KEY
KEY	DESCRIPTION
C/G	REMOVE AND REPLACE CURB AND GUTTER
C/GHE	REMOVE CURB AND GUTTER, REPLACE WITH CONCRETE CURB AND GUTTER H.E.
C4HE	REMOVE EXISTING RAMP OR SIDEWALK. REPLACE WITH 4" SIDEWALK OR TYPE 1 SIDEWALK RAMP,H.E.
CR	REMOVE SIDEWALK, DRIVE OR RAMP.
AA	ADJUST MDOT TYPE A CASTINGS.
AB	ADJUST GATE VALVE BOX OR MONUMENT BOX.
ADST	ADDITIONAL DEPTH STRUCTURE REPAIR.
RRA	REMOVE AND REPLACE MDOT TYPE A CASTING ADJUST TO FINISH GRADE.
CPRHE	CONCRETE PAVEMENT REPAIR, H.E.
DS	CONSTRUCT 2, 3 OR 4' DIAM. DRAINAGE STRUCTURE.
PT	POINT STRUCTURE.
C4	REMOVE EXISTING RAMP OR SIDEWALK, REPLACE WITH 4" SIDEWAL OR RAMP.
C6	REMOVE EXISTING RAMP OR SIDEWALK, REPLACE WITH 6" SIDEWAL OR RAMP
C8	PLACE 8" SIDEWALK OR RAMP ONLY
C HE	REMOVE EXISTING DRIVE APPROACH, RAMP SIDEWALK. REPLAC WITH 6" OR 8" APPROACH, RAMP, OR SIDEWALK, H.E.
CP	PLACE 4" SIDEWALK OR RAMP.
AK	ADJUST MDOT TYPE K CASTING.
TYPE II	MDOT TYPE II BARRICADE.
TYPE III	MDOT TYPE III BARRICADE.
RRK	REMOVE AND REPLACE MDOT TYPE K CASTING. ADJUST TO FINISH GRADE.
RS	RECONSTRUCT STRUCTURE.
RCP	REMOVE CONC. PAVEMENT - ANY THICKNESS
RCW	RAISED CROSSWALK

	LEGEND
SYMBOL	DESCRIPTION
9	EXISTING SANITARY SEWER MANHOLE
0	EXISTING STORM SEWER MANHOLE
8	EXISTING WATER MAIN VALVE IN WELL
+	WATER MAIN GATE VALVE IN BOX
ф	FIRE HYDRANT
0	MICHCON GAS CO. VALVE BOX/WELL
Θ	AMERITECH TELEPHONE VAULT
	ELECTRIC MANHOLE
•	SOIL BORING
	EXISTING STORM SEWER INLET
•	MONUMENT BOX
	REMOVE AND REPLACE CONC. SIDEWALK
*	PLACE CONCRETE SIDEWALK
—	REMOVE & REPLACE CONC. CURB & GUTTER
	CONSTRUCTION LIMITS
	6" WRAPPED UNDERDRAIN
	REMOVE CONCRETE SIDEWALK
	SUBGRADE UNDERCUT

- PUBLIC SERVICES - CITY OF ANN ARBOR
2014 ANNUAL RESURFACING PROGRAM
NORTHSIDE GRILL ALLEY
CONSTRUCTION PLAN

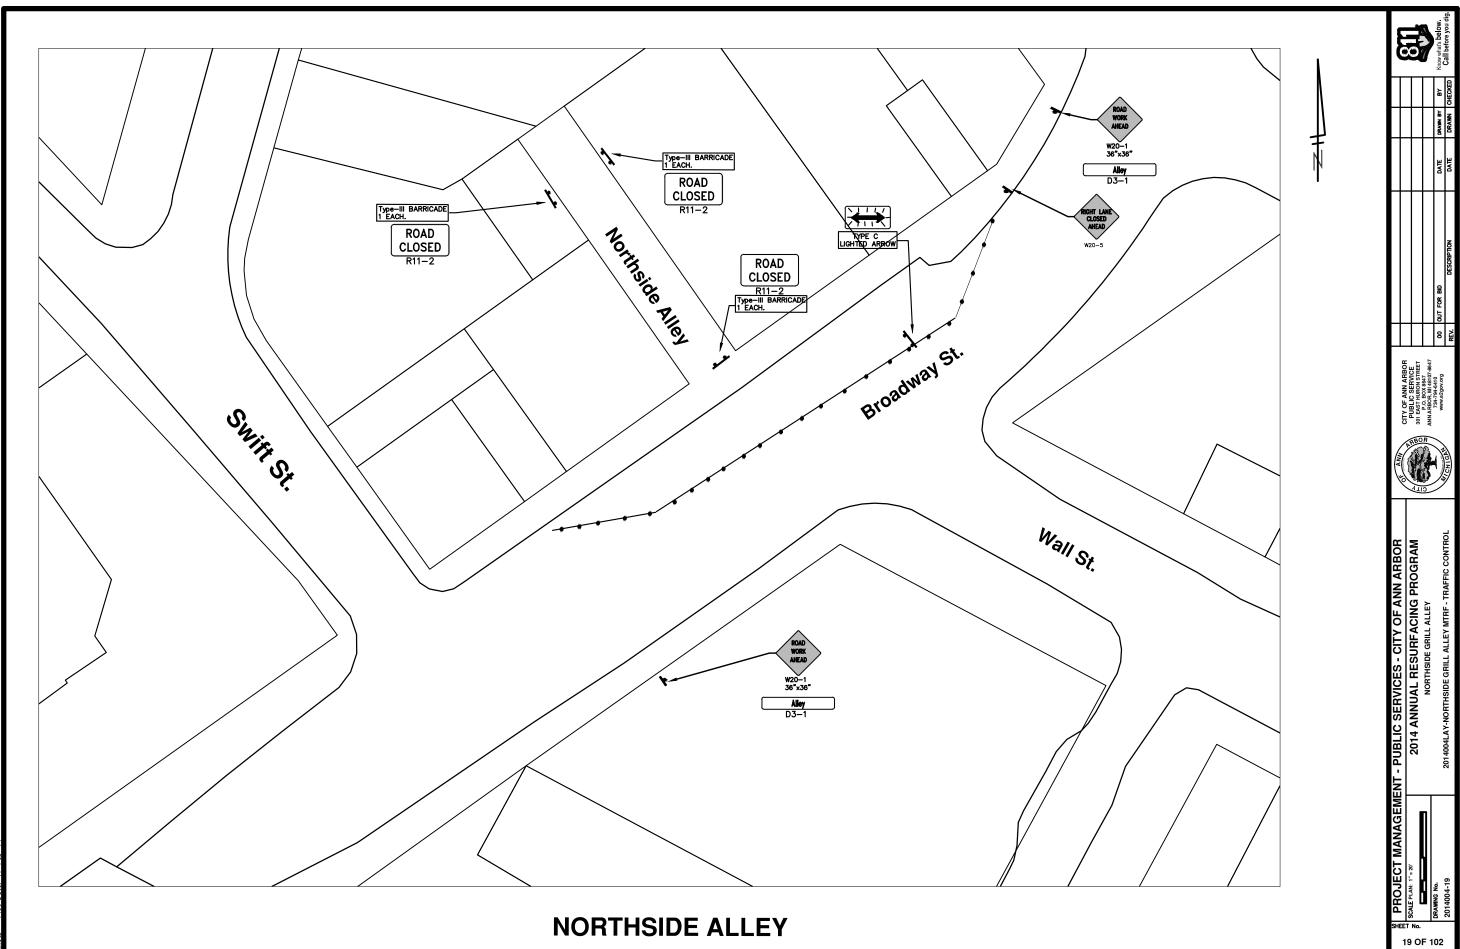



CITY OF ANN ARBOR PROJECT MANAGEMENT 2014 ANNUAL RESURFACING PROGRAM PROJECT LOCATION: FULLER ROAD

FILE No. 2014004

QUANTITIES

ITEM#	DESCRIPTION	Units	Total
206	Remove HMA Pavement	S.Y.	400
207	Cold Milling Pavement	Tons	2720
209	Subgrade Undercutting	C.Y.	1230
220	HMA Patching	Tons	400
226	HMA Pavement Wearing - 5E3	Tons	1170
227	HMA Pavement Base or Leveling - 4E3	Tons	1550
230	Remove Curb & Gutter, Any Type	L.F.	430
232	Remove Conc. S/Walk & Drive - Any Thickness	S.F.	2840
237	Conc. Curb & Gutter - Any type - Fixed Form	L.F.	430
240	4" Sidewalk or Ramp	S.F.	2170
241	6" Drive, Sidewalk or Ramp	S.F.	680
245	Detectable Warning, Cast in Place	S.F.	144
254	Lower Structure Cover	Each	3
256	Adjust Structure Covers	Each	3
257	Adjust Curb Inlet Structure Cover	Each	7
260	Inlet Structure Cover (MDOT Type K)	Each	2
268	Flowable Fill	C.Y.	10
271	21AA Limestone - C.I.P.	C.Y.	1230
281	Arrow Panel, Furn. & Operate	Each	2
282	Plastic Drum - Lighted - Furn. & Operate	Each	200
283	Barricade Type III - Furn. & Operate	Each	7
284	Temp Sign - Type B	S.F.	580
286	Sign, Portable Changeable Mess., Furn.	Each	2
287	Sign, Portable Changeable Mess., Oper.	Each	2
297	Cold Plastic Bike Symbol - "Sharrow"	Each	4
594	Rec. Polyurea Pvmt. Mkg., 4" White	L.F.	1200
595	Rec. Polyurea Pvmt. Mkg., 4" Yellow	L.F.	1436
597	Rec. Polyurea Pvmt. Mkg., 24" White	L.F.	757

Rec. Polyurea Pvmt. Mkg., Symbol or Legend Each 30

TRAFFIC CONTROL & SIGN LEGEND

TY.		TYPE	DESCRIPTION
	16	W20-1	"ROAD WORK AHEAD"
	16	W20-5	"(RIGHT OR LEFT) LANE CLOSED AHEAD
	16	D3-1	CONVENTIONAL GUIDE
	7	TYPE III	TYPE III LIGHTED BARRICADE
	200	TVPF II	TYPE ILLIGHTED BARRICADE (DRUM)

CONSTRUCTION METHOD AND SEQUENCING

- THE WORK TO BE COMPLETED ON THIS STREET SHALL INCLUDE, BUT NOT BE LIMITED TO THE FOLLOWING ITEMS. THE ORDER OF CONSTRUCTION SHALL BE AS GIVEN UNLESS OTHERWISE AUTHORIZED OR DIRECTED BY THE ENGINEER.
- IMPLEMENT TRAFFIC MAINTENANCE, AND SOIL EROSION CONTROLS IN ACCORDANCE WITH THE PLANS, AND AS DIRECTED BY THE ENGINEER.
- 3. Install any proposed storm sewer, and underdrain as shown on the plans, and as directed by the engineer.
- 4. LOWER ALL STRUCTURE COVERS, INCLUDING VALVE AND MONUMENT BOXES.
- . PERFORM ALL CONCRETE WORK, INCLUDING RESTORATION, IN ACCORDANCE WITH THE PLANS, AND AS DIRECTED BY THE ENGINEER.
- MILL 3 1/2 INCHES OF BITUMINOUS MATERIAL FROM EXISTING ROADWAY. THIS MAY INCLUDE GRANULAR ROAD BASE MATERIAL DEPTH TO BE DIRECTED BY THE ENGINEER. PROOF ROLL WITH FULL TRUCK.
- PERFORM DETAIL 7 AND/OR 8 REPAIRS, UNDERCUTS AND/OR BASE REPAIRS AS DIRECTED BY THE ENGINEER.
- 8. PAVE 2 INCHES OF THE BITUMINOUS MIX 4E OR AS DIRECTED BY THE ENGINEER, AS THE LEVELING COURSE, IN ONE LIFT.
 9. ADJUST ALL STRUCTURE COVERS, MONUMENT BOXES, AND VALVE BOXES TO THEIR FINISHED ELEVATIONS.
- 10. PAVE 1-1/2 INCHES OF THE BITUMINOUS MIX 5E OR AS DIRECTED BY THE ENGINEER, AS THE WEARING COURSE, IN ONE LIFT.
- 11. INSTALL ALL PAVEMENT MARKINGS IN ACCORDANCE WITH THE PLANS OR AS DIRECTED BY THE ENGINEER.
- 12. COMPLETE ALL MISCELLANEOUS CONSTRUCTION INCLUDING ALL CLEAN-UP AND FINAL RESTORATION.
- 13. REMOVE ALL TRAFFIC CONTROL DEVICES. REMOVE MISS DIG FLAGS.

NOTES:

THE CONSTRUCTION COVERED BY THESE PLANS SHALL CONFORM TO THE 1994 EDITION OF THE CITY OF ANN ARBOR PUBLIC SERVICES DEPARTMENT STANDARD SPECIFICATIONS AND IT'S DETAILS WHICH ARE INCLUDED BY REFERENCE. THE OMISSION OF ANY CURRENT STANDARD DETAIL DOES NOT RELIEVE THE CONTRACTOR FROM THIS REQUIREMENT. THE WORK SHALL BE PERFORMED IN COMPLETE CONFORMANCE WITH THE CURRENT PUBLIC SERVICES STANDARD SPECIFICATIONS AND DETAILS.

FOR PROTECTION OF UNDERGROUND UTILITIES AND IN CONFORMANCE WITH PUBLIC ACT 53, THE CONTRACTOR SHALL CALL 811 OR 1-800-482-7171 A MINIMUM OF THREE FULL WORKING DAYS, EXCLUDING SATURDAYS, SUNDAYS, AND HOLDAYS PRIOR TO BEGINNING EACH EXCAVATION IN AREAS WHERE PUBLIC UTILITIES HAVE NOT BEEN PREVIOUSLY LOCATED. MEMBERS WILL THUS BE ROUTINELY NOTIFIED. THIS DOES NOT RELIEVE THE CONTRACTOR OF THE RESPONSIBILITY OF NOTIFYING UTILITY OWNERS WHO MAY NOT BE A PART OF THE "MISS DIG" ALERT SYSTEM.

THE UNDERGROUND LOCATIONS SHOWN FOR NATURAL GAS (GAS), TELEPHONE (TEL), ELECTRICAL POWER (PWR), CABLE TV (CTV) AND FIBER OPTIC LINES (FIBER) ARE APPROXIMATE. THE CITY OF ANN ARBOR ASSUMES NO RESPONSIBILITY FOR THEIR ACCURATE REPRESENTATION IN THIS DRAWING. MISS DIG MUST BE CONTACTED PRIOR TO CONSTRUCTION TO LOCATE THESE UTILITIES.

OF ANN YES

PROJECT MANAGEMENT SERVICE UNIT


CITY OF ANN ARBOR PUBLIC SERVICE 301 EAST HURON STREET, P.O. BOX 8647 ANN ARBOR, MICHIGAN 48107-8647 734-794-6410 www.a2gov.org Know what's below

NPTION 2014 ANNUAL RESURFACING

ROJECT DESCRIPTION

DRAWING No. 2014004 - 20


20 TO 102

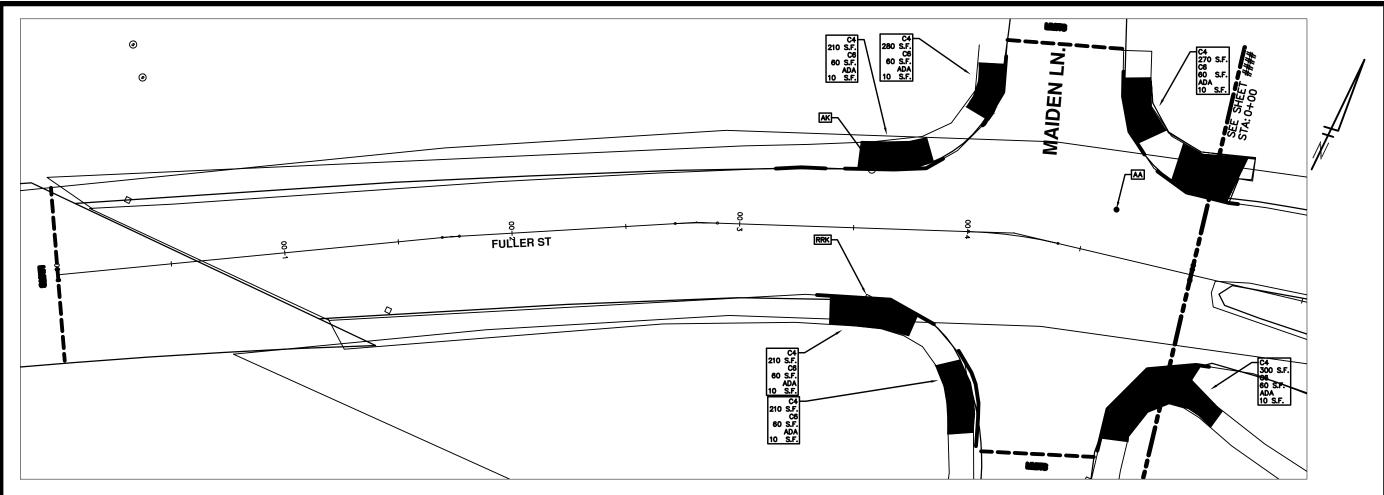

	CONSTRUCTION KEY
KEY	DESCRIPTION
C/G	REMOVE AND REPLACE CURB AND GUTTER
C/GHE	REMOVE CURB AND GUTTER, REPLACE WITH CONCRETE CURB AND GUTTER H.E.
C4HE	REMOVE EXISTING RAMP OR SIDEWALK. REPLACE WITH 4" SIDEWALK OR TYPE 1 SIDEWALK RAMP, H.E.
CR	REMOVE SIDEWALK, DRIVE OR RAMP.
AA	ADJUST MDOT TYPE A CASTINGS.
AB	ADJUST GATE VALVE BOX OR MONUMENT BOX.
ADST	ADDITIONAL DEPTH STRUCTURE REPAIR.
RRA	REMOVE AND REPLACE MDOT TYPE A CASTING ADJUST TO FINISH GRADE.
CPRHE	CONCRETE PAVEMENT REPAIR, H.E.
DS	CONSTRUCT 2, 3 OR 4' DIAM. DRAINAGE STRUCTURE.
PT	POINT STRUCTURE.
C4	REMOVE EXISTING RAMP OR SIDEWALK, REPLACE WITH 4" SIDEWAL OR RAMP.
C6	REMOVE EXISTING RAMP OR SIDEWALK, REPLACE WITH 6" SIDEWAL OR RAMP
СВ	PLACE 8" SIDEWALK OR RAMP ONLY
C HE	REMOVE EXISTING DRIVE APPROACH, RAMP OR SIDEWALK. REPLAC WITH 6" OR 8" APPROACH, RAMP, OR SIDEWALK, H.E.
CP	PLACE 4" SIDEWALK OR RAMP.
AK	ADJUST MDOT TYPE K CASTING.
TYPE II	MDOT TYPE II BARRICADE.
TYPE III	MDOT TYPE III BARRICADE.
RRK	REMOVE AND REPLACE MDOT TYPE K CASTING. ADJUST TO FINISH GRADE.
RS	RECONSTRUCT STRUCTURE.
RCP	REMOVE CONC. PAVEMENT - ANY THICKNESS
RCW	RAISED CROSSWALK

	LEGEND
SYMBOL	DESCRIPTION
•	EXISTING SANITARY SEWER MANHOLE
•	EXISTING STORM SEWER MANHOLE
•	EXISTING WATER MAIN VALVE IN WELL
+	WATER MAIN GATE VALVE IN BOX
δ.	FIRE HYDRANT
•	MICHOON GAS CO. VALVE BOX/WELL
•	AMERITECH TELEPHONE VAULT
•	ELECTRIC MANHOLE
•	SOIL BORING
0	EXISTING STORM SEWER INLET
•	MONUMENT BOX
	REMOVE AND REPLACE CONC. SIDEWALK
	PLACE CONCRETE SIDEWALK
	REMOVE & REPLACE CONC. CURB & GUTTER
	CONSTRUCTION LIMITS
	6" WRAPPED UNDERDRAIN
	REMOVE CONCRETE SIDEWALK
	SUBGRADE UNDERCUT
FILE AND IT W	S A REFERENCE FILE. MANE CHANGES TO THE REFERENCE IL UPDATE ALL SHEETS. TO MAKE A CHANGE RIGHT K OPEN XMEF, MAKE YOUR EDIT AND SAVE.


			₽9.	DRAWN CHECKED	
Ш			DRAWN BY	DRAWN	
			DATE	DATE	
			00 OUT FOR BID	DESCRIPTION	
			8	REV.	
PROJECT MANAGEMENT - PUBLIC SERVICES - CITY OF ANN ARBOR	2014 ANNUAL RESURFACING PROGRAM	FULLER	TO MILITARE DE LA CONTROL	ZU14004LAT-FULLER - FLAN VIEW (U1)	
	SCALE		DRAWING No.	2014004-21	
SHEE 2	T No. 21 O	F 1	02		
-					1

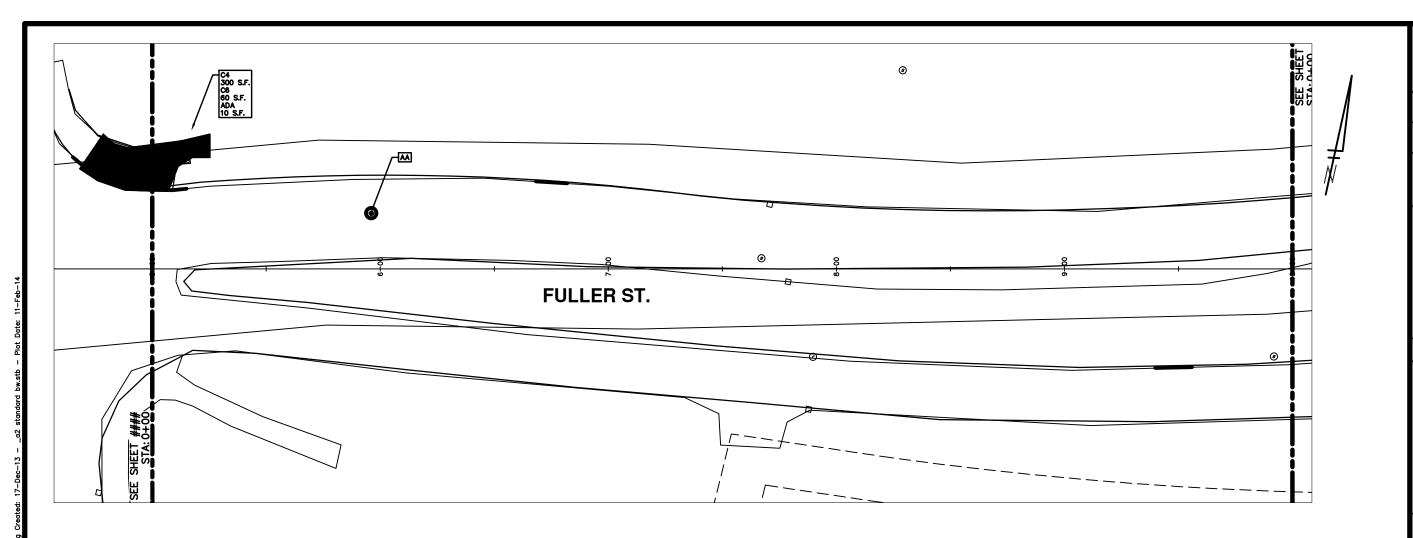

	CONSTRUCTION KEY
KEY	DESCRIPTION
C/G	REMOVE AND REPLACE CURB AND GUTTER
C/GHE	REMOVE CURB AND GUTTER, REPLACE WITH CONCRETE CURB AND GUTTER H.E.
C4HE	REMOVE EXISTING RAMP OR SIDEWALK. REPLACE WITH 4" SIDEWALK OR TYPE 1 SIDEWALK RAMP,H.E.
CR	REMOVE SIDEWALK, DRIVE OR RAMP.
AA	ADJUST MDOT TYPE A CASTINGS.
AB	ADJUST GATE VALVE BOX OR MONUMENT BOX.
ADST	ADDITIONAL DEPTH STRUCTURE REPAIR.
RRA	REMOVE AND REPLACE MDOT TYPE A CASTING ADJUST TO FINISH GRADE.
CPRHE	CONCRETE PAVEMENT REPAIR, H.E.
DS	CONSTRUCT 2, 3 OR 4' DIAM. DRAINAGE STRUCTURE.
PT	POINT STRUCTURE.
C4	REMOVE EXISTING RAMP OR SIDEWALK, REPLACE WITH 4" SIDEWALL OR RAMP.
C6	REMOVE EXISTING RAMP OR SIDEWALK, REPLACE WITH 6" SIDEWALK OR RAMP
C8	PLACE 8" SIDEWALK OR RAMP ONLY
C HE	REMOVE EXISTING DRIVE APPROACH, RAMP OR SIDEWALK. REPLACE WITH 6" OR 8" APPROACH, RAMP,OR SIDEWALK, H.E.
CP	PLACE 4" SIDEWALK OR RAMP.
AK	ADJUST MDOT TYPE K CASTING.
TYPE II	MDOT TYPE II BARRICADE.
TYPE III	MDOT TYPE III BARRICADE.
RRK	REMOVE AND REPLACE MDOT TYPE K CASTING. ADJUST TO FINISH GRADE.
RS	RECONSTRUCT STRUCTURE.
RCP	REMOVE CONC. PAVEMENT - ANY THICKNESS
RCW	RAISED CROSSWALK

	LEGEND
SYMBOL	DESCRIPTION
•	EXISTING SANITARY SEWER MANHOLE
•	EXISTING STORM SEWER MANHOLE
•	EXISTING WATER MAIN VALVE IN WELL
+	WATER MAIN GATE VALVE IN BOX
φ.	FIRE HYDRANT
•	MICHOON GAS CO. VALVE BOX/WELL
•	AMERITECH TELEPHONE VAULT
•	ELECTRIC MANHOLE
•	SOIL BORING
0	EXISTING STORM SEWER INLET
•	MONUMENT BOX
	REMOVE AND REPLACE CONC. SIDEWALK
777	PLACE CONCRETE SIDEWALK
	REMOVE & REPLACE CONC. CURB & GUTTER
	CONSTRUCTION LIMITS
	6" WRAPPED UNDERDRAIN
	REMOVE CONCRETE SIDEWALK
	SUBGRADE UNDERCUT
FILE AND IT WE CLICK AND PIC	S A REPERENCE PILE. MANGE CHANGES TO THE REPERENCE. LL UPDATE ALL SHEETS. TO MAKE A CHANCE RIGHT K OPEN WREF, MAKE YOUR EDIT AND SAVE.


			DATE DRAWN BY Know what's below.	DATE DRAWN CHECKED CAll before you dig.	
			00 OUT FOR BID	DESCRIPTION	
			8	REV.	
ANA	BE WALL	R		CHICK	

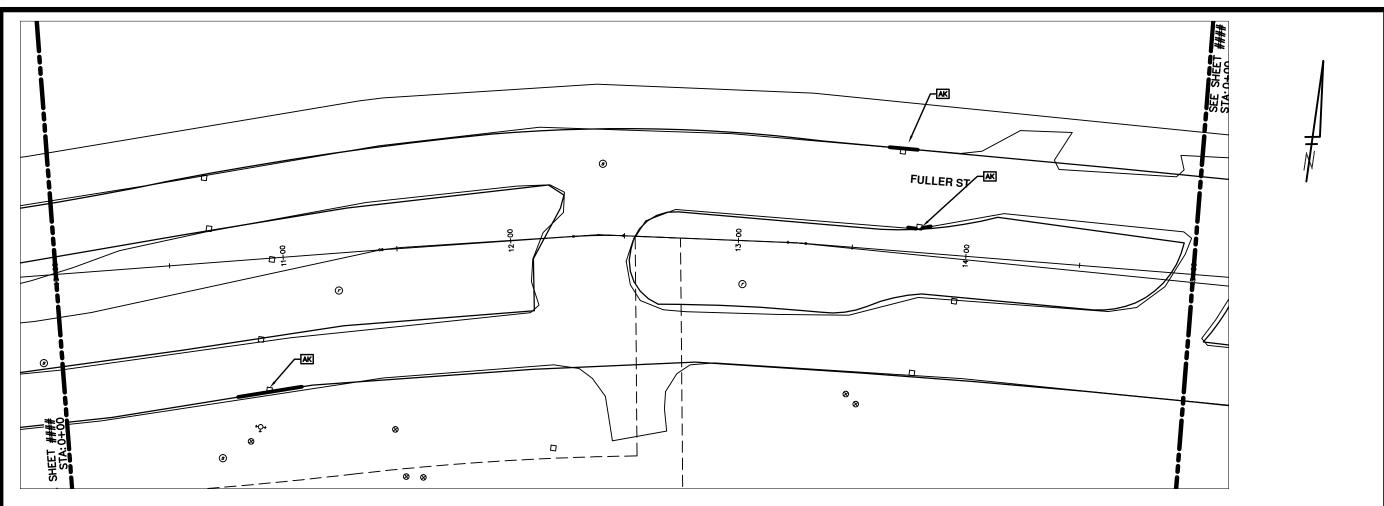

	CONSTRUCTION KEY
KEY	DESCRIPTION
C/G	REMOVE AND REPLACE CURB AND GUTTER
C/GHE	REMOVE CURB AND GUTTER, REPLACE WITH CONCRETE CURB AND GUTTER H.E.
C4HE	REMOVE EXISTING RAMP OR SIDEWALK. REPLACE WITH 4" SIDEWALK OR TYPE 1 SIDEWALK RAMP, H.E.
CR	REMOVE SIDEWALK, DRIVE OR RAMP.
AA	ADJUST MDOT TYPE A CASTINGS.
AB	ADJUST GATE VALVE BOX OR MONUMENT BOX.
ADST	ADDITIONAL DEPTH STRUCTURE REPAIR.
RRA	REMOVE AND REPLACE MDOT TYPE A CASTING ADJUST TO FINISH GRADE.
CPRHE	CONCRETE PAVEMENT REPAIR, H.E.
DS	CONSTRUCT 2, 3 OR 4' DIAM. DRAINAGE STRUCTURE.
PT	POINT STRUCTURE.
C4	REMOVE EXISTING RAMP OR SIDEWALK, REPLACE WITH 4" SIDEWAL OR RAMP.
C6	REMOVE EXISTING RAMP OR SIDEWALK, REPLACE WITH 6" SIDEWAL OR RAMP
C8	PLACE 8" SIDEWALK OR RAMP ONLY
C HE	REMOVE EXISTING DRIVE APPROACH, RAMP OR SIDEWALK. REPLAC WITH 6" OR 8" APPROACH, RAMP, OR SIDEWALK, H.E.
CP	PLACE 4" SIDEWALK OR RAMP.
AK	ADJUST MDOT TYPE K CASTING.
TYPE II	MDOT TYPE II BARRICADE.
TYPE III	MDOT TYPE III BARRICADE.
RRK	REMOVE AND REPLACE MDOT TYPE K CASTING. ADJUST TO FINISH GRADE.
RS	RECONSTRUCT STRUCTURE.
RCP	REMOVE CONC. PAVEMENT - ANY THICKNESS
RCW	RAISED CROSSWALK

	LEGEND
SYMBOL	DESCRIPTION
•	EXISTING SANITARY SEWER MANHOLE
•	EXISTING STORM SEWER MANHOLE
•	EXISTING WATER MAIN VALVE IN WELL
+	WATER MAIN GATE VALVE IN BOX
•₺•	FIRE HYDRANT
•	MICHCON GAS CO. VALVE BOX/WELL
•	AMERITECH TELEPHONE VAULT
•	ELECTRIC MANHOLE
•	SOIL BORING
0	EXISTING STORM SEWER INLET
•	MONUMENT BOX
	REMOVE AND REPLACE CONG. SIDEWALK
	PLACE CONCRETE SIDEWALK
	REMOVE & REPLACE CONC. CURB & GUTTER
	CONSTRUCTION LIMITS
	6" WRAPPED UNDERDRAIN
	REMOVE CONCRETE SIDEWALK
	SUBGRADE UNDERCUT
PILE AND IT WE GLICK AND PIC	S A REFERENCE FILE. MAKE CHANGES TO THE REFERENCE IL UPDATE ALL SHEETS. TO MAKE A CHANGE MIGHT K OPEN WIEF, MAKE YOUR EDIT AND SAVE.

	_		_	Ϋ́	3
				¥8	DRAWN CHECKED
				DRAWN BY	DRAWN
				DATE	DATE
				OUT FOR BID	DESCRIPTION
				8	REV.
PROJECT MANAGEMENT - PUBLIC SERVICES - CITY OF ANN ARBOR		2014 ANNUAL RESURFACING PROGRAM	FULLER		Z014004LAY-ULLEH - PLAN VIEW (03)
PROJECT MANAGEN		SCALE PLAN: 1 = ZU		DRAWING No.	2014004-23
SHE	23	No. 3 O	F 1	102	

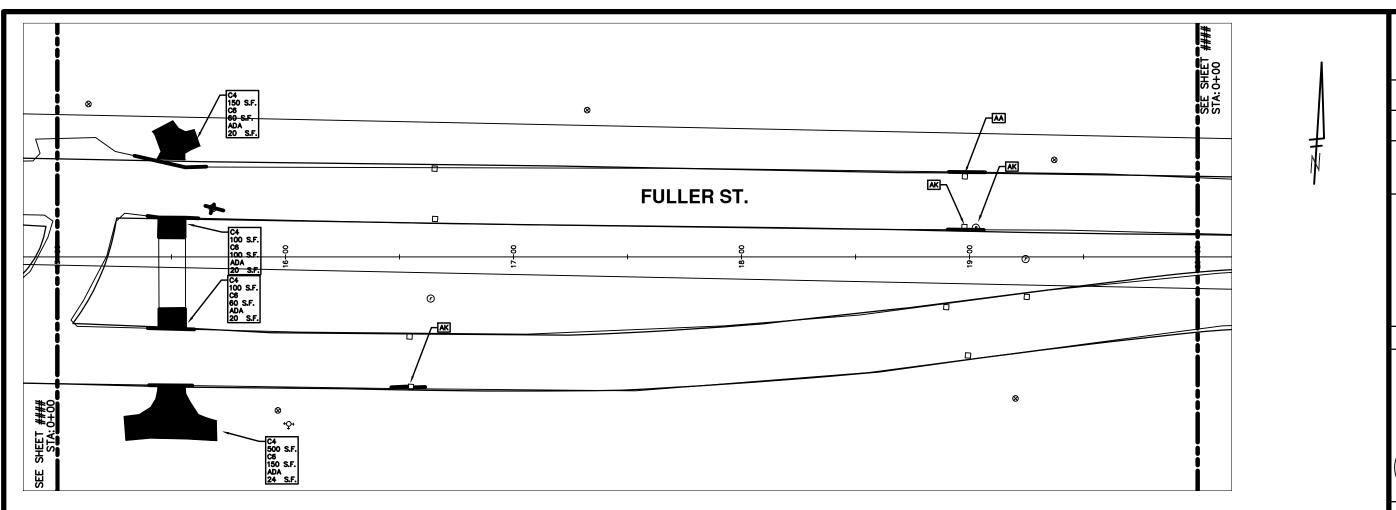


	CONSTRUCTION KEY
KEY	DESCRIPTION
C/G	REMOVE AND REPLACE CURB AND GUTTER
C/GHE	REMOVE CURB AND GUTTER, REPLACE WITH CONCRETE CURB AND GUTTER H.E.
C4HE	REMOVE EXISTING RAMP OR SIDEWALK. REPLACE WITH 4" SIDEWALK OR TYPE 1 SIDEWALK RAMP, H.E.
CR	REMOVE SIDEWALK, DRIVE OR RAMP.
AA	ADJUST MDOT TYPE A CASTINGS.
AB	ADJUST GATE VALVE BOX OR MONUMENT BOX.
ADST	ADDITIONAL DEPTH STRUCTURE REPAIR.
RRA	REMOVE AND REPLACE MDOT TYPE A CASTING ADJUST TO FINISH GRADE.
CPRHE	CONCRETE PAVEMENT REPAIR, H.E.
DS	CONSTRUCT 2, 3 OR 4' DIAM. DRAINAGE STRUCTURE.
PT	POINT STRUCTURE.
C4	REMOVE EXISTING RAMP OR SIDEWALK, REPLACE WITH 4" SIDEWAL OR RAMP.
C6	REMOVE EXISTING RAMP OR SIDEWALK, REPLACE WITH 6" SIDEWAL OR RAMP
СВ	PLACE 8" SIDEWALK OR RAMP ONLY
C HE	REMOVE EXISTING DRIVE APPROACH, RAMP OR SIDEWALK. REPLACI WITH 6" OR 8" APPROACH, RAMP,OR SIDEWALK, H.E.
CP	PLACE 4" SIDEWALK OR RAMP.
AK	ADJUST MDOT TYPE K CASTING.
TYPE II	MDOT TYPE II BARRICADE.
TYPE III	MDOT TYPE III BARRICADE.
RRK	REMOVE AND REPLACE MDOT TYPE K CASTING. ADJUST TO FINISH GRADE.
RS	RECONSTRUCT STRUCTURE.
RCP	REMOVE CONC. PAVEMENT - ANY THICKNESS
RCW	RAISED CROSSWALK

	LEGEND		
SYMBOL	DESCRIPTION		
•	EXISTING SANITARY SEWER MANHOLE		
•	EXISTING STORM SEWER MANHOLE		
•	EXISTING WATER MAIN VALVE IN WELL		
+	WATER MAIN GATE VALVE IN BOX		
-&-	FIRE HYDRANT		
•	MICHCON GAS CO. VALVE BOX/MELL		
•	AMERITECH TELEPHONE VAULT		
•	ELECTRIC MANHOLE		
SOIL BORING			
0	EXISTING STORM SEWER INLET		
•	MONUMENT BOX		
	REMOVE AND REPLACE CONC. SIDEWALK		
7773	PLACE CONCRETE SIDEWALK		
	REMOVE & REPLACE CONC. CURB & GUTTER		
	CONSTRUCTION LIMITS		
	6" WRAPPED UNDERDRAIN		
	REMOVE CONCRETE SIDEWALK		
	SUBGRADE UNDERCUT		
PILE AND IT WE CLICK AND PICE	S A REPERENCE FILE. MAKE CHANGES TO THE REFERENCE LL UPDATE ALL SHEETS. TO MAKE A CHANCE RIGHT K OPEN XREF, MAKE YOUR EDIT AND SAVE.		

- PUBLIC SERVICES - CITY OF ANN ARBOR 2014 ANNUAL RESURFACING PROGRAM FULLER

FILES\PSAPub\$\Project Management\Design\2014004 Resurfacing\Plan Production\Fu

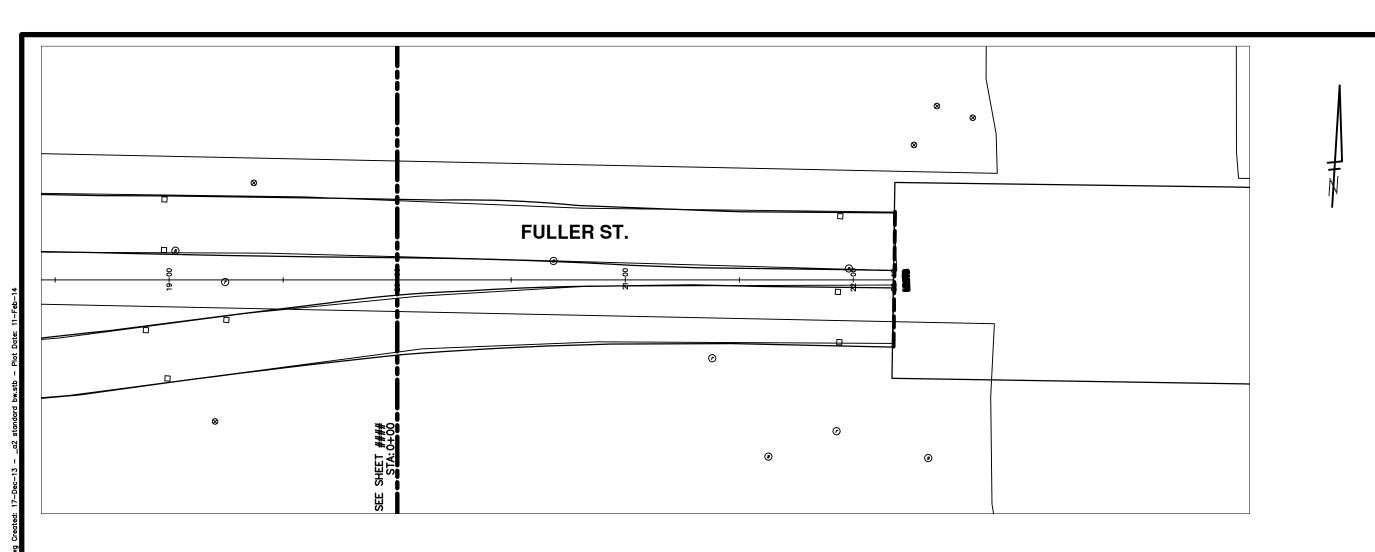



CONSTRUCTION KEY				
KEY	DESCRIPTION			
C/G	REMOVE AND REPLACE CURB AND GUTTER			
C/GHE	REMOVE CURB AND GUTTER, REPLACE WITH CONCRETE CURB AND GUTTER H.E.			
C4HE	REMOVE EXISTING RAMP OR SIDEWALK. REPLACE WITH 4" SIDEWALK OR TYPE 1 SIDEWALK RAMP, H.E.			
CR	REMOVE SIDEWALK, DRIVE OR RAMP.			
AA	ADJUST MDOT TYPE A CASTINGS.			
AB	ADJUST GATE VALVE BOX OR MONUMENT BOX.			
ADST	ADDITIONAL DEPTH STRUCTURE REPAIR.			
RRA	REMOVE AND REPLACE MDOT TYPE A CASTING ADJUST TO FINISH GRADE.			
CPRHE	CONCRETE PAVEMENT REPAIR, H.E.			
DS	CONSTRUCT 2, 3 OR 4' DIAM. DRAINAGE STRUCTURE.			
PT	POINT STRUCTURE.			
C4	REMOVE EXISTING RAMP OR SIDEWALK, REPLACE WITH 4" SIDEWAL OR RAMP.			
C6	REMOVE EXISTING RAMP OR SIDEWALK, REPLACE WITH 6" SIDEWAL OR RAMP			
C8	PLACE 8" SIDEWALK OR RAMP ONLY			
C HE	REMOVE EXISTING DRIVE APPROACH, RAMP OR SIDEWALK. REPLAC WITH 6" OR 8" APPROACH, RAMP, OR SIDEWALK, H.E.			
CP	PLACE 4" SIDEWALK OR RAMP.			
AK	ADJUST MDOT TYPE K CASTING.			
TYPE II	MDOT TYPE II BARRICADE.			
TYPE III	MDOT TYPE III BARRICADE.			
RRK	REMOVE AND REPLACE MOOT TYPE K CASTING. ADJUST TO FINISH GRADE.			
RS	RECONSTRUCT STRUCTURE.			
RCP	REMOVE CONC. PAVEMENT - ANY THICKNESS			
RCW	RAISED CROSSWALK			


	LEGEND
SYMBOL	DESCRIPTION
•	EXISTING SANITARY SEWER MANHOLE
0	EXISTING STORM SEWER MANHOLE
•	EXISTING WATER MAIN VALVE IN WELL
+	WATER MAIN GATE VALVE IN BOX
Ŷ	FIRE HYDRANT
•	MICHOON GAS CO. VALVE BOX/WELL
•	AMERITECH TELEPHONE VAULT
•	ELECTRIC MANHOLE
•	SOIL BORING
0	EXISTING STORM SEWER INLET
•	MONUMENT BOX
	REMOVE AND REPLACE CONG. SIDEWALK
774.	PLACE CONCRETE SIDEWALK
	REMOVE & REPLACE CONC. CURB & GUTTER
	CONSTRUCTION LIMITS
	6" WRAPPED UNDERDRAIN
	REMOVE CONCRETE SIDEWALK
	SUBGRADE UNDERCUT
PILE AND IT WE CLICK AND PICE	S A REFERENCE FILE. MAKE CHANGES TO THE REFERENCE IL UPDATE ALL SHEETS. TO MAKE A CHANGE MIGHT K OPEN WEF, MAKE YOUR ESIT AND SAKE.

JECT MANAGEME	JECT MANAGEMENT - PUBLIC SERVICES - CITY OF ANN ARBOR	AMA	H			П		T
No. 1:: - 20:								S O
	2014 ANNUAL RESURFACING PROGRAM	ABO						3
	FULLER	H P O						
No.			8	00 OUT FOR BID	DATE	DRAWN BY	Æ	Know what's below
1-25	2014004LAY-FULLER - PLAN VIEW (05)	WCHIGAN RE	REV.	DESCRIPTION	DATE	DRAWN CHECKED	CHECKED	Call before you dig.

EET No.

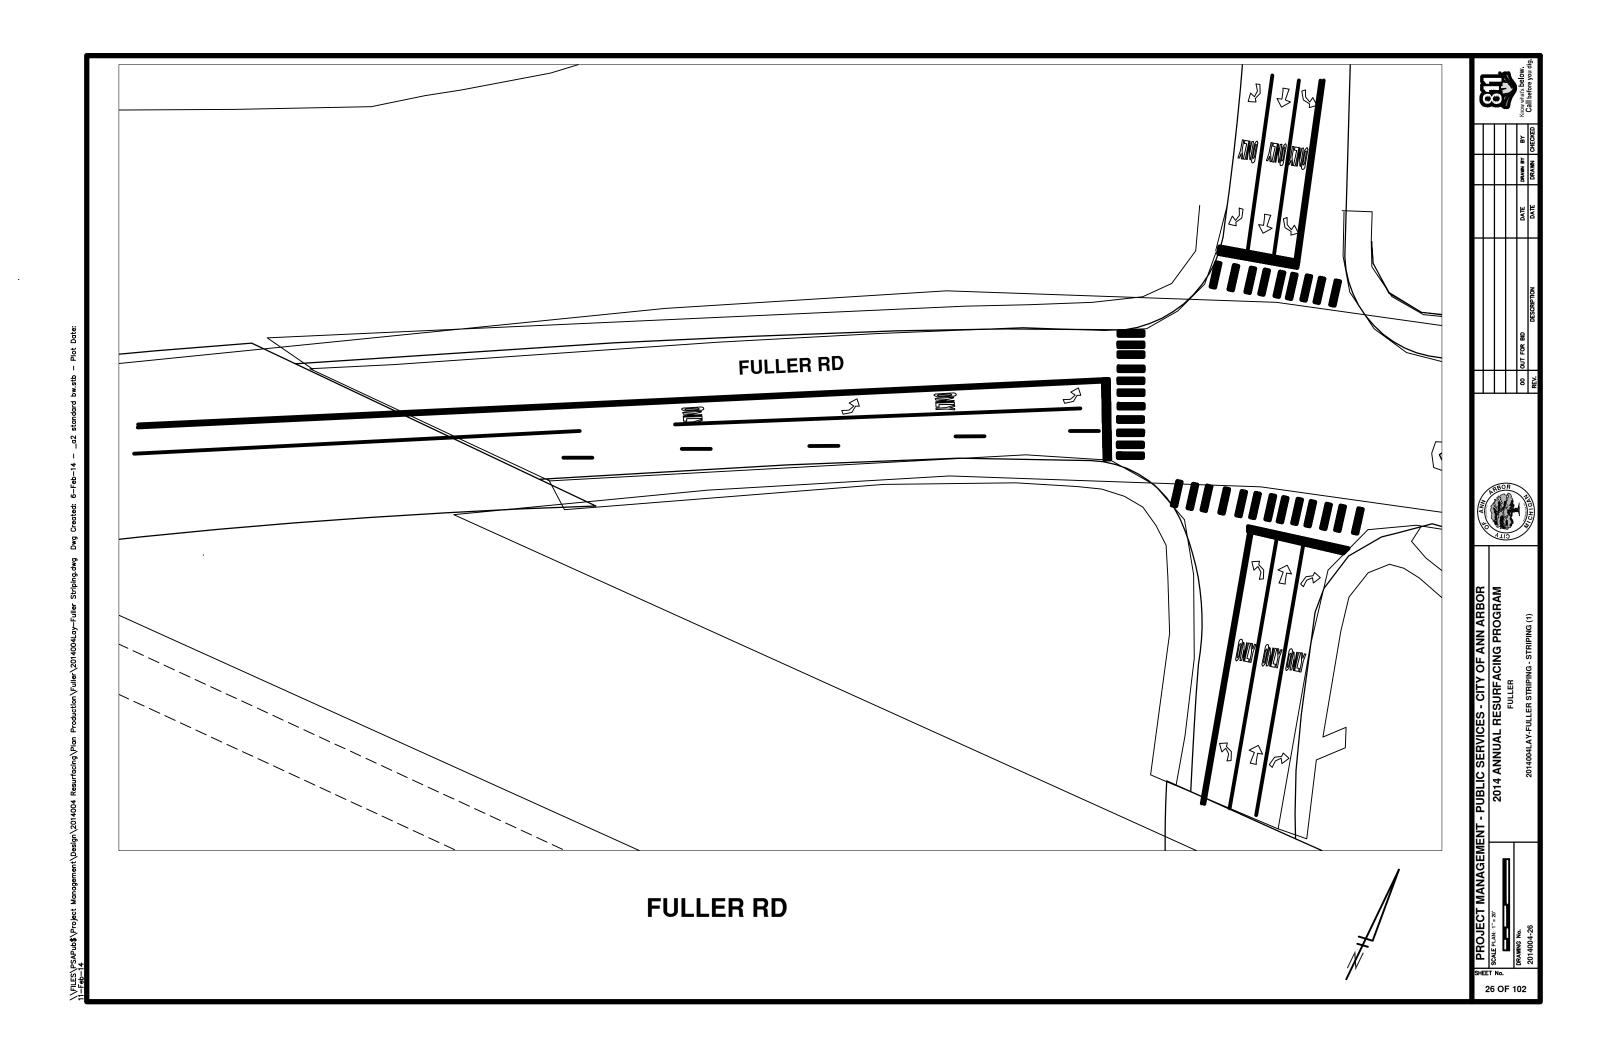


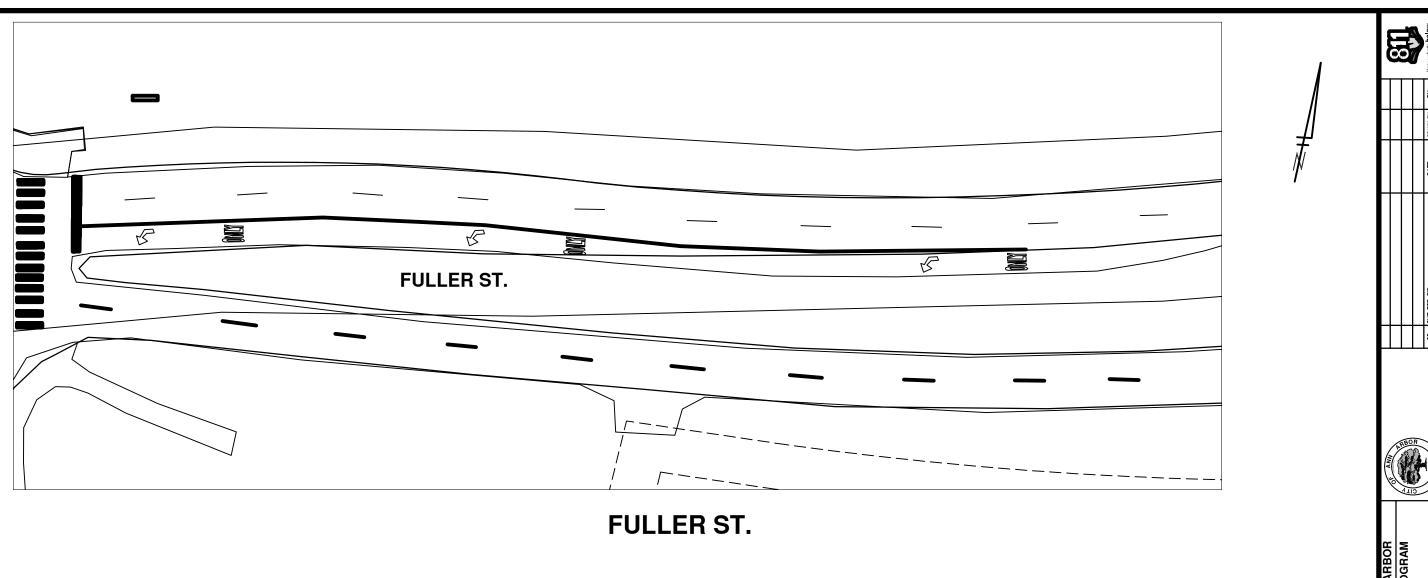

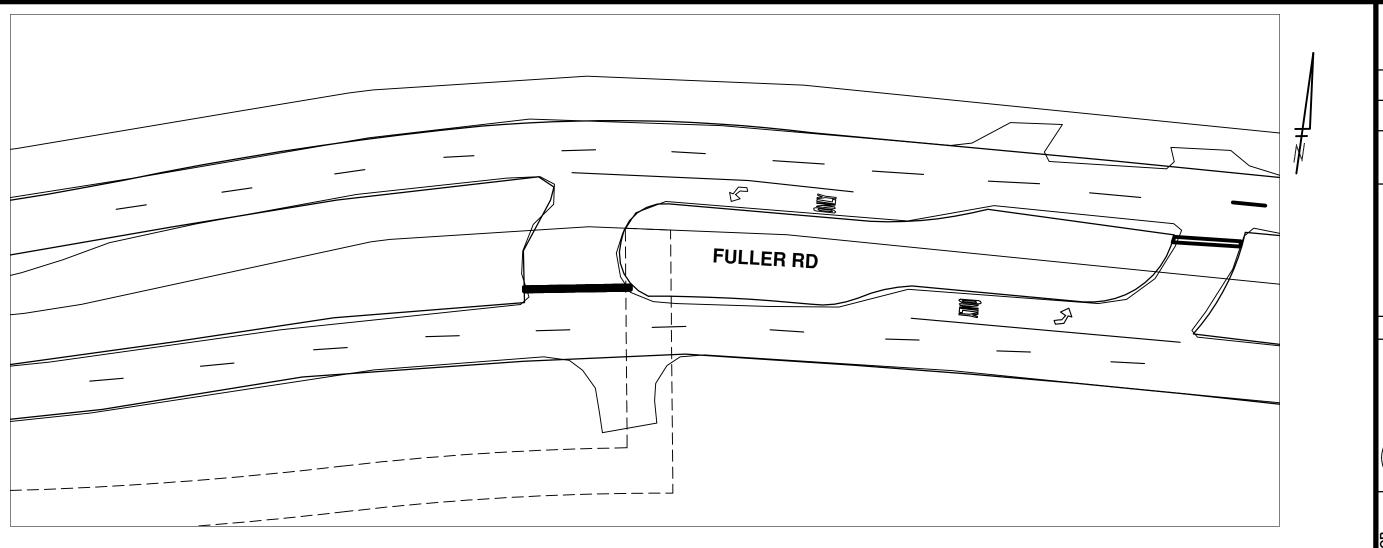

FULLER RD

PUBLIC SERVICES - CITY OF ANN ARBOR
2014 ANNUAL RESURFACING PROGRAM
FULLER

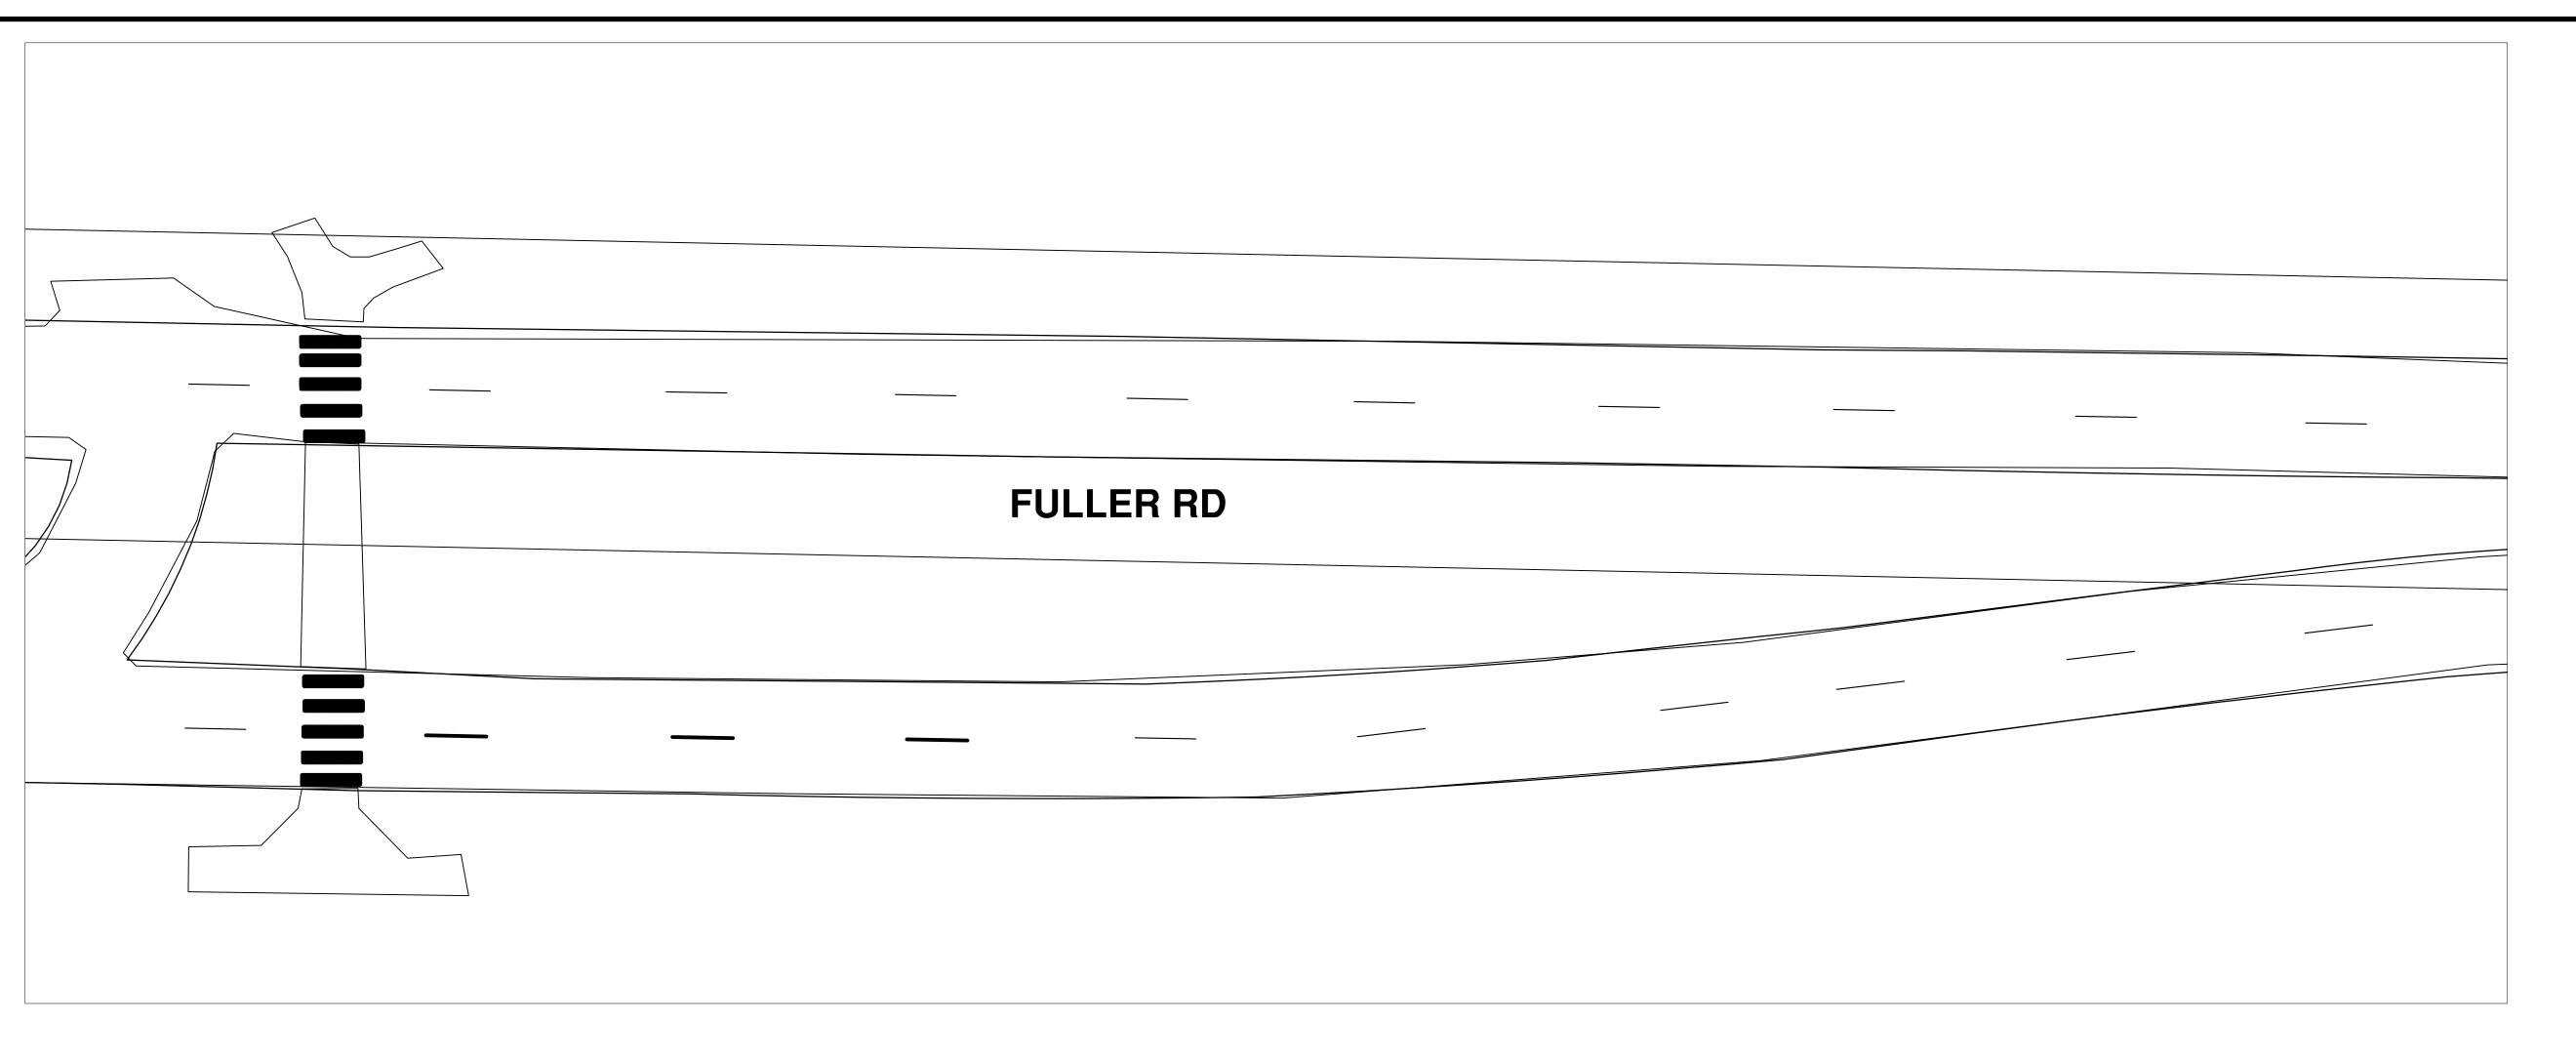

FULLER RD



PROJECT MANAGEMENT - PUBLIC SERVICES - CITY OF ANN ARBOR

SCALE PLAN: 1" = 20'

SCALE PLAN: 1" = 20'

DRAWING No.

2014004-29


PROJECT MANAGEMENT - PUBLIC SERVICES - CITY OF ANN ARBOR


2014 ANN ARBOR

2014 ANN ARBOR

FULLER

2014004-29

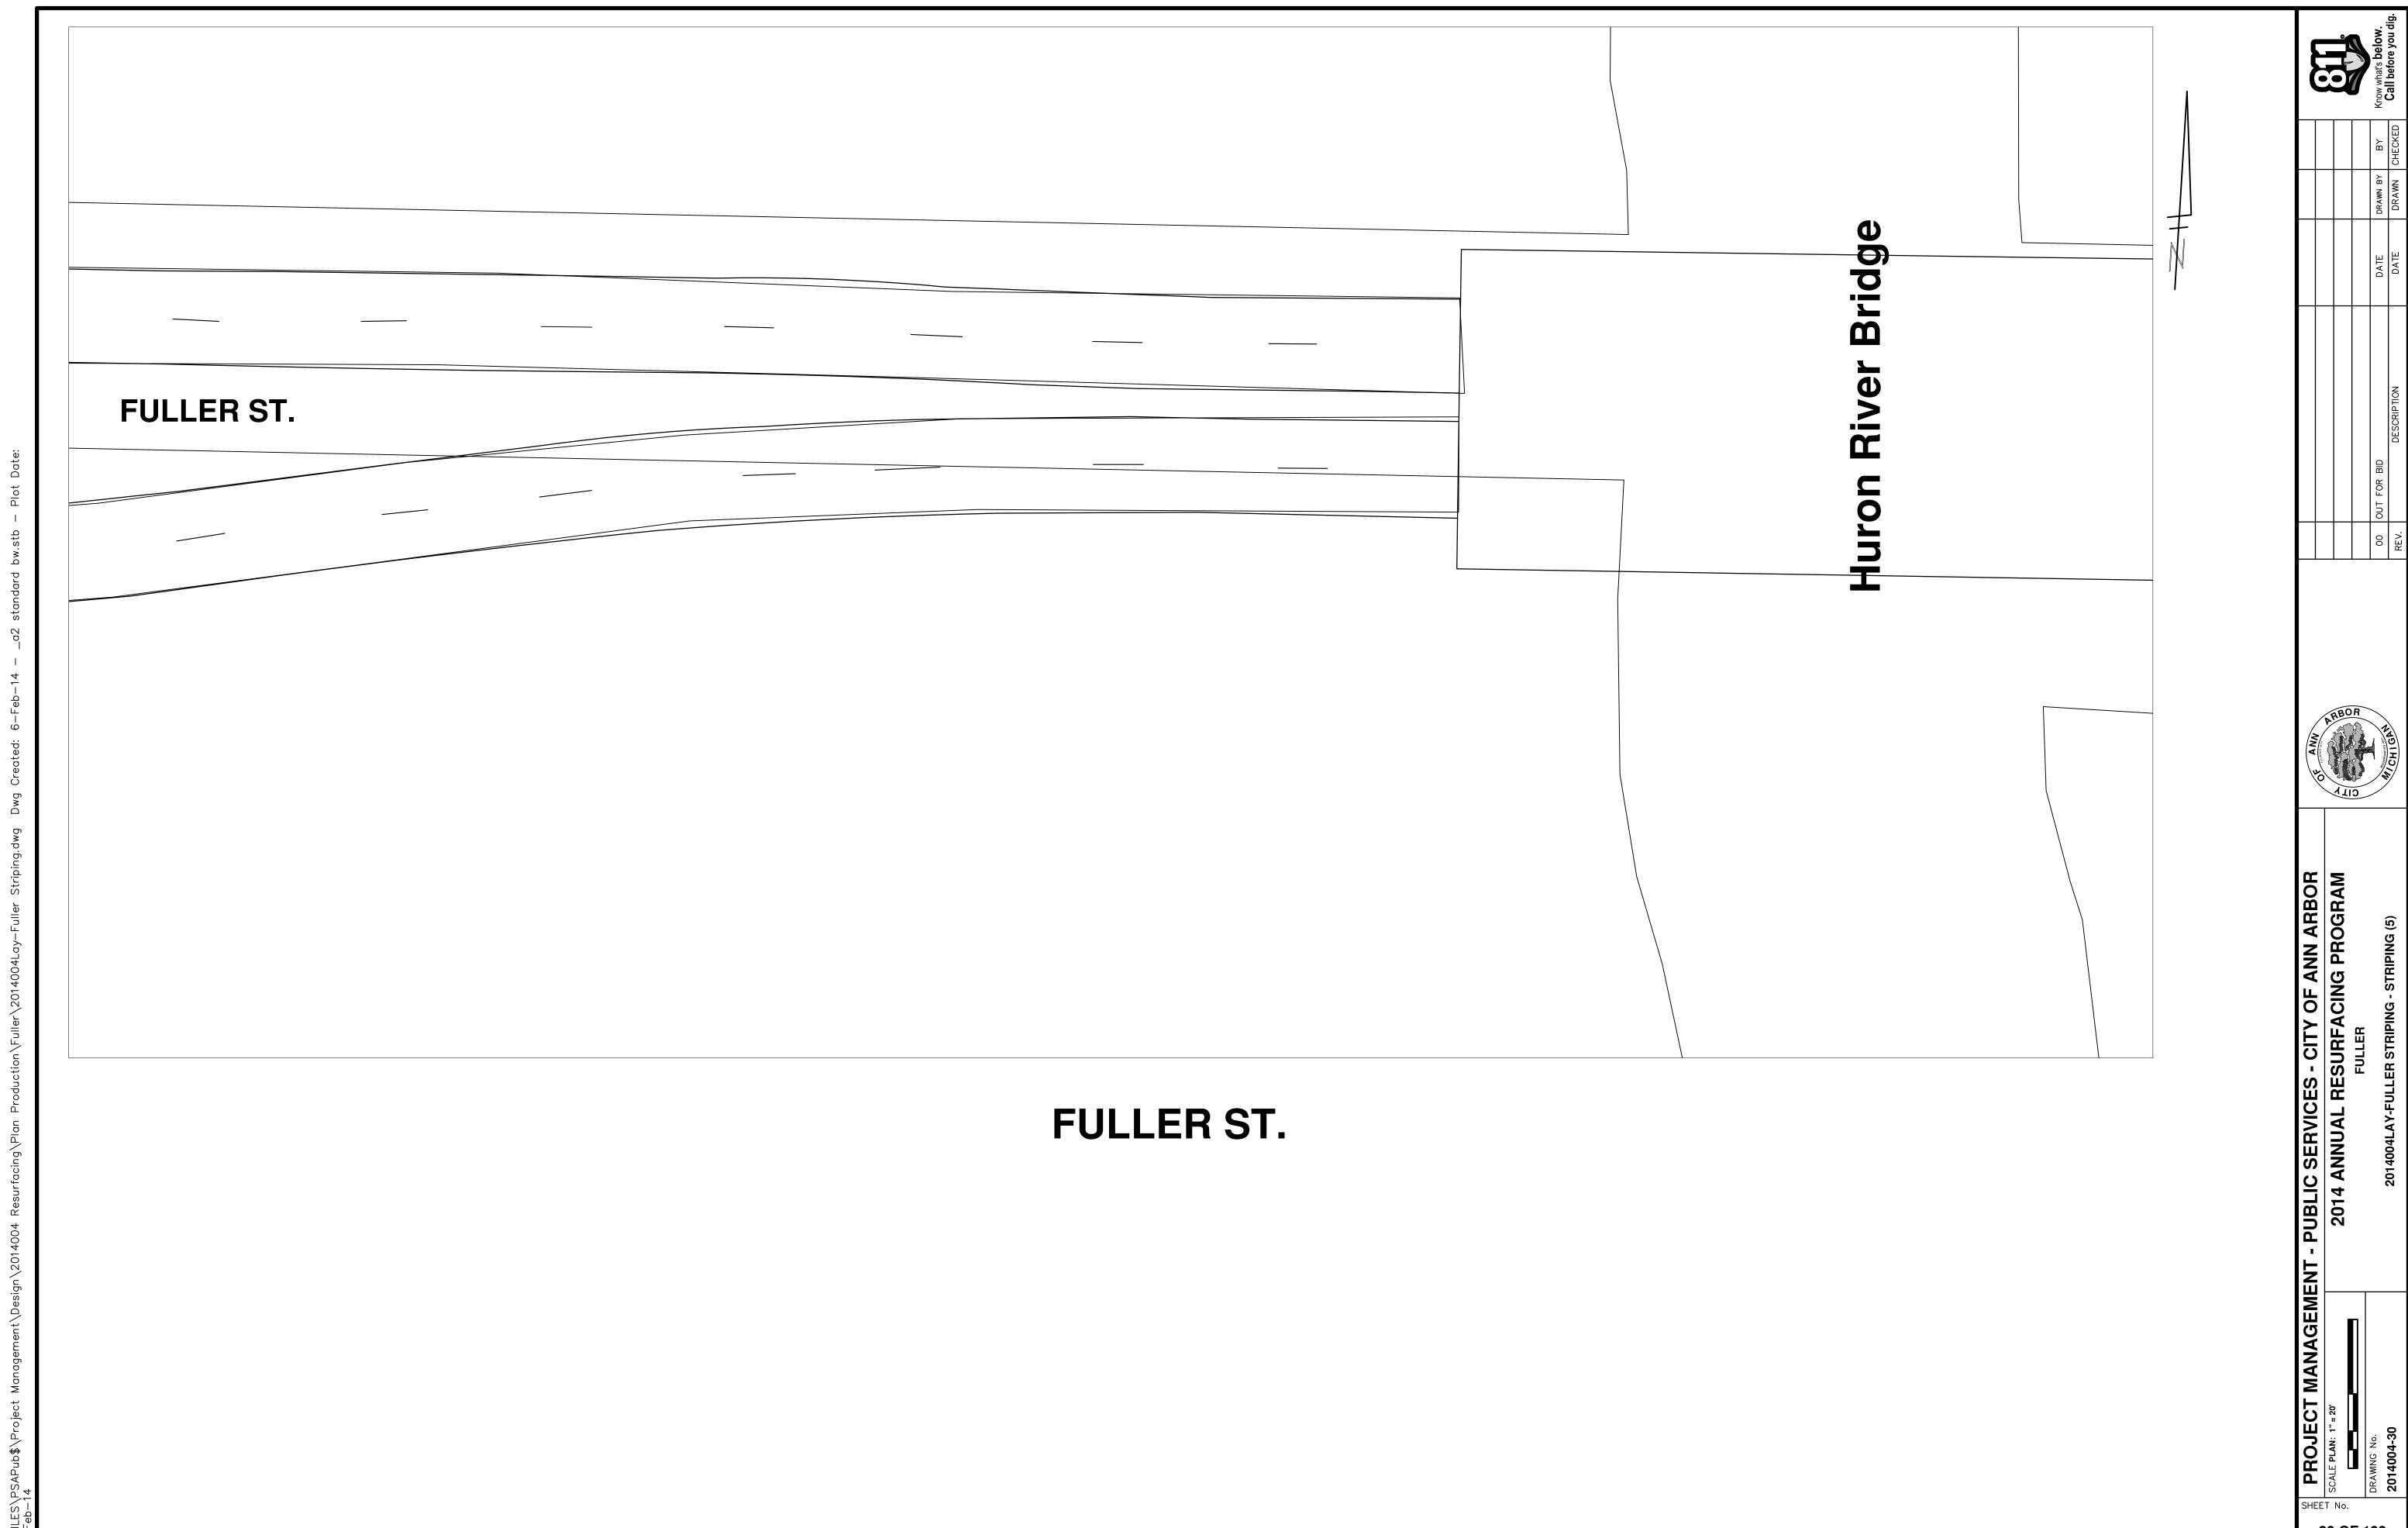


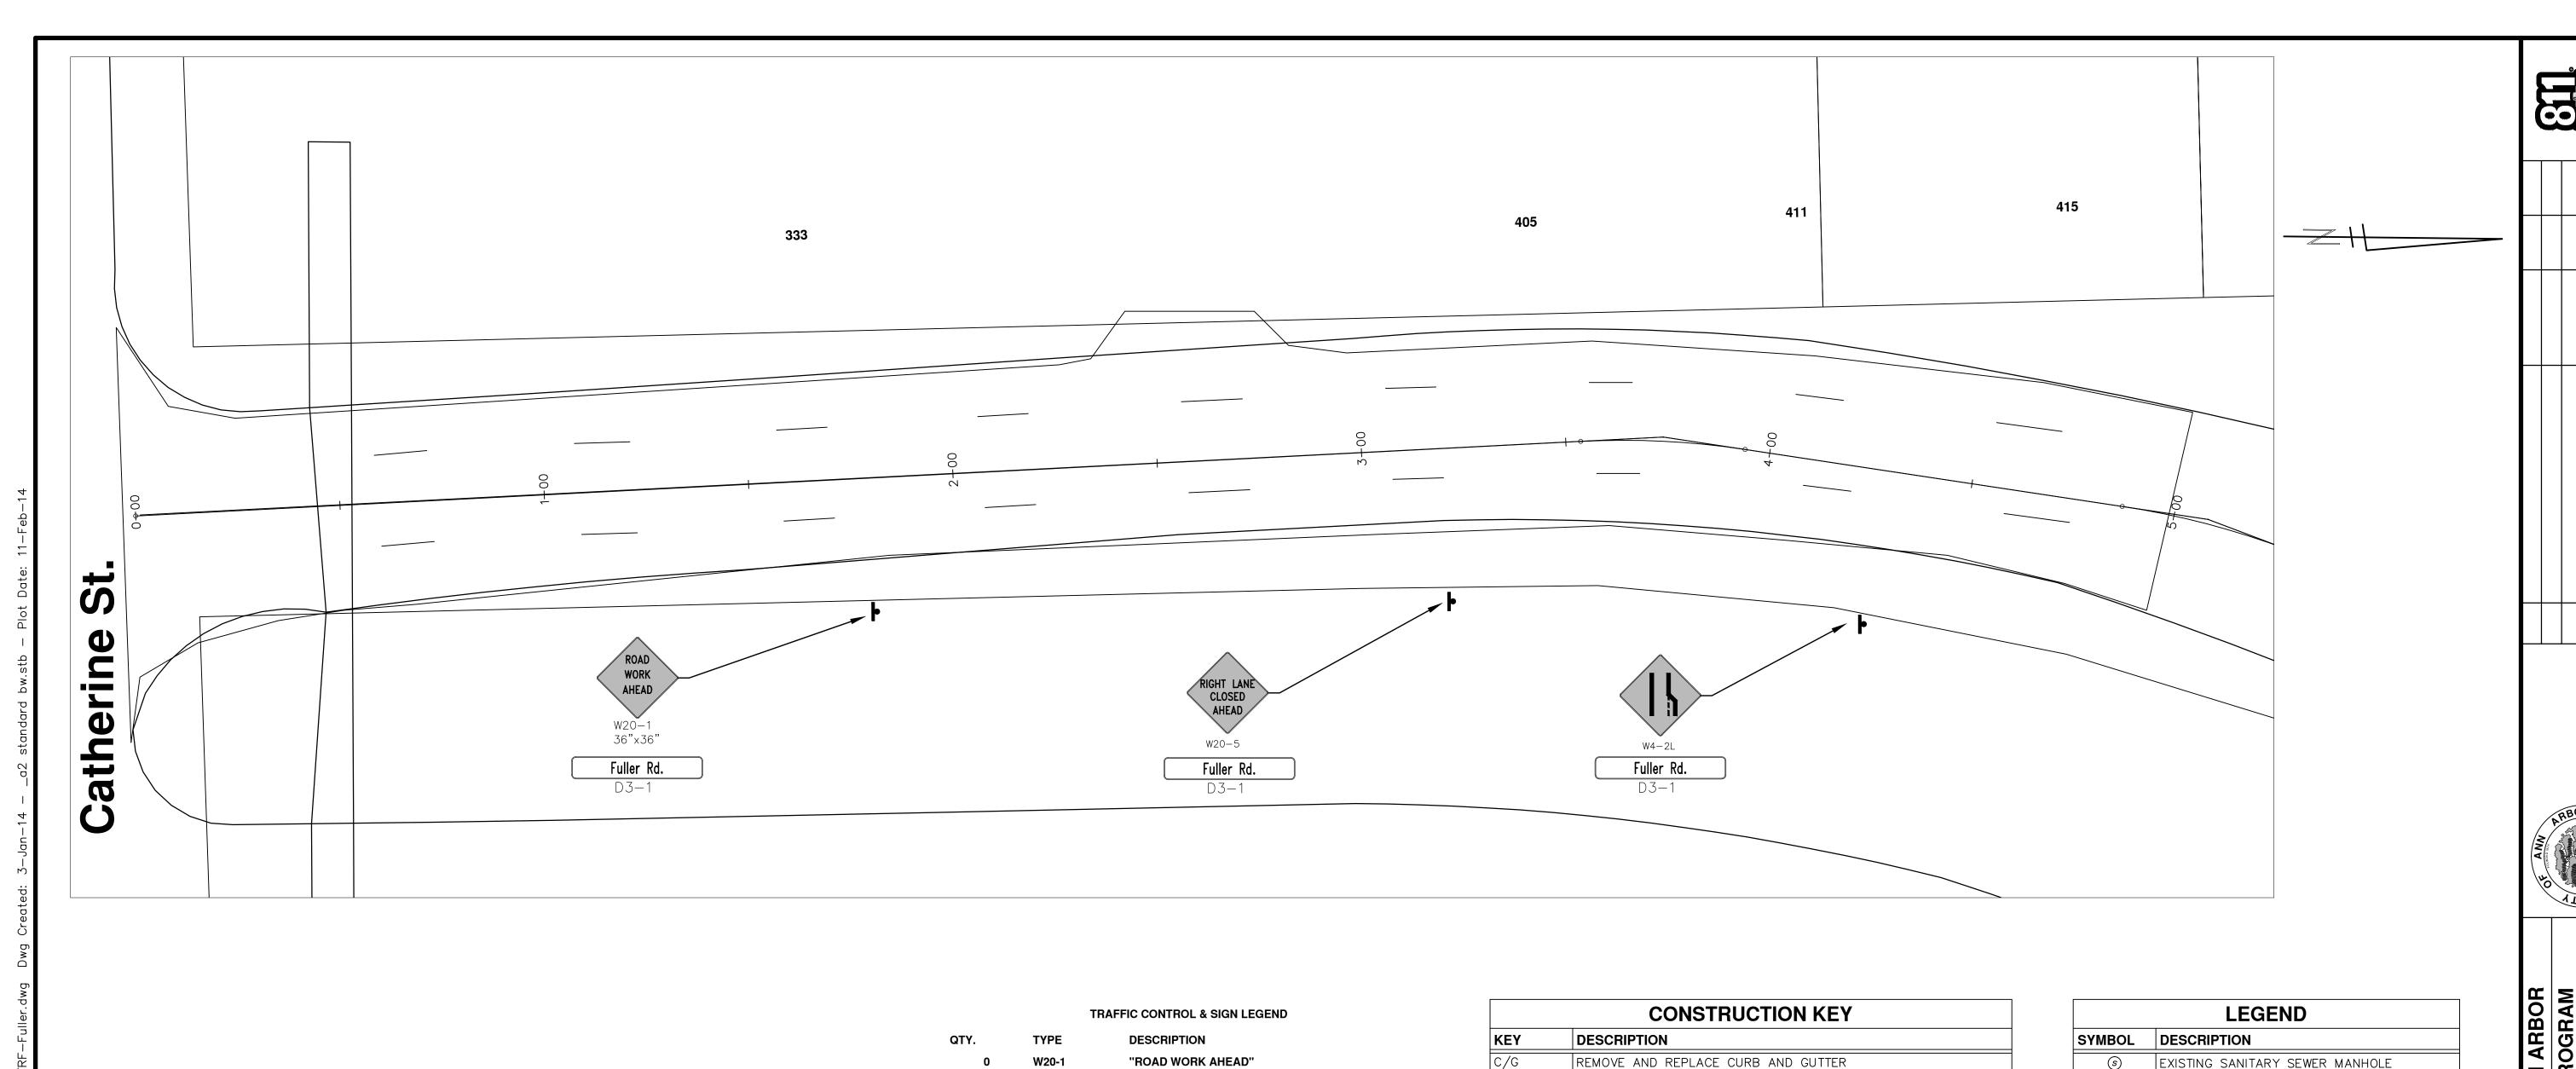


QTY.		TYPE	DESCRIPTION
GII.	0	W20-1	"ROAD WORK AHEAD"
	0		
	0	W20-2	"DETOUR AHEAD"
	0	W20-3	"ROAD CLOSED AHEAD"
	0	W20-5	"(RIGHT OR LEFT) LANE CLOSED AHEAD"
	0	W4-2	LANE DROP SYMBOL, RIGHT OR LEFT
	0	W20-1a	WORK SYMBOL
		W1-4	REVERSE CURVE
		W1-6	ONE DIRECTION ARROW
		M4-9 L&R&S	DETOUR (LEFT, RIGHT, OR STRAIGHT ARROW)
		D3-1	CONVENTIONAL GUIDE
		M4-8a	"DETOUR ENDS"
		M4-10	"DETOUR"
		R6-1 L&R	"ONE WAY" (LEFT OR RIGHT)
		TYPE III	TYPE III LIGHTED BARRICADE
		TYPE II	TYPE II LIGHTED BARRICADE (DRUM)
		R11-2	"ROAD CLOSED"
		R11-4	"ROAD CLOSED TO THRU TRAFFIC"
		TYPE A	LIGHTED ARROW, TYPE A
		TYPE B	LIGHTED ARROW, TYPE B
		R9-9	SIDEWALK CLOSED
		R9-11	SIDEWALK CLOSED AHEAD CROSS HERE
		R5-9	SIDEWALK CLOSED USE OTHER SIDE
		G20-2	"END ROAD WORK"
		R5-18b	"INJURE/KILL A WORKER \$7500+15 YEARS"
		R5-18cLA	"WORK ZONE BEGINS/TRAFFIC FINES DOUBLED"
		R3-1	NO RIGHT TURN
		R3-2	NO LEFT TURN
		SPECIAL	42"X48" SPECIAL SIGN
		W20-5c	"CENTER LANE CLOSED AHEAD"
		R2-1	SPEED LIMIT
		TYPE C	LIGHTED ARROW, TYPE C
		W3-5	REDUCED SPEED LIMIT AHEAD

CONSTRUCTION KEY		
KEY	DESCRIPTION	
C/G	REMOVE AND REPLACE CURB AND GUTTER	
C/GHE	REMOVE CURB AND GUTTER, REPLACE WITH CONCRETE CURB AND GUTTER H.E.	
C4HE	REMOVE EXISTING RAMP OR SIDEWALK. REPLACE WITH 4" SIDEWALK OR TYPE 1 SIDEWALK RAMP, H.E.	
CR	REMOVE SIDEWALK, DRIVE OR RAMP.	
AA	ADJUST MDOT TYPE A CASTINGS.	
AB	ADJUST GATE VALVE BOX OR MONUMENT BOX.	
ADST ADDITIONAL DEPTH STRUCTURE REPAIR.		
REMOVE AND REPLACE MDOT TYPE A CASTING ADJUST TO FINI GRADE.		
CPRHE CONCRETE PAVEMENT REPAIR, H.E.		
DS	CONSTRUCT 2, 3 OR 4' DIAM. DRAINAGE STRUCTURE.	
PT POINT STRUCTURE.		
C4 REMOVE EXISTING RAMP OR SIDEWALK, REPLACE WITH 4" SIDEWALK, WITH		
C6 REMOVE EXISTING RAMP OR SIDEWALK, REPLACE WITH 6" S		
C8 PLACE 8" SIDEWALK OR RAMP ONLY		
C HE REMOVE EXISTING DRIVE APPROACH, RAMP OR SIDEWALK. REWITH 6" OR 8" APPROACH, RAMP, OR SIDEWALK, H.E.		
CP	PLACE 4" SIDEWALK OR RAMP.	
AK	ADJUST MDOT TYPE K CASTING.	
TYPE II	MDOT TYPE II BARRICADE.	
TYPE III	MDOT TYPE III BARRICADE.	
RRK	REMOVE AND REPLACE MDOT TYPE K CASTING. ADJUST TO FINISH GRADE.	
RS	RECONSTRUCT STRUCTURE.	
RCP	REMOVE CONC. PAVEMENT - ANY THICKNESS	
RCW	RAISED CROSSWALK	

LEGEND		
SYMBOL	DESCRIPTION	
S	EXISTING SANITARY SEWER MANHOLE	
	EXISTING STORM SEWER MANHOLE	
	EXISTING WATER MAIN VALVE IN WELL	
+	WATER MAIN GATE VALVE IN BOX	
	FIRE HYDRANT	
	MICHCON GAS CO. VALVE BOX/WELL	
	AMERITECH TELEPHONE VAULT	
	ELECTRIC MANHOLE	
	SOIL BORING	
	EXISTING STORM SEWER INLET	
	MONUMENT BOX	
	REMOVE AND REPLACE CONC. SIDEWALK	
A	PLACE CONCRETE SIDEWALK	
	REMOVE & REPLACE CONC. CURB & GUTTER	
	CONSTRUCTION LIMITS	
	6" WRAPPED UNDERDRAIN	
	REMOVE CONCRETE SIDEWALK	
	SUBGRADE UNDERCUT	

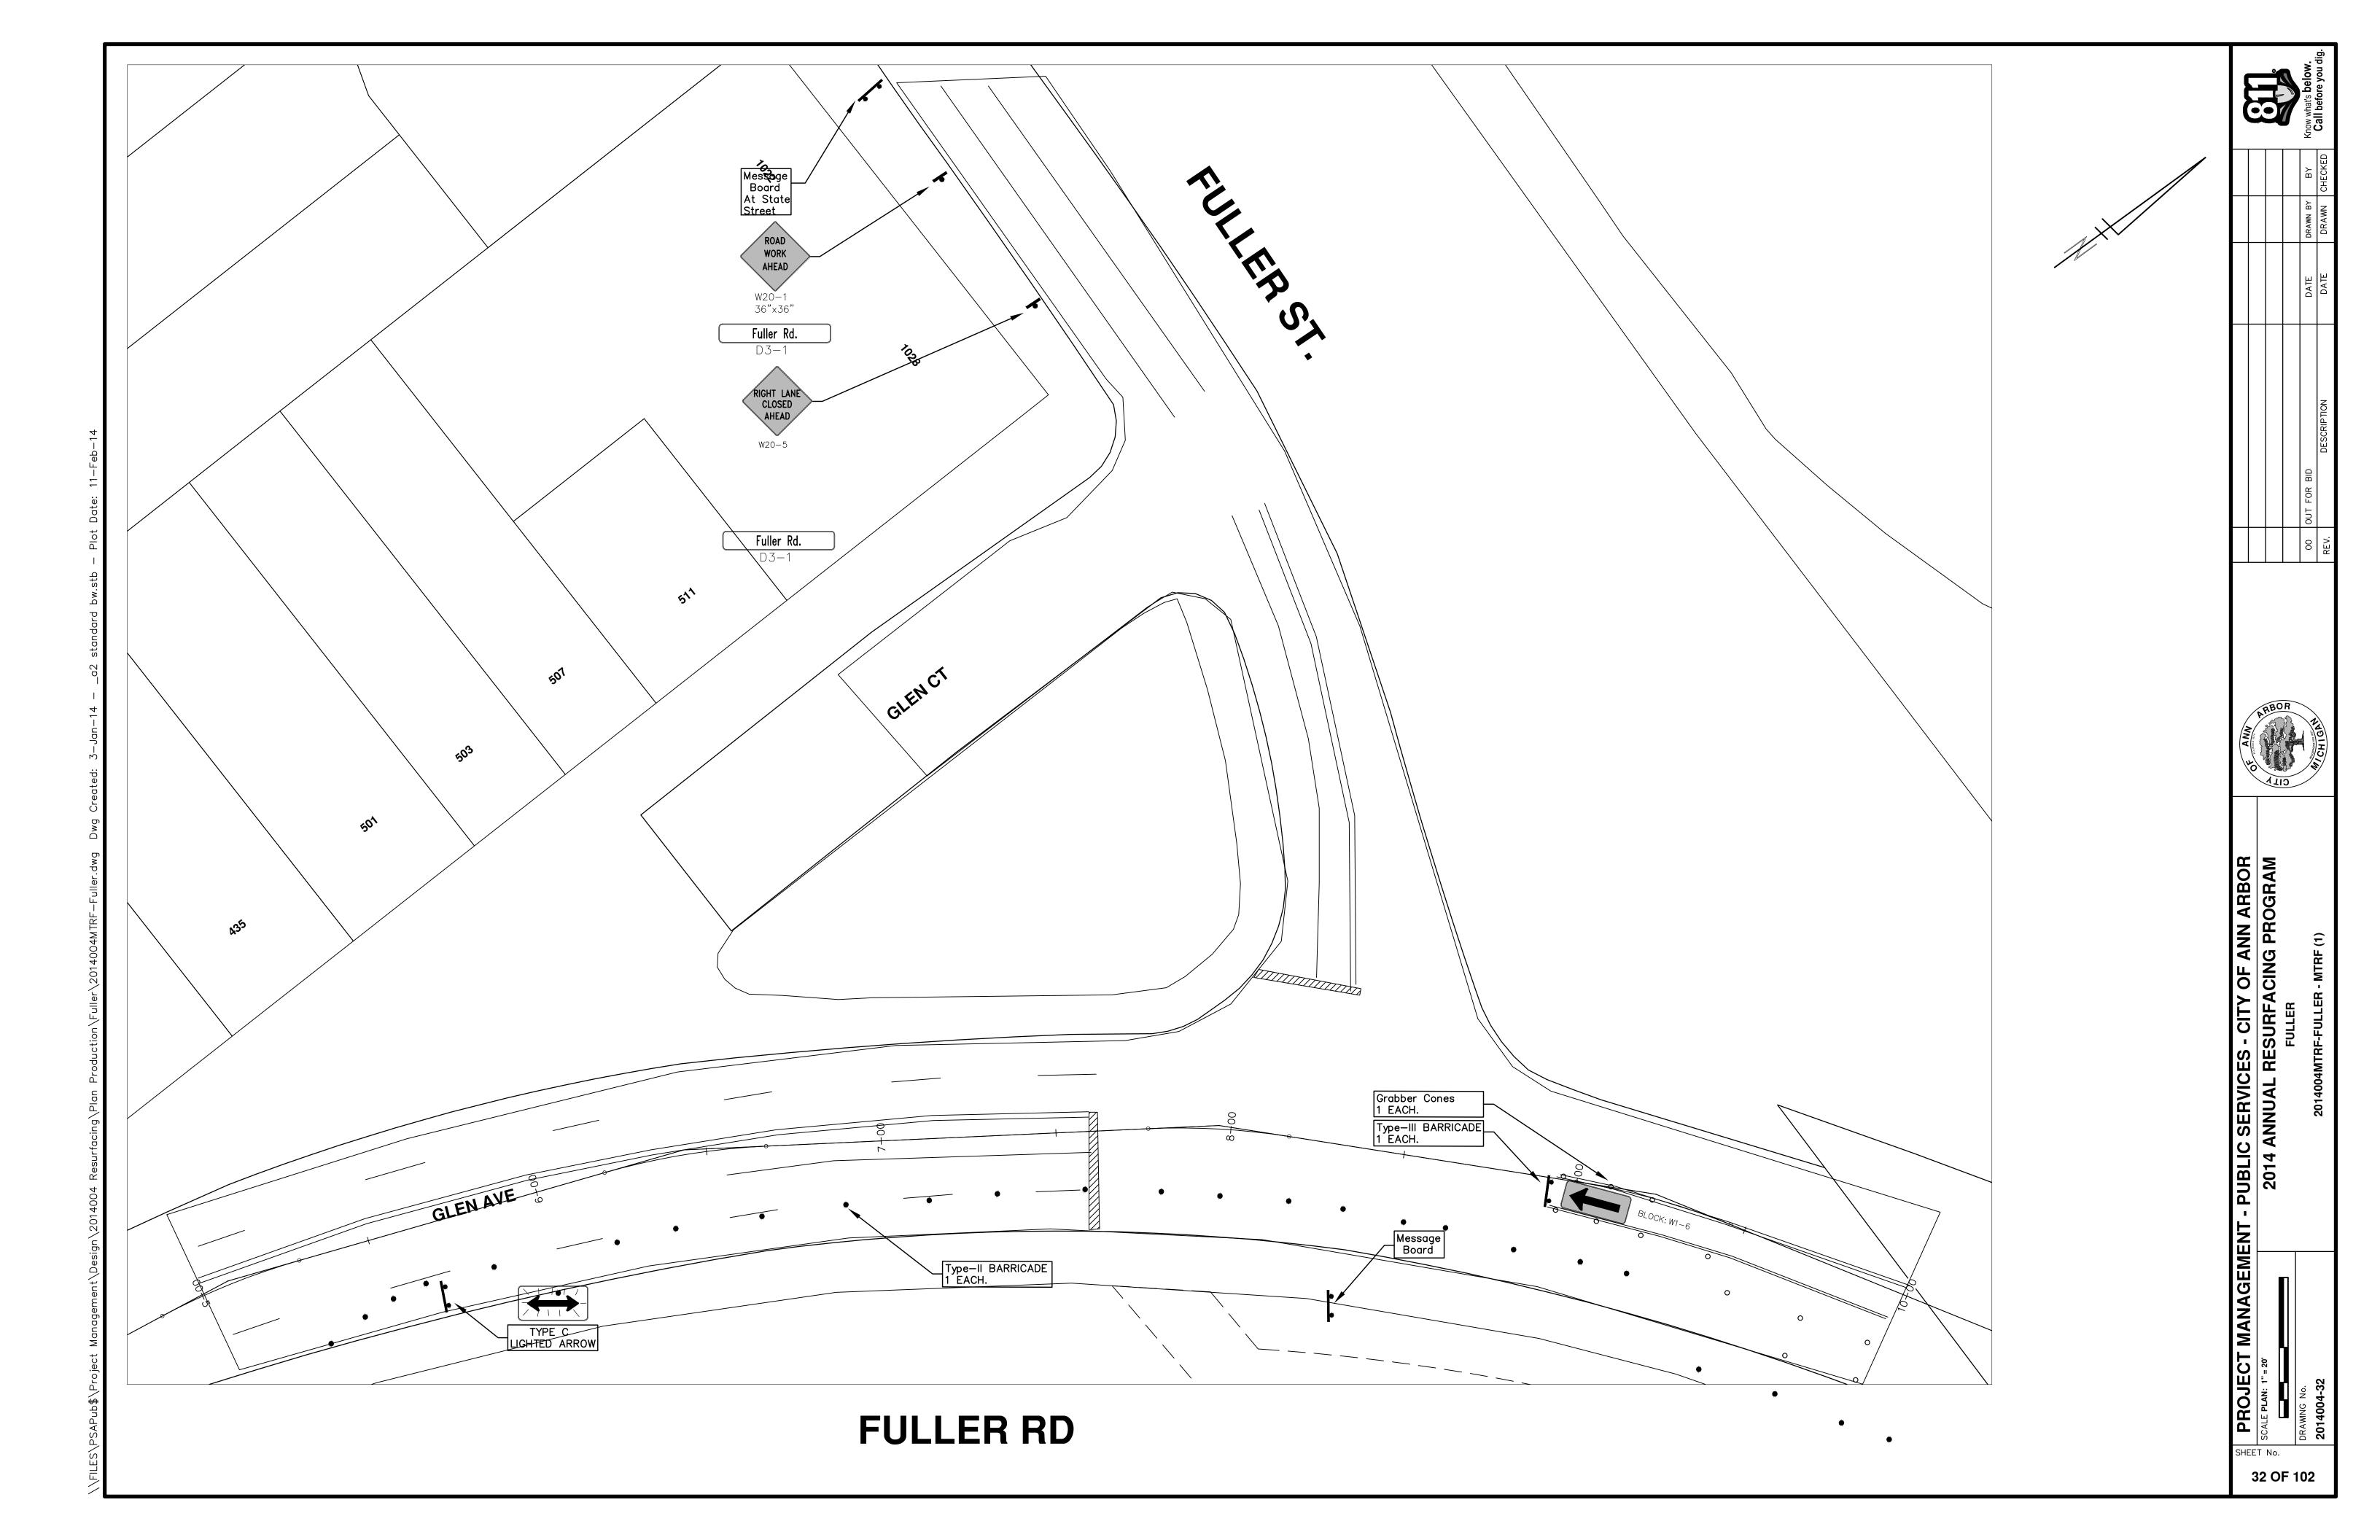

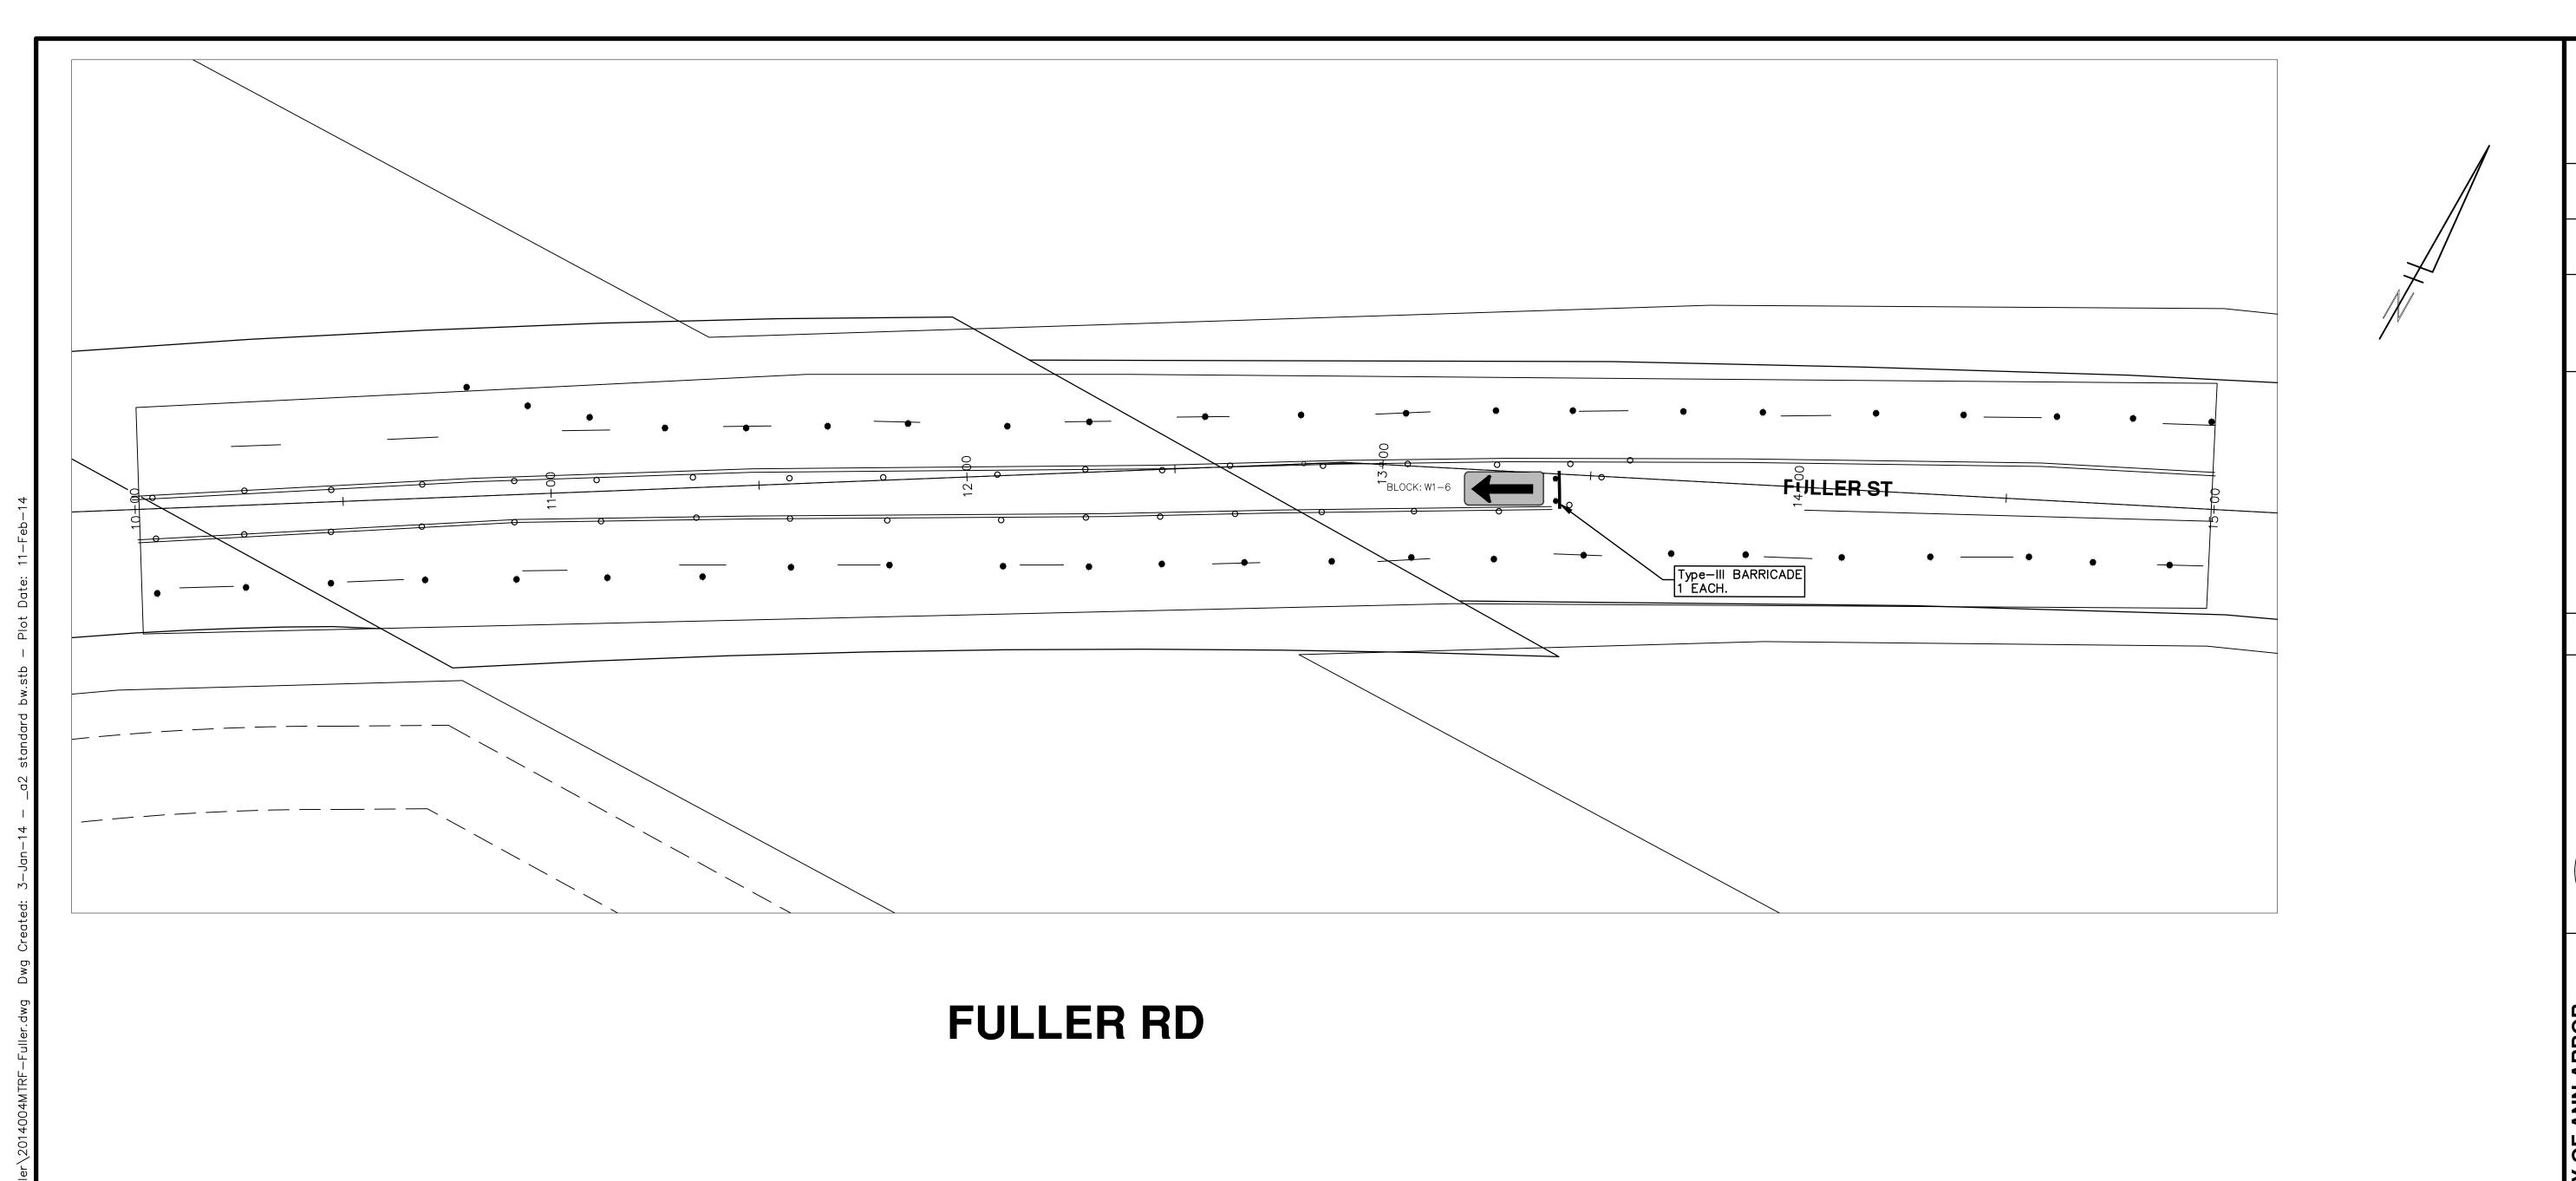

PROJECT MANAGEMENT - PUBLIC SERVICES - CITY OF ANN ARBOR

SCALE PLAN: 1" = 20

BRAWING No.


2014004-33


PROJECT MANAGEMENT - PUBLIC SERVICES - CITY OF ANN ARBOR


2014 ANNUAL RESURFACING PROGRAM


FULLER


2014004-33

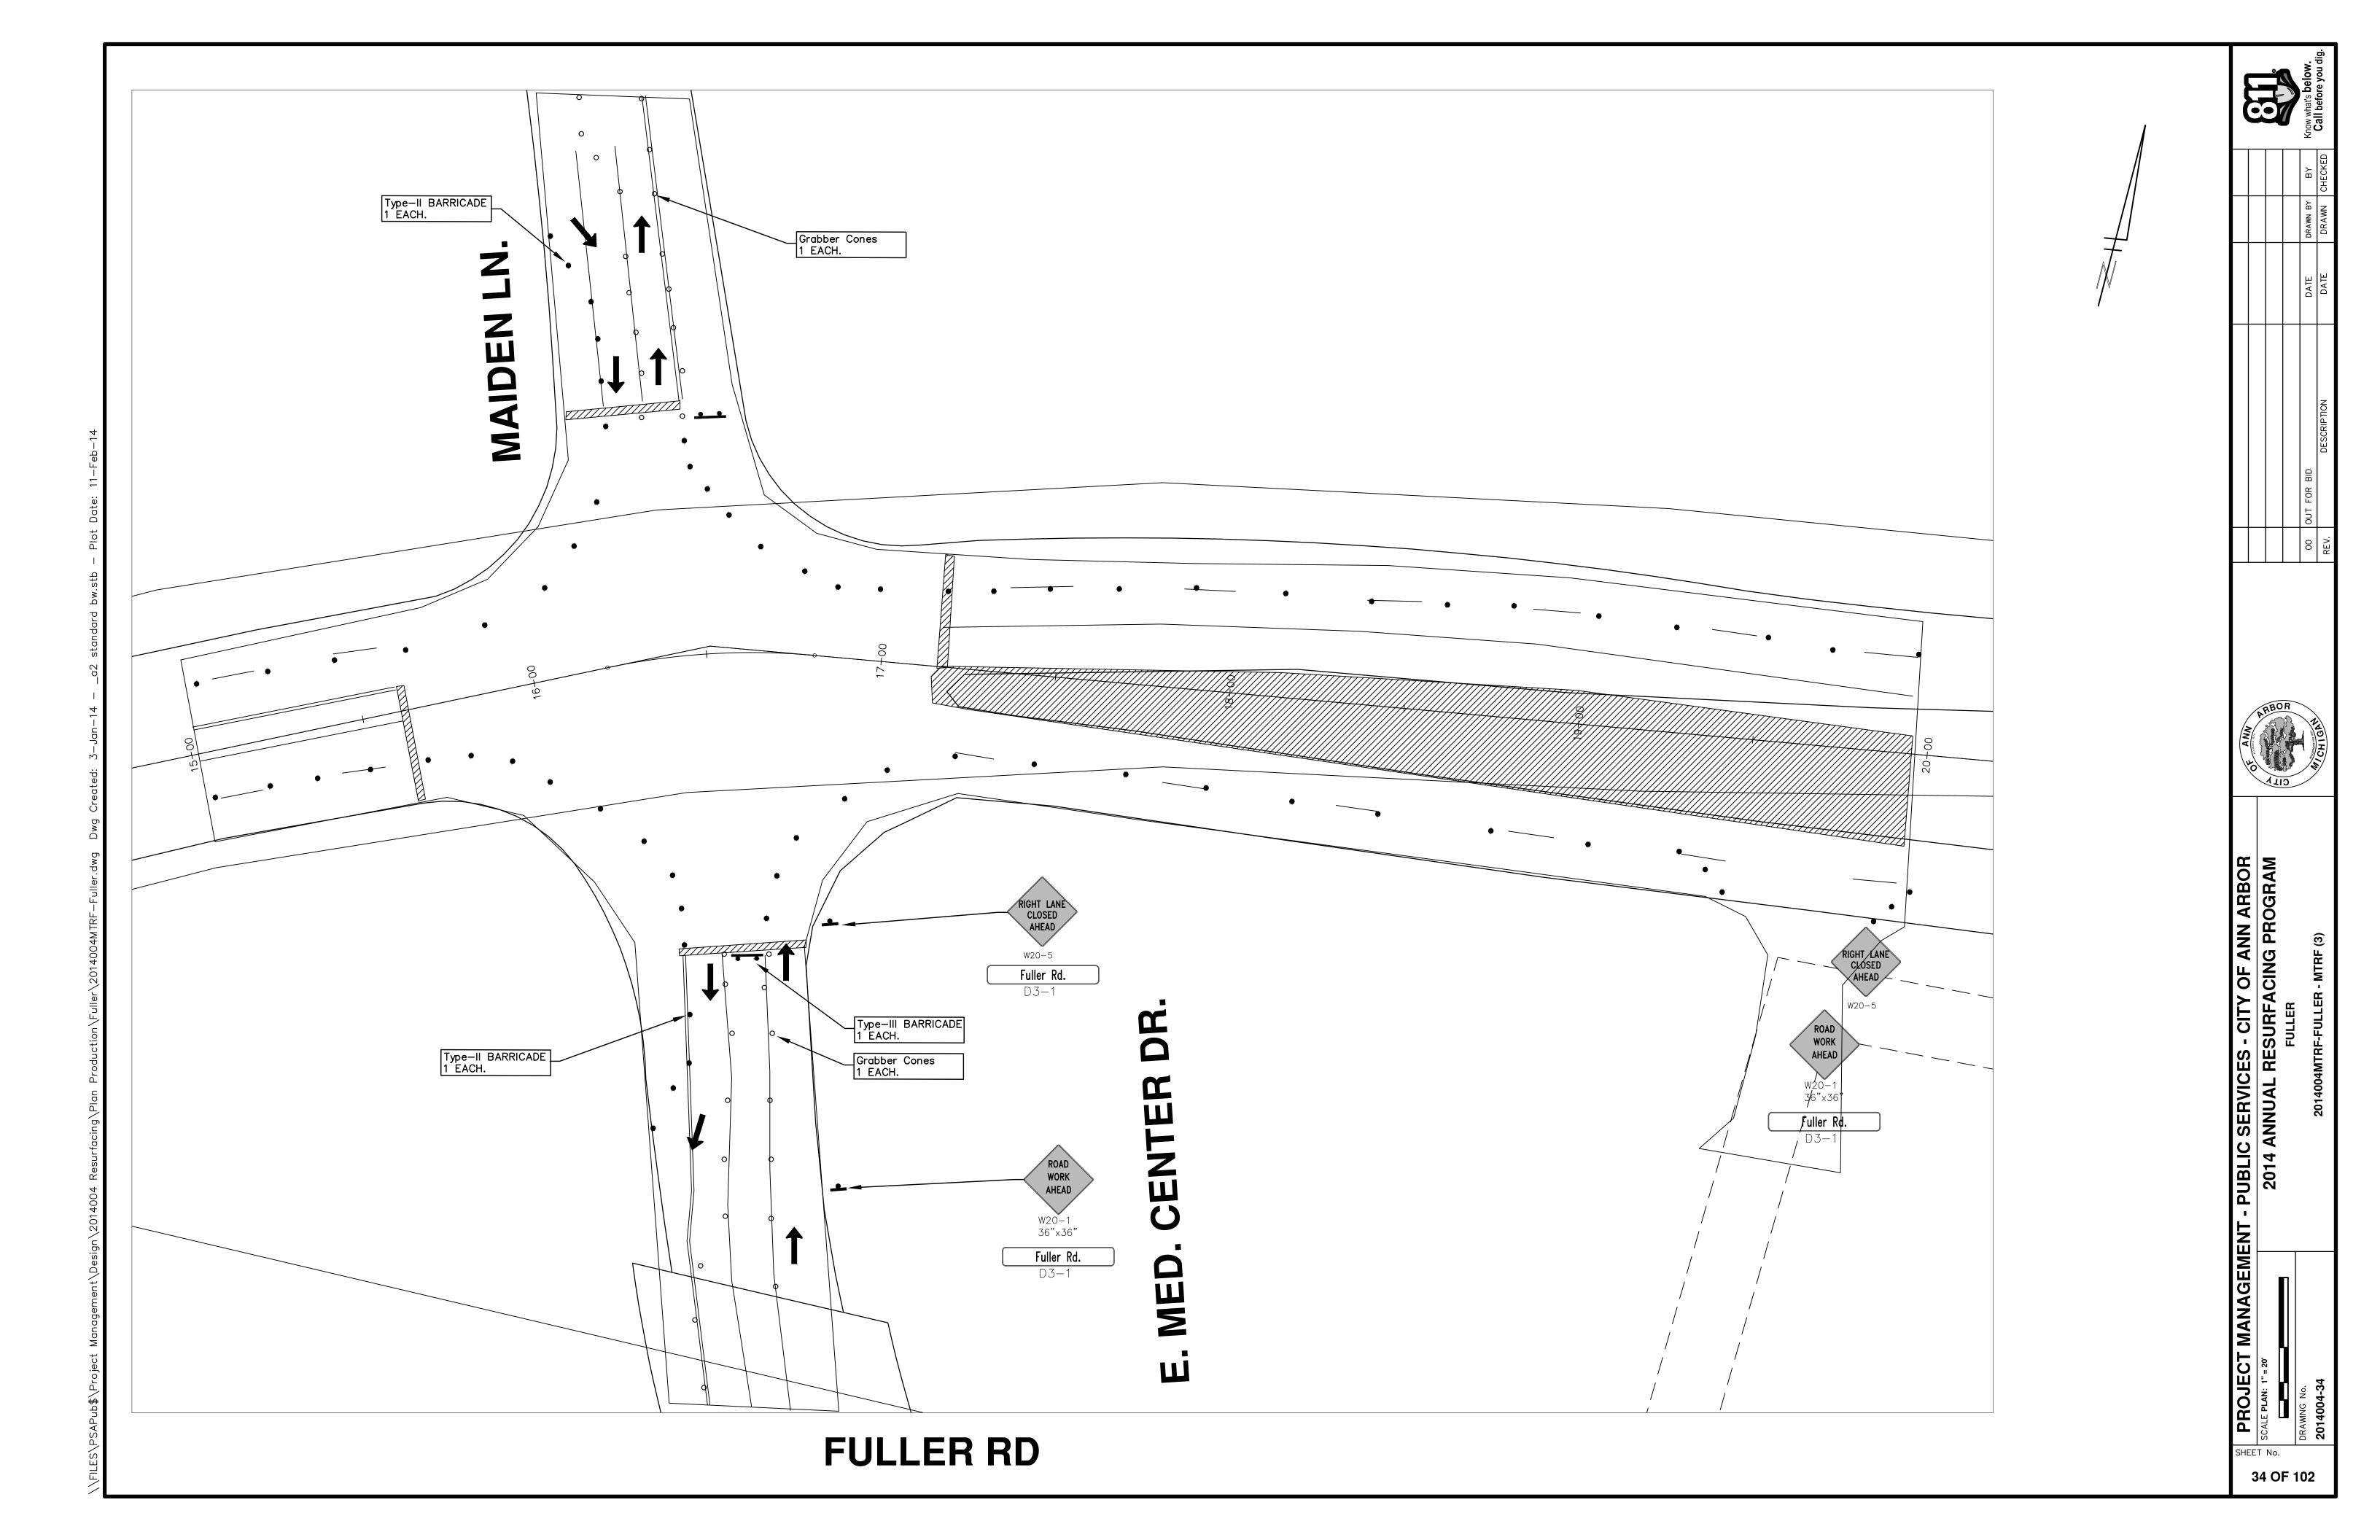

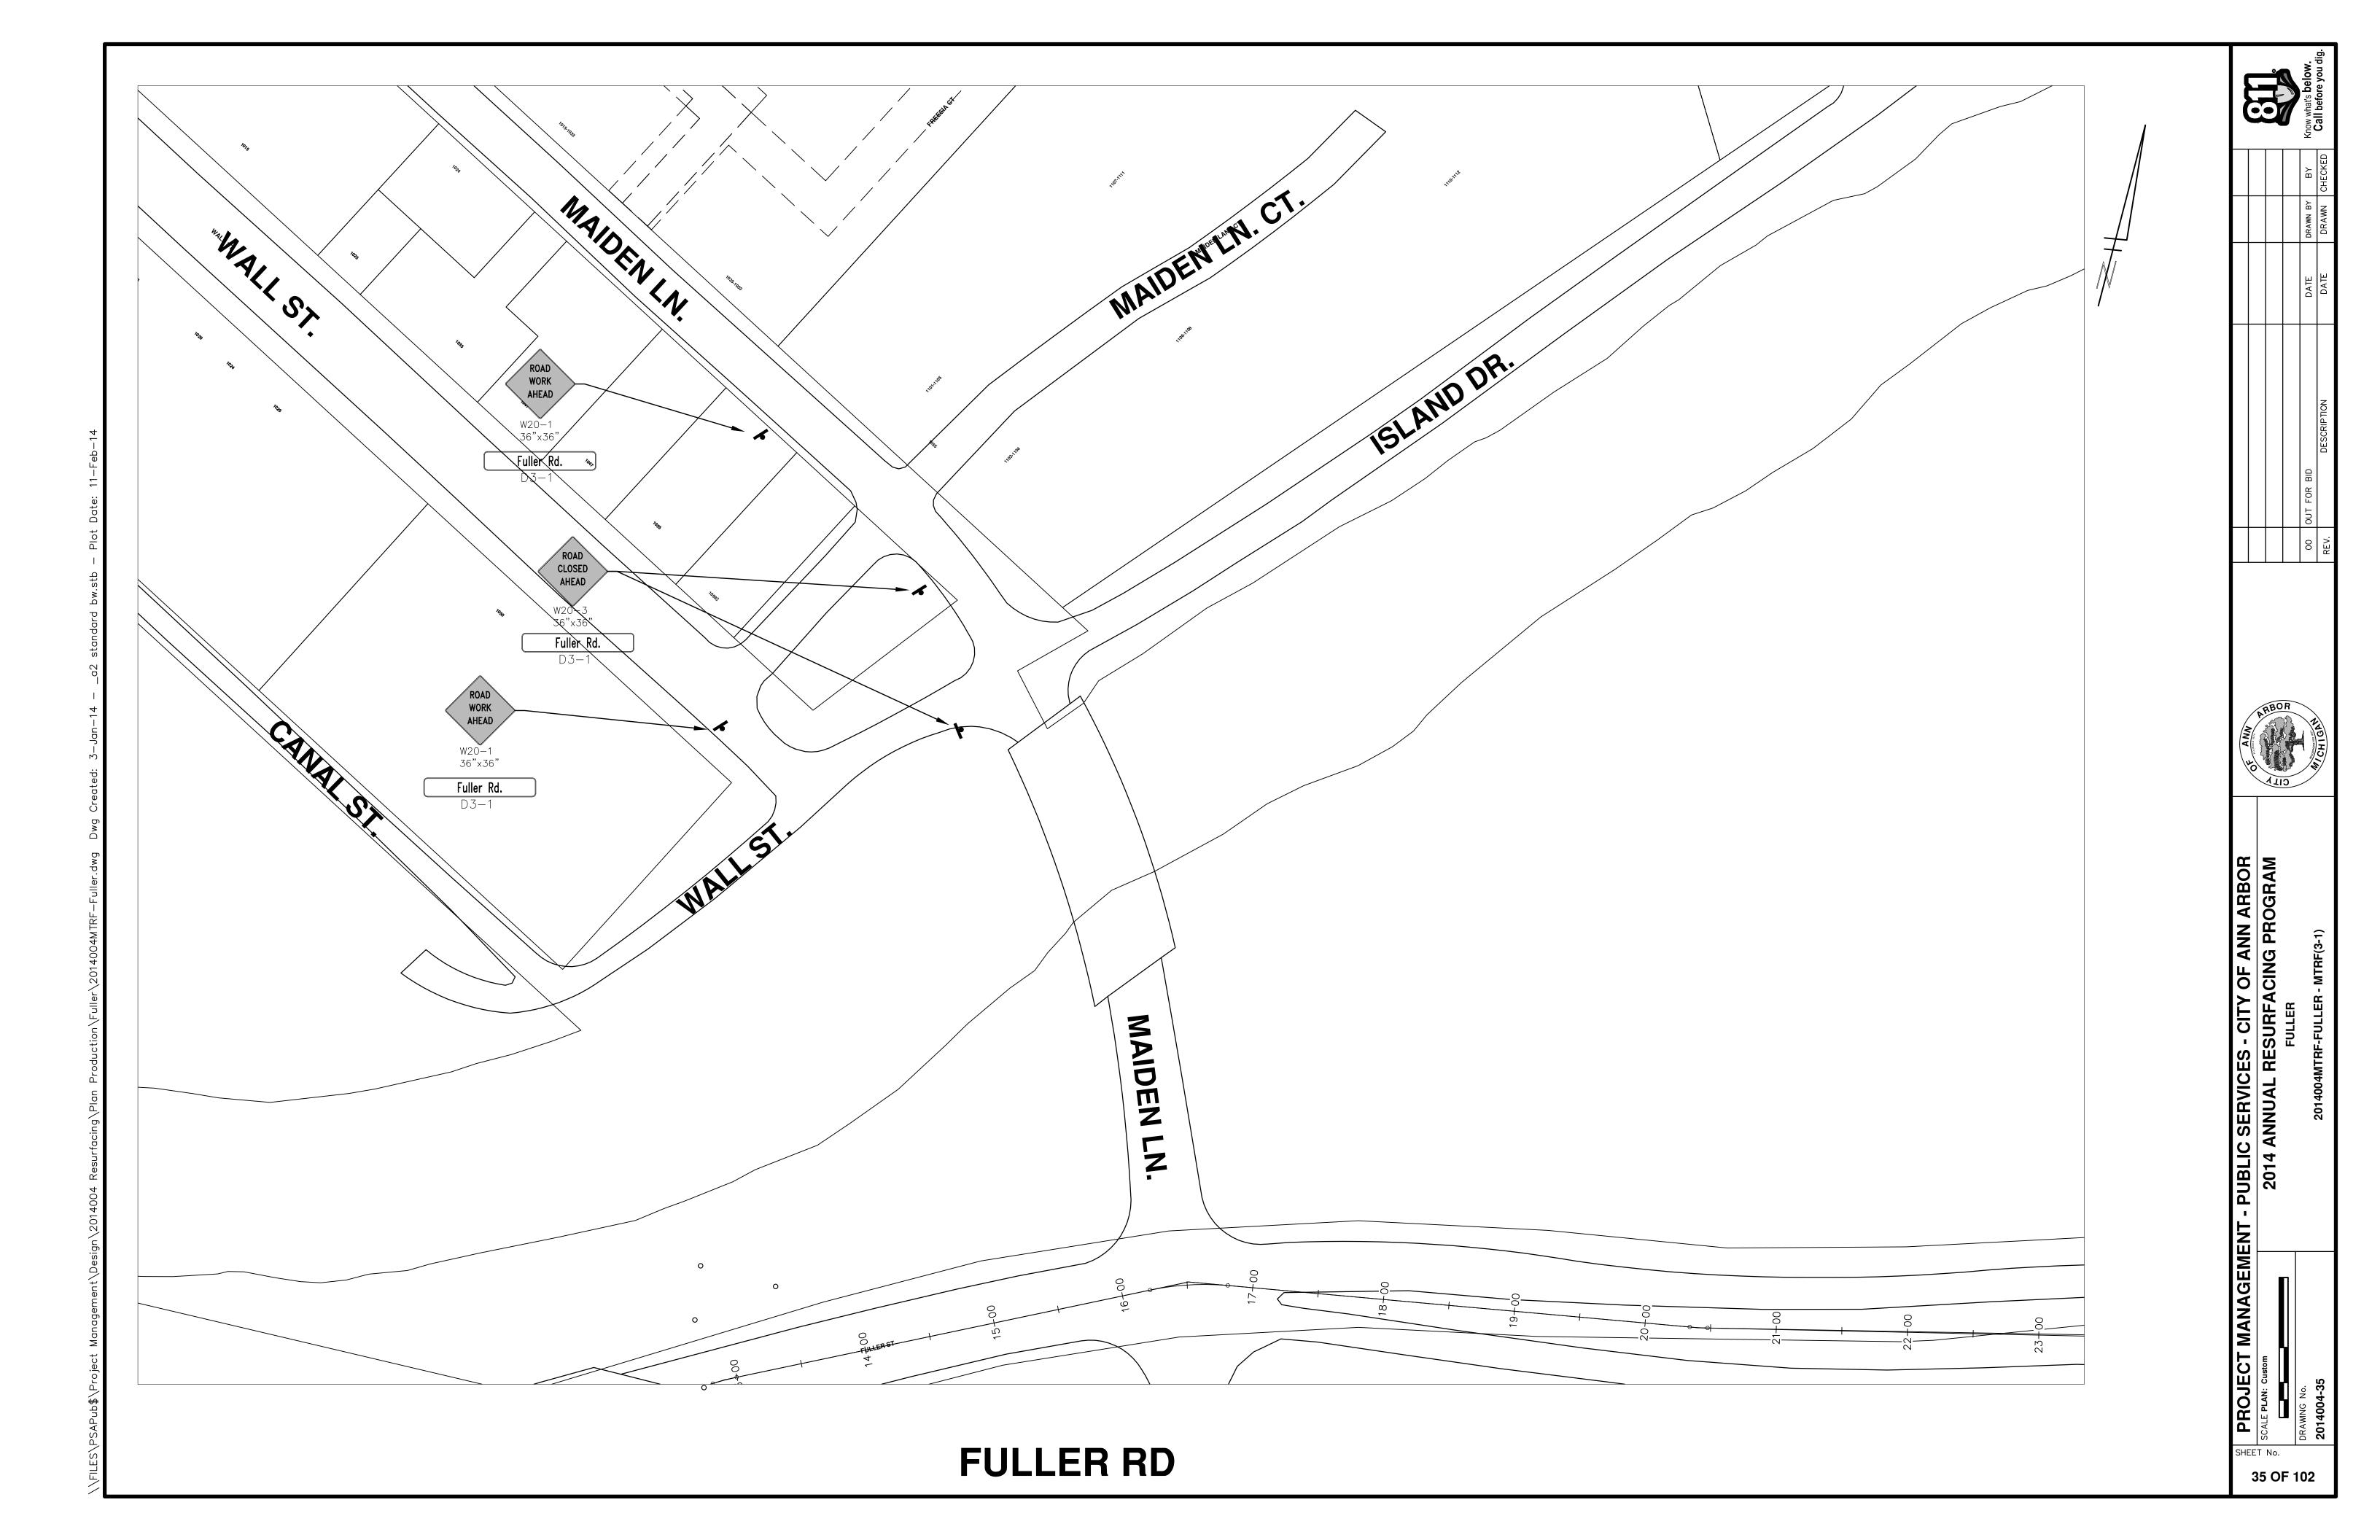

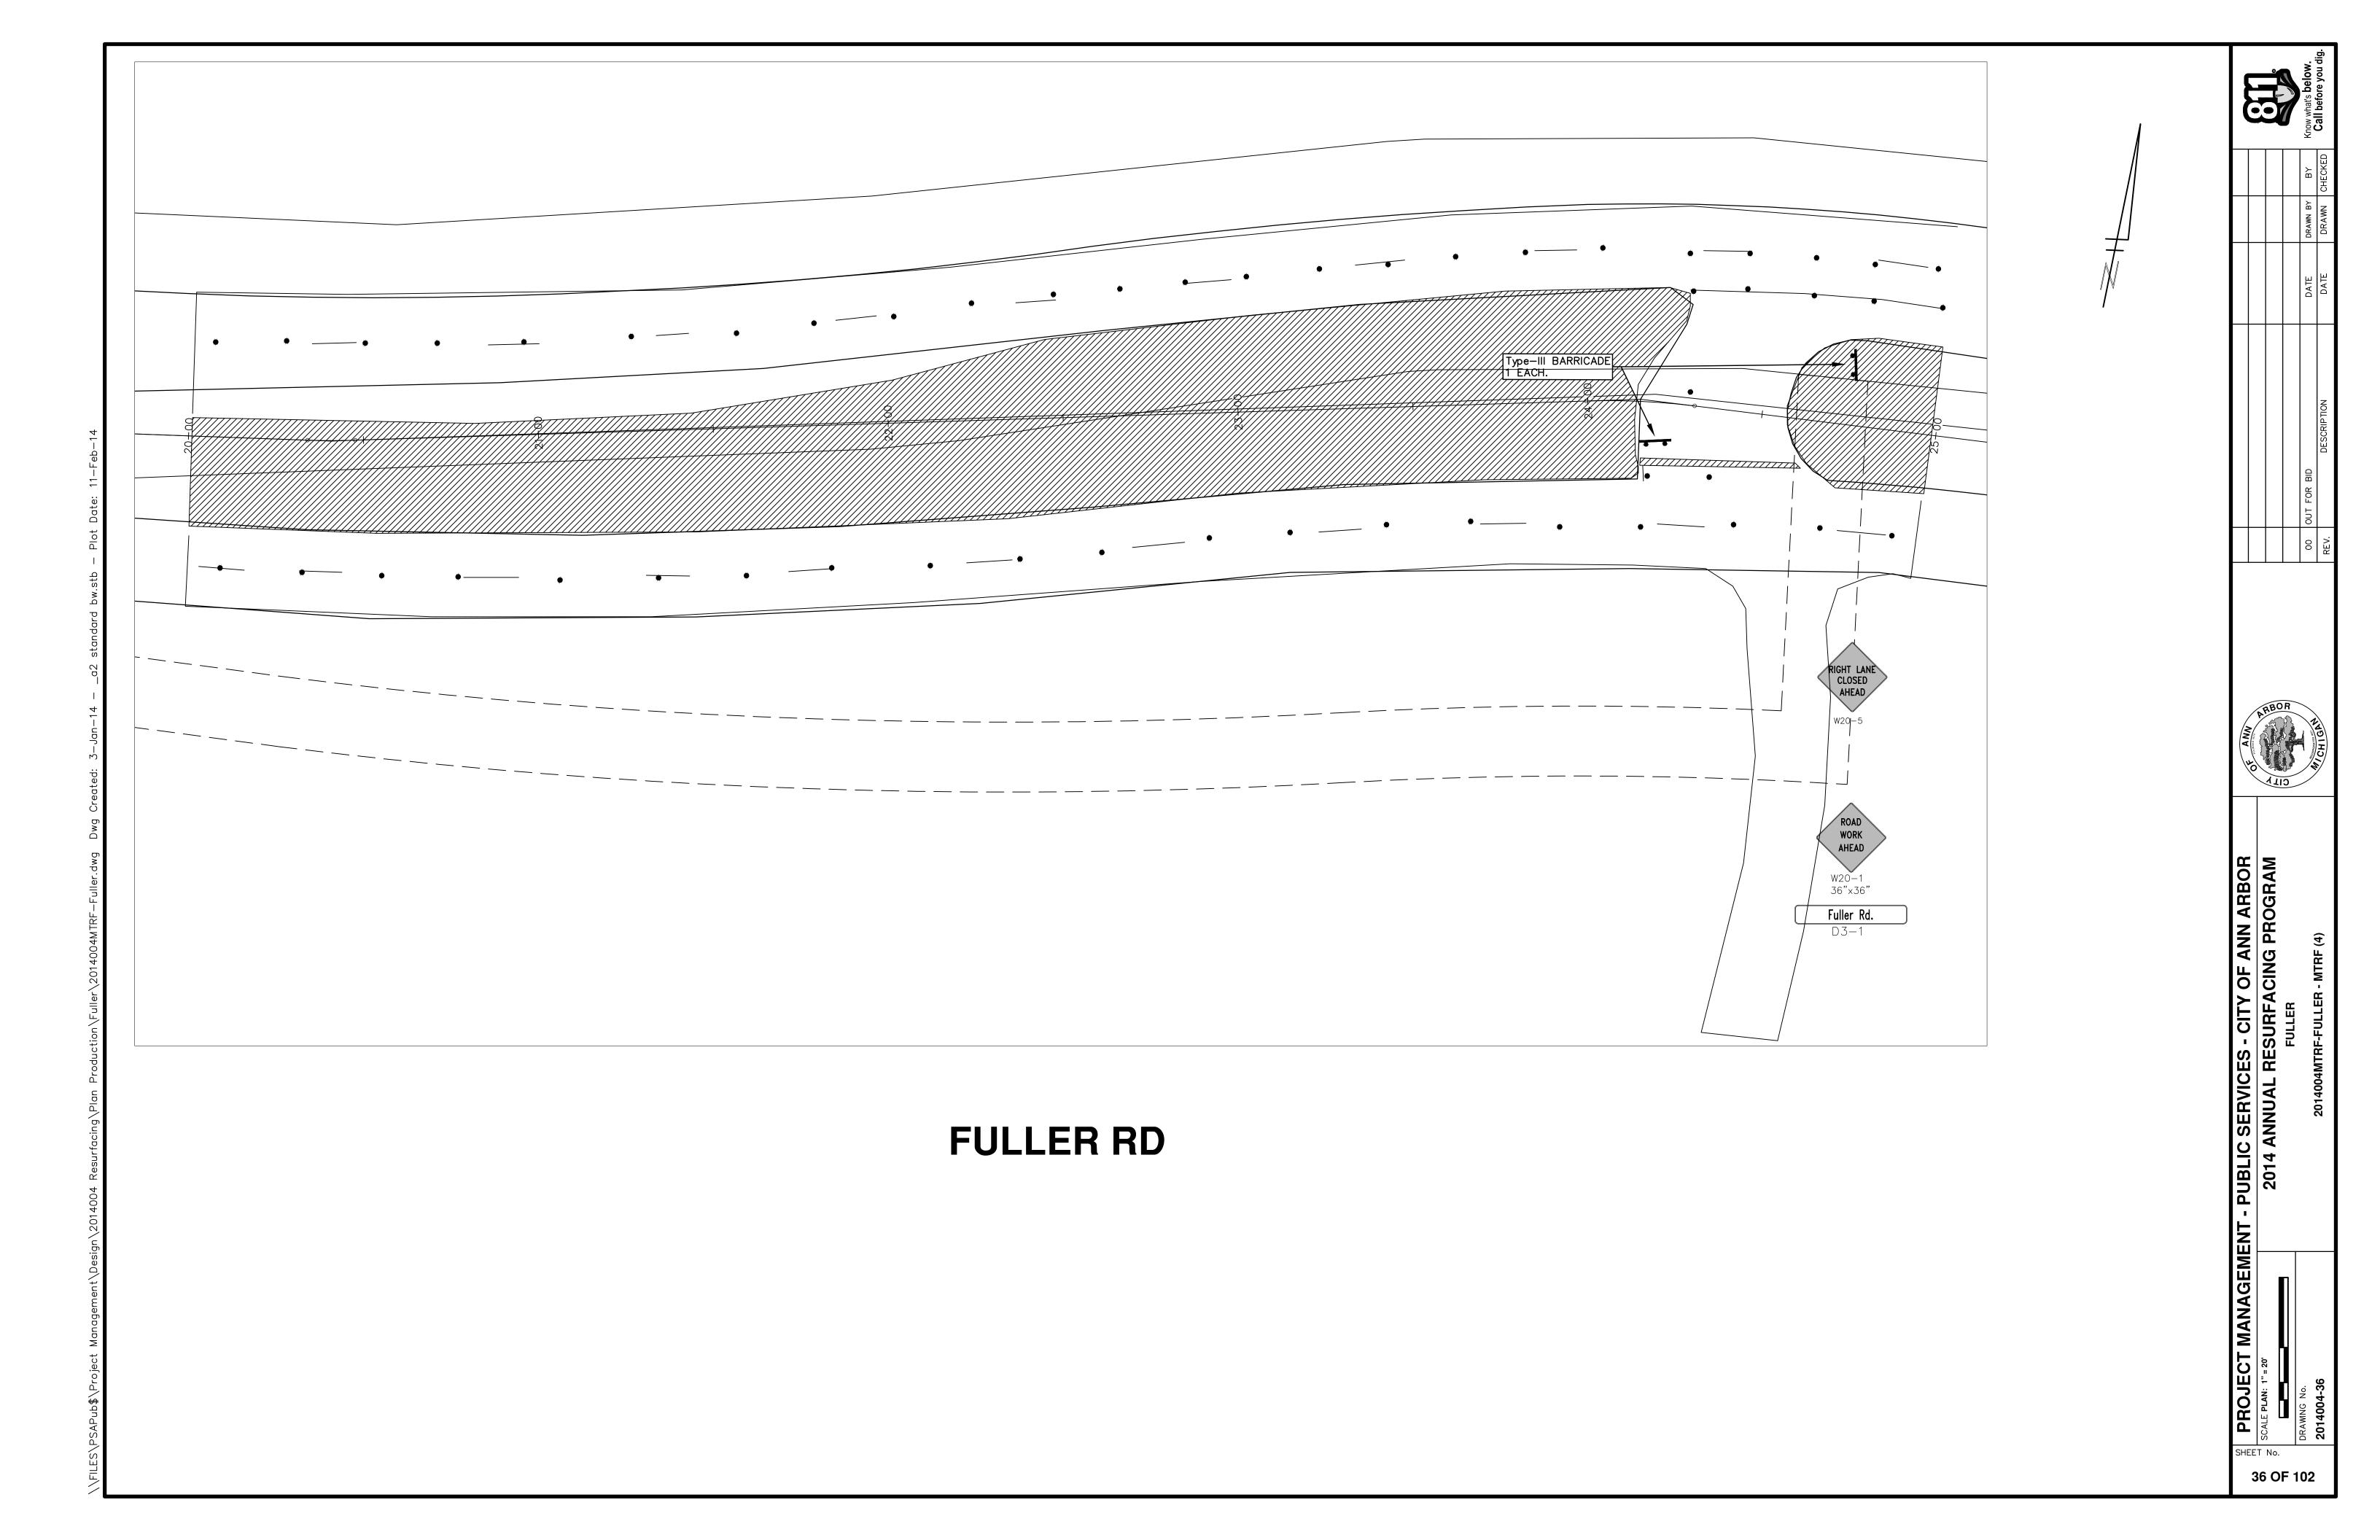

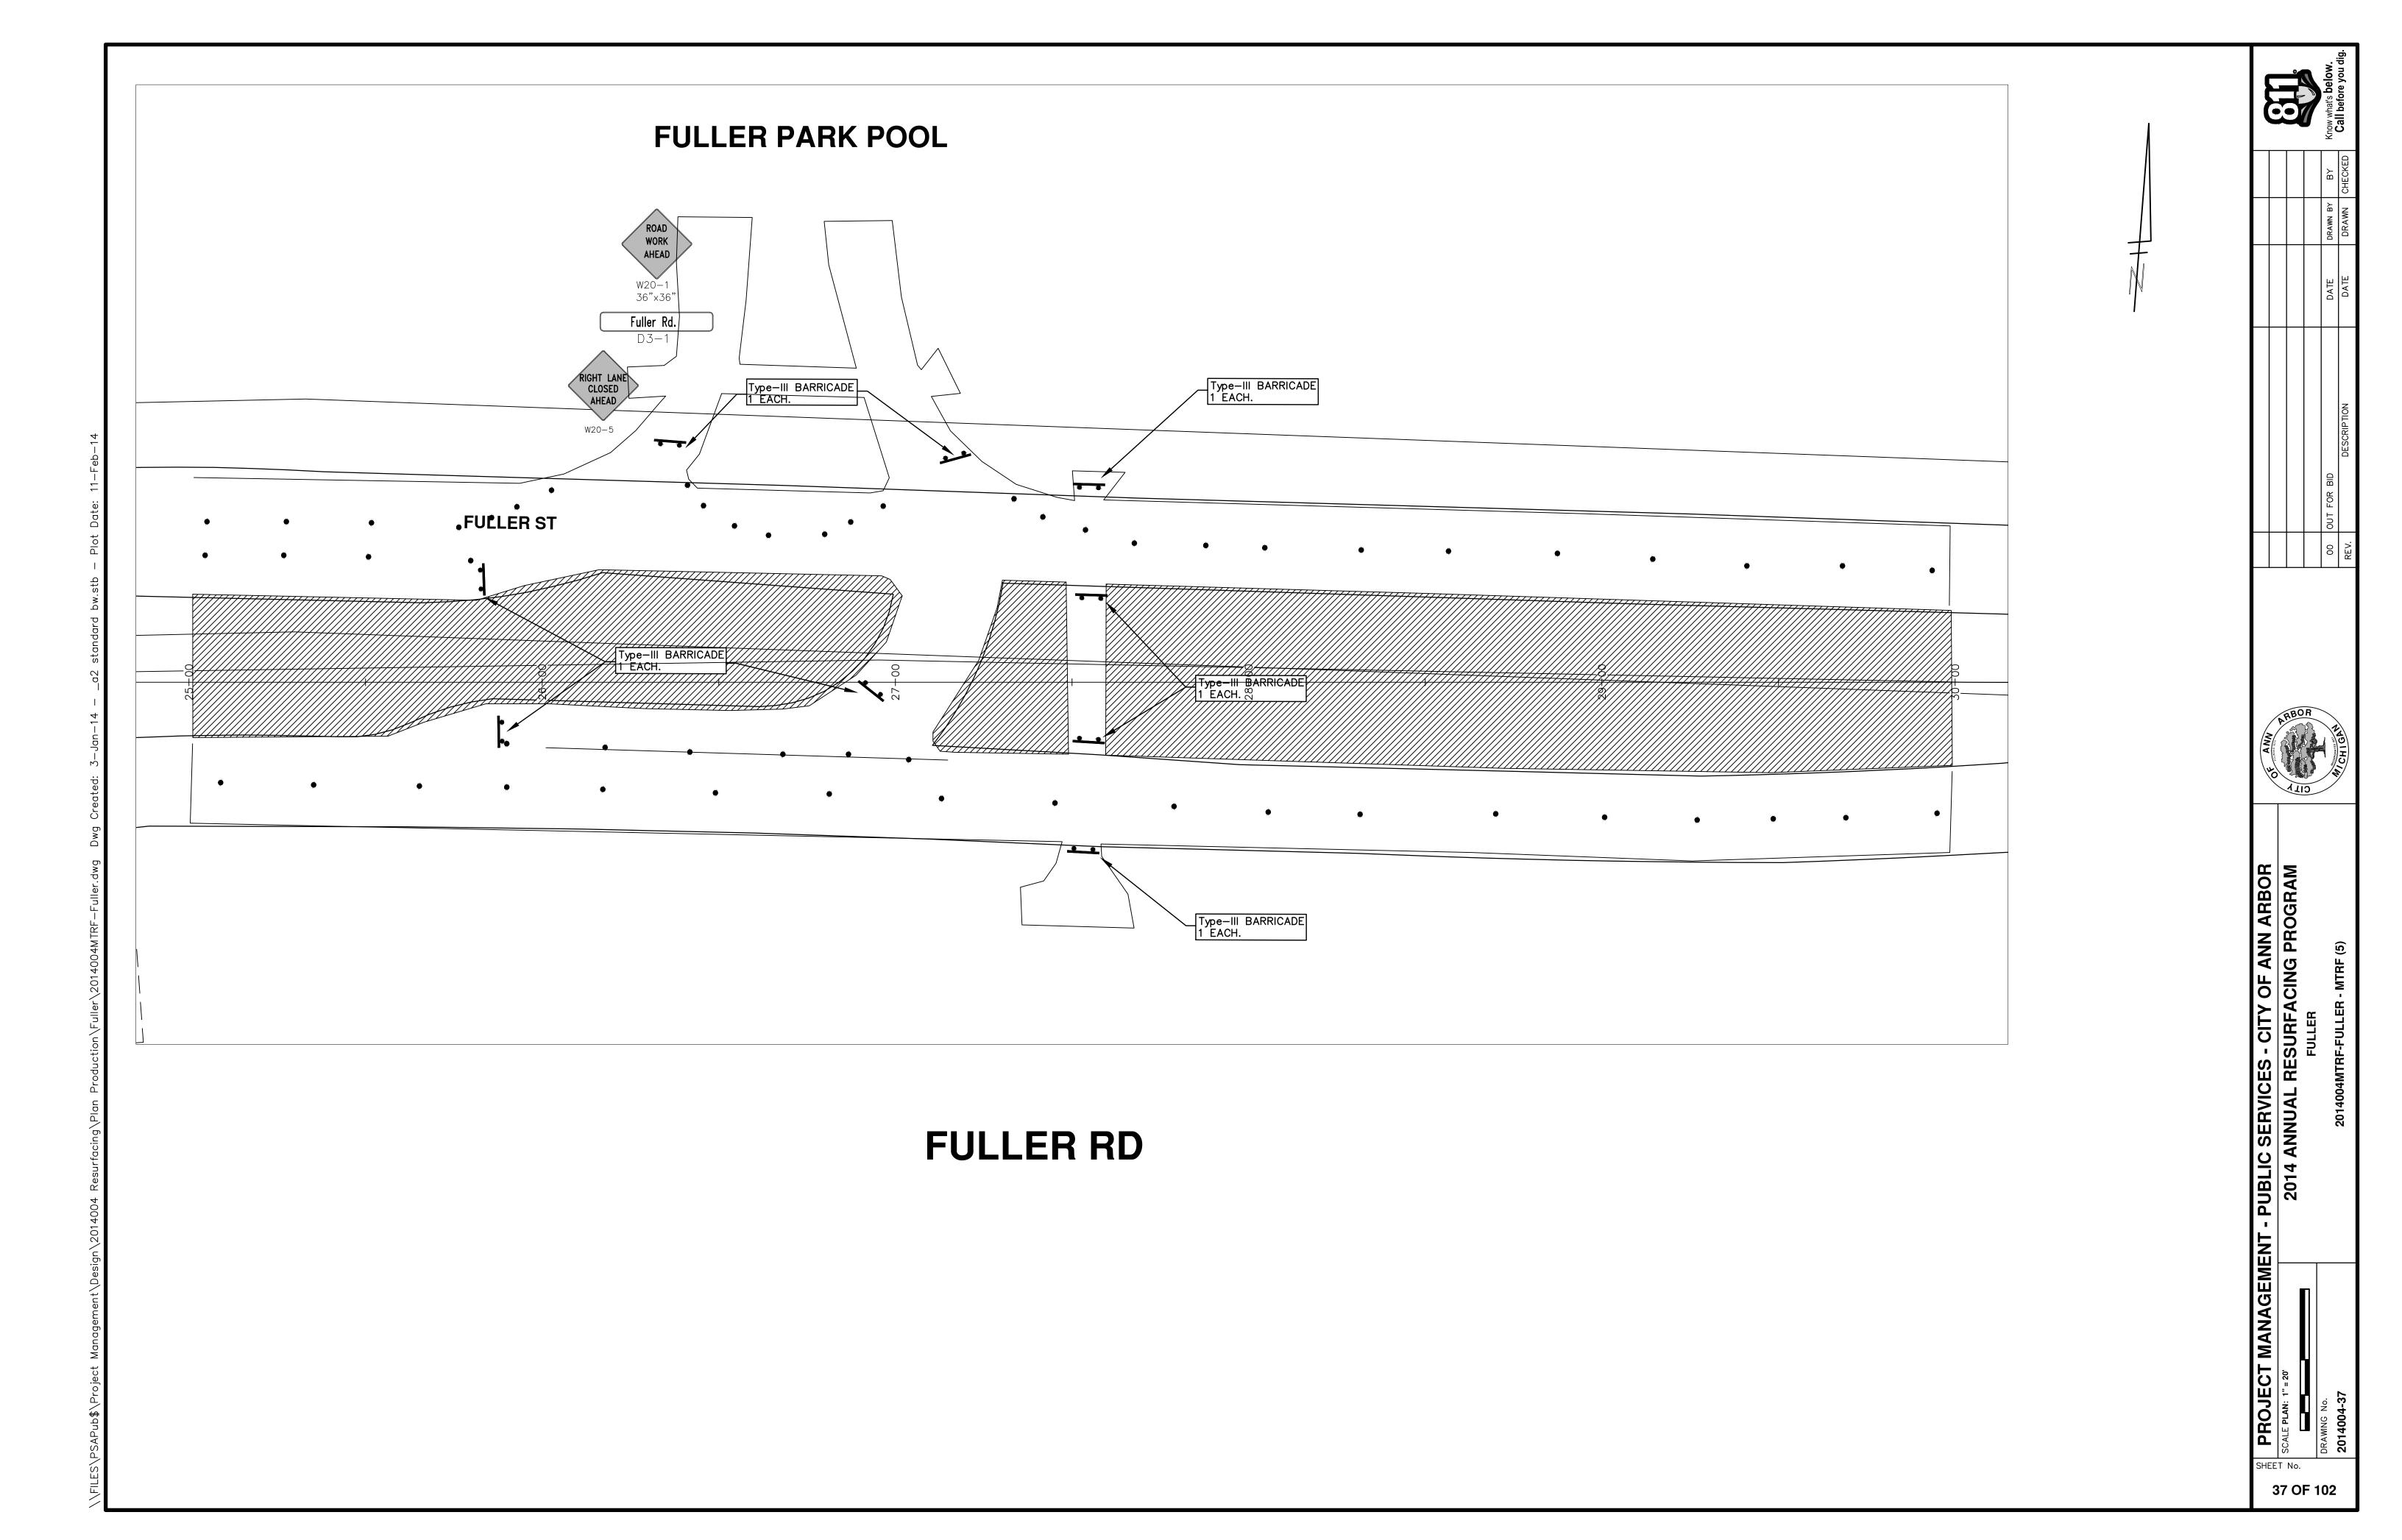

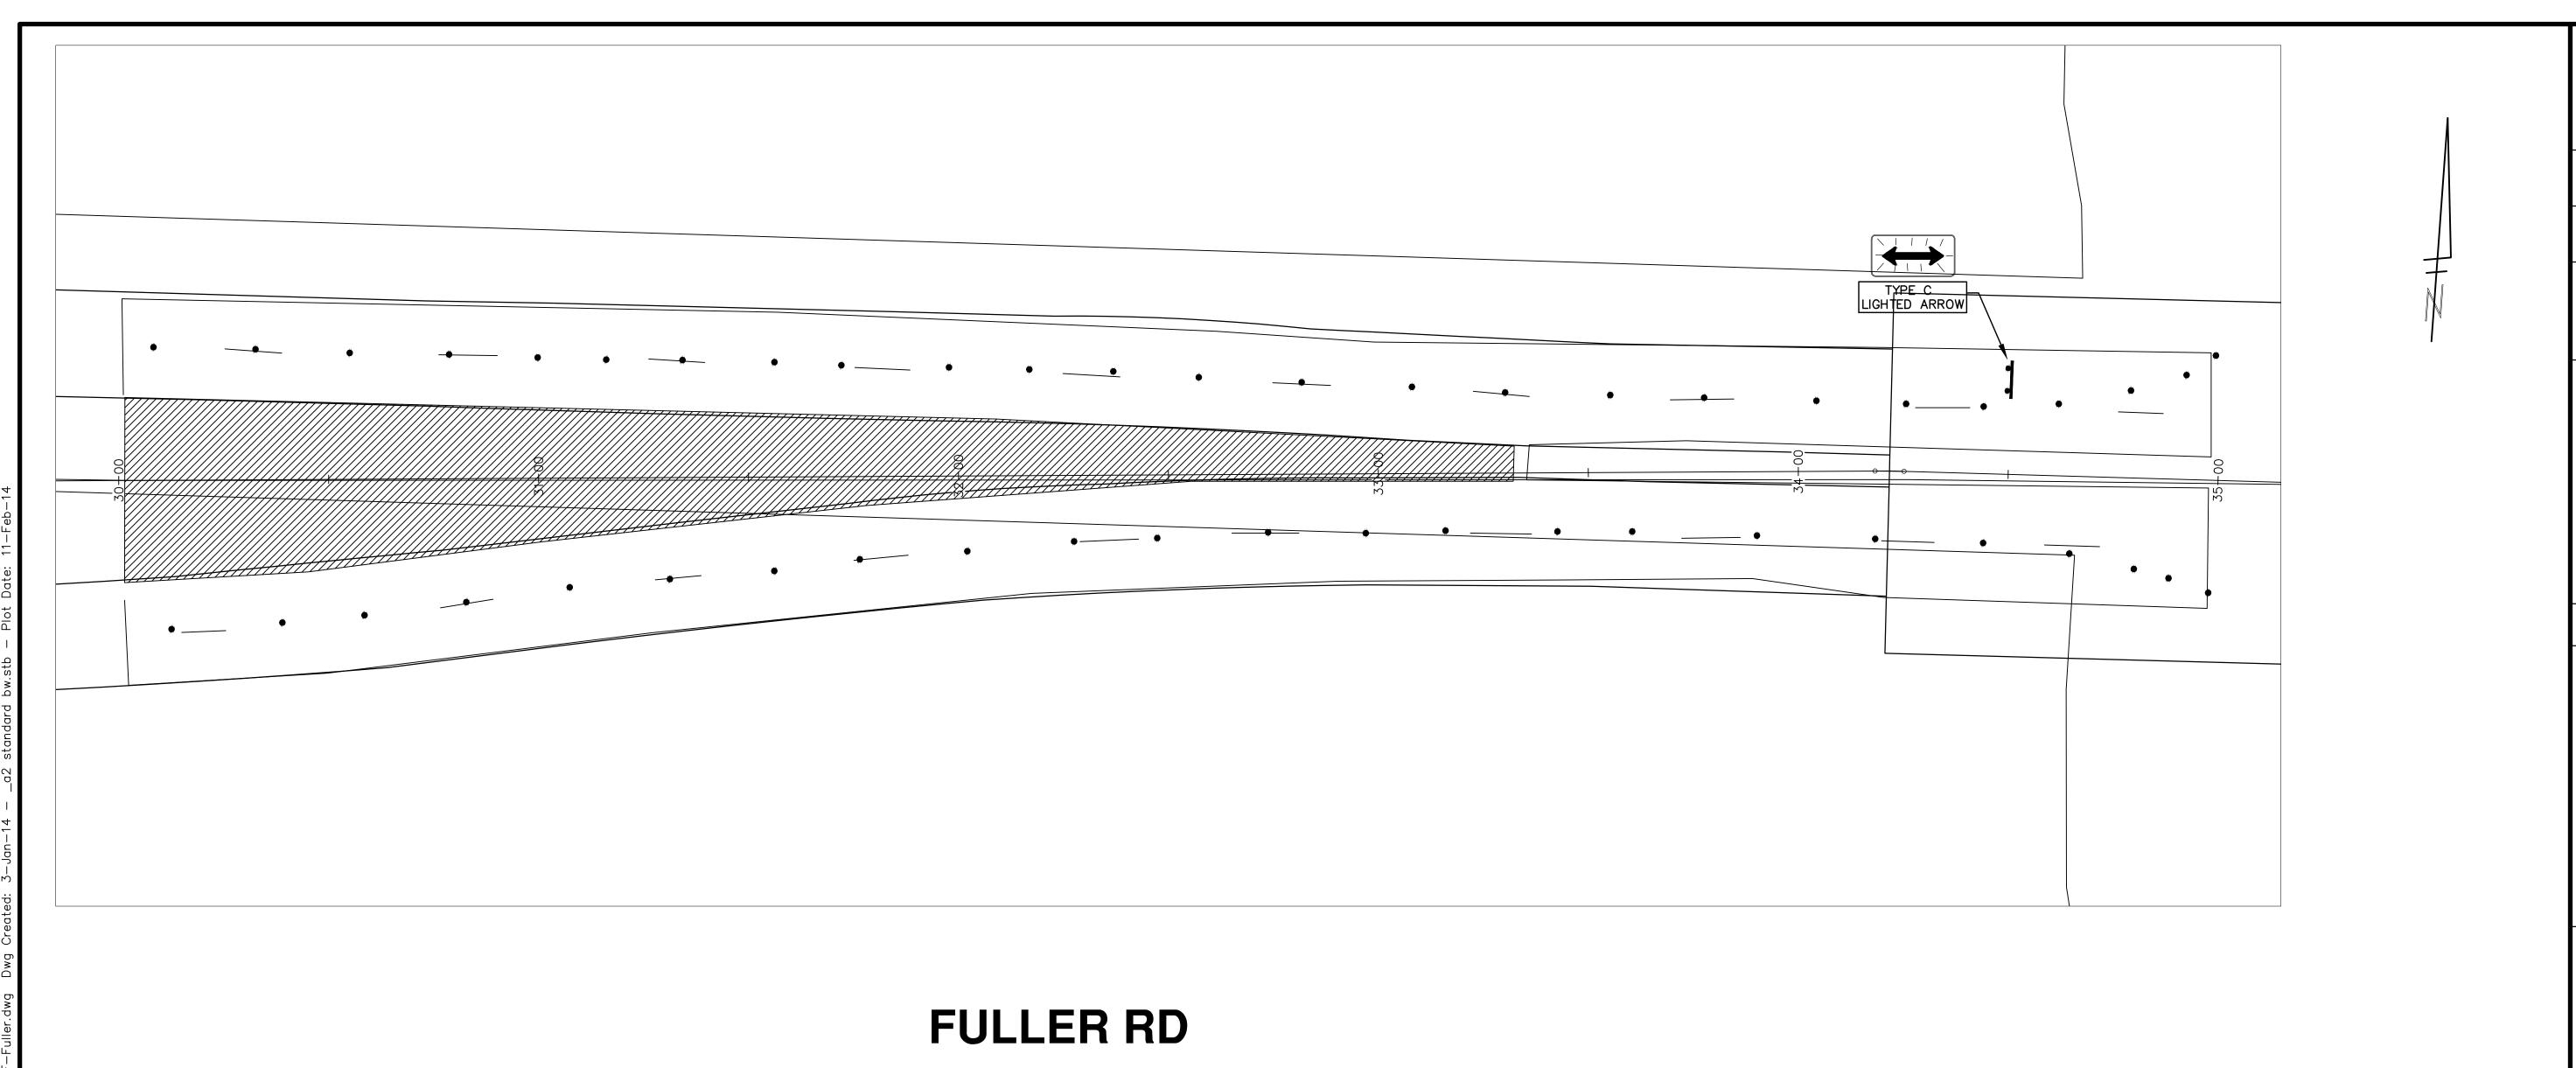

PROJECT MANAGEMENT - PUBLIC SERVICES - CITY OF ANN ARBOR

SCALE PLAN: 1" = 20

BRAWING No.


2014004-38

PROJECT MANAGEMENT - PUBLIC SERVICES - CITY OF ANN ARBOR

2014 ANNUAL RESURFACING PROGRAM

FULLER

2014004-38

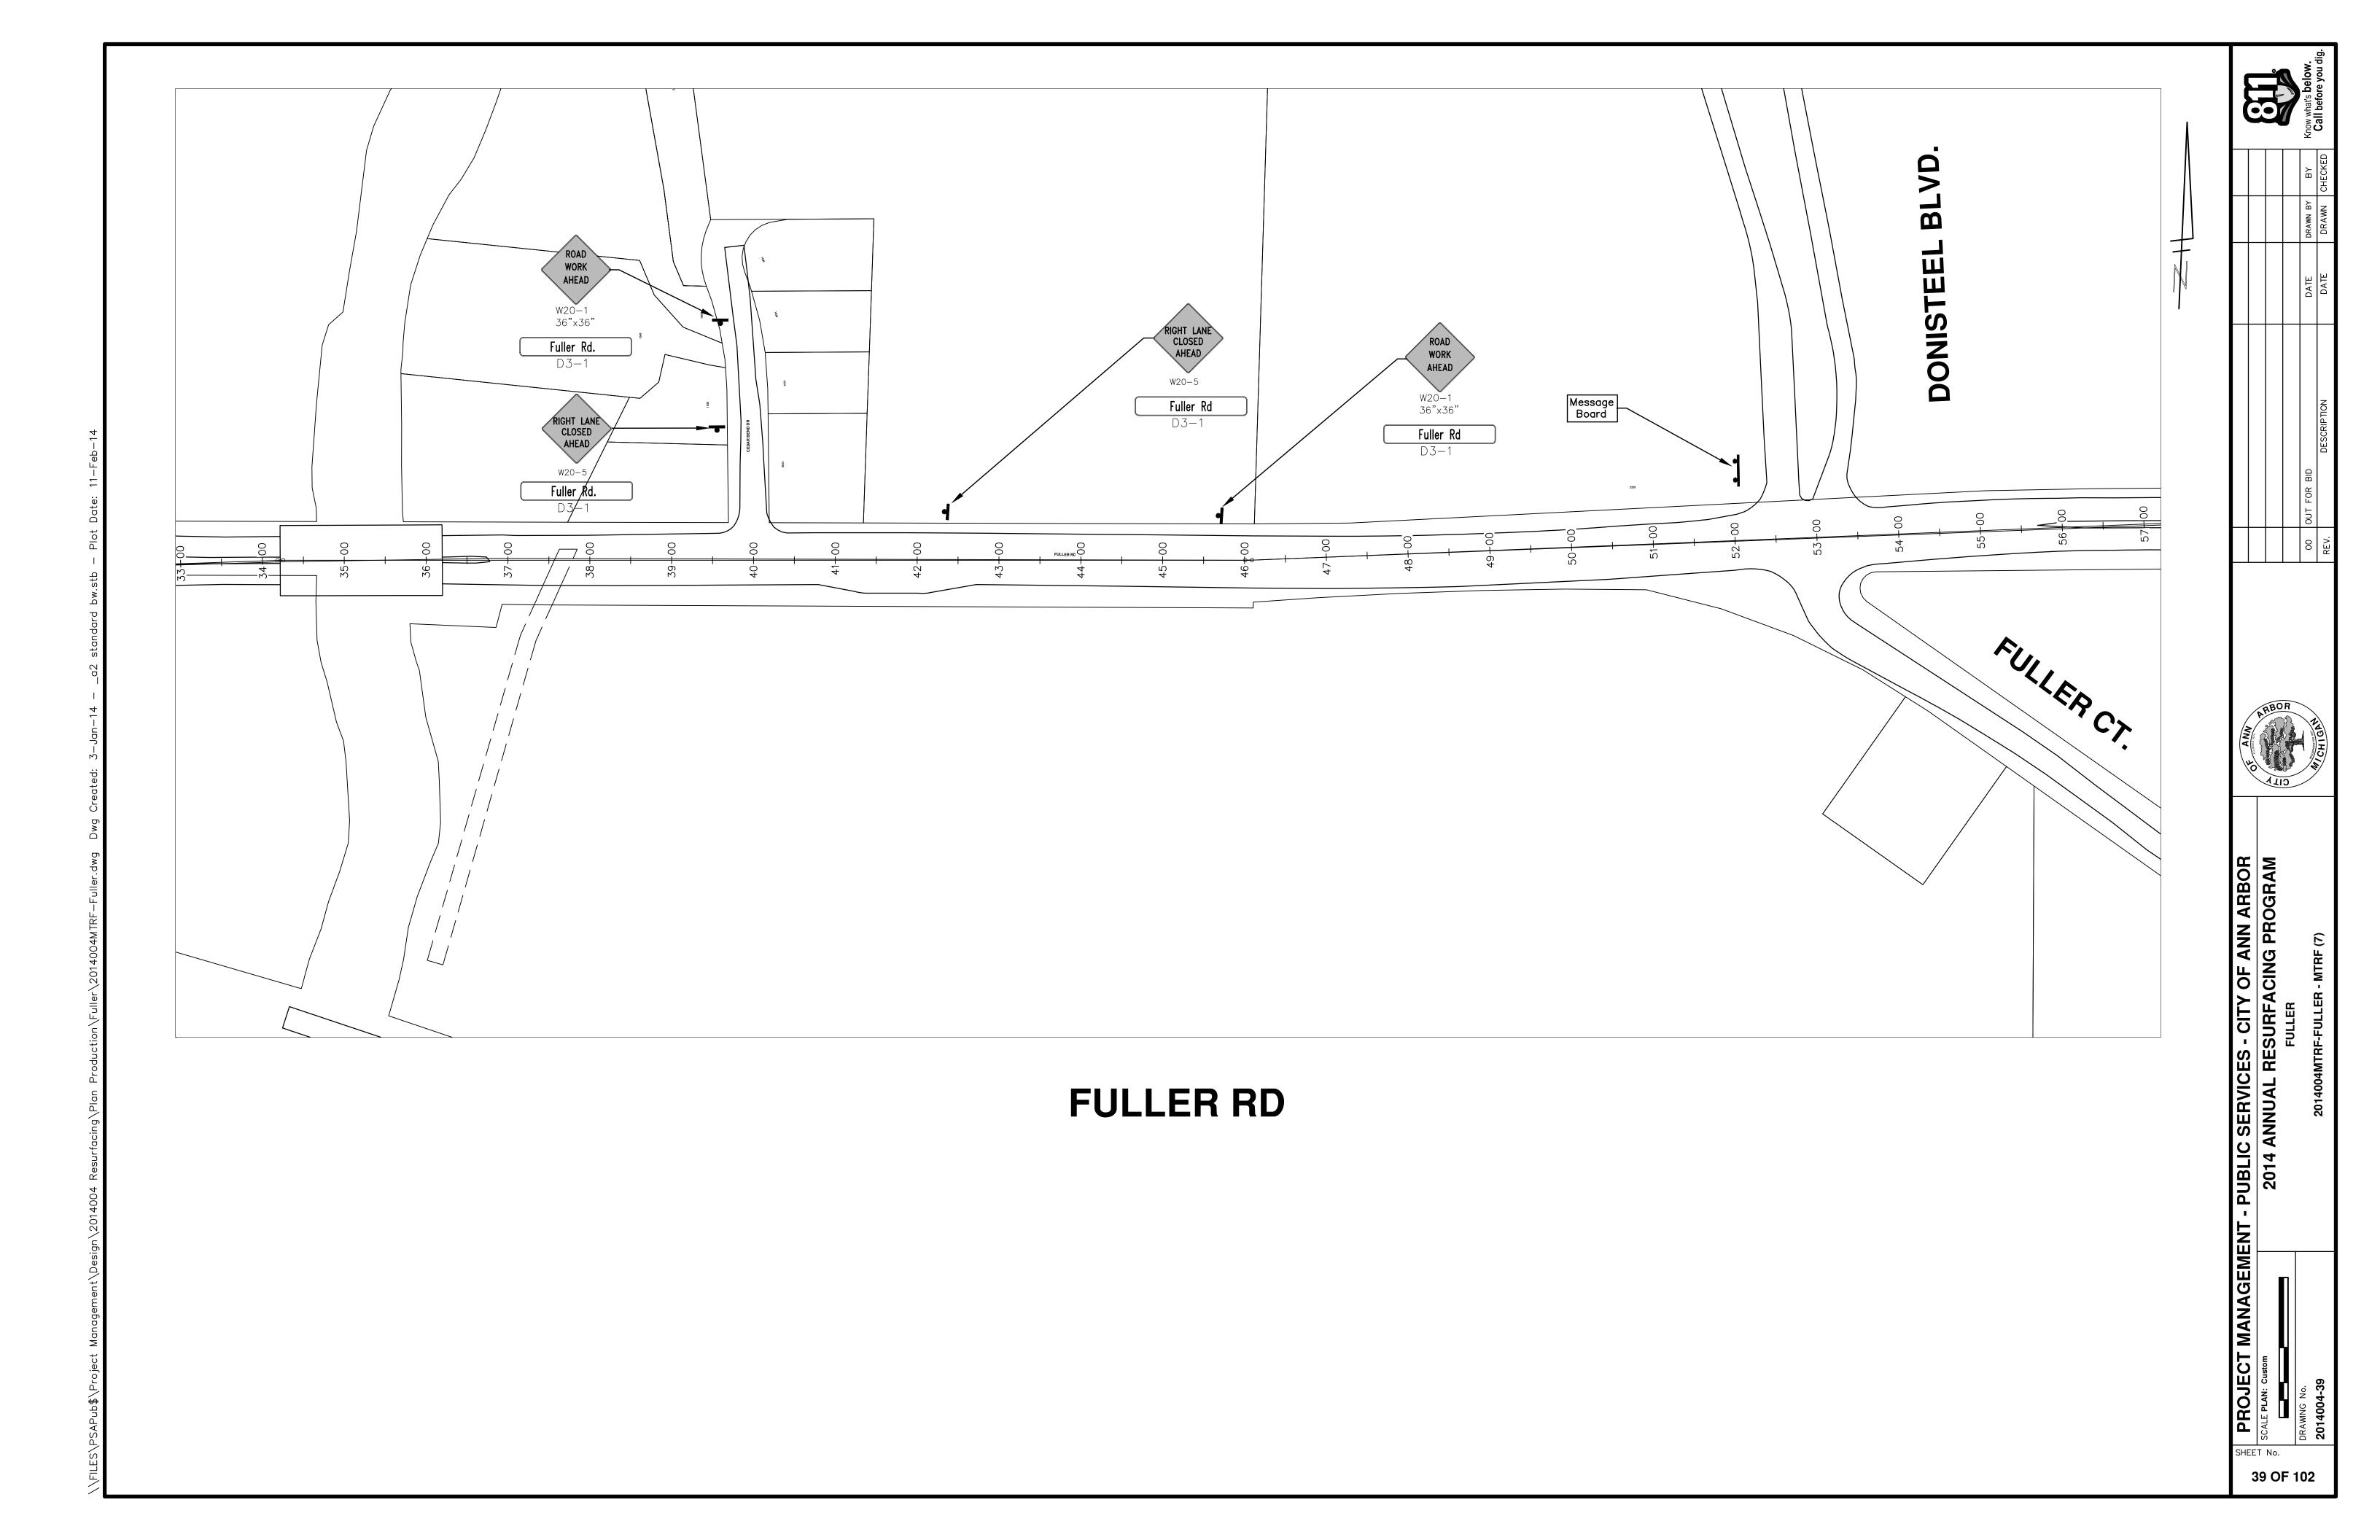



CITY OF ANN ARBOR PROJECT MANAGEMENT 2014 ANNUAL RESURFACING **PROGRAM** PROJECT LOCATION: VINEWOOD **BOULEVARD**

FILE No. 2014004

	QUANTITIES		
ITEM#	DESCRIPTION	Units	Total
207	Cold Milling Pavement	Tons	1170
209	Subgrade Undercutting - Type II	C.Y.	450
221	HMA Pavement Finish Wedging	Tons	8
222	HMA Pavement Leveling, Regular	Tons	780
223	HMA Pavement Wearing, Regular	Tons	390
230	Remove Curb & Gutter, Any Type	L.F.	790
232	Rem. Conc. Sidewalk & Drive - Any Thickness	S.F.	1050
237	Conc. Curb & Gutter - Any Type - Fixed Form	L.F.	790
241	6" Drive, Sidewalk or Ramp	S.F.	1050
250	2' Dia. Structure	Each	5
252	Reconstruct Structure	Each	2
254	Lower Structure Cover	Each	5
255	Lower Mon. / Gatevalve Box	Each	2
256	Adjust Structure Cover	Each	5
257	Adjust Curb Inlet Structure Cover	Each	10
258	Adj. Monument or Gate Valve Box	Each	2
259	Manhole Flange & Cover (MDOT Type A)	Each	6
260	Inlet Structure Cover (MDOT Type A)	Each	4
264	12" Sewer, Trench Detail I, Modified	L.F.	900
265	Single Inlet, 4' Dia.	Each	2
271	21AA Limestone - C.I.P.	C.Y.	450
282	Plastic Drum - Lighted - Furn. & Operate	Each	35
283	Barricade Type III - Furn. & Operate	Each	2
284	Temp Sign - Type B	S.F.	360
285	No Parking Sign	Each	25
291	4' Dia. Structure	Each	2
295	Tubular Markers, 36", Furn. & Oper.	Each	20
360	Type 1 Manhole (0-10' Deep)	Each	1
385	Sewer Pipe Abandonment	L.F.	15
386	Sewer Structure Abandonment	Each	1

TRAFFIC CONTROL & SIGN LEGEND				
QTY.	TYPE	DESCRIPTION		
12	W20-1	"ROAD WORK AHEAD"		
12	W20-5	"(RIGHT OR LEFT) LANE CLOSED AHEAD"		
24	D3-1	CONVENTIONAL GUIDE		
2	TYPE III	TYPE III LIGHTED BARRICADE		
35	TYPE II	TYPE II LIGHTED BARRICADE DRUM		

CONSTRUCTION METHOD AND SEQUENCING

- 1. THE WORK TO BE COMPLETED ON THIS STREET SHALL INCLUDE. BUT NOT BE LIMITED TO THE FOLLOWING ITEMS. THE ORDER OF CONSTRUCTION SHALL BE AS GIVEN UNLESS OTHERWISE AUTHORIZED
- 2. IMPLEMENT TRAFFIC MAINTENANCE, AND SOIL EROSION CONTROLS IN ACCORDANCE WITH THE PLANS,
- 3. INSTALL ANY PROPOSED STORM SEWER, AND UNDERDRAIN AS SHOWN ON THE PLANS, AND AS DIRECTED BY THE ENGINEER.
- 4. LOWER ALL STRUCTURES COVERS, INCLUDING VALVE AND MONUMENT BOXES.
- 5. PERFORM ALL CONCRETE WORK, INCLUDING RESTORATION, IN ACCORDANCE WITH THE PLANS, AND AS DIRECTED BY THE ENGINEER.
- 6. MILL 6 INCHES OF BITUMINOUS MATERIAL FROM EXISTING ROADWAY. THIS MAY INCLUDE GRANULAR ROAD BASE MATERIAL. DEPTH TO BE DETERMINED BY THE ENGINEER. PROOF ROLL WITH FULL TRUCK.
- 7. PERFORM UNDERCUTS AND/OR BASE REPAIRS AS DIRECTED BY THE ENGINEER.
- 8. GRADE, SHAPE, AND RE-COMPACT THE EXISTING ROAD BASE AS REQUIRED, AND AS DIRECTED BY THE
- 9. PAVE 2-1/2 INCHES OF THE BITUMINOUS MIX AS SPECIFIED OR DIRECTED BY THE ENGINEER, AS THE
- 10. PAVE 2 INCHES OF THE BITUMINOUS MIX AS SPECIFIED OR DIRECTED BY THE ENGINEER, AS THE LEVELING COURSE, IN ONE LIFT.
- 11. ADJUST ALL STRUCTURE COVERS, MONUMENT BOXES, AND VALVE BOXES TO THEIR FINISHED ELEVATIONS
- 12. PAVE 1-1/2 INCHES OF THE BITUMINOUS MIX AS SPECIFIED OR DIRECTED BY THE ENGINEER, AS THE WEARING COURSE, IN ONE LIFT.
- 13. COMPLETE ALL PAVEMENT MARKINGS IN ACCORDANCE WITH THE PLANS, AND AS DIRECTED BY THE
- 14. COMPLETE ALL MISCELLANEOUS CONSTRUCTION INCLUDING ALL CLEAN-UP AND FINAL RESTORATION.
- 15. REMOVE ALL TRAFFIC CONTROL DEVICES. REMOVE MISS DIG FLAGS

NOTES:

THE CONSTRUCTION COVERED BY THESE PLANS SHALL CONFORM TO THE 1994 EDITION OF THE CITY OF ANN ARBOR PUBLIC SERVICES DEPARTMENT STANDARD SPECIFICATIONS AND IT'S DETAILS WHICH ARE INCLUDED BY REFERENCE. THE OMISSION OF ANY CURRENT STANDARD DETAIL DOES NOT RELIEVE THE CONTRACTOR FROM THIS REQUIREMENT. THE WORK SHALL BE PERFORMED IN COMPLETE CONFORMANCE WITH THE CURRENT PUBLIC SERVICES STANDARD SPECIFICATIONS AND DETAILS.


FOR PROTECTION OF UNDERGROUND UTILITIES AND IN CONFORMANCE WITH PUBLIC ACT 53, THE CONTRACTOR SHALL CALL 611 OR 1-800-482-7171 A MINIMUM OF THREE FULL WORKING DAYS, EXCLUDING SATURDAYS, SUNDAYS, AND HOLDAYS PRIOR TO BEGINNING EACH EXCAVATION IN AREAS WHERE PUBLIC UTILITIES HAVE NOT BEEN PREVIOUSLY LOCATED. MEMBERS WILL THUS BE ROUTINELY NOTIFIED. THIS DOES NOT RELIEVE THE CONTRACTOR OF THE RESPONSIBILITY OF NOTIFYING UTILITY OWNERS WHO MAY NOT BE A PART OF THE "MISS DIG" ALERT SYSTEM.

THE UNDERGROUND LOCATIONS SHOWN FOR NATURAL GAS (GAS), TELEPHONE (TEL), ELECTRICAL POWER (PWR), CABLE TV (CTV) AND FIBER OPTIC LINES (FIBER) ARE APPROXIMATE. THE CITY OF ANN ARBOR ASSUMES NO RESPONSIBILITY FOR THEIR ACCURATE REPRESENTATION IN THIS DRAWING. MISS DIG MUST BE CONTACTED PRIOR

PROJECT MANAGEMENT SERVICE UNIT

CITY OF ANN ARBOR PUBLIC SERVICE 301 EAST HURON STREET, P.O. BOX 8647 ANN ARBOR MICHIGAN 48107-8647 734-794-6410 www.a2gov.org

40 TO 102

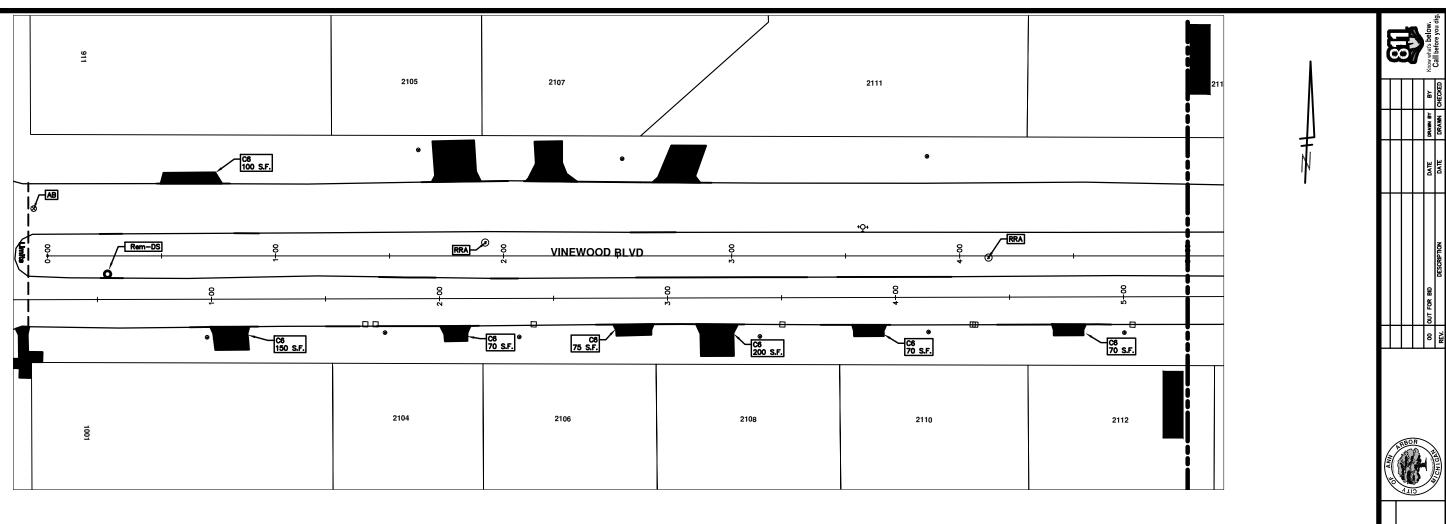


VINEWOOD BLVD.

	CONSTRUCTION KEY
KEY	DESCRIPTION
C/G	REMOVE AND REPLACE CURB AND GUTTER
C/GHE	REMOVE CURB AND GUTTER, REPLACE WITH CONCRETE CURB AND GUTTER H.E.
C4HE	REMOVE EXISTING RAMP OR SIDEWALK. REPLACE WITH 4" SIDEWALK OR TYPE 1 SIDEWALK RAMP, H.E.
CR	REMOVE SIDEWALK, DRIVE OR RAMP.
AA	ADJUST MDOT TYPE A CASTINGS.
AB	ADJUST GATE VALVE BOX OR MONUMENT BOX.
ADST	ADDITIONAL DEPTH STRUCTURE REPAIR.
RRA	REMOVE AND REPLACE MDOT TYPE A CASTING ADJUST TO FINISH GRADE.
CPRHE	CONCRETE PAVEMENT REPAIR, H.E.
DS	CONSTRUCT 2, 3 OR 4' DIAM. DRAINAGE STRUCTURE.
PT	POINT STRUCTURE.
C4	REMOVE EXISTING RAMP OR SIDEWALK, REPLACE WITH 4" SIDEWAL OR RAMP.
C6	REMOVE EXISTING RAMP OR SIDEWALK, REPLACE WITH 6" SIDEWAL OR RAMP
C8	PLACE 8" SIDEWALK OR RAMP ONLY
C HE	REMOVE EXISTING DRIVE APPROACH, RAMP OR SIDEWALK. REPLAC WITH 6" OR 8" APPROACH, RAMP, OR SIDEWALK, H.E.
CP	PLACE 4" SIDEWALK OR RAMP.
AK	ADJUST MDOT TYPE K CASTING.
TYPE II	MDOT TYPE II BARRICADE.
TYPE III	MDOT TYPE III BARRICADE.
RRK	REMOVE AND REPLACE MDOT TYPE K CASTING. ADJUST TO FINISH GRADE.
RS	RECONSTRUCT STRUCTURE.
RCP	REMOVE CONC. PAVEMENT - ANY THICKNESS
RCW	RAISED CROSSWALK

	LEGEND
SYMBOL	DESCRIPTION
•	EXISTING SANITARY SEWER MANHOLE
0	EXISTING STORM SEWER MANHOLE
•	EXISTING WATER MAIN VALVE IN WELL
+	WATER MAIN GATE VALVE IN BOX
ŵ	FIRE HYDRANT
•	MICHOON GAS CO. VALVE BOX/NELL
•	AMERITECH TELEPHONE VAULT
•	ELECTRIC MANHOLE
•	SOIL BORING
0	EXISTING STORM SEVER INLET
•	MONUMENT BOX
	REMOVE AND REPLACE CONC. SIDEWALK
	PLACE CONCRETE SIDEWALK
_	REMOVE & REPLACE CONC. CURB & GUTTER
	CONSTRUCTION LIMITS
_:-	6" WRAPPED UNDERDRAIN
	REMOVE CONCRETE SIDEWALK
	SUBGRADE UNDERCUT

l`	•		U	Know	ន
				β¥	DRAWN CHECKED
				DRAWN BY	DRAWN
				DATE	DATE
				OUT FOR BID	DESCRIPTION
				8	Æ.
PROJECT MANAGEMENT - PUBLIC SERVICES - CITY OF ANN ARBOR		2014 ANNUAL RESURFACING PROGRAM	VINEWOOD		2014004LAY-VINEWOOD - PLAN VIEW (01)
PROJECT MANAGEM	SCALE PLAN: 1" - 20"			DRAWING No.	2014004-41
SHEE	11	No.	F	102	

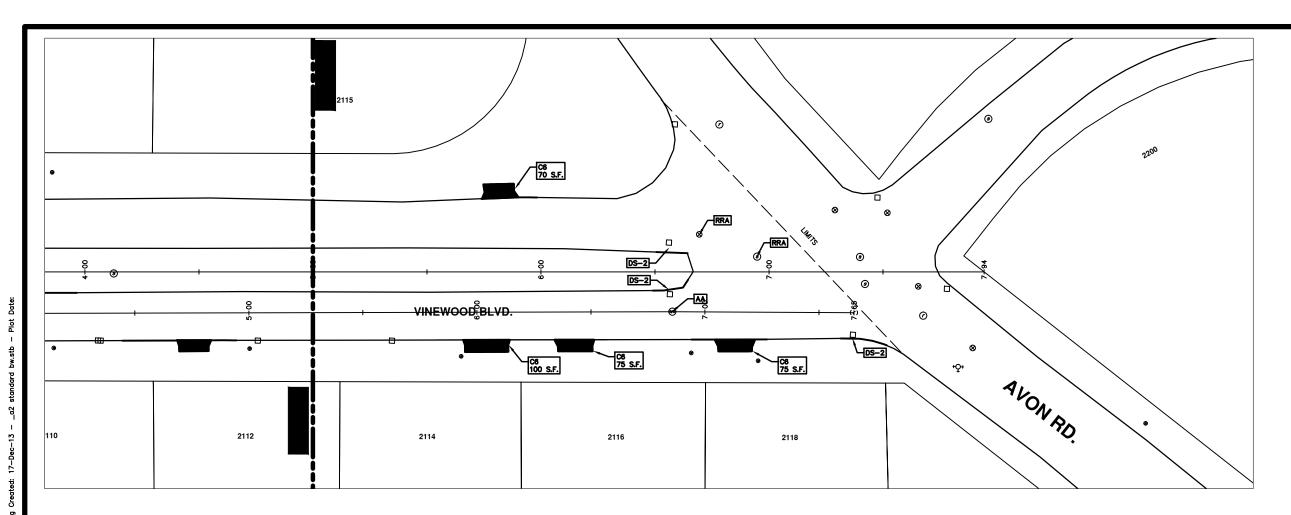




	CONSTRUCTION KEY
KEY	DESCRIPTION
C/G	REMOVE AND REPLACE CURB AND GUTTER
C/GHE	REMOVE CURB AND GUTTER, REPLACE WITH CONCRETE CURB AN GUTTER H.E.
C4HE	REMOVE EXISTING RAMP OR SIDEWALK. REPLACE WITH 4" SIDEWALK OR TYPE 1 SIDEWALK RAMP, H.E.
CR	REMOVE SIDEWALK, DRIVE OR RAMP.
AA	ADJUST MDOT TYPE A CASTINGS.
AB	ADJUST GATE VALVE BOX OR MONUMENT BOX.
ADST	ADDITIONAL DEPTH STRUCTURE REPAIR.
RRA	REMOVE AND REPLACE MDOT TYPE A CASTING ADJUST TO FINIS GRADE.
CPRHE	CONCRETE PAVEMENT REPAIR, H.E.
DS	CONSTRUCT 2, 3 OR 4' DIAM. DRAINAGE STRUCTURE.
PT	POINT STRUCTURE.
C4	REMOVE EXISTING RAMP OR SIDEWALK, REPLACE WITH 4" SIDEW. OR RAMP.
C6	REMOVE EXISTING RAMP OR SIDEWALK, REPLACE WITH 6" SIDEW. OR RAMP
С8	PLACE 8" SIDEWALK OR RAMP ONLY
C HE	REMOVE EXISTING DRIVE APPROACH, RAMP OR SIDEWALK. REPLA WITH 6" OR 8" APPROACH, RAMP,OR SIDEWALK, H.E.
СР	PLACE 4" SIDEWALK OR RAMP.
AK	ADJUST MDOT TYPE K CASTING.
TYPE II	MDOT TYPE II BARRICADE.
TYPE III	MDOT TYPE III BARRICADE.
RRK	REMOVE AND REPLACE MDOT TYPE K CASTING. ADJUST TO FINIS GRADE.
RS	RECONSTRUCT STRUCTURE.
RCP	REMOVE CONC. PAVEMENT - ANY THICKNESS
RCW	RAISED CROSSWALK


LEGEND			
SYMBOL	DESCRIPTION		
•	EXISTING SANITARY SEWER MANHOLE		
0	EXISTING STORM SEWER MANHOLE		
•	EXISTING WATER MAIN VALVE IN WELL		
+	WATER MAIN GATE VALVE IN BOX		
•6•	FIRE HYDRANT		
•	MICHOON GAS CO. VALVE BOX/WELL		
•	AMERITECH TELEPHONE VAULT		
•	ELECTRIC MANHOLE		
•	SOIL BORING		
0	EXISTING STORM SEWER INLET		
•	MONUMENT BOX		
	REMOVE AND REPLACE CONC. SIDEWALK		
	PLACE CONCRETE SIDEWALK		
	REMOVE & REPLACE CONC. CURB & GUTTER		
	CONSTRUCTION LIMITS		
	6" WRAPPED UNDERDRAIN		
	REMOVE CONCRETE SIDEWALK		
	SUBGRADE UNDERCUT		








PUBLIC SERVICES - CITY OF ANN ARBOR
2014 ANNUAL RESURFACING PROGRAM
VINEWOOD

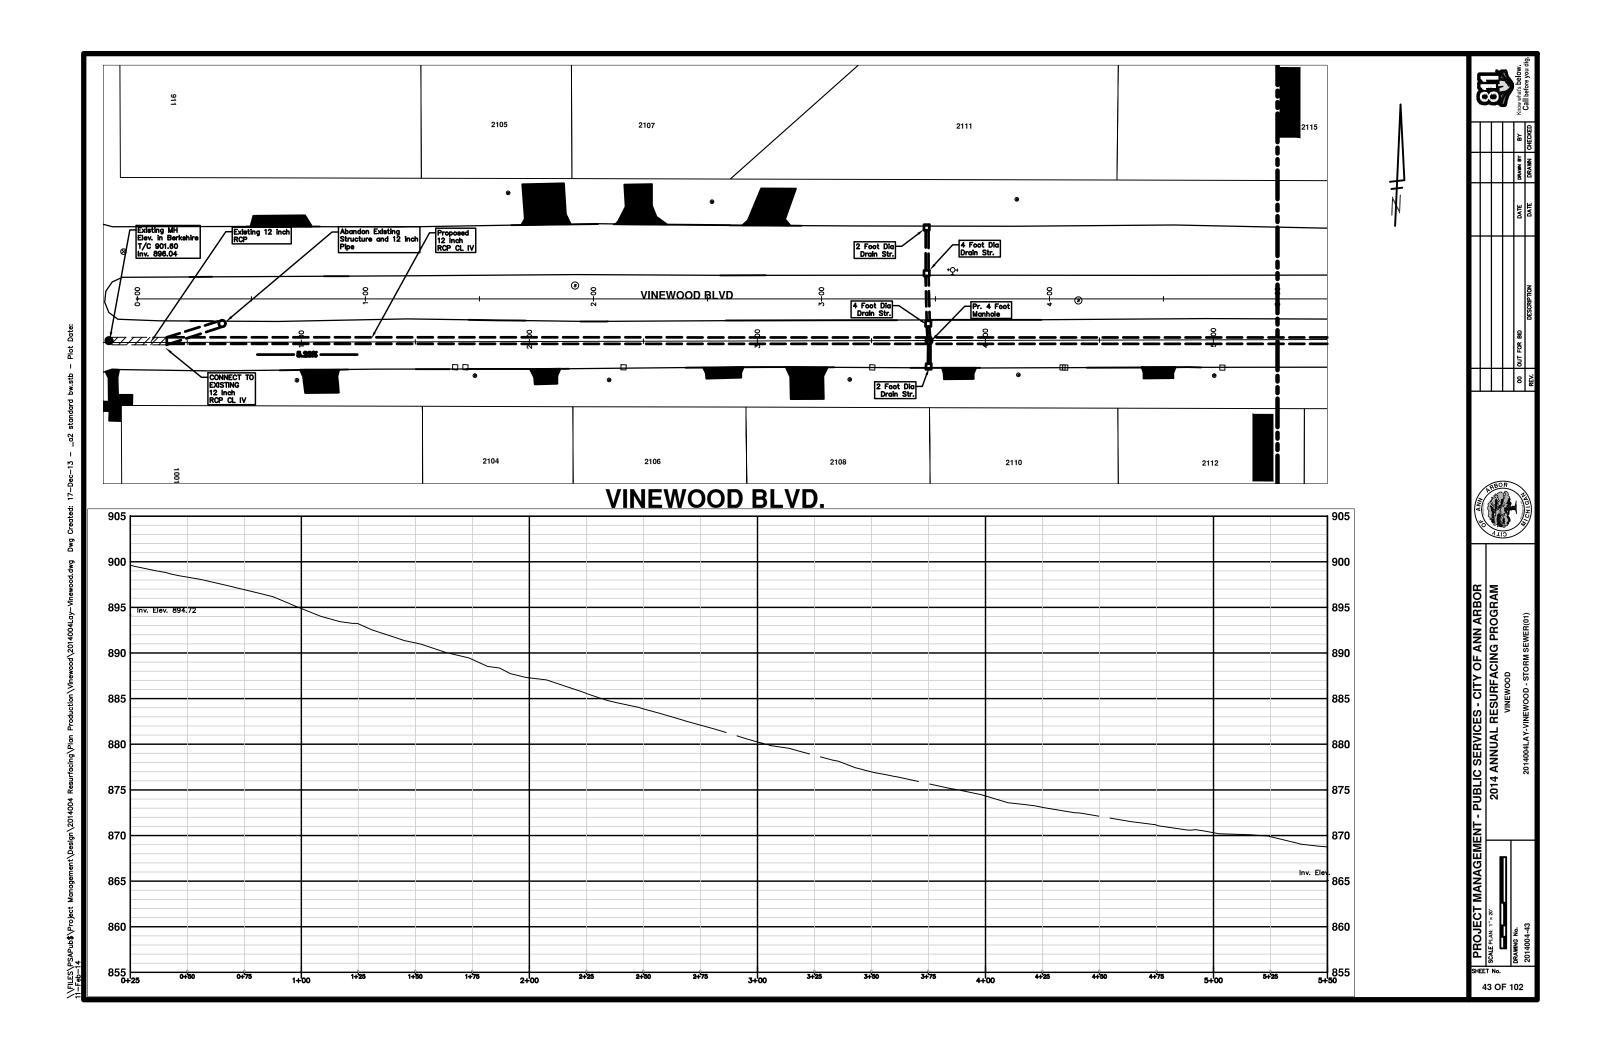

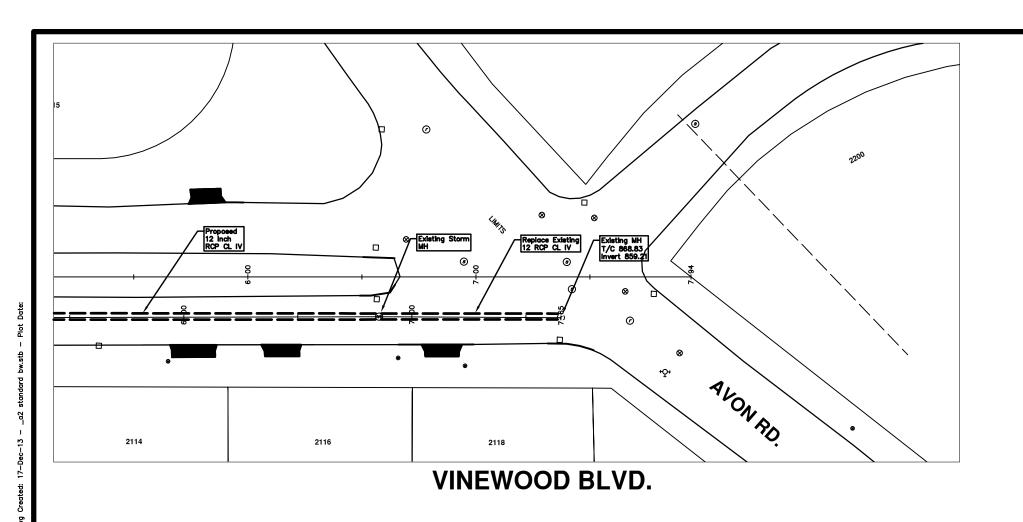


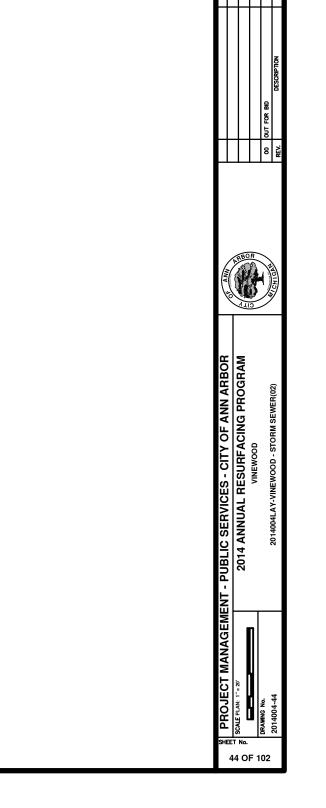

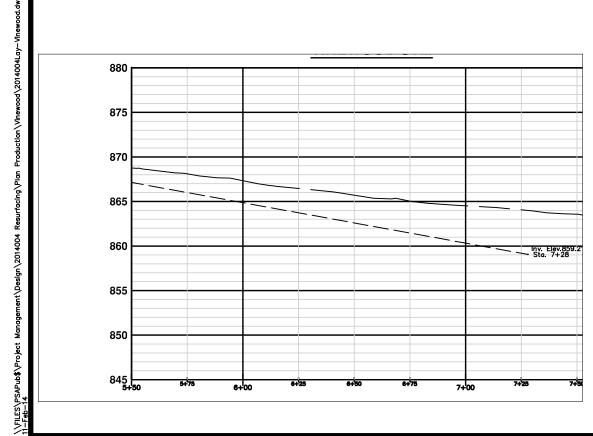

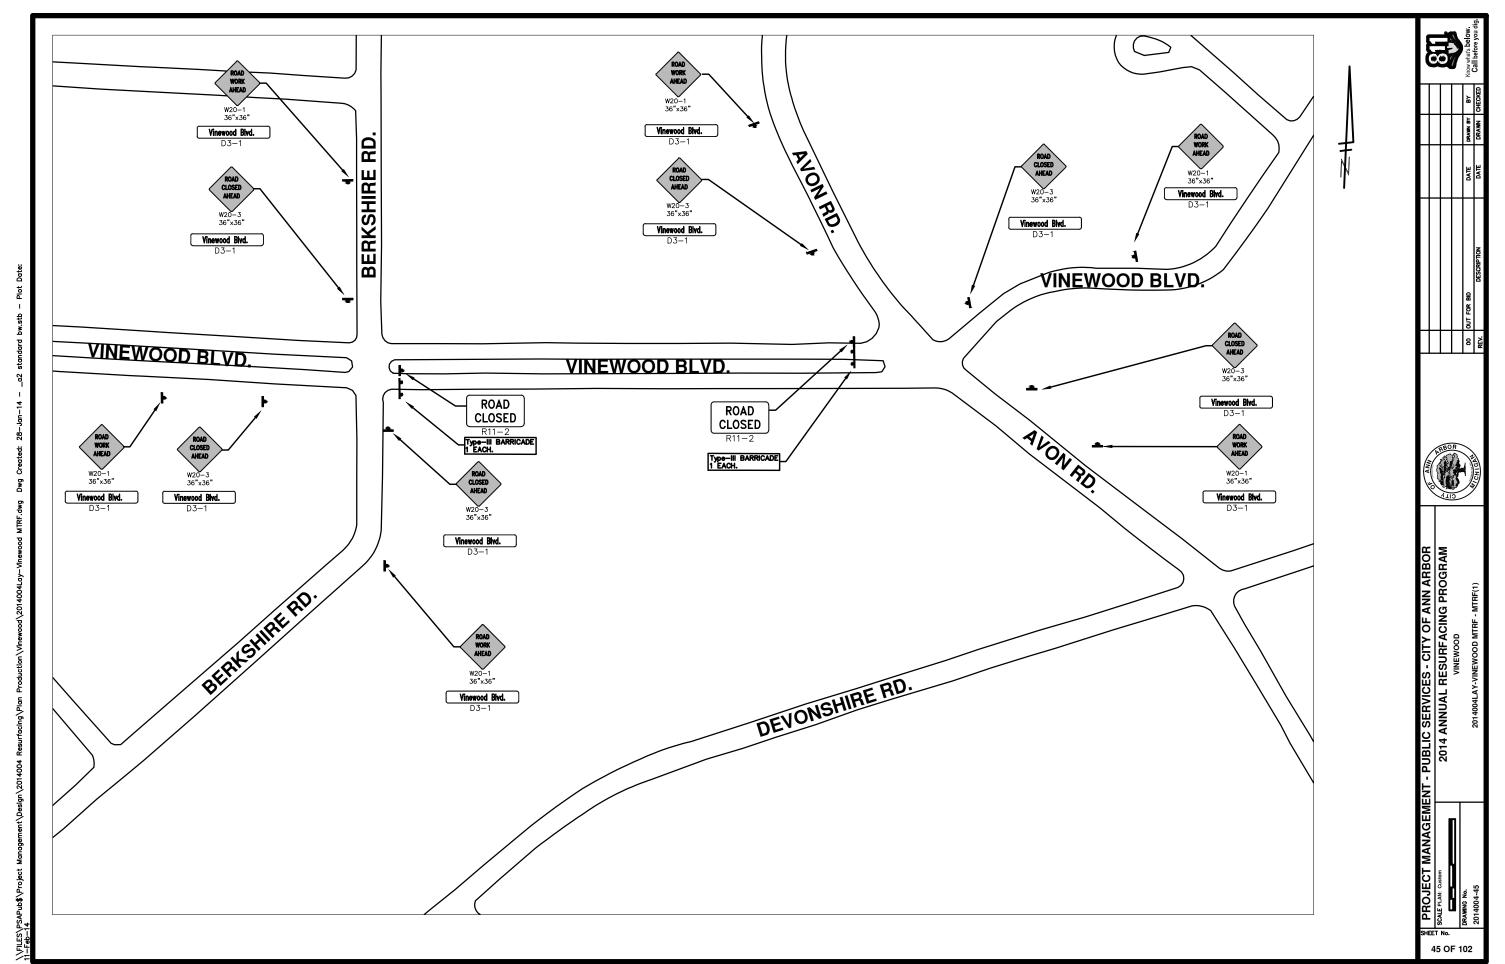

VINEWOOD BLVD.

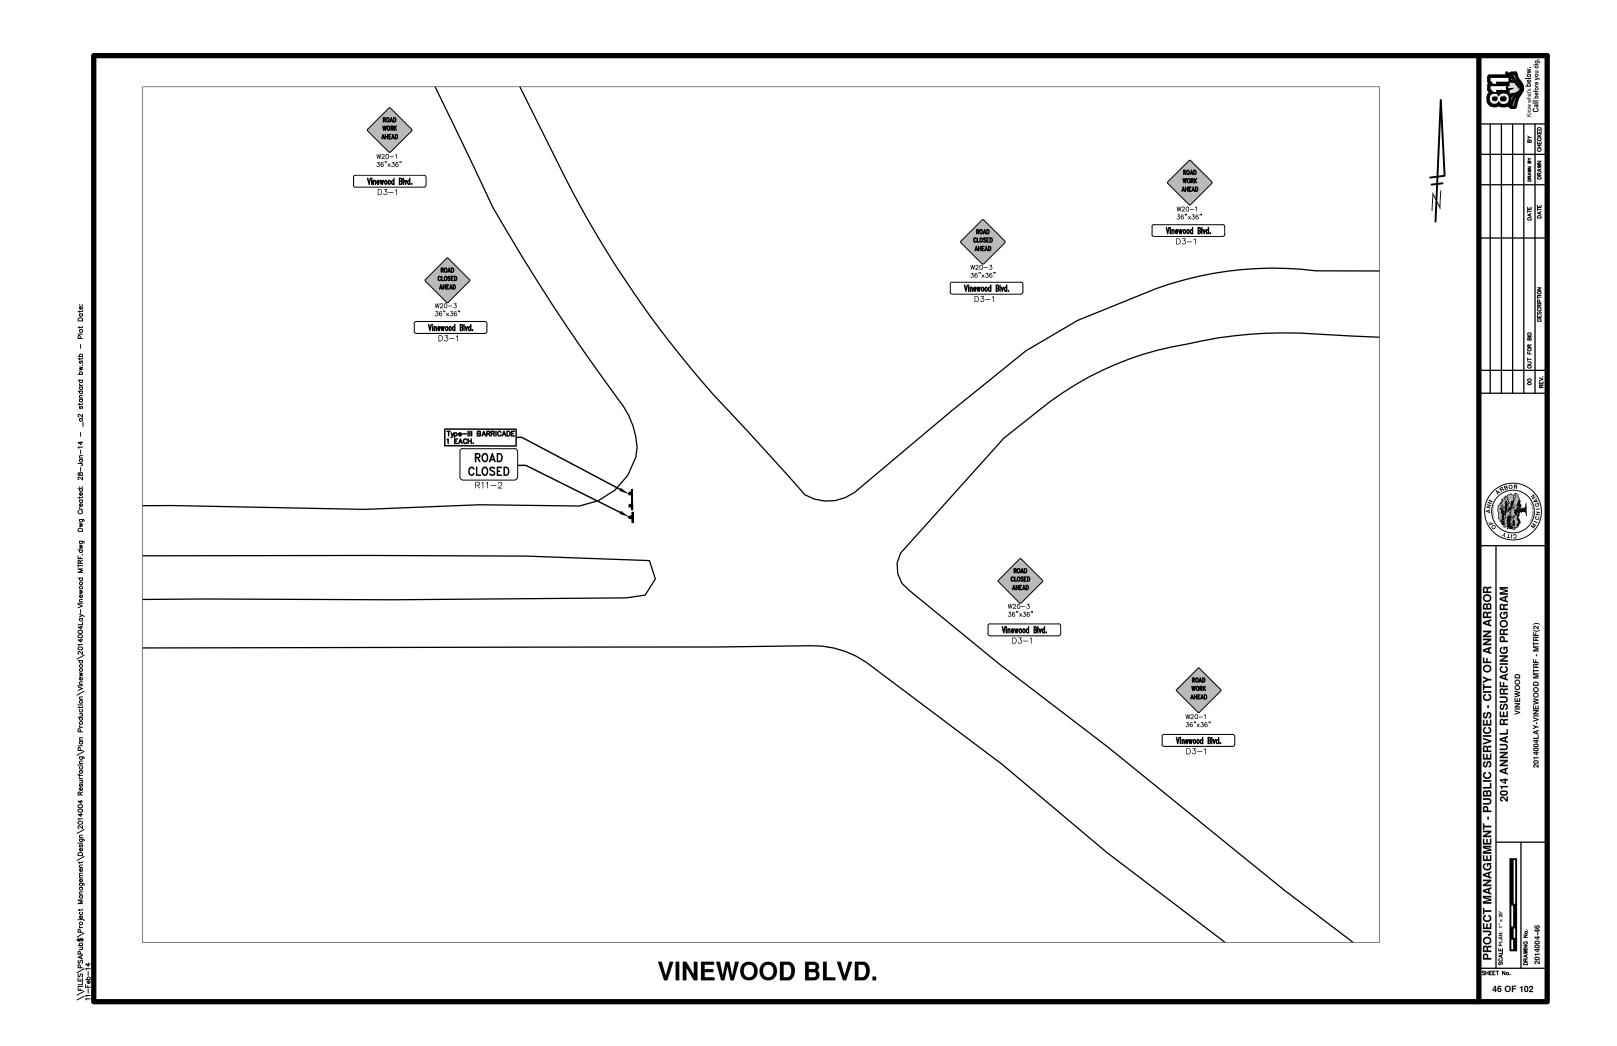



CITY OF ANN ARBOR PROJECT MANAGEMENT 2014 ANNUAL RESURFACING PROGRAM PROJECT LOCATION: STEEPLECHASE

FILE No. 2014004

DRIVE

QUANTITIES				
ITEM#	DESCRIPTION	Units	Total	
207	Cold Milling Pavement	Tons	800	
209	Subgrade Undercutting - Type II	C.Y.	470	
222	HMA Pavement Leveling, Regular	Tons	480	
223	HMA Pavement Wearing, Regular	Tons	320	
230	Rem. Curb & Gutter, Any Type	L.F.	1400	
232	Rem. Conc. Sidewalk & Drive - Any Thickness	S.F.	150	
237	Conc. Curb & Gutter - Any Type - Fixed Form	L.F.	1400	
241	6" Drive, Sidewalk or Ramp	S.F.	200	
250	2' Dia. Structure	Each	3	
252	Reconstruct Structure	Each	1	
254	Lower Structure Cover	Each	10	
255	Lower Mon. / Gate Valve Box	Each	1	
256	Adj. Structure Covers	Each	10	
257	Adj. Curb Inlet Structure Cover	Each	5	
258	Adj. Monument or Gate Valve Box	Each	1	
259	Manhole Flange & Cover (MDOT Type A)	Each	10	
260	Inlet Structure Cover (MDOT Type K)	Each	1	
264	12" Sewer Trench Detail I, Modified	L.F.	30	
267	6" Wrapped Underdrain	L.F.	500	
271	21AA Limestone - C.I.P.	C.Y.	470	
282	Plastic Drum - Lighted - Furn. & Operate	Each	50	
283	Barricade Type III - Furn. & Operate	Each	2	
284	Temporary Signs - Type B	S.F.	120	
285	No Parking Sign	Each	23	
596	Rec. Polyurea Pvmt. Mkg., 6" White or Yellow	L.F.	150	

TRAFFIC CONTROL & SIGN LEGEND					
QTY.	TYPE	DESCRIPTION			
3	W20-1	"ROAD WORK AHEAD"			
3	W20-5	"Rt. Lane Closed Ahead			
6	D3-1	CONVENTIONAL GUIDE			
2	TYPE III	TYPE III LIGHTED BARRICADE			
50	TYPE II	TYPE II LIGHTED BARRICADE (DRUM)			

CONSTRUCTION METHOD AND SEQUENCING

- The work to be completed on this street shall include, but not be limited to the following items. The order of construction shall be as given unless otherwise authorized or directed by the engineer.
- IMPLEMENT TRAFFIC MAINTENANCE, AND SOIL EROSION CONTROLS IN ACCORDANCE WITH THE PLANS, AND AS DIRECTED BY THE ENGINEER.
- 3. INSTALL ANY PROPOSED STORM SEWER, AND UNDERDRAIN AS SHOWN ON THE PLANS, AND AS DIRECTED BY THE ENGINEER.
- 4. LOWER ALL STRUCTURES COVERS, INCLUDING VALVE AND MONUMENT BOXES.
- PERFORM ALL CONCRETE WORK, INCLUDING RESTORATION, IN ACCORDANCE WITH THE PLANS, AND AS DIRECTED BY THE ENGINEER.
- MILL 5 INCHES OF BITUMINOUS MATERIAL FROM EXISTING ROADWAY. THIS MAY INCLUDE GRANULAR ROAD BASE MATERIAL. DEPTH TO BE DETERMINED BY THE ENGINEER. PROOF ROLL WITH FULL TRUCK.
- 7. PERFORM UNDERCUT AND/OR BASE REPAIRS AS DIRECTED BY THE ENGINEER.
- GRADE, SHAPE, AND RE—COMPACT THE EXISTING ROAD BASE AS REQUIRED, AND AS DIRECTED BY THE ENGINEER.
- PAVE 3 INCHES OF THE BITUMINOUS MIX AS SPECIFIED OR DIRECTED, AS THE LEVELING COURSE, IN ONE LIFT.
- 10. ADJUST ALL STRUCTURE COVERS, MONUMENT BOXES, AND VALVE BOXES TO THEIR FINISHED ELEVATIONS.
- PAVE 2 INCHES OF THE BITUMINOUS MIX AS SPECIFIED OR DIRECTED, AS THE WEARING COURSE, IN ONE LIFT.
- 12. COMPLETE ALL PAVEMENT MARKINGS IN ACCORDANCE WITH THE PLANS, AND AS DIRECTED BY THE ENGINEER.
- 13. COMPLETE ALL MISCELLANEOUS CONSTRUCTION INCLUDING ALL CLEAN-UP AND FINAL RESTORATION.
- 14. COMPLETE ALL PAVEMENT MARKINGS AS PER PLAN AND AS DIRECTED BY THE ENGINEER.
- 15. REMOVE ALL TRAFFIC CONTROL DEVICES. REMOVE MISS DIG FLAGS.

NOTES:

THE CONSTRUCTION COVERED BY THESE PLANS SHALL CONFORM TO THE 1994 EDITION OF THE CITY OF ANN ABOOR PUBLIC SERVICES DEPARTMENT STANDARD SPECIFICATIONS AND IT'S DETAILS WHICH ARE INCLUDED BY REFERENCE. THE OMISSION OF ANY CURRENT STANDARD DETAIL DOES NOT RELIEVE THE CONTRACTOR FROM THIS REQUIREMENT. THE WORK SHALL BE PERFORMED IN COMPLETE CONFORMANCE WITH THE CURRENT PUBLIC SERVICES STANDARD SPECIFICATIONS AND DETAILS.

FOR PROTECTION OF UNDERGROUND UTILITIES AND IN CONFORMANCE WITH PUBLIC ACT 53, THE CONTRACTOR SHALL CALL 811 OR 1-800-482-7171 A MINIMUM OF THREE FULL WORKING DAYS, EXCLUDING SATURDAYS, SUNDAYS, AND HOLIDAYS PRIOR TO BEGINNING EACH EXCAVATION IN AREAS WHERE PUBLIC UTILITIES HAVE NOT BEEN PREVIOUSLY LOCATED. MEMBERS WILL THUS BE ROUTINELY NOTHERD. THIS DOES NOT RELIEVE THE CONTRACTOR OF THE RESPONSIBILITY OF NOTIFYING UTILITY OWNERS WHO MAY NOT BE A PART OF THE "MISS DIG" ALERT SYSTEM.

THE UNDERGROUND LOCATIONS SHOWN FOR NATURAL GAS (GAS), TELEPHONE (TEL), ELECTRICAL POWER (PWR), CABLE TV (CTV) AND FIBER OPTIC LINES (FIBER) ARE APPROXIMATE. THE CITY OF ANN ARBOR ASSUMES NO RESPONSIBILITY FOR THEIR ACCURATE REPRESENTATION IN THIS DRAWING, MISS DIG MUST BE CONTACTED PRIOR TO CONSTRUCTION TO LOCATE THESE UTILITIES.



PROJECT MANAGEMENT SERVICE UNIT


CITY OF ANN ARBOR PUBLIC SERVICE 301 EAST HURON STREET, P.O. BOX 8647 ANN ARBOR, MICHIGAN 48107-8647 734-794-6410 www.a2gov.org Know what's

2014 RESURFACING

PROJECT DESCRIPTION

MNG No.

47 TO 102

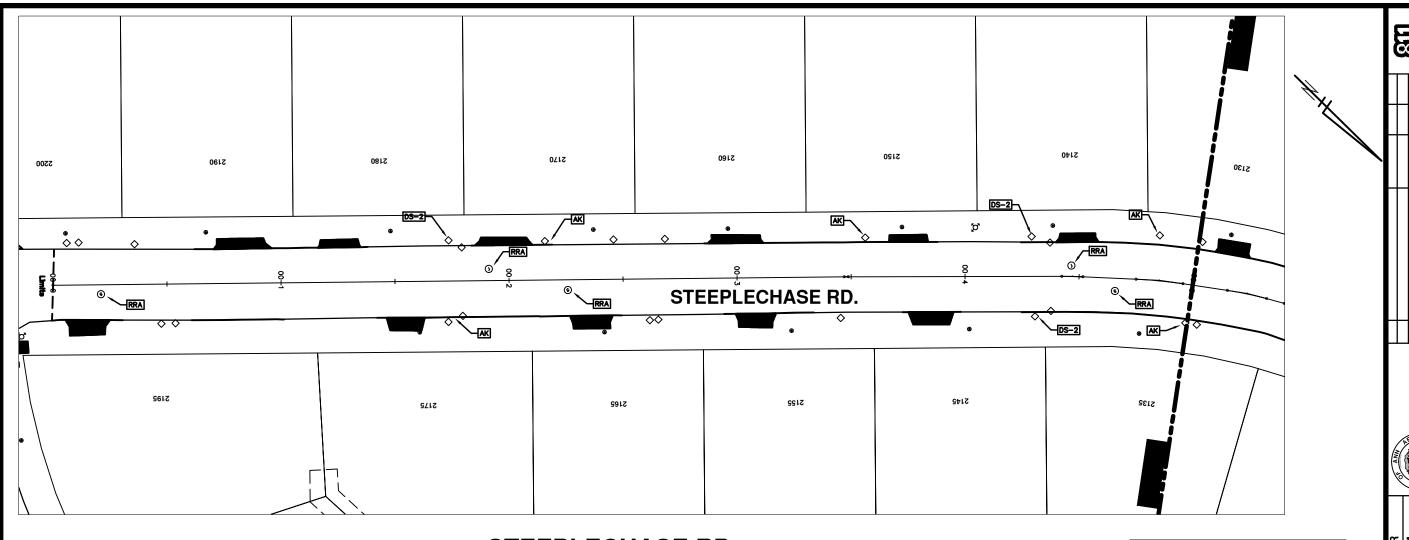


STEEPLECHASE RD.

	CONSTRUCTION KEY
KEY	DESCRIPTION
C/G	REMOVE AND REPLACE CURB AND GUTTER
C/GHE	REMOVE CURB AND GUTTER, REPLACE WITH CONCRETE CURB AND GUTTER H.E.
C4HE	REMOVE EXISTING RAMP OR SIDEWALK. REPLACE WITH 4" SIDEWALK OR TYPE 1 SIDEWALK RAMP, H.E.
CR	REMOVE SIDEWALK, DRIVE OR RAMP.
AA	ADJUST MDOT TYPE A CASTINGS.
AB	ADJUST GATE VALVE BOX OR MONUMENT BOX.
ADST	ADDITIONAL DEPTH STRUCTURE REPAIR.
RRA	REMOVE AND REPLACE MDOT TYPE A CASTING ADJUST TO FINISH GRADE.
CPRHE	CONCRETE PAVEMENT REPAIR, H.E.
DS	CONSTRUCT 2, 3 OR 4' DIAM. DRAINAGE STRUCTURE.
PT	POINT STRUCTURE.
C4	REMOVE EXISTING RAMP OR SIDEWALK, REPLACE WITH 4" SIDEWAL OR RAMP.
C6	REMOVE EXISTING RAMP OR SIDEWALK, REPLACE WITH 6" SIDEWAL OR RAMP
C8	PLACE 8" SIDEWALK OR RAMP ONLY
C HE	REMOVE EXISTING DRIVE APPROACH, RAMP OR SIDEWALK. REPLAC WITH 6" OR 8" APPROACH, RAMP,OR SIDEWALK, H.E.
CP	PLACE 4" SIDEWALK OR RAMP.
AK	ADJUST MDOT TYPE K CASTING.
TYPE II	MDOT TYPE II BARRICADE.
TYPE III	MDOT TYPE III BARRICADE.
RRK	REMOVE AND REPLACE MDOT TYPE K CASTING. ADJUST TO FINISH GRADE.
RS	RECONSTRUCT STRUCTURE.
RCP	REMOVE CONC. PAVEMENT - ANY THICKNESS
RCW	RAISED CROSSWALK

	LEGEND
SYMBOL	DESCRIPTION
•	EXISTING SANITARY SEWER MANHOLE
•	EXISTING STORM SEWER MANHOLE
•	EXISTING WATER MAIN VALVE IN WELL
+	WATER MAIN GATE VALVE IN BOX
Ŷ	FIRE HYDRANT
•	MICHOON GAS CO. VALVE BOX/MELL
•	AMERITECH TELEPHONE VAULT
•	ELECTRIC MANHOLE
•	SOIL BORING
0	EXISTING STORM SEWER INLET
•	MONUMENT BOX
	REMOVE AND REPLACE CONC. SIDEWALK
774.	PLACE CONCRETE SIDEWALK
	REMOVE & REPLACE CONC. CURB & GUTTER
	CONSTRUCTION LIMITS
	6" WRAPPED UNDERDRAIN
	REMOVE CONCRETE SIDEWALK
	SUBGRADE UNDERCUT
PILE AND IT WE CLICK AND PICE	A REPORTED FILE MANE CHANGES TO THE REPORTED LL UPDATE ALL SHEETS. TO MANE A CHANGE MONT KNOWN CONT. AND SAVE.


PROJECT MANAGE
scale plan: 1"= 20'

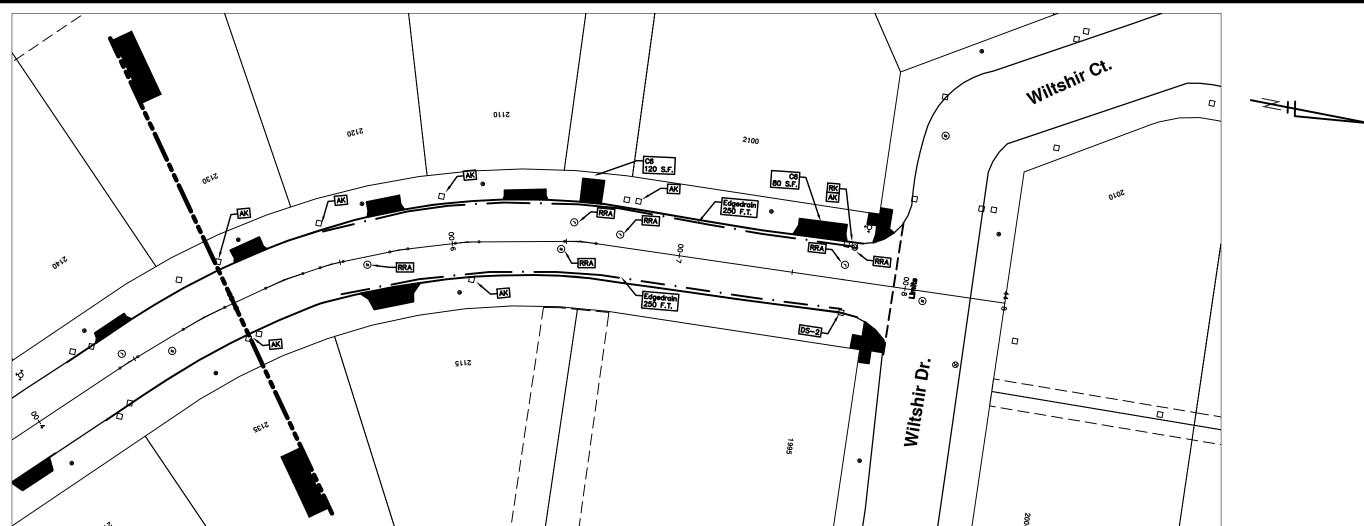

STEEPLECHASE RD

	CONSTRUCTION KEY		
KEY	DESCRIPTION		
C/G	REMOVE AND REPLACE CURB AND GUTTER		
C/GHE	REMOVE CURB AND GUTTER, REPLACE WITH CONCRETE CURB AND GUTTER H.E.		
C4HE	REMOVE EXISTING RAMP OR SIDEWALK. REPLACE WITH 4" SIDEWALK OR TYPE 1 SIDEWALK RAMP,H.E.		
CR	REMOVE SIDEWALK, DRIVE OR RAMP.		
AA	ADJUST MDOT TYPE A CASTINGS.		
AB	ADJUST GATE VALVE BOX OR MONUMENT BOX.		
ADST	ADDITIONAL DEPTH STRUCTURE REPAIR.		
RRA	REMOVE AND REPLACE MDOT TYPE A CASTING ADJUST TO FINISH GRADE.		
CPRHE	CONCRETE PAVEMENT REPAIR, H.E.		
DS	CONSTRUCT 2, 3 OR 4' DIAM. DRAINAGE STRUCTURE.		
PT	POINT STRUCTURE.		
C4	REMOVE EXISTING RAMP OR SIDEWALK, REPLACE WITH 4" SIDEWAL OR RAMP.		
C6	REMOVE EXISTING RAMP OR SIDEWALK, REPLACE WITH 6" SIDEWAL OR RAMP		
СВ	PLACE 8" SIDEWALK OR RAMP ONLY		
C HE	REMOVE EXISTING DRIVE APPROACH, RAMP OR SIDEWALK. REPLACI WITH 6" OR 8" APPROACH, RAMP,OR SIDEWALK, H.E.		
CP	PLACE 4" SIDEWALK OR RAMP.		
AK	ADJUST MDOT TYPE K CASTING.		
TYPE II	MDOT TYPE II BARRICADE.		
TYPE III	MDOT TYPE III BARRICADE.		
RRK	REMOVE AND REPLACE MDOT TYPE K CASTING. ADJUST TO FINISH GRADE.		
RS	RECONSTRUCT STRUCTURE.		
RCP	REMOVE CONC. PAVEMENT - ANY THICKNESS		
RCW	RAISED CROSSWALK		

	LEGEND
SYMBOL	DESCRIPTION
•	EXISTING SANITARY SEWER MANHOLE
۰	EXISTING STORM SEWER MANHOLE
•	EXISTING WATER MAIN VALVE IN WELL
+	WATER MAIN GATE VALVE IN BOX
ιδι	FIRE HYDRANT
•	MICHCON GAS CO. VALVE BOX/NELL
•	AMERITECH TELEPHONE VAULT
•	ELECTRIC MANHOLE
•	SOIL BORING
0	EXISTING STORM SEWER INLET
•	MONUMENT BOX
	REMOVE AND REPLACE CONG. SIDEWALK
777	PLACE CONCRETE SIDEWALK
_	REMOVE & REPLACE CONG. CURB & GUTTER
	CONSTRUCTION LIMITS
	6" WRAPPED UNDERDRAIN
	REMOVE CONCRETE SIDEWALK
	SUBGRADE UNDERCUT
FILE AND IT W	S A REFERENCE FILE. MAKE CHANGES TO THE REFERENCE IL UPDATE ALL SHEETS. TO MAKE A CHANCE MIGHT K OPEN WIEF, MAKE YOUR EDIT AND SAVE.

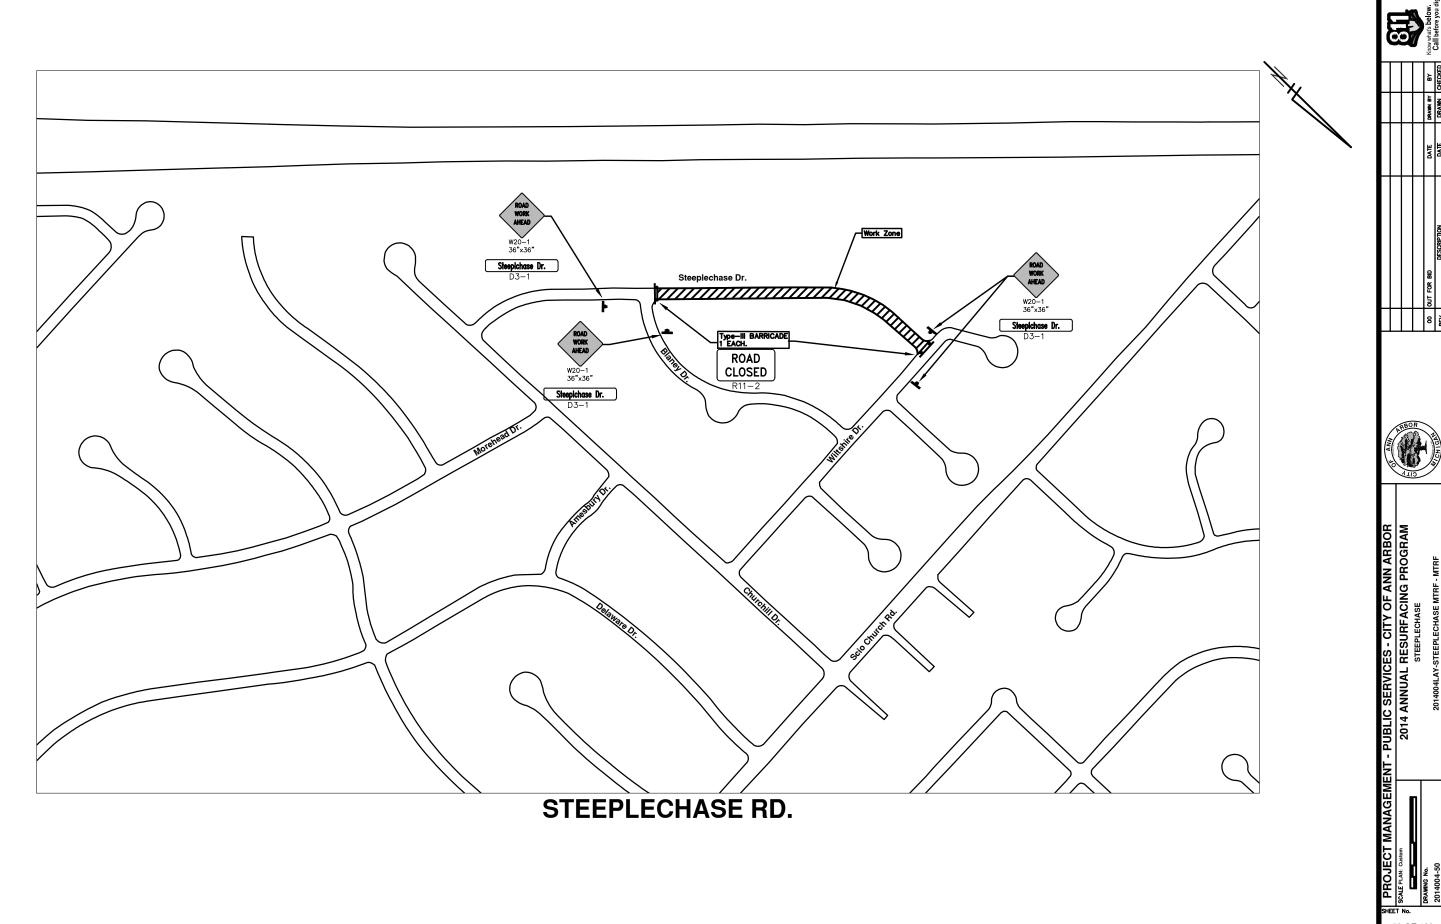



CITY OF ANN ARBOR PROJECT MANAGEMENT 2014 ANNUAL RESURFACING PROGRAM PROJECT LOCATION: ST AUBIN AVENUE

FILE No. 2014004

	QUANTITIES		
ITEM#	DESCRIPTION	Units	Total
207	Cold Milling Pavement	Tons	1100
208	Cold Milling Pavement, Curb Reveal	Tons	380
222	HMA Pavement Leveling, Regular	Tons	660
223	HMA Pavement Wearing, Regular	Tons	440
230	Rem. Curb & Gutter, Any Type	L.F.	200
232	Rem. Conc. Sidewalk & Drive - Any Thickness	S.F.	760
237	Conc. Curb & Gutter - Any Type - Fixed Form	L.F.	100
238	Conc. Curb & Gutter - Any Type - High Early	L.F.	100
240	4" Sidewalk Or Ramp	S.F.	380
241	6" Drive, Sidewalk or Ramp	S.F.	270
242	6" Drive, Sidewalk or Ramp - High Early	S.F.	120
245	Detectable Warning, Cast in Place	S.F.	20
250	2' Dia. Structure	Each	3
254	Lower Structure Cover	Each	4
255	Lwr. Mon. / Gate Valve Box	Each	1
256	Adj. Structure Cover	Each	4
257	Adj. Curb Inlet Structure Cover	Each	6
258	Adj. Monument or Gate Valve Box	Each	1
259	Manhole Flange & Cover (MDOT Type A)	Each	2
264	12" Sewer, Trench Detail I, Modified	L.F.	15
268	Flowable Fill	C.Y.	4
271	21AA Limestone - C.I.P.	C.Y.	380
281	Arrow Panel - Furn. & Operate	Each	1
282	Plastic Drum - Lighted - Furn. & Operate	Each	50
283	Barricade Type III - Furn. & Operate	Each	2
284	Temp Sign - Type B	S.F.	136
285	No Parking Sign	Each	29
594	4" Blue Thermo. Handicapped spaces	L.F.	72
594	Rec. Polyurea Pvmt. Mkg., 4" White	L.F.	1656
598	Rec. Polyurea Pvmt. Mkg., Symbol or Legend	Each	3

TRAFFIC CONTROL & SIGN LEGEND		
QTY.	TYPE	DESCRIPTION
3	W20-1	"ROAD WORK AHEAD"
4	W20-3	"ROAD CLOSED AHEAD"
10	D3-1	CONVENTIONAL GUIDE
1	TYPE C	LIGHTED ARROW, TYPE C
2	TYPE III	TYPE III LIGHTED BARRICADE
50	TYPE II	TYPE II LIGHTED BARRICADE (DRUM)

CONSTRUCTION METHOD AND SEQUENCING

- 1. THE WORK TO BE COMPLETED ON THIS STREET SHALL INCLUDE, BUT NOT BE LIMITED TO THE FOLLOWING ITEMS. THE ORDER OF CONSTRUCTION SHALL BE AS GIVEN UNLESS OTHERWISE AUTHORIZED OR DIRECTED BY THE ENGINEER.
- IMPLEMENT TRAFFIC MAINTENANCE, AND SOIL EROSION CONTROLS IN ACCORDANCE WITH THE PLANS, AND AS DIRECTED BY THE ENGINEER.
- 3. INSTALL ANY PROPOSED STORM SEWER, AND UNDERDRAIN AS SHOWN ON THE PLANS, AND AS DIRECTED BY THE ENGINEER.
- 4. LOWER ALL STRUCTURE COVERS, INCLUDING VALVE AND MONUMENT BOXES.
- 5. PERFORM ALL CONCRETE WORK, INCLUDING RESTORATION, IN ACCORDANCE WITH THE PLANS, AND AS DIRECTED BY THE ENGINEER.
- 6. MILL 5 INCHES OF BITUMINOUS MATERIAL FROM EXISTING ROADWAY. THIS MAY INCLUDE GRANULAR ROAD BASE MATERIAL. DEPTH TO BE DETERMINED BY THE ENGINEER. PROOF ROLL WITH FULL TRUCK.
- 7. PERFORM UNDERCUTS AND/OR BASE REPAIRS AS DIRECTED BY THE ENGINEER.
- 8. GRADE, SHAPE, AND RE—COMPACT THE EXISTING ROAD BASE AS REQUIRED, AND AS DIRECTED BY THE ENGINEER.
- . PAVE 3 INCHES OF THE BITUMINOUS MIX AS SPECIFIED OR DIRECTED, AS THE LEVELING COURSE, IN ONE LIFT.
- 10. ADJUST ALL STRUCTURE COVERS, MONUMENT BOXES, AND VALVE BOXES TO THEIR FINISHED ELEVATIONS.
- PAVE 2 INCHES OF THE BITUMINOUS MIX AS SPECIFIED OR DIRECTED, AS THE WEARING COURSE, IN ONE LIFT.
- COMPLETE ALL PAVEMENT MARKINGS IN ACCORDANCE WITH THE PLANS, AND AS DIRECTED BY THE ENGINEER.
- 13. COMPLETE ALL MISCELLANEOUS CONSTRUCTION INCLUDING ALL CLEAN-UP AND FINAL RESTORATION.
- 14. REMOVE ALL TRAFFIC CONTROL DEVICES. REMOVE MISS DIG FLAGS.

NOTES:

THE CONSTRUCTION COVERED BY THESE PLANS SHALL CONFORM TO THE 1994 EDITION OF THE CITY OF ANN ARBOR PUBLIC SERVICES DEPARTMENT STANDARD SPECIFICATIONS AND IT'S DETAILS WHICH ARE INCLUDED BY REFERENCE. THE OMISSION OF ANY CURRENT STANDARD DETAIL DOES NOT RELIEVE THE CONTRACTOR FROM THIS REQUIREMENT. THE WORK SHALL BE PERFORMED IN COMPLETE CONFORMANCE WITH THE CURRENT PUBLIC SERVICES STANDARD SPECIFICATIONS AND DETAILS.

FOR PROTECTION OF UNDERGROUND UTILITIES AND IN CONFORMANCE WITH PUBLIC ACT 53, THE CONTRACTOR SHALL CALL 811 OR 1-800-482-7171 A MINIMUM OF THREE FULL WORKING DAYS, EXCLUDING SATURDAYS, SUNDAYS, AND HOLIDAYS PRIOR TO BEGINNING EACH EXCAVATION IN AREAS WHERE PUBLIC UTILITIES HAVE NOT BEEN PREVIOUSLY LOCATED. MEMBERS WILL THUS BE ROUTINELY NOTIFIED. THIS DOES NOT RELIEVE THE CONTRACTOR OF THE RESPONSIBILITY OF NOTIFYING UTILITY OWNERS WHO MAY NOT BE A PART OF THE "MISS DIG" ALERT SYSTEM.

THE UNDERGROUND LOCATIONS SHOWN FOR NATURAL GAS (GAS), TELEPHONE (TEL), ELECTRICAL POWER (PWR), CABLE TV (CTV) AND FIBER OPTIC LINES (FIBER) ARE APPROXIMATE. THE CITY OF ANN ARBOR ASSUMES NO RESPONSIBILITY FOR THEIR ACCURATE REPRESENTATION IN THIS DRAWING. MISS DIG MUST BE CONTACTED PRIOR TO CONSTRUCTION TO LOCATE THESE UTILITIES.


OF AMM OF

PROJECT MANAGEMENT SERVICE UNIT

CITY OF ANN ARBOR PUBLIC SERVICE 301 EAST HURON STREET, P.O. BOX 8647 ANN ARBOR, MICHIGAN 48107-8647 734-794-6410 www.a2gov.org MANAGEMENT - PUBLIC SERVICES - CITY OF ANN Inspect research

DRAWING No.


SHEET No. 51 TO 102

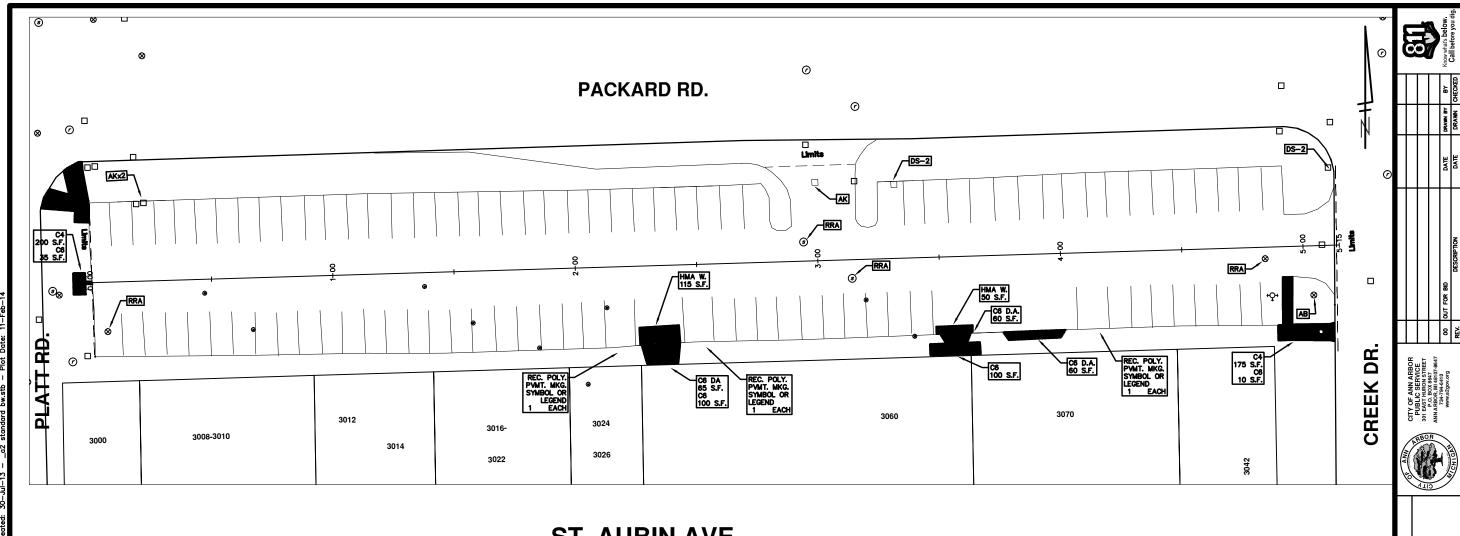

ST. AUBIN AVE.

	CONSTRUCTION KEY
KEY	DESCRIPTION
C/G	REMOVE AND REPLACE CURB AND GUTTER
C/GHE	REMOVE CURB AND GUTTER, REPLACE WITH CONCRETE CURB AND GUTTER H.E.
C4HE	REMOVE EXISTING RAMP OR SIDEWALK. REPLACE WITH 4" SIDEWALK OR TYPE 1 SIDEWALK RAMP,H.E.
CR	REMOVE SIDEWALK, DRIVE OR RAMP.
AA	ADJUST MDOT TYPE A CASTINGS.
AB	ADJUST GATE VALVE BOX OR MONUMENT BOX.
ADST	ADDITIONAL DEPTH STRUCTURE REPAIR.
RRA	REMOVE AND REPLACE MDOT TYPE A CASTING ADJUST TO FINISH GRADE.
CPRHE	CONCRETE PAVEMENT REPAIR, H.E.
DS	CONSTRUCT 2, 3 OR 4' DIAM. DRAINAGE STRUCTURE.
PT	POINT STRUCTURE.
C4	REMOVE EXISTING RAMP OR SIDEWALK, REPLACE WITH 4" SIDEWALK OR RAMP.
C6	REMOVE EXISTING RAMP OR SIDEWALK, REPLACE WITH 6" SIDEWALK OR RAMP
СВ	PLACE 8" SIDEWALK OR RAMP ONLY
СНЕ	REMOVE EXISTING DRIVE APPROACH, RAMP O⊕ SIDEWALK. REPLACE WITH 6" OR 8" APPROACH, RAMP, OR SIDEWALK, H.E.
CP	PLACE 4" SIDEWALK OR RAMP.
AK	ADJUST MDOT TYPE K CASTING.
TYPE II	MDOT TYPE II BARRICADE.
TYPE III	MDOT TYPE III BARRICADE.
RRK	REMOVE AND REPLACE MDOT TYPE K CASTING. ADJUST TO FINISH GRADE.
RS	RECONSTRUCT STRUCTURE.
RCP	REMOVE CONC. PAVEMENT - ANY THICKNESS
RCW	RAISED CROSSWALK

		,	۳	Σ	
	LEGEND		မ္က	₹	
SYMBOL	DESCRIPTION		찁	ਯੁ	
9	EXISTING SANITARY SEWER MANHOLE	1	۲.	2	
0	EXISTING STORM SEWER MANHOLE		ź۱	교	
8	EXISTING WATER MAIN VALVE IN WELL			9	
+	WATER MAIN GATE VALVE IN BOX		ō	ᅙ	
+Ç+	FIRE HYDRANT		ا≾	¥ ¥	:
9	MICHCON GAS CO. VALVE BOX/WELL		CITY OF ANN ARBOR	SURF/	į
Θ	AMERITECH TELEPHONE VAULT		ايٰ	ES	5
	ELECTRIC MANHOLE		ΫІ	쮼	
•	SOIL BORING		۶۱	¥	
	EXISTING STORM SEWER INLET		<u></u>	₹	
•	MONUMENT BOX		8	Ę	
	REMOVE AND REPLACE CONC. SIDEWALK		임	2014 ANNUAL RESURFACING PROGRAM STAIIBIN	
	PLACE CONCRETE SIDEWALK		B	20	
_	REMOVE & REPLACE CONC. CURB & GUTTER		믺		
	CONSTRUCTION LIMITS		닐		
	6" WRAPPED UNDERDRAIN		氲		_
	REMOVE CONCRETE SIDEWALK		譶	_	1
	SUBGRADE UNDERCUT		<u>ত</u>		l
			ANAGEMENT - PUBLIC SERVICES -		l

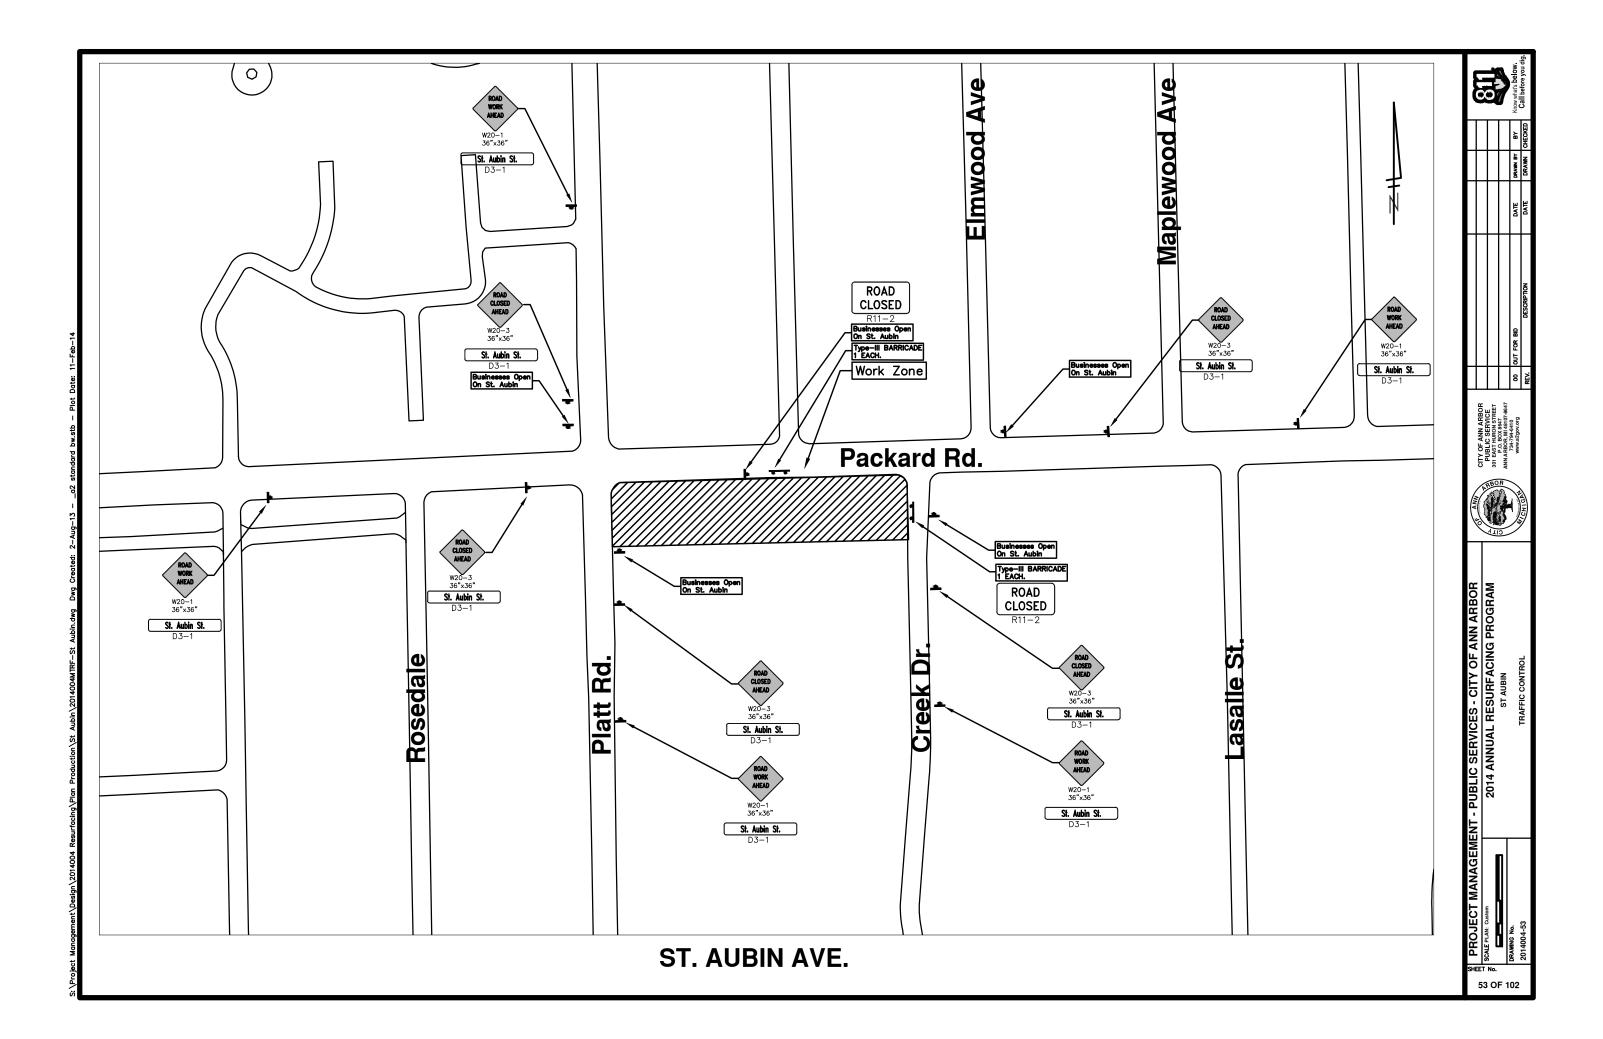



CITY OF ANN ARBOR PROJECT MANAGEMENT 2014 ANNUAL RESURFACING **PROGRAM** PROJECT LOCATION: NEWPORT ROAD

FILE No. 2014004

	QUANTITIES		
ITEM#	DESCRIPTION	Units	Total
207	Cold Milling Pavement	Tons	2020
209	Subgrade Undercutting Type II	C.Y.	970
221	HMA Finish Wedging	Tons	29
226	HMA Pavement Wearing - 5E3	Tons	870
227	HMA Pavement Base or Leveling - 4E3	Tons	1160
228	Bituminus Curb, Remove	L.F.	4000
229	Bituminus Curb	L.F.	4000
230	Rem. Curb & Gutter, Any Type	L.F.	500
232	Rem. Conc. Sidewalk & Drive - Any Thickness	S.F.	760
237	Conc. Curb & Gutter - Any Type - Fixed Form	L.F.	1000
240	4" Sidewalk or Ramp	S.F.	6000
241	6" Drive, Sidewalk or Ramp	S.F.	500
245	Detectable Warning, Cast in Place	S.F.	60
246	Integral Sidewalk Ret. Wall (< 6")	S.F.	150
247	Integral Sidewalk Ret. Wall (6"-18")	S.F.	200
254	Lower Structure Cover	Each	14
256	Adjust Structure Cover	Each	14
257	Adjust Curb Inlet Structure Cover	Each	6
259	Manhole Flange & Cover (MDOT Type A)	Each	2
260	Inlet Structure Cover (MDOT Type K)	Each	1
271	21AA Limestone - C.I.P.	C.Y.	1000
282	Plastic Drum - Lighted - Furn. & Operate	Each	50
283	Barricade Type III - Furn. & Operate	Each	11
284	Temp Signs Type - B	S.F.	520
286	Sign, Portable Changeable Mess., Furn.	Each	2
295	Tubular Markers, 36", Furn & Oper.	Each	160
594	Rec. Polyurea Pvmt. Mkg., 4" White	L.F.	2500
595	Rec. Polyurea Pvmt. Mkg., 4" Yellow	L.F.	6800
596	Rec. Polyurea Pvmt. Mkg., 6" White or Yellow	L.F.	6800
597	Rec. Polyurea Pvmt. Mkg., 24" White	L.F.	100
598	Rec. Polyurea Pvmt. Mkg., Symbol or Legend	Each	2

TRAFFIC CONTROL & SIGN LEGEND		
Υ.	TYPE	DESCRIPTION
12	W20-1	"ROAD WORK AHEAD"
11	W20-5	"(RIGHT OR LEFT) LANE CLOSED AHEAD"
2	W1-6	ARROW BOARD
160		TUBULAR MARKERS 36"
33	D3-1	CONVENTIONAL GUIDE
8	TYPE III	TYPE III LIGHTED BARRICADE
100	TYPE II	TYPE II LIGHTED BARRICADE (DRUM)
2 160 33 8	W1-6 D3-1 TYPE III	ARROW BOARD TUBULAR MARKERS 36" CONVENTIONAL GUIDE TYPE III LIGHTED BARRICADE

CONSTRUCTION METHOD AND SEQUENCING

- THE WORK TO BE COMPLETED ON THIS STREET SHALL INCLUDE, BUT NOT BE LIMITED TO THE FOLLOWING ITEMS. THE ORDER OF CONSTRUCTION SHALL BE AS GIVEN UNLESS OTHERWISE AUTHORIZED OR DIRECTED BY THE ENGINEER.
- IMPLEMENT TRAFFIC MAINTENANCE, NO PARKING AND SOIL EROSION CONTROLS IN ACCORDANCE WITH THE PLANS, AND AS DIRECTED BY THE ENGINEER.
- INSTALL ANY PROPOSED STORM SEWER, AND UNDERDRAIN AS SHOWN ON THE PLANS, AND AS DIRECTED BY THE ENGINEER.
- 4. LOWER ALL STRUCTURE COVERS, INCLUDING VALVE AND MONUMENT BOXES.
- PERFORM ALL CONCRETE WORK, INCLUDING RESTORATION, IN ACCORDANCE WITH THE PLANS, AND AS DIRECTED BY THE ENGINEER.
- MILL 3 1/2 INCHES OF BITUMINOUS MATERIAL FROM EXISTING ROADWAY, DEPTH TO BE DETERMINED BY THE ENGINEER. PROOF ROLL WITH FULL TRUCK.
- 7. PERFORM UNDERCUTS AND/OR BASE REPAIRS AS DIRECTED BY THE ENGINEER.
- 8. GRADE, SHAPE, AND RE-COMPACT THE EXISTING ROAD BASE AS REQUIRED, AND AS DIRECTED BY THE
- 9. PAVE 2 INCHES OF THE BITUMINOUS MIX 4E3 AS SPECIFIED OR DIRECTED, AS THE LEVELING COURSE,
- 10. ADJUST ALL STRUCTURE COVERS, MONUMENT BOXES, AND VALVE BOXES TO THEIR FINISHED ELEVATIONS
- 11. PAVE 1-1/2 INCHES OF THE BITUMINOUS MIX 5E3 AS SPECIFIED OR DIRECTED, AS THE WEARING COURSE, IN ONE LIFT.
- 12. COMPLETE ALL PAVEMENT MARKINGS IN ACCORDANCE WITH THE PLANS, AND AS DIRECTED BY
- 13. COMPLETE ALL MISCELLANEOUS CONSTRUCTION INCLUDING ALL CLEAN-UP AND FINAL RESTORATION
- 14. REMOVE ALL TRAFFIC CONTROL DEVICES. REMOVE MISS DIG FLAGS.

NOTES:

THE CONSTRUCTION COVERED BY THESE PLANS SHALL CONFORM TO THE 1994 EDITION OF THE CITY OF ANN ARBOR PUBLIC SERVICES DEPARTMENT STANDARD SPECIFICATIONS AND IT'S DETAILS WHICH ARE INCLUDED BY REFERENCE. THE OMISSION OF ANY CURRENT STANDARD DETAIL DOES NOT RELIEVE THE CONTRACTOR FROM THIS REQUIREMENT. THE WORK SHALL BE PERFORMED IN COMPLETE CONFORMANCE WITH THE CURRENT PUBLIC SERVICES STANDARD SPECIFICATIONS AND DETAILS.


FOR PROTECTION OF UNDERGROUND UTILITIES AND IN CONFORMANCE WITPUBLIC ACT 53, THE CONTRACTOR SHALL CALL 811 OR 1-800-482-7171 A MINIMUM OF THREE FULL WORKING DAYS, EXCLUDING SATURDAYS, SUNDAYS, AND HOLIDAYS PRIOR TO BEGINNING EACH EXCAVATION IN AREAS WHERE PUBLIC UTILITIES HAVE NOT BEEN PREVIOUSLY LOCATED. MEMBERS WILL THUS BE ROUTINELY NOTIFIED. THIS DOES NOT RELIEVE THE CONTRACTOR OF THE RESPONSIBILITY OF NOTIFYING UTILITY OWNERS WHO MAY NOT BE A PART OF THE "MISS DIG" ALERT SYSTEM.


THE UNDERGROUND LOCATIONS SHOWN FOR NATURAL GAS (GAS), TELEPHONE (TEL), ELECTRICAL POWER (PWR), CABLE TV (CTV) AND FIBER OPTIC LINES (FIBER) ARE APPROXIMATE. THE CITY OF ANN ARBOR ASSUMES NO RESPONSIBILITY FOR THEIR ACCURATE REPRESENTATION IN THIS DRAWING. MISS DIG MUST BE CONTACTED PRIOR TO CONSTRUCTION TO LOCATE THESE UTILITIES.

PROJECT MANAGEMENT SERVICE UNIT

CITY OF ANN ARBOR PUBLIC SERVICE 301 EAST HURON STREET, P.O. BOX 8647 ANN ARBOR MICHIGAN 48107-8647 734-794-6410 www.a2gov.org

54 TO 102

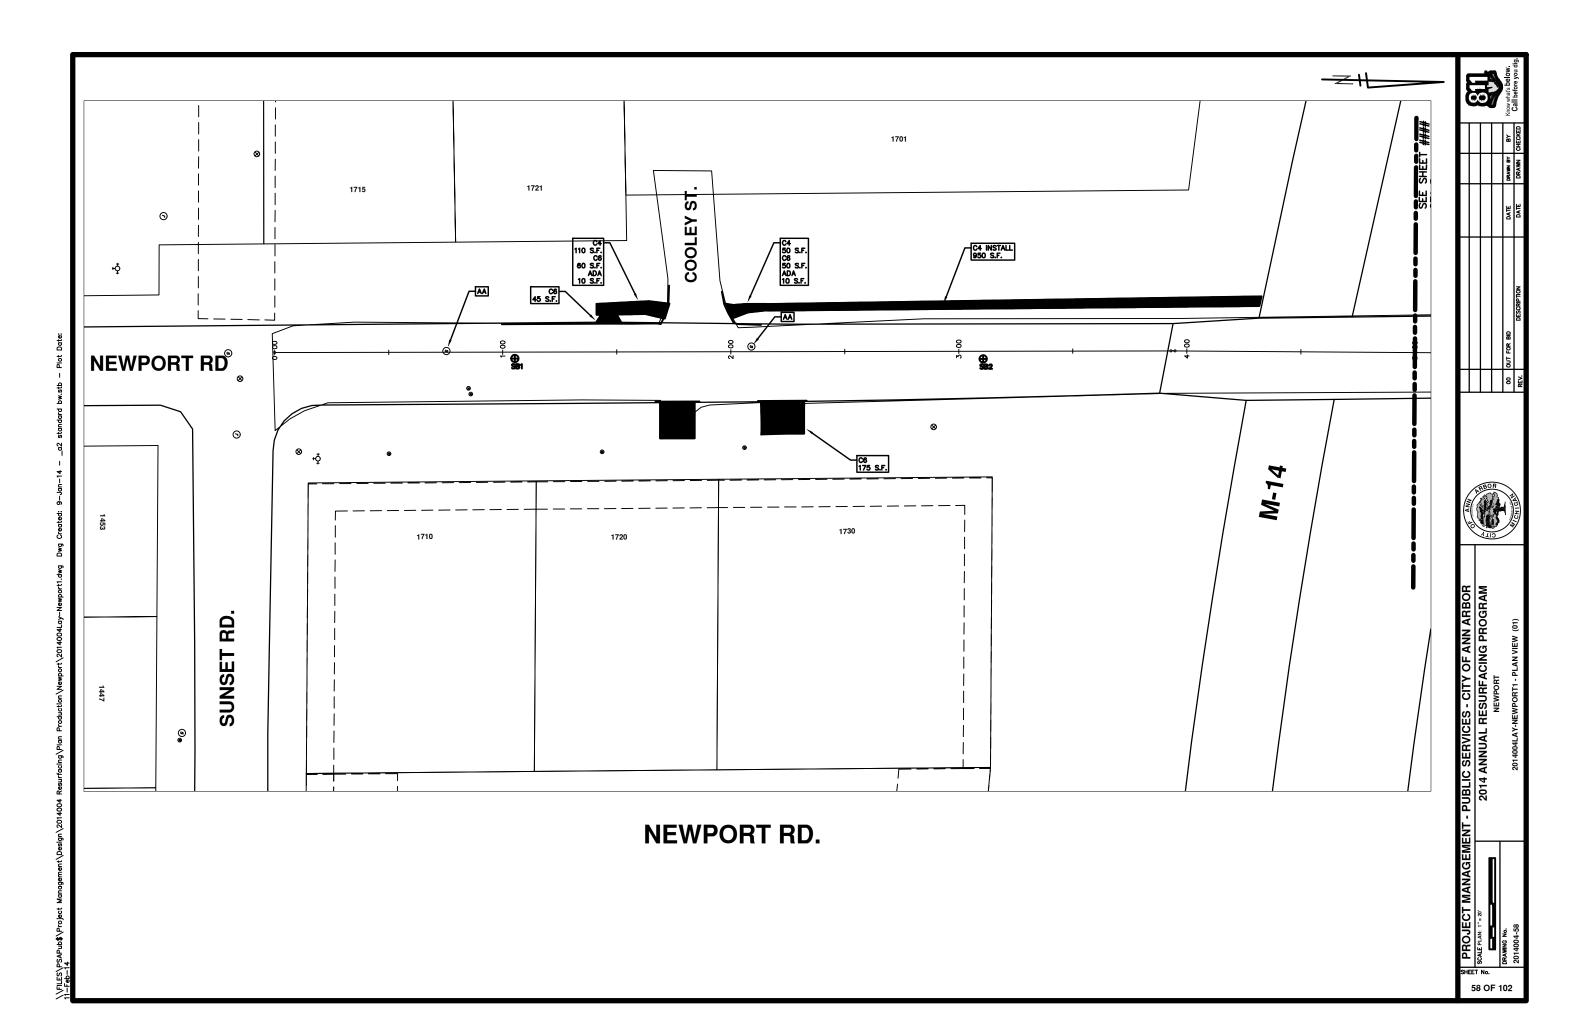


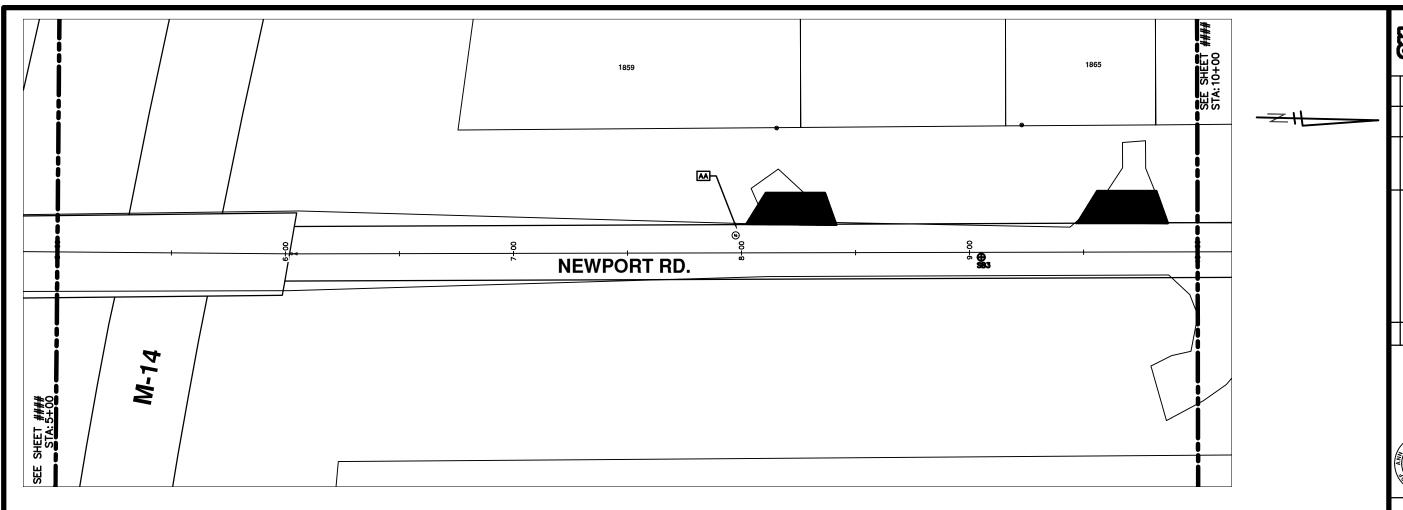

	CONSTRUCTION KEY
KEY	DESCRIPTION
C/G	REMOVE AND REPLACE CURB AND GUTTER
C/GHE	REMOVE CURB AND GUTTER, REPLACE WITH CONCRETE CURB ANI GUTTER H.E.
C4HE	REMOVE EXISTING RAMP OR SIDEWALK. REPLACE WITH 4" SIDEWALK OR TYPE 1 SIDEWALK RAMP, H.E.
CR	REMOVE SIDEWALK, DRIVE OR RAMP.
AA	ADJUST MDOT TYPE A CASTINGS.
AB	ADJUST GATE VALVE BOX OR MONUMENT BOX.
ADST	ADDITIONAL DEPTH STRUCTURE REPAIR.
RRA	REMOVE AND REPLACE MDOT TYPE A CASTING ADJUST TO FINISH GRADE.
CPRHE	CONCRETE PAVEMENT REPAIR, H.E.
DS	CONSTRUCT 2, 3 OR 4' DIAM. DRAINAGE STRUCTURE.
PT	POINT STRUCTURE.
C4	REMOVE EXISTING RAMP OR SIDEWALK, REPLACE WITH 4" SIDEWA OR RAMP.
C6	REMOVE EXISTING RAMP OR SIDEWALK, REPLACE WITH 6" SIDEWA OR RAMP
C8	PLACE 8" SIDEWALK OR RAMP ONLY
C HE	REMOVE EXISTING DRIVE APPROACH, RAMP OR SIDEWALK. REPLACE WITH 6" OR 8" APPROACH, RAMP, OR SIDEWALK, H.E.
CP	PLACE 4" SIDEWALK OR RAMP.
AK	ADJUST MDOT TYPE K CASTING.
TYPE II	MDOT TYPE II BARRICADE.
TYPE III	MDOT TYPE III BARRICADE.
RRK	REMOVE AND REPLACE MDOT TYPE K CASTING. ADJUST TO FINIS GRADE.
RS	RECONSTRUCT STRUCTURE.
RCP	REMOVE CONC. PAVEMENT - ANY THICKNESS


	LEGEND
SYMBOL	DESCRIPTION
•	EXISTING SANITARY SEWER MANHOLE
0	EXISTING STORM SEWER MANHOLE
•	EXISTING WATER MAIN VALVE IN WELL
+	WATER MAIN GATE VALVE IN BOX
-6∙	FIRE HYDRANT
•	MICHCON GAS CO. VALVE BOX/WELL
•	AMERITECH TELEPHONE VAULT
•	ELECTRIC MANHOLE
•	SOIL BORING
0	EXISTING STORM SEWER INLET
•	MONUMENT BOX
	REMOVE AND REPLACE CONC. SIDEWALK
	PLACE CONCRETE SIDEWALK
	REMOVE & REPLACE CONC. CURB & GUTTER
	CONSTRUCTION LIMITS
	6" WRAPPED UNDERDRAIN
	REMOVE CONCRETE SIDEWALK
	SUBGRADE UNDERCUT
FILE AND IT W	R A REPERENCE FILE. MANY CHANGES TO THE REPERENCE IL UPDATE ALL SHEETS. TO MANY A CHANGE MIGHT K OPEN XHEF, MANY YOUR EDIT AND SAVE.

PUBLIC SERVICES - CITY OF ANN ARBOR
2014 ANNUAL RESURFACING PROGRAM
NEWPORT

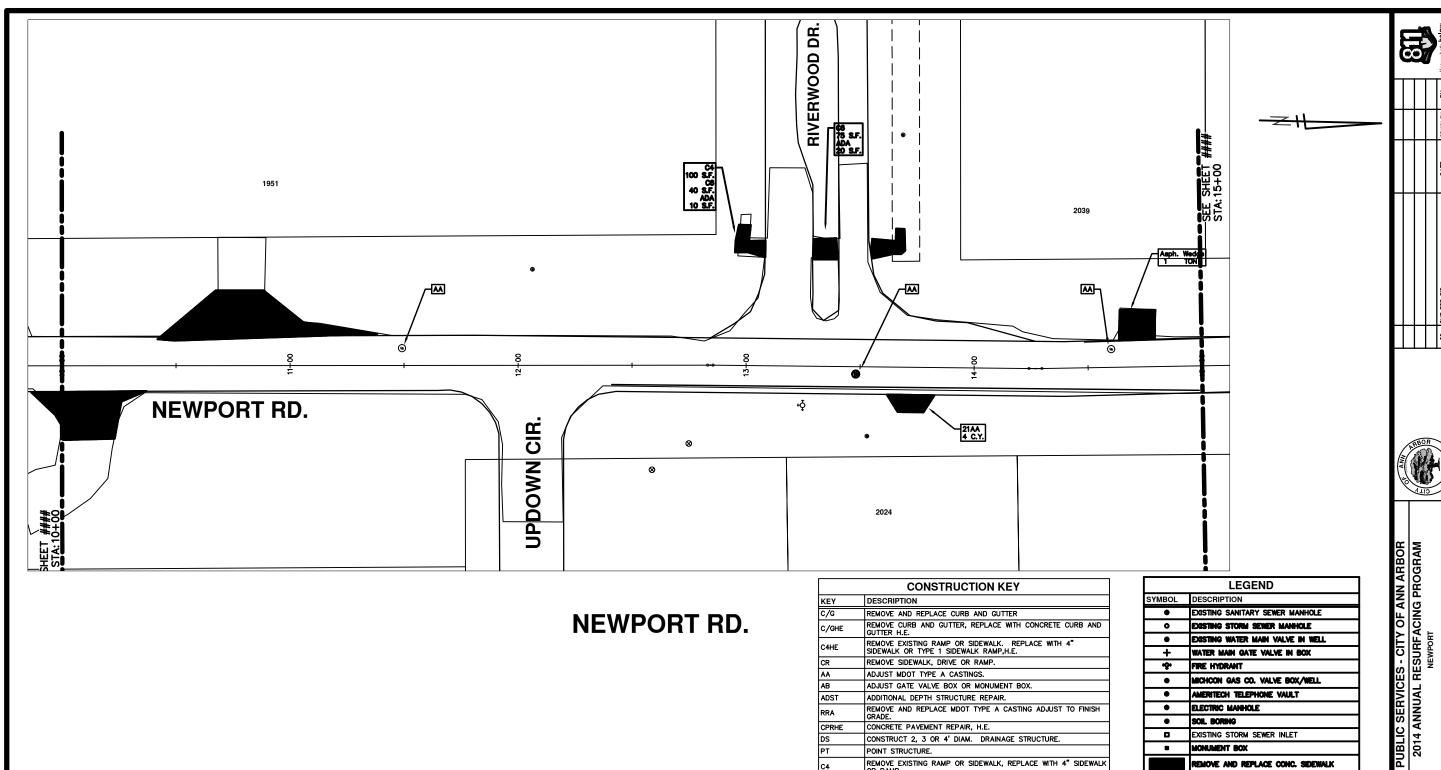

	CONSTRUCTION KEY
KEY	DESCRIPTION
C/G	REMOVE AND REPLACE CURB AND GUTTER
C/GHE	REMOVE CURB AND GUTTER, REPLACE WITH CONCRETE CURB AND GUTTER H.E.
C4HE	REMOVE EXISTING RAMP OR SIDEWALK. REPLACE WITH 4" SIDEWALK OR TYPE 1 SIDEWALK RAMP, H.E.
CR	REMOVE SIDEWALK, DRIVE OR RAMP.
AA	ADJUST MDOT TYPE A CASTINGS.
AB	ADJUST GATE VALVE BOX OR MONUMENT BOX.
ADST	ADDITIONAL DEPTH STRUCTURE REPAIR.
RRA	REMOVE AND REPLACE MDOT TYPE A CASTING ADJUST TO FINISH GRADE.
CPRHE	CONCRETE PAVEMENT REPAIR, H.E.
DS	CONSTRUCT 2, 3 OR 4' DIAM. DRAINAGE STRUCTURE.
PT	POINT STRUCTURE.
C4	REMOVE EXISTING RAMP OR SIDEWALK, REPLACE WITH 4" SIDEWALK OR RAMP.
C6	REMOVE EXISTING RAMP OR SIDEWALK, REPLACE WITH 6" SIDEWALK OR RAMP
С8	PLACE 8" SIDEWALK OR RAMP ONLY
C HE	REMOVE EXISTING DRIVE APPROACH, RAMP OR SIDEWALK. REPLACE WITH 6" OR 8" APPROACH, RAMP,OR SIDEWALK, H.E.
CP	PLACE 4" SIDEWALK OR RAMP.
AK	ADJUST MDOT TYPE K CASTING.
TYPE II	MDOT TYPE II BARRICADE.
TYPE III	MDOT TYPE III BARRICADE.
RRK	REMOVE AND REPLACE MDOT TYPE K CASTING. ADJUST TO FINISH GRADE.
RS	RECONSTRUCT STRUCTURE.
RCP	REMOVE CONC. PAVEMENT - ANY THICKNESS
RCW	RAISED CROSSWALK


	LEGEND
SYMBOL	DESCRIPTION
•	EXISTING SANITARY SEWER MANHOLE
•	EXISTING STORM SEWER MANHOLE
•	EXISTING WATER MAIN VALVE IN WELL
+	WATER MAIN GATE VALVE IN BOX
•6•	FIRE HYDRANT
•	MICHOON GAS CO. VALVE BOX/WELL
•	AMERITECH TELEPHONE VAULT
•	ELECTRIC MANHOLE
•	SOIL BORING
0	EXISTING STORM SEWER INLET
•	MONUMENT BOX
	REMOVE AND REPLACE CONG. SIDEWALK
777	PLACE CONCRETE SIDEWALK
	REMOVE & REPLACE CONC. CURB & GUTTER
	CONSTRUCTION LIMITS
	6" WRAPPED UNDERDRAIN
	REMOVE CONCRETE SIDEWALK
	SUBGRADE UNDERCUT
FILE AND IT WE CLICK AND PIC	B A REFERENCE FILE. MAKE CHANGES TO THE REFERENCE IL UPDATE ALL SHEETS. TO MAKE A CHANGE MIGHT K OPEN XMEF, MAKE YOUR EDIT AND SAVE.

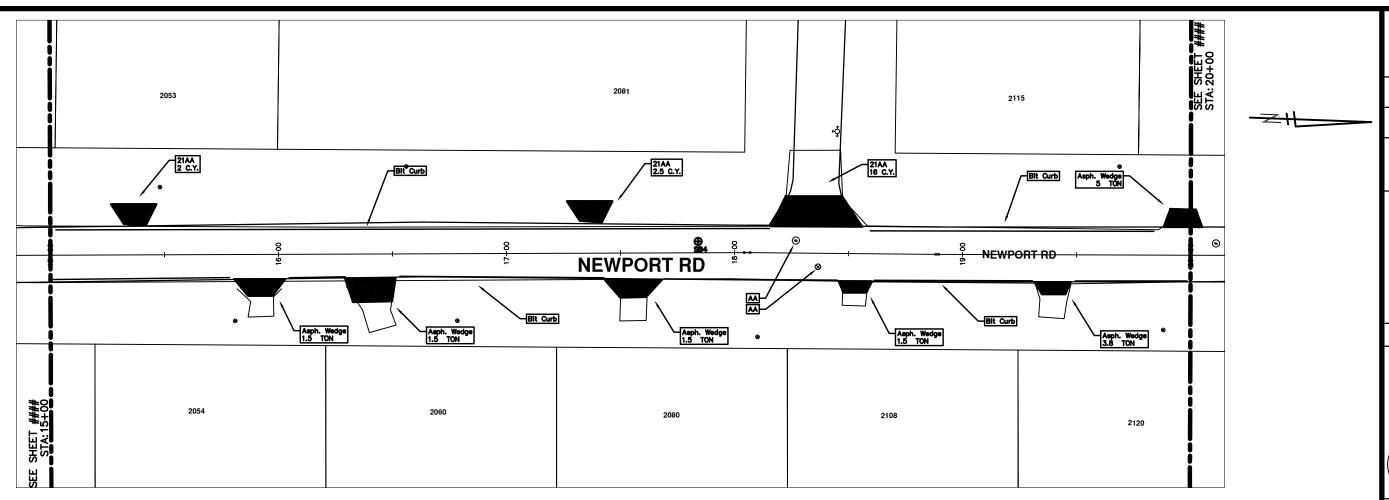

SYMBOL	LEGEND DESCRIPTION
SYMBOL	DESCRIPTION
•	EXISTING SANITARY SEWER MANHOLE
0	EXISTING STORM SEVER MANHOLE
•	EXISTING WATER MAIN VALVE IN WELL
+	WATER MAIN GATE VALVE IN BOX
•♦•	FIRE HYDRANT
•	MICHCON GAS CO. VALVE BOX/WELL
•	AMERITECH TELEPHONE VAULT
•	ELECTRIC MANHOLE
•	SOIL BORING
0	EXISTING STORM SEWER INLET
•	MONUMENT BOX
	REMOVE AND REPLACE CONC. SIDEWALK
	PLACE CONCRETE SIDEWALK
	REMOVE & REPLACE CONC. CURB & GUTTER
	CONSTRUCTION LIMITS
	6" WRAPPED UNDERDRAIN
	REMOVE CONCRETE SIDEWALK
	SUBGRADE UNDERCUT
PILE AND IT WE GLICK AND PICK	A REPERENCE FILE. MANE CHANNES TO THE REPERENCE LUPDATE ALL SHEETE. TO MANE A CHANCE RIGHT COPEN XMEF, MANE YOUR EDIT AND SAVE.

NEWPORT RD. CONSTRUCTION KEY KEY DESCRIPTION REMOVE AND REPLACE CURB AND GUTTER REMOVE CURB AND GUTTER, REPLACE WITH CONCRETE CURB AND GUTTER H.E. REMOVE EXISTING RAMP OR SIDEWALK. REPLACE WITH 4" SIDEWALK OR TYPE 1 SIDEWALK RAMP,H.E. REMOVE SIDEWALK, DRIVE OR RAMP. ADJUST MDOT TYPE A CASTINGS. AB ADJUST GATE VALVE BOX OR MONUMENT BOX. ADST ADDITIONAL DEPTH STRUCTURE REPAIR. REMOVE AND REPLACE MDOT TYPE A CASTING ADJUST TO FINISH GRADE. CPRHE DS PT CONCRETE PAVEMENT REPAIR, H.E. CONSTRUCT 2, 3 OR 4' DIAM. DRAINAGE STRUCTURE. REMOVE EXISTING RAMP OR SIDEWALK, REPLACE WITH 4" SIDEWALK OR RAMP. REMOVE EXISTING RAMP OR SIDEWALK, REPLACE WITH 6" SIDEWALK OR RAMP PLACE 8" SIDEWALK OR RAMP ONLY REMOVE EXISTING DRIVE APPROACH, RAMP OR SIDEWALK. REPLACE WITH 6" OR 8" APPROACH, RAMP, OR SIDEWALK, H.E. C HE PLACE 4" SIDEWALK OR RAMP. ADJUST MDOT TYPE K CASTING. TYPE II MOOT TYPE II BARRICADE. MDOT TYPE III BARRICADE. REMOVE AND REPLACE MOOT TYPE K CASTING. ADJUST TO FINISH GRADE. RS RCP RECONSTRUCT STRUCTURE. REMOVE CONC. PAVEMENT - ANY THICKNESS RAISED CROSSWALK


PUBLIC SERVICES - CITY OF ANN ARBOR 2014 ANNUAL RESURFACING PROGRAM NEWPORT

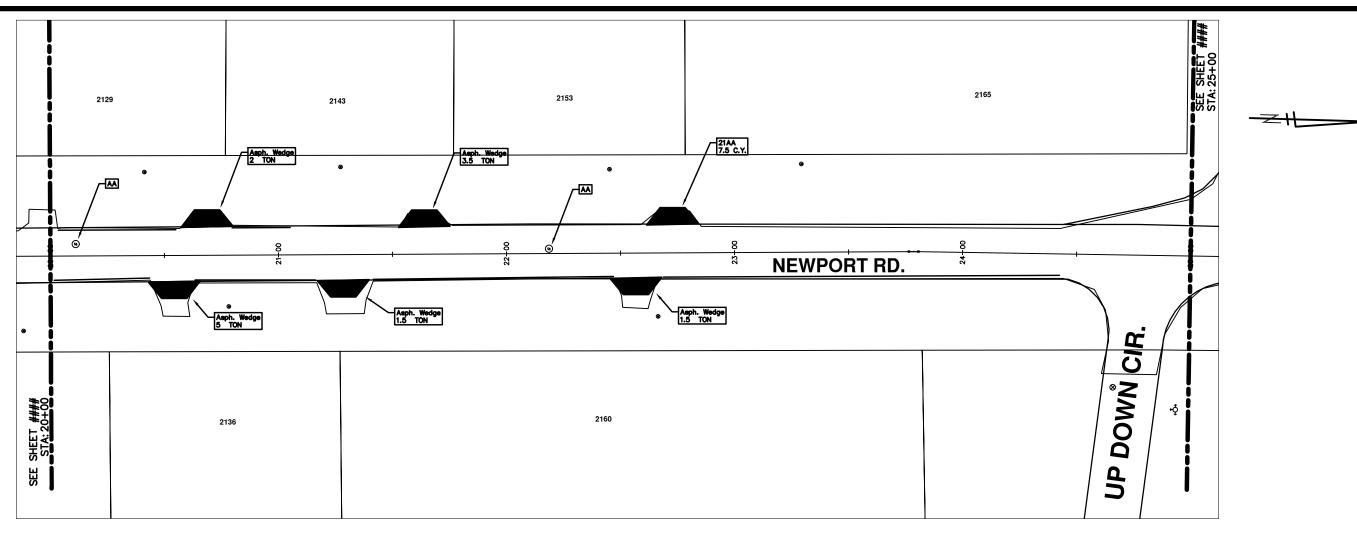

CONSTRUCTION KEY		
KEY	DESCRIPTION	
C/G	REMOVE AND REPLACE CURB AND GUTTER	
C/GHE	REMOVE CURB AND GUTTER, REPLACE WITH CONCRETE CURB ANI GUTTER H.E.	
C4HE	REMOVE EXISTING RAMP OR SIDEWALK. REPLACE WITH 4" SIDEWALK OR TYPE 1 SIDEWALK RAMP, H.E.	
CR	REMOVE SIDEWALK, DRIVE OR RAMP.	
AA	ADJUST MDOT TYPE A CASTINGS.	
AB	ADJUST GATE VALVE BOX OR MONUMENT BOX.	
ADST	ADDITIONAL DEPTH STRUCTURE REPAIR.	
RRA	REMOVE AND REPLACE MDOT TYPE A CASTING ADJUST TO FINISH GRADE.	
CPRHE	CONCRETE PAVEMENT REPAIR, H.E.	
DS	CONSTRUCT 2, 3 OR 4' DIAM. DRAINAGE STRUCTURE.	
PT	POINT STRUCTURE.	
C4	REMOVE EXISTING RAMP OR SIDEWALK, REPLACE WITH 4" SIDEWA OR RAMP.	
C6	REMOVE EXISTING RAMP OR SIDEWALK, REPLACE WITH 6" SIDEWA OR RAMP	
СВ	PLACE 8" SIDEWALK OR RAMP ONLY	
C HE	REMOVE EXISTING DRIVE APPROACH, RAMP OR SIDEWALK. REPLACE WITH 6" OR 8" APPROACH, RAMP, OR SIDEWALK, H.E.	
CP	PLACE 4" SIDEWALK OR RAMP.	
AK	ADJUST MDOT TYPE K CASTING.	
TYPE II	MDOT TYPE II BARRICADE.	
TYPE III	MDOT TYPE III BARRICADE.	
RRK	REMOVE AND REPLACE MDOT TYPE K CASTING. ADJUST TO FINIS GRADE.	
RS	RECONSTRUCT STRUCTURE.	
RCP	REMOVE CONC. PAVEMENT - ANY THICKNESS	
RCW	RAISED CROSSWALK	


	LEGEND
SYMBOL	DESCRIPTION
•	EXISTING SANITARY SEWER MANHOLE
•	EXISTING STORM SEWER MANHOLE
•	EXISTING WATER MAIN VALVE IN WELL
+	WATER MAIN GATE VALVE IN BOX
φ.	FIRE HYDRANT
•	MICHOON GAS CO. VALVE BOX/NELL
•	AMERITECH TELEPHONE VAULT
•	ELECTRIC MANHOLE
•	SOIL BORING
0	EXISTING STORM SEWER INLET
•	MONUMENT BOX
	REMOVE AND REPLACE CONC. SIDEWALK
	PLACE CONCRETE SIDEWALK
	REMOVE & REPLACE CONC. CURB & GUTTER
	CONSTRUCTION LIMITS
	6" WRAPPED UNDERDRAIN
	REMOVE CONCRETE SIDEWALK
	SUBGRADE UNDERCUT
PILE AND IT WE CLICK AND PIC	S A REPERCY PILE. MANE CHANGES TO THE REPERCH CE IL UPDATE ALL SHEETS. TO MANE A CHANGE RIGHT K OPEN XINEF, MANE YOUR EDIT AND SAVE.

PUBLIC SERVICES - CITY OF ANN ARBOR
2014 ANNUAL RESURFACING PROGRAM
NEWPORT

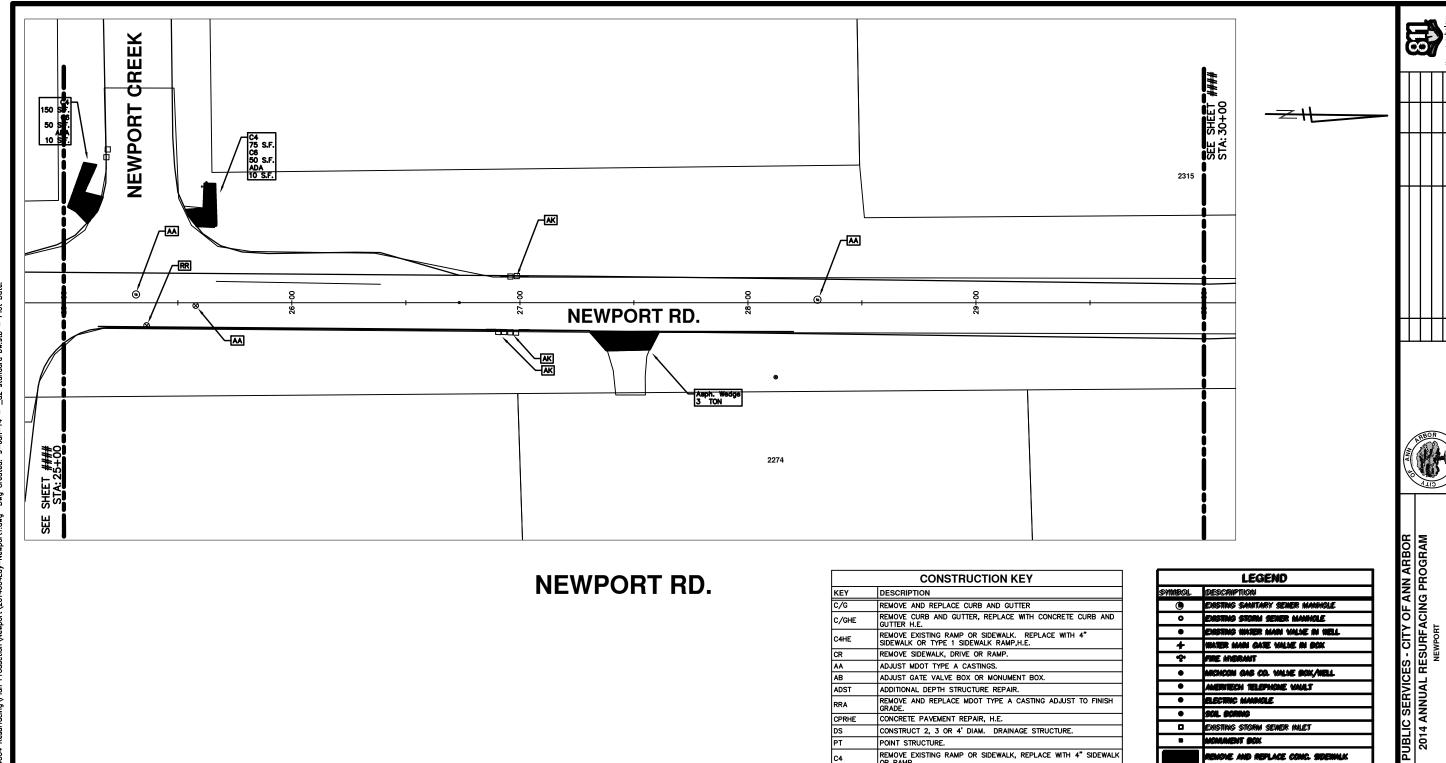

CONSTRUCTION KEY	
KEY	DESCRIPTION
C/G	REMOVE AND REPLACE CURB AND GUTTER
C/GHE	REMOVE CURB AND GUTTER, REPLACE WITH CONCRETE CURB AND GUTTER H.E.
C4HE	REMOVE EXISTING RAMP OR SIDEWALK. REPLACE WITH 4" SIDEWALK OR TYPE 1 SIDEWALK RAMP, H.E.
CR	REMOVE SIDEWALK, DRIVE OR RAMP.
AA	ADJUST MDOT TYPE A CASTINGS.
AB	ADJUST GATE VALVE BOX OR MONUMENT BOX.
ADST	ADDITIONAL DEPTH STRUCTURE REPAIR.
RRA	REMOVE AND REPLACE MDOT TYPE A CASTING ADJUST TO FINISH GRADE.
CPRHE	CONCRETE PAVEMENT REPAIR, H.E.
DS	CONSTRUCT 2, 3 OR 4' DIAM. DRAINAGE STRUCTURE.
PT	POINT STRUCTURE.
C4	REMOVE EXISTING RAMP OR SIDEWALK, REPLACE WITH 4" SIDEWA OR RAMP.
C6	REMOVE EXISTING RAMP OR SIDEWALK, REPLACE WITH 6" SIDEWA OR RAMP
C8	PLACE 8" SIDEWALK OR RAMP ONLY
C HE	REMOVE EXISTING DRIVE APPROACH, RAMP OR SIDEWALK. REPLAC WITH 6" OR 8" APPROACH, RAMP,OR SIDEWALK, H.E.
CP	PLACE 4" SIDEWALK OR RAMP.
AK	ADJUST MDOT TYPE K CASTING.
TYPE II	MDOT TYPE II BARRICADE.
TYPE III	MDOT TYPE III BARRICADE.
RRK	REMOVE AND REPLACE MDOT TYPE K CASTING. ADJUST TO FINISH GRADE.
RS	RECONSTRUCT STRUCTURE.
RCP	REMOVE CONC. PAVEMENT - ANY THICKNESS
RCW	RAISED CROSSWALK

LEGEND		
SYMBOL	DESCRIPTION	
•	existing sanitary sewer manhole	
0	EXISTING STORM SENER MANHOLE	
•	Existing water main value in well	
+	WATER MAIN GATE VALVE IN DOX	
ф.	FIRE HYDRANT	
•	MICHOCH GAS CO. VALNE BOX/NELL	
•	AMERITECH TELEPHONE VALLE	
•	ELECTRIC MANIMOLE	
•	SCIL BORMS	
0	Existing storm sewer inlet	
•	MONUMENT BOX	
	REMOVE AND REPLACE CONG. SIDEWALK	
	PLACE CONCRETE SIDEMALK	
	REMONE & REPLACE CONG. CURD & GUTTER	
	CONSTRUCTION LIMITS	
	6" WRAPPED UNDERDRAIM	
	REMOVE CONCRETE SIDEWALK	
	SUBGRADE UNDERCUT	
PLE AND IT I	IS A REPERENCE FILE. MAKE CHANGES TO THE REFERENCE MLL UPDATE ALL SHEETS. TO MAKE A CHANGE RIGHT OK OPEN XNEF, MAKE YOUR EDIT AND SAVE.	

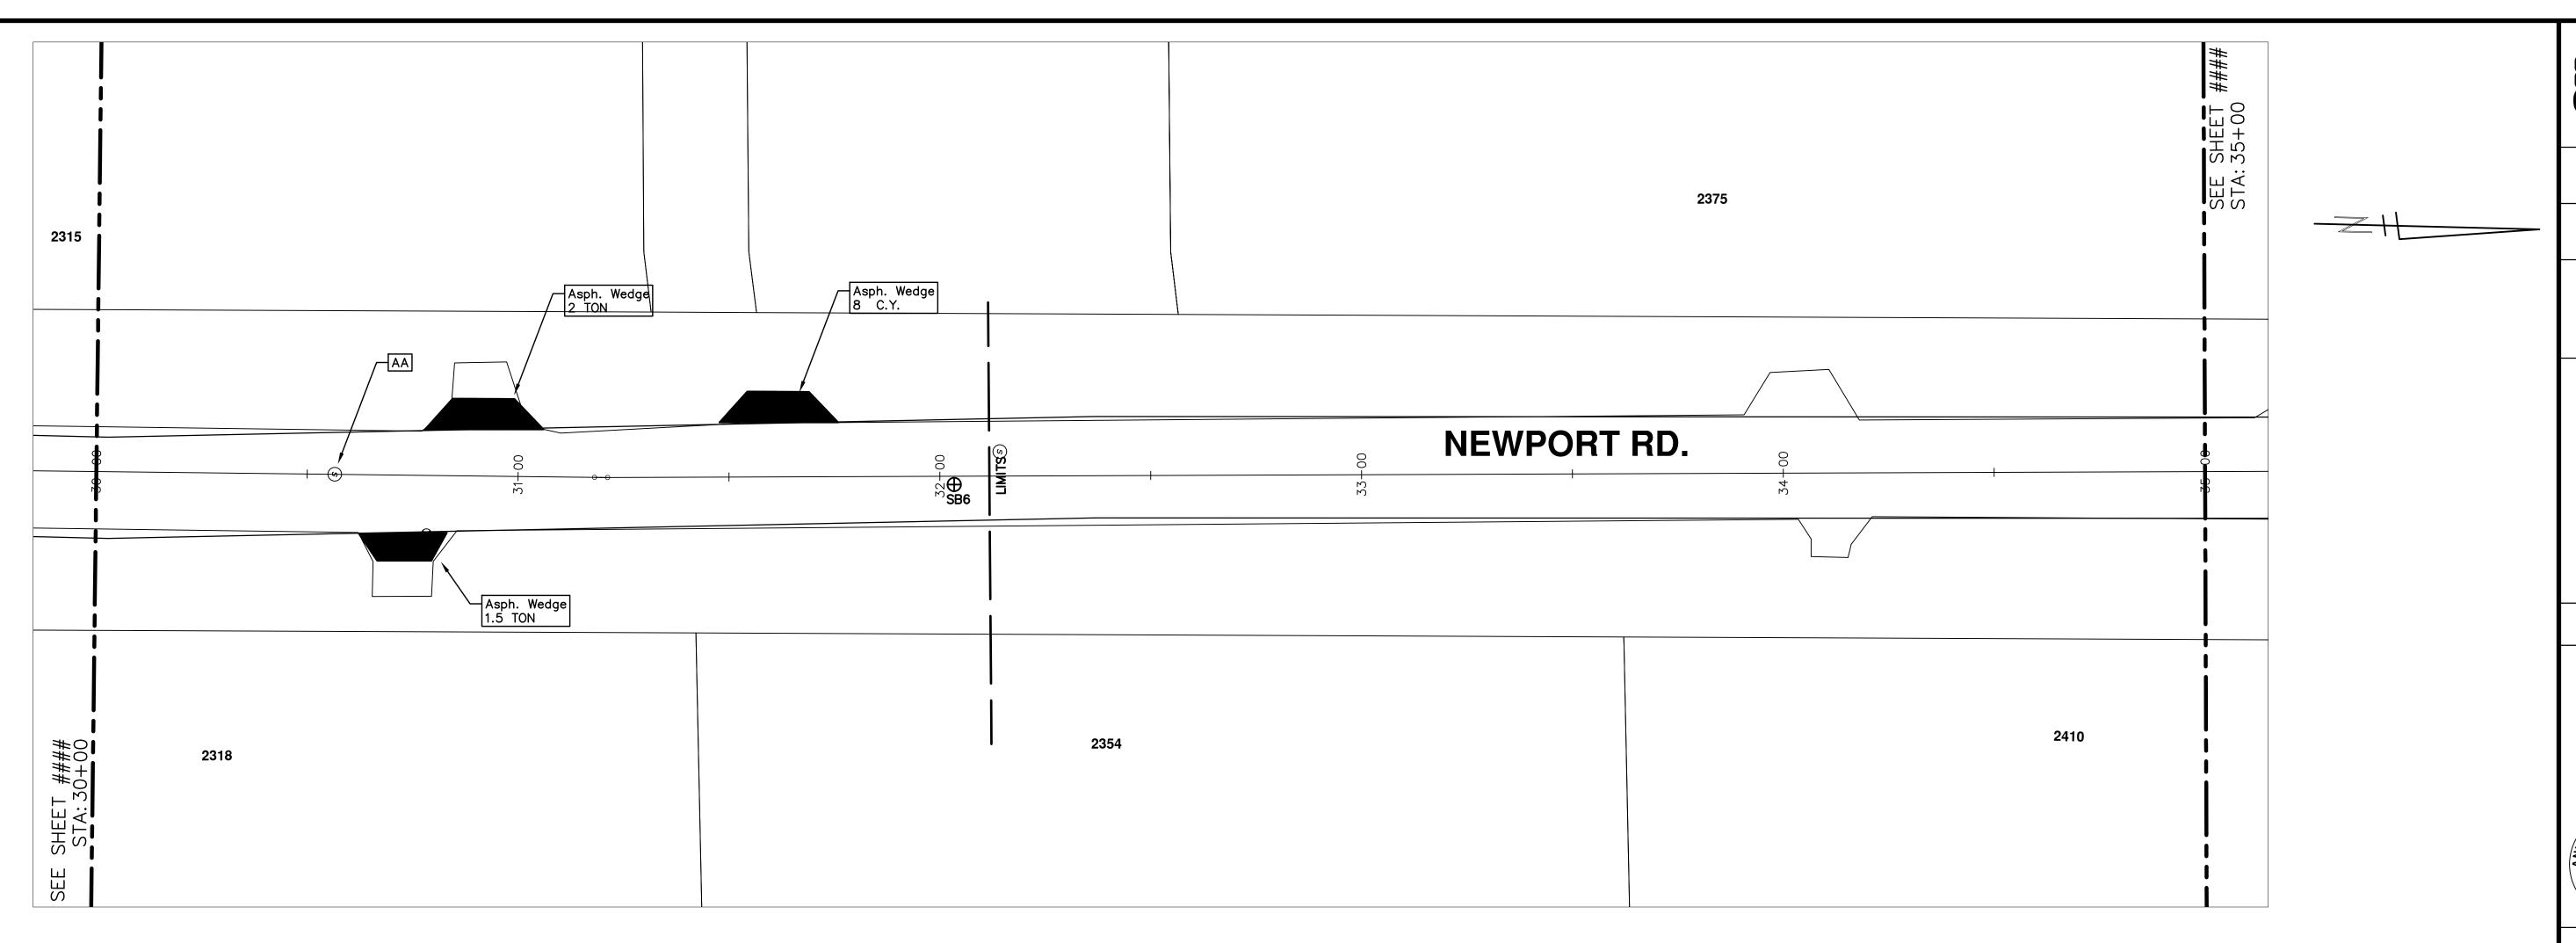

	CONSTRUCTION KEY
KEY	DESCRIPTION
C/G	REMOVE AND REPLACE CURB AND GUTTER
C/GHE	REMOVE CURB AND GUTTER, REPLACE WITH CONCRETE CURB AND GUTTER H.E.
C4HE	REMOVE EXISTING RAMP OR SIDEWALK. REPLACE WITH 4" SIDEWALK OR TYPE 1 SIDEWALK RAMP, H.E.
CR	REMOVE SIDEWALK, DRIVE OR RAMP.
AA	ADJUST MDOT TYPE A CASTINGS.
AB	ADJUST GATE VALVE BOX OR MONUMENT BOX.
ADST	ADDITIONAL DEPTH STRUCTURE REPAIR.
RRA	REMOVE AND REPLACE MDOT TYPE A CASTING ADJUST TO FINISH GRADE.
CPRHE	CONCRETE PAVEMENT REPAIR, H.E.
DS	CONSTRUCT 2, 3 OR 4' DIAM. DRAINAGE STRUCTURE.
PT	POINT STRUCTURE.
C4	REMOVE EXISTING RAMP OR SIDEWALK, REPLACE WITH 4" SIDEWALI OR RAMP.
C6	REMOVE EXISTING RAMP OR SIDEWALK, REPLACE WITH 6" SIDEWALK OR RAMP
C8	PLACE 8" SIDEWALK OR RAMP ONLY
С НЕ	REMOVE EXISTING DRIVE APPROACH, RAMP OR SIDEWALK. REPLACE WITH 6" OR 8" APPROACH, RAMP,OR SIDEWALK, H.E.
CP	PLACE 4" SIDEWALK OR RAMP.
AK	ADJUST MDOT TYPE K CASTING.
TYPE II	MDOT TYPE II BARRICADE.
TYPE III	MDOT TYPE III BARRICADE.
RRK	REMOVE AND REPLACE MDOT TYPE K CASTING. ADJUST TO FINISH GRADE.
RS	RECONSTRUCT STRUCTURE.
RCP	REMOVE CONC. PAVEMENT - ANY THICKNESS
RCW	RAISED CROSSWALK


SYMBOL	DESCRIPTION
0	EXISTING SANITARY SEWER MANHOLE
0	EXISTING STORM SEWER MANHOLE
8	EXISTING WATER MAIN VALVE IN WELL
+	WATER MAIN GATE VALVE IN BOX
+ Ç +	FIRE HYDRANT
•	MICHCON GAS CO. VALVE BOX/WELL
•	AMERITECH TELEPHONE VAULT
•	ELECTRIC MANHOLE
•	SOIL BORING
0	EXISTING STORM SEWER INLET
0	MONUMENT BOX
	REMOVE AND REPLACE CONC. SIDEWALK
4	PLACE CONCRETE SIDEWALK
	REMOVE & REPLACE CONC. CURB & GUTTER
	CONSTRUCTION LIMITS
	6" WRAPPED UNDERDRAIN
	REMOVE CONCRETE SIDEWALK
	SUBGRADE UNDERCUT S A REFERENCE FILE. MAKE CHANGES TO THE REFEREN


PROJECT MANAGEMENT - PUBLIC SERVICES - CITY OF ANN ARBOR


SCALE PLAN: 1" = 20

BRAWING No.


2014004-64 64 OF 102

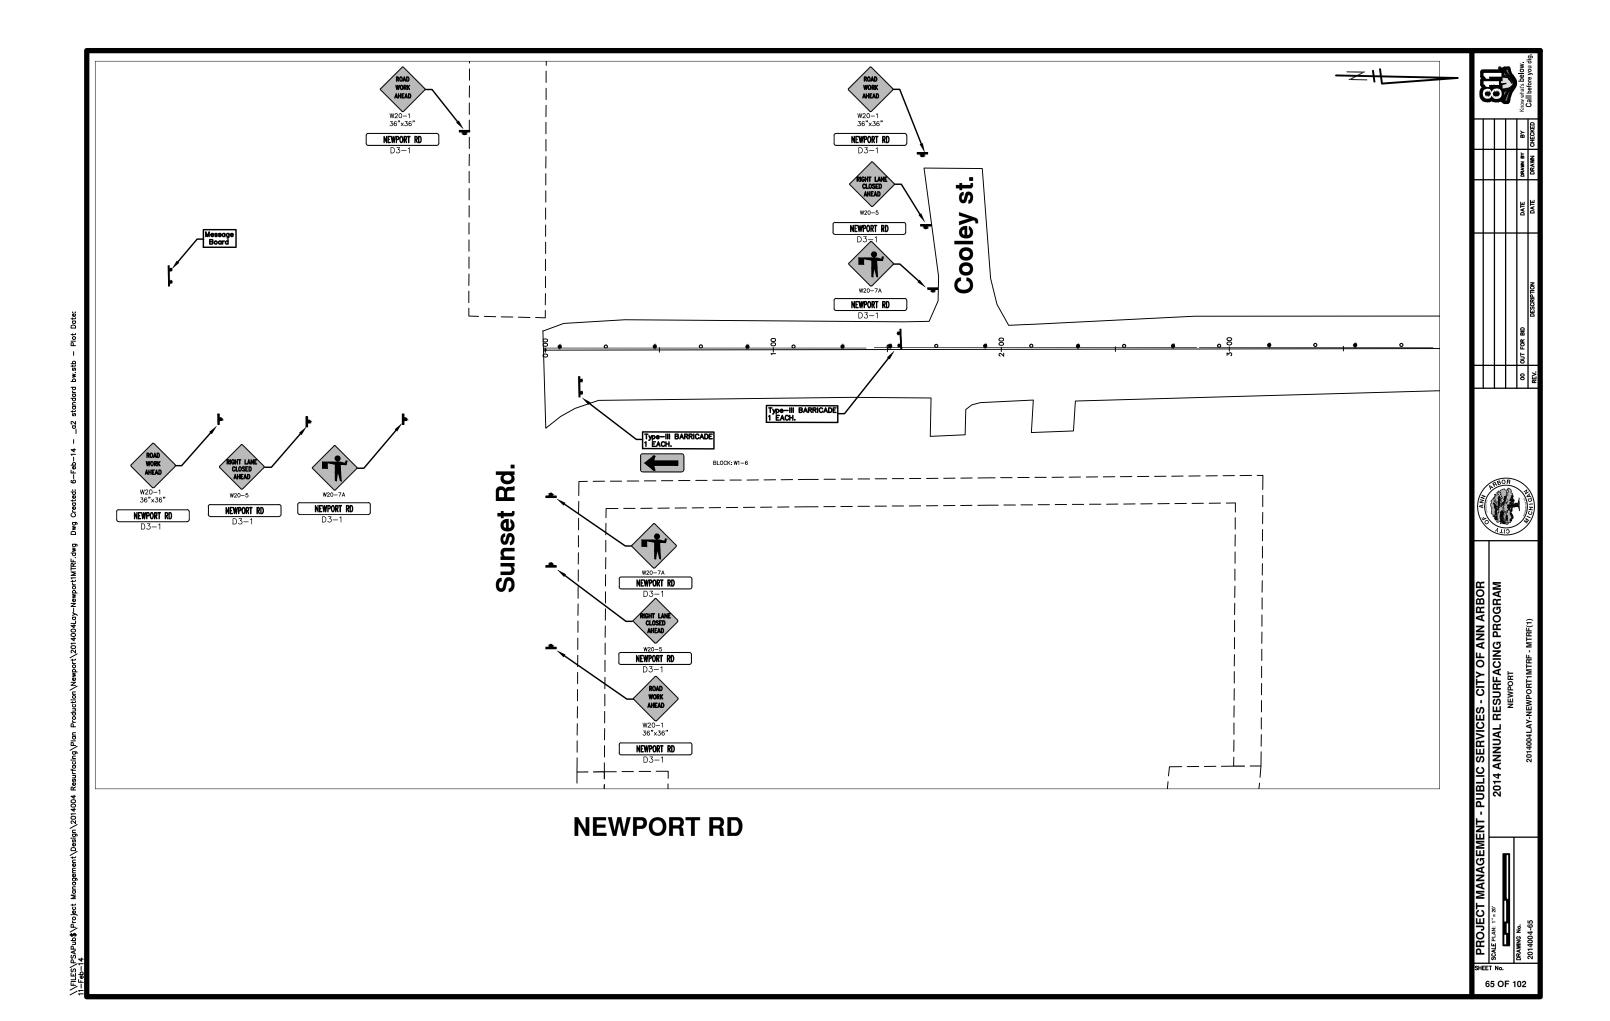


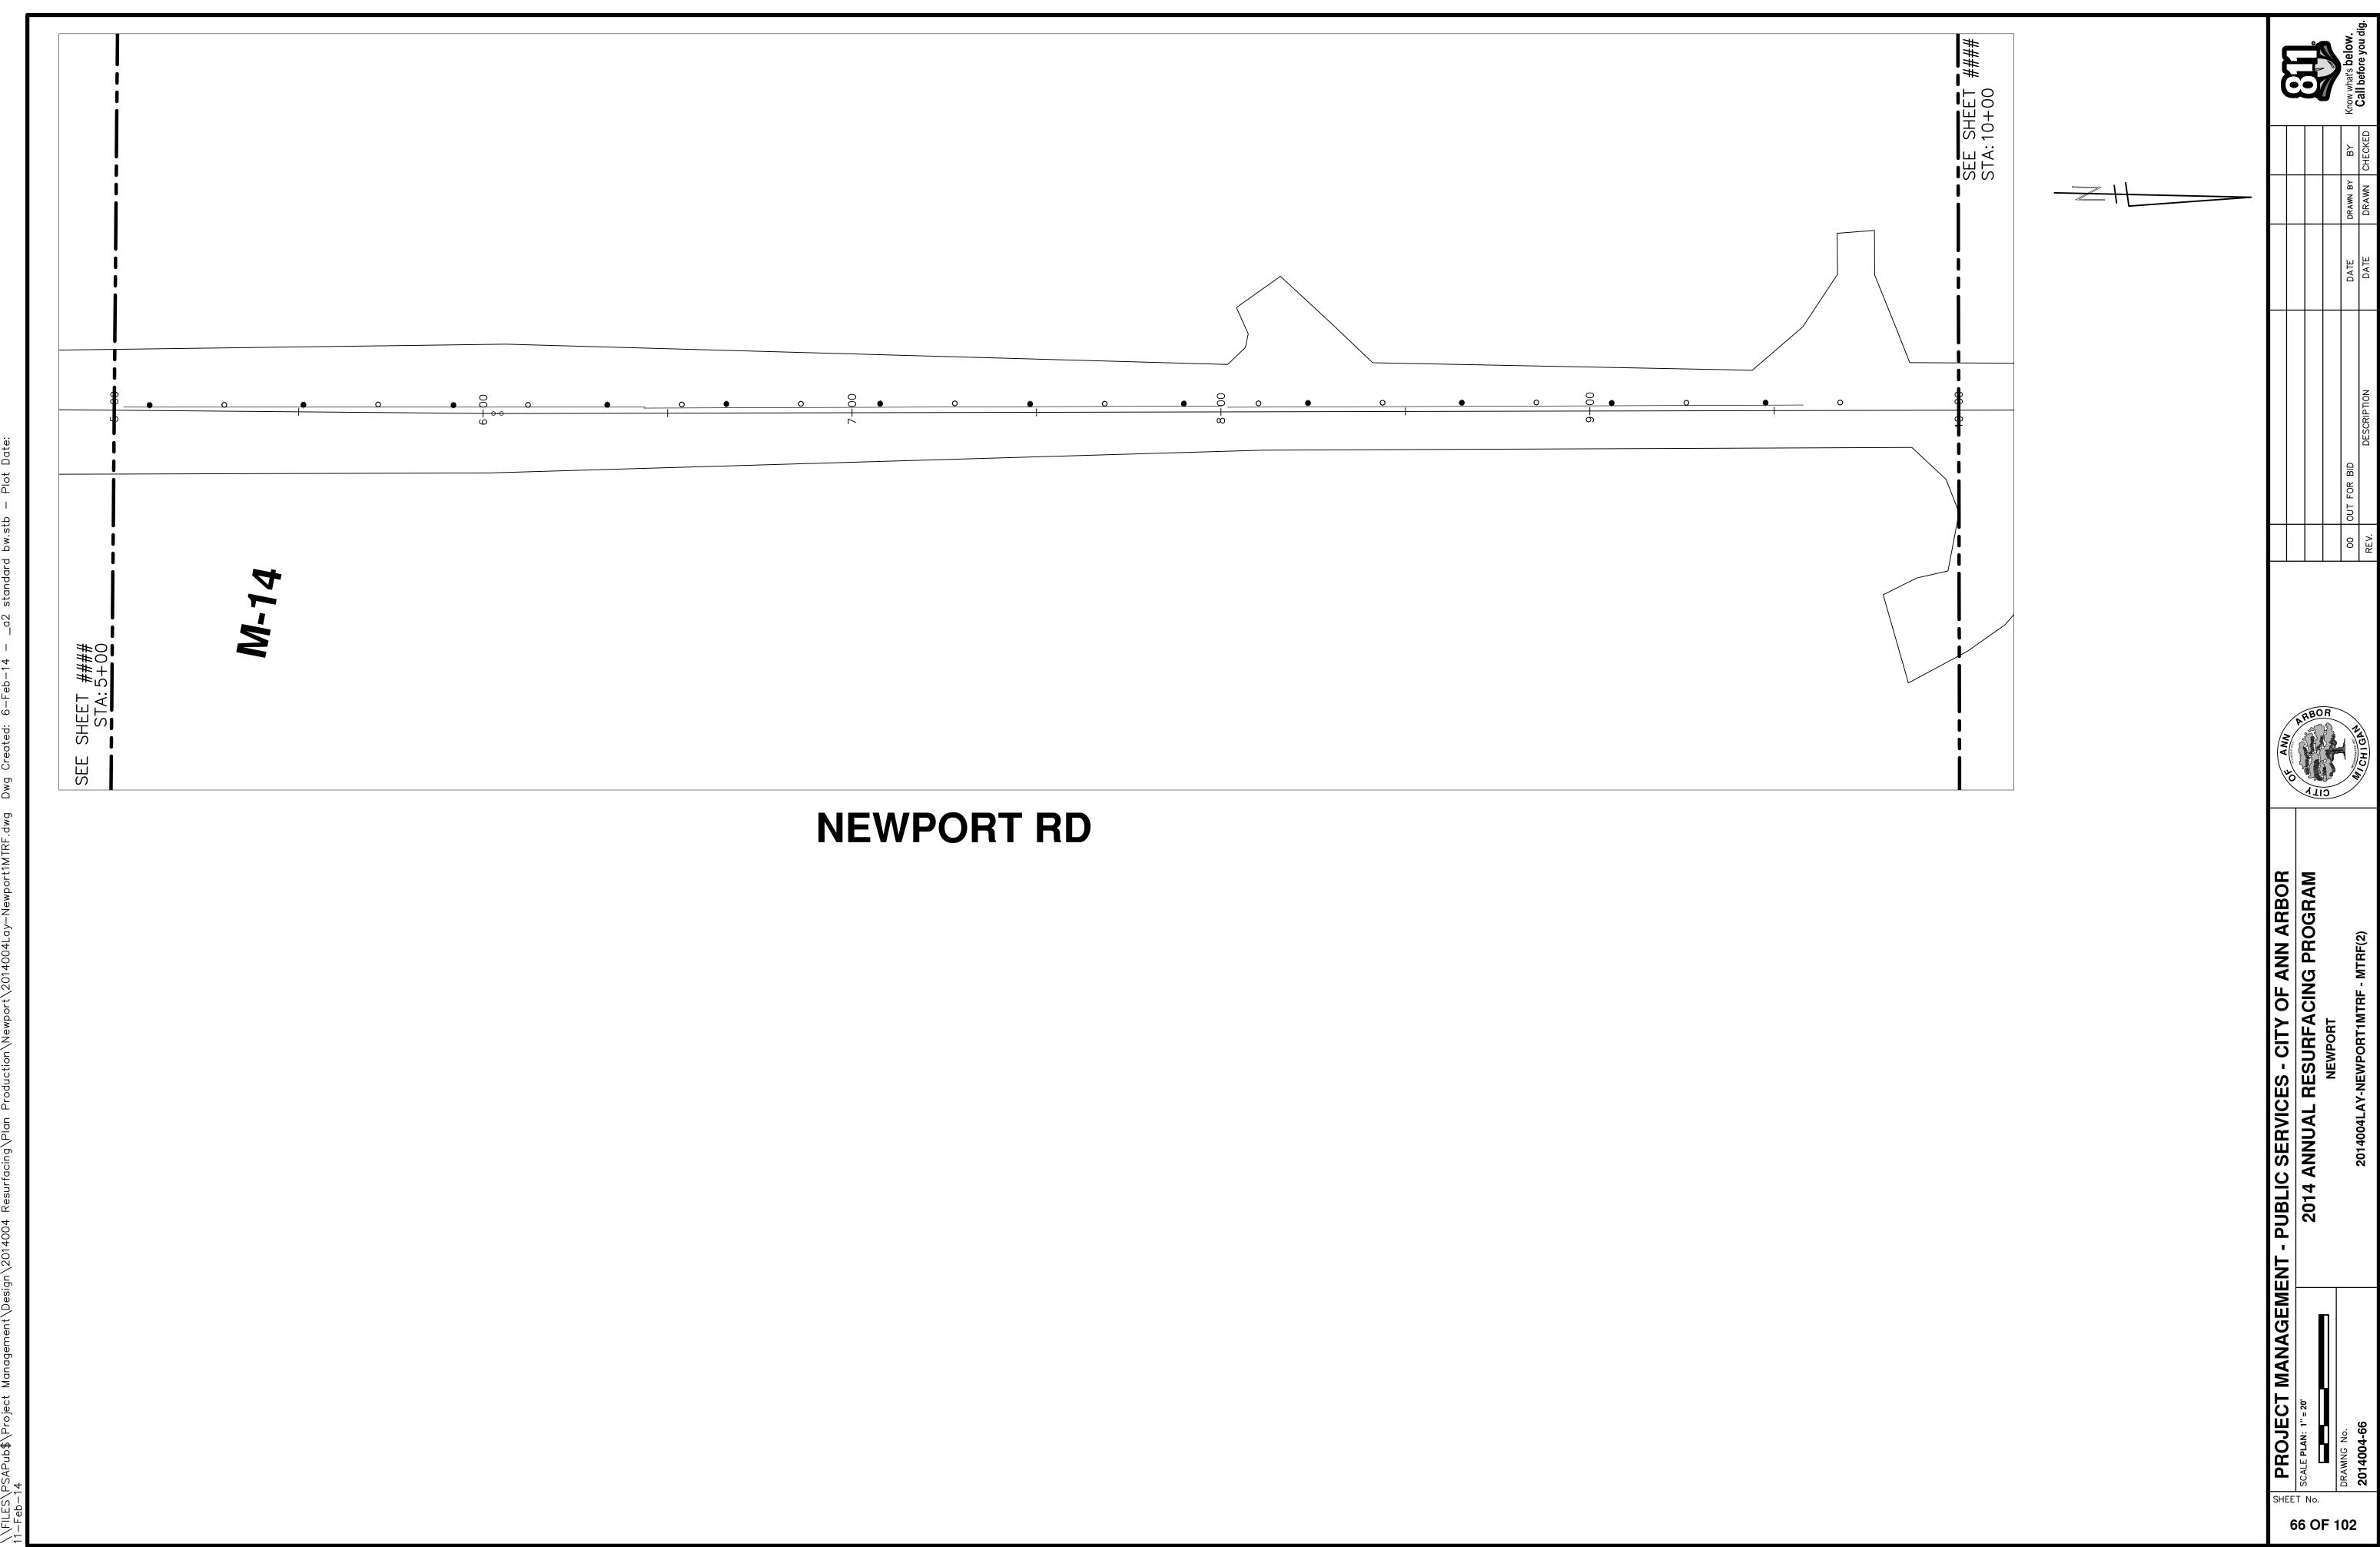


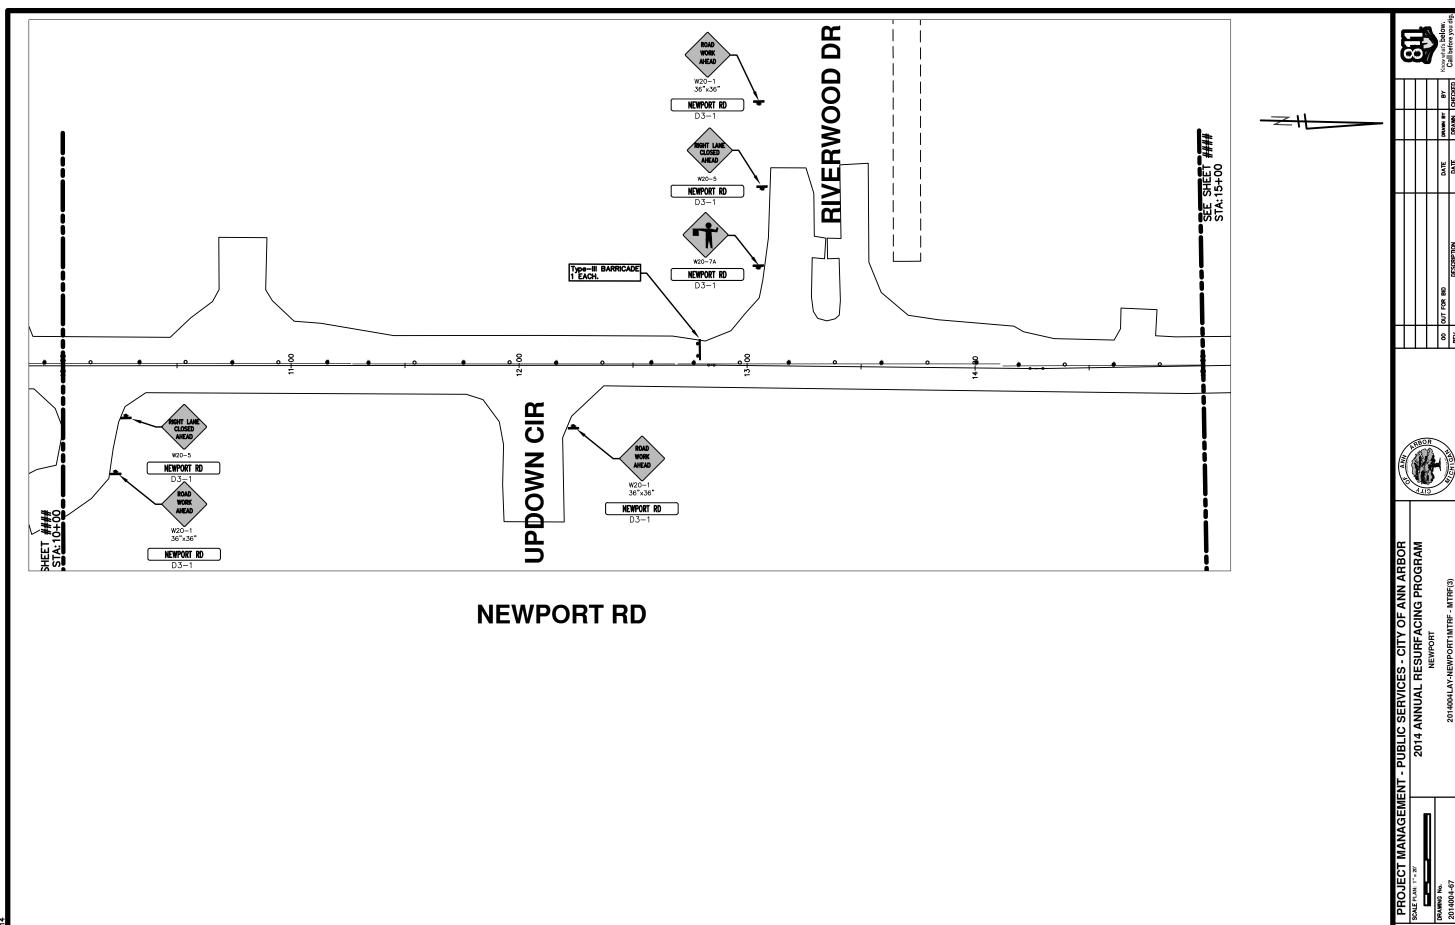



SHEET No. 67 OF 102

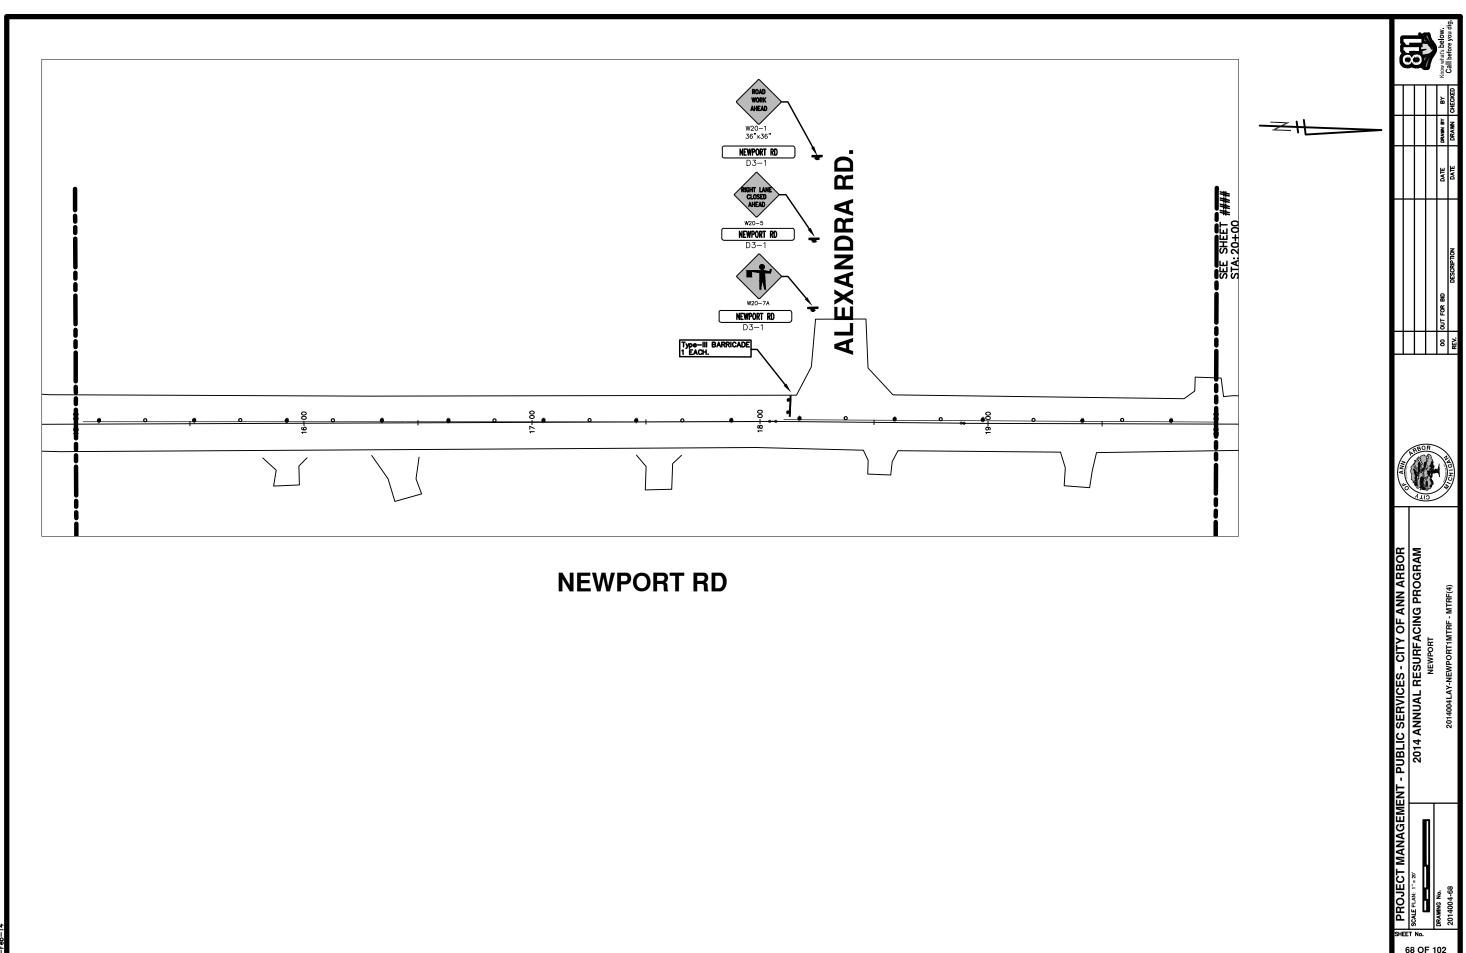


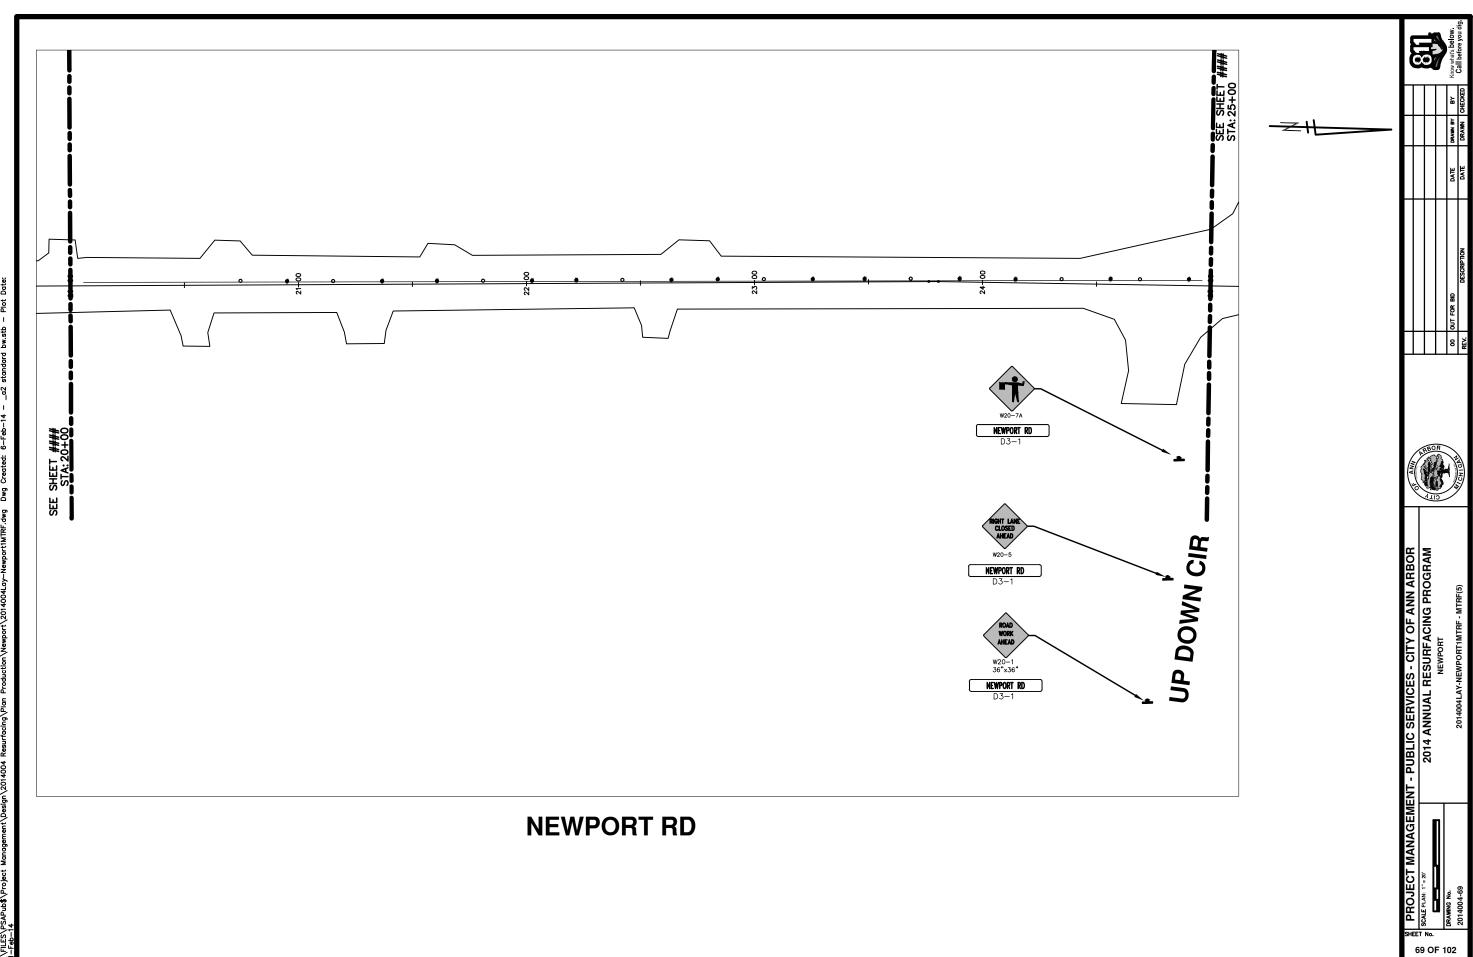


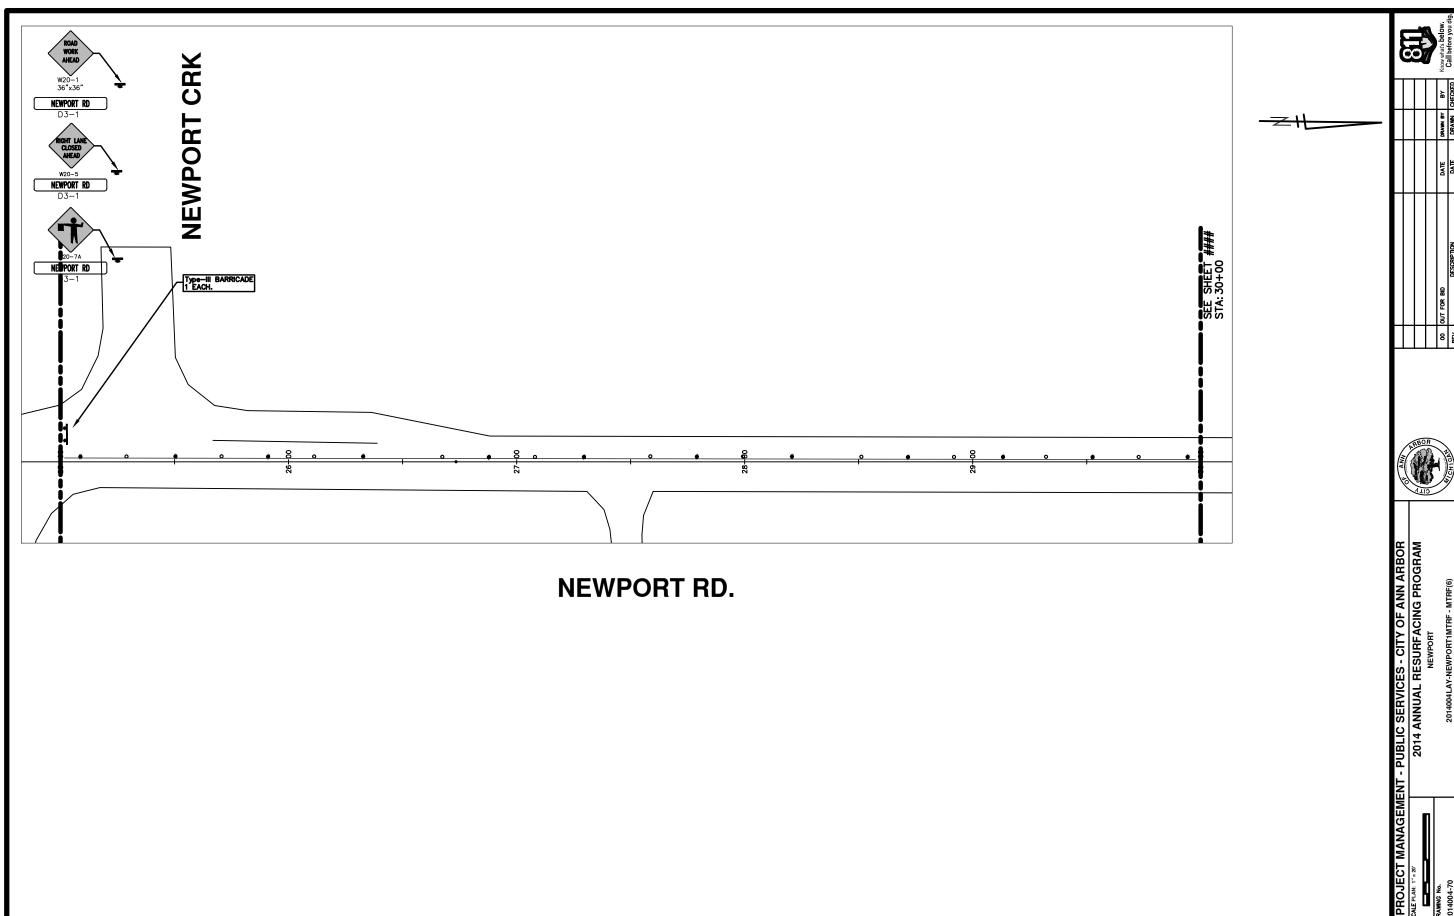


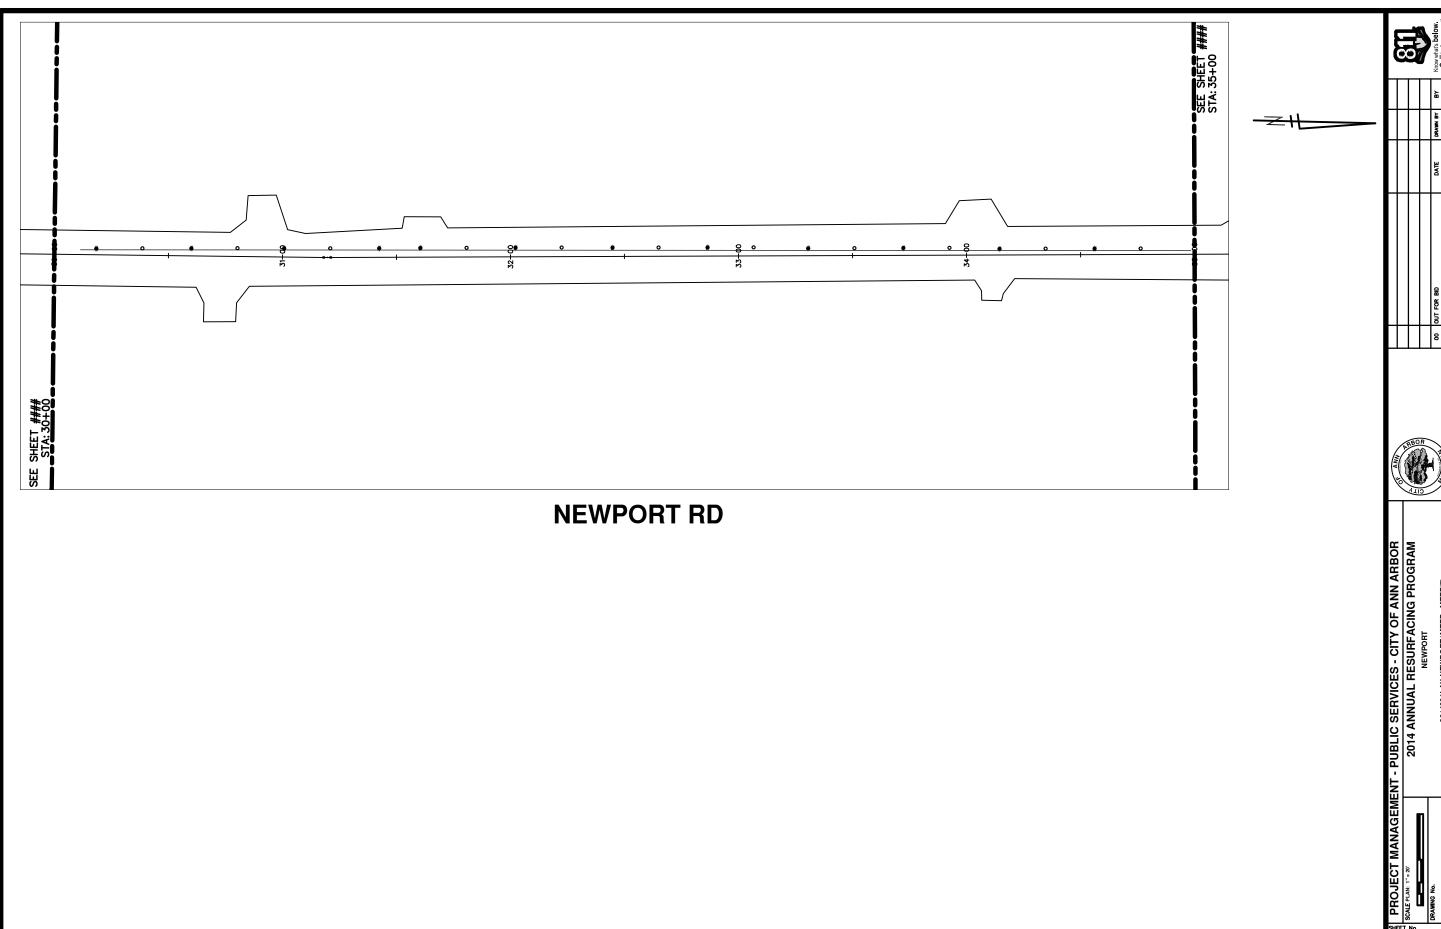


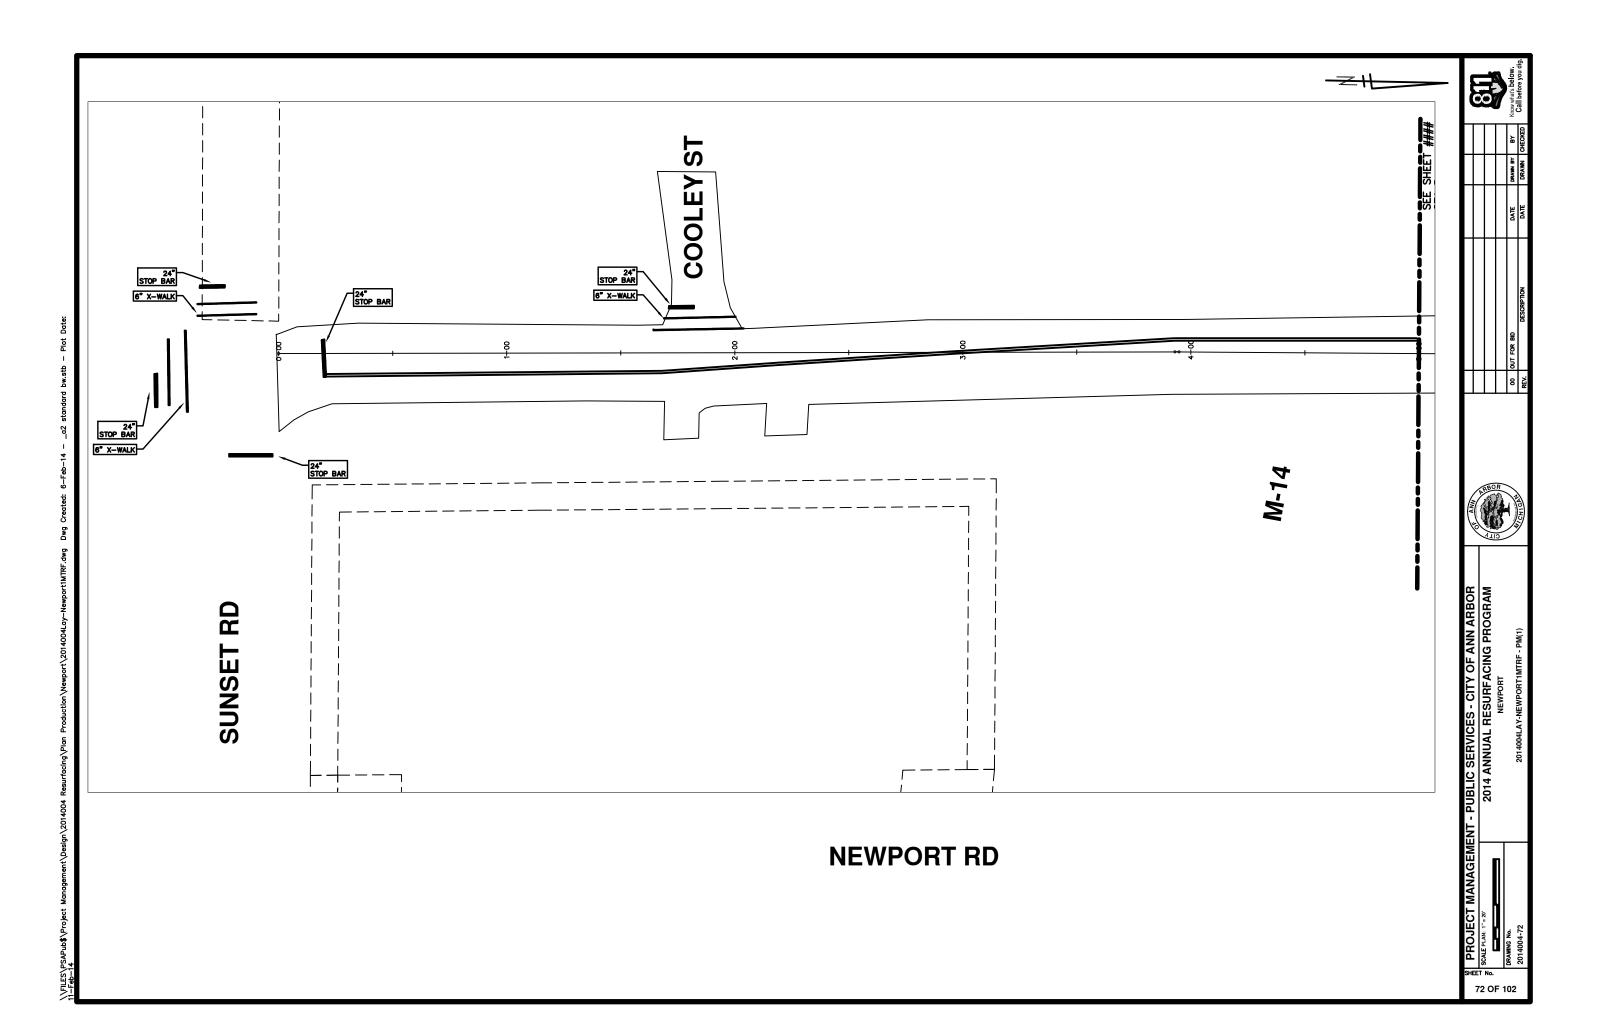


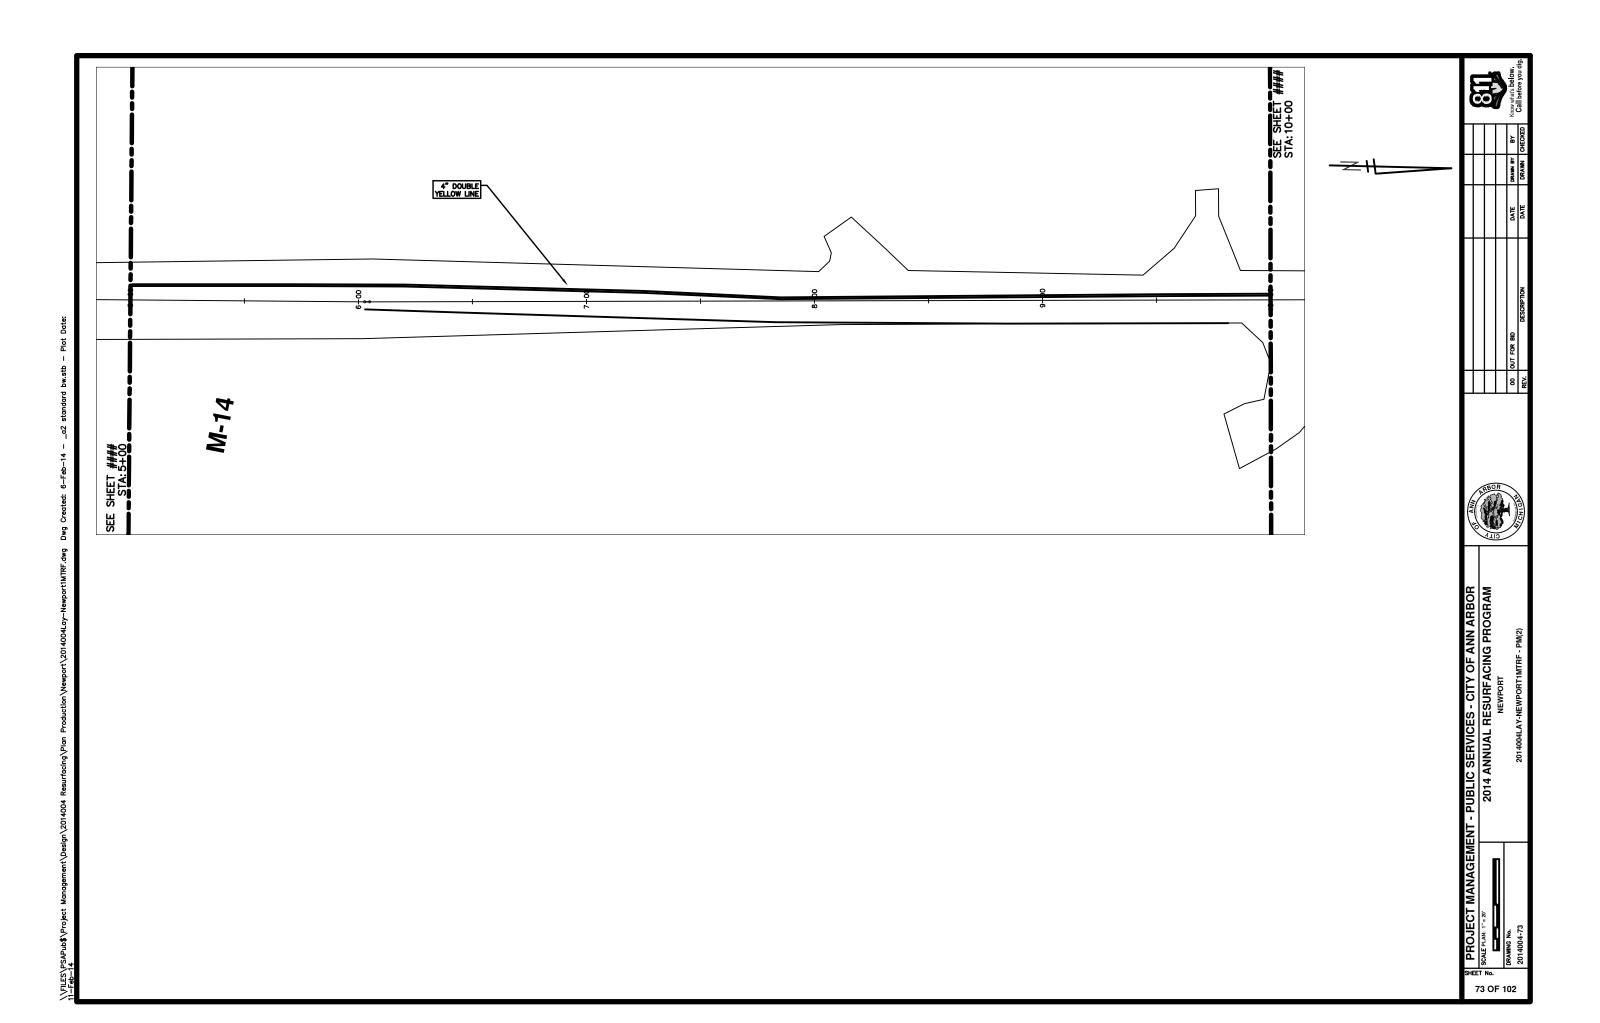


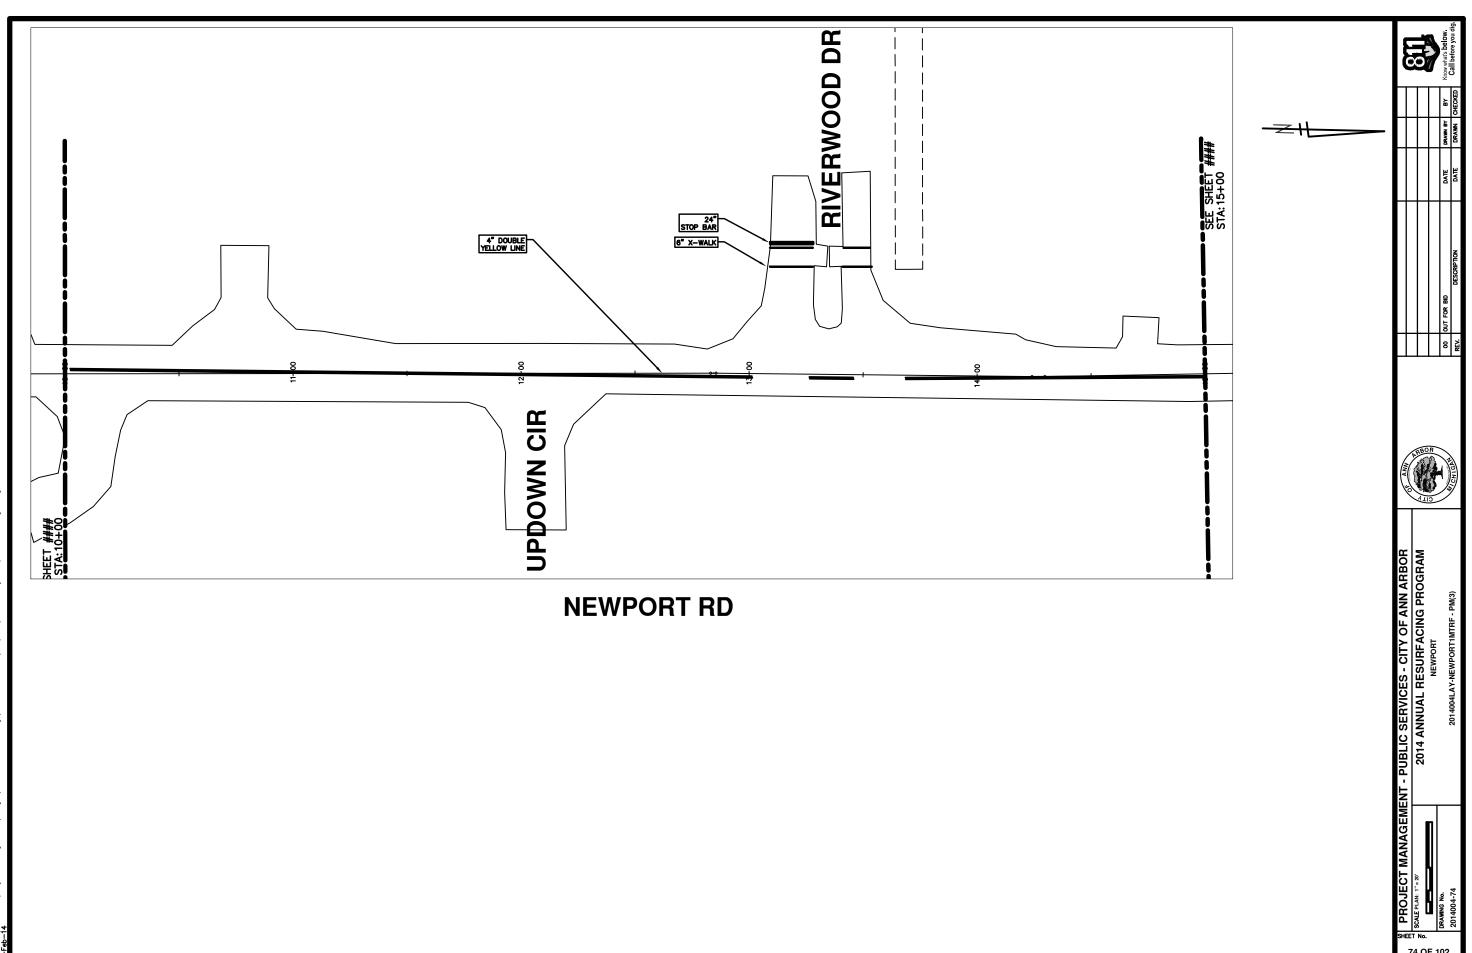


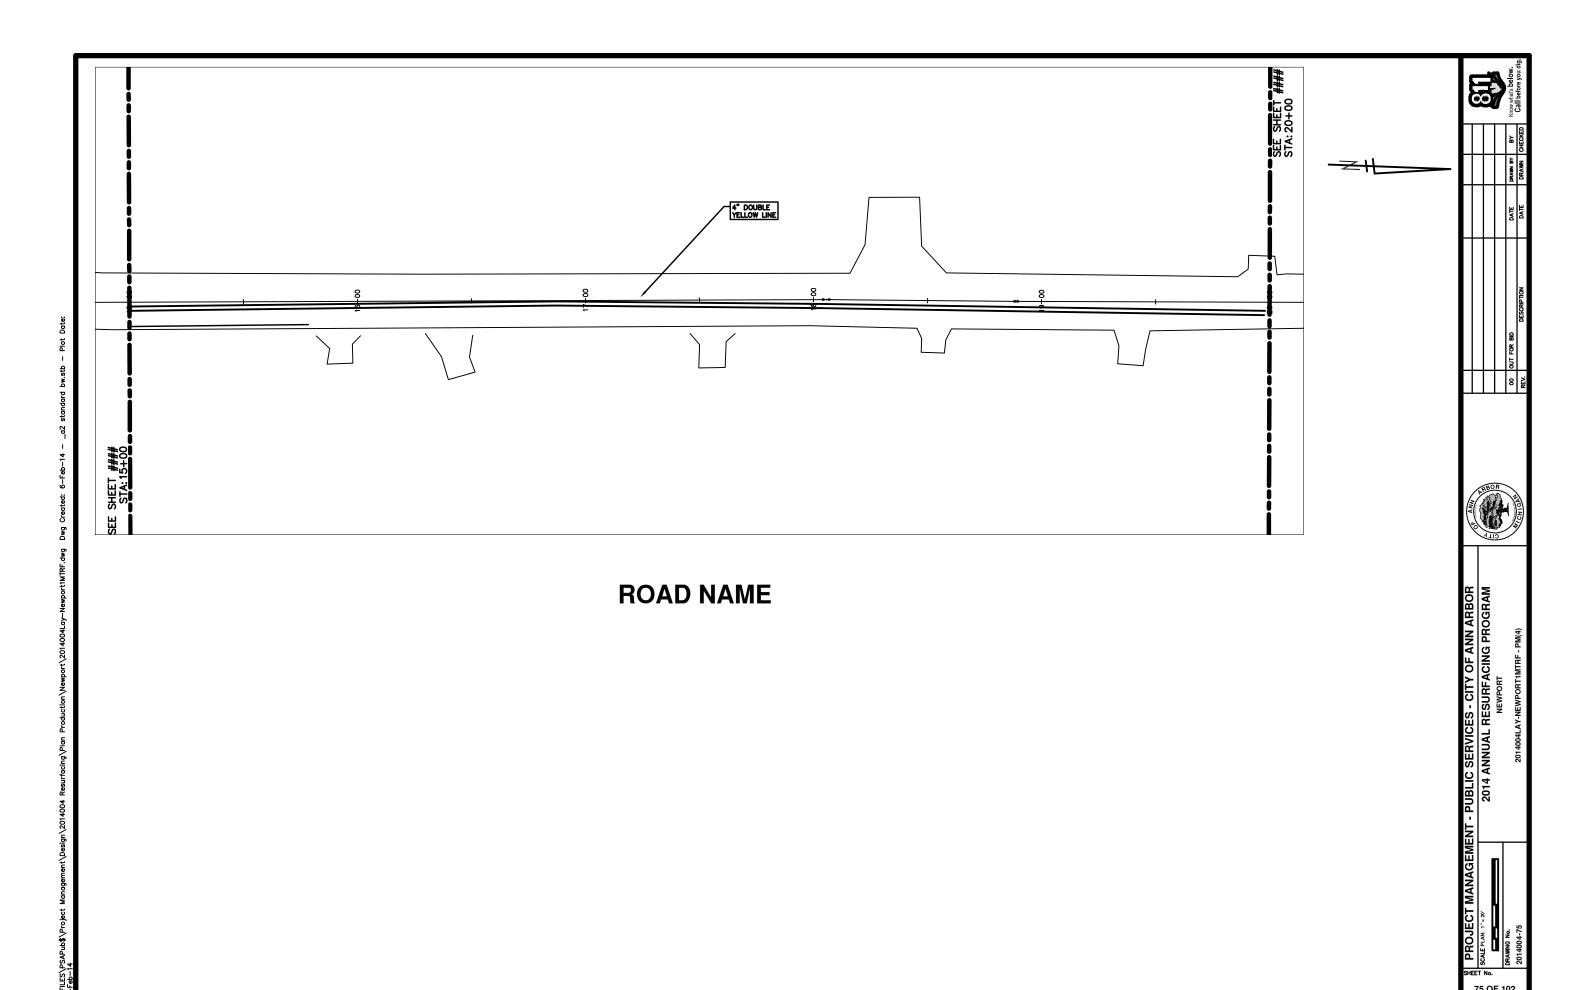

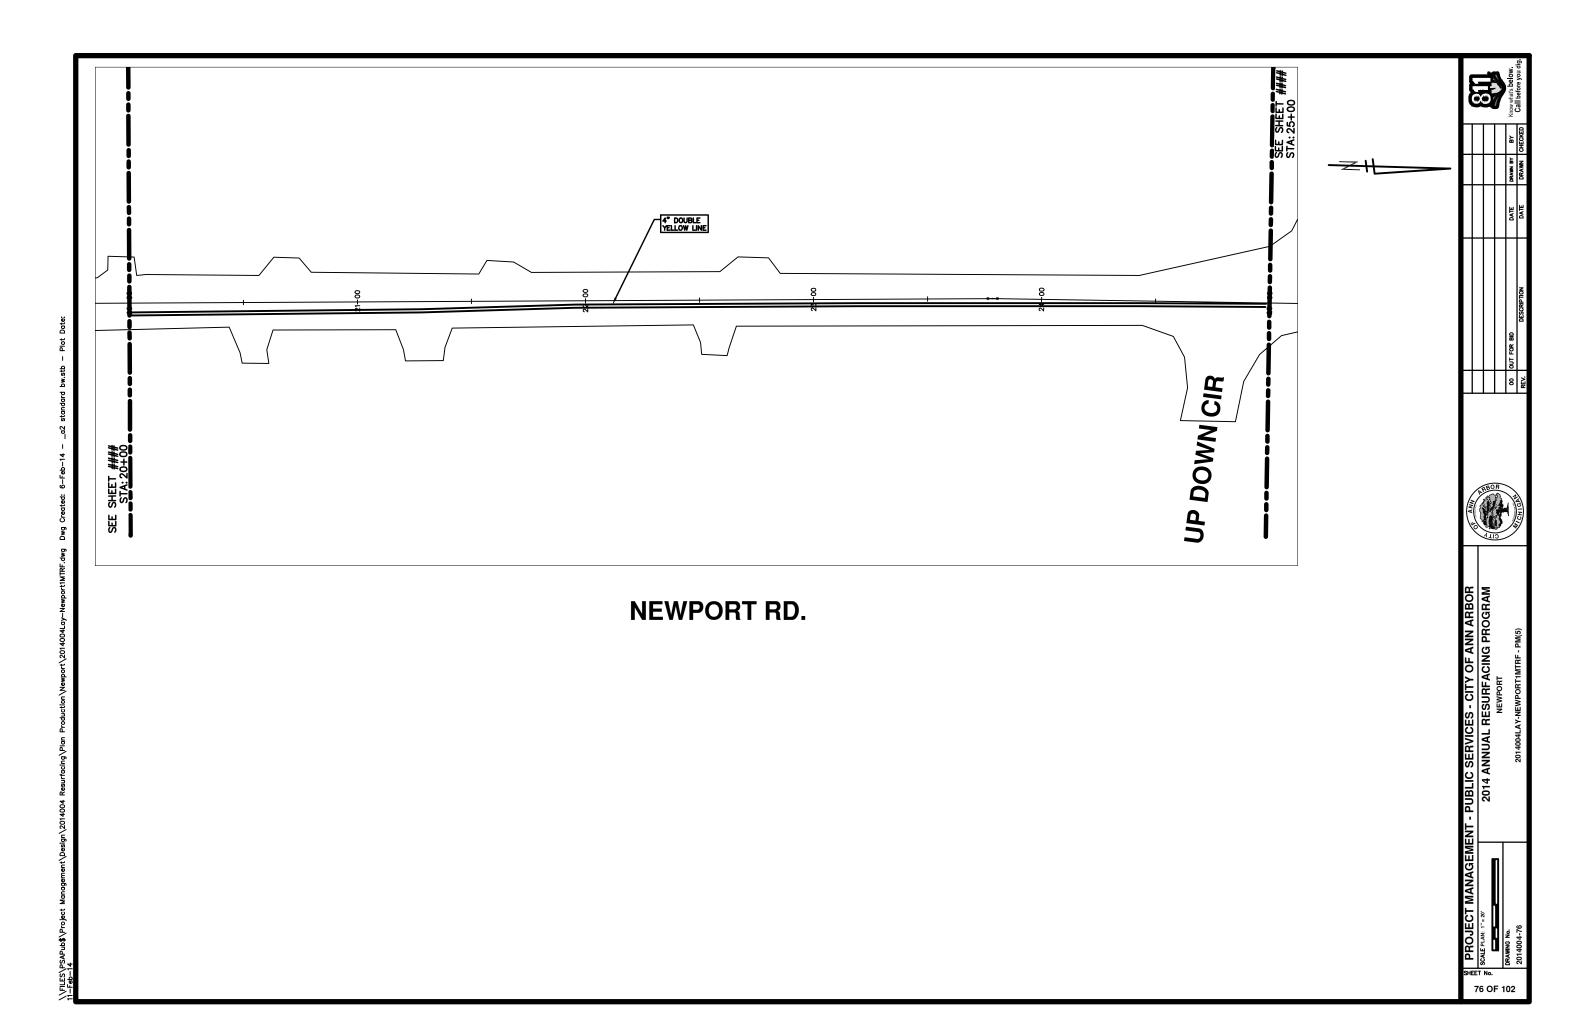

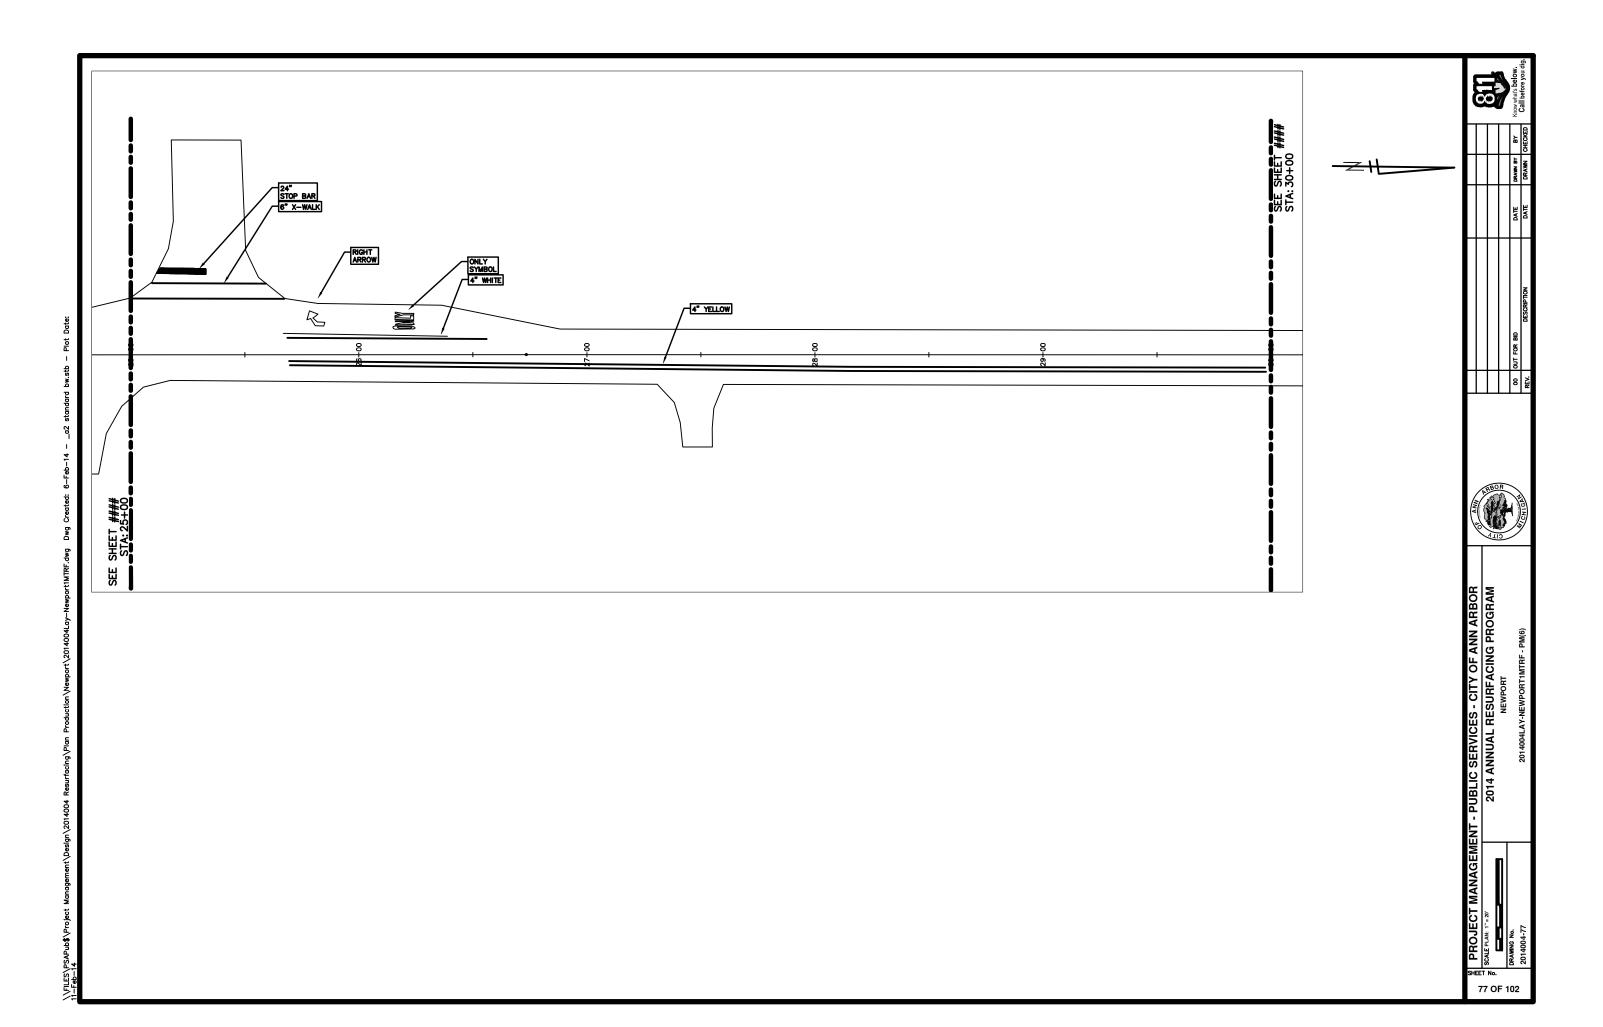

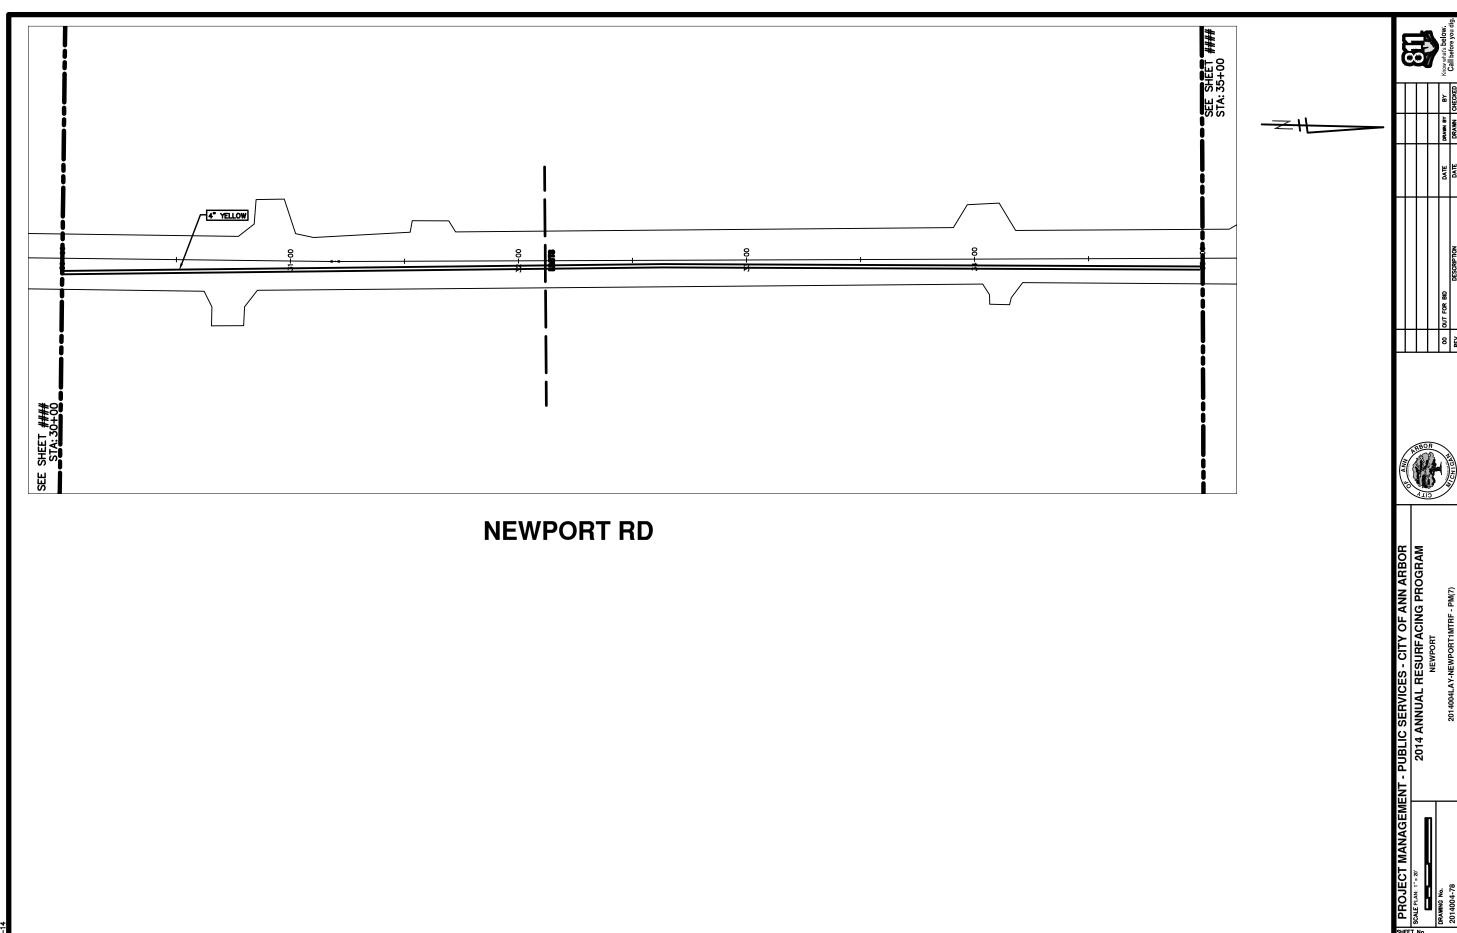

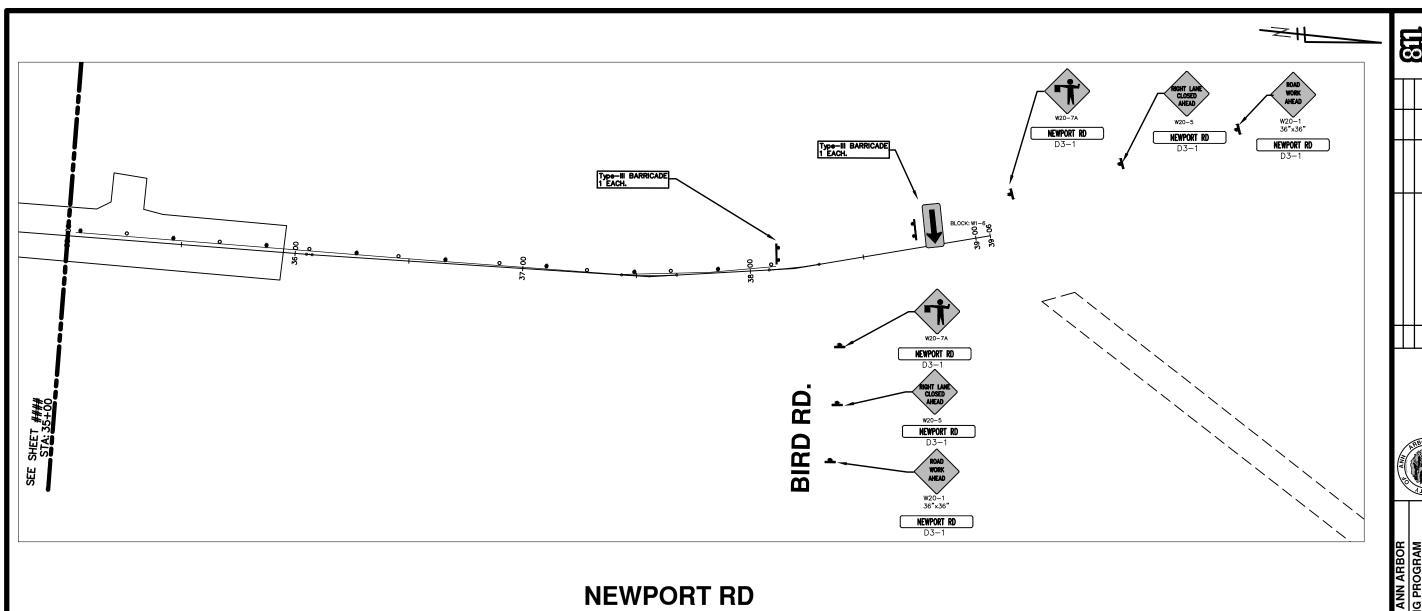



PROJECT MANAGEMENT 2014 ANNUAL RESURFACING PROGRAM PROJECT LOCATION: WOODBURY DRIVE

FILE No. 2014004

QUANTITIES				
ITEM#	DESCRIPTION	Units	Total	
206	Remove HMA Pavement	S.Y.	20	
207	Cold Millilling Pavement	Tons	910	
209	Subgrade Undercutting - Type II	C.Y.	310	
220	HMA Patching	Tons	8	
222	HMA Pavement Leveling, Regular	Tons	520	
223	HMA Pavement Wearing, Regular	Tons	390	
230	Remove Curb & Gutter, Any Type	L.F.	650	
232	Rem. Conc. Sidewalk & Drive - Any Thickness	S.F.	50	
237	Conc. Curb & Gutter - Any Type - Fixed Form	L.F.	650	
241	6" Drive, Sidewalk or Ramp	S.F.	50	
245	Detectable Warning, Cast in Place	S.F.	10	
254	Lower Structure Cover	Each	9	
256	Adjust Structure Cover	Each	9	
257	Adjust Curb Inlet Structure Cover	Each	8	
258	Manhole Flange & Cover (MDOT Type A)	Each	9	
271	21AA Limestone - C.I.P.	C.Y.	310	
281	Arrow Panel - Furn. & Operate	Each	1	
282	Plastic Drum - Lighted - Furn. & Operate	Each	80	
283	Barricade Type III - Furn. & Operate	Each	3	
284	Temp Signs Type - B	S.F.	341	
285	No Parking Sign	Each	39	
596	Rec. Polyurea Pvmt. Mkg., 6" White or Yellow	L.F.	215	
597	Rec. Polyurea Pvmt. Mkg., 24" White	L.F.	30	

	TRAFFIC CONTROL & SIGN LEGEND				
QTY.	TYPE	DESCRIPTION			
6	W20-1	"ROAD WORK AHEAD"			
1	W20-2	"DETOUR AHEAD"			
8	W20-3	"ROAD CLOSED AHEAD"			
10	D3-1	CONVENTIONAL GUIDE			
1	M4-8a	"DETOUR ENDS"			
4	M4-9	"DETOUR ARROW"			
3	R11-4	"ROAD CLOSED TO THRU TRAFFIC"			
1	TYPE A	LIGHTED ARROW, TYPE A			
3	TYPE III	TYPE III LIGHTED BARRICADE			
80	TYPE III	TYPE III LIGHTED BARRICADE (DRUM)			

CONSTRUCTION METHOD AND SEQUENCING

- THE WORK TO BE COMPLETED ON THIS STREET SHALL INCLUDE, BUT NOT BE LIMITED TO THE FOLLOWING ITEMS. THE ORDER OF CONSTRUCTION SHALL BE AS GIVEN UNLESS OTHERWISE AUTHORIZED OR DIRECTED BY THE ENGINEER.
- IMPLEMENT TRAFFIC MAINTENANCE, AND SOIL EROSION CONTROLS IN ACCORDANCE WITH THE PLANS, AND AS DIRECTED BY THE ENGINEER.
- 3. INSTALL ANY PROPOSED STORM SEWER, AND UNDERDRAIN AS SHOWN ON THE PLANS, AND AS DIRECTED BY THE ENGINEER.
- 4. LOWER ALL STRUCTURE COVERS, INCLUDING VALVE AND MONUMENT BOXES.
- 5. PERFORM ALL CONCRETE WORK, INCLUDING RESTORATION, IN ACCORDANCE WITH THE PLANS, AND AS DIRECTED BY THE ENGINEER.
- MILL 3-1/2 INCHES OF BITUMINOUS MATERIAL FROM EXISTING ROADWAY. THIS MAY INCLUDE GRANULAR ROAD BASE MATERIAL DEPTH TO BE DETERMINED BY THE ENGINEER. PROOF ROLL WITH FULL TRUCK.
- 7. PERFORM UNDERCUTS AND/OR BASE REPAIRS AS DIRECTED BY THE ENGINEER.
- 8. Grade, shape, and re-compact the existing road base as required, and as directed by the engineer.
- PAVE 2 INCHES OF THE BITUMINOUS MIX AS SPECIFIED OR DIRECTED, AS THE LEVELING COURSE, IN ONE LIFT.
- 10. ADJUST ALL STRUCTURE COVERS, MONUMENT BOXES, AND VALVE BOXES TO THEIR FINISHED ELEVATIONS
- 11. PAVE 1-1/2 INCHES OF THE BITUMINOUS MIX AS SPECIFIED OR DIRECTED, AS THE WEARING COURSE, IN ONE LIFT.
- 12. COMPLETE ALL PAVEMENT MARKINGS IN ACCORDANCE WITH THE PLANS, AND AS DIRECTED BY THE ENGINEER.
- 13. COMPLETE ALL MISCELLANEOUS CONSTRUCTION INCLUDING ALL CLEAN-UP AND FINAL RESTORATION.
- 14. REMOVE ALL TRAFFIC CONTROL DEVICES. REMOVE MISS DIG FLAGS.

NOTES:

THE CONSTRUCTION COVERED BY THESE PLANS SHALL CONFORM TO THE 1994 EDITION OF THE CITY OF ANN ARBOR PUBLIC SERVICES DEPARTMENT STANDARD SPECIFICATIONS AND IT'S DETAILS WHICH ARE INCLUDED BY REFERENCE. THE OMISSION OF ANY CURRENT STANDARD DETAIL DOES NOT RELIEVE THE CONTRACTOR FROM THIS REQUIREMENT. THE WORK SHALL BE PERFORMED IN COMPLETE CONFORMANCE WITH THE CURRENT PUBLIC SERVICES STANDARD SPECIFICATIONS AND DETAILS.

FOR PROTECTION OF UNDERGROUND UTILITIES AND IN CONFORMANCE WITH PUBLIC ACT 53, THE CONTRACTOR SHALL CALL 811 OR 1-800-482-7171 A MINIMUM OF THREE FULL WORKING DAYS, EXCLUDING SATURDAYS, SUNDAYS, AND HOLIDAYS PRIOR TO BEGINNING EACH EXCAVATION IN AREAS WHERE PUBLIC UTILITIES HAVE NOT BEEN PREVMOUSLY LOCATED. MEMBERS WILL THUS BE ROUTINELY NOTIFIED. THIS DOES NOT RELIEVE THE CONTRACTOR OF THE RESPONSIBILITY OF NOTIFYING UTILITY OWNERS WALD MAN NOT BE A DRET OF THE THISS OF A LEFT SYSTEM.

THE UNDERGROUND LOCATIONS SHOWN FOR NATURAL GAS (GAS), TELEPHONE (TEL), ELECTRICAL POWER (PWR), CABLE TV (CTV) AND FIBER OPTIC LINES (FIBER) ARE APPROXIMATE. THE CITY OF ANN ARBOR ASSUMES NO RESPONSIBILITY FOR THEIR ACCURATE REPRESENTATION IN THIS DRAWING, MISS DIG MUST BE CONTACTED PRIOR TO CONSTRUCTION TO LOCATE THESE UTILITIES.

OF AMY PER STORY OF THE STORY O

PROJECT MANAGEMENT SERVICE UNIT


CITY OF ANN ARBOR PUBLIC SERVICE 301 EAST HURON STREET, P.O. BOX 8647 ANN ARBOR, MICHIGAN 48107-8647 734-794-6410 www.a2gov.org Know what's belov

T DESCRIPTION
2014 ANNUAL RESURFACING

MENT - PUBLIC (

AWING No. 014004 - 80

80 TO 102

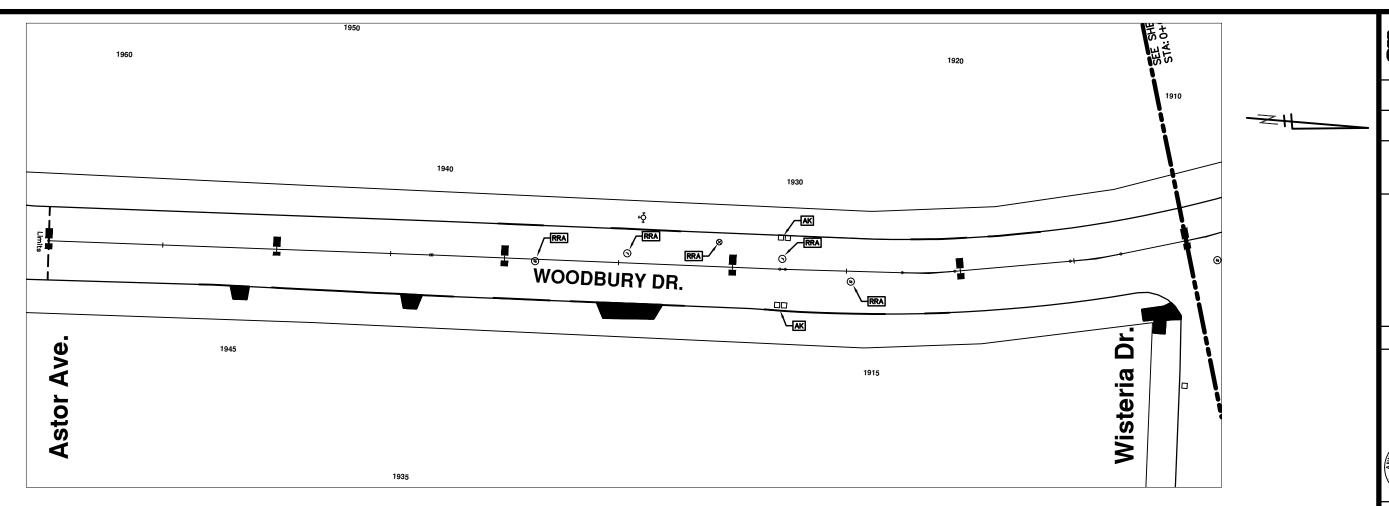


WOODBURY DR.

	CONSTRUCTION KEY
KEY	DESCRIPTION
C/G	REMOVE AND REPLACE CURB AND GUTTER
C/GHE	REMOVE CURB AND GUTTER, REPLACE WITH CONCRETE CURB AND GUTTER H.E.
C4HE	REMOVE EXISTING RAMP OR SIDEWALK. REPLACE WITH 4" SIDEWALK OR TYPE 1 SIDEWALK RAMP, H.E.
CR	REMOVE SIDEWALK, DRIVE OR RAMP.
AA	ADJUST MDOT TYPE A CASTINGS.
AB	ADJUST GATE VALVE BOX OR MONUMENT BOX.
ADST	ADDITIONAL DEPTH STRUCTURE REPAIR.
RRA	REMOVE AND REPLACE MDOT TYPE A CASTING ADJUST TO FINISH GRADE.
CPRHE	CONCRETE PAVEMENT REPAIR, H.E.
DS	CONSTRUCT 2, 3 OR 4' DIAM. DRAINAGE STRUCTURE.
PT	POINT STRUCTURE.
C4	REMOVE EXISTING RAMP OR SIDEWALK, REPLACE WITH 4" SIDEWAL OR RAMP.
C6	REMOVE EXISTING RAMP OR SIDEWALK, REPLACE WITH 6" SIDEWAL OR RAMP
С8	PLACE 8" SIDEWALK OR RAMP ONLY
C HE	REMOVE EXISTING DRIVE APPROACH, RAMP OR SIDEWALK. REPLACE WITH 6" OR 8" APPROACH, RAMP, OR SIDEWALK, H.E.
CP	PLACE 4" SIDEWALK OR RAMP.
AK	ADJUST MDOT TYPE K CASTING.
TYPE II	MDOT TYPE II BARRICADE.
TYPE III	MDOT TYPE III BARRICADE.
RRK	REMOVE AND REPLACE MDOT TYPE K CASTING. ADJUST TO FINISH GRADE.
RS	RECONSTRUCT STRUCTURE.
RCP	REMOVE CONC. PAVEMENT - ANY THICKNESS
RCW	RAISED CROSSWALK

	LEGEND
SYMBOL	DESCRIPTION
•	EXISTING SANITARY SEWER MANHOLE
•	EXISTING STORM SEWER MANHOLE
•	EXISTING WATER MAIN VALVE IN WELL
+	WATER MAIN GATE VALVE IN BOX
ጭ	FIRE HYDRANT
•	MICHCON GAS CO. VALVE BOX/WELL
•	AMERITECH TELEPHONE VAULT
•	ELECTRIC MANHOLE
•	SOIL BORING
0	EXISTING STORM SEWER INLET
•	MONUMENT BOX
	REMOVE AND REPLACE CONC. SIDEWALK
	PLACE CONCRETE SIDEWALK
	REMOVE & REPLACE CONC. CURB & GUTTER
	CONSTRUCTION LIMITS
	6" WRAPPED UNDERDRAIN
	REMOVE CONCRETE SIDEWALK
	SUBGRADE UNDERCUT
THE TABLE	IS A PEPERBACE PILE. MAKE CHANGES TO THE REPERBA BLL UPDATE ALL SHEETS. TO MAKE A CHANCE RIGHT


				0	REV.
NA NA	T	RBO	R		CHIGH
CT MANAGEMENT - PUBLIC SERVICES - CITY OF ANN ARBOR		2014 ANNUAL RESURFACING PROGRAM	WOODBURY		ZU14004LAT-WOODBURT - PLAN VIEW (UI)
CT MANAGEN	-30,	07-			

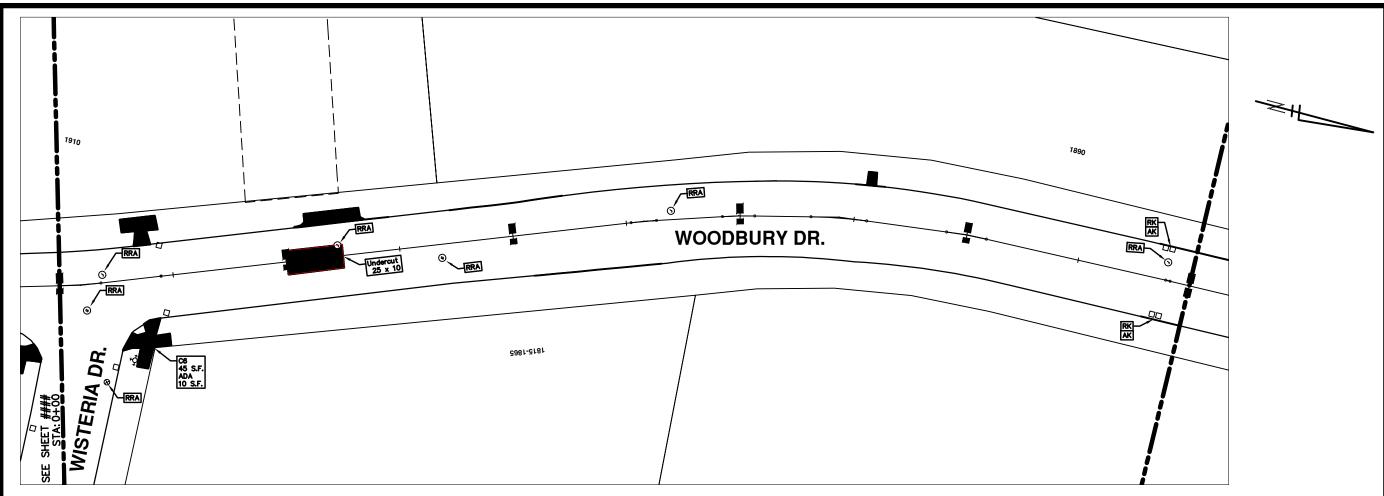

WOODBURY DR.

	CONSTRUCTION KEY
KEY	DESCRIPTION
C/G	REMOVE AND REPLACE CURB AND GUTTER
C/GHE	REMOVE CURB AND GUTTER, REPLACE WITH CONCRETE CURB AND GUTTER H.E.
C4HE	REMOVE EXISTING RAMP OR SIDEWALK. REPLACE WITH 4" SIDEWALK OR TYPE 1 SIDEWALK RAMP,H.E.
CR	REMOVE SIDEWALK, DRIVE OR RAMP.
AA	ADJUST MDOT TYPE A CASTINGS.
AB	ADJUST GATE VALVE BOX OR MONUMENT BOX.
ADST	ADDITIONAL DEPTH STRUCTURE REPAIR.
RRA	REMOVE AND REPLACE MDOT TYPE A CASTING ADJUST TO FINISH GRADE.
CPRHE	CONCRETE PAVEMENT REPAIR, H.E.
DS	CONSTRUCT 2, 3 OR 4' DIAM. DRAINAGE STRUCTURE.
PT	POINT STRUCTURE.
C4	REMOVE EXISTING RAMP OR SIDEWALK, REPLACE WITH 4" SIDEWALI OR RAMP.
C6	REMOVE EXISTING RAMP OR SIDEWALK, REPLACE WITH 6" SIDEWALL OR RAMP
C8	PLACE 8" SIDEWALK OR RAMP ONLY
C HE	REMOVE EXISTING DRIVE APPROACH, RAMP OR SIDEWALK. REPLACE WITH 6" OR 8" APPROACH, RAMP,OR SIDEWALK, H.E.
CP	PLACE 4" SIDEWALK OR RAMP.
AK	ADJUST MDOT TYPE K CASTING.
TYPE II	MDOT TYPE II BARRICADE.
TYPE III	MDOT TYPE III BARRICADE.
RRK	REMOVE AND REPLACE MOOT TYPE K CASTING. ADJUST TO FINISH GRADE.
RS	RECONSTRUCT STRUCTURE.
RCP	REMOVE CONC. PAVEMENT - ANY THICKNESS
RCW	RAISED CROSSWALK


	LEGEND
SYMBOL	DESCRIPTION
•	EXISTING SANITARY SEWER MANHOLE
0	EXISTING STORM SEWER MANHOLE
•	EXISTING WATER MAIN VALVE IN WELL
+	WATER MAIN GATE VALVE IN BOX
ŵ	FIRE HYDRANT
•	MICHOON GAS CO. VALVE BOX/WELL
•	AMERITECH TELEPHONE VAULT
•	ELECTRIC MANHOLE
•	SOIL BORING
0	EXISTING STORM SEWER INLET
•	MONUMENT BOX
	REMOVE AND REPLACE CONC. SIDEWALK
	PLACE CONCRETE SIDEWALK
	REMOVE & REPLACE CONC. CURB & GUTTER
	CONSTRUCTION LIMITS
	6" WRAPPED UNDERDRAIN
	REMOVE CONCRETE SIDEWALK
	SUBGRADE UNDERCUT
THE TABLE	S A REPERENCE FILE. MANE CHANGES TO THE REPEREN LL UPDATE ALL SHEETS. TO MAKE A CHANGE RIGHT K OPEN XREF, MAKE YOUR EDIT AND SAVE.

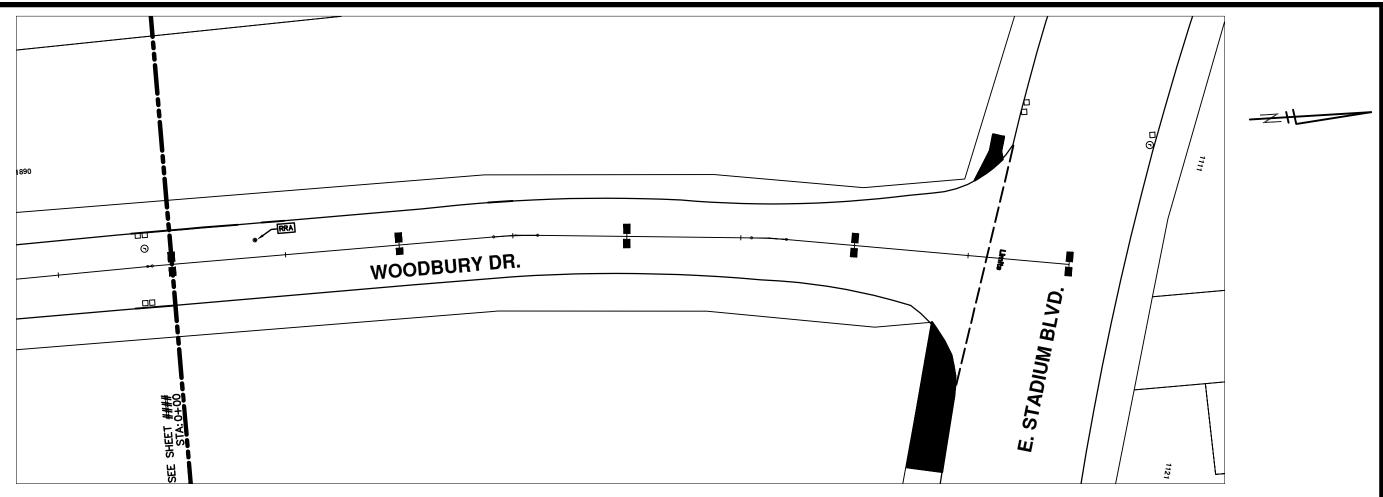

WOODBURY DR.

	CONSTRUCTION KEY
KEY	DESCRIPTION
C/G	REMOVE AND REPLACE CURB AND GUTTER
C/GHE	REMOVE CURB AND GUTTER, REPLACE WITH CONCRETE CURB AND GUTTER H.E.
C4HE	REMOVE EXISTING RAMP OR SIDEWALK. REPLACE WITH 4" SIDEWALK OR TYPE 1 SIDEWALK RAMP, H.E.
CR	REMOVE SIDEWALK, DRIVE OR RAMP.
AA	ADJUST MDOT TYPE A CASTINGS.
AB	ADJUST GATE VALVE BOX OR MONUMENT BOX.
ADST	ADDITIONAL DEPTH STRUCTURE REPAIR.
RRA	REMOVE AND REPLACE MDOT TYPE A CASTING ADJUST TO FINISH GRADE.
CPRHE	CONCRETE PAVEMENT REPAIR, H.E.
DS	CONSTRUCT 2, 3 OR 4' DIAM. DRAINAGE STRUCTURE.
PT	POINT STRUCTURE.
C4	REMOVE EXISTING RAMP OR SIDEWALK, REPLACE WITH 4" SIDEWAL OR RAMP.
C6	REMOVE EXISTING RAMP OR SIDEWALK, REPLACE WITH 6" SIDEWAL OR RAMP
C8	PLACE 8" SIDEWALK OR RAMP ONLY
C HE	REMOVE EXISTING DRIVE APPROACH, RAMP OR SIDEWALK. REPLACE WITH 6" OR 8" APPROACH, RAMP, OR SIDEWALK, H.E.
CP	PLACE 4" SIDEWALK OR RAMP.
AK	ADJUST MDOT TYPE K CASTING.
TYPE II	MDOT TYPE II BARRICADE.
TYPE III	MDOT TYPE III BARRICADE.
RRK	REMOVE AND REPLACE MDOT TYPE K CASTING. ADJUST TO FINISH GRADE.
RS	RECONSTRUCT STRUCTURE.
RCP	REMOVE CONC. PAVEMENT - ANY THICKNESS
RCW	RAISED CROSSWALK

	LEGEND
SYMBOL	DESCRIPTION
•	EXISTING SANITARY SEWER MANHOLE
•	EXISTING STORM SEWER MANHOLE
•	EXISTING WATER MAIN VALVE IN WELL
+	WATER MAIN GATE VALVE IN BOX
₩.	FIRE HYDRANT
•	MICHCON GAS CO. VALVE BOX/WELL
•	AMERITECH TELEPHONE VAULT
•	ELECTRIC MANHOLE
•	SOIL BORING
0	EXISTING STORM SEWER INLET
•	MONUMENT BOX
	REMOVE AND REPLACE CONG. SIDEWALK
	PLACE CONCRETE SIDEWALK
	REMOVE & REPLACE CONC. CURB & GUTTER
	CONSTRUCTION LIMITS
	6" WRAPPED UNDERDRAIN
	REMOVE CONCRETE SIDEWALK
	SUBGRADE UNDERCUT
-THE TABLE	IS A REPRENCE PILE. MAKE CHANGES TO THE REPREN BLL UPDATE ALL SHEETS. TO MAKE A CHANGE RIGHT

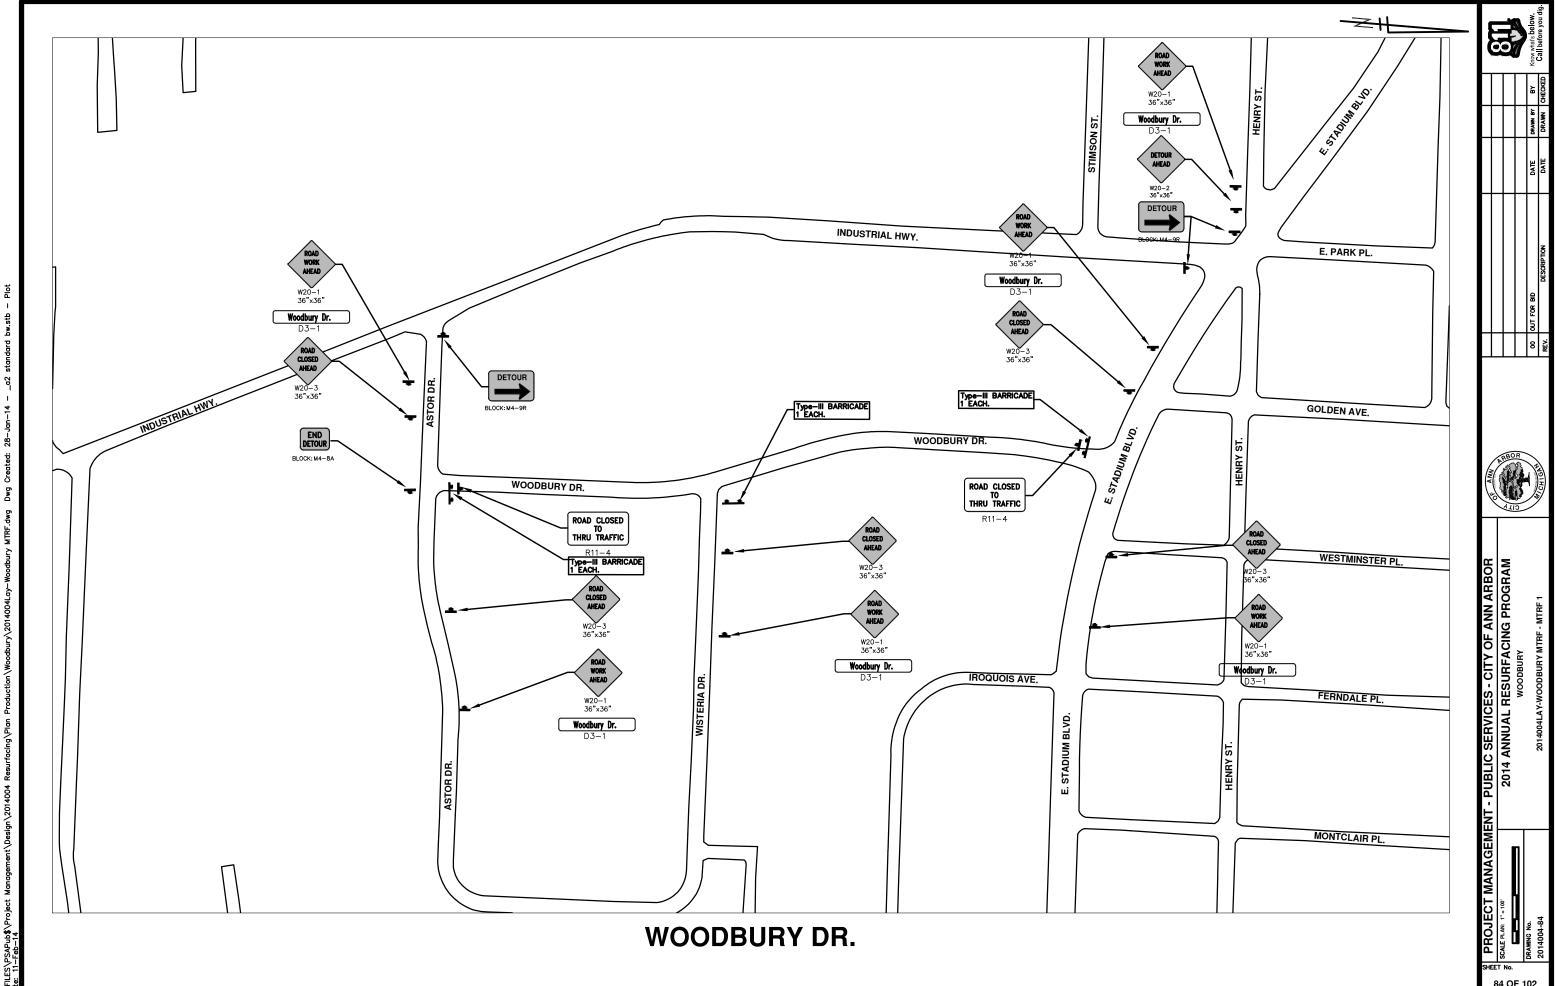



CITY OF ANN ARBOR PROJECT MANAGEMENT 2014 RESURFACING PROJECT PROGRAM PROJECT LOCATION: PRARIE STREET

FILE No. 2014004

	QUANTITIES				
ITEM#	DESCRIPTION	Units	Total		
207	Cold Mill Pavement	Tons	1370		
209	Subgrade Undercutting	C.Y.	920		
222	Bit Pvmnt. Leveling, Regular	Tons	830		
223	Bit Pvmnt. Wearing, Regular	Tons	550		
230	Remove Curb & Gutter	L.F.	1620		
232	Remove Conc. S/Walk & Drive	S.F.	305		
237	Conc. Curb & Gutter	L.F.	1670		
240	4" Sidewalk Or Ramp	S.F.	100		
241	6" Sidewalk & Drives	S.F.	205		
245	Detectable Warning, Cast in Place	S.F.	40		
250	2' Dia. Structure	Each	9		
254	Lower Structures	Each	11		
255	Lwr. Mon. + GV. Box	Each	1		
256	Adj. Structure Covers	Each	11		
257	Adj. Curb Inlet Structure Cover	Each	11		
258	Adj. Mon. & GV. Box	Each	1		
260	Inlet Structure Cover (MDOT K)	Each	2		
264	12" Storm Sewer	L.F.	30		
271	21AA Limestone, C.I.P.	C.Y.	920		
281	Arrow Panel, Furn. & Operate	Each	1		
282	Plastic Drum - Furn. & Operate	Each	110		
283	Type 3 Barr.	Each	6		
284	Temp Signs Type B	S.F.	320		
285	No Parking Signs	Each	38		
595	4" Yellow Thermo.	L.F.	900		
596	6" Rescd Poly Pvmt. Mkg., 6" White Or Yellow	L.F.	500		
597	24" White Thermo.	L.F.	69		
598	Pvmt. Marking Symbol	Each	4		

TRAFFIC CONTROL & SIGN LEGEND			
QTY.	TYPE	DESCRIPTION	
6	W20-1	"ROAD WORK AHEAD"	
6	W20-3	"ROAD CLOSED AHEAD"	
1	W20-5	"(RIGHT OR LEFT) LANE CLOSED AHEAD"	
12	D3-1	CONVENTIONAL GUIDE	
3	TYPE III	TYPE III LIGHTED BARRICADE	
105	TYPE II	TYPE II LIGHTED BARRICADE (DRUM)	
4	R11-2	"ROAD CLOSED"	
5	R11-4	"ROAD CLOSED TO THRU TRAFFIC"	
1		LIGHTED ARROW PANEL	

CONSTRUCTION METHOD AND SEQUENCING

- THE WORK TO BE COMPLETED ON THIS STREET SHALL INCLUDE, BUT NOT BE LIMITED TO THE FOLLOWING ITEMS. THE ORDER OF CONSTRUCTION SHALL BE AS GIVEN UNLESS OTHERWISE AUTHORIZED OR DIRECTED BY THE ENGINEER.
- 2. IMPLEMENT TRAFFIC MAINTENANCE, AND SOIL EROSION CONTROLS IN ACCORDANCE WITH THE PLANS, AND AS DIRECTED BY THE ENGINEER.
- 3. INSTALL ANY PROPOSED STORM SEWER, AND UNDERDRAIN AS SHOWN ON THE PLANS, AND AS DIRECTED BY THE ENGINEER.
- 4. LOWER ALL STRUCTURE COVERS, INCLUDING VALVE AND MONUMENT BOXES.
- 5. PERFORM ALL CONCRETE WORK, INCLUDING RESTORATION, IN ACCORDANCE WITH THE PLANS, AND AS DIRECTED BY THE ENGINEER.
- 6. MILL 5-1/2 INCHES OF BITUMINOUS MATERIAL FROM EXISTING ROADWAY. THIS MAY INCLUDE GRANULAR ROAD BASE MATERIAL. DEPTH TO BE DETERMINED BY THE ENGINEER.
- 7. GRADE, SHAPE, AND RE-COMPACT THE EXISTING ROAD BASE AS REQUIRED, AND AS DIRECTED BY THE ENGINEER.
- 8. PAVE 2-1/2 INCHES OF THE BITUMINOUS MIX SPECIFIED OR DIRECTED, AS THE BASE COURSE, IN ONE LIFT.
- 9. PAVE 1-1/2 INCHES OF THE BITUMINOUS MIX SPECIFIED OR DIRECTED, AS THE LEVELING COURSE, IN ONE LIFT.

10. ADJUST ALL STRUCTURE COVERS, MONUMENT BOXES, AND VALVE BOXES TO THEIR FINISHED ELEVATIONS.

- 11. PAVE 1-1/2 INCHES OF THE BITUMINOUS MIX SPECIFIED OR DIRECTED, AS THE WEARING COURSE, IN ONE LIFT.
- 12. COMPLETE ALL PAVEMENT MARKINGS AS PER PLAN OR AS DIRECTED BY THE ENGINEER.
- 13. COMPLETE ALL MISCELLANEOUS CONSTRUCTION INCLUDING ALL CLEAN-UP AND FINAL RESTORATION.
- 14. REMOVE ALL TRAFFIC CONTROL DEVICES. REMOVE MISS DIG FLAGS.

NOTES:

THE CONSTRUCTION COVERED BY THESE PLANS SHALL CONFORM TO THE 1994 EDITION OF THE CITY OF ANN ARBOR PUBLIC SERVICES DEPARTMEN STANDARD SPECIFICATIONS AND IT'S DETAILS WHICH ARE INCLUDED BY REFERENCE. THE OMISSION OF ANY CURRENT STANDARD DETAIL DOES NOT RELIEVE THE CONTRACTOR FROM THIS REQUIREMENT. THE WORK SHALL BE PERFORMED IN COMPLETE CONFORMANCE WITH THE CURRENT PUBLIC SERVICES STANDARD SPECIFICATIONS AND DETAILS.

FOR PROTECTION OF UNDERGROUND UTILITIES AND IN CONFORMANCE WITH PUBLIC ACT 53, THE CONTRACTOR SHALL CALL 811 OR 1-800-482-7171 A MINIMUM OF THREE FULL WORKING DAYS, EXCLUDING SATURDAYS, SUNDAYS, AND HOLIDAYS PRIOR TO BEGINNING EACH EXCAVATION IN AREAS WHERE PUBLIC UTILITIES HAVE NOT BEEN PREVIOUSLY LOCATED. MEMBERS WILL THUS BE ROUTINELY NOTIFIED. THIS DOES NOT RELIEVE THE CONTRACTOR OF THE RESPONSIBILITY OF NOTIFYING UTILITY OWNERS WHO MAY NOT BE A PART OF THE "MISS DIG" ALERT SYSTEM.

THE UNDERGROUND LOCATIONS SHOWN FOR NATURAL GAS (GAS),
TELEPHONE (TEL), ELECTRICAL POWER (PWR), CABLE TV (CTV) AND
FIBER OPTIC LINES (FIBER) ARE APPROXIMATE. THE CITY OF ANN
ARBOR ASSUMES NO RESPONSIBILITY FOR THEIR ACCURATE
REPRESENTATION IN THIS DRAWING. MISS DIG MUST BE CONTACTED PRIOR
TO CONSTRUCTION TO LOCATE THESE UTILITIES.

OF ANN PROBATION OF AND

PROJECT MANAGEMENT SERVICE UNIT

CITY OF ANN ARBOR PUBLIC SERVICE 301 EAST HURON STREET, P.O. BOX 8647 ANN ARBOR, MICHIGAN 48107-8647 734-794-6410 www.a2gov.org Know what's below.


RVICES - CITY OF ANN ARB


EMENT - PUBLIC SE

ECT MANAGEMENT
PROJECT

DRAWING No.

SHEET No. **85 TO 102**

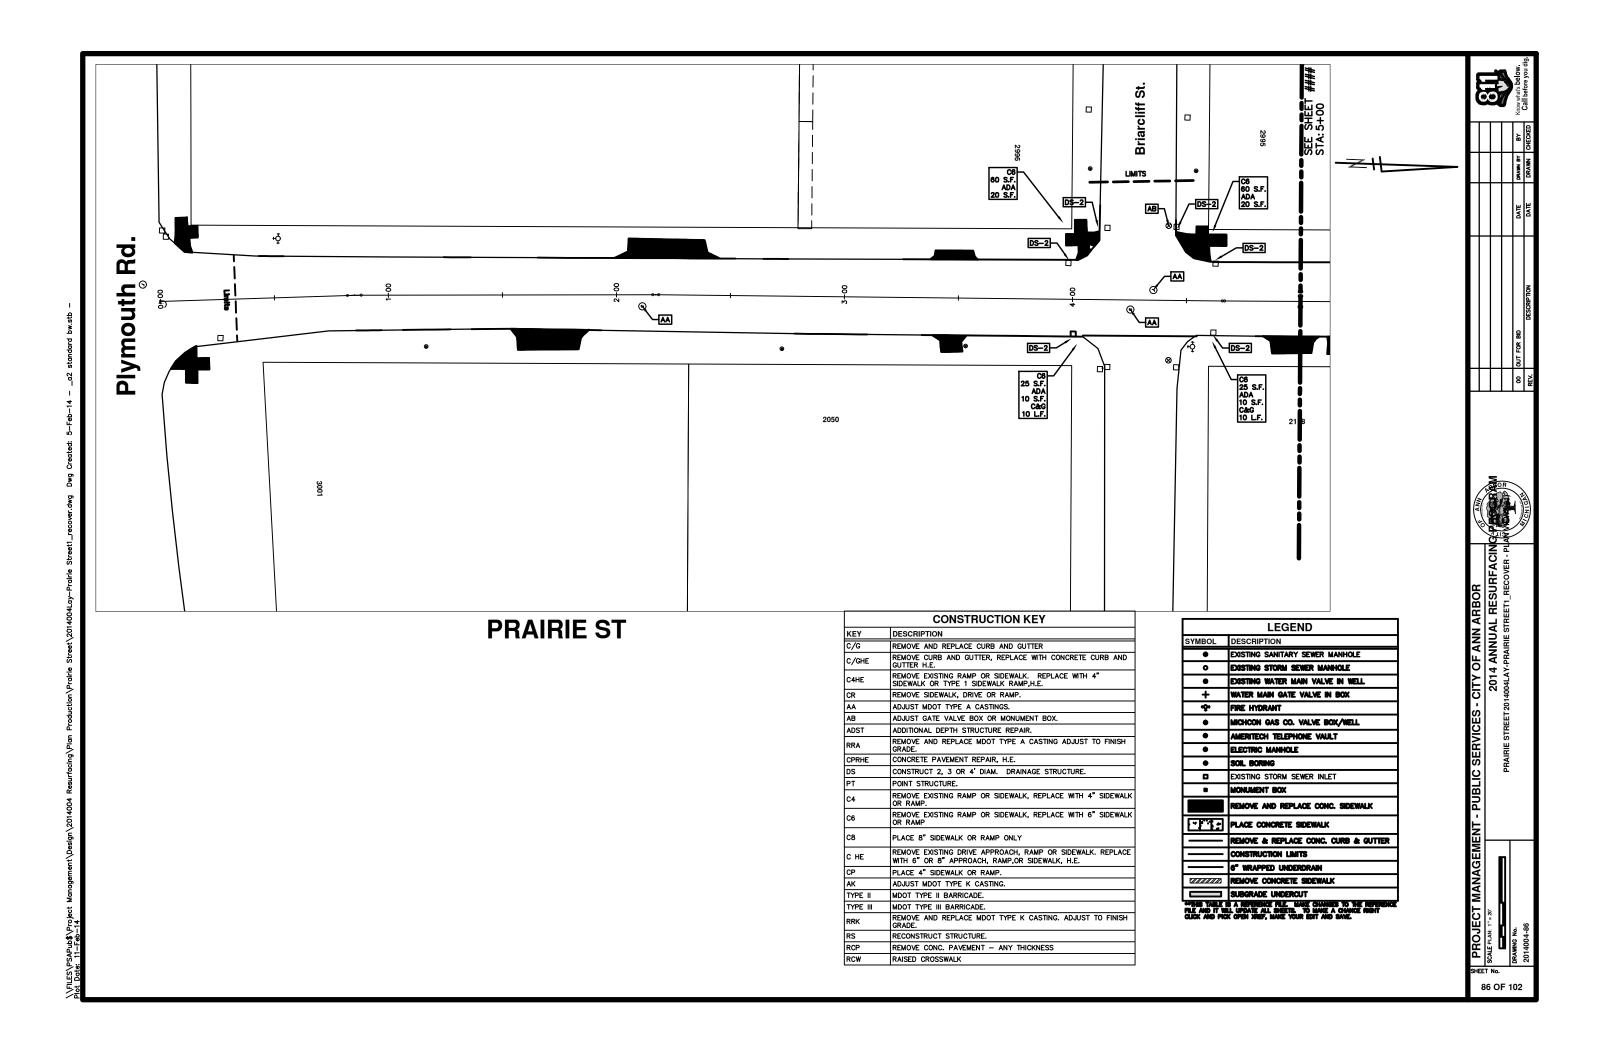

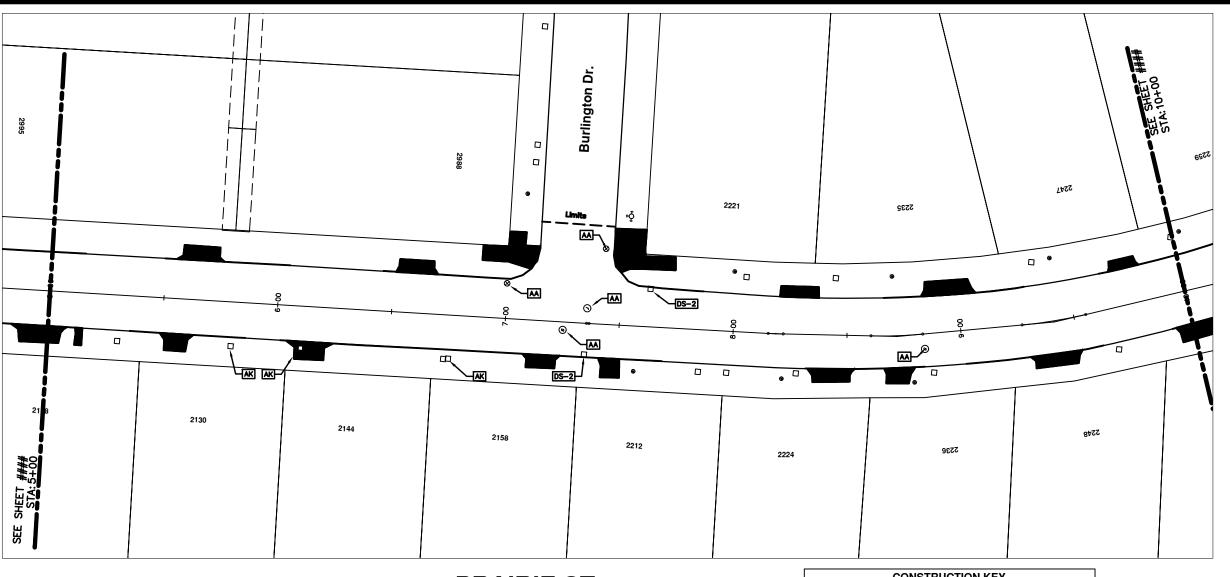




PRAIRIE ST

	CONSTRUCTION KEY
KEY	DESCRIPTION
C/G	REMOVE AND REPLACE CURB AND GUTTER
C/GHE	REMOVE CURB AND GUTTER, REPLACE WITH CONCRETE CURB AND GUTTER H.E.
C4HE	REMOVE EXISTING RAMP OR SIDEWALK. REPLACE WITH 4" SIDEWALK OR TYPE 1 SIDEWALK RAMP,H.E.
CR	REMOVE SIDEWALK, DRIVE OR RAMP.
AA	ADJUST MDOT TYPE A CASTINGS.
AB	ADJUST GATE VALVE BOX OR MONUMENT BOX.
ADST	ADDITIONAL DEPTH STRUCTURE REPAIR.
RRA	REMOVE AND REPLACE MDOT TYPE A CASTING ADJUST TO FINISH GRADE.
CPRHE	CONCRETE PAVEMENT REPAIR, H.E.
DS	CONSTRUCT 2, 3 OR 4' DIAM. DRAINAGE STRUCTURE.
PT	POINT STRUCTURE.
C4	REMOVE EXISTING RAMP OR SIDEWALK, REPLACE WITH 4" SIDEWAL OR RAMP.
C6	REMOVE EXISTING RAMP OR SIDEWALK, REPLACE WITH 6" SIDEWAL OR RAMP
СВ	PLACE 8" SIDEWALK OR RAMP ONLY
СНЕ	REMOVE EXISTING DRIVE APPROACH, RAMP OR SIDEWALK. REPLAC WITH 6" OR 8" APPROACH, RAMP,OR SIDEWALK, H.E.
CP	PLACE 4" SIDEWALK OR RAMP.
AK	ADJUST MDOT TYPE K CASTING.
TYPE II	MDOT TYPE II BARRICADE.
TYPE III	MDOT TYPE III BARRICADE.
RRK	REMOVE AND REPLACE MDOT TYPE K CASTING. ADJUST TO FINISH GRADE.
RS	RECONSTRUCT STRUCTURE.
RCP	REMOVE CONC. PAVEMENT - ANY THICKNESS
RCW	RAISED CROSSWALK

LEGEND	
SYMBOL	DESCRIPTION
•	EXISTING SANITARY SEWER MANHOLE
0	EXISTING STORM SEWER MANHOLE
•	EXISTING WATER MAIN VALVE IN WELL
+	WATER MAIN GATE VALVE IN BOX
÷	FIRE HYDRANT
•	MICHCON GAS CO. VALVE BOX/MELL
•	AMERITECH TELEPHONE VAULT
•	ELECTRIC MANHOLE
•	SOIL BORING
0	EXISTING STORM SEWER INLET
•	MONUMENT BOX
	REMOVE AND REPLACE CONG. SIDEWALK
	PLACE CONCRETE SIDEWALK
	REMOVE & REPLACE CONG. CURB & GUTTER
	CONSTRUCTION LIMITS
	6" WRAPPED UNDERDRAIN
	REMOVE CONCRETE SIDEWALK
	SUBGRADE UNDERCUT
PLE AND IT Y	IS A REPERENCE PILE. MAKE CHANGES TO THE REPERENCE BLL UPDATE ALL SHEETS. TO MAKE A CHANGE RIGHT

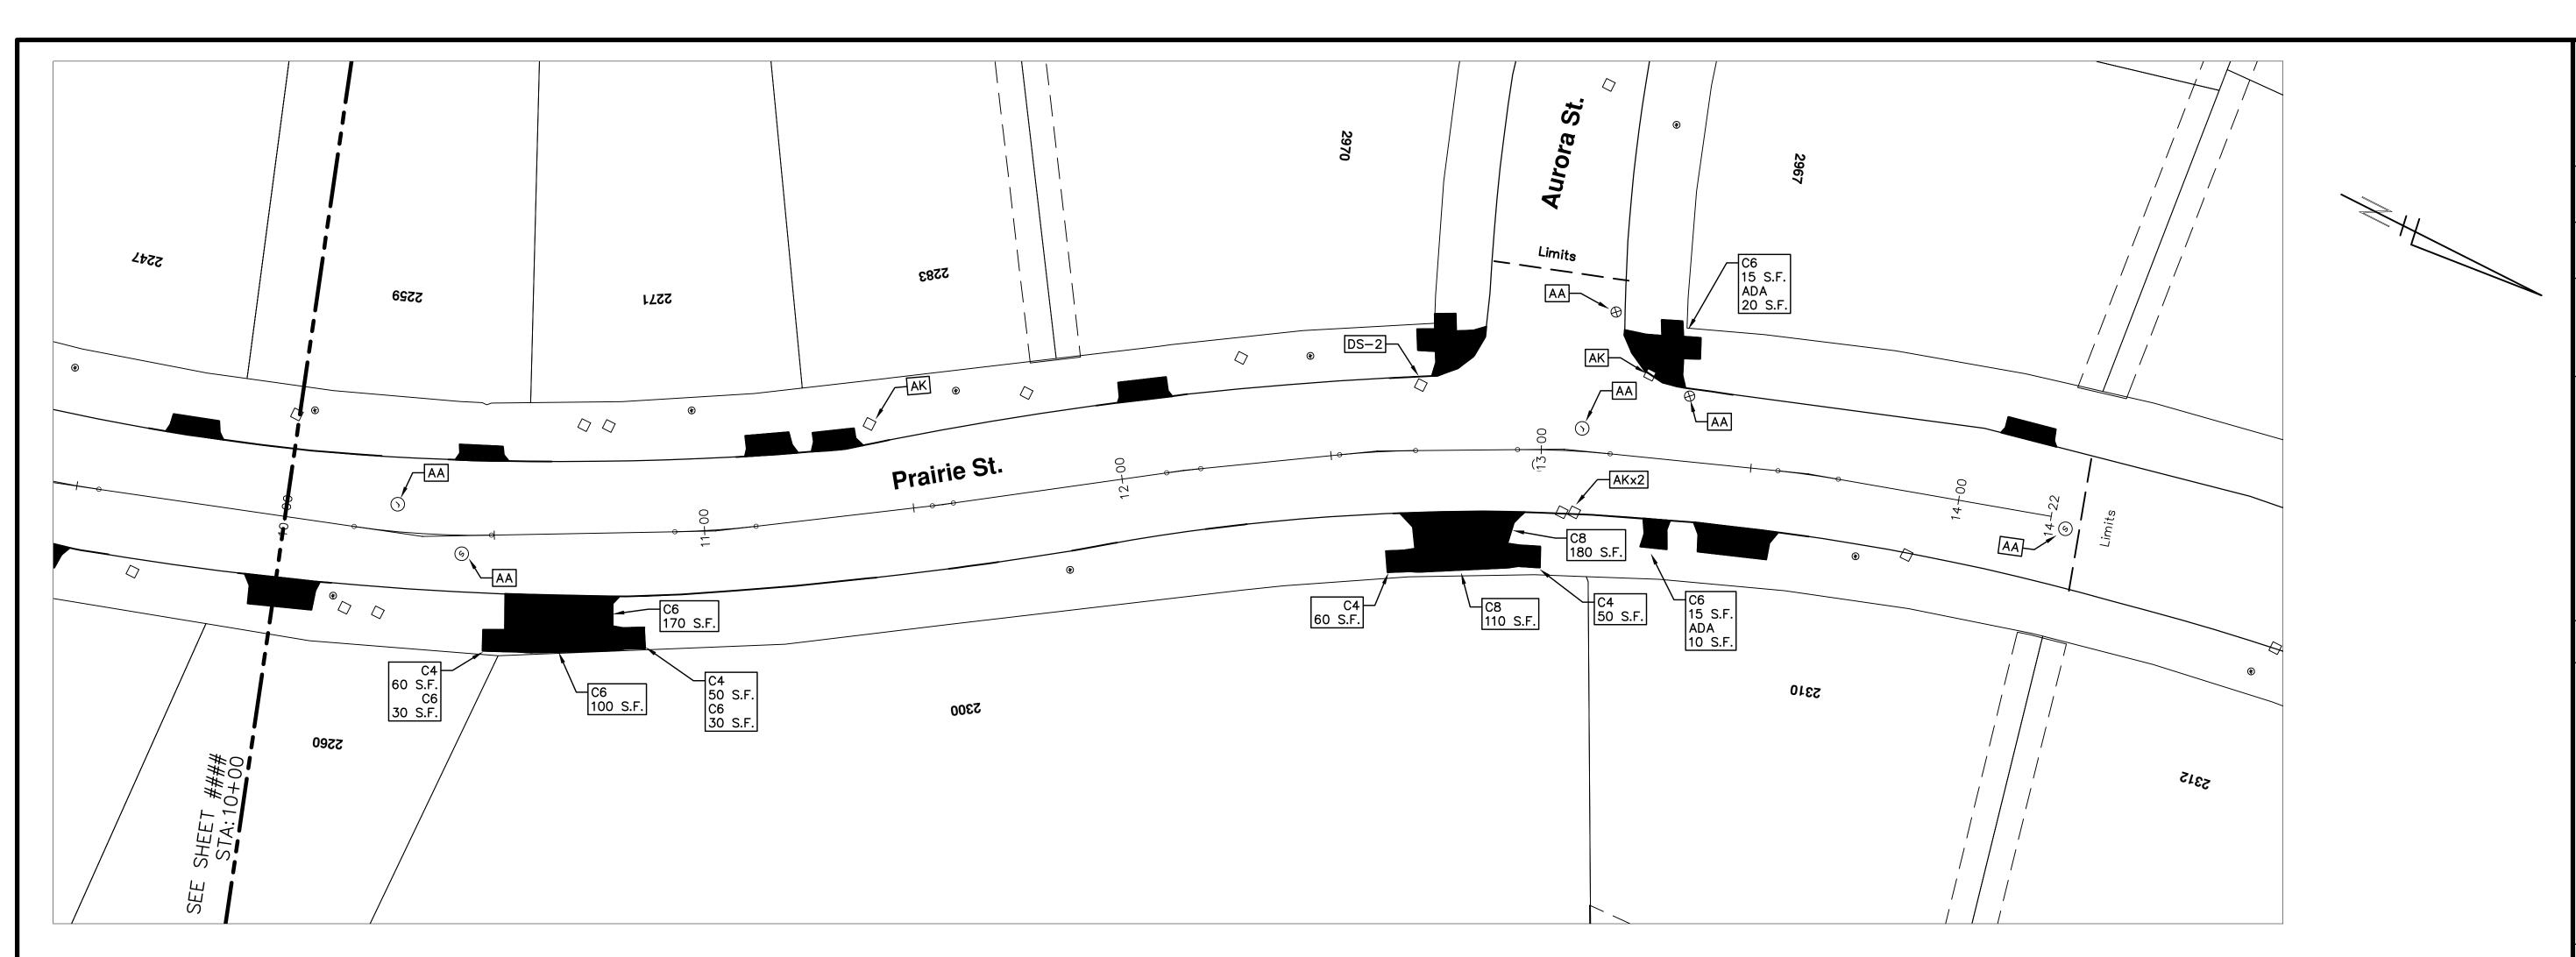

PRAIRIE ST

	CONSTRUCTION KEY		
KEY	DESCRIPTION		
C/G	REMOVE AND REPLACE CURB AND GUTTER		
C/GHE	REMOVE CURB AND GUTTER, REPLACE WITH CONCRETE CURB AND GUTTER H.E.		
C4HE	REMOVE EXISTING RAMP OR SIDEWALK. REPLACE WITH 4" SIDEWALK OR TYPE 1 SIDEWALK RAMP, H.E.		
CR	REMOVE SIDEWALK, DRIVE OR RAMP.		
AA	ADJUST MDOT TYPE A CASTINGS.		
AB	ADJUST GATE VALVE BOX OR MONUMENT BOX.		
ADST	ADDITIONAL DEPTH STRUCTURE REPAIR.		
RRA	REMOVE AND REPLACE MDOT TYPE A CASTING ADJUST TO FINISH GRADE.		
CPRHE	CONCRETE PAVEMENT REPAIR, H.E.		
DS	CONSTRUCT 2, 3 OR 4' DIAM. DRAINAGE STRUCTURE.		
PT	POINT STRUCTURE.		
C4	REMOVE EXISTING RAMP OR SIDEWALK, REPLACE WITH 4" SIDEWAL OR RAMP.		
C6	REMOVE EXISTING RAMP OR SIDEWALK, REPLACE WITH 6" SIDEWALI OR RAMP		
C8	PLACE 8" SIDEWALK OR RAMP ONLY		
С НЕ	REMOVE EXISTING DRIVE APPROACH, RAMP OR SIDEWALK. REPLACE WITH 6" OR 8" APPROACH, RAMP,OR SIDEWALK, H.E.		
CP	PLACE 4" SIDEWALK OR RAMP.		
AK	ADJUST MDOT TYPE K CASTING.		
TYPE II	MDOT TYPE II BARRICADE.		
TYPE III	MDOT TYPE III BARRICADE.		
RRK	REMOVE AND REPLACE MDOT TYPE K CASTING. ADJUST TO FINISH GRADE.		
RS	RECONSTRUCT STRUCTURE.		
RCP	REMOVE CONC. PAVEMENT - ANY THICKNESS		
RCW	RAISED CROSSWALK		

LEGEND		
SYMBOL	DESCRIPTION	
@	EXISTING SANITARY SEWER MANHOLE	
0	EXISTING STORM SEWER MANHOLE	
8	EXISTING WATER MAIN VALVE IN WELL	
+	WATER MAIN GATE VALVE IN BOX	
+ Ç +	FIRE HYDRANT	
•	MICHCON GAS CO. VALVE BOX/WELL	
•	AMERITECH TELEPHONE VAULT	
•	ELECTRIC MANHOLE	
•	SOIL BORING	
	EXISTING STORM SEWER INLET	
0	MONUMENT BOX	
	REMOVE AND REPLACE CONC. SIDEWALK	
	PLACE CONCRETE SIDEWALK	
	REMOVE & REPLACE CONC. CURB & GUTTER	
	CONSTRUCTION LIMITS	
	6" WRAPPED UNDERDRAIN	
	REMOVE CONCRETE SIDEWALK	
	SUBGRADE UNDERCUT	


PROJECT MANAGEMENT - PUBLIC SERVICES - CITY OF ANN ARBOR

2014 ANNUAL RESURFACIN

PRAIRIE STREET2014004LAY-PRAIRIE STREET1_RECOVER - PL

2014004-88

\\FILES\PSAPub\$\Project Management\Design\2014004 Resurfacing\Plan Production\Prairie Street\2014004Lay—Prairie

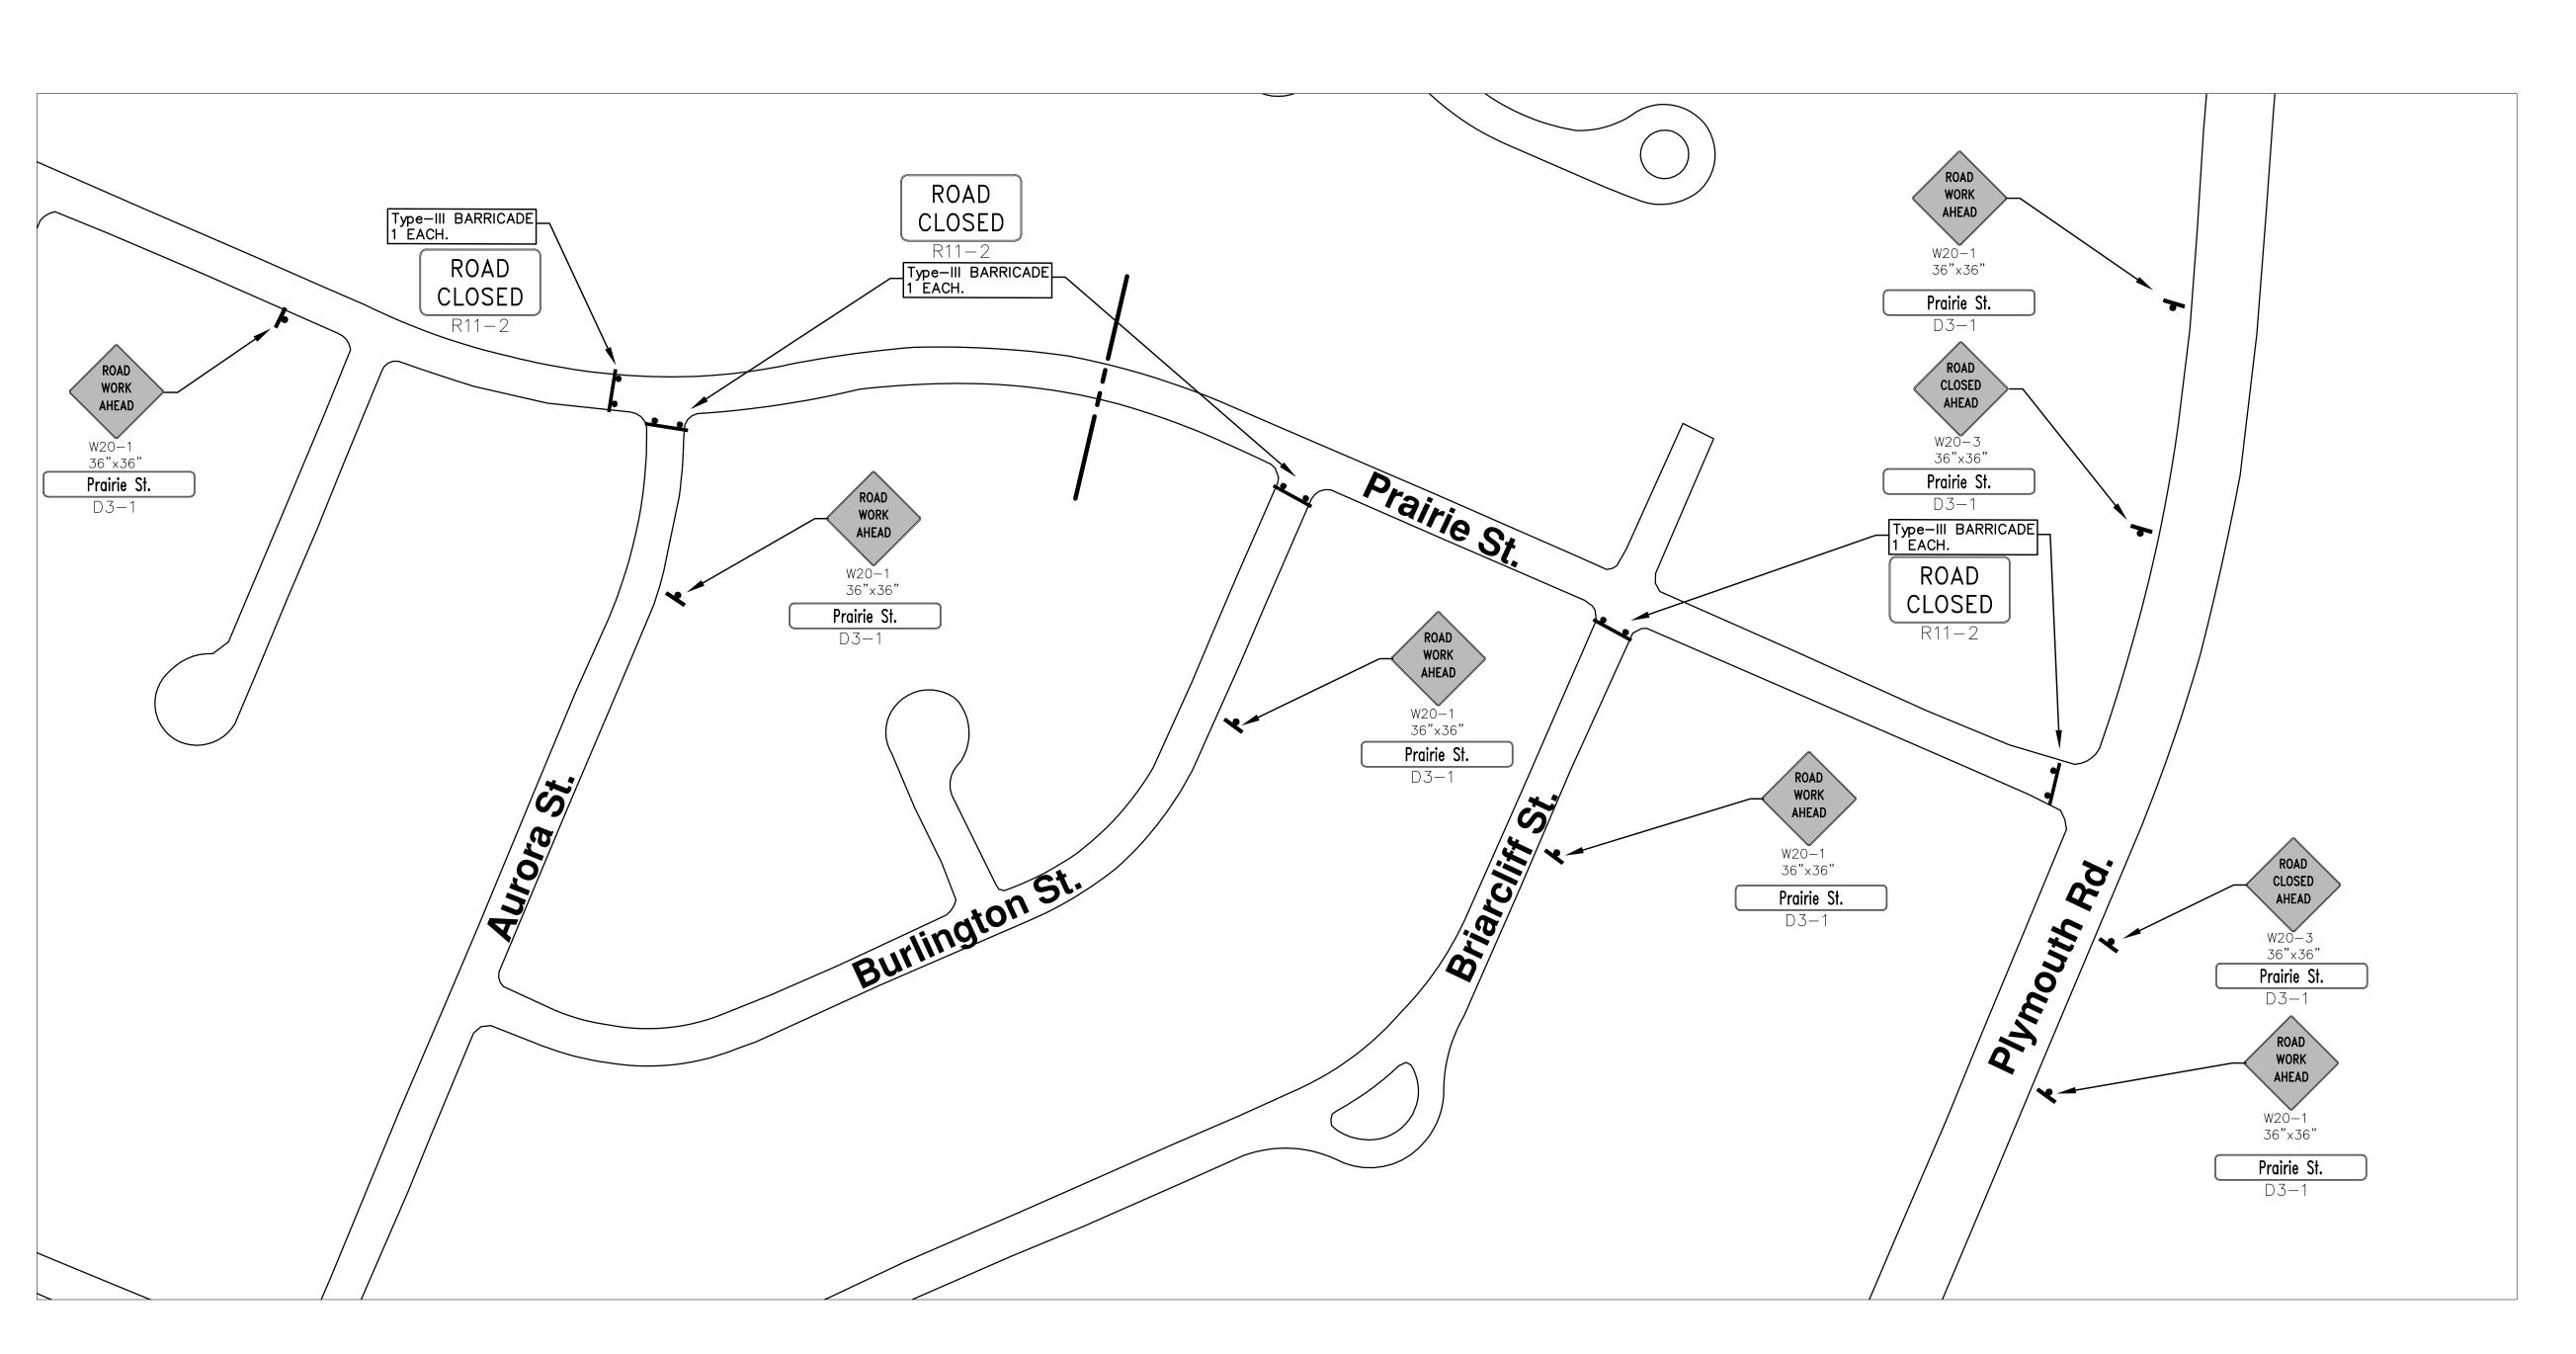

PRAIRIE ST



CITY OF ANN ARBOR PROJECT MANAGEMENT 2014 ANNUAL RESURFACING PROGRAM PROJECT LOCATION: BURLINGTON COURT

FILE No. 2014004

	QUANTITIES			
ITEM#	DESCRIPTION	Units	Total	
207	Cold Milling Pavement	Tons	320	
209	Subgrade Undercutting - Type II	C.Y.	120	
222	HMA Pavement Leveling, Regular	Tons	200	
223	HMA Pavement Wearing, Regular	Tons	130	
230	Rem. Curb & Gutter, Any Type	L.F.	220	
237	Conc. Curb & Gutter - Any Type - Fixed Form	L.F.	220	
250	2' Dia. Structure	Each	1	
254	Lower Structure Cover	Each	2	
256	Adjust Structure Cover	Each	2	
257	Adjust Curb Inlet Structure Cover	Each	2	
264	12" Sewer, Trench Detail I, Modified	L.F.	10	
271	21AA Limestone - C.I.P.	C.Y.	120	
282	Plastic Drum - Lighted - Furn. & Operate	Each	30	
283	Barricade Type III - Furn. & Operate	Each	1	
284	Temp Signs Type - B	S.F.	40	
285	No Parking Sign	Each	8	
596	Rescd. Poly Pvmt. Mkg., 6" White or Yellow	L.F.	66	

TRAFFIC CONTROL & SIGN LEGEND			
QTY.	TYPE	DESCRIPTION	
2	W20-1	"ROAD WORK AHEAD"	
2	D3-1	CONVENTIONAL GUIDE	
1	TYPE III	TYPE III LIGHTED BARRICADE	
30	TYPE II	TYPE II LIGHTED BARRICADE (DRUM)	

CONSTRUCTION METHOD AND SEQUENCING

- THE WORK TO BE COMPLETED ON THIS STREET SHALL INCLUDE, BUT NOT BE LIMITED TO THE FOLLOWING ITEMS. THE ORDER OF CONSTRUCTION SHALL BE AS GIVEN UNLESS OTHERWISE AUTHORIZED OR DIRECTED BY THE ENGINEER.
- IMPLEMENT TRAFFIC MAINTENANCE, "NO PARKING" SIGNS AND SOIL EROSION CONTROLS IN ACCORDANCE WITH THE PLANS, AND AS DIRECTED BY THE ENGINEER.
- 3. INSTALL ANY PROPOSED STORM SEWER, AND UNDERDRAIN AS SHOWN ON THE PLANS, AND AS DIRECTED BY THE ENGINEER.
- 4. LOWER ALL STRUCTURE COVERS, INCLUDING VALVE AND MONUMENT BOXES.
- 5. PERFORM ALL CONCRETE WORK, INCLUDING RESTORATION, IN ACCORDANCE WITH THE PLANS, AND AS DIRECTED BY THE ENGINEER.
- 6. MILL 5 INCHES OF BITUMINOUS MATERIAL FROM EXISTING ROADWAY DOWN TO ROAD BASE. THIS MAY INCLUDE GRANULAR ROAD BASE MATERIAL. DEPTH TO BE DETERMINED BY THE ENGINEER. PROOF ROLL WITH FULL TRUCK.
- 7. PERFORM UNDERCUTS AND/OR BASE REPAIRS AS DIRECTED BY THE ENGINEER.
- 8. GRADE, SHAPE, UNDERCUT AND RE-COMPACT THE ROAD BASE AS REQUIRED, AND AS DIRECTED BY THE ENGINEER.
- 9. PAVE 3 INCHES OF THE BITUMINOUS MIX AS SPECIFIED OR DIRECTED BY THE ENGINEER, AS THE LEVELING COURSE, IN ONE LIFT.
- 10. ADJUST ALL STRUCTURE COVERS, MONUMENT BOXES, AND VALVE BOXES TO THEIR FINISHED ELEVATIONS.
- 11. PAVE 2 INCHES OF THE BITUMINOUS MIX AS SPECIFIED OR DIRECTED BY THE ENGINEER, AS THE WEARING COURSE, IN ONE LIFT.
- 12. COMPLETE ALL PAVEMENT MARKINGS IN ACCORDANCE WITH THE PLANS, AND AS DIRECTED BY THE ENGINEER.
- 13. COMPLETE ALL MISCELLANEOUS CONSTRUCTION INCLUDING ALL CLEAN-UP AND FINAL RESTORATION.
- 14. REMOVE ALL TRAFFIC CONTROL DEVICES. REMOVE MISS DIG FLAGS.

NOTES:

THE CONSTRUCTION COVERED BY THESE PLANS SHALL CONFORM TO THE 1994 EDITION OF THE CITY OF ANN ARBOR PUBLIC SERVICES DEPARTMENT STANDARD SPECIFICATIONS AND IT'S DETAILS WHICH ARE INCLUDED BY REFERENCE. THE OMISSION OF ANY CURRENT STANDARD DETAIL DOES NOT RELIEVE THE CONTRACTOR FROM THIS REQUIREMENT. THE WORK SHALL BE PERFORMED IN COMPLETE CONFORMANCE WITH THE CURRENT PUBLIC SERVICES STANDARD SPECIFICATIONS AND DETAILS.

FOR PROTECTION OF UNDERGROUND UTILITIES AND IN CONFORMANCE WITH PUBLIC ACT 53, THE CONTRACTOR SHALL CALL 811 OR 1-800-482-7171 A MINIMUM OF THREE FULL WORKING DAYS, EXCLUDING SATURDAYS, SUNDAYS, AND HOLIDAYS PRIOR TO BEGINNING EACH EXCAVATION IN AREAS WHERE PUBLIC UTILITIES HAVE NOT BEEN PREVIOUSLY LOCATED. MEMBERS WILL THUS DER KOUTINELY NOTIFIED. THIS DOES NOT RELIEVE THE CONTRACTOR OF THE RESPONSIBILITY OF NOTIFYING UTILITY OWNERS WHO MAY NOT BE A PART OF THE "MISS DIG" ALERT SYSTEM.

THE UNDERGROUND LOCATIONS SHOWN FOR NATURAL GAS (GAS), TELEPHONE (TEL), ELECTRICAL POWER (PWR), CABLE TV (CTV) AND FIBER OPTIC LINES (FIBER) ARE APPROXIMATE. THE CITY OF ANN ARBOR ASSUMES NO RESPONSIBILITY FOR THEIR ACCURATE REPRESENTATION IN THIS DRAWING. MISS DIG MUST BE CONTACTED PRIOR TO CONSTRUCTION TO LOCATE THESE UTILITIES.

PROJECT MANAGEMENT SERVICE UNIT


CITY OF ANN ARBOR PUBLIC SERVICE
301 EAST HURON STREET, P.O. BOX 8647
ANN ARBOR, MICHIGAN 48107-8647
734-794-6410 www.a2gov.org

ERVICES - CITY OF ANN ARBOR
2014 ANNUAL RESURFACING

MENT - PUBLIC SE

lG No. 004 - 90

| |<u>|</u> HEET №. 90 TO 102

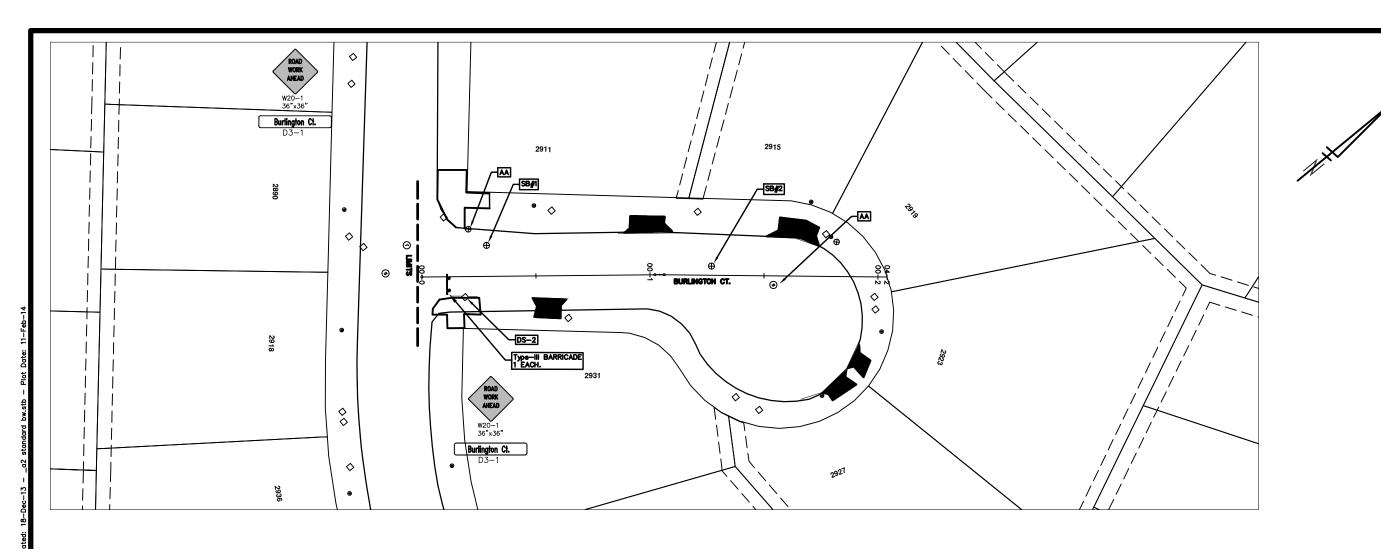

BURLINGTON CT.

	CONSTRUCTION KEY		
KEY	DESCRIPTION		
C/G	REMOVE AND REPLACE CURB AND GUTTER		
C/GHE	REMOVE CURB AND GUTTER, REPLACE WITH CONCRETE CURB AND GUTTER H.E.		
C4HE	REMOVE EXISTING RAMP OR SIDEWALK. REPLACE WITH 4" SIDEWALK OR TYPE 1 SIDEWALK RAMP,H.E.		
CR	REMOVE SIDEWALK, DRIVE OR RAMP.		
AA	ADJUST MDOT TYPE A CASTINGS.		
AB	ADJUST GATE VALVE BOX OR MONUMENT BOX.		
ADST	ADDITIONAL DEPTH STRUCTURE REPAIR.		
RRA	REMOVE AND REPLACE MDOT TYPE A CASTING ADJUST TO FINISH GRADE.		
CPRHE	CONCRETE PAVEMENT REPAIR, H.E.		
DS	CONSTRUCT 2, 3 OR 4' DIAM. DRAINAGE STRUCTURE.		
PT	POINT STRUCTURE.		
C4	REMOVE EXISTING RAMP OR SIDEWALK, REPLACE WITH 4" SIDEWALK OR RAMP.		
C6	REMOVE EXISTING RAMP OR SIDEWALK, REPLACE WITH 6" SIDEWALK OR RAMP		
СВ	PLACE 8" SIDEWALK OR RAMP ONLY		
C HE	REMOVE EXISTING DRIVE APPROACH, RAMP OR SIDEWALK. REPLACE WITH 6" OR 8" APPROACH, RAMP,OR SIDEWALK, H.E.		
CP	PLACE 4" SIDEWALK OR RAMP.		
AK	ADJUST MDOT TYPE K CASTING.		
TYPE II	MDOT TYPE II BARRICADE.		
TYPE III	MDOT TYPE III BARRICADE.		
RRK	REMOVE AND REPLACE MDOT TYPE K CASTING. ADJUST TO FINISH GRADE.		
RS	RECONSTRUCT STRUCTURE.		
RCP	REMOVE CONC. PAVEMENT - ANY THICKNESS		
RCW	RAISED CROSSWALK		

	LEGEND
SYMBOL	DESCRIPTION
•	EXISTING SANITARY SEWER MANHOLE
0	EXISTING STORM SEWER MANHOLE
•	EXISTING WATER MAIN VALVE IN WELL
+	WATER MAIN GATE VALVE IN BOX
φ.	FIRE HYDRANT
•	MICHOON GAS CO. VALVE BOX/NELL
•	AMERITECH TELEPHONE VAULT
•	ELECTRIC MANHOLE
•	SOIL BORING
0	EXISTING STORM SEWER INLET
•	MONUMENT BOX
	REMOVE AND REPLACE CONC. SIDEWALK
77:	PLACE CONCRETE SIDEWALK
	REMOVE & REPLACE CONC. CURB & GUTTER
	CONSTRUCTION LIMITS
	6" WRAPPED UNDERDRAIN
	REMOVE CONCRETE SIDEWALK
	SUBGRADE UNDERCUT
FILE AND IT W	S A REPERENCE PILE. MANE CHANGES TO THE REPERENCE LL UPDATE ALL SHEETS. TO MAKE A CHANCE RIGHT



CITY OF ANN ARBOR PROJECT MANAGEMENT 2014 ANNUAL RESURFACING PROGRAM PROJECT LOCATION: WALDENWOOD

FILE No. 2014004

DRIVE & COURTS

	QUANTITIES			
ITEM#	DESCRIPTION	Units	Total	
206	Remove HMA Pavement	S.Y.	90	
207	Cold Mill Pavement	Tons	2200	
209	Subgrade Undercutting	C.Y.	1900	
220	HMA Patching	Tons	20	
222	HMA Pavement. Leveling, Regular	Tons	1220	
223	HMA Pavement Wearing, Regular	Tons	910	
230	Rem. Curb & Gutter, Any Type	L.F.	2750	
232	Rem. Conc. SideWalk & Drive - Any Thickness	S.F.	4450	
237	Conc. Curb & Gutter - Any type - Fixed Form	L.F.	2750	
240	4" Sidewalk Or Ramp	S.F.	6355	
241	6" Drive, Sidewalk & Ramp	S.F.	1210	
245	Detectable Warning, Cast in Place	S.F.	340	
247	Integral Sidewalk Ret. Wall (6"-18")	S.F.	200	
250	2' Dia. Structure	Each	13	
251	Double Inlet Structure	Each	3	
252	Reconstruct Structure	Each	1	
254	Lower Structure Cover	Each	38	
255	Lower Mon./Gate Valve Box	Each	4	
256	Adjust Structure Cover	Each	38	
257	Adjust Curb Inlet Structure Cover	Each	28	
258	Adjust Mon. & Gate Valve Box	Each	4	
259	Manhole Flange & Cover (MDOT Type A)	Each	32	
261	Point Structure	Each	5	
264	12" Sewer, Trench Detail I, Modified	L.F.	78	
268	Flowable Fill	C.Y.	45	
271	21AA Limestone - C.I.P.	C.Y.	1900	
281	Arrow Panel, Furnish & Operate	Each	1	
282	Plastic Drum - Furnish & Operate	Each	140	
283	Barricade Type III - Furn. & Operate	Each	7	
284	Temp Signs - Type B	S.F.	440	
285	No Parking Sign	Each	80	
596	Rec. Polyurea Pvmt. Mkg., 6" White or Yellow	L.F.	965	
597	Rec. Polyurea Pvmt. Mkg., 24" White or Yellow	L.F.	75	

TRAFFIC CONTROL & SIGN LEGEND		
QTY.	TYPE	DESCRIPTION
10	W20-1	"ROAD WORK AHEAD"
10	W20-3	"ROAD CLOSED AHEAD"
20	D3-1	CONVENTIONAL GUIDE
9	TYPE III	TYPE III LIGHTED BARRICADE
140	TYPE II	TYPE II LIGHTED BARRICADE (DRUM)

CONSTRUCTION METHOD AND SEQUENCING

- THE WORK TO BE COMPLETED ON THIS STREET SHALL INCLUDE, BUT NOT BE LIMITED TO THE
 FOLLOWING ITEMS. THE ORDER OF CONSTRUCTION SHALL BE AS GIVEN UNLESS OTHERWISE AUTHORIZED
 OR DIRECTED BY THE ENGINEER.
- IMPLEMENT TRAFFIC MAINTENANCE, AND SOIL EROSION CONTROLS IN ACCORDANCE WITH THE PLANS, AND AS DIRECTED BY THE ENGINEER. THERE ARE 14 METER BAGS TO BE COVERED.
- 3. INSTALL ANY PROPOSED STORM SEWER, AND UNDERDRAIN AS SHOWN ON THE PLANS, AND AS DIRECTED BY THE ENGINEER.
- 4. LOWER ALL STRUCTURE COVERS, INCLUDING VALVE AND MONUMENT BOXES.
- 5. PERFORM ALL CONCRETE WORK, INCLUDING RESTORATION, IN ACCORDANCE WITH THE PLANS, AND AS DIRECTED BY THE ENGINEER.
- . MILL 3-1/2 INCHES OF BITUMINOUS MATERIAL FROM EXISTING ROADWAY. THIS MAY INCLUDE GRANULAR ROAD BASE MATERIAL DEPTH TO BE DETERMINED BY THE ENGINEER. PROOF ROLL WITH FULL TRUCK.
- 7. PERFORM UNDERCUTS AND AND/OR BASE REPAIRS AS DIRECTED BY THE ENGINEER.
- 8. Grade, shape, and re-compact the existing road base as required, and as directed by the engineer.
- 9. PAVE 2 INCHES OF THE BITUMINOUS MIX AS SPECIFIED OR DIRECTED BY THE ENGINEER, AS THE LEVELING COURSE, IN ONE LIFT.
- 10. ADJUST ALL STRUCTURE COVERS, MONUMENT BOXES, AND VALVE BOXES TO THEIR FINISHED ELEVATIONS.
- 11. PAVE 1-1/2 INCHES OF THE BITUMINOUS MIX AS SPECIFIED OR DIRECTED BY THE ENGINEER, AS THE WEARING COURSE, IN ONE LIFT.
- 12. COMPLETE ALL PAVEMENT MARKINGS IN ACCORDANCE WITH THE PLANS, AND AS DIRECTED BY THE ENGINEER.
- 13. COMPLETE ALL MISCELLANEOUS CONSTRUCTION INCLUDING ALL CLEAN-UP AND FINAL RESTORATION.
- 14. REMOVE ALL TRAFFIC CONTROL DEVICES. REMOVE MISS DIG FLAGS.

NOTES:

THE CONSTRUCTION COVERED BY THESE PLANS SHALL CONFORM TO THE 1994 EDITION OF THE CITY OF ANN ARBOR PUBLIC SERVICES DEPARTMENT STANDARD SPECIFICATIONS AND IT'S DETAILS WHICH ARE INCLUDED BY REFERENCE. THE OMISSION OF ANY CURRENT STANDARD DETAIL DOES NOT RELIEVE THE CONTRACTOR FROM THIS REQUIREMENT. THE WORK SHALL BE PERFORMED IN COMPLETE CONFORMANCE WITH THE CURRENT PUBLIC SERVICES STANDARD SPECIFICATIONS AND DETAILS.

FOR PROTECTION OF UNDERGROUND UTILITIES AND IN CONFORMANCE WITH PUBLIC ACT 53, THE CONTRACTOR SHALL CALL 811 OR 1-800-482-7171 A MINIMUM OF THREE FULL WORKING DAYS, EXCLUDING SATURDAYS, SUNDAYS, AND HOLIDAYS PRIOR TO BEGINNING EACH EXCAVATION IN AREAS WHERE PUBLIC UTILITIES HAVE NOT BEEN PREVIOUSLY LOCATED. MEMBERS WILL THUS BE ROUTINELY NOTIFIED. THIS DOES NOT RELIEVE THE CONTRACTOR OF THE RESPONSIBILITY OF NOTIFYING UTILITY OWNERS WHO MAY NOT BE A PART OF THE "MISS DIG" ALFET SYSTEM

THE UNDERGROUND LOCATIONS SHOWN FOR NATURAL GAS (GAS), TELEPHONE (TEL), ELECTRICAL POWER (PWR), CABLE TV (CTV) AND FIBER OPTIC LINES (FIBER) ARE APPROXIMATE. THE CITY OF ANN ARBOR ASSUMES NO RESPONSIBILITY FOR THEIR ACCURATE REPRESENTATION IN THIS DRAWING. MISS DIG MUST BE CONTACTED PRIOR TO CONSTRUCTION TO LOCATE THESE UTILITIES.

OF AMM

PROJECT MANAGEMENT SERVICE UNIT


CITY OF ANN ARBOR PUBLIC SERVICE 301 EAST HURON STREET, P.O. BOX 8647 ANN ARBOR, MICHIGAN 48107-8647 734-794-6410 www.a2gov.org Know what's belov

COSPTION
2014 ANNUAL RESURFACING

VAGEMENT - PUBL

AWING No. 014004 - 92

92 TO 102

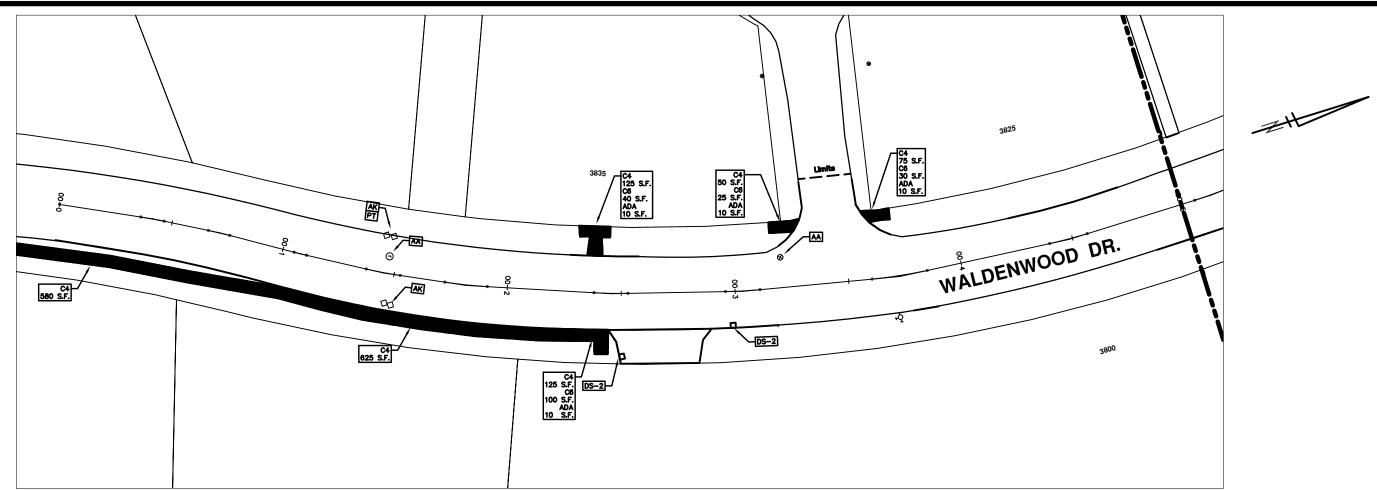


	CONSTRUCTION KEY
KEY	DESCRIPTION
C/G	REMOVE AND REPLACE CURB AND GUTTER
C/GHE	REMOVE CURB AND GUTTER, REPLACE WITH CONCRETE CURB AND GUTTER H.E.
C4HE	REMOVE EXISTING RAMP OR SIDEWALK. REPLACE WITH 4" SIDEWALK OR TYPE 1 SIDEWALK RAMP, H.E.
CR	REMOVE SIDEWALK, DRIVE OR RAMP.
AA	ADJUST MDOT TYPE A CASTINGS.
AB	ADJUST GATE VALVE BOX OR MONUMENT BOX.
ADST	ADDITIONAL DEPTH STRUCTURE REPAIR.
RRA	REMOVE AND REPLACE MDOT TYPE A CASTING ADJUST TO FINISH GRADE.
CPRHE	CONCRETE PAVEMENT REPAIR, H.E.
DS	CONSTRUCT 2, 3 OR 4' DIAM. DRAINAGE STRUCTURE.
PT	POINT STRUCTURE.
C4	REMOVE EXISTING RAMP OR SIDEWALK, REPLACE WITH 4" SIDEWAL OR RAMP.
C6	REMOVE EXISTING RAMP OR SIDEWALK, REPLACE WITH 6" SIDEWAL OR RAMP
C8	PLACE 8" SIDEWALK OR RAMP ONLY
C HE	REMOVE EXISTING DRIVE APPROACH, RAMP OR SIDEWALK. REPLAC WITH 6" OR 8" APPROACH, RAMP, OR SIDEWALK, H.E.
CP	PLACE 4" SIDEWALK OR RAMP.
AK	ADJUST MDOT TYPE K CASTING.
TYPE II	MDOT TYPE II BARRICADE.
TYPE III	MDOT TYPE III BARRICADE.
RRK	REMOVE AND REPLACE MDOT TYPE K CASTING. ADJUST TO FINISH GRADE.
RS	RECONSTRUCT STRUCTURE.
RCP	REMOVE CONC. PAVEMENT - ANY THICKNESS
RCW	RAISED CROSSWALK

	LEGEND
SYMBOL	DESCRIPTION
•	EXISTING SANITARY SEWER MANHOLE
۰	EXISTING STORM SEWER MANHOLE
•	EXISTING WATER MAIN VALVE IN WELL
+	WATER MAIN GATE VALVE IN BOX
-6∙	FIRE HYDRANT
•	MICHCON GAS CO. VALVE BOX/WELL
•	AMERITECH TELEPHONE VAULT
•	ELECTRIC MANHOLE
•	SOIL BORING
0	EXISTING STORM SEWER INLET
•	MONUMENT BOX
	REMOVE AND REPLACE CONG. SIDEWALK
777	PLACE CONCRETE SIDEWALK
	REMOVE & REPLACE CONC. CURB & GUTTER
	CONSTRUCTION LIMITS
	6" WRAPPED UNDERDRAIN
	REMOVE CONCRETE SIDEWALK
	SUBGRADE UNDERCUT
FILE AND IT W	S A REPENENCE FILE. WAKE CHANGES TO THE REPENENCE ILL UPDATE ALL SHEETS. TO MAKE A CHANCE RIGHT K OPEN MIEF, MAKE YOUR EDIT AND SAVE.




PUBLIC SERVICES - CITY OF ANN ARBOR
2014 ANNUAL RESURFACING PROGRAM
WALDENWOOD

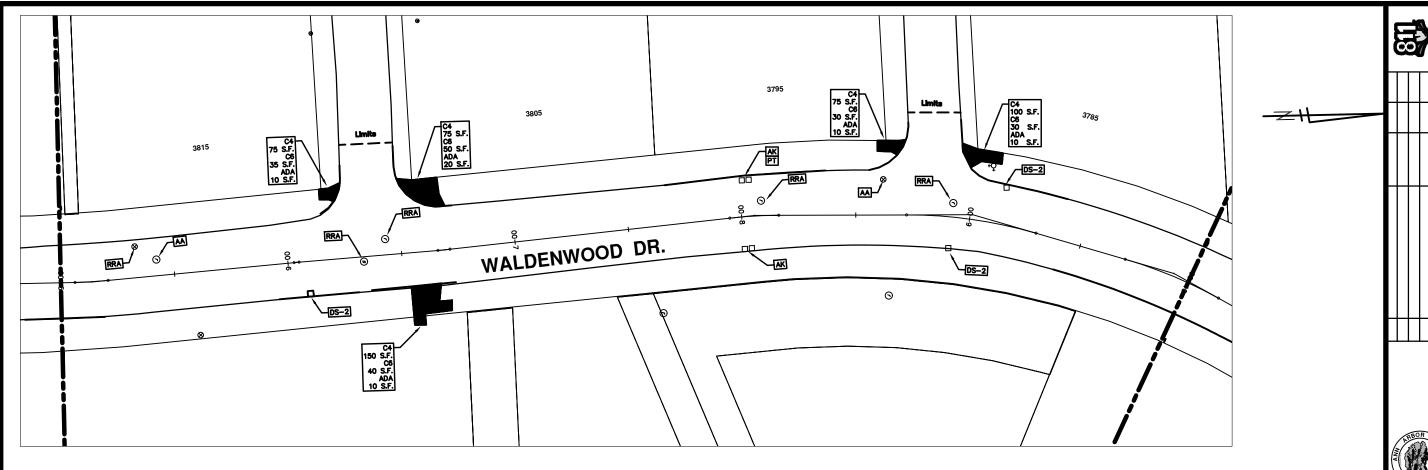

WALDENWOOD DR.

CONSTRUCTION KEY LEGEND KEY DESCRIPTION SYMBOL DESCRIPTION PUBLIC SERVICES - CITY OF ANN ARBOR
2014 ANNUAL RESURFACING PROGRAM
WALDENWOOD C/G REMOVE AND REPLACE CURB AND GUTTER EXISTING SANITARY SEWER MANHOLE REMOVE CURB AND GUTTER, REPLACE WITH CONCRETE CURB AND GUTTER H.E. C/GHE EXISTING STORM SEWER MANHOLE REMOVE EXISTING RAMP OR SIDEWALK. REPLACE WITH 4" SIDEWALK OR TYPE 1 SIDEWALK RAMP, H.E. EXISTING WATER MAIN VALVE IN WELL WATER MAIN GATE VALVE IN BOX REMOVE SIDEWALK, DRIVE OR RAMP. ADJUST MDOT TYPE A CASTINGS. 19 FIRE HYDRANT AB ADJUST GATE VALVE BOX OR MONUMENT BOX. MICHOON GAS CO. VALVE BOX/WELL ADST ADDITIONAL DEPTH STRUCTURE REPAIR. AMERITECH TELEPHONE VAULT REMOVE AND REPLACE MDOT TYPE A CASTING ADJUST TO FINISH GRADE. ELECTRIC MANHOLE CONCRETE PAVEMENT REPAIR, H.E. SOIL BORING CONSTRUCT 2, 3 OR 4' DIAM. DRAINAGE STRUCTURE. EXISTING STORM SEWER INLET _ POINT STRUCTURE. MONUMENT BOX REMOVE EXISTING RAMP OR SIDEWALK, REPLACE WITH 4" SIDEWALK REMOVE AND REPLACE CONC. SIDEWALK REMOVE EXISTING RAMP OR SIDEWALK, REPLACE WITH 6" SIDEWALK OR RAMP PLACE CONCRETE SIDEWALK PLACE 8" SIDEWALK OR RAMP ONLY REMOVE & REPLACE CONG. CURB & GUTTER REMOVE EXISTING DRIVE APPROACH, RAMP OR SIDEWALK. REPLACE WITH 6" OR 8" APPROACH, RAMP,OR SIDEWALK, H.E. CONSTRUCTION LIMITS C HE 6" WRAPPED UNDERDRAIN PLACE 4" SIDEWALK OR RAMP. REMOVE CONCRETE SIDEWALK ADJUST MDOT TYPE K CASTING. SUBGRADE UNDERCUT


WHIS TABLE IS A REPRESENCE FILE. HAVE CHANGES TO THE REPRESENCE FILE HAVE CHANGES TO THE REPRESENCE T TYPE II MOOT TYPE II BARRICADE. TYPE III MOOT TYPE III BARRICADE. REMOVE AND REPLACE MDOT TYPE K CASTING. ADJUST TO FINISH GRADE. RECONSTRUCT STRUCTURE. REMOVE CONC. PAVEMENT - ANY THICKNESS RAISED CROSSWALK

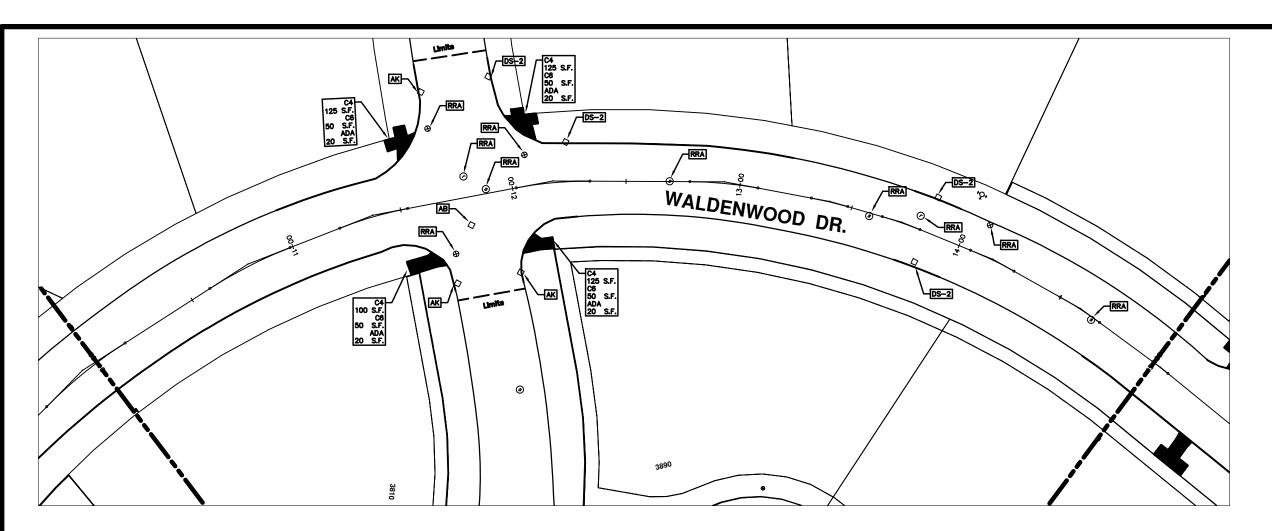




	CONSTRUCTION KEY
KEY	DESCRIPTION
C/G	REMOVE AND REPLACE CURB AND GUTTER
C/GHE	REMOVE CURB AND GUTTER, REPLACE WITH CONCRETE CURB AND GUTTER H.E.
C4HE	REMOVE EXISTING RAMP OR SIDEWALK. REPLACE WITH 4" SIDEWALK OR TYPE 1 SIDEWALK RAMP, H.E.
CR	REMOVE SIDEWALK, DRIVE OR RAMP.
AA	ADJUST MDOT TYPE A CASTINGS.
AB	ADJUST GATE VALVE BOX OR MONUMENT BOX.
ADST	ADDITIONAL DEPTH STRUCTURE REPAIR.
RRA	REMOVE AND REPLACE MDOT TYPE A CASTING ADJUST TO FINISH GRADE.
CPRHE	CONCRETE PAVEMENT REPAIR, H.E.
DS	CONSTRUCT 2, 3 OR 4' DIAM. DRAINAGE STRUCTURE.
PT	POINT STRUCTURE.
C4	REMOVE EXISTING RAMP OR SIDEWALK, REPLACE WITH 4" SIDEWAL OR RAMP.
C6	REMOVE EXISTING RAMP OR SIDEWALK, REPLACE WITH 6" SIDEWAL OR RAMP
C8	PLACE 8" SIDEWALK OR RAMP ONLY
C HE	REMOVE EXISTING DRIVE APPROACH, RAMP OR SIDEWALK. REPLAC WITH 6" OR 8" APPROACH, RAMP, OR SIDEWALK, H.E.
CP	PLACE 4" SIDEWALK OR RAMP.
AK	ADJUST MDOT TYPE K CASTING.
TYPE II	MDOT TYPE II BARRICADE.
TYPE III	MDOT TYPE III BARRICADE.
RRK	REMOVE AND REPLACE MDOT TYPE K CASTING. ADJUST TO FINISH GRADE.
RS	RECONSTRUCT STRUCTURE.
RCP	REMOVE CONC. PAVEMENT - ANY THICKNESS
RCW	RAISED CROSSWALK

	LEGEND
SYMBOL	DESCRIPTION
•	EXISTING SANITARY SEWER MANHOLE
•	EXISTING STORM SEWER MANHOLE
•	EXISTING WATER MAIN VALVE IN WELL
+	WATER MAIN GATE VALVE IN BOX
ιδ.	FIRE HYDRANT
•	MICHCON GAS CO. VALVE BOX/NELL
•	AMERITECH TELEPHONE VAULT
•	ELECTRIC MANHOLE
•	SOIL BORING
0	EXISTING STORM SEWER INLET
•	MONUMENT BOX
	REMOVE AND REPLACE CONC. SIDEWALK
	PLACE CONCRETE SIDEWALK
	REMOVE & REPLACE CONC. CURB & GUTTER
	CONSTRUCTION LIMITS
	6" WRAPPED UNDERDRAIN
	REMOVE CONCRETE SIDEWALK
	SUBGRADE UNDERCUT
PILE AND IT Y	IS A REPERENCE PILE. MAKE CHANGES TO THE REPERENC ILL UPDATE ALL SHEETS. TO MAKE A CHANCE RIGHT XX OPEN XREF, MAKE YOUR EDIT AND SAVE.

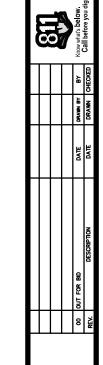



- PUBLIC SERVICES - CITY OF ANN ARBOR 2014 ANNUAL RESURFACING PROGRAM WALDENWOOD

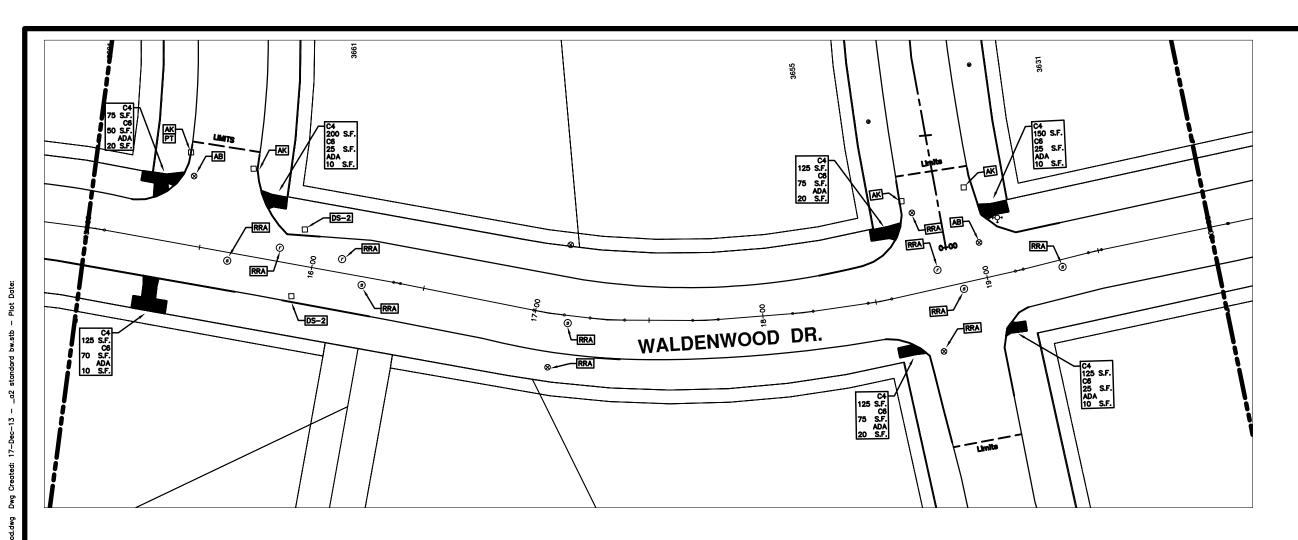




	CONSTRUCTION KEY
KEY	DESCRIPTION
C/G	REMOVE AND REPLACE CURB AND GUTTER
C/GHE	REMOVE CURB AND GUTTER, REPLACE WITH CONCRETE CURB AND GUTTER H.E.
C4HE	REMOVE EXISTING RAMP OR SIDEWALK. REPLACE WITH 4" SIDEWALK OR TYPE 1 SIDEWALK RAMP, H.E.
CR	REMOVE SIDEWALK, DRIVE OR RAMP.
AA	ADJUST MDOT TYPE A CASTINGS.
AB	ADJUST GATE VALVE BOX OR MONUMENT BOX.
ADST	ADDITIONAL DEPTH STRUCTURE REPAIR.
RRA	REMOVE AND REPLACE MDOT TYPE A CASTING ADJUST TO FINISH GRADE.
CPRHE	CONCRETE PAVEMENT REPAIR, H.E.
DS	CONSTRUCT 2, 3 OR 4' DIAM. DRAINAGE STRUCTURE.
PT	POINT STRUCTURE.
C4	REMOVE EXISTING RAMP OR SIDEWALK, REPLACE WITH 4" SIDEWAL OR RAMP.
C6	REMOVE EXISTING RAMP OR SIDEWALK, REPLACE WITH 6" SIDEWAL OR RAMP
C8	PLACE 8" SIDEWALK OR RAMP ONLY
C HE	REMOVE EXISTING DRIVE APPROACH, RAMP OR SIDEWALK. REPLAC WITH 6" OR 8" APPROACH, RAMP,OR SIDEWALK, H.E.
CP	PLACE 4" SIDEWALK OR RAMP.
AK	ADJUST MDOT TYPE K CASTING.
TYPE II	MDOT TYPE II BARRICADE.
TYPE III	MDOT TYPE III BARRICADE.
RRK	REMOVE AND REPLACE MDOT TYPE K CASTING. ADJUST TO FINISH GRADE.
RS	RECONSTRUCT STRUCTURE.
RCP	REMOVE CONC. PAVEMENT - ANY THICKNESS
RCW	RAISED CROSSWALK

	LEGEND
SYMBOL	DESCRIPTION
•	EXISTING SANITARY SEWER MANHOLE
•	EXISTING STORM SEWER MANHOLE
•	EXISTING WATER MAIN VALVE IN WELL
+	WATER MAIN GATE VALVE IN BOX
∙6.	FIRE HYDRANT
•	MICHOON GAS CO. VALVE BOX/WELL
•	AMERITECH TELEPHONE VAULT
•	ELECTRIC MANHOLE
•	SOIL BORING
0	EXISTING STORM SEWER INLET
•	MONUMENT BOX
	REMOVE AND REPLACE CONC. SIDEWALK
777	PLACE CONCRETE SIDEWALK
	REMOVE & REPLACE CONC. CURB & GUTTER
	CONSTRUCTION LIMITS
	6" WRAPPED UNDERDRAIN
	REMOVE CONCRETE SIDEWALK
	SUBGRADE UNDERCUT
PILE AND IT W CLICK AND PIC	S A REPENDICE FILE. MAKE CHANGES TO THE REPERDICE IL UPDATE ALL SHEETS. TO MAKE A CHANCE RIGHT IK OPEN WREP, MAKE YOUR EDIT AND SAVE.

Know what's below.					
				BY	СНЕСКЕВ
				DRAWN BY	DRAWN CHECKED
				DATE	DATE
				00 OUT FOR BID	DESCRIPTION
				00	REV.



- PUBLIC SERVICES - CITY OF ANN ARBOR
2014 ANNUAL RESURFACING PROGRAM
WALDENWOOD

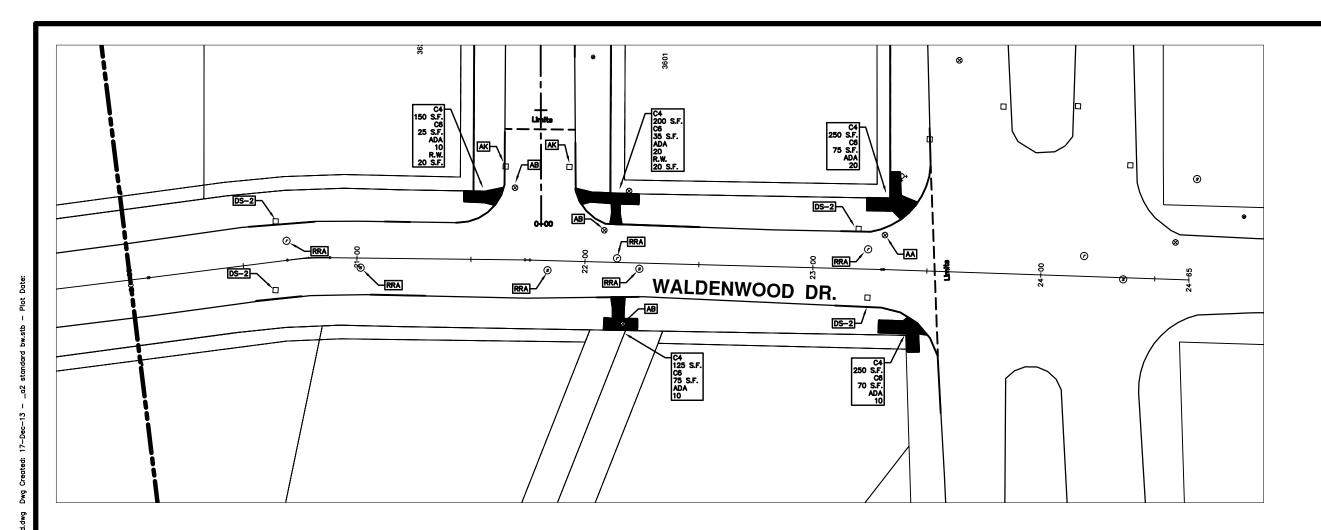




	CONSTRUCTION KEY
KEY	DESCRIPTION
C/G	REMOVE AND REPLACE CURB AND GUTTER
C/GHE	REMOVE CURB AND GUTTER, REPLACE WITH CONCRETE CURB AND GUTTER H.E.
C4HE	REMOVE EXISTING RAMP OR SIDEWALK. REPLACE WITH 4" SIDEWALK OR TYPE 1 SIDEWALK RAMP, H.E.
CR	REMOVE SIDEWALK, DRIVE OR RAMP.
AA	ADJUST MDOT TYPE A CASTINGS.
AB	ADJUST GATE VALVE BOX OR MONUMENT BOX.
ADST	ADDITIONAL DEPTH STRUCTURE REPAIR.
RRA	REMOVE AND REPLACE MDOT TYPE A CASTING ADJUST TO FINISH GRADE.
CPRHE	CONCRETE PAVEMENT REPAIR, H.E.
DS	CONSTRUCT 2, 3 OR 4' DIAM. DRAINAGE STRUCTURE.
PT	POINT STRUCTURE.
C4	REMOVE EXISTING RAMP OR SIDEWALK, REPLACE WITH 4" SIDEWAL OR RAMP.
C6	REMOVE EXISTING RAMP OR SIDEWALK, REPLACE WITH 6" SIDEWAL OR RAMP
C8	PLACE 8" SIDEWALK OR RAMP ONLY
C HE	REMOVE EXISTING DRIVE APPROACH, RAMP OR SIDEWALK. REPLAC WITH 6" OR 8" APPROACH, RAMP, OR SIDEWALK, H.E.
CP	PLACE 4" SIDEWALK OR RAMP.
AK	ADJUST MDOT TYPE K CASTING.
TYPE II	MDOT TYPE II BARRICADE.
TYPE III	MDOT TYPE III BARRICADE.
RRK	REMOVE AND REPLACE MDOT TYPE K CASTING. ADJUST TO FINISH GRADE.
RS	RECONSTRUCT STRUCTURE.
RCP	REMOVE CONC. PAVEMENT - ANY THICKNESS
RCW	RAISED CROSSWALK

	LEGEND
SYMBOL	DESCRIPTION
•	EXISTING SANITARY SEWER MANHOLE
•	EXISTING STORM SEWER MANHOLE
•	EXISTING WATER MAIN VALVE IN WELL
+	WATER MAIN GATE VALVE IN BOX
φ.	FIRE HYDRANT
•	MICHCON GAS CO. VALVE BOX/NELL
•	AMERITECH TELEPHONE VAULT
•	ELECTRIC MANHOLE
•	SOIL BORING
0	EXISTING STORM SEWER INLET
•	MONUMENT BOX
	REMOVE AND REPLACE CONG. SIDEWALK
- 4	PLACE CONCRETE SIDEWALK
	REMOVE & REPLACE CONC. CURB & GUTTER
	CONSTRUCTION LIMITS
	6" WRAPPED UNDERDRAIN
	REMOVE CONCRETE SIDEWALK
	SUBGRADE UNDERCUT
FILE AND IT W	A REPERIOR FILE, MANE CHANGES TO THE REPERIORE LL LIPPATE ALL SHEETS. TO MAKE A CHANCE RIGHT


SCALE PLAN: 1'

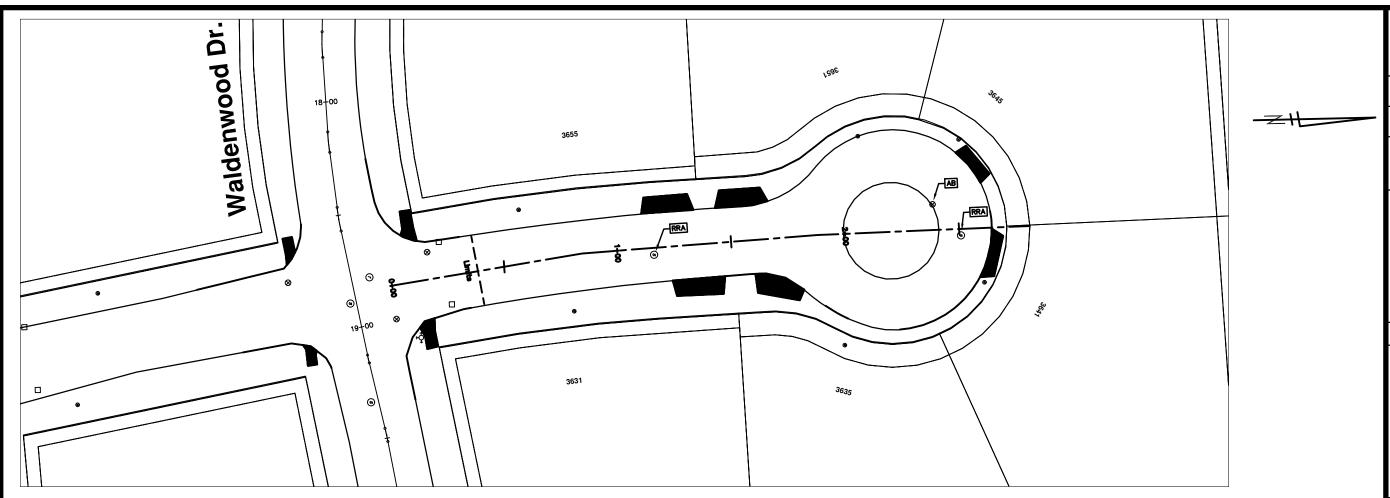

WALDENWOOD CT. 3631-3655

	CONSTRUCTION KEY
KEY	DESCRIPTION
C/G	REMOVE AND REPLACE CURB AND GUTTER
C/GHE	REMOVE CURB AND GUTTER, REPLACE WITH CONCRETE CURB AND GUTTER H.E.
C4HE	REMOVE EXISTING RAMP OR SIDEWALK. REPLACE WITH 4" SIDEWALK OR TYPE 1 SIDEWALK RAMP, H.E.
CR	REMOVE SIDEWALK, DRIVE OR RAMP.
AA	ADJUST MDOT TYPE A CASTINGS.
AB	ADJUST GATE VALVE BOX OR MONUMENT BOX.
ADST	ADDITIONAL DEPTH STRUCTURE REPAIR.
RRA	REMOVE AND REPLACE MDOT TYPE A CASTING ADJUST TO FINISH GRADE.
CPRHE	CONCRETE PAVEMENT REPAIR, H.E.
DS	CONSTRUCT 2, 3 OR 4' DIAM. DRAINAGE STRUCTURE.
PT	POINT STRUCTURE.
C4	REMOVE EXISTING RAMP OR SIDEWALK, REPLACE WITH 4" SIDEWAL OR RAMP.
C6	REMOVE EXISTING RAMP OR SIDEWALK, REPLACE WITH 6" SIDEWAL OR RAMP
C8	PLACE 8" SIDEWALK OR RAMP ONLY
C HE	REMOVE EXISTING DRIVE APPROACH, RAMP OR SIDEWALK. REPLAC WITH 6" OR 8" APPROACH, RAMP, OR SIDEWALK, H.E.
CP	PLACE 4" SIDEWALK OR RAMP.
AK	ADJUST MDOT TYPE K CASTING.
TYPE II	MDOT TYPE II BARRICADE.
TYPE III	MDOT TYPE III BARRICADE.
RRK	REMOVE AND REPLACE MDOT TYPE K CASTING. ADJUST TO FINISH GRADE.
RS	RECONSTRUCT STRUCTURE.
RCP	REMOVE CONC. PAVEMENT - ANY THICKNESS
RCW	RAISED CROSSWALK

	LEGEND
SYMBOL	DESCRIPTION
•	EXISTING SANITARY SEWER MANHOLE
•	EXISTING STORM SEWER MANHOLE
•	EXISTING WATER MAIN VALVE IN WELL
+	WATER MAIN GATE VALVE IN BOX
-∳-	FIRE HYDRANT
•	MICHOON GAS CO. VALVE BOX/MELL
•	AMERITECH TELEPHONE VAULT
•	ELECTRIC MANHOLE
•	SOIL BORING
0	EXISTING STORM SEWER INLET
•	MONUMENT BOX
	REMOVE AND REPLACE CONC. SIDEWALK
77	PLACE CONCRETE SIDEWALK
	REMOVE & REPLACE CONC. CURB & GUTTER
	CONSTRUCTION LIMITS
	6" WRAPPED UNDERDRAIN
	REMOVE CONCRETE SIDEWALK
	SUBGRADE UNDERCUT
PILE AND IT W	B A REPERCY FILE. MAKE CHANGES TO THE REPERCY IL UPDATE ALL SHEETS. TO MAKE A CHANGE MIGHT K OPEN XMEF, MAKE YOUR EDIT AND SAVE.

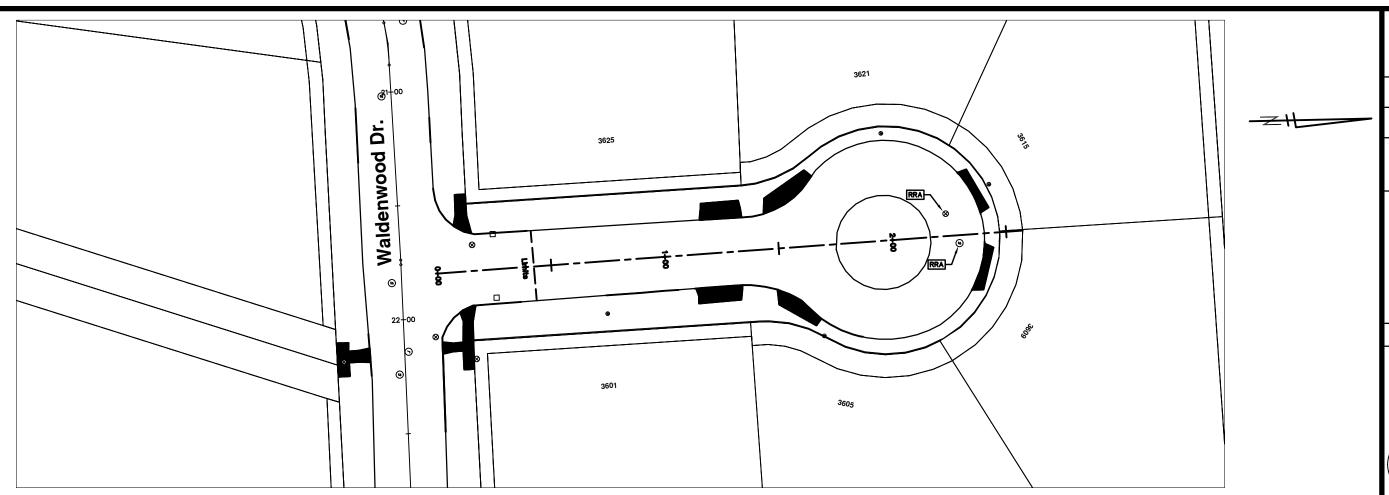


WALDENWOOD CT. 3601-3625

	CONSTRUCTION KEY
KEY	DESCRIPTION
C/G	REMOVE AND REPLACE CURB AND GUTTER
C/GHE	REMOVE CURB AND GUTTER, REPLACE WITH CONCRETE CURB AND GUTTER H.E.
C4HE	REMOVE EXISTING RAMP OR SIDEWALK. REPLACE WITH 4" SIDEWALK OR TYPE 1 SIDEWALK RAMP,H.E.
CR	REMOVE SIDEWALK, DRIVE OR RAMP.
AA	ADJUST MDOT TYPE A CASTINGS.
AB	ADJUST GATE VALVE BOX OR MONUMENT BOX.
ADST	ADDITIONAL DEPTH STRUCTURE REPAIR.
RRA	REMOVE AND REPLACE MDOT TYPE A CASTING ADJUST TO FINISH GRADE.
CPRHE	CONCRETE PAVEMENT REPAIR, H.E.
DS	CONSTRUCT 2, 3 OR 4' DIAM. DRAINAGE STRUCTURE.
PT	POINT STRUCTURE.
C4	REMOVE EXISTING RAMP OR SIDEWALK, REPLACE WITH 4" SIDEWAL OR RAMP.
C6	REMOVE EXISTING RAMP OR SIDEWALK, REPLACE WITH 6" SIDEWAL OR RAMP
C8	PLACE 8" SIDEWALK OR RAMP ONLY
C HE	REMOVE EXISTING DRIVE APPROACH, RAMP OR SIDEWALK. REPLAC WITH 6" OR 8" APPROACH, RAMP,OR SIDEWALK, H.E.
CP	PLACE 4" SIDEWALK OR RAMP.
AK	ADJUST MDOT TYPE K CASTING.
TYPE II	MDOT TYPE II BARRICADE.
TYPE III	MDOT TYPE III BARRICADE.
RRK	REMOVE AND REPLACE MDOT TYPE K CASTING. ADJUST TO FINISH GRADE.
RS	RECONSTRUCT STRUCTURE.
RCP	REMOVE CONC. PAVEMENT - ANY THICKNESS
RCW	RAISED CROSSWALK

LEGEND		
SYMBOL	DESCRIPTION	
•	EXISTING SANITARY SEWER MANHOLE	
0	EXISTING STORM SEWER MANHOLE	
•	EXISTING WATER MAIN VALVE IN WELL	
+	WATER MAIN GATE VALVE IN BOX	
ģ	FIRE HYDRANT	
•	MICHCON GAS CO. VALVE BOX/WELL	
•	AMERITECH TELEPHONE VAULT	
•	ELECTRIC MANHOLE	
•	SOIL BORING	
0	EXISTING STORM SEWER INLET	
•	MONUMENT BOX	
	REMOVE AND REPLACE CONC. SIDEWALK	
	PLACE CONCRETE SIDEWALK	
	REMOVE & REPLACE CONC. CURB & GUTTE	
	CONSTRUCTION LIMITS	
	6" WRAPPED UNDERDRAIN	
	REMOVE CONCRETE SIDEWALK	
	SUBGRADE UNDERCUT	
THIS TABLE	IS A REPERENCE FILE. MAKE CHANGES TO THE REPERENCE IN THE	

E PLAN: 1" = 20'


IEET No.

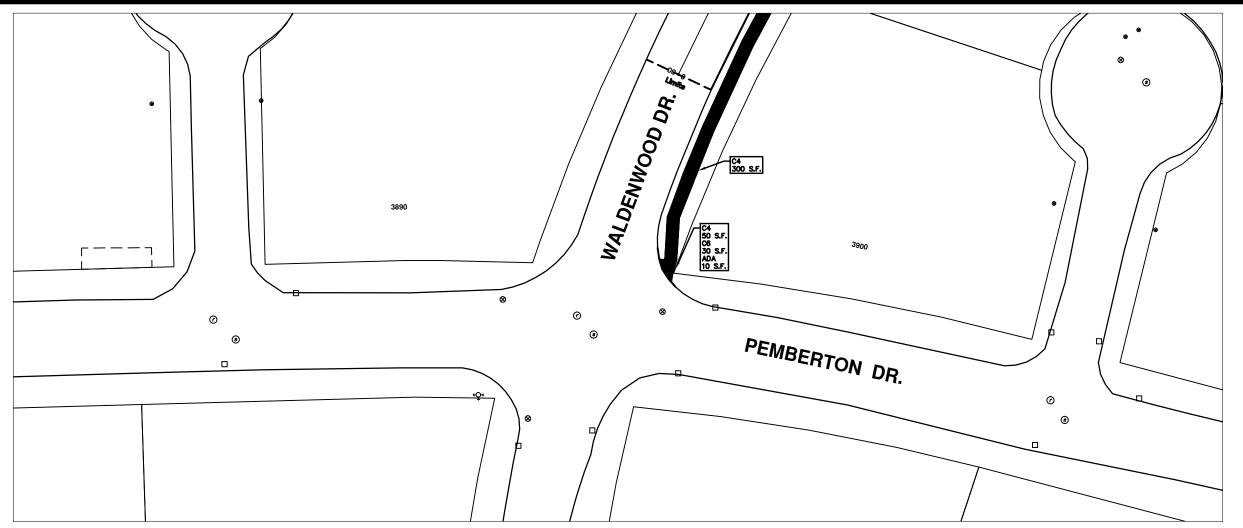

WALDENWOOD DR

	CONSTRUCTION KEY
KEY	DESCRIPTION
C/G	REMOVE AND REPLACE CURB AND GUTTER
C/GHE	REMOVE CURB AND GUTTER, REPLACE WITH CONCRETE CURB AND GUTTER H.E.
C4HE	REMOVE EXISTING RAMP OR SIDEWALK. REPLACE WITH 4" SIDEWALK OR TYPE 1 SIDEWALK RAMP,H.E.
CR	REMOVE SIDEWALK, DRIVE OR RAMP.
AA	ADJUST MDOT TYPE A CASTINGS.
AB	ADJUST GATE VALVE BOX OR MONUMENT BOX.
ADST	ADDITIONAL DEPTH STRUCTURE REPAIR.
RRA	REMOVE AND REPLACE MDOT TYPE A CASTING ADJUST TO FINISH GRADE.
CPRHE	CONCRETE PAVEMENT REPAIR, H.E.
DS	CONSTRUCT 2, 3 OR 4' DIAM. DRAINAGE STRUCTURE.
PT	POINT STRUCTURE.
C4	REMOVE EXISTING RAMP OR SIDEWALK, REPLACE WITH 4" SIDEWAL OR RAMP.
C6	REMOVE EXISTING RAMP OR SIDEWALK, REPLACE WITH 6" SIDEWAL OR RAMP
С8	PLACE 8" SIDEWALK OR RAMP ONLY
C HE	REMOVE EXISTING DRIVE APPROACH, RAMEP OR SIDEWALK. REPLACE WITH 6" OR 8" APPROACH, RAMP, OR SIDEWALK, H.E.
CP	PLACE 4" SIDEWALK OR RAMP.
AK	ADJUST MDOT TYPE K CASTING.
TYPE II	MDOT TYPE II BARRICADE.
TYPE III	MDOT TYPE III BARRICADE.
RRK	REMOVE AND REPLACE MDOT TYPE K CASTING. ADJUST TO FINISH GRADE.
RS	RECONSTRUCT STRUCTURE.
RCP	REMOVE CONC. PAVEMENT - ANY THICKNESS
RCW	RAISED CROSSWALK

	LEGEND			
SYMBOL				
9	EXISTING SANITARY SEWER MANHOLE			
0	EXISTING STORM SEWER MANHOLE			
8	EXISTING WATER MAIN VALVE IN WELL			
+	WATER MAIN GATE VALVE IN BOX			
+Ç+	FIRE HYDRANT			
9	MICHCON GAS CO. VALVE BOX/WELL			
Θ	AMERITECH TELEPHONE VAULT			
	ELECTRIC MANHOLE			
•	SOIL BORING			
	EXISTING STORM SEWER INLET			
•	MONUMENT BOX			
	REMOVE AND REPLACE CONC. SIDEWALK			
	PLACE CONCRETE SIDEWALK			
_	REMOVE & REPLACE CONC. CURB & GUTTER			
	CONSTRUCTION LIMITS			
	6" WRAPPED UNDERDRAIN			
	REMOVE CONCRETE SIDEWALK			
	SUBGRADE UNDERCUT			

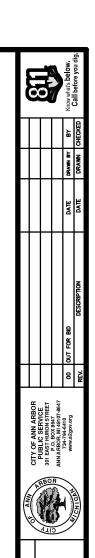

PUBLIC SERVICES - CITY OF ANN ARBOR
2014 ANNUAL RESURFACING PROGRAM
WALDENWOOD

2014

PLAN: 1" = 20'
46 No.

SHEET No.

