ADDENDUM No. 1

RFP No. 23-50

Ultraviolet (UV) Disinfection System Replacement Project

Due: OCTOBER 17, 2023 by 11:00 A.M. (local time)

The information contained herein shall take precedence over the original documents and all previous addenda (if any), and is appended thereto. **This Addendum includes forty-four (44) pages.**

The Proposer is to acknowledge receipt of this Addendum No. 1, including all attachments in its Proposal by so indicating in the proposal that the addendum has been received. Proposals submitted without acknowledgement of receipt of this addendum may be considered non-conforming.

A pre-bid meeting was held on September 19, 2023. The information disclosed in the pre-bid meeting is available in the Contract Documents. Bidders are reminded that oral statements made at the pre-bid meeting may not be relied upon and will not be binding or legally effective. The pre-bid meeting agenda and roster of attendees are on the attached pages.

The following forms provided within the RFP Document should be included in submitted proposal:

- Attachment D Prevailing Wage Declaration of Compliance
- Attachment E Living Wage Declaration of Compliance
- Attachment G Vendor Conflict of Interest Disclosure Form
- Attachment H Non-Discrimination Declaration of Compliance

<u>Proposals that fail to provide these completed forms listed above upon proposal opening may be rejected as non-responsive and may not be considered for award.</u>

I. CORRECTIONS/ADDITIONS/DELETIONS

Changes to the RFP documents which are outlined below are referenced to a page or Section in which they appear conspicuously. Offerors are to take note in its review of the documents and include these changes as they may affect work or details in other areas not specifically referenced here.

Section/Page(s)

Under the "Extended Cost" Column of Base Bid Item 1.2, "Permit Allowance": Page 16

Change

Remove: "\$10,000" and Replace with: "\$15,000" Replace Page 16 with Page 16 (AD-1)

Section/Page(s)

Attachment K

Addition

Record Documents:

- 1999 Wastewater Treatment Plant Disinfection Facilities Upgrade (29 sheets)
- 1977 Wastewater Treatment Plant Improvements, sheets 91-94 (4 sheets)
- Existing UV Channel Slide Gate Shop Drawings (6 sheets)

II. QUESTIONS AND ANSWERS

The following Questions have been received by the City. Responses are being provided in accordance with the terms of the RFP. Respondents are directed to take note in its review of the documents of the following questions and City responses as they affect work or details in other areas not specifically referenced here.

Question 1: SPECIFICATION SECTION 07 41 20 - METAL WALL PANELS specifies Centria "CS-660" or approved equal. Is product approval required before bidding.

Answer 1: No. Approving or accepting a product as equal is not allowed prior to bidding. Bidders shall reference the Contract Documents with regards to substitutions.

Offerors are responsible for any conclusions that they may draw from the information contained in the Addendum.





PREBID MEETING AGENDA

Client Name:	City of Ann Arbo	City of Ann Arbor, MI				
Project Name:	Ann Arbor WRRF	Ann Arbor WRRF UV Disinfection Replacement Project				
Project No:	413104		B&V Project File No	: 81.0600		
Meeting Date:	9/19/2023	0/19/2023 Meeting Time: 11:00 AM - 12:00 PM EST Meeting No		Meeting No:	1	
Meeting Location:	Ann Arbor WRRF (49 S Dixboro		Dial In No. / Codo	(913) 278-0791/313 602 720#		
wieeting Location:	Rd, Ann Arbor, MI 48105)		Diai-iii No. / Code:	(915) 27	8-0/91/313 602	720#
Prepared By:	Emily Schlandere	r (Black & Veatch)				

Meeting Agenda: Key objectives for the meeting are shown below.

- 1. Attendance Prebid Meeting is Mandatory for General Contractor Bidding
- 2. Introductions of Owner and Engineer
- 3. Safety Moment
- 4. Project Overview
- 5. UV Equipment Preselection Process, Contracts/Purchase Orders
- 6. Contract Documents
 - a. Drawings
 - b. Specifications
- 7. Addenda
- 8. Bid Form
- 9. Owner's Forms and Other Bidding Documents
- 10. Prevailing Wage Requirements
- 11. Insurance and Bonds Requirements
- 12. RFP Scoring Criteria
- 13. Connections to Existing Facilities, Shutdowns, and Coordination
- 14. Submittals
- 15. Contractor Staging and Laydown
- 16. Site Security and Deliveries
- 17. Question Deadline
- 18. Bid Due Date
- 19. Additional Items
- 20. Open Discussion/Questions
- 21. Tour
- 22. Adjourn

PREBID MEETING ATTENDANCE ROSTER

The second secon			
Date:	9/19/2023	Time (start and end time): 11:00 AM to 12:00 PM EST	11:00 AM to 12:00 PM EST
Location:	Ann Arbor WRRF (49 S Dixboro Rd, Ann Arbor, MI 48105)	nn Arbor, MI 48105)	
Presenter(s):	Emily Schlanderer (Black & Veatch)		
Project:	Ann Arbor WRRF UV Disinfection Replacement Project	lacement Project	
Subject/Purpose:	Prebid Meeting		

UNCONTROLLED when printed

<u>E.</u>	Schedule of Pricing/Cost – 20 Points	
Com	oany:	

Bid Items Notes -

- 1. Provide a Unit Price and Total Price for all bid items specified in Division 01 Section "Measurement and Payment" and herein.
- 2. Quantities included in the bid table represent estimated quantities for different work. The CONTRACTOR shall be compensated for the actual number of items completed using the unit prices provided.
- 3. The City, at its sole discretion, may elect to delete any portion of the work delineated below, with no change to the unit prices provided. Work shall be determined based upon the availability of funds.
- 4. Any item not provided in the following list shall be considered incidental.
- 5. Contract shall be awarded based on the base bid or any combination of a base bid and alternate bid in any manner the City believes to be in its best interest.

Base Bid Items -

For the entire work outlined in these documents for RFP 23-50 – Ultraviolet (UV) Disinfection System Replacement Project, complete as specified, using equipment and materials only of the type and manufacturers where specifically named.

	Description	Unit	Quantity	Unit Cost	Extended Cost
1.0	General Conditions (max 10%)	LS	1		
1.1	Mobilization (max 10%)	LS	1		
1.2	Permit Allowance	LS	1	\$15,000.00	\$15,000.00
1.3	¹ UVSS Balance of Work	LS	1	\$1,269,949.00	\$1,269,949.00
1.4	Installation of All Work (except UV Disinfection Building)	LS	1		
1.5	Electrical, Instrumentation & Controls	LS	1		
1.6	UV Disinfection Building	LS	1		
1.7	Start-up, Commissioning, Training	LS	1		
1.8	Special Inspections	LS	1		
1.9	Maintenance of Plant Operations	LS	1		

BASE BID TOTAL:	 (\$	_)
_	•	

CITY OF ANN ARBOR, MICHIGAN WATER UTILITIES DEPARTMENT

WASTEWATER TREATMENT PLANT DISINFECTION FACILITIES UPGRADE

GREELEY AND HANSEN 211 WEST FORT STREET, SUITE 710 DETROIT, MICHIGAN 48226-3202

OCTOBER 1999

CATCH BASIN PVM'T PAVEMENT CENTER TO CENTER PSI POUNDS PER SQUARE INCH CHLORINATED EFFLUENT PVC POLYVINYL CHLORIDE CALCIUM HYPOCHLORYTE PROPERTY LINE PL SOLUTION PRV PRESSURE RELIEF VALVE CENTER LINE RCP

REINFORCED CONCRETE PIPE CHLORINE GAS R/W OR ROW RIGHT-OF-WAY CLEARANCE REINF REINFORCING CHLORINE SOLUTION RS RETURN SLUDGE CORRUGATED METAL SD STORM DRAIN CULVERT PIPE SDS SULFUR DIOXIDE SOLUTION CONCRETE SE SECONDARY EFFLUENT DRAWING SHEET

TQC

Uν

STAINLESS STEEL

TERTIARY FEELUENT

VITRIFIED CLAY PIPE

TOP OF CONCRETE

SAMPLING PIPE

SPECIFICATION

SQUARE

STEEL

TOP OF

TYPICAL

VERTICAL

VENT PIPE

WATER MAIN

WORK POINT

ULTRAVIOLET

WATER SURFACE

UNLESS NOTED OTHERWISE

UNITED STATES COAST

AND GEODETIC SURVEY

WEST

WITH

STANDARD

SS OR SST OR DIA OR o DIAMETER S.P. OR SAM DIM DIMENSION SPEC DWLS DOWELS SQ EACH FACE STD EL OR ELEV ELEVATION STL EMB EMBEDMENT T/ EDGE OF PAVEMENT TE EQUIP.OR EQPT. EQUIPMENT

EXIST. OR EX. EXISTING CONSTRUCTION JOINT VCP EXP EXPANSION VERT FILTERED EFFLUENT FIG FIGURE GAL. OR GALV GALVANIZED HDPE HIGH DENSITY POLYETHYLENE HOR HORIZONTAL

HIGH POINT

DUCTILE IRON

HWS HOT WATER SERVICE INSIDE DEAMETER INV INVERT ELEVATION IN. INCH 1 F LINEAL FEET LP LOW POINT MANHOLE MDOT MICHIGAN DEPARTMENT

ADDL

RITUM

BWW

CI

CIP

ĊВ

CE

CHS

CLG

CLS

CMCP

CONC

DWG

CLR OR CL.

C.C OR C/C

OF TRANSPORTATION MAX MAXIMUM MINIMUM MIXED LIQUOR

--∢ HYDRANT EXISTING SPOT ELEVATION 0.00 EXISTING CONTOUR PROPOSED SPOT ELEVATION PROPOSED CONTOUR

SECTION OR DETAIL NUMBER 1/M2-DRAWING NUMBER WHERE SECTION OR DETAIL IS SHOWN SECTION OR DETAIL NUMBER SECTION 1/M1

DRAWING NUMBER WHERE SECTION OR DETAIL IS TAKEN FROM

GENERAL NOTES:

SECTION CUTTING PLANES ARE IDENTIFIED WITH A SECTION NUMBER AND THE DRAWING NUMBER ON WHICH THE SECTION IS SHOWN , I.E. 1/M3. SECTION TITLES INCLUDE A FRACTION, WHERE THE NUMERATOR SHOWS THE SECTION IDENTIFYING NUMBER , AND THE DENOMINATOR INDICATES THE DRAWING ON WHICH THE SECTION IS CUT, I.E. SECTION 1/M3.
DETAILS ARE IDENTIFIED WITH A NUMBER FOLLOWED BY THE DRAWING ON WHICH THE DETAIL IS

SHOWN, I.E. 1/M3. DETAIL TITLES INCLUDE A FRACTION, WHERE THE NUMERATOR SHOWS THE DETAIL NUMBER AND THE DENOMINATOR INDICATES THE DRAWING ON WHICH THE DETAIL IS CROSS REFERENCED, I.E. DETAIL 3/S1

MAKE AN ON-SITE INSPECTION OF THE FACILITY AND RELATED CONDITIONS PRIOR TO BIDDING THIS CONTRACT

4. A DISTINCTION BETWEEN NEW AND EXISTING MATERIALS, EQUIPMENT AND STRUCTURES HAS BEEN MADE ON THE DRAWINGS BY LINE WEIGHT. HEAVY REPRESENTS NEW, LIGHT REPRESENTS EXISTING.

 AN ASTERISK (*) AT NEW CONSTRUCTION DENOTES LOCATIONS, ELEVATIONS, DIMENSIONS AND OTHER INFORMATION DEPENDENT ON THE CONTRACTOR'S APPROVED WORKING DRAWINGS. DEVELOP AND SHOW THE INFORMATION MARKED WITH AN ASTERISK (*) ON SUBMITTALS AND DEVELOP AND PROVIDE SUCH INFORMATION FOR ALL ASTERISKS (*) WITHIN OR INTERFACING WITH ANY SUBMITTALS AND BETWEEN SUBMITTALS. THIS REQUIREMENT ALSO EXTENDS TO CONDITIONS OR SITUATIONS WHERE A LOCATION, DIMENSION, ELEVATION OR OTHER ITEM IS INDICATED TO BE DETERMINED AFTER FINAL SELECTION OF EQUIPMENT AND/OR APPURTENANCES. ALL INFORMATION FOR ASTERISK (*) EQUIPMENT AND APPURTENANCES SITUATIONS DESCRIBED HEREIN ARE THE RESPONSIBILITY OF THE CONTRACTOR TO DEVELOP AND ASSURE COMPATIBLE INTERFACING FOR A COMPLETE, COORDINATED AND TROUBLE-FREE OPERATING INSTALLATION.

GENERAL NOTES AND SYMBOLS ARE PROVIDED FOR EACH DISCIPLINE (E.G. ELECTRICAL, MECHANICAL, ETC).

SEE APPROPRIATE DISCIPLINE DRAWINGS IN GENERAL SECTION OF THE PLANS.

INDICATES AREAS OF NEW WORK, //// INDICATES DEMOLITION.

PERFORM ALL WORK IN ACCORDANCE WITH THE REQUIREMENTS OF THE MICHIGAN SOIL EROSION AND

SEDIMENTATION CONTROL ACT, ACT 347, OF THE PUBLIC ACTS OF 1972 AS AMENDED AND THE REGULATIONS OF THE LOCAL ENFORCING AGENCIES.

IN COMPLIANCE WITH PUBLIC ACT 53 OF THE STATE OF MICHIGAN NOTIFY IN ADVANCE OF CONSTRUCTION ALL PUBLIC AND PRIVATE OWNERS HAVING EXISTING IN OR NEAR THE IMMEDIATE WORK AREA.

10. LOCATIONS, ELEVATIONS AND DIMENSIONS OF EXISTING STRUCTURES, PIPING, EQUIPMENT, APPURTENANCES AND OTHER FEATURES ARE SHOWN ACCORDING TO THE BEST INFORMATION AT THE TIME OF PREPARATION OF THESE CONTRACT DOCUMENTS BUT DO NOT PURPORT TO BE ABSOLUTELY CORRECT. FIELD VERIFY THE LOCATIONS AND DIMENSIONS OF ALL EXISTING STRUCTURES, PIPING, EQUIPMENT, APPURIENANCES AND

OTHER FEATURES AFFECTING WORK PRIOR TO CONSTRUCTION.

11. ELEVATION DATUM IS THE NGVD OF 1929 OF THE U.S.G.S. BENCH MARKS ARE SHOWN ON THE SITE PLAN

AND ARE AS FOLLOWS: NO. 1. CHISELED 'x' IN CONCRETE BASE ON FLAGPOLE, ELEVATION 739.44.

NO. 2. TOP OF NE ANCHOR BOLT ON LIGHT POLE ELEVATION, 736.53.

NO. 3. CHISELED SQUARE IN CONCRETE AT EAST PLANT FLOW SPLIT, ELEVATION 744.03.

12. ALL PIPE SUPPORTS, ANCHOR BOLT ASSEMBLIES, MOUNTING BRACKETS, UNISTRUT, CLAMPS AND METAL FASTENERS SHALL BE CONSTRUCTED OF TYPE 316 L STAINLESS STEEL.

 REQUIREMENTS FOR, AND LOCATIONS, ARRANGEMENTS, ELEVATIONS AND DIMENSIONS OF STRUCTURAL WORK, PIPING, EQUIPMENT, GRATING, ELECTRICAL GEAR. CONDUIT, CABLE, WIRING AND APPURTENANCES ARE DEPENDENT ON CONTRACTOR'S SELECTION OF PRE-QUALIFIED MANUFACTURER OF UV EQUIPMENT. CONTRACTOR'S BID SHALL REFLECT HIS SELECTION OF THE PRE-QUALIFIED MANUFACTURER OF UV EQUIPMENT INCLUDING ALL COSTS FOR PROVIDING AND INSTALLING ALL NECESSARY STRUCTURAL WORK, PIPING, EQUIPMENT, GRATING, ELECTRICAL GEAR, CONDUIT, CABLE, WIRING AND APPURTENANCES. FINAL LOCATIONS, ARRANGEMENTS, ELEVATIONS AND DIMENSIONS OF STRUCTURAL WORK, PIPING, EQUIPMENT, GRATING, ELECTRICAL GEAR, CONDUIT, CABLE, WIRING AND APPURTENANCES SHALL BE IN ACCORDANCE WITH APPROVED WORKING DRAWINGS

THE ELECTRICAL DRAWINGS DEPICT ALTERNATE ELECTRICAL WORK DEPENDENT ON THE UV EQUIPMENT PROVIDED AS FOLLOWS:

ALTERNATE A TROJAN TECHNOLOGIES, INC. ALTERNATE B CALGON CARBON CORPORATION?

GENERAL STRUCTURAL NOTES

- CONSIDER ALL SECTIONS, DETAILS AND NOTES TO BE TYPICAL AND TO APPLY TO SIMILAR SITUATIONS.
- CONSIDER ALL DIMENSIONS AND SIZES OF EXISTING CONSTRUCTION INDICATED ON DRAWINGS APPROXIMATE AND VERIFY IN FIELD.
- REPORT VARIATIONS BETWEEN ACTUAL FIELD CONDITIONS AND CONDITIONS SHOWN ON THE DRAWINGS TO THE ENGINEER PRIOR TO BEGINNING WORK.
- THE WORK INCLUDES THE DESIGN AND CONSTRUCTION OF ALL SHORING, BRACING AND FALSEWORK REQUIRED FOR THE WORK.
- 5. STRENGTH OF CONCRETE AT 28 DAYS: F'c = 4,000 P.S.I. YIELD STRENGTH OF REINFORCING STEEL: Fy = 60,000 P.S.I.
- PROVIDE EXPOSED CORNERS WITH A 3/4" CHAMFER AND REENTRANT CORNERS WITH A 3/4" FLAT FILLET UNLESS OTHERWISE NOTED.
- LOCATE EXISTING REINFORCEMENT BARS WITH A PACHOMETER BEFORE ANY PENETRATIONS ARE MADE IN THE EXISTING CONCRETE.

DRAWING INDEX

INDEX, GENERAL NOTES AND ABBREVIATIONS VICINITY MAP AND SITE LOCATION

DRAWING TITLE

G3 SITE PLAN

NO.

NORTH CHLORINE CONTACT TANK - YARD PIPING PLAN

NORTH CHLORINE CONTACT TANK - GRADING PLAN AND DIAGRAM

PIPING SYMBOLS

G7 HYDRAULIC PROFILES

S1 TYPICAL DETAILS AND GENERAL NOTES

NORTH CHLORINE CONTACT TANK DEMOLITION TOP PLAN, SECTIONS AND DETAILS

10 S3 NORTH CHLORINE CONTACT TANK - PLAN AT EL 727.00

NORTH CHLORINE CONTACT TANK - TOP PLAN

12 55 NORTH CHLORINE CONTACT TANK - SECTIONS

NORTH CHLORINE CONTACT TANK - SECTIONS AND DETAILS

NORTH CHLORINE CONTACT TANK - DEMOLITION PLAN AT EL 736.00

NORTH CHLORINE CONTACT TANK - PLAN AT EL 727.00

NORTH CHLORINE CONTACT TANK - TOP PLAN

NORTH CHLORINE CONTACT TANK - SECTIONS AND DETAILS

CHLORINE BUILDING - PLANS, SECTIONS AND DIAGRAMS

DIAGRAMS AND DETAILS

INSTRUMENTATION AND CONTROL DIAGRAMS

E1 SYMBOL LIST

22 E2 SITE PLAN

E3 ONE LINE DIAGRAM

PARTIAL ONE LINE DIAGRAMS

TERTIARY FILTER BUILDING BUILDING - PLANS

FABRICATION BUILDING - PLANS

E7 CHLORINE CONTACT TANK - PLANS AND SECTIONS

E8 PLAN, DETAILS AND SCHEDULE

RECORD DRAWING

THIS RECORD IS NOT WARRANTED BUT IS BELIEVED TO REPRESENT CONDITI
UPON COMPLETION OF CONSTRUCTION WITHIN REASONABLE TOLERANCES,
BASED UPON THE INFORMATION FURNISHED TO THE ENGINEER PERTAINING TOLERANCES AND FURNISH TOLERANCES.

INDEX, GENERAL NOTES

GENERAL

GREELEY AND HANSEN ENGINEERS 211 WEST FORT STREET, SUITE 710 DETROIT, MICHIGAN 48226-3202

CHECKED PJR

106/04/01 PJV RECORD DRAWING NO. DATE APPD REVISION


NOT TO SCALE

SCALE

CITY OF ANN ARBOR, MICHIGAN WATER UTILITIES DEPARTMENT WASTEWATER TREATMENT PLANT DISINFECTION FACILITIES UPGRADE

AND ABBREVIATIONS


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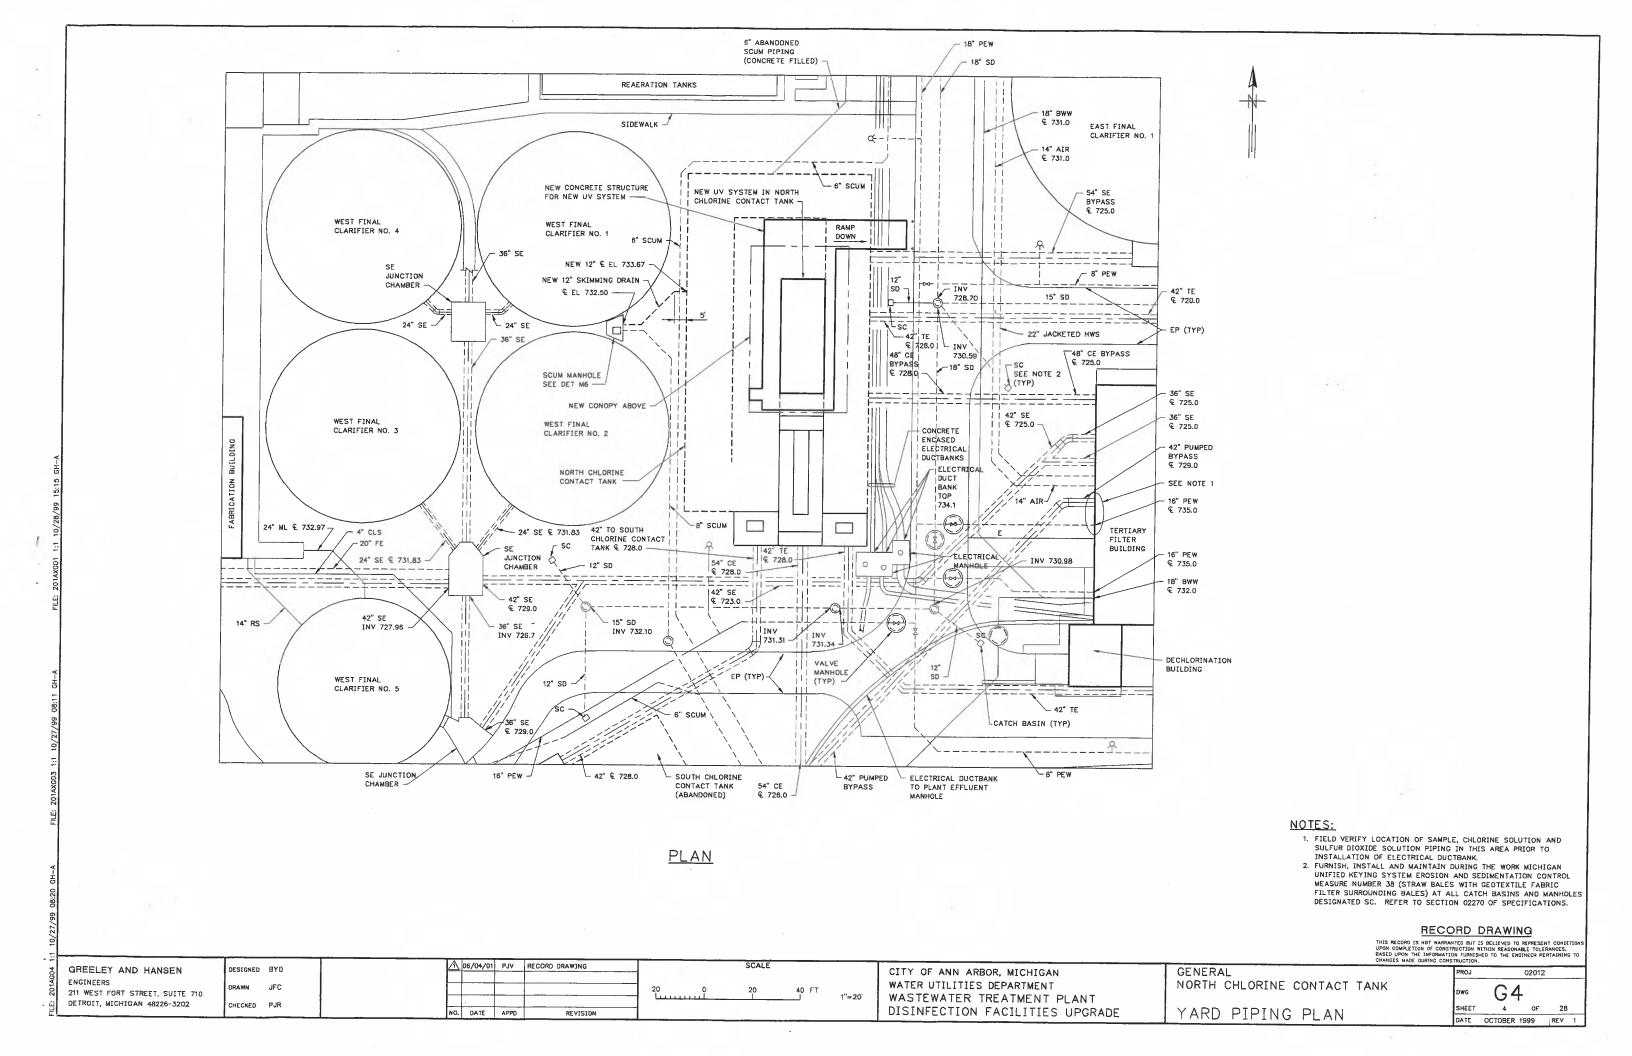


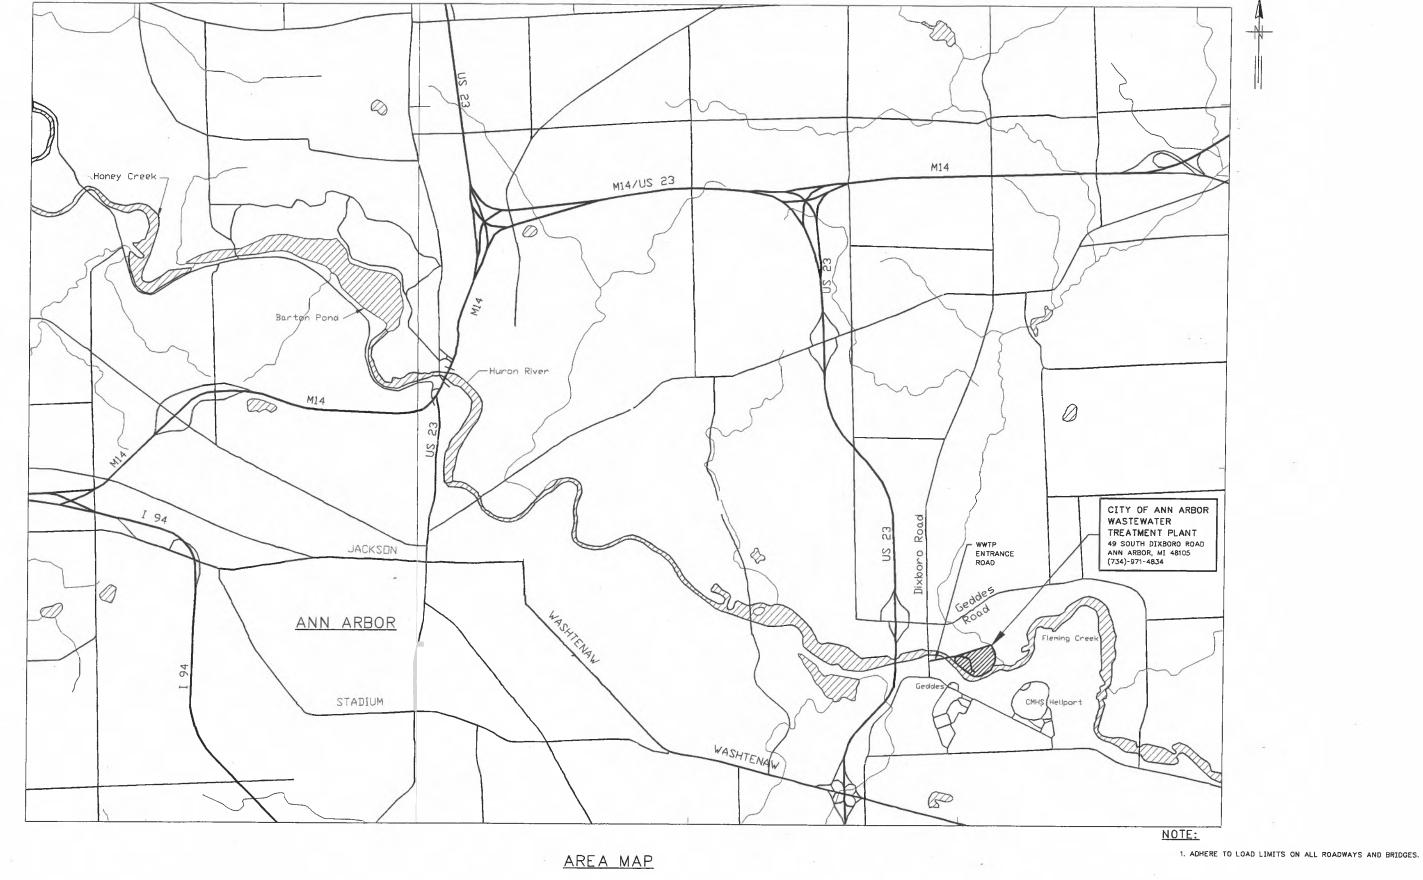
RECORD DRAWING

THIS RECORD IS NOT WARRANTED BUT IS BELIEVED TO REPRESENT CONDITUTION COMPLETION OF CONSTRUCTION WITHIN REASONABLE TOLERANCES, BASED UPON THE INFORMATION FURNISHED TO THE EMGINEER PERTAINING CHANGES MADE DURING CONSTRUCTION.

106/04/01 PJV RECORD DRAWING SCALE DESIGNED NBJ GENERAL GREELEY AND HANSEN CITY OF ANN ARBOR, MICHIGAN 02012 ENGINEERS WATER UTILITIES DEPARTMENT G2 2000 4000 FT 211 WEST FORT STREET, SUITE 710 VICINITY MAP AND SITE LOCATION WASTEWATER TREATMENT PLANT DETROIT, MICHIGAN 48225-3202 CHECKED PJR DISINFECTION FACILITIES UPGRADE NO. DATE APPO REVISION DATE OCTOBER 1999 REV 1



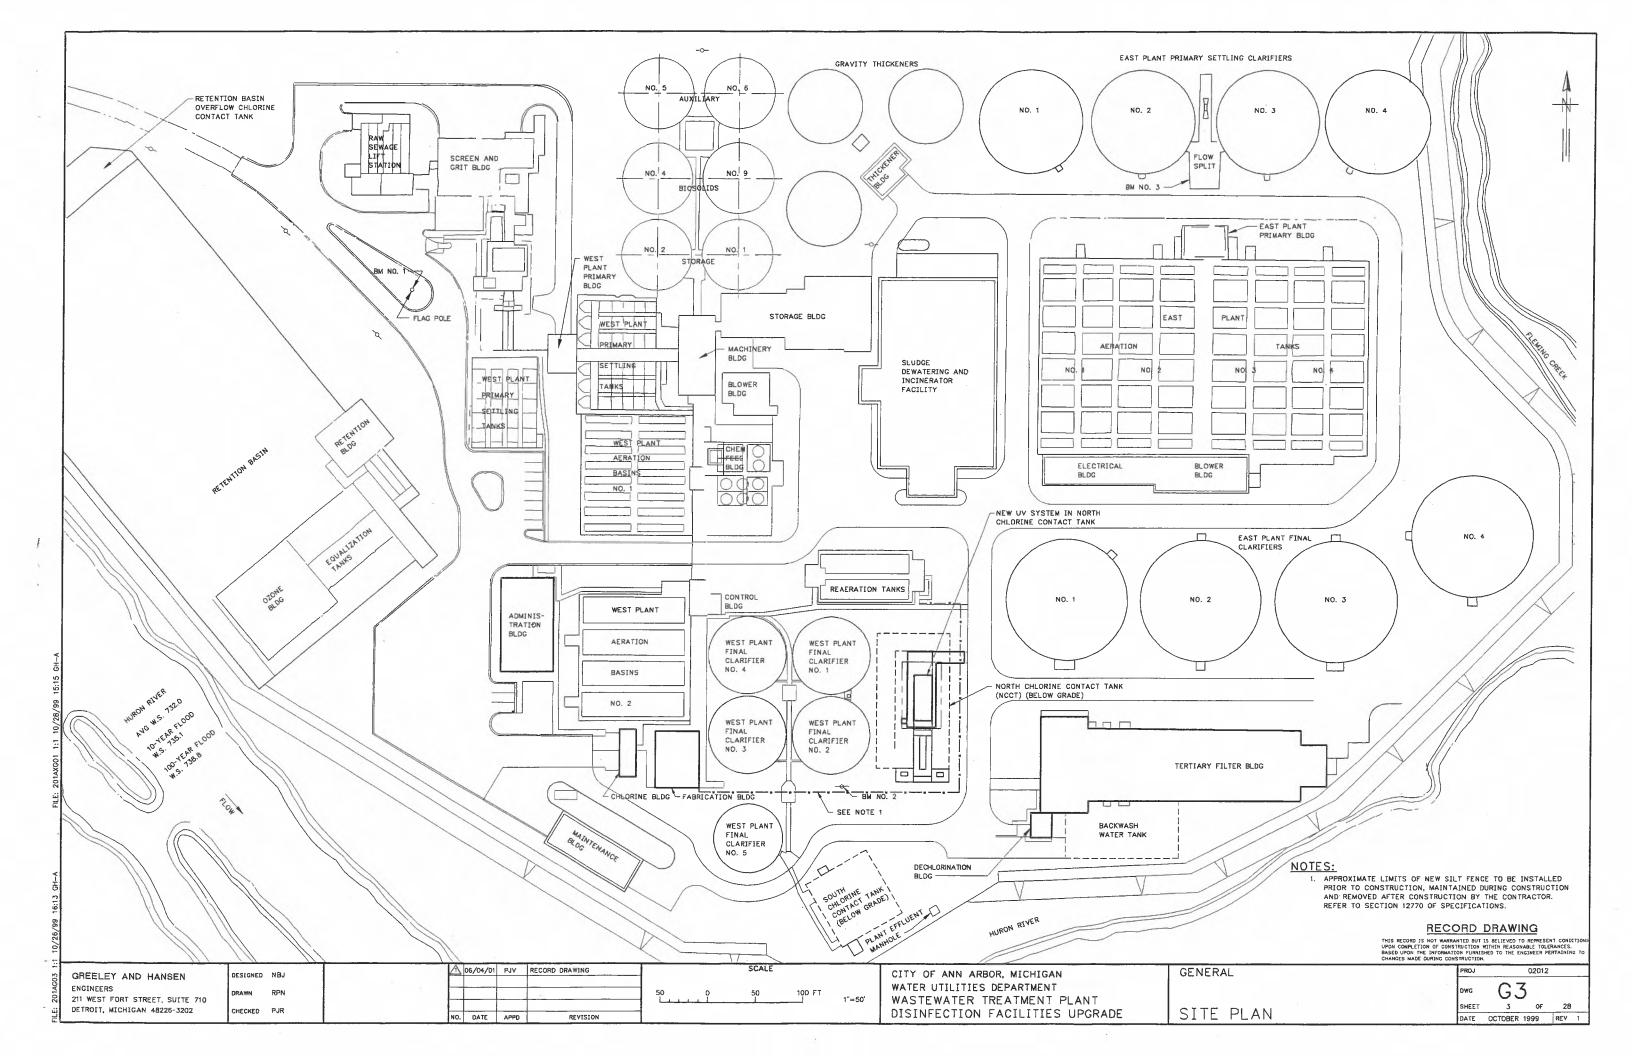

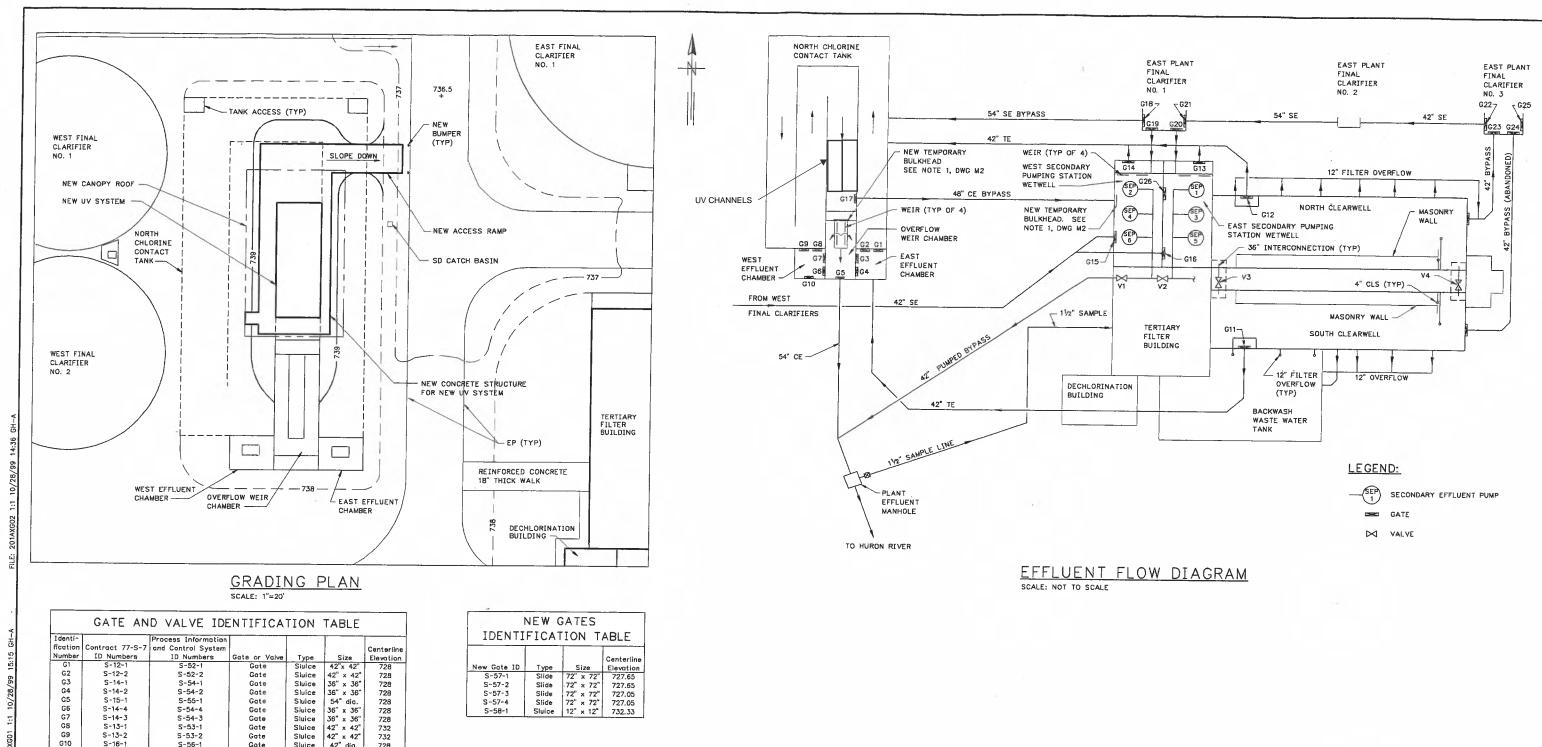

SCALE

NOTES:

- A DASHED LINE (———) INDICATES EXISTING CONTOUR.
 A HEAVY SOLID LINE (———) INDICATES NEW CONTOUR.
 FIELD VERIFY EXISTING TOPOGRAPHIC CONDITIONS.
- 2. FIELD VERIFY EXISTING TOPOGRAPHIC CONDITIONS.

 3. SLOPE WALK FROM EL 743.00 TO MATCH EXISTING ELEVATION AT BOAD.

RECORD DRAWING

THIS RECORD IS NOT WARRANTED BUT IS BELIEVED TO REPRESENT CONDITIONS UPON COMPLETION OF CONSTRUCTION WITHIN REASONABLE TOLERANCES, BASED UPON THE INFORMATION FURNISHED TO THE ENGINEER PERTAINING TO CHANGES MADE DURING CONSTRUCTION.

CITY OF ANN ARBOR, MICHIGAN
WATER UTILITIES DEPARTMENT
WASTEWATER TREATMENT PLANT
DISINFECTION FACILITIES UPGRADE

GRADING PLAN AND DIAGRAM

	GATE AN	D VALVE IDE	NTIFICA	TION	TABLE	
Identi-		Process Information			T	
fication	Contract 77-S-7	and Control System				Centerline
Number	ID Numbers	ID Numbers	Gate or Vaive	Туре	Size	Elevation
G1	S-12-1	S-52-1	Gate	Sluice	42"x 42"	728
G2	S-12-2	5-52-2	Gate	Sluice	42" x 42"	728
G3	S-14-1	S-54-1	Gate	Sluice	36" x 36"	728
G4	S-14-2	S-54-2	Gate	Sluice	36" x 36"	728
G5	S-15-1	S-55-1	Gate	Sluice	54" dia.	728
G6	5-14-4	5-54-4	Gate	Sluice	36" x 35"	728
G7	S-14-3	S-54-3	Gate	Sluice	36" x 36"	728
GB	S-13-1	S-53-1	Gate	Sluice	42" x 42"	732
G9	S-13-2	S-53-2	Gate	Sluice	42" x 42"	732
G10	S-16-1	S-56-1	Gate	Sluice	42" dia.	728
G11	S-5-1	"	Gate	Sluice	42" dia.	728
G12	S~4-1		Gate	Sluice	42" dia.	728
G13	S-1-2		Gate	Sluice	42" dia.	726
G14	S-1-1		Gate	Sluice	42" dia.	726
G15	S-2-1		Gate	Sluice	36" dia.	725
G16	S-2-2		Gate	Sluice	36" dia.	725
G17	S-11-1	S-51-1	Gate	Sluice	48" día.	728
G18	S-7-1	S-47-1	Gate	Sluice	54" dia.	725
G19	S-6-1	S-46-1	Gate	Sluice	48" dia.	725
G20	S-6-2	S-46-2	Gote	Sluice	48" dia.	725
G21	S-7-2	S-47-2	Gate	Sluice	54" dia.	725
G22	S-9-1	S-49-1	Gate	Sluice	42" dia.	725
G23	S-8-1	S-48-1	Gate	Sluice	42" dia.	725
G24	S-8-2	S-48-2	Gate	Sluice	42" dia.	725
G25	S-10-1	S-50-1	Gate	Sluice	42" dia.	725
G26	S-3-1		Gate	Sluice	36" × 36"	725
V1	*B-3-1		Valve	Butterfly	42" dia.	729.5
V2	B-2-1		Valve	Butterfly	48" dia.	747.5
V3	B-9-1		Valve	Butterfly	36" dìa.	725
V4	B-9-2		Valve	Butterfly	36" dia.	725

DESIGNED NBJ

DRAWN GSD

CHECKED PJR

GREELEY AND HANSEN

211 WEST FORT STREET, SUITE 710


DETROIT, MICHIGAN 48226-3202

ENGINEERS

1 06/04/01 PJV RECORD DRAWING

REVISION

NO. DATE APPD

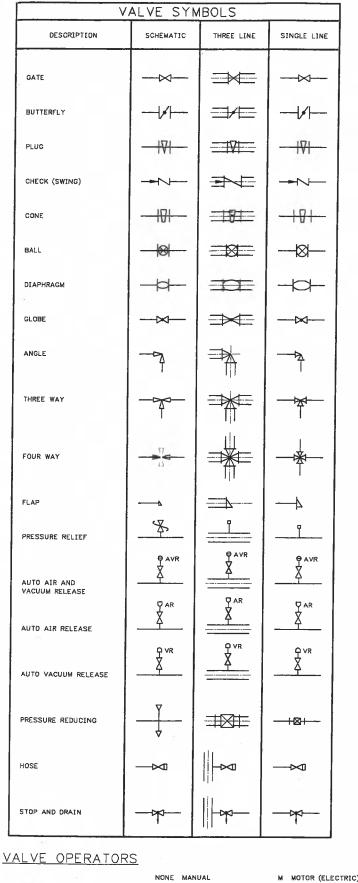

	PIPE FITT		Τ
DESCRIPTION	SCHEMATIC	THREE LINE	SINGLE LIN
CROSS	NA		
CROSS	NA		
TEE	NA NA	#	-++
TEE	NA		-1 ⊙⊢
TEE	NA		-101
SIDE OUTLET TEE	NA		<u>−</u> • <u></u>
SIDE OUTLET TEE	NA	=======================================	-191-
LATERAL	NA	***	+×+-
90° ELBOW	NA		
90° ELBOW	NA		 !0
90° ELBOW	NA		10
90° ELBOW (LONG RADIUS)	NA	LR	LR
45° ELBOW	NA	=>	\rightarrow
45° ELBOW	NA	==	10-
45° ELBOW	NA	=======================================	10-
45° ELBOW (LONG RADIUS)	NA	LR	
SIDE OUTLET ELBOW	NA		
SIDE OUTLET ELBOW	NA		
BASE ELBOW	NA		

	4		
DESCRIPTION	SCHEMATIC	THREE LINE	SINGLE LINE
UNION (SCREWED)			—ф—
REDUCER		===	
REDUCER - ECCENTRIC (OFFSET VIEW)	NA	===	
BLIND FLANGE			
SLEEVE TYPE COUPLING			
SLEEVE TYPE COUPLING (HARNESSED)			——#——
GROOVED TYPE COUPLING	GC U	GC GC	GC GC
EXPANSION JOINT RUBBER BELLOWS TYPE		==0=	1001
EXPANSION JOINT METAL BELLOWS TYPE	www		
VENTURI METER		**	→
METER	M	###	 M
STRAINER	-+>+-	**	-1>+
DUPLEX STRAINER	-8-	=8=	- 181 -
LUBE OIL FILTER	—⊗—	NA	
MOISTURE SEPARATOR		NA	
SCALE TRAP	—[o]—	NA	-[0]
FLAME TRAP		====	
VENT			
THERMOSTAT (TEMPERATURE REGULATOR)			
PRESSURE GAUGE			
THERMOMETER	HWL 1	HWL	Hwr I
WATER LEVEL ALARM	OR LWL	I OR LWL	OR LWL
DIFFERENTIAL PRESSURE GAUGE			

PIPE FITTINGS

	PIPE JOII	NTS	
DESCRIPTION	SCHEMATIC	THREE LINE	SINGLE LINE
FLANGE	NA		
MECHANICAL JOINT	NA	=	
MECHANICAL JOINT (RESTRAINED)	NA -	₩ -	
PUSH ON OR BELL AND SPIGOT	NA -		
PUSH ON OR BELL AND SPIGOT (RESTRAINED)	NA	₹ R	c R
WELDED	NA		NA
SCREWED	NA	====	
JOINT IN CONCRETE PIPE	NA		NA

W	ALL FITT	INGS	12
DESCRIPTION	SCHEMATIC	THREE LINE	SINGLE LINE
WALL SLEEVE (CAULKED)	NA		
WALL SLEEVE (ANNULAR TYPE SEAL)	NA		
WALL SLEEVE (MECHANICAL JOINT)	NA	- brond -	
FLANGE AND FLANGE WALL PIPE WITH INTERMEDIATE COLLAR (F × F × F)	NA		
BELL AND BELL WALL PIPE WITH INTERMEDIATE COLLAR (B × F × B)	NA	====	
MECHANICAL JOINT AND MECHANICAL JOINT WALL PIPE WITH INTERMEDIATE COLLAR (MJ x F x MJ)	NA		
BELL AND FLANGE WALL PIPE WITH INTERMEDIATE COLLAR (B × F × F)	NA		++-
MECHANICAL JOINT AND FLANGE WALL PIPE WITH INTERMEDIATE COLLAR (MJ × F × F)	NA		
STEEL WALL RING FOR MECHANICAL JOINT AND CONCRETE PIPE (RUBBER AND STEEL)	NA		NA

- PLACE KEY FOR OPERATOR IN PLACE OF #
- C CHAINWHEEL D DIAPHRAGM F FLOAT

H HYDRAULIC CYLINDER

M MOTOR (ELECTRIC)
P PNEUMATIC CYLINDER

A AIR MOTOR

RECORD DRAWING

THIS RECORD IS NOT WARRANTED BUT IS BELIEVED TO REPRESENT CONDITIONS UPON COMPLETION OF CONSTRUCTION WITHIN REASONABLE TOLERANCES, BASED UPON THE INFORMATION EVENTSHED TO THE ENGINEER PERTAINING TO CHANGES MADE DURING CONSTRUCTION.

NOTES:

- THIS IS A GENERAL LEGEND PROVIDED TO FACILITATE
 USE OF THE DRAWINGS. REFER TO THE DRAWINGS AND
 SPECIFICATIONS FOR ITEMS REQUIRED.
- 2. VALVES AND PIPE FITTINGS ARE SHOWN WITH FLANGED JOINTS. ITEMS ARE AVAILABLE WITH VARIOUS JOINTS AND ARE SHOWN AS REQUIRED. 3. NA MEANS NOT APPLICABLE.

_	
	GREELEY AND HANSEN
	ENGINEERS
	211 WEST FORT STREET, SUITE 7
	DETROIT, MICHIGAN 48226-3202

DESIGNED LCC CHECKED PJV


	\triangle	06/04/01	PJV	RECORD DRAWING
İ	L			
	L			
	NO.	DATE	APPD	REVISION

NOT TO SCALE

CITY OF ANN ARBOR, MICHIGAN WATER UTILITIES DEPARTMENT WASTEWATER TREATMENT PLANT DISINFECTION FACILITIES UPGRADE PIPING AND EQUIPMENT


PIPING SYMBOLS

02012 G6 DATE OCTOBER 1999 REV 1

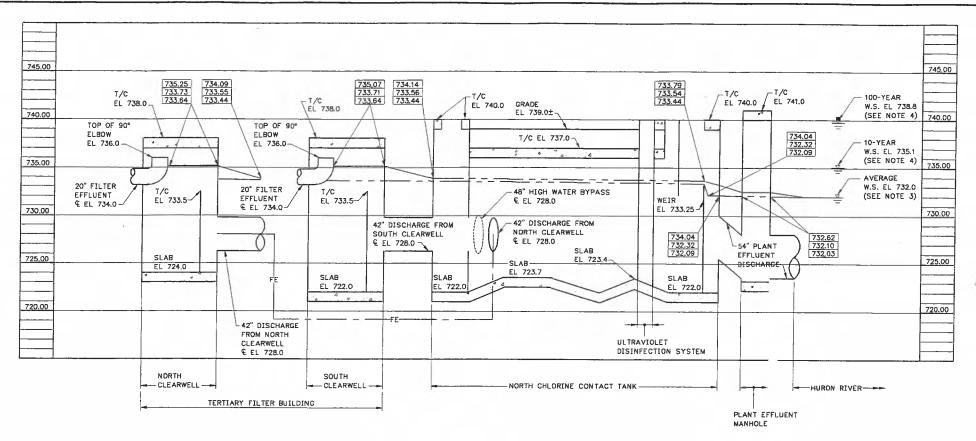

HYDRAULIC PROFILE OF EXISITNG CONDITIONS

HORZ: NO SCALE

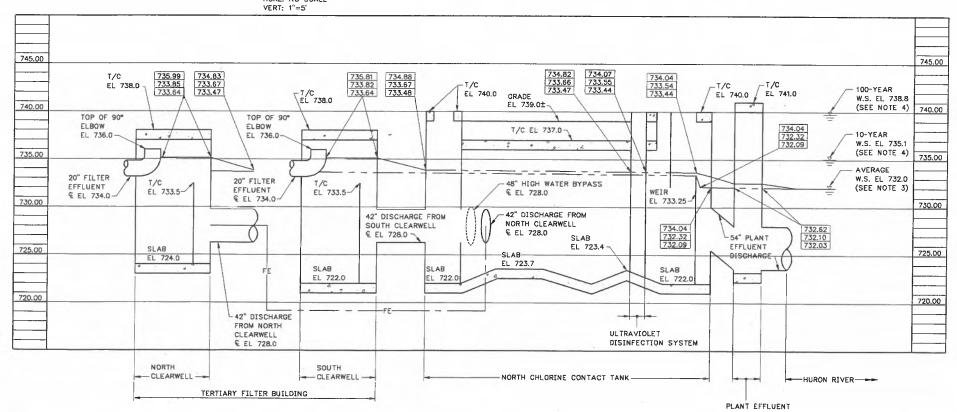

HYDRAULIC PROFILE INCLUDING ULTRAVIOLET DISINFECTION SYSTEM

HORZ: NO SCALE VERT: 1"=5"

105/04/01 PJV RECORD DRAWING GREELEY AND HANSEN DESIGNED NBJ ENGINEERS KPB 211 WEST FORT STREET, SUITE 710 DETROIT, MICHIGAN 48226-3202 CHECKED PJV NO. DATE APPO REVISION

HORIZ: NO SCALE

CITY OF ANN ARBOR, MICHIGAN WATER UTILITIES DEPARTMENT WASTEWATER TREATMENT PLANT DISINFECTION FACILITIES UPGRADE

GENERAL

NOTES:

1. ELEVATIONS SHOWN REFER TO NGVD OF 1929 OF THE U.S.G.S. DATUM.

OF 48 MGD BASED ON AVERAGE RIVER WATER SURFACE ELEVATION.

OF 19 MGD BASED ON AVERAGE RIVER WATER SURFACE ELEVATION.

10 MGD BASED ON AVERAGE RIVER WATER SURFACE ELEVATION.

MICHIGAN, PANEL 5 OF 10, DATED JUNE 18, 1980.

2. VALUE SHOWN XXX.XX IN UPPER BOX DENOTES WATER SURFACE AT PEAK HOUR FLOW

VALUE SHOWN XXXXXX IN MIDDLE BOX DENOTES WATER SURFACE AT AVERAGE FLOW

VALUE SHOWN XXXXXX IN LOWER BOX DENOTES WATER SURFACE AT LOW FLOW OF

PUBLIC WORKS, CITY OF ANN ARBOR, MICHIGAN WASTEWATER TREATMENT PLANT

4. 10- AND 100-YEAR RIVER WATER SURFACE ELEVATIONS FROM THE NATIONAL FLOOD

3. AVERAGE RIVER WATER SURFACE ELEVATION FROM WASHTENAW COUNTY, DEPARTMENT OF

IMPROVEMENTS, CONTRACT 77-S-7, C26 2539 05, VOLUME II DRAWINGS, DATED JULY 1977.

INSURANCE PROGRAM FLOOD BOUNDARY AND FLOODWAY MAP FOR TOWNSHIP OF ANN ARBOR,


HYDRAULIC PROFILES


RECORD DRAWING


IS NOT WARRANTED BUT IS BELIEVED TO REPRESENT CONDITION OF CONSTRUCTION WITHIN REASONABLE TOLERANCES, THE INFORMATION FURNISHED TO THE ENGINEER PERTAINING


G7


DATE OCTOBER 1999 REV 1

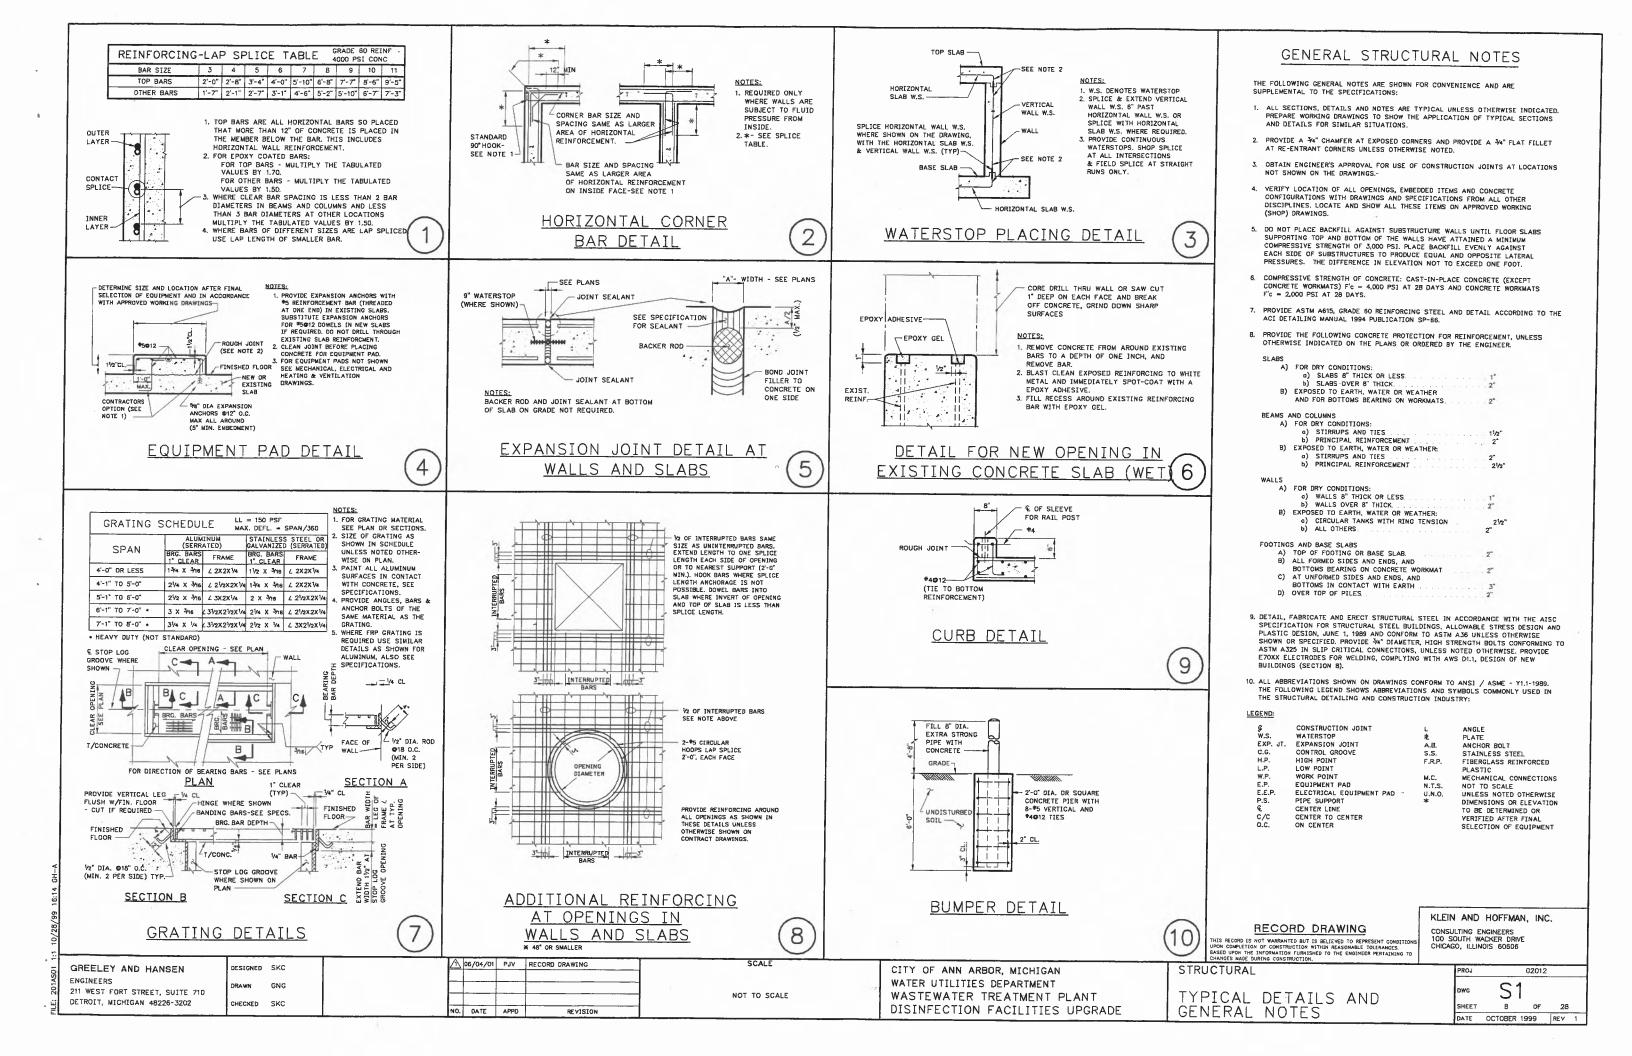


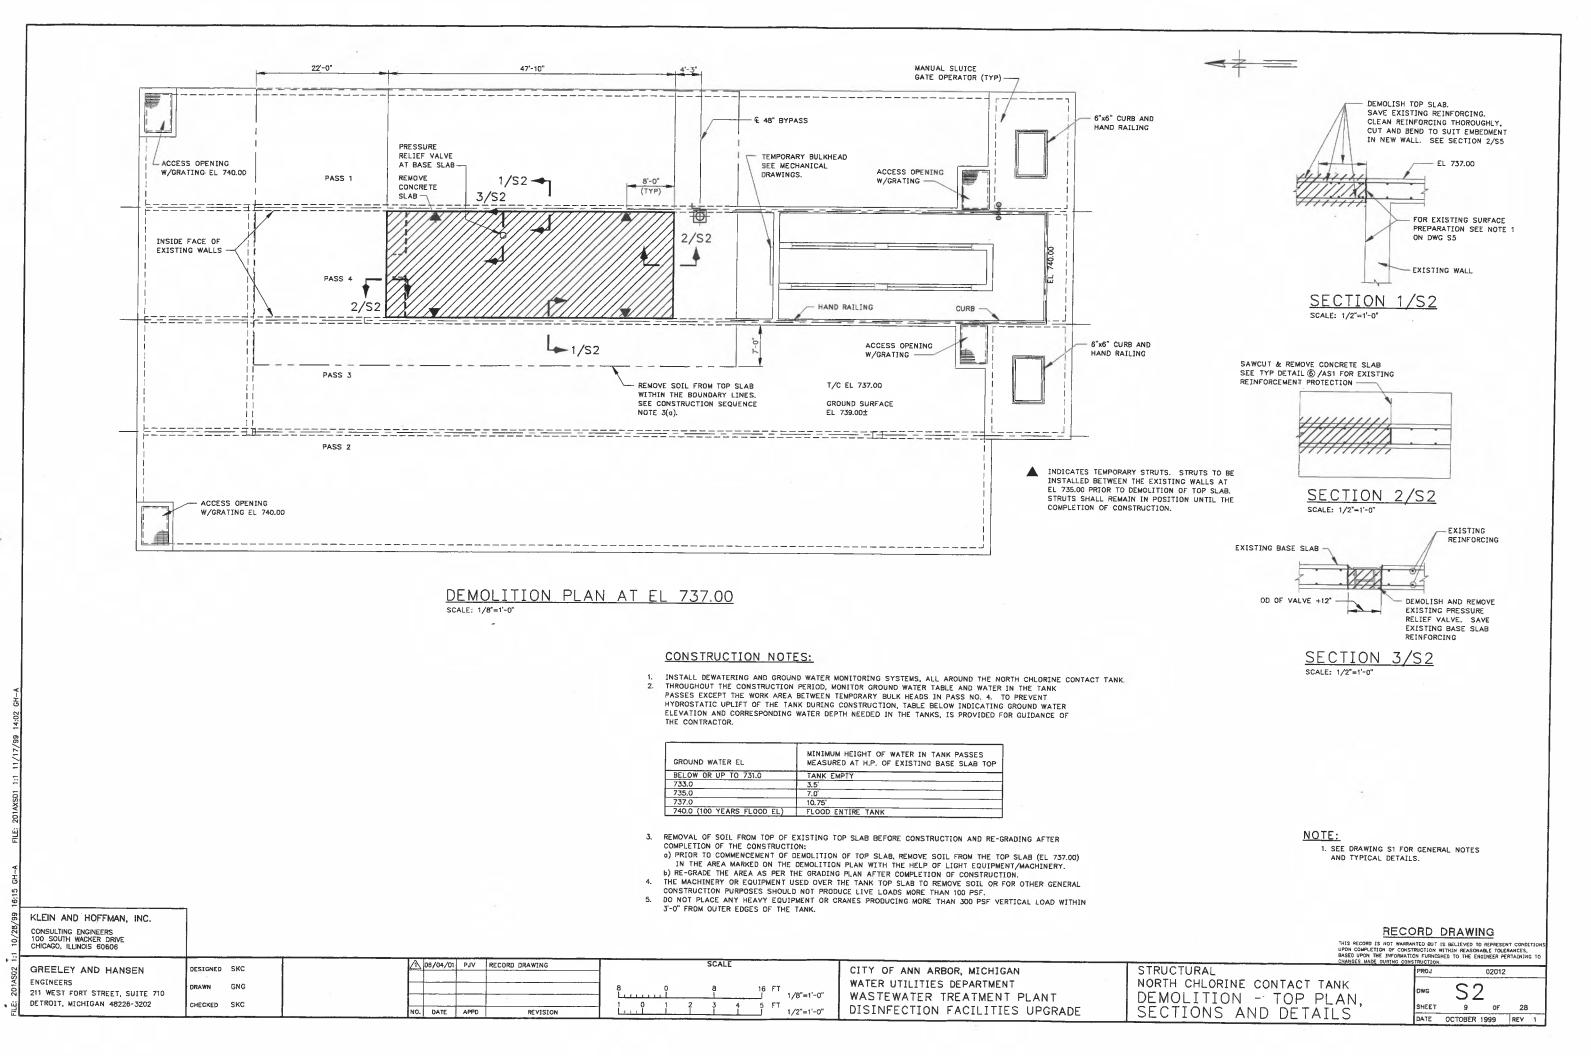


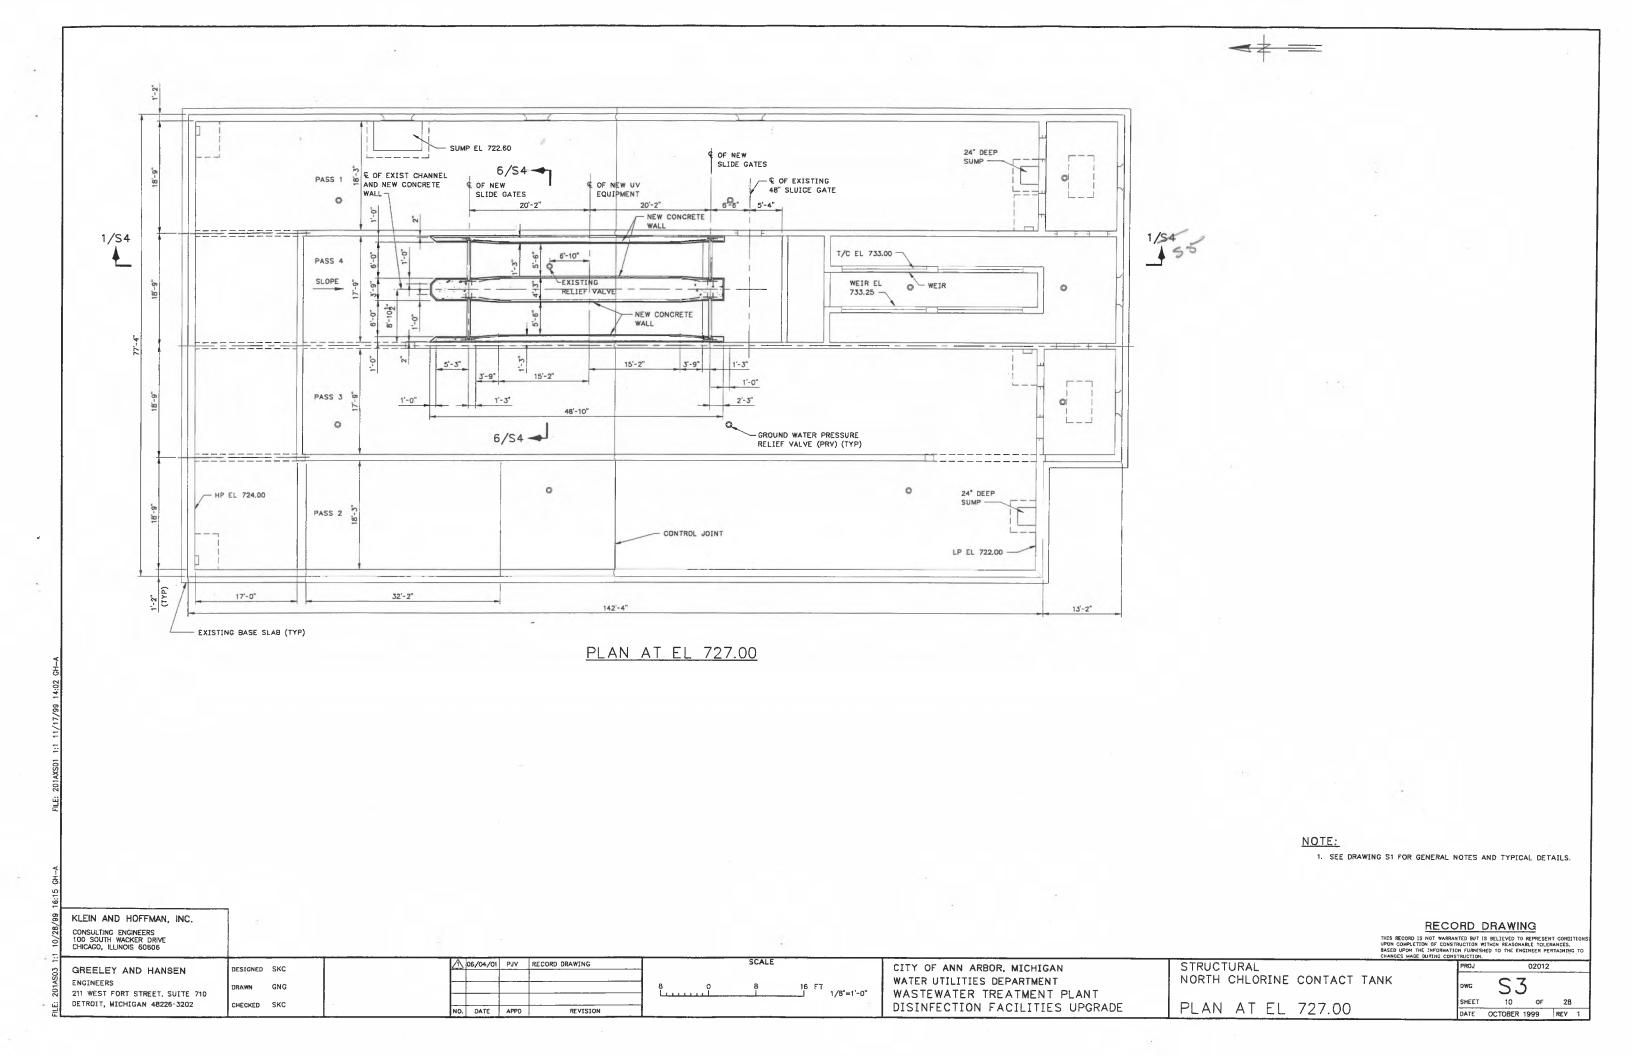

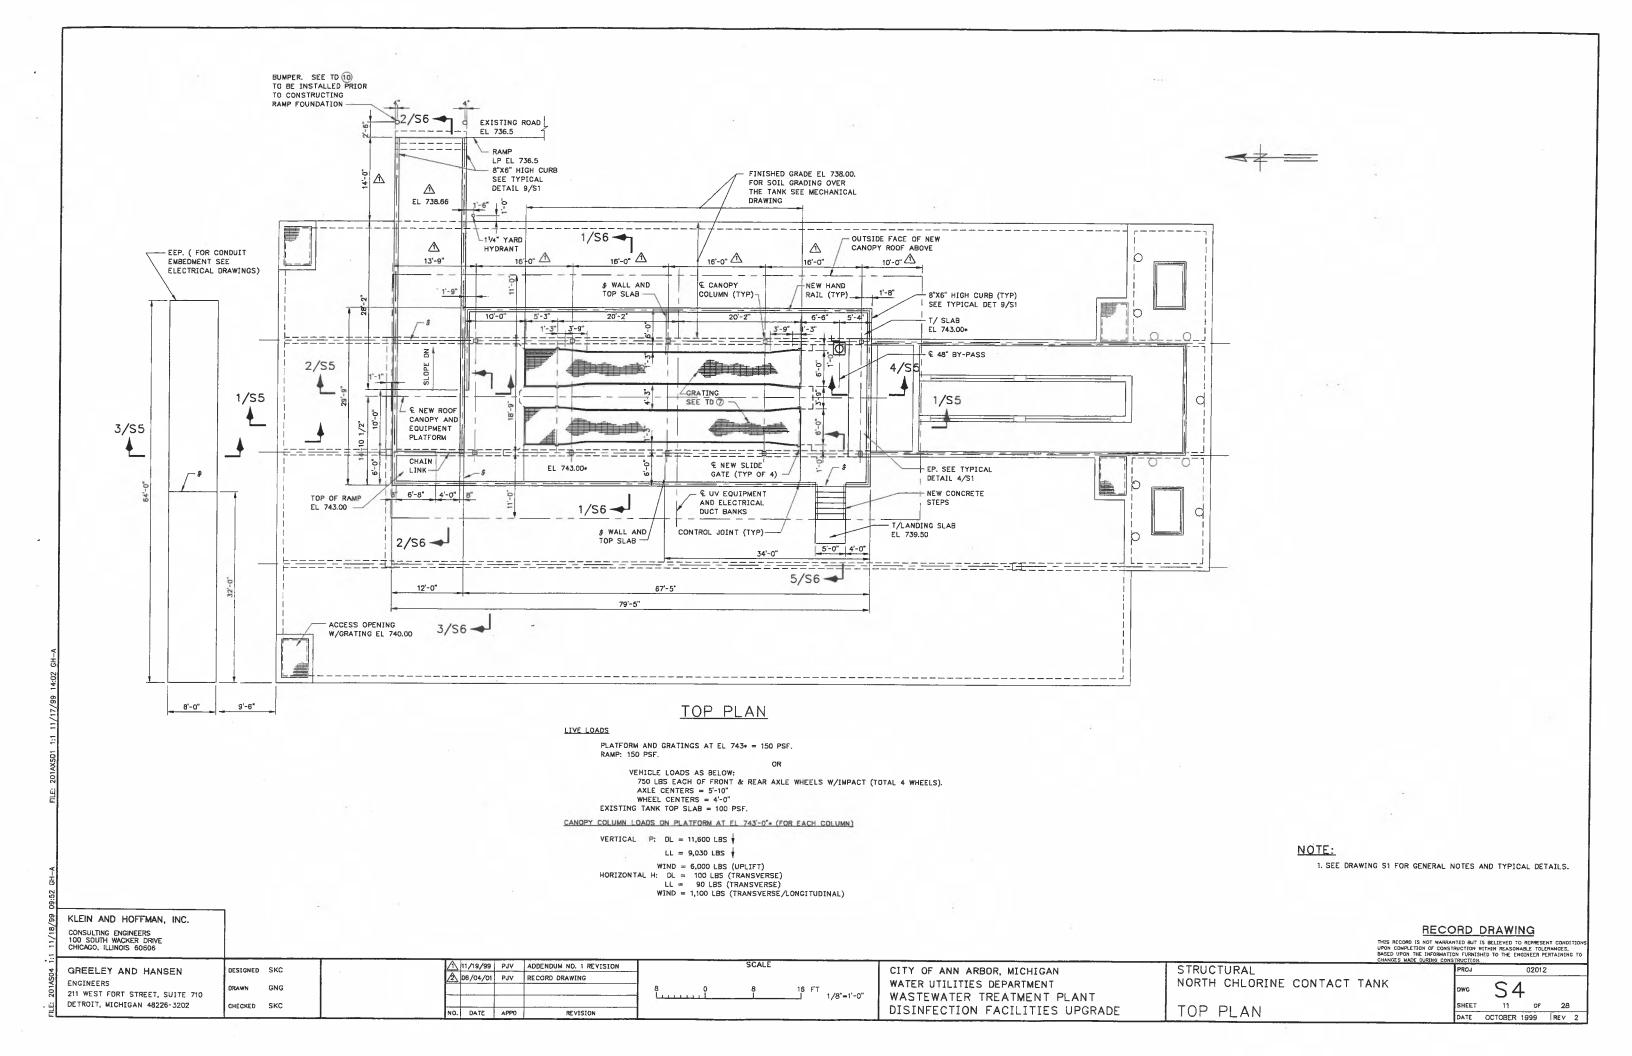

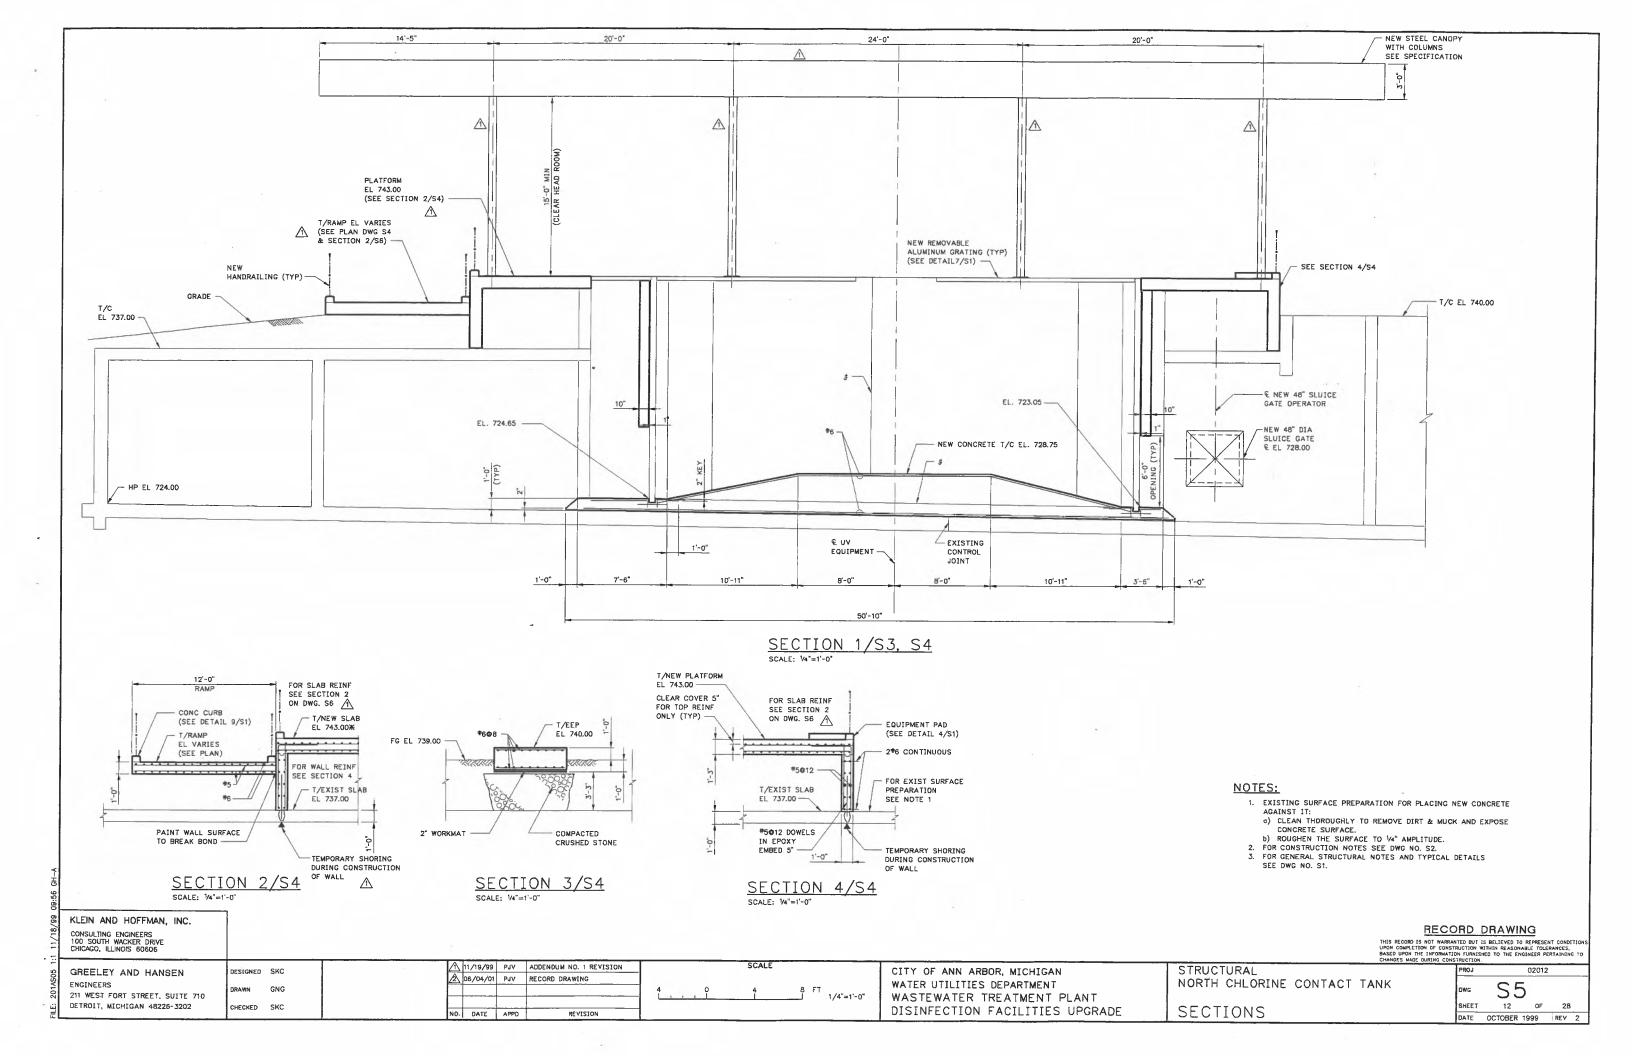

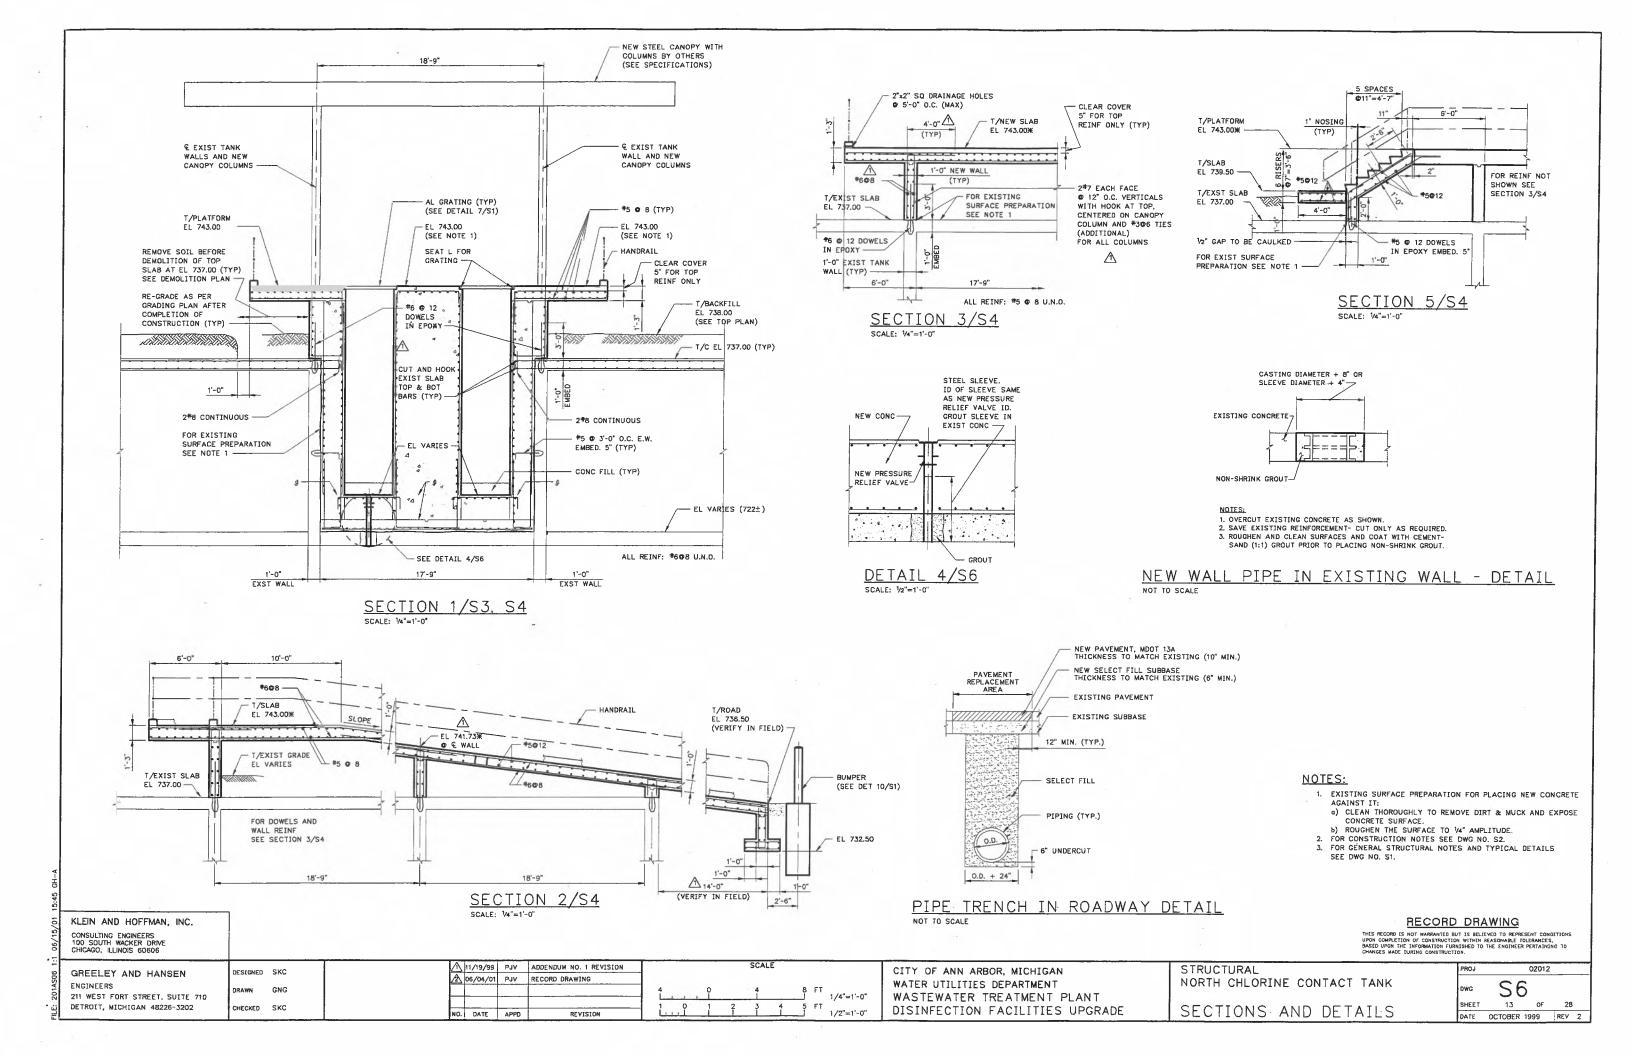

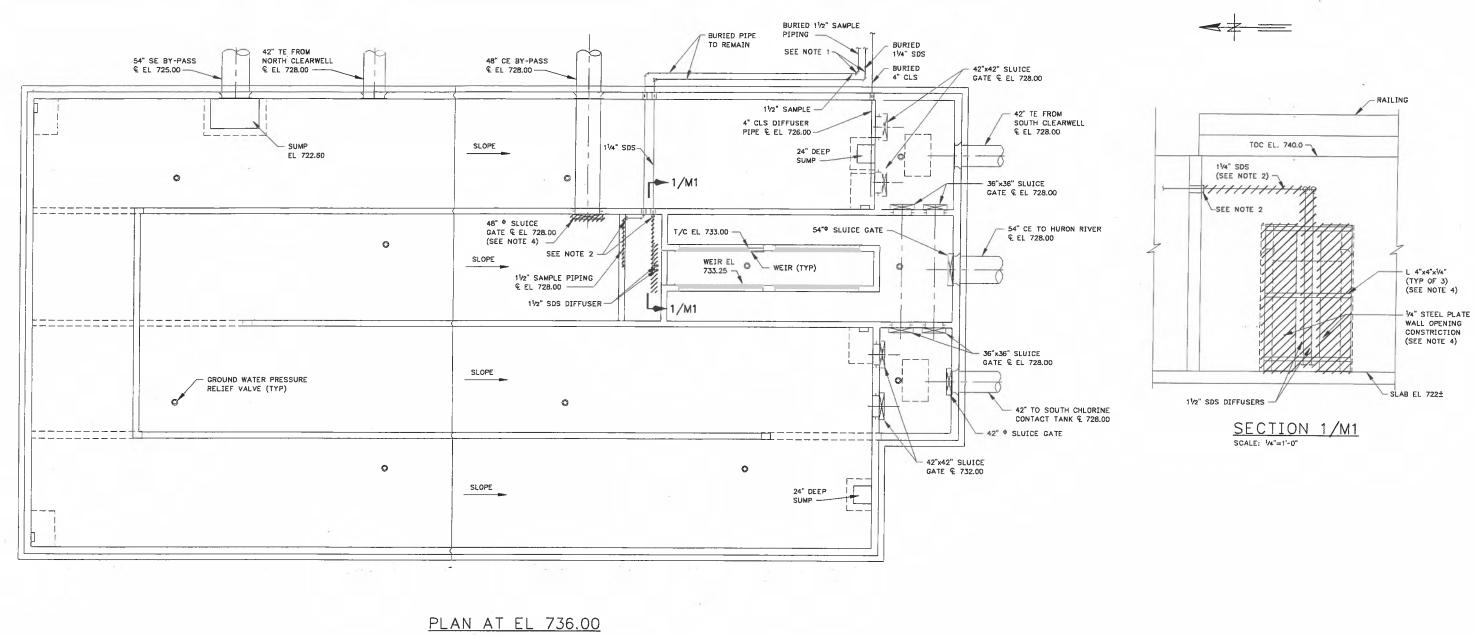

NOTES:

- 1. NOTE REMOVED.
- 2. 1½° SAMPLE PIPING AND 1¼° SDS PIPING CAPPED.

 3. REMOVE ALL ¼° STEEL PLATES, 4°×4°×½° ANGLE AND ALL ASSOCIATED HARDWARE FROM STEEL PLATE WALL OPENING CONSTRICTION.
- REMOVE EXISTING 48^{*©} SLUICE GATE STEM, OPERATOR STAND AND MOTOR OPERATOR, EXISTING WALL THIMBLE TO REMAIN.

RECORD DRAWING

THIS RECORD IS NOT WARRANTED BUT IS BELIEVED TO REPRESENT COUPON COMPLETION OF CONSTRUCTION WITHIN REASONABLE TOLERANCE BASED UPON THE INFORMATION FURNISHED TO THE ENGINEER PERTAIN


PIPING AND EQUIPMENT NORTH CHLORINE CONTACT TANK DEMOLITION PLAN AT EL 736.00


M1 SHEET 14 OF DATE OCTOBER 1999 REV 1

SCALE: 1/8"=1'-0"

105/04/01 PJV RECORD DRAWING GREELEY AND HANSEN DESIGNED NBJ ENGINEERS 211 WEST FORT STREET, SUITE 710 1/8"=1'-0" DETROIT, MICHIGAN 48226-3202 CHECKED PJR 1/4"=1'-0" NO. DATE APPD REVISION

CITY OF ANN ARBOR, MICHIGAN WATER UTILITIES DEPARTMENT WASTEWATER TREATMENT PLANT DISINFECTION FACILITIES UPGRADE

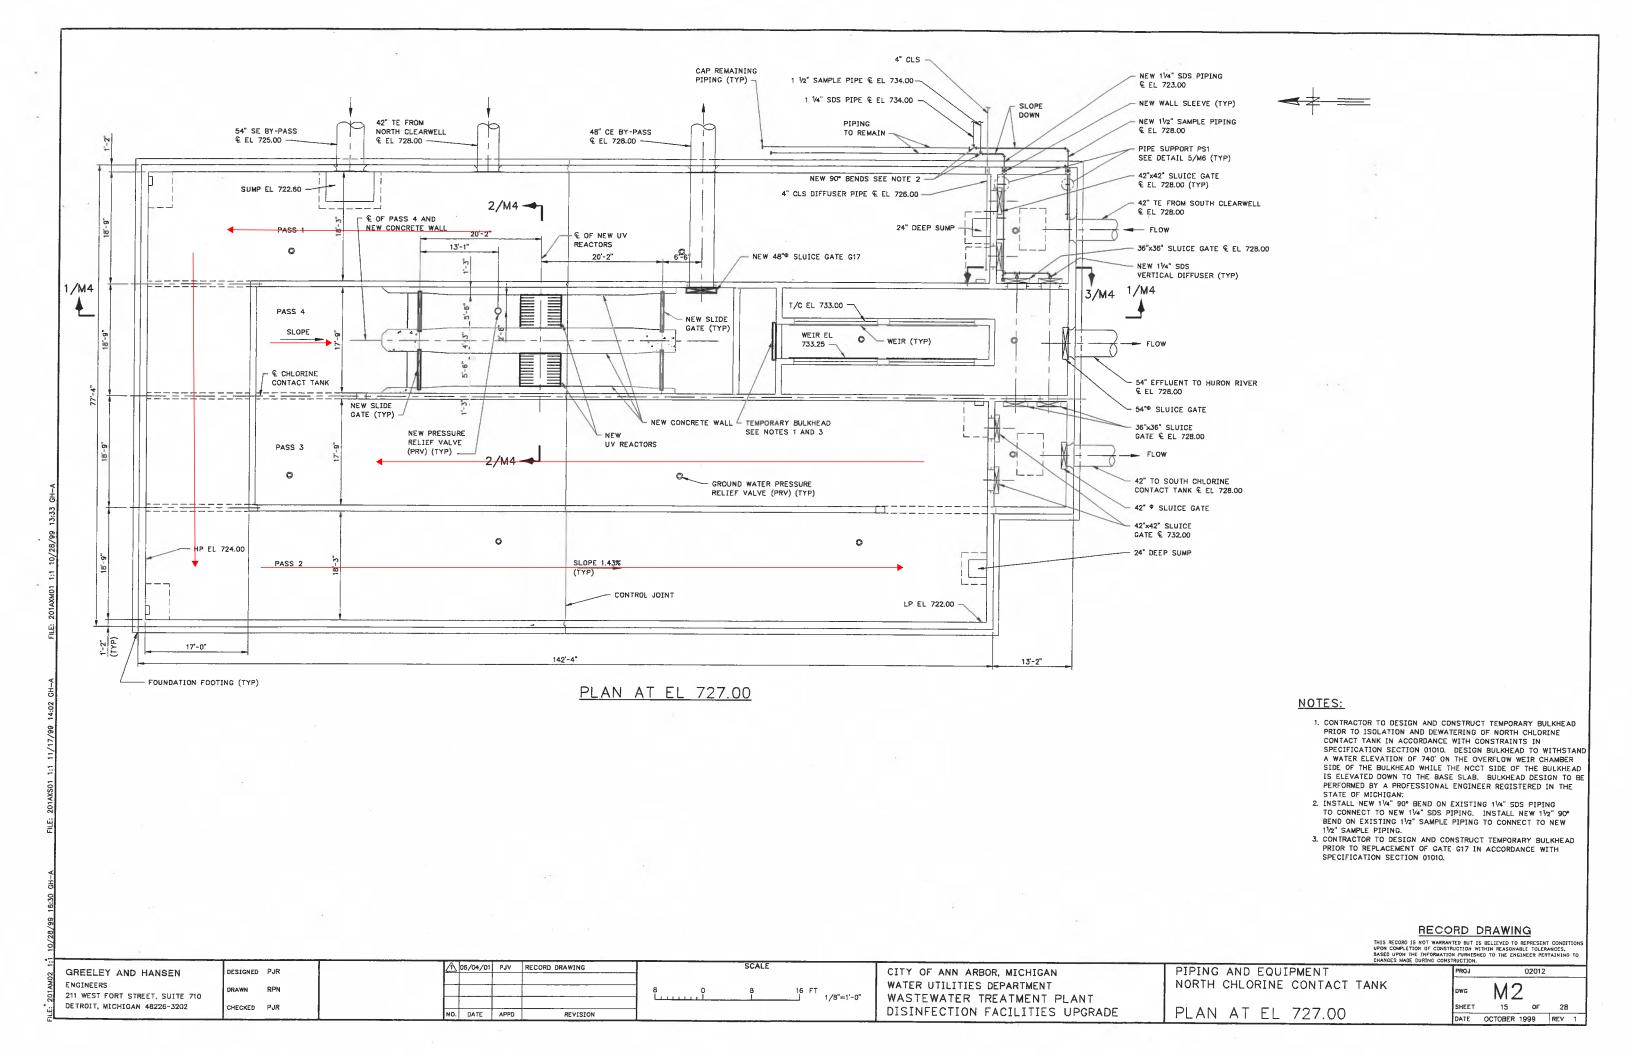

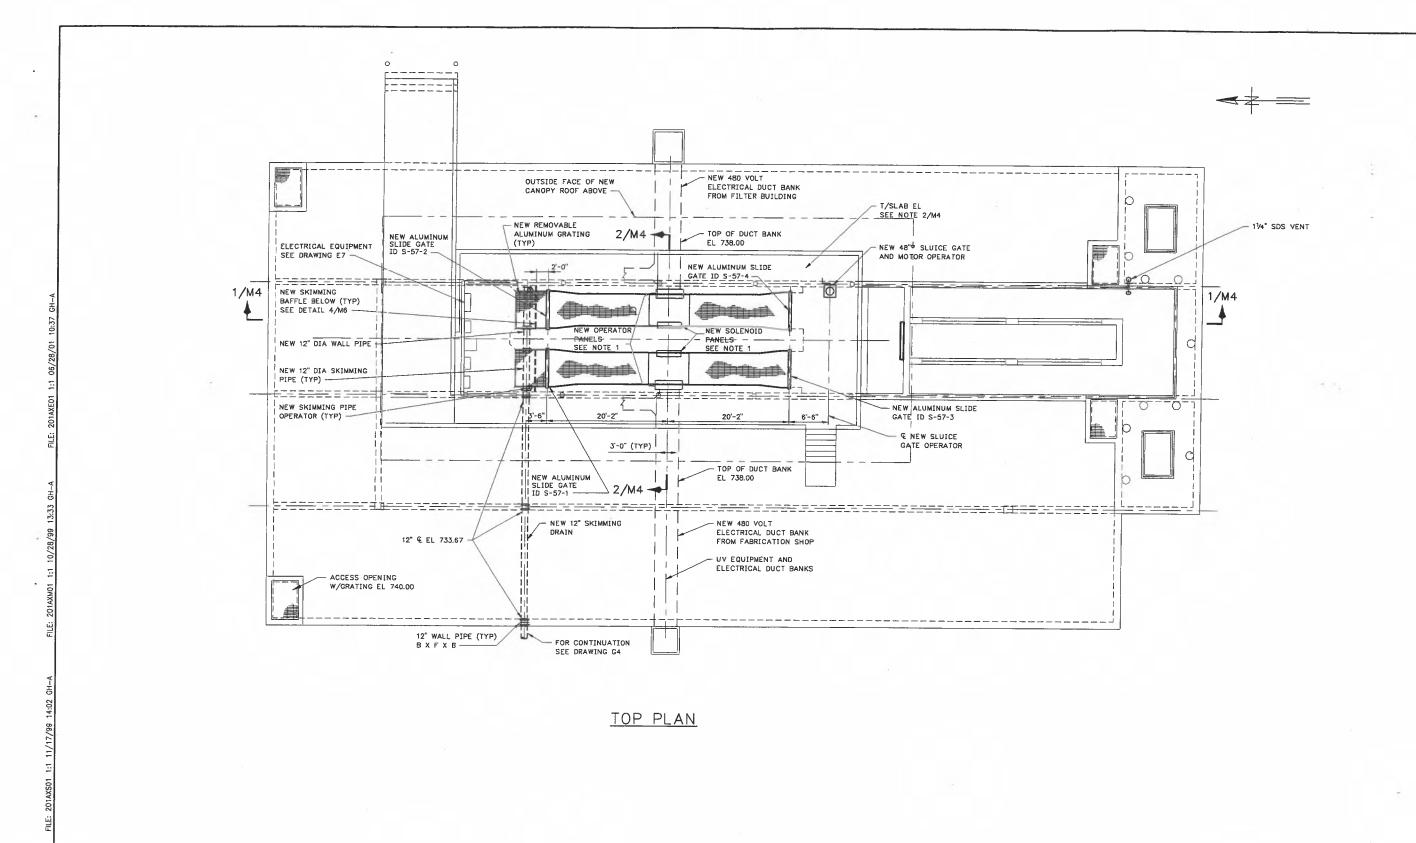

RECORD DRAWING


THIS RECORD IS NOT WARRANTED BUT IS BELIEVED TO REPRESENT CONDITIONS UPON COMPLETION OF CONSTRUCTION WITHIN REASONABLE TOLERANCES, BASED UPON THE INFORMATION FURNISHED TO THE ENGINEER PERTAINING TO CHANGES MADE DURING CONSTRUCTION.


CITY OF ANN ARBOR, MICHIGAN WATER UTILITIES DEPARTMENT WASTEWATER TREATMENT PLANT DISINFECTION FACILITIES UPGRADE


PIPING AND EQUIPMENT NORTH CHLORINE CONTACT TANK TOP PLAN


02012 М3 16 OF 28 DATE OCTOBER 1999 REV 1

GREELEY AND HANSEN	DESIGNED	PJR	Λ	06/04/01	PJV	RECORD DRAWING		SCALE		
ENGINEERS 211 WEST FORT STREET, SUITE 710	DRAWN	GD					8 O	8	16 FT I 1/8"=1'-0"	
	CHECKED	PJR	NO.	DATE	APPD	REVISION				

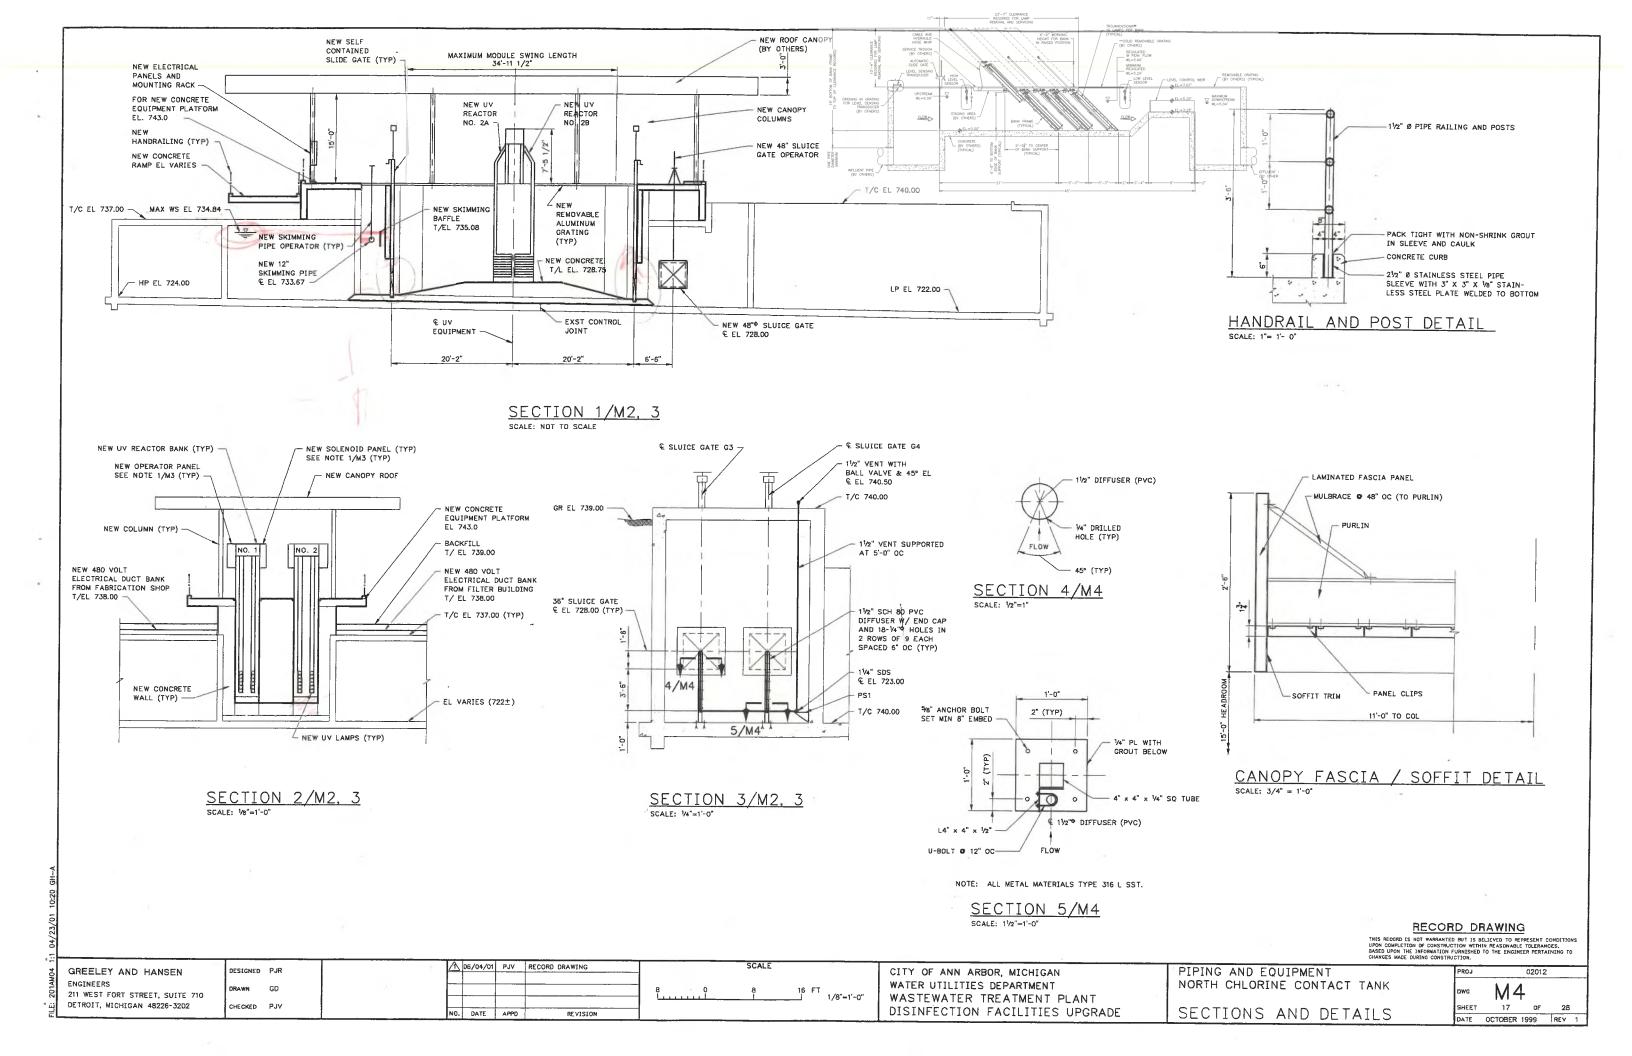

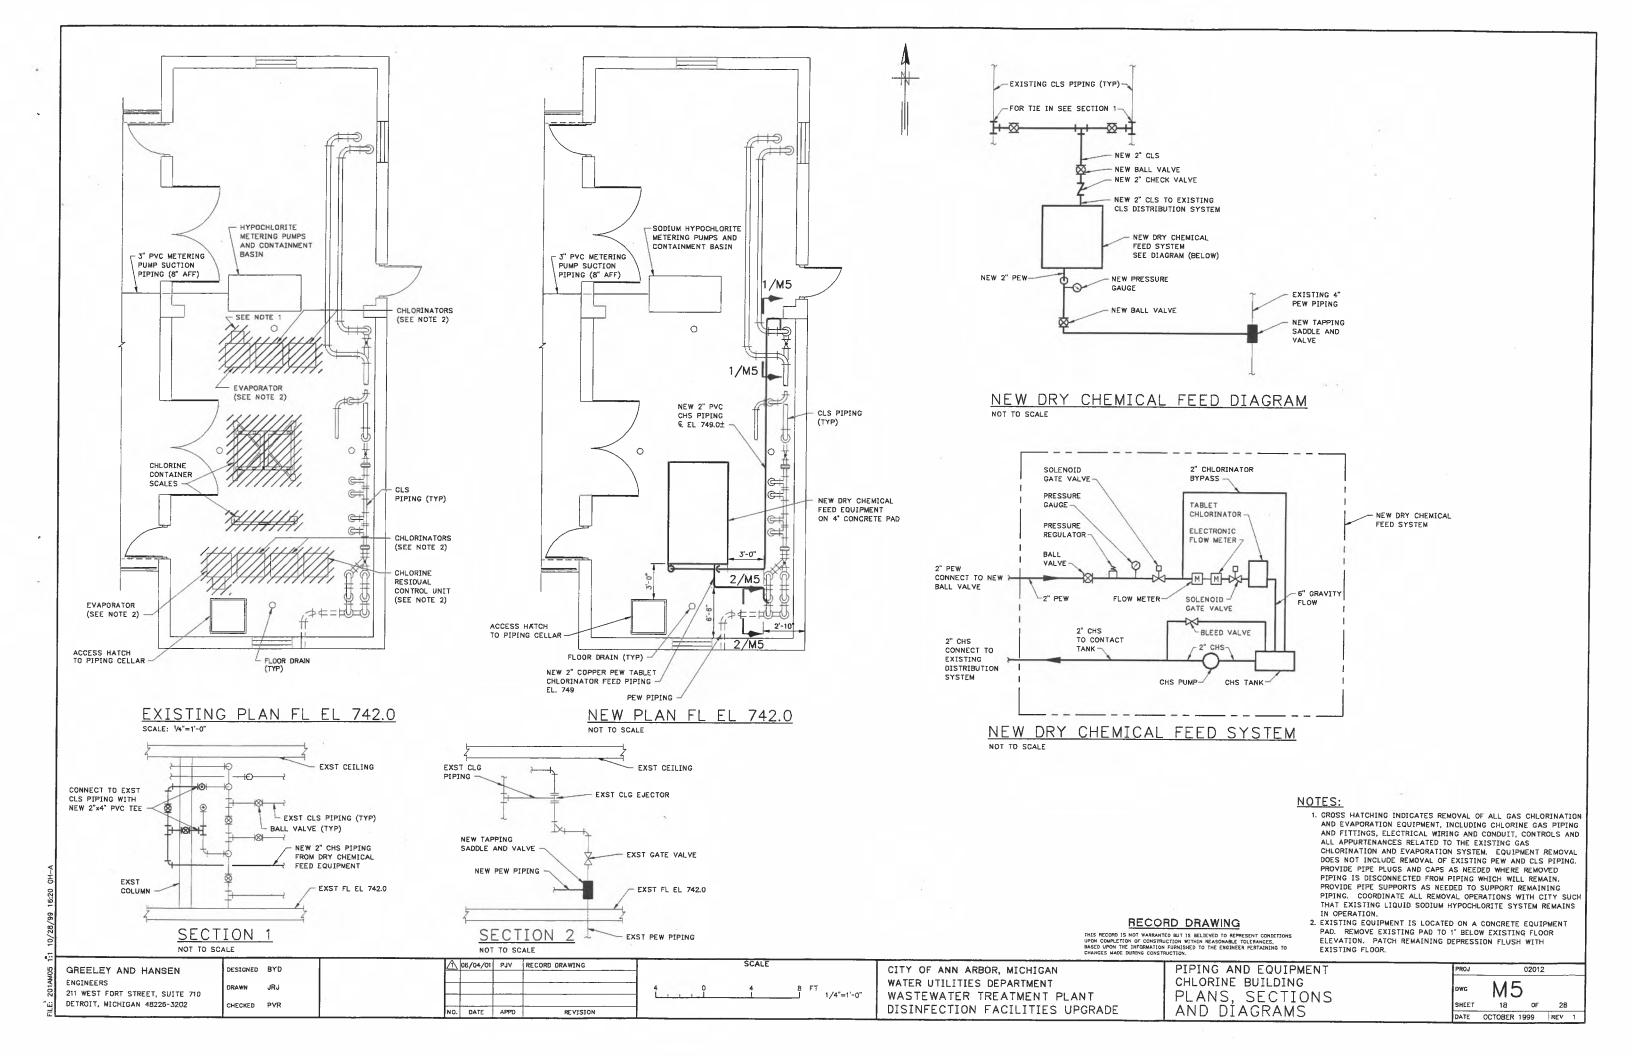

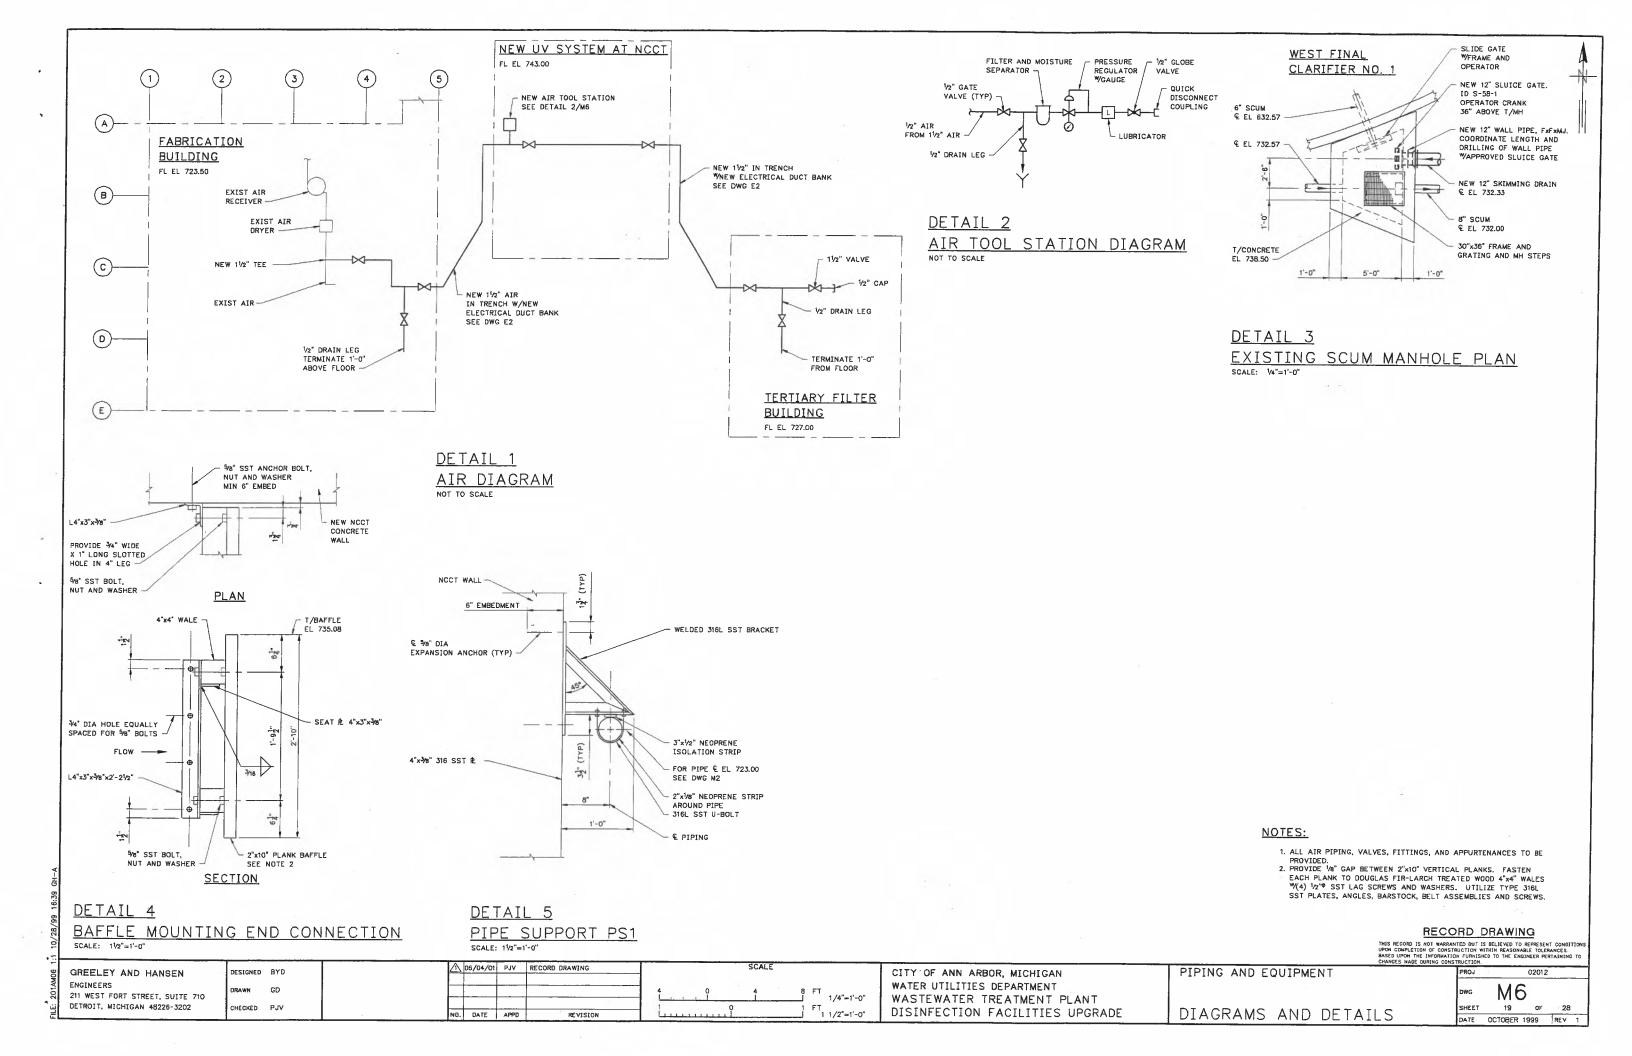

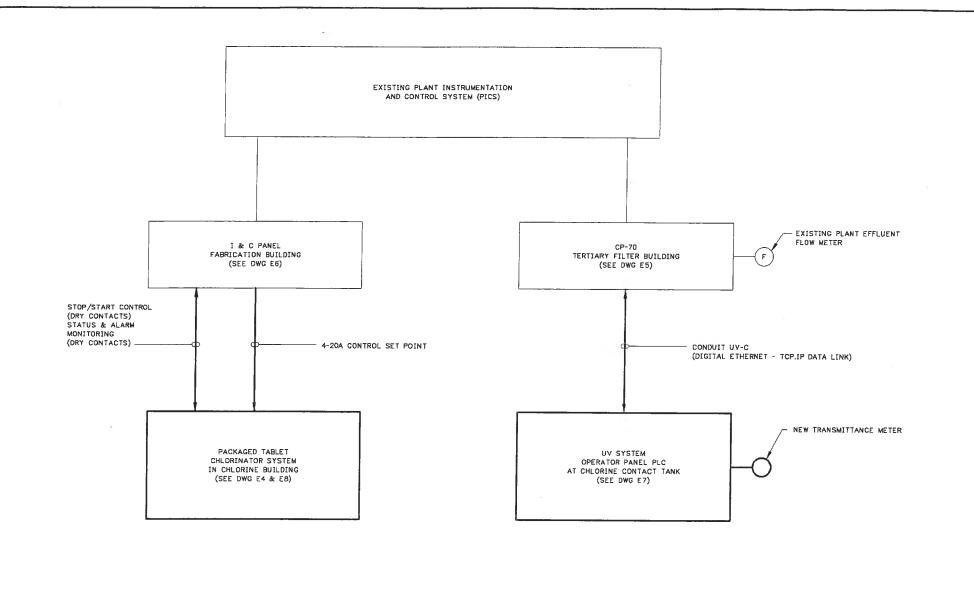

RECORD DRAWING

THIS RECORD IS NOT WARRANTED BUT IS BELIEVED TO REPRESENT CONDITION UPON COMPLETION OF CONSTRUCTION WITHIN REASONABLE TOLERANCES, BASED UPON THE INFORMATION FURNISHED TO THE ENGINEER PERTAINING TO CHAMGES MADE DURING CONSTRUCTION.

WATER UTILITIES DEPARTMENT
WASTEWATER TREATMENT PLANT
DISINFECTION FACILITIES UPGRADE

CITY OF ANN ARBOR, MICHIGAN

INSTRUMENTATION AND CONTROL DIAGRAMS

INSTRUMENTATION

PROJ 02012

DWG I 1

SHEET 20 OF 28

DATE OCTOBER 1999 REV 1

14101 1:1 10/26/99 15:30 GH-A

GREELEY AND HANSEN ENGINEERS 211 WEST FORT STREET, SUITE 710 DETROIT, MICHIGAN 48226-3202

DESIGNED SHP


DRAWN AF


CHECKED SHP


NO. DATE APPD REVISION


NOT TO SCALE


SCALE

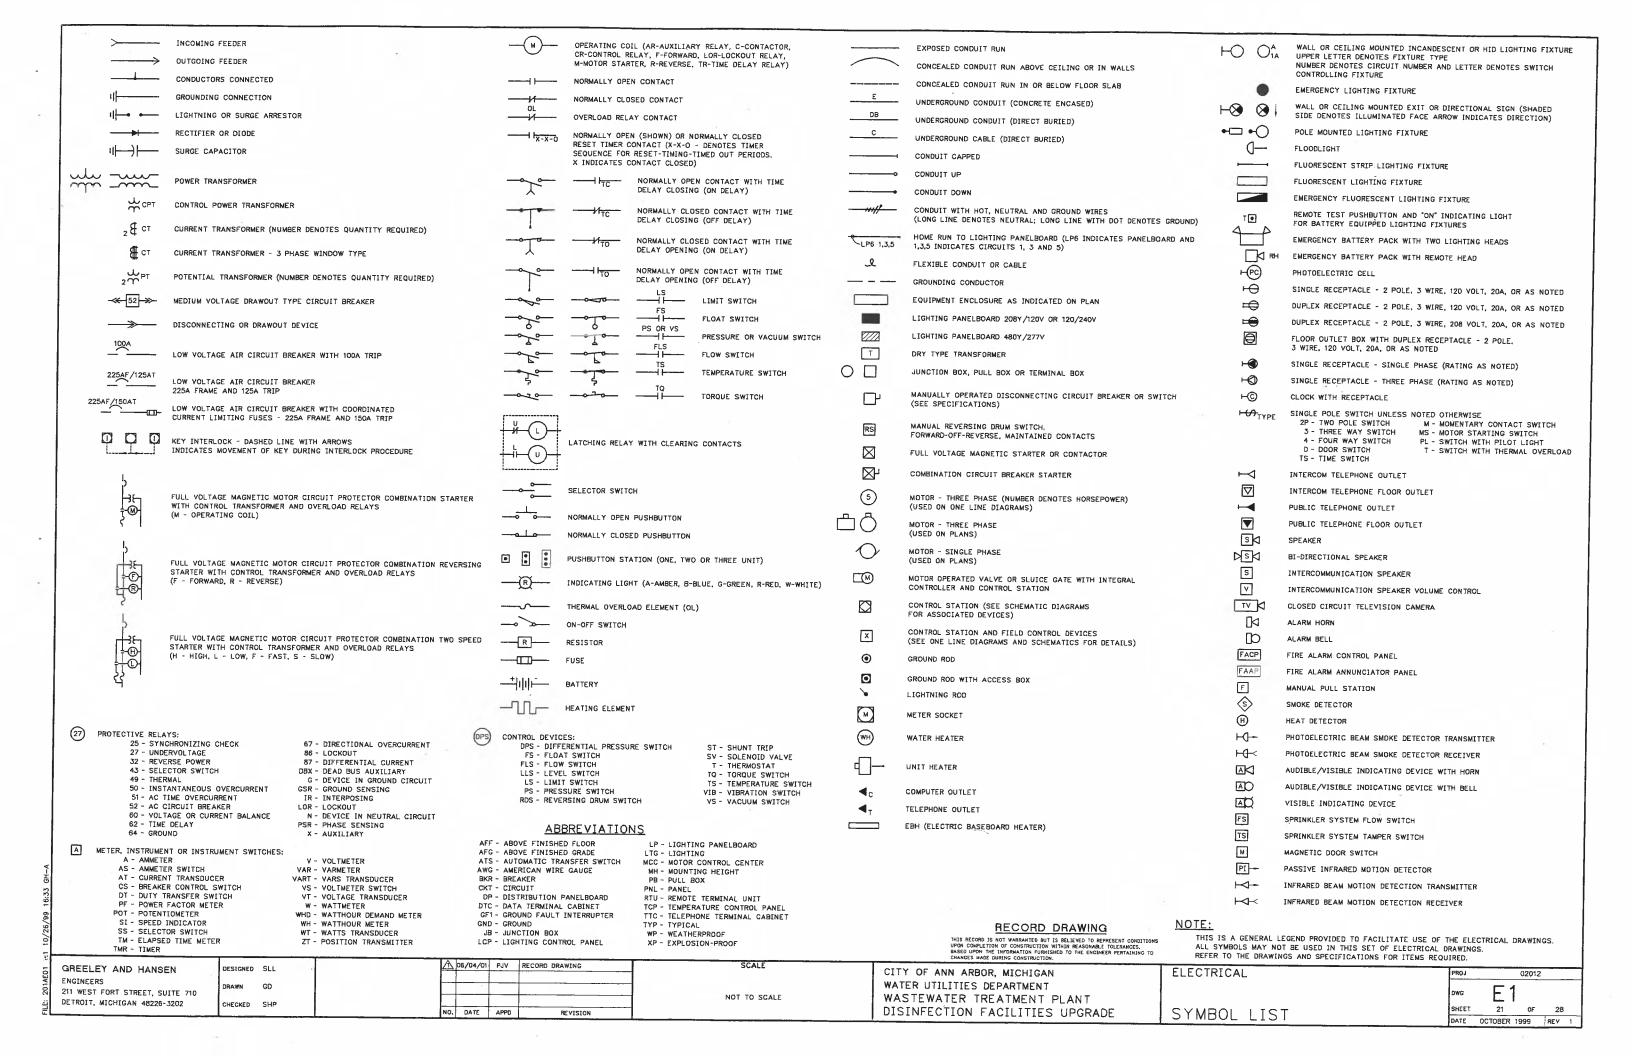


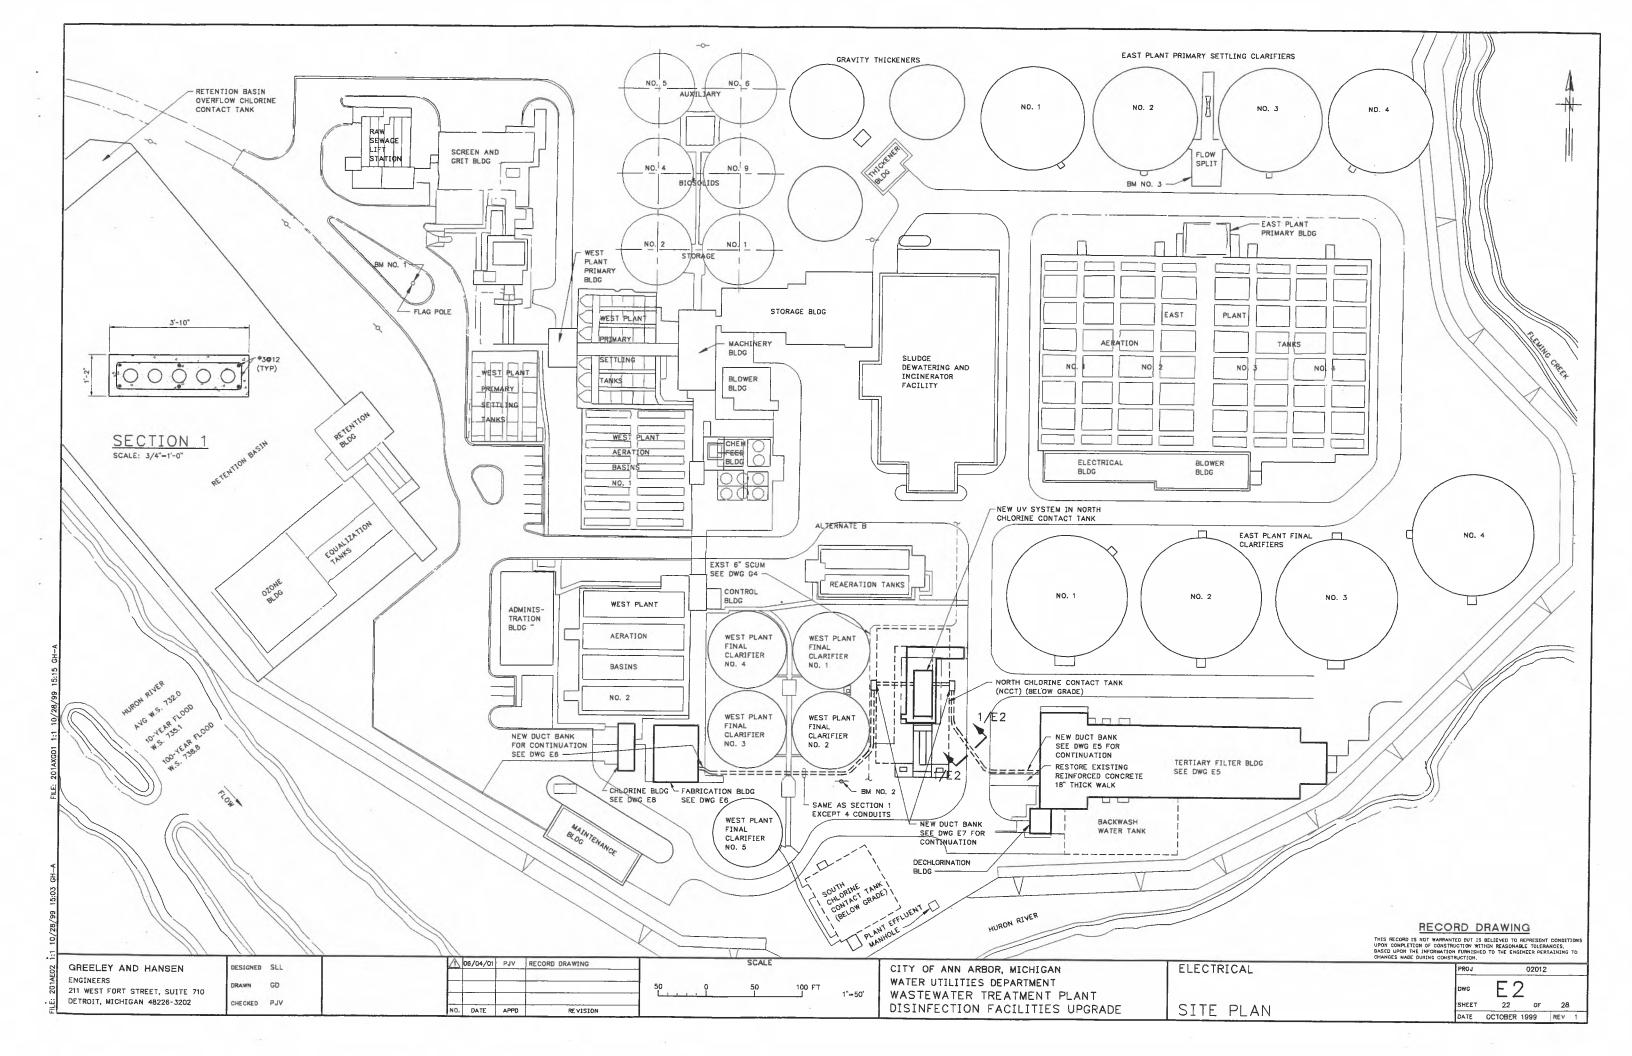


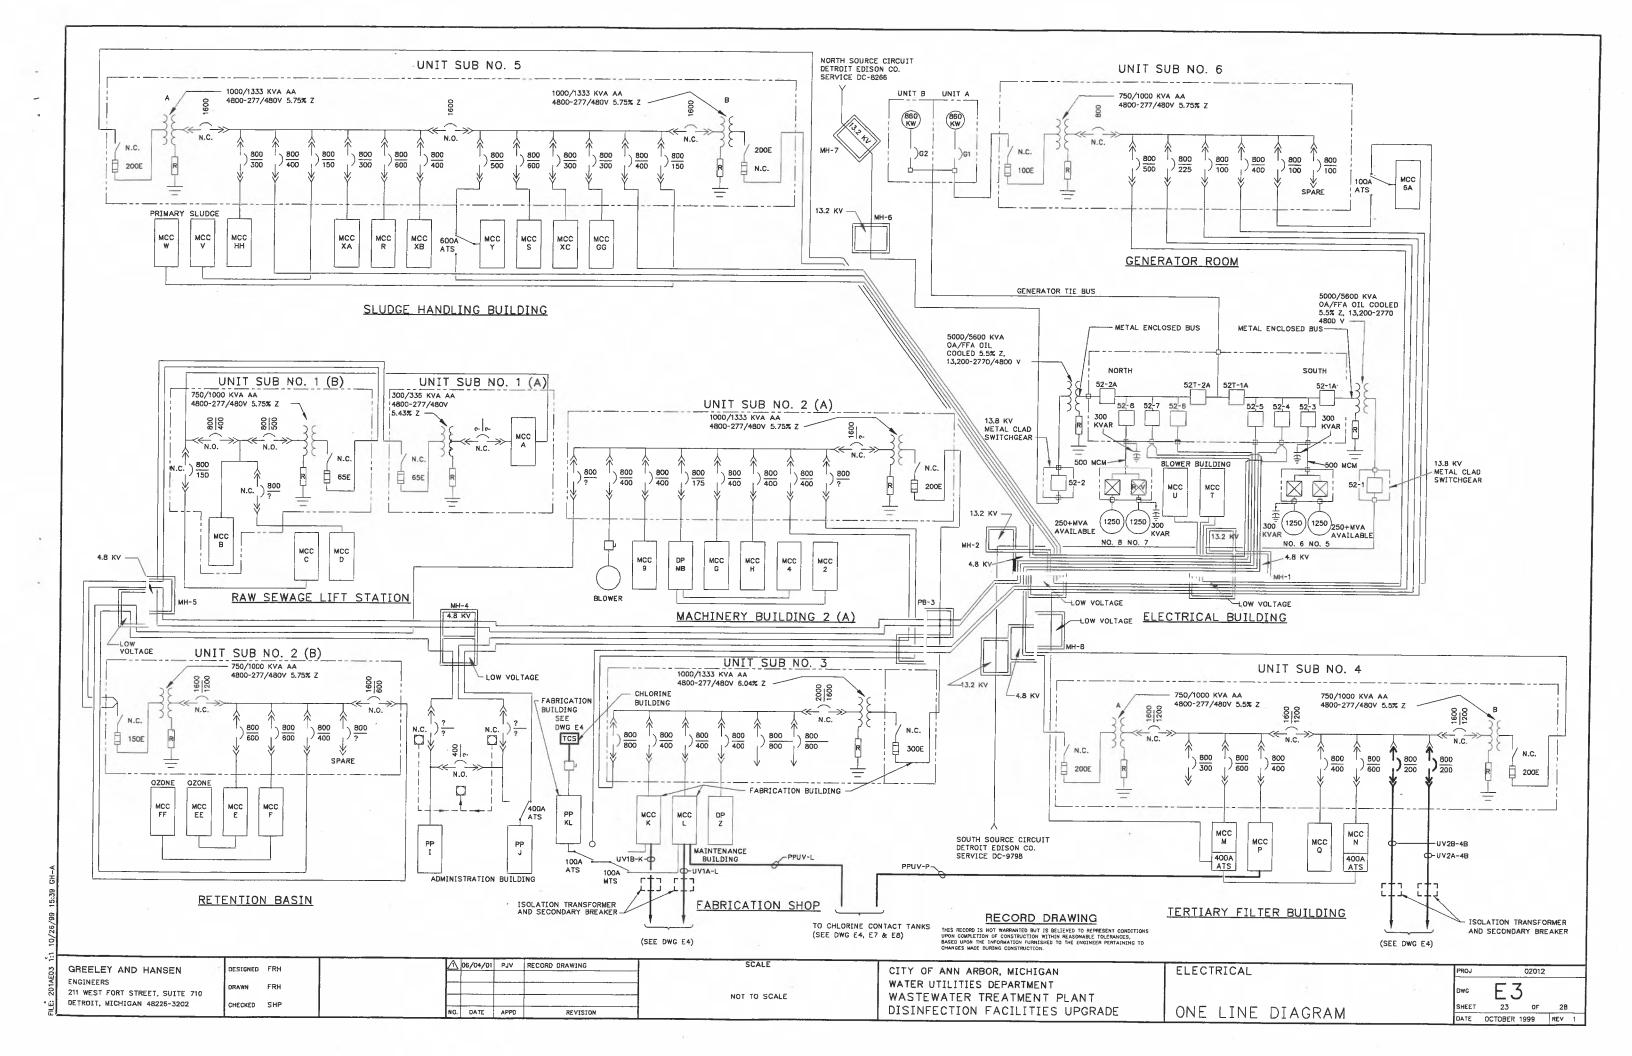


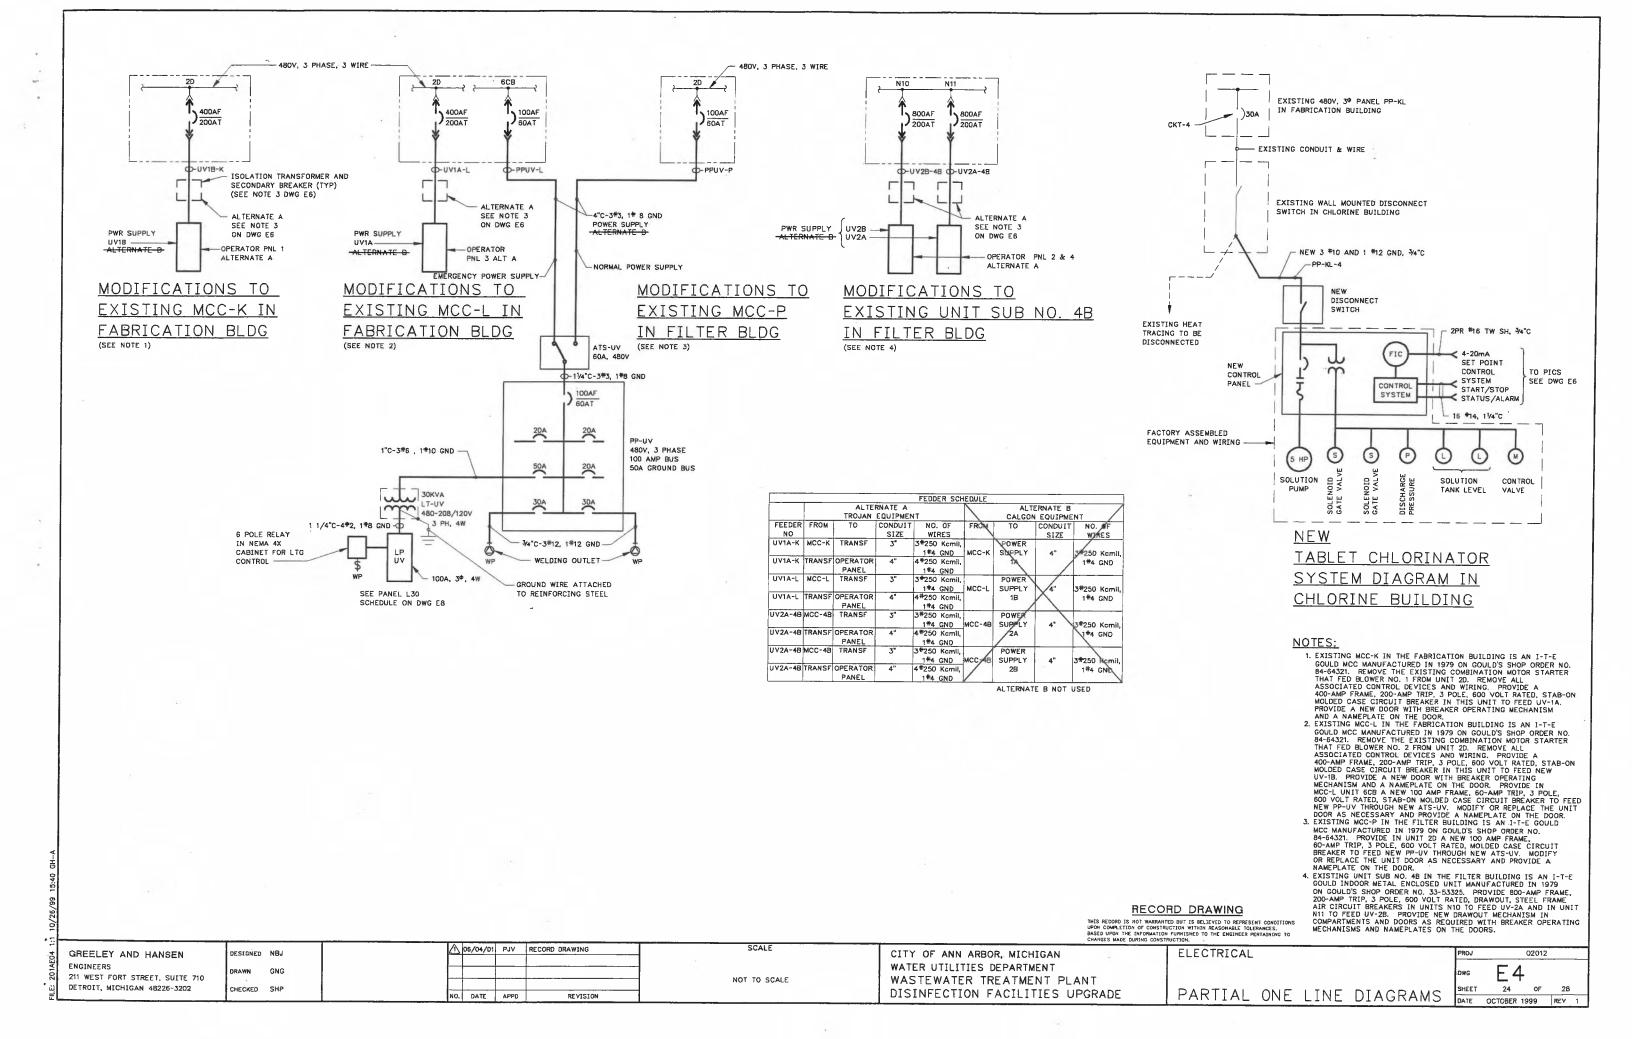


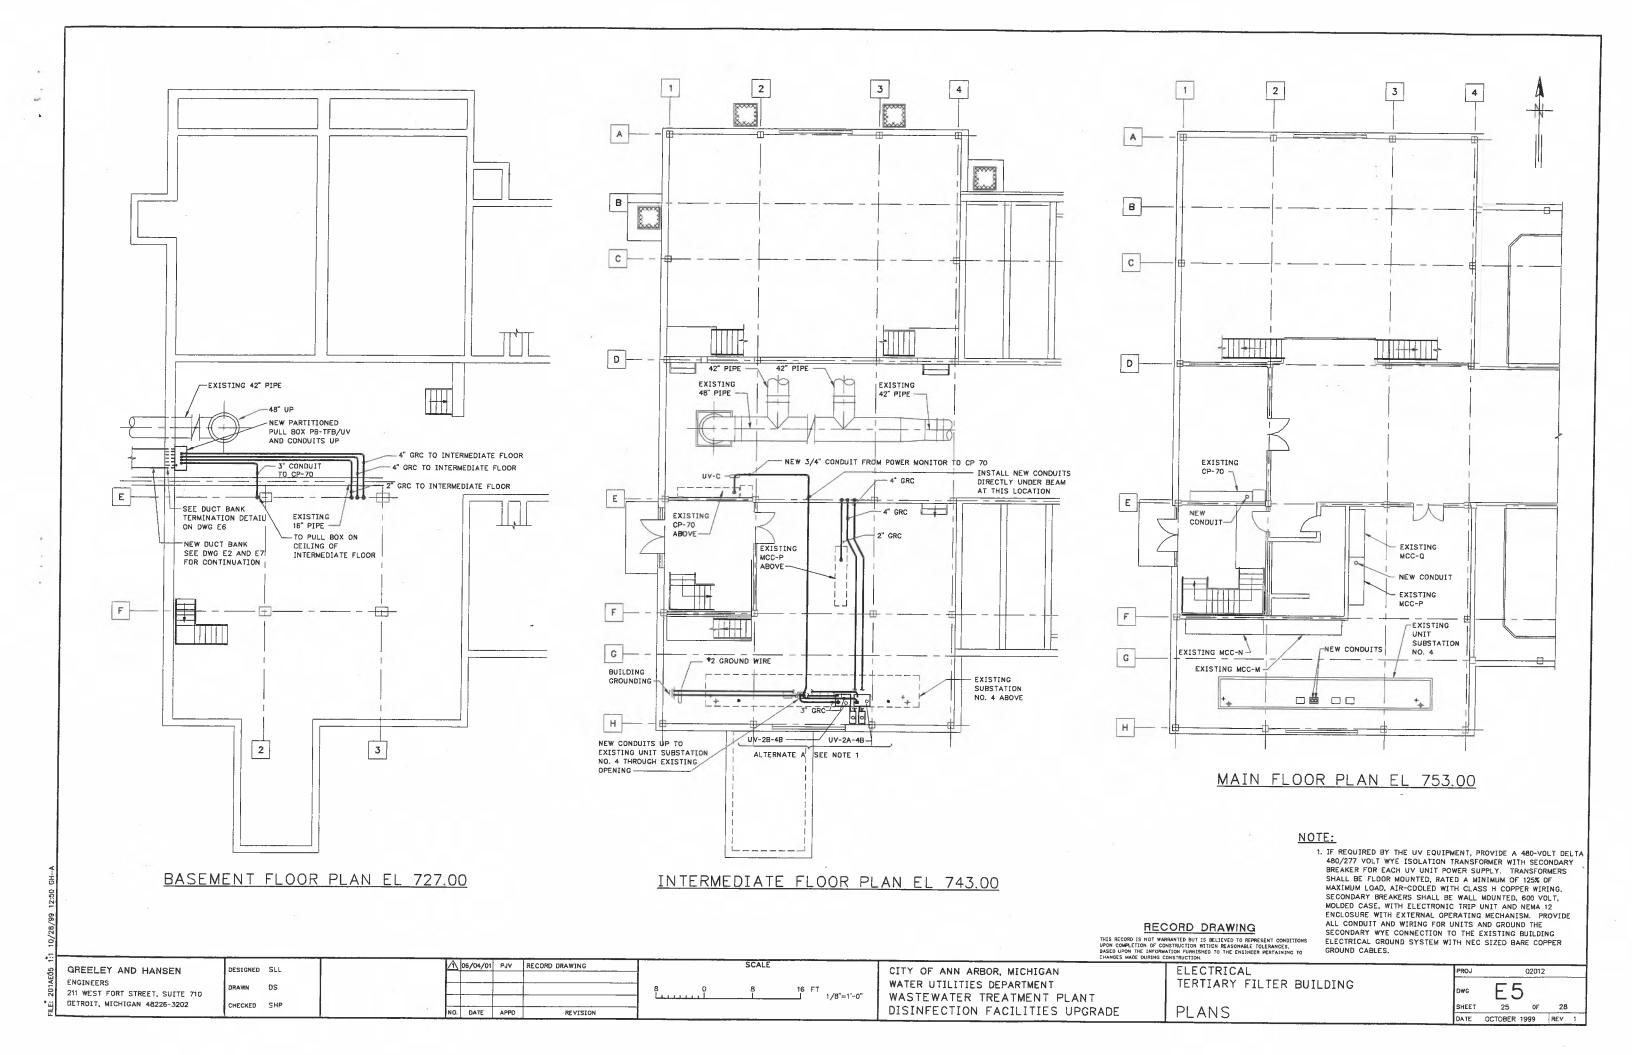

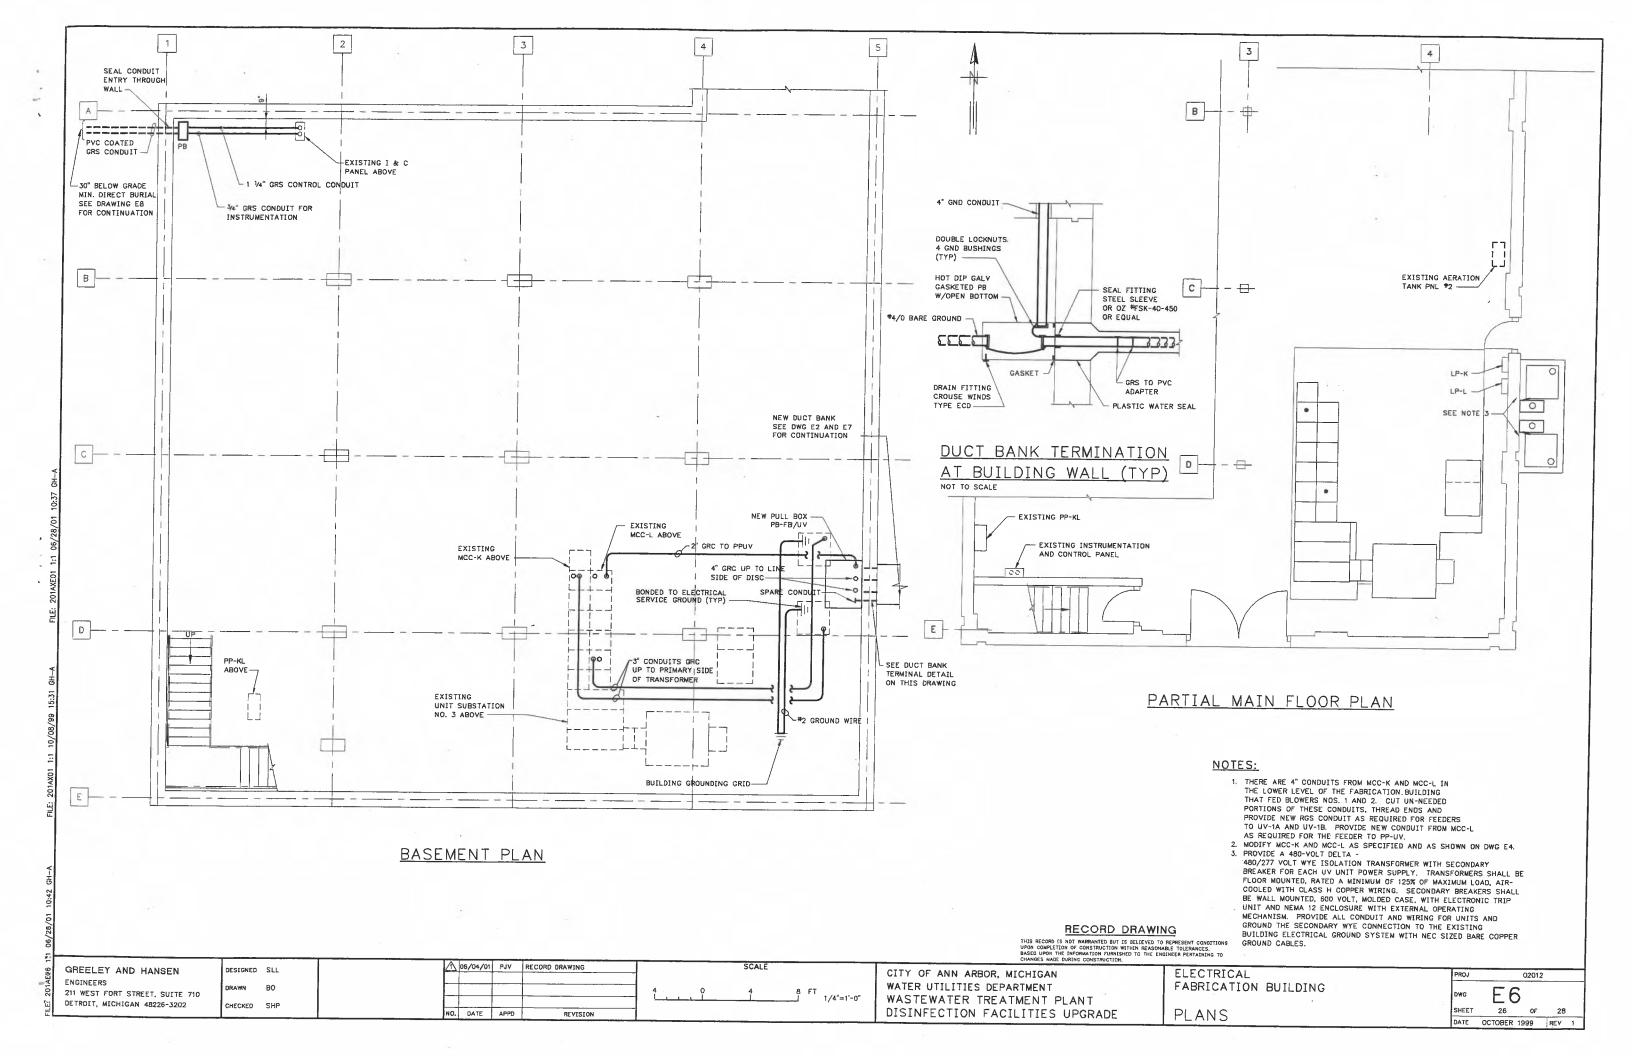

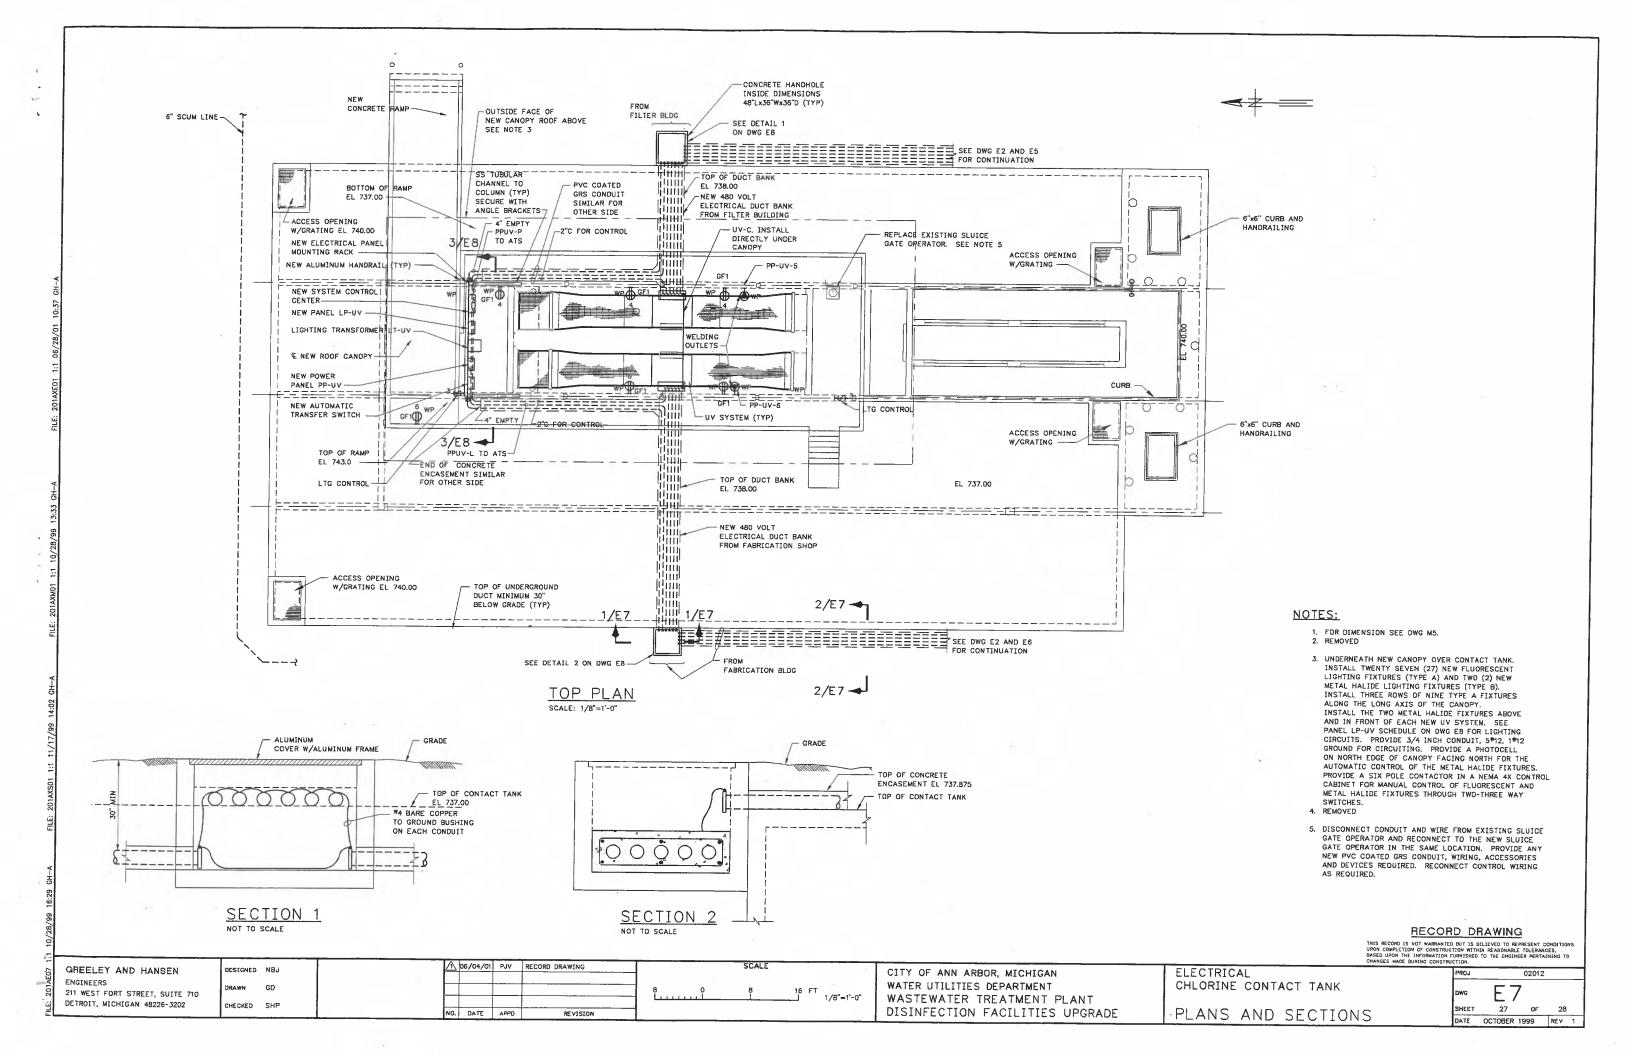

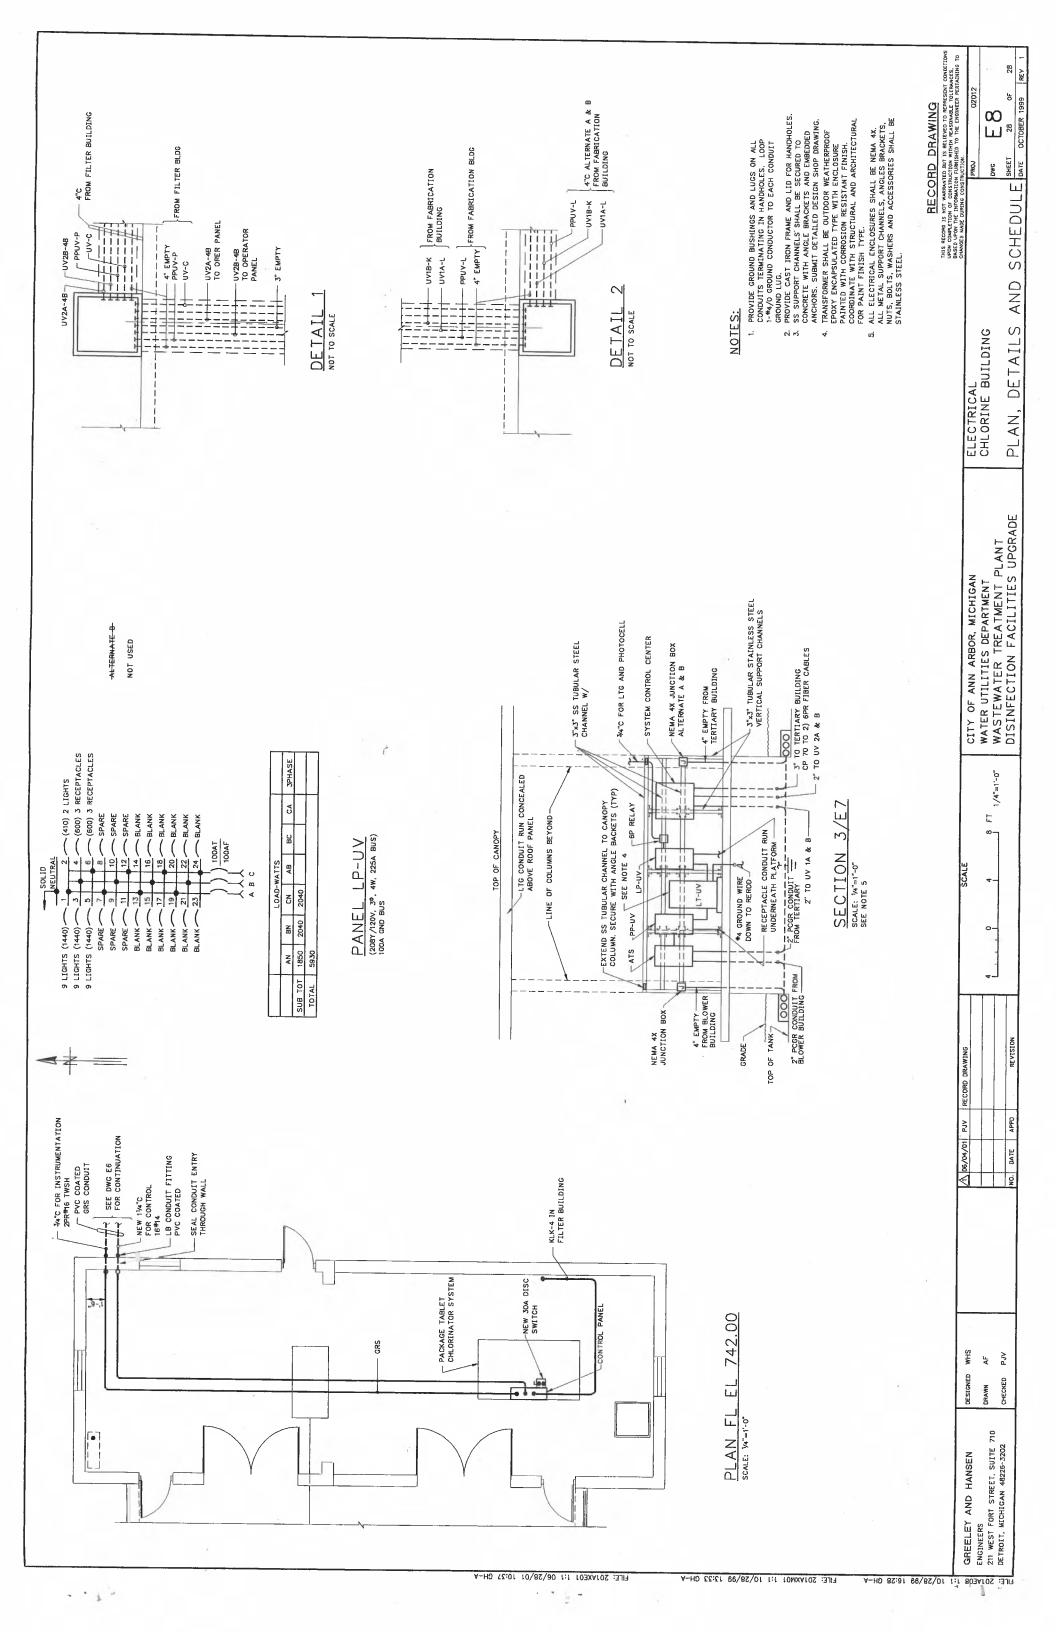

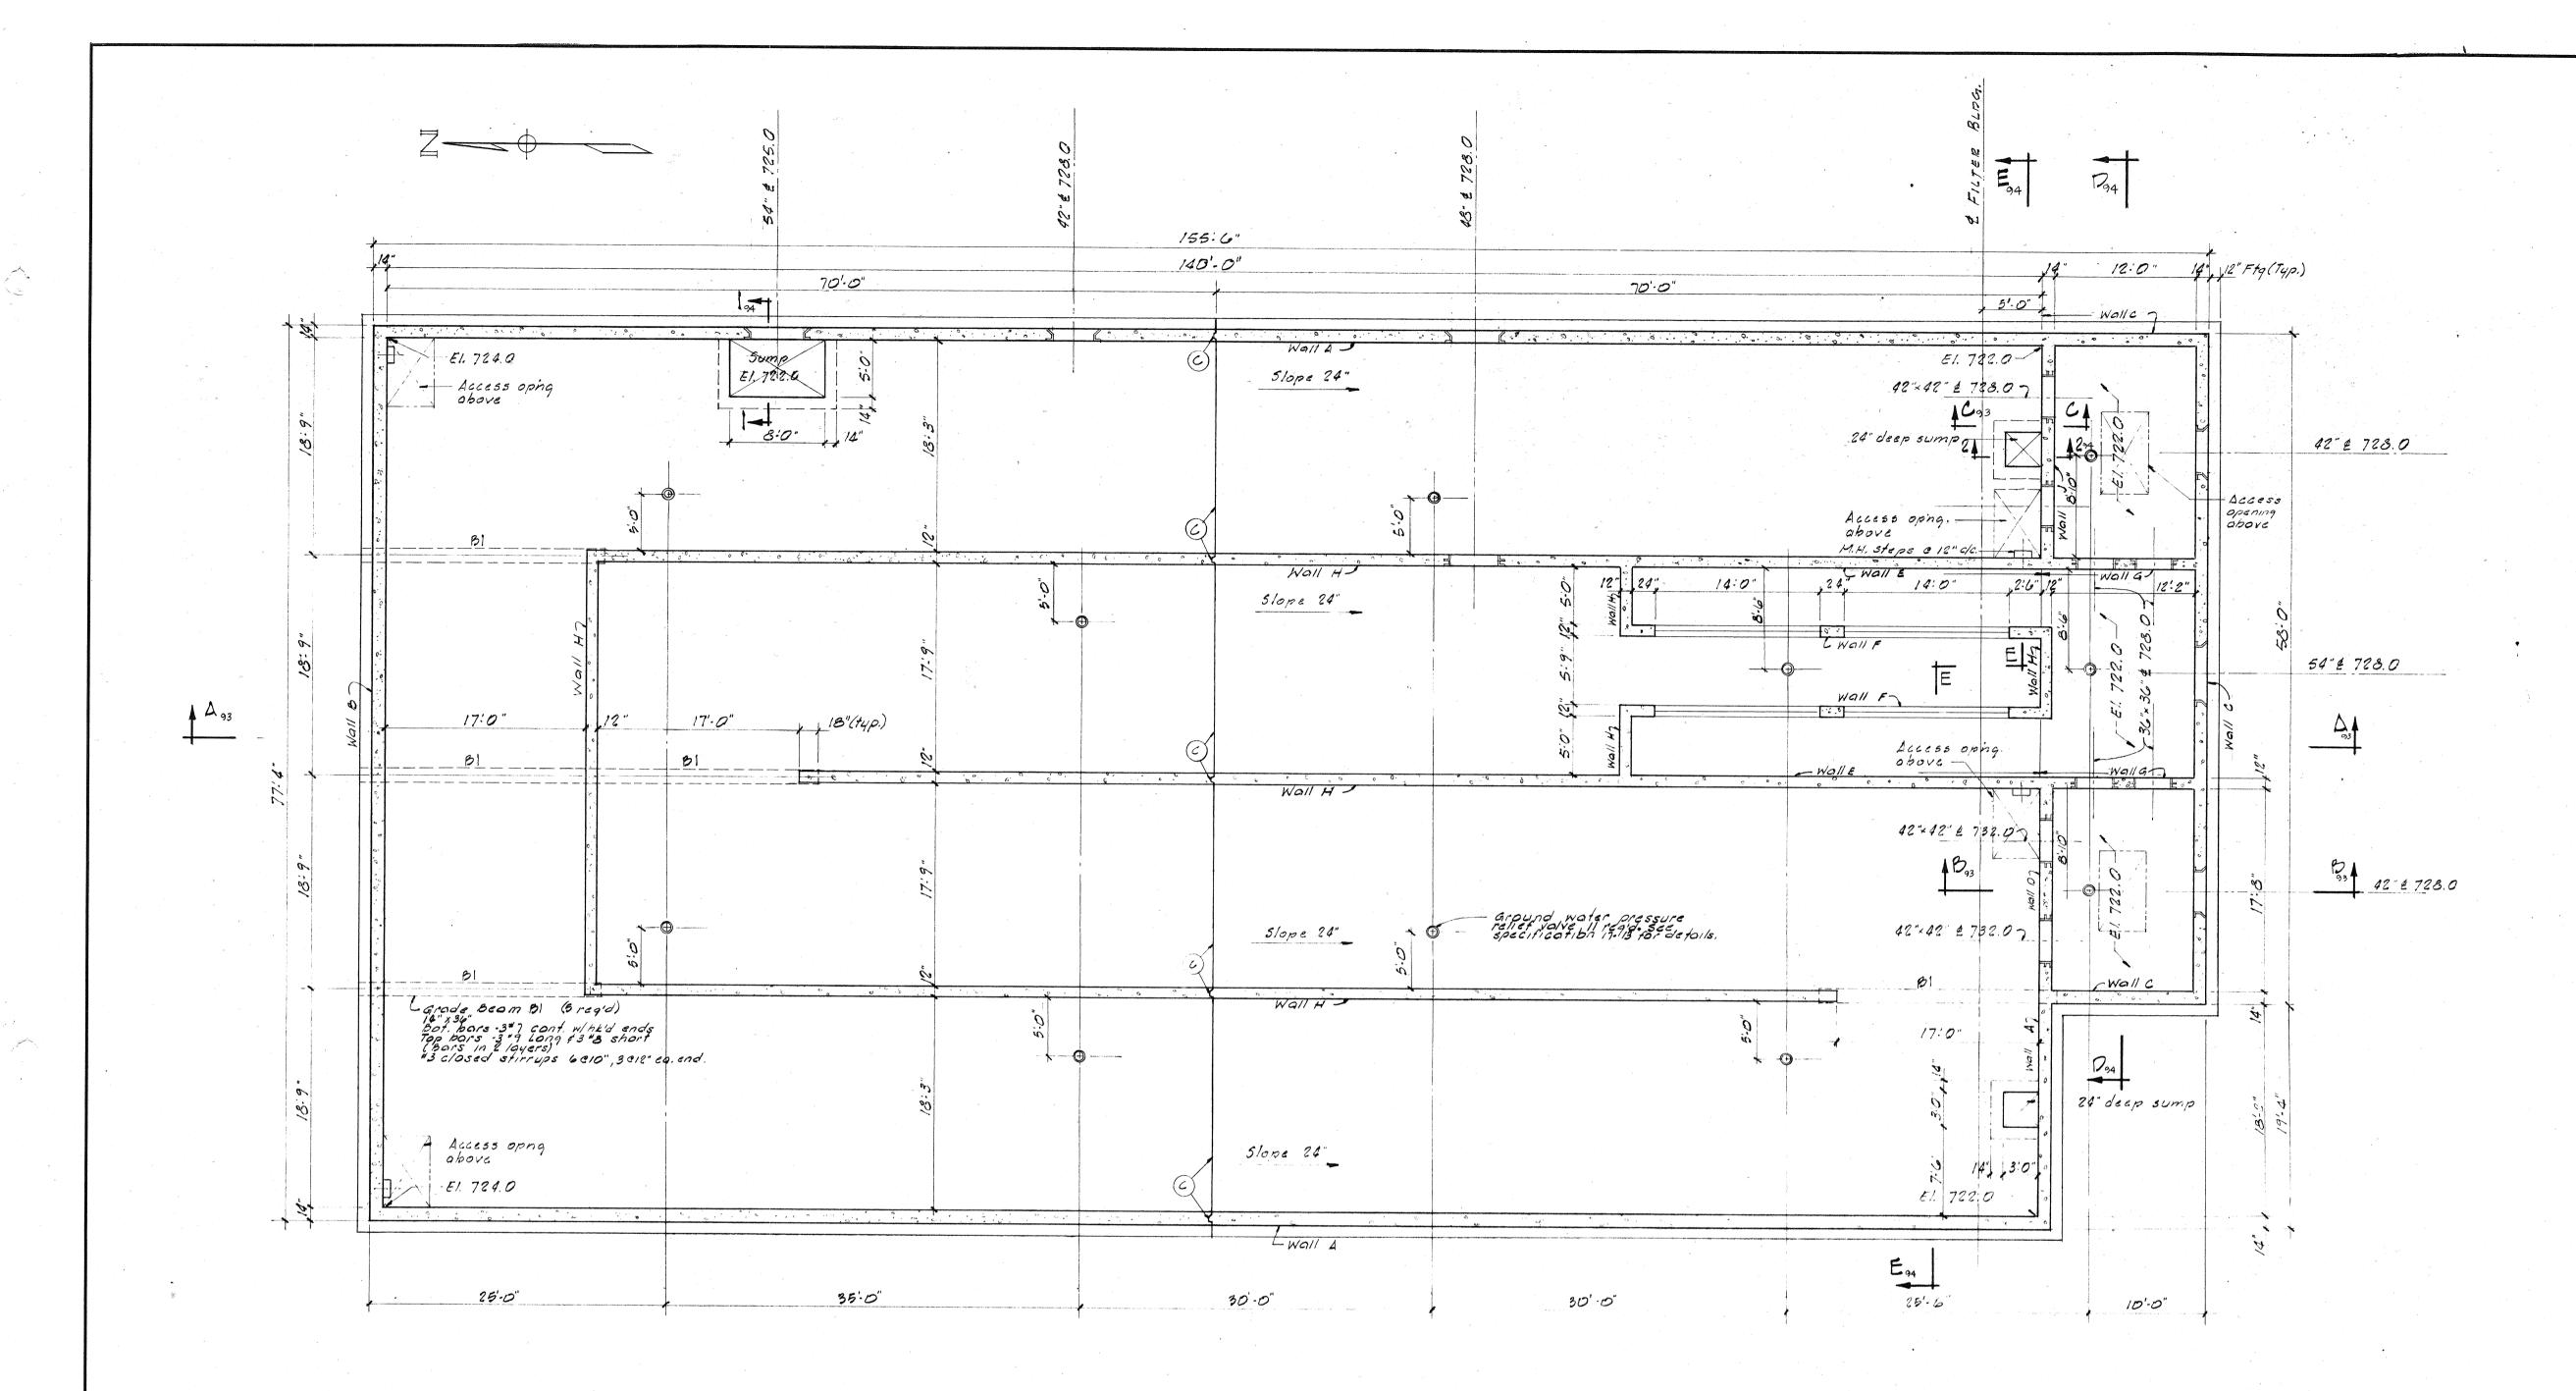

SECTIONAL PLAN

MCNAMEE, PORTER AND SEELEY
CONSULTING ENGINEERS
ANN ARBOR, MICHIGAN

SCALE 18": 10" ISSUED JULY 1977

DRAWN HL TRACED KMU CHECKED DHN
ISSUE NATURE OF REVISION DATE


CONTRACT
77.5.7 C26 2539 05

WASHTENAW COUNTY DEPARTMENT OF PUBLIC WORKS
CITY OF ANN ARBOR, MICHIGAN
WASTEWATER TREATMENT PLANT IMPROVEMENTS

STRUCTURAL
CHICAGO
CONTRACT
77.5.7 C26 2539 05

SHEET

BRUNING 44-132-

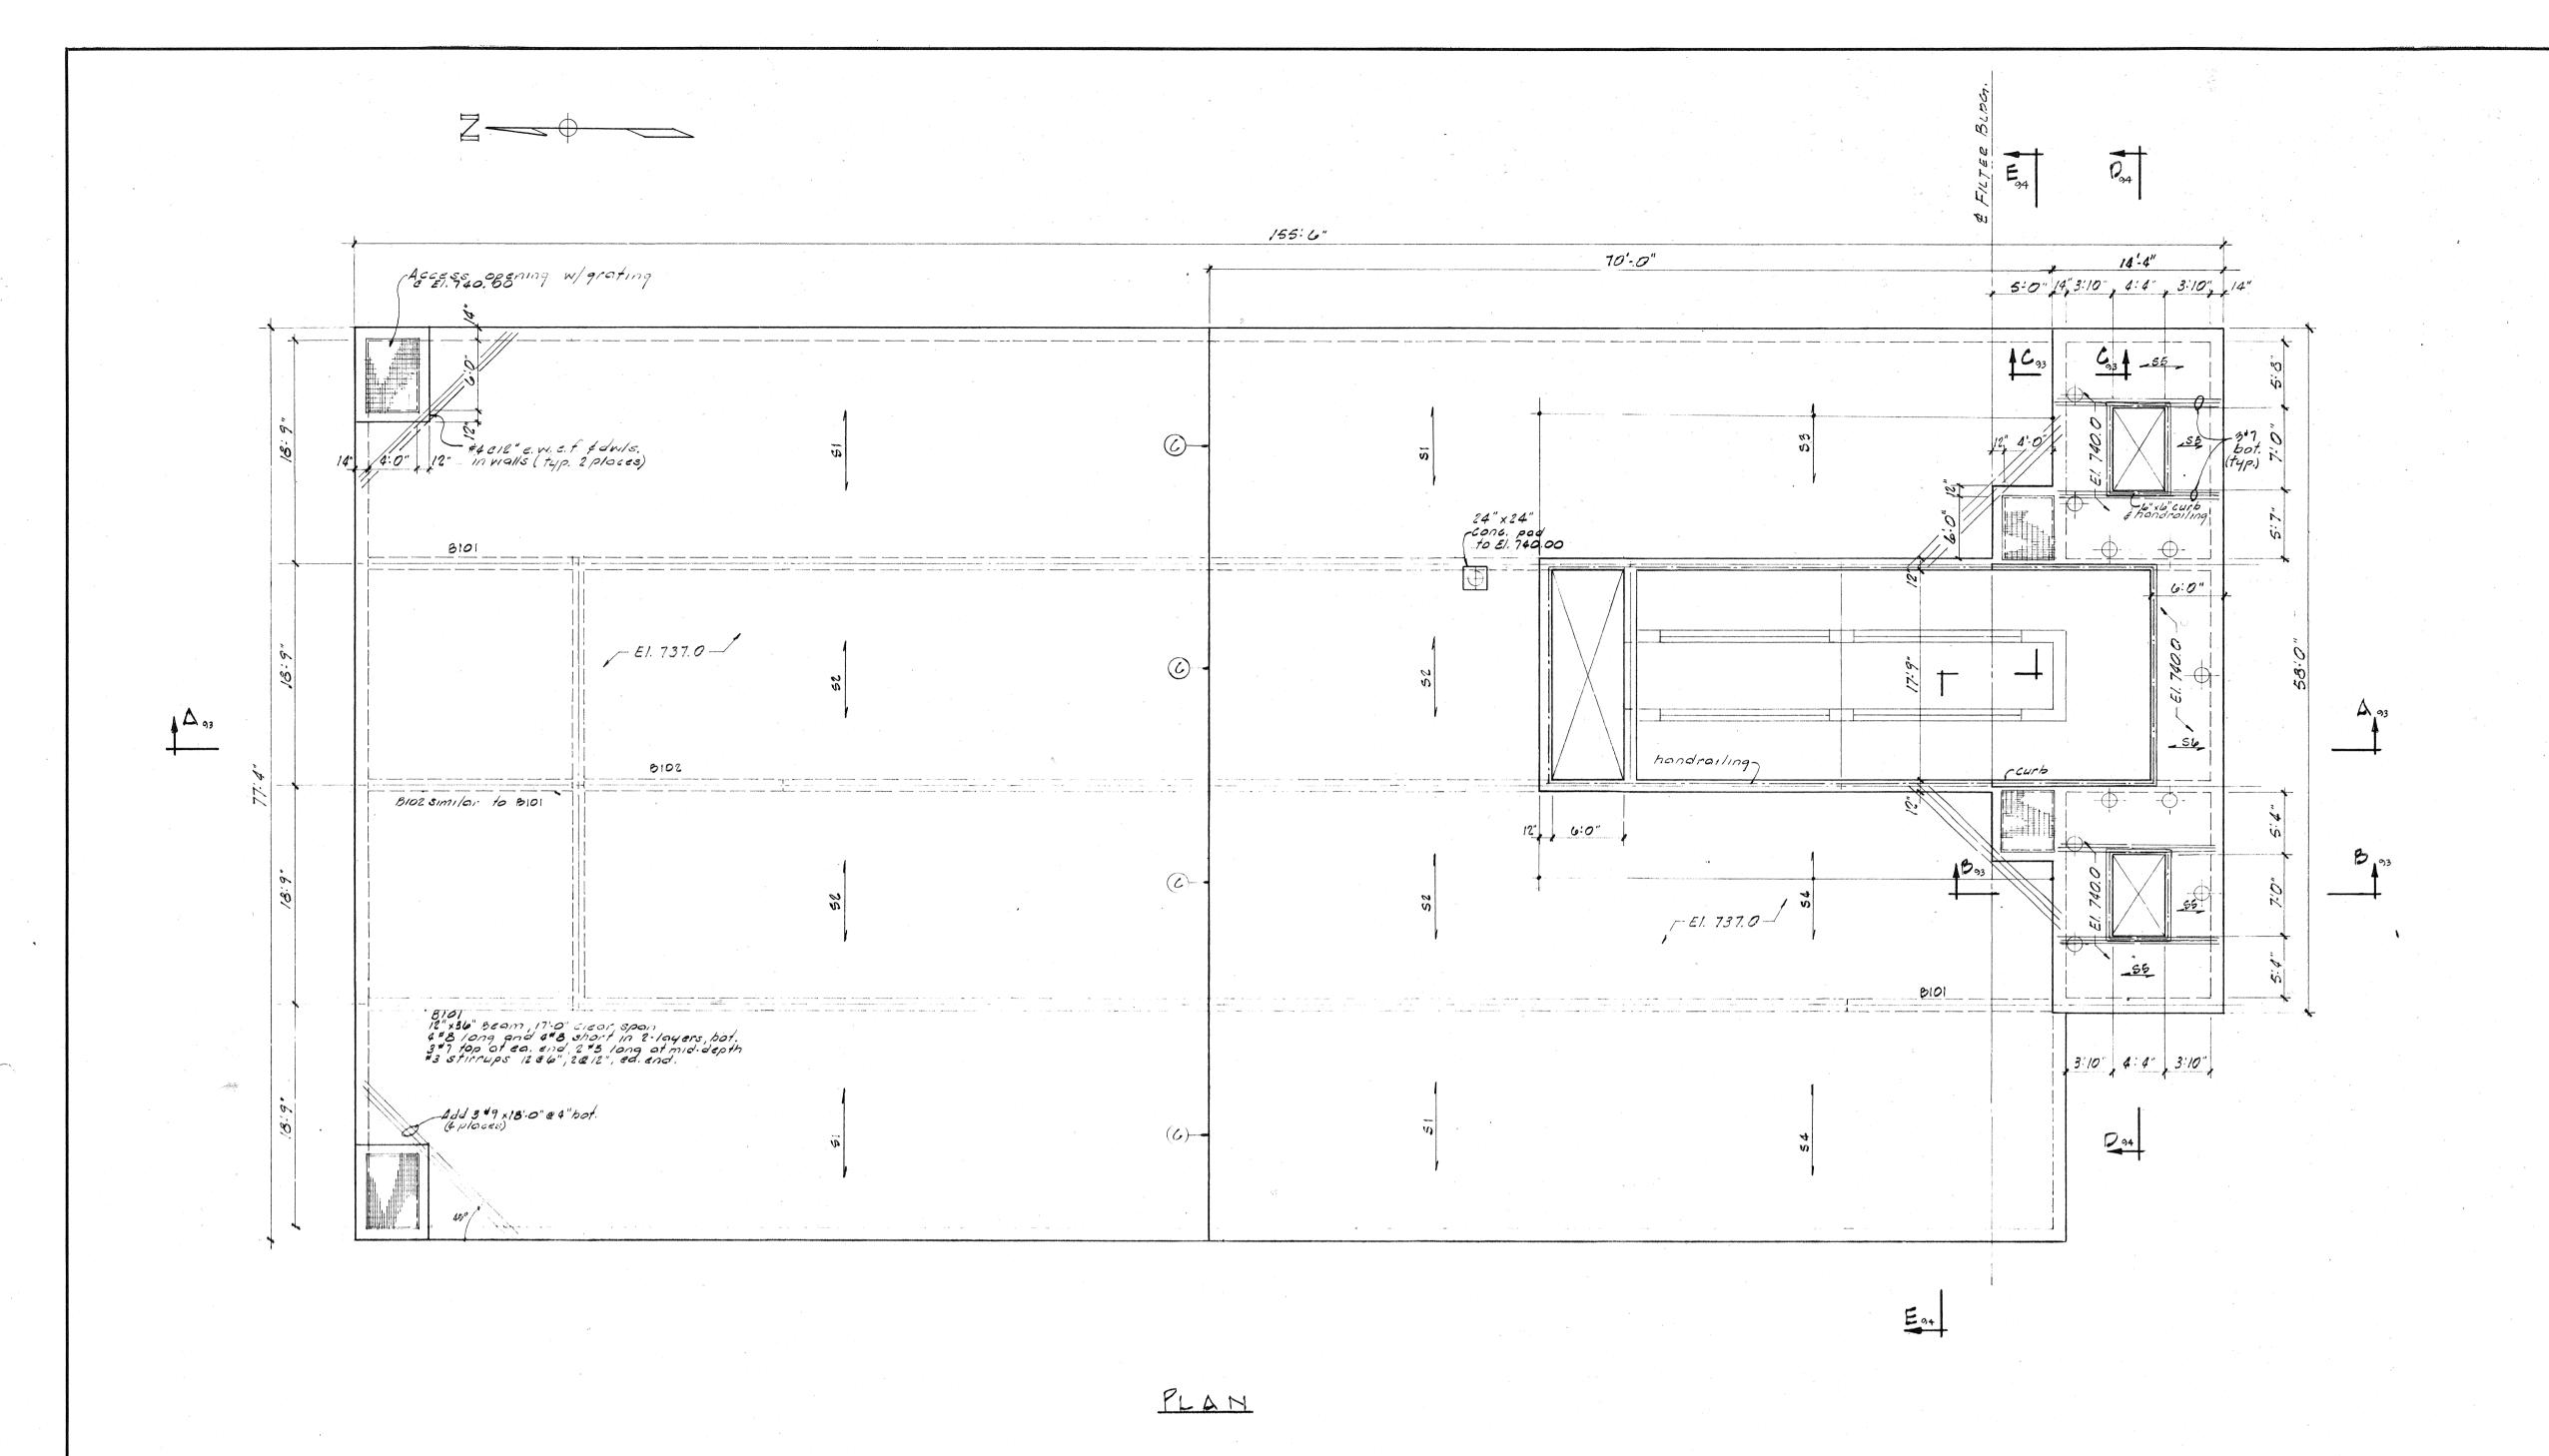

	SLAB REINFORCEMENT SCHEDULE									
		BOTTOM	BARS	TOP BARS						
	MARK	MAIN REINF. (Long & Short ALTERNATING)	TIE BARS (CONTINUOUS)	CONTINUOUS END	DISCONTINUOUS END	TIE BARS				
	51	#608	#5 @ 12"	#6.0"	#5 e 9	# 4@12"				
	52	#609"	#5 @ 12"	600	•	# 4 C 12"				
	53	47 e5"	#5012"	<u>.</u> .	#5@12"	#4012"				
	54	#608"	±5€12"	#605"	#5@9	#4012"				
	55 ·	#5012"	# 5@12"	<u>.</u>	-					
1	56	See	Section A-A							

MCNAMEE, PORTER AND SEELEY CONSULTING ENGINEERS ANN ARBOR, MICHIGAN WASHTENAW COUNTY DEPARTMENT OF PUBLIC WORKS CITY OF ANN ARBOR, MICHIGAN
WASTEWATER TREATMENT PLANT IMPROVEMENTS


STRUCTURAL SCALE 18"=1:0" ISSUED JULY 1977


DRAWN HL TRACED KMU CHECKED DHM

ISSUE NATURE OF REVISION DATE CHLORINE CONTACT TANK TOP PLAN

> SHEET 92 of 105. C26 2539 05


BRUNING 44-132-

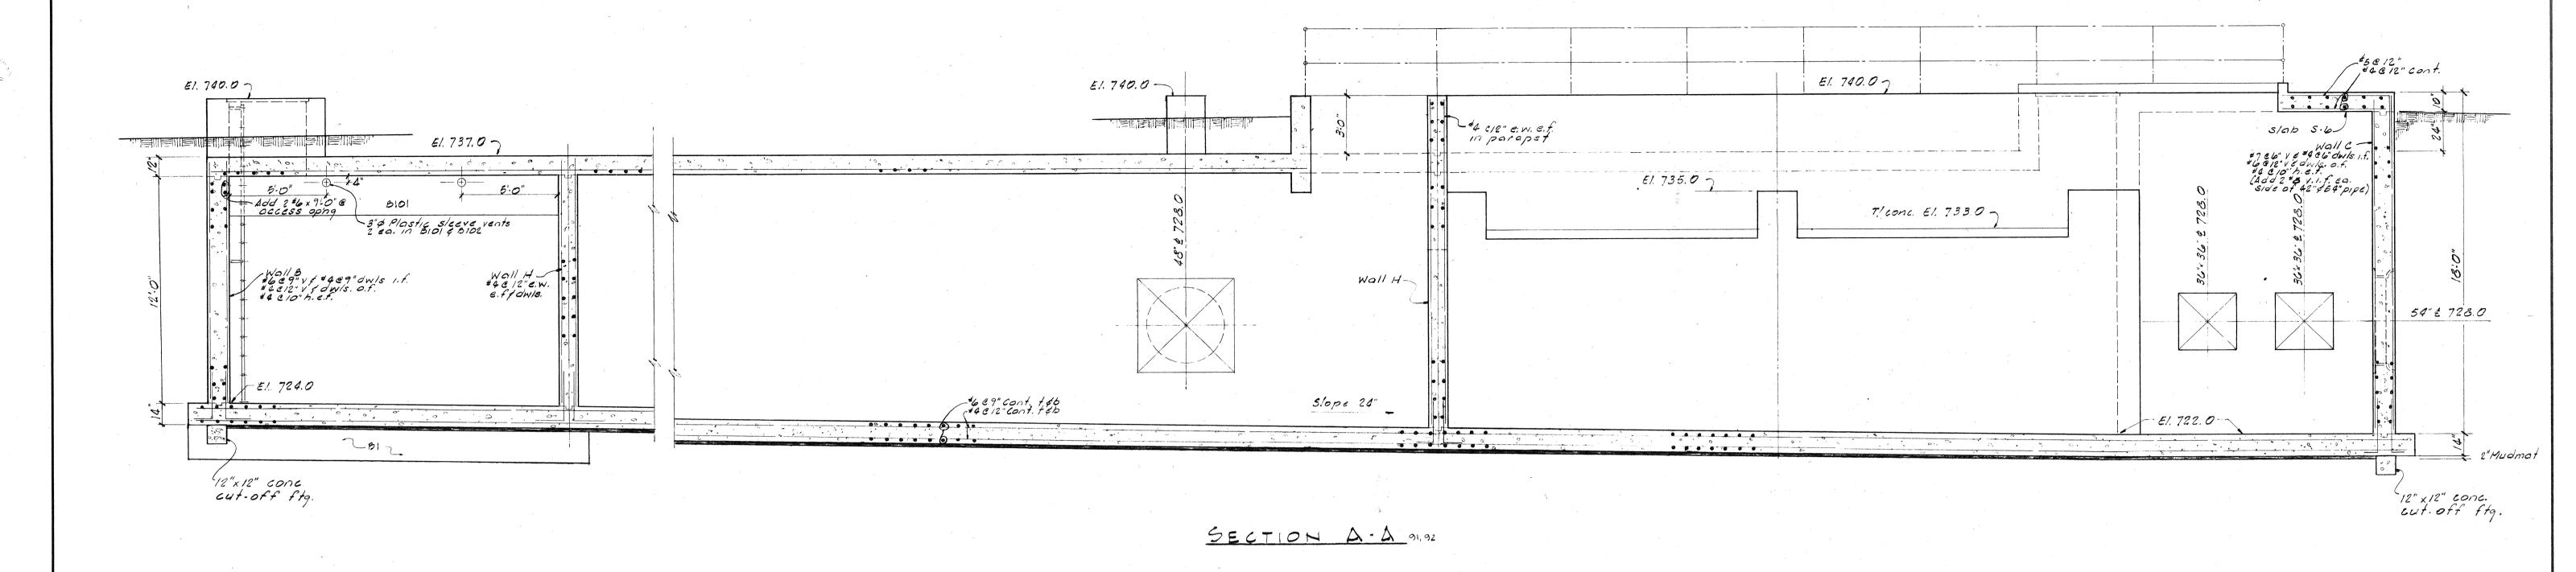


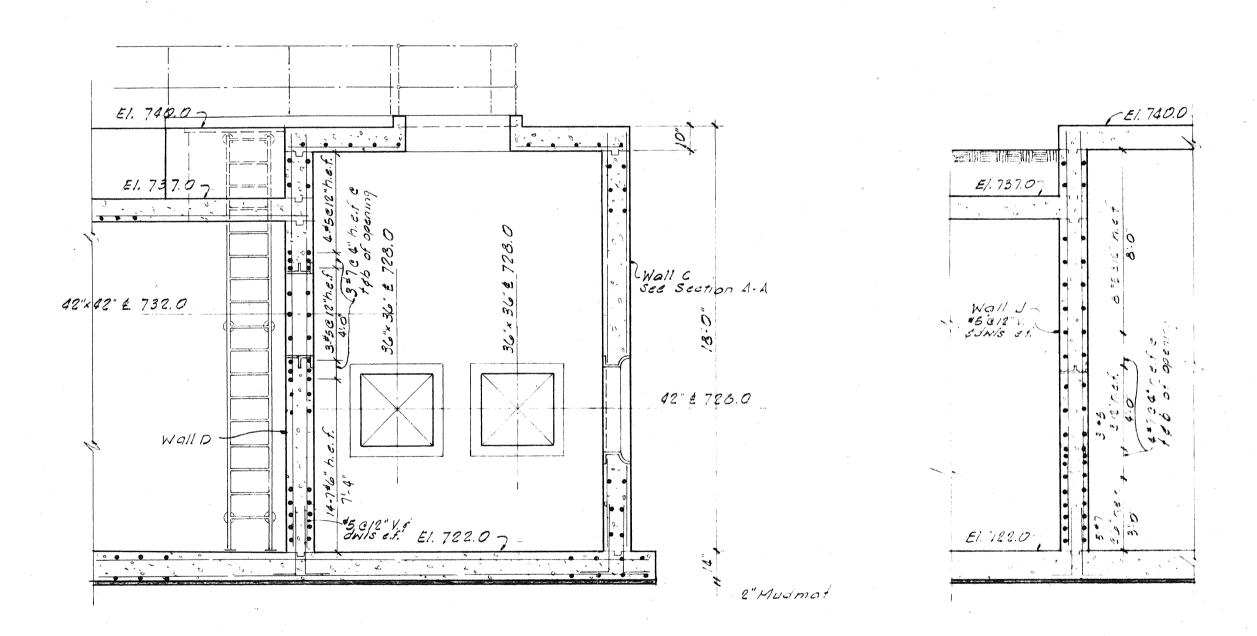


SECTION B.B 91,92

٨	CON	SULTING	TER AND S ENGINE R, MICHIG	ERS			AW COUNTY DEPARTMENT OF PUE CITY OF ANN ARBOR, MICHIGAN VATER TREATMENT PLANT IMPRO		
SCALE 14"=1:0" ISSUED JULY				الالم	1977	STRUCTURAL			
 DRAWN H	<u>L</u>	TRACED	KMU	CHECKED	マキロ	CHLO	RINE CONTACT	TANK	
ISSUE NATURE OF		F REVISI	ON	DATE	· · · · · · · · · · · · · · · · · · ·				
						CONTRACT	C26 2539 0 5	93 of 105	

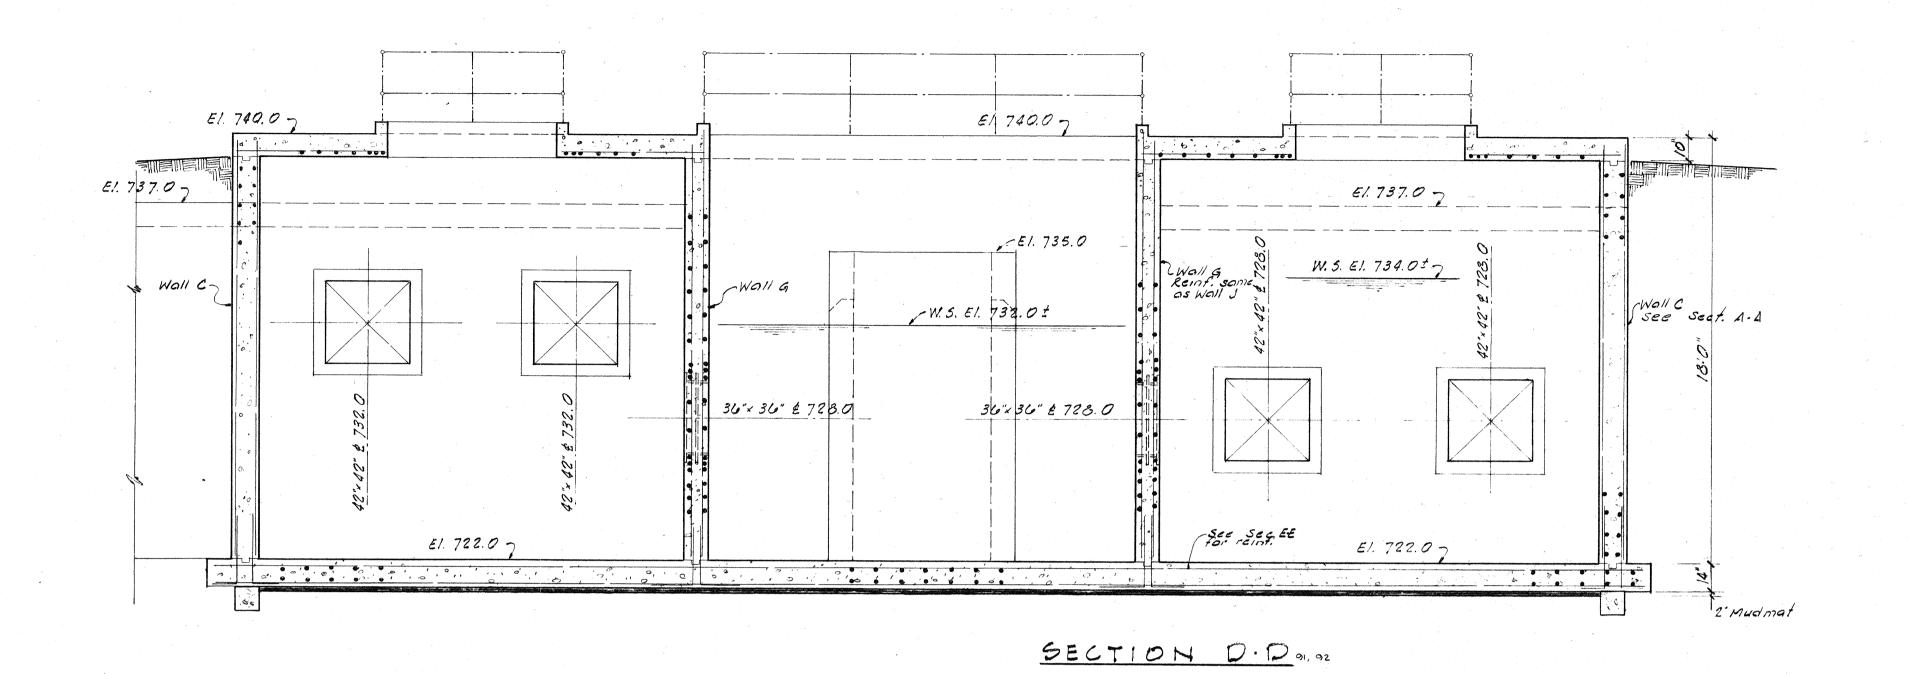


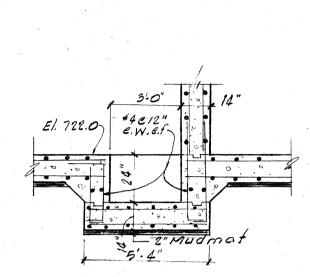

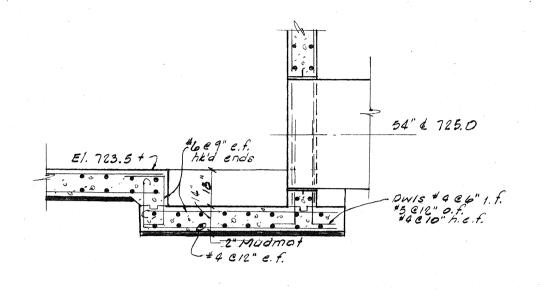

SECTION 2.201

SECTION 1-1 91

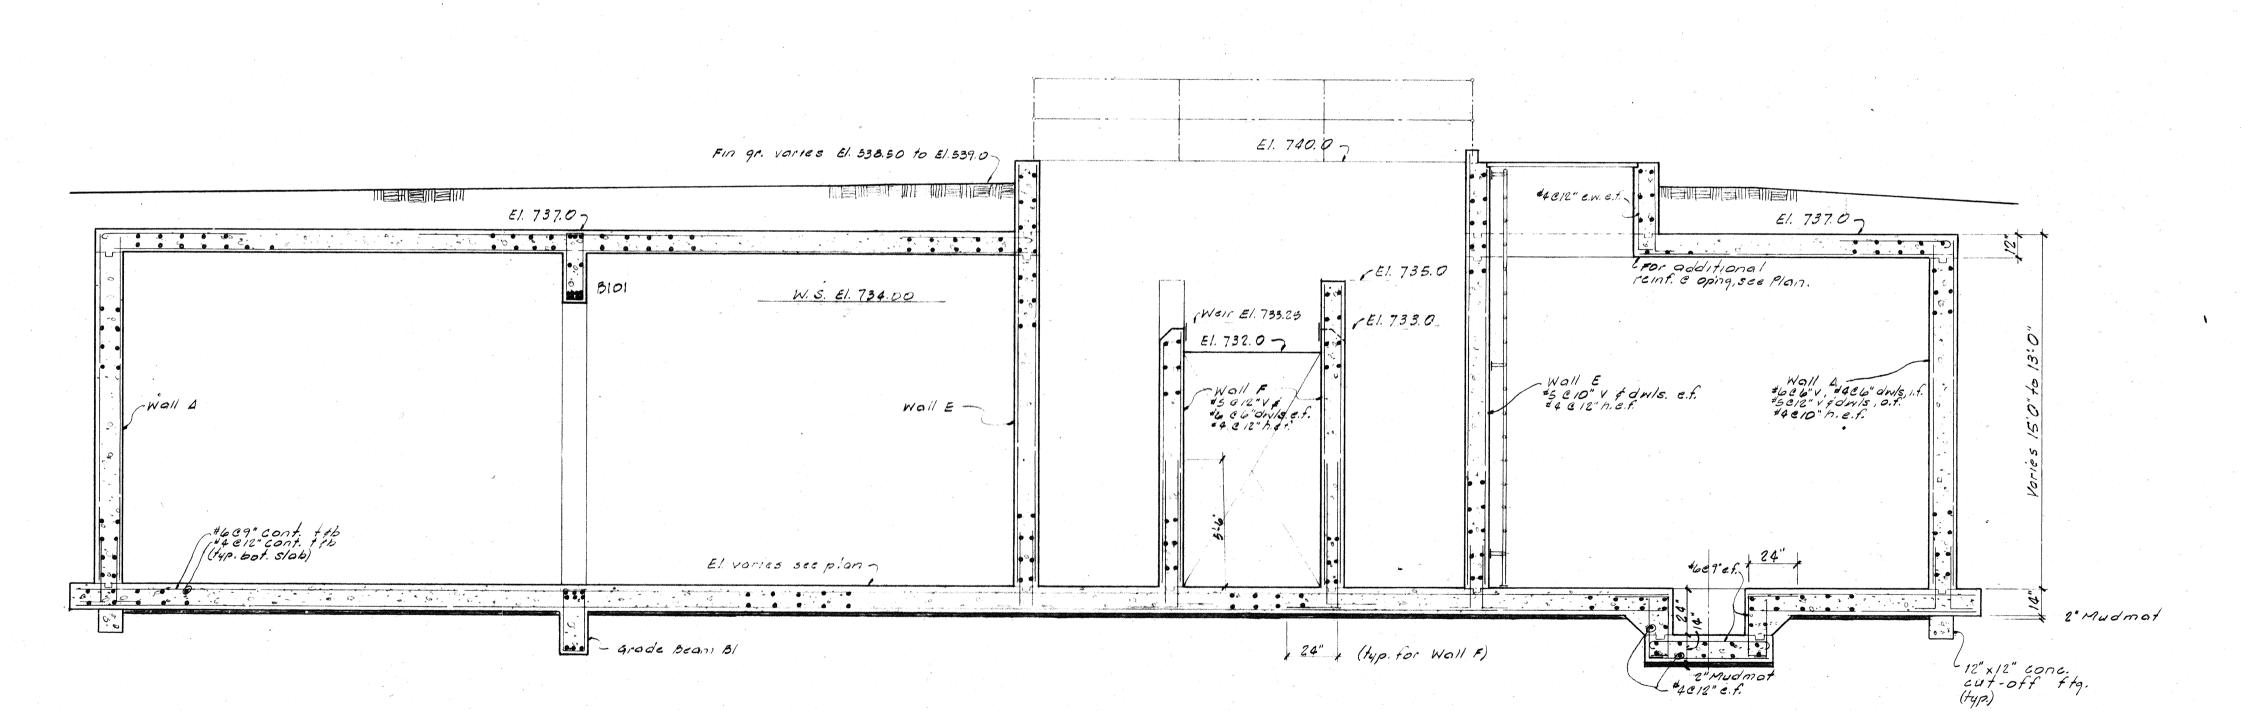

SECTION E. E 91.92

	CON	EE, PORT SULTING N ARBOR	ENGINE	ERS		WASHTENAW COUNTY DEPARTMENT OF PUBLIC WORKS CITY OF ANN ARBOR, MICHIGAN WASTEWATER TREATMENT PLANT IMPROVEMENTS				
SCALE	SCALE V4":1:0" ISSUED JULY			144	1977	STRUCTURAL				
DRAWN H	DRAWN HL TRACED L			CHECKED	DHH	CHLORINE CONTACT TANK				
ISSUE	ISSUE NATURE OF REV				DATE					
				•			SECTIONS			
					,	CONTRACT	C26 2539 0.5	SHEET 94		
						77-S-7	C26 2539 0 <i>5</i>	C		

BRUNING 44-132-

CITY OF ANN ARBOR, MICHIGAN Water Utilities Department Wastewater Treatment Plant

Disinfection Facilities Upgrade

RECEIVED MAY

1 2000

CONTRACTOR'S SUBMITTAL TRANSMITTAL FORM

TO: Greeley & Hansen

211 West Fort Street Suite 710

Detroit, MI 48226

ATTN: Nicole Jannis

SUBMITTAL NO.: 4B

DATE: Thursday, April 27, 2000

PREVIOUS SUBMITTAL NO. & DATE: No. 4(2/23/2000), No. 5(2/21/2000), No. 6(2/23/2000)

SPEC. PARA. REF. NO.: 11285

PLAN REF. NO.:

SUPPLIER/MANUFACTURER:

WATERMAN INDUSTRIES

FROM: 3-S Construction

3200 James Savage Rd. Suite 1


Midland, MI 48642

1. The following submittals are forwarded for your review:

Item	Drawing	Copies	Description	Deviation
	No.	Submitted		(Yes/No)
1		11/10	48" X 48" GATE	NO
2		11/10	12" X 12" GATE	NO
3		11/10	72" X 72" GATE	NO
4		1110	EM-25 TRIPOD MOUNTED OPERATOR	NO
5		11/10	IDENTIFICATION TAG	NO
6		11	TNEMEC COLOR BOOK	NO

Will item submitted for review fit in space provided in the Contract Documents? Yes 3. Has work indicated in this submittal been coordinated with all trades? Yes Is work by all trades being provided as necessary to accommodate this submittal? Yes Contractor has approved submittal and has affixed his certification stamp? Yes Contractor's description and justification for deviations from Contract Documents. (Use additional sheet, if necessary) 7.

Signature: Vince Drumright

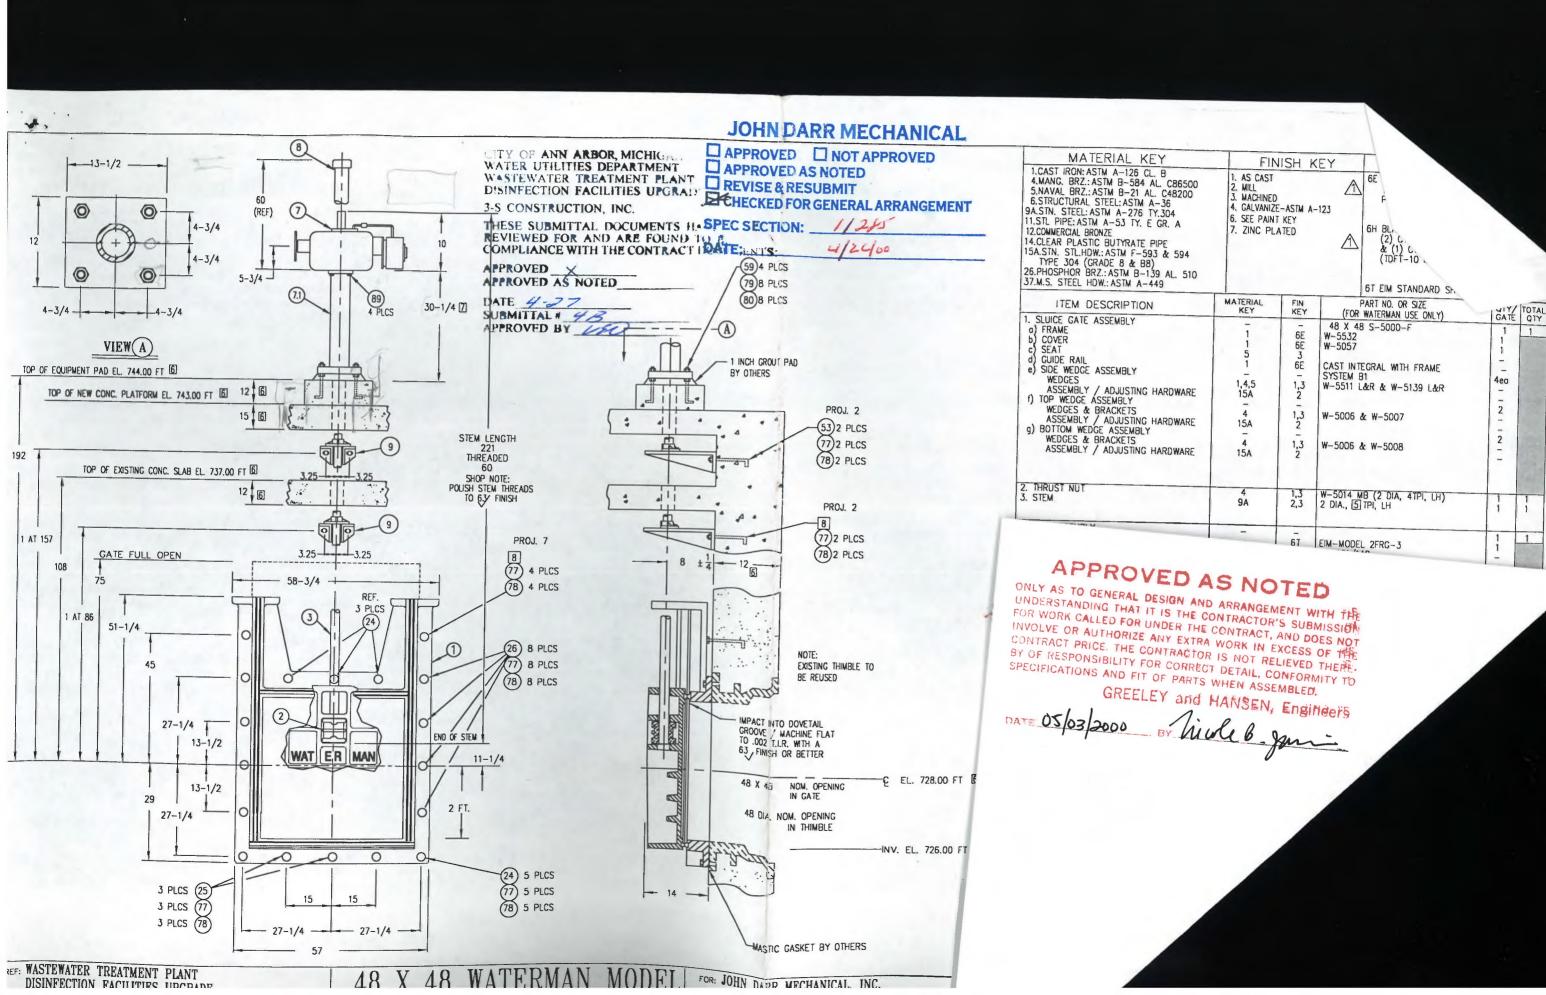

JOHN DARR MECHANICAL (8) ☐ APPROVED ☐ NOT APPROVED MATERIAL KEY FINISH KEY ITY OF ANN ARBOR MICHIGA WATER UTILITIES DEPARTMENT ☐ APPROVED AS NOTED LCAST IRON: ASTM A-126 CL. B AS CAST ---13-1/2 --- WASTEWATER TREATMENT PLANT | REVISE & RESUBMIT 4.MANG. BRZ.: ASTM B-584 AL. C86500 2. MILL 3. MACHINED DISINFECTION FACILITIES UPGRAD CHECKED FOR GENERAL ARRANGEMENT 5.NAVAL BRZ.: ASTM 8-21 AL. C48200 6.STRUCTURAL STEEL: ASTM A-36 . GALVANIZE-ASTM A-123 9A.STN. STEEL: ASTM A-276 TY.304 3-S CONSTRUCTION, INC. 6. SEE PAINT KEY 0 (REF) 11.STL PIPE: ASTM A-53 TY, E GR. A 7. ZINC PLATED THESE SUBMITTAL DOCUMENTS H. SPEC SECTION: 12.COMMERCIAL BRONZE (2) C. & (1) C. (TDFT-10 . 4 - 3/4REVIEWED FOR AND ARE FOUND TO A COMPLIANCE WITH THE CONTRACT DATE: LATE: 4.CLEAR PLASTIC BUTYRATE PIPE 15A.STN. STL.HDW.: ASTM F-593 & 594 TYPE 304 (GRADE 8 & 88) 26.PHOSPHOR BRZ.: ASTM B-139 AL. 510 4-3/4 (59)4 PLCS PPROVED_X 37.M.S. STEEL HDW.: ASTM A-449 0 6T EIM STANDARD St. 79 8 PLCS 5-3/4 APPROVED AS NOTED PART NO. OR SIZE FIN (80)8 PLCS GATE OTY ITEM DESCRIPTION (89) (FOR WATERMAN USE ONLY) ATE 4-27 30-1/4 [7] SLUICE GATE ASSEMBLY SUBMITTAL # 48
APPROVED BY USCO 48 X 48 S-5000-F a) FRAME
b) COVER
c) SEAT
d) GUIDE RAIL
e) SIDE WEDGE ASSEMBLY 6E 6E 3 6E W-5532 W-5057 VIEW(A) CAST INTEGRAL WITH FRAME 1 INCH GROUT PAD SYSTEM B1 W-5511 L&R & W-5139 L&R 4ea BY OTHERS TOP OF EQUIPMENT PAD EL. 744.00 FT 6 WEDGES 1,3 2 1,4,5 15A ASSEMBLY / ADJUSTING HARDWARE

f) TOP WEDGE ASSEMBLY
WEDGES & BRACKETS
ASSEMBLY / ADJUSTING HARDWARE
g) BOTTOM WEDGE ASSEMBLY 2 TOP OF NEW CONC. PLATFORM EL. 743.00 FT 6 12 [6] W-5006 & W-5007 1,3 2 PROJ. 2 15A 15 6 2 (53)2 PLCS WEDGES & BRACKETS W-5006 & W-5008 (77)2 PLCS STEM LENGTH ASSEMBLY / ADJUSTING HARDWARE 15A 221 THREADED (78)2 PLCS 192 TOP OF EXISTING CONC. SLAB EL 737.00 FT 6 SHOP NOTE: W-5014 MB (2 DIA, 4TPI, LH) 2 DIA., 5 TPI, LH POLISH STEM THREADS TO 63' FINISH 3. STEM 9A PROJ. 2 7. LIFT ASSEMBLY a) ELECTRIC OPERATOR 6T EIM-MODEL 2FRG-3 2-0001/14G 54393 (77)2 PLCS OUTLINE DWG. SCHEMATIC DWG. PROJ. 7 1 AT 157 (78)2 PLCS 3.25 7.1 PEDESTAL GATE FULL OPEN 6H 6,11 102806 8 ± 4 (77) 4 PLCS 108 REF. 102786 (3in); 52 LG. TYPE K-2 75 58-3/4 (78) 4 PLCS 9. STEM GUIDE (LZ BRONZE BUSHED) 1,26 IDENTIFICATION TAG (NOT SHOWN) SEE DRAWING RA-99-1556 3 PLCS 1 AT 86 51-1/4 (26) 8 PLCS EXISTING THIMBLE TO 777) 8 PLCS 24. DOUBLE ENDED STUD 25. DOUBLE ENDED STUD 26. DOUBLE ENDED STUD 5/8 NC X 3-1/2 LG. 5/8 NC X 6-1/2 LG. 5/8 NC X 8 LG. 2,3 2,3 2,3 BE REUSED 9A 9A 53. ANCHOR BOLT 59. ANCHOR BOLT 2,3 2,3 9A 9A 15A 15A 15A 15A 37 5/8 NC X 10 LG. 3/4 NC X 12 LG. MPACT INTO DOVETAIL 77. HEX NUT 20 20 8 8 20 20 GROOVE / MACHINE FLAT TO .002 T.I.R. WITH A 63 FINISH OR BETTER 78. WASHER 27-1/4 5/B DIA END OF STEM 79. HEX NUT 3/4 NC 13-1/2 80. WASHER WAT ER MAN 89. HEX HEAD BOLT 5/8 NC X 1-3/4 LG. 11-1/4 C EL. 728,00 FT 6 NOM. OPENING -Furnish anchor polts a 13-1/2 IN GATE stainless steel per 29 Spec. 48 DIA. NOM, OPENING 27-1/4 IN THIMBLE -INV. EL. 726.00 FT 6 NOTES: UNLESS OTHERWISE SPECIFIED. 1. (GATE CAPACITY) MAX. SEATING HD.= 70 FT.: MAX UNSEATING HD.= 26 FT.
2. OPERATING HEAD FROM CENTER LINE: SEATING= 12 FT.: UNSEATING= 12 FT.
3. UFT CAPACITY = 8,055 LBS © 12 IN/MIN (125 FT-LBS. TORQUE; 48 RPM)
4. TURN HANDWHEEL CCW TO OPEN (RAISE) GATE.

[5] 1/4 PITCH; 1/4 LEAD (SINGLE LEAD REF); 29° STUB ACME THREAD.
[6] CONTRACTOR TO VERIFY OR SUPPLY. 24) 5 PLCS 3 PLCS (25 (77) 5 PLCS 3 PLCS (77) (78) 5 PLCS 7 DIMENSION INCLUDES 1 INCH FOR GROUT PAD.
8 CONTRACTOR TO REUSE EXISTING 5/8 NC ANCHOR BOLTS. 3 PLCS (78) MASTIC GASKET BY OTHERS 1) CATE REQUIRED AT NORTH CHLORINE CONTACT TANK-PLANT EFFLUENT BYPASS, GATE NO. S-51-1 REF PLAN SHEET M-3 REF: WASTEWATER TREATMENT PLANT 48 X 48 WATERMAN MODEL FOR: JOHN DARR MECHANICAL, INC. REV.NO. DATE PROJECT MANAGER DISINFECTION FACILITIES UPGRADE 1046 BAKER ROAD <u>L-5189</u> WATER UTILITIES DEPARTMENT DEXTER, MI REV.NO. DATE QUOTE NO. QUOTE ITEM NO. CITY OF ANN ARBOR, MICHIGAN S-5000-FGQ99-A-1159 REV,NO. DATE DRAWN BY CHECKED BY ENGRS: GREELEY AND HANSEN GT SLUICE GATE REV.NO. DATE SCALE NONE 12/28/99 DRAWING NO. INDUSTRIES INC. EXETER, CALIFORNIA 93221 4-3-00 ME DREW RB-99-1552

